




B

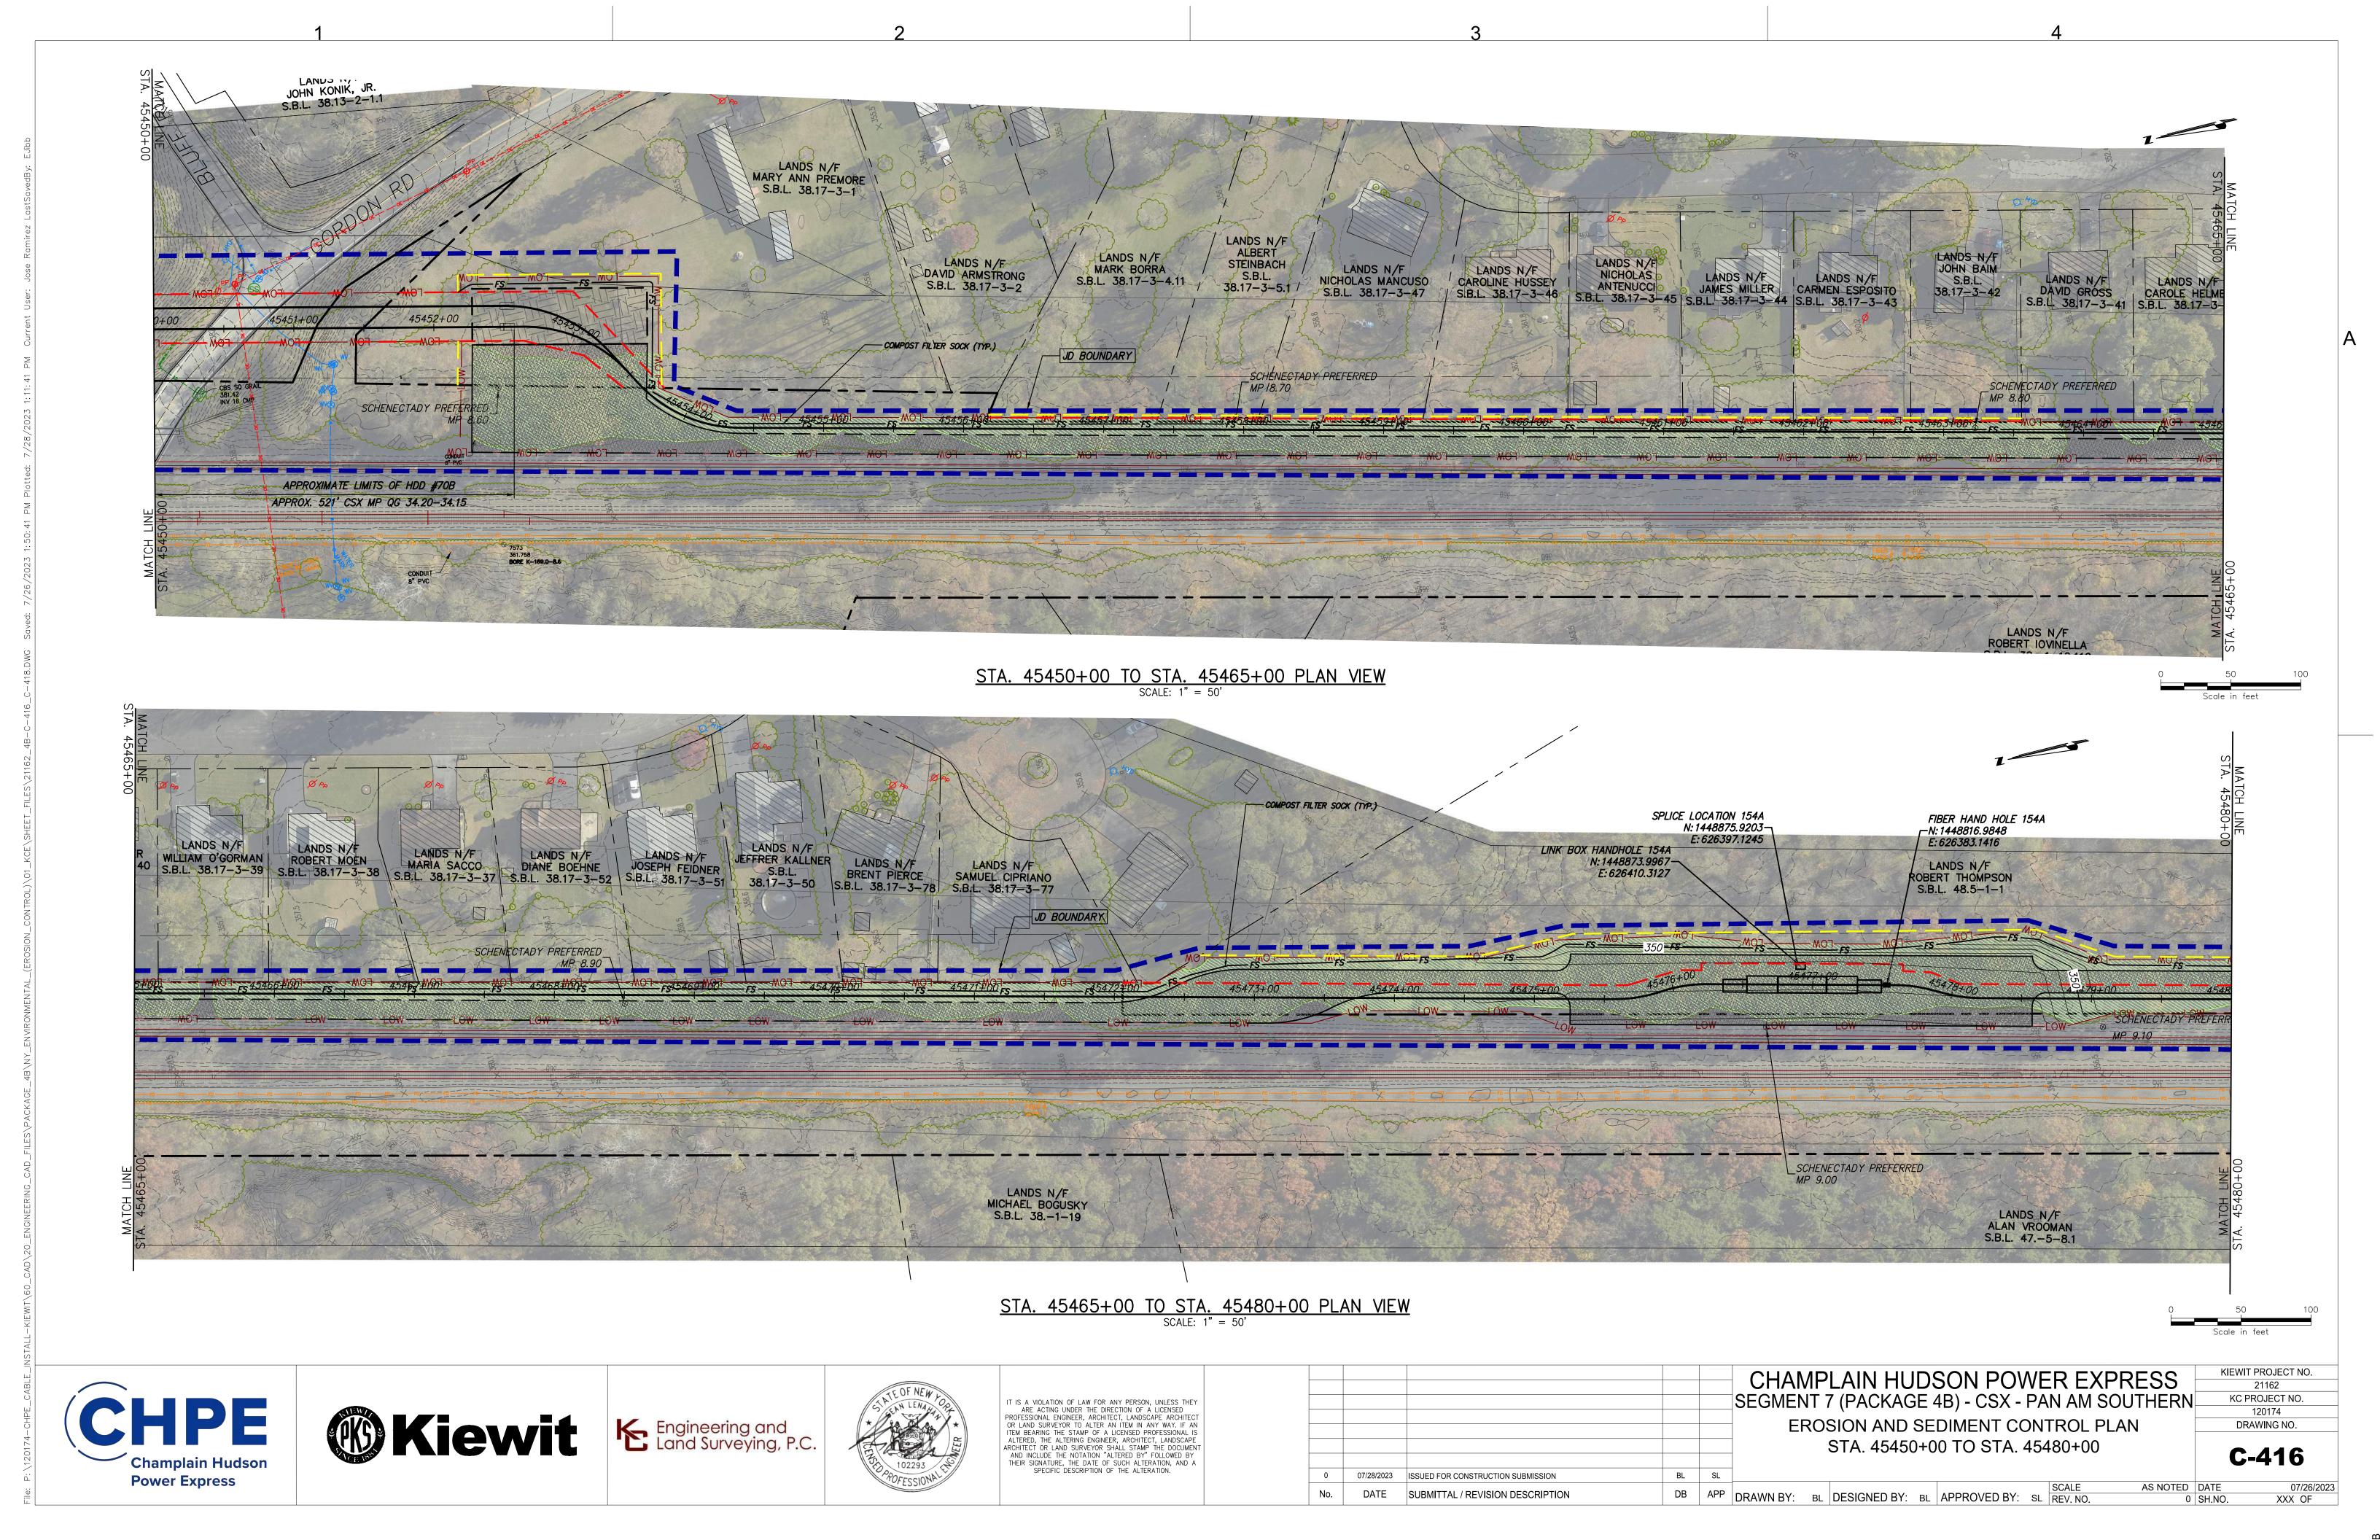

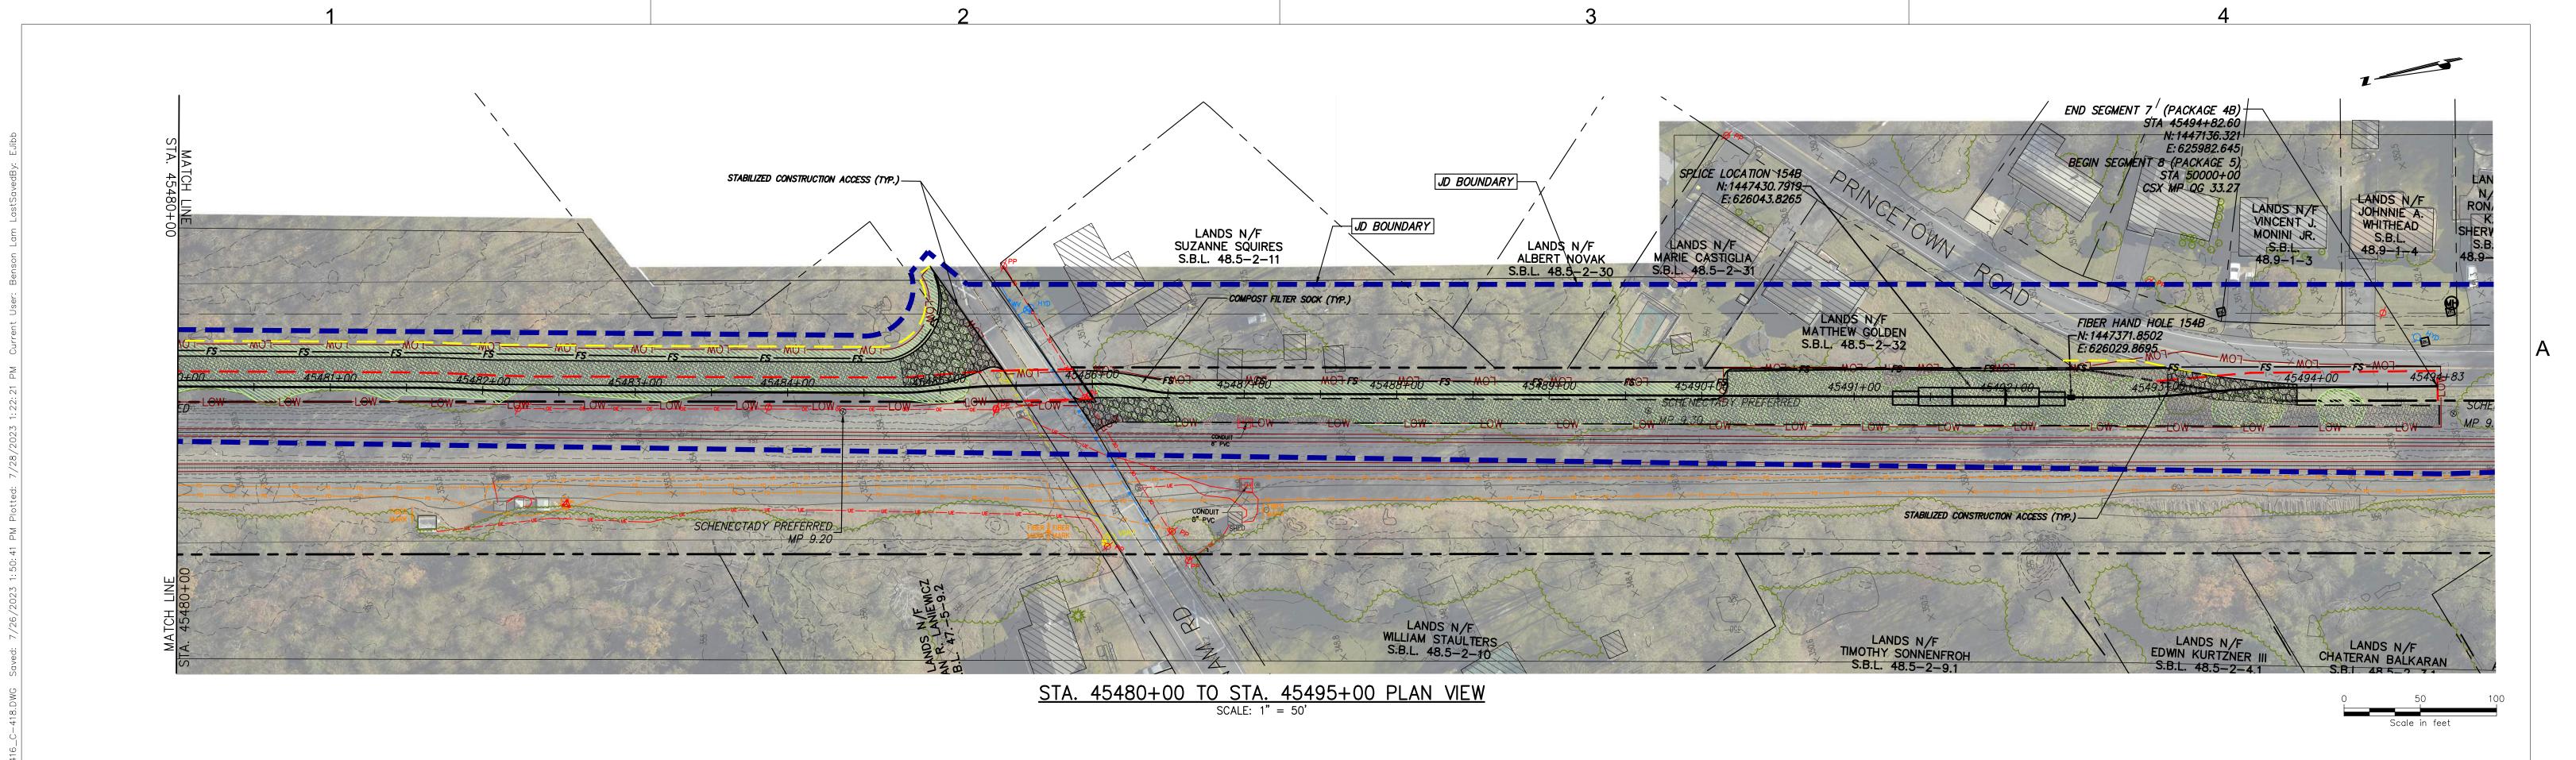





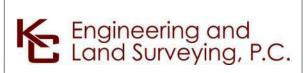



IT IS A VIOLATION OF LAW FOR ANY PERSON, UNLESS THEY ARE ACTING UNDER THE DIRECTION OF A LICENSED PROFESSIONAL ENGINEER, ARCHITECT, LANDSCAPE ARCHITECT OR LAND SURVEYOR TO ALTER AN ITEM IN ANY WAY. IF AN ITEM BEARING THE STAMP OF A LICENSED PROFESSIONAL IS ALTERED, THE ALTERING ENGINEER, ARCHITECT, LANDSCAPE ARCHITECT OR LAND SURVEYOR SHALL STAMP THE DOCUMENT AND INCLUDE THE NOTATION "ALTERED BY" FOLLOWED BY THEIR SIGNATURE, THE DATE OF SUCH ALTERATION, AND A SPECIFIC DESCRIPTION OF THE ALTERATION.

					CHAMPLAIN HUDSON POWER EXPRESS SEGMENT 7 (PACKAGE 4B) - CSX - PAN AM SOUTHERN
					EROSION AND SEDIMENT CONTROL PLAN
					STA. 45480+00 TO STA. 45495+00
0	07/28/2023	ISSUED FOR CONSTRUCTION SUBMISSION	BL	SL	

DATE SUBMITTAL / REVISION DESCRIPTION

DB APP DRAWN BY: BL DESIGNED BY: BL APPROVED BY: SL REV. NO.

KIEWIT PROJECT NO. 21162 KC PROJECT NO. 120174 DRAWING NO.

C-417

AS NOTED DATE

07/26/2023 0 SH.NO. XXX OF

	MAIN STAGE	STA. START	STA. END	ROUTE(S)	POSTED SPEED (MPH)	CLOSURE TYPE	PLAN SHEET	TRAFFIC COUNTS (AADT)	WORK NOTES
	71	45452+52	45476+36	CSX R.O.W. / EASEMENT					TRENCHING & CONDUIT INSTALLATION
	72	45476+36	45477+55	CSX R.O.W. / EASEMENT					SPLICE BOX INSTALLATION 154A
	73	45477+55	45485+49	CSX R.O.W. / EASEMENT					TRENCHING & CONDUIT INSTALLATION
	74	45485+49	45484+82	COUNT ROAD 54 (PUTNAM RD)	35	LANE CLOSURE WITH ALTERNATING ONE WAY TRAFFIC	C-511 C-512	2655 (2019)	TRENCHING & CONDUIT INSTALLATION
	75	45484+82	45491+25	CSX R.O.W. / EASEMENT					TRENCHING & CONDUIT INSTALLATION
	76	45491+25	45492+44	CSX R.O.W. / EASEMENT					SPLICE BOX INSTALLATION 154B
	77	45492+44	45494+83	COUNTY ROAD 83 (PRINCETOWN RD)	35	LANE CLOSURE WITH ALTERNATING ONE WAY TRAFFIC	C-504	1158 (2019)	TRENCHING & CONDUIT INSTALLATION
-c.									1 D D D E V # 1 T 0 V 0

ALL TRAFFIC CONTROL AND WORK AREA PROTECTIONS DEVICES SHALL BE FABRICATED AND INSTALLED IN ACCORDANCE WITH THE FEDERAL HIGHWAY ADMINISTRATION (FHWA) MANUAL ON UNIFORM TRAFFIC CONTROL DEVICES (MUTCD) FOR STREETS AND HIGHWAYS, LATEST EDITION, EXCEPT AS NOTED.

- ALL TEMPORARY TRAFFIC CONTROL AND WORK AREA PROTECTION DEVICES SHALL BE FURNISHED AND INSTALLED BY THE CONTRACTOR UNLESS OTHERWISE NOTED ON THE CONTRACT DRAWINGS AND APPROVED BY THE ENGINEER PRIOR TO COMMENCING WORK.
- ALL MAINTENANCE AND PROTECTIONS OF TRAFFIC WORK SHALL CONFORM TO THE CONTRACT DRAWINGS. MAINTENANCE AND PROTECTION OF TRAFFIC SCHEMES SHOWN ON THE CONTRACT DRAWINGS SHALL NOT BE CHANGED BY THE CONTRACTOR WITHOUT THE WRITTEN PERMISSION OF THE ENGINEER.
- THE TEMPORARY MAINTENANCE OF TRAFFIC AND WORK AREA PROTECTION DEVICE 24. ACCESS TO RESIDENTIAL AND COMMERCIAL DRIVEWAYS SHALL BE LOCATIONS SHOWN ON THE CONTRACT DRAWINGS ARE SCHEMATIC EXCEPT AS NOTED. LOCATION OF TRAFFIC CONTROL DEVICES MAY BE MODIFIED TO MEET FIELD CONDITIONS AS APPROVED BY THE ENGINEER.
- 5. ALL CLOSURES SHALL BE COORDINATED WITH THE ENGINEER. A SCHEDULE OF WORK SHALL BE SUBMITTED AT LEAST TWO WEEKS IN ADVANCE FOR APPROVAL BY THE ENGINEER.
- THERE MAY BE ONGOING CONSTRUCTION CONTRACTS WITHIN THE VICINITY OF THE WORK AREA. DO NOT MOVE, MODIFY, OR RELOCATE ANY ITEM ASSOCIATED WITH THESE CONTRACTS WITHOUT PROPER APPROVAL OF AND COORDINATION WITH THE ENGINEER.
- PERFORM WORK IN SUCH A MANNER AND SEQUENCE AS TO INTERFERE AS LITTLE AS POSSIBLE WITH THE PASSAGE OF VEHICLES, PEDESTRIANS, AND OTHER KINDS OF PUBLIC TRAFFIC.
- ALL TEMPORARY MAINTENANCE OF TRAFFIC AND WORK AREA PROTECTION SIGN SUPPORTS AND MOUNTING SHALL BE IN CONFORMANCE WITH NYSDOT STANDARD SHEETS AND STANDARD SPECIFICATIONS.
- 9. ALL CONSTRUCTION SIGNS SHALL BE COVERED WITH THICK PLASTIC WHEN THE WORK THEY ARE INTENDED FOR IS NOT IN PROGRESS.
- 10. ALL TRAFFIC CONTROL DEVICES SHALL BE INSTALLED PRIOR TO THE COMMENCEMENT OF THE WORK TO WHICH THEY APPLY. AND SHALL BE MAINTAINED BY THE CONTRACTOR THEREAFTER. THE DEVICES SHALL REMAIN IN PLACE AS LONG AS THEY ARE APPLICABLE.
- TRAFFIC CONTROL DEVICES SHALL NOT BE PLACED AT ANY LOCATIONS WHERE THEY MAY OBSCURE OR INTERFERE WITH THE MOTORIST VIEW OF APPROACHING MERGING. OR INTERSECTING TRAFFIC: OBSTRUCT OTHER TEMPORARY OR PERMANENT TRAFFIC CONTROL DEVICES WHICH ARE STILL APPLICABLE TO ROADWAY CONDITIONS; MISLEAD OR MISDIRECT MOTORISTS, OR ARE BLOCKED BY OTHER TEMPORARY OR PERMANENT OBJECTS.
- 12. ALL EXISTING ROADWAY ITEMS SUCH AS GUIDE RAILS, PAVEMENT MARKINGS, CURBS, SIGNALS AND SIGNS DAMAGED BY THE CONTRACTOR SHALL BE RESTORED BY THE CONTRACTOR TO THE SATISFACTION OF THE ENGINEER AT NO ADDITIONAL
- 13. TRAFFIC LANES AND OTHER AREAS CLOSED BY THE CONTRACTOR DURING PERMITTED WORK HOURS SHALL BE CLEARED OF ALL MATERIAL. EQUIPMENT. AND DEBRIS, AND SAFELY REOPENED TO TRAFFIC BY THE END OF THE WORK PERIOD UNLESS OTHERWISE INDICATED ON THE CONTRACT DRAWINGS.
- 14. IF THE CONTRACTOR REQUIRES A LANE CLOSURE TO PERFORM OPERATIONS, THEY MAY DO SO WITH THE APPROVAL OF THE ENGINEER. ANY LANE CLOSURES WILL BE SHORT TERM AND IN ACCORDANCE WITH NYS STANDARD SHEETS UNLESS OTHERWISE SHOWN IN CONTRACT PLANS.
- 15. NO WORK ACTIVITY OR STORAGE OF EQUIPMENT, VEHICLES, OR MATERIAL SHOULD OCCUR WITHIN A BUFFER SPACE.
- CHANNELIZING DEVICE SPACING (CENTER TO CENTER) SHALL NOT EXCEED 20' IN THE ACTIVE WORK SPACE.
- 17. ALL OPEN TRENCH EXCAVATIONS SHALL BE BACKFILLED OR PLATED AT THE END OF EACH WORK DAY, OR AS DIRECTED BY THE ENGINEER.
- RAILROAD GRADE CROSSING AND WHENEVER WITHIN THE RAILROAD ROW. 19. ALL ADDITIONAL TEMPORARY SIGNAGE, NOT COVERED IN FHWA MUTCD, SHALL COMPLY WITH NYS SUPPLEMENT TO MANUAL OF UNIFORM TRAFFIC CONTROL
- 20. DURING NON-WORK HOURS, LEAVE DRUMS AND TCB IN PLACE, OR AS DIRECTED BY THE ENGINEER.
- DURING WINTER MORATORIUM, COVER EXCAVATION WITH TEMPORARY ASPHALT AND OPEN ALL LANES TO TRAFFIC.

ISSUED FOR CONSTRUCTION SUBMISSION

SUBMITTAL / REVISION DESCRIPTION

- 22. THE WZTC DETAILS CONTAINED IN THE CONTRACT PLANS SUPPLEMENT THE CURRENT NYSDOT STANDARD SHEETS. REFERENCE SHALL BE MADE TO THE APPLICABLE NYSDOT STANDARD SHEETS FOR ALL NOTES AND TABLES. THE LATEST REVISIONS OF THE STANDARD SHEETS MAINTAINED BY NYSDOT SHALL BE CONSIDERED TO BE IN EFFECT. ALL PAY ITEMS AND WORK CONTAINED IN THE CONTRACT AND ANY ADDITIONAL PAY ITEMS AND WORK ENCOUNTERED DURING THE COURSE OF THE CONTRACT SHALL BE SUBJECT TO THE APPLICABLE STANDARD SHEET(S) UNLESS OTHERWISE SPECIFIED IN THE CONTRACT
- 23. MAINTAIN SAFE AND ADEQUATE ACCESS FOR INTERSECTING ROADWAYS. HOMES, AND BUSINESSES, AT ALL TIMES, TO THE SATISFACTION OF THE ENGINEER.
- MAINTAINED AT ALL TIMES. UNLESS OTHER AGREEMENTS SUITABLE TO THE PROPERTY OWNERS CAN BE MADE, PROPERTY OWNERS WHOSE DRIVEWAYS WILL BE MADE INACCESSIBLE SHALL BE NOTIFIED BY THE CONTRACTOR AT LEAST 24 HOURS PRIOR TO RESTRICTING USE OF THE DRIVEWAY. THE CONTRACTOR SHALL MAINTAIN ACCESS TO COMMERCIAL DRIVEWAYS AT ALL TIMES WHEN A FACILITY IS IN USE. FOR MULTIPLE ACCESS PROPERTIES, ONLY ONE DRIVEWAY MAY BE CLOSED AT ANY ONE TIME. ACCESS SHALL BE RESTORED TO ALL DRIVEWAYS AS SOON AS POSSIBLE, OR AS DIRECTED BY THE ENGINEER.
- 25. THE CONTRACTOR'S ATTENTION IS DIRECTED TO THE FACT THAT THE FOLLOWING HOLIDAY WORK RESTRICTIONS ARE APPLICABLE TO THIS PROJECT. DURING THESE HOLIDAY PERIODS. THE CONTRACTOR WILL NOT BE ALLOWED TO PERFORM ANY WORK THAT WILL BE DISRUPTIVE TO TRAFFIC, INCLUDING BUT NOT LIMITED TO LANE CLOSURES. LANE CLOSURES WILL NOT BE PERMITTED DURING THE FOLLOWING STATE RECOGNIZED HOLIDAYS:
 - MONDAY. SEPTEMBER 4, 2023 THANKSGIVING DAY THURSDAY, NOVEMBER 23, 2023 CHRISTMAS DAY
 - MONDAY, DECEMBER 25, 2023 **NEW YEAR'S DAY** MEMORIAL DAY MONDAY, JANUARY 1, 2024 INDEPENDENCE DAY - MONDAY, MAY 27, 2024 LABOR DAY THURSDAY, JULY 4, 2024 THANKSGIVING DAY - MONDAY, SEPTEMBER 2, 2024
 -) CHRISTMAS DAY - THURSDAY, NOVEMBER 28, 2024 WEDNESDAY, DECEMBER 25, 2024 10) NEW YEAR'S DAY WEDNESDAY, JANUARY 1, 2025 I) MEMORIAL DAY INDEPENDENCE DAY - MONDAY, MAY 26, 2025 FRIDAY, JULY 4, 2025 LABOR DAY THANKSGIVING DAY - MONDAY, SEPTEMBER 1. 2025 15) CHRISTMAS DAY — THURSDAY, NOVEMBER 27, 2025
- 26. LANE CLOSURES SHALL BE SUSPENDED AS FOLLOWS:
- BEGINNING 6AM, FRIDAY SEPTEMBER 1, 2023 AND ENDING 6AM, TUESDAY SEPTEMBER 5, 2023 - BEGINNING 6AM, WEDNESDAY NOVEMBÉR 22, 2023 AND ENDING 6AM, MONDAY NOVEMBÉR 27, 2023

THURSDAY, DECEMBER 25, 2025

- BEGINNING 6AM, SUNDAY DECEMBER 30, 2023 AND ENDING 6AM, WEDNESDAY JANUARY 3, 2024

- BEGINNING 6AM, FRIDAY DECEMBER 22, 2023 AND ENDING 6AM, TUESDAY DECEMBER 26, 2023

- BEGINNING 6AM, FRIDAY MAY 24, 2024 AND ENDING 6AM, TUESDAY MAY 28, 2024
- BEGINNING 6AM, MONDAY JULY 1, 2024 AND ENDING 6AM, FRIDAY JULY 5, 2024 BEGINNING 6AM, FRIDAY AUGUST 30, 2024 AND ENDING 6AM, TUESDAY SEPTEMBER 3, 2024
- BEGINNING 6AM, WEDNESDAY NOVEMBER 27, 2024 AND ENDING 6AM, MONDAY DECEMBER 2, 2024 BEGINNING 6AM, FRIDAY DECEMBER 20, 2024 AND ENDING 6AM, THURSDAY DECEMBER 26, 2024
- BEGINNING 6AM, TUESDAY DECEMBER 30, 2024 AND ENDING 6AM, FRIDAY JANUARY 3, 2025
- BEGINNING 6AM, FRIDAY MAY 23, 2025 AND ENDING 6AM, TUESDAY MAY 27, 2025
- BEGINNING 6AM, THURSDAY JULY 3, 2025 AND ENDING 6AM, MONDAY JULY 7, 2025 - BEGINNING 6AM, FRIDAY AUGUST 29, 2025 AND ENDING 6AM, TUESDAY SEPTEMBER 2, 2025
- BEGINNING 6AM, WEDNESDAY NOVEMBER 26, 2025 AND ENDING 6AM, MONDAY DECEMBER 1, 2025 - BEGINNING 6AM, WEDNESDAY DECEMBER 24, 2025 AND ENDING 6AM, MONDAY DECEMBER 29, 2025
- 18. PRIOR TO COMMENCING ANY WORK. THE CONTRACTOR SHALL COORDINATE WITH DURING WINTER STORM EVENTS, NO WORK WITHIN THE ROAD RIGHT-OF-WAY IS PERMITTED TO CSX RAILROAD FOR RAILROAD FLAGGING FOR ALL WORK IN THE VICINITY OF ANY ALLOW FOR SNOW REMOVAL, PLOWING ACTIVITIES.
 - 28. ANY EARTHWORK DONE BETWEEN NOVEMBER 1ST AND APRIL 1ST MUST CONFORM TO NYSDOT STANDARD SPECIFICATION SECTION 203-1.01 P.
 - 29. WHEN THE DISTANCE BETWEEN THE ADVANCE WARNING SIGNS AND WORK IS 2 MILES TO 5 MILES, A SUPPLEMENTAL DISTANCE PLAQUE (W7-30) SHOULD BE USED WITH THE SHOULDER WORK SIGN
 - 30. THE ROAD WORK NEXT XX MILES SIGN (G20-1) MAY BE USED INSTEAD OF THE ROAD WORK AHEAD SIGN (W20-1) IF WORK LOCATIONS OCCUR OVER A DISTANCE OF MORE THAN 2 MILES.

MS DESIGNED BY: MS APPROVED BY: BD REV. NO.

CHAMPLAIN HUDSON POWER EXPRESS SEGMENT 7 (PACKAGE 4B) - CSX - PAN AM SOUTHERN WORK ZONE TRAFFIC CONTROL NOTES LEGEND AND ABBREVIATIONS

KIEWIT PROJECT NO. 21162 KC PROJECT NO. 120174

C-501

DRAWING NO.

07/26/2023





IT IS A VIOLATION OF LAW FOR ANY PERSON, UNLESS THEY ARE ACTING UNDER THE DIRECTION OF A LICENSED OR LAND SURVEYOR TO ALTER AN ITEM IN ANY WAY, IF AN ALTERED THE ALTERING ENGINEER ARCHITECT LANDSCAPE ARCHITECT OR LAND SURVEYOR SHALL STAMP THE DOCUMENT AND INCLUDE THE NOTATION "ALTERED BY" FOLLOWED BY THEIR SIGNATURE, THE DATE OF SUCH ALTERATION, AND A SPECIFIC DESCRIPTION OF THE ALTERATION.

Power Express

ABBREVIATION

AVERAGE ANNUAL DAILY TRAFFIC

DIRECTIONAL HOURLY VOLUME

FEDERAL HIGHWAY ADMINISTRATION

MUTCD MANUAL ON UNIFORM TRAFFIC CONTROL DEVICES

TEMPORARY CONCRETE BARRIER

TEMPORARY SIGN

WORK ZONE

■ ■ CHANNELIZING DEVICE

FLAGGER

FLAG TREE

TCB (UNPINNED)

NYSDOT NEW YORK STATE DEPARTMENT OF TRANSPORTATION

CHANGEABLE MESSAGE SIGN (PVMS)

24.000 LB PROTECTIVE VEHICLE

WITH TRUCK/TRAILER MOUNTED

ARROW PANEL (CAUTION MODE)

ARROW PANEL TRAILER OR SUPPORT

TEMPORARY TRAFFIC FLOW ARROW

TEMPORARY IMPACT ATTENUATOR

WARNING LIGHT ON SIGN

ATTENUATOR (TMIA)

ARROW PANEL

TYPE III BARRICADE

FLASHING ARROW SIGN UNIT

COUNTY ROUTE

MILE POST

MAXIMUM

MINIMUM

STATION

MILES PER HOUR

NEW YORK STATE

MAX.

RTE

TCB

STA.


0 SH.NO.

LOCATION	SIGN	MUTCD NO.	COLOR	SIZE(S)
N	END ROAD WORK	G20-2	ORANGE AND BLACK	36"X18"
0	ROAD WORK AHEAD	W20-1	ORANGE AND BLACK	36"X36"
Р	BE PREPARED TO STOP	W3-4	ORANGE AND BLACK	36"X36"
Q	ONE LANE ROAD AHEAD	W20-4	ORANGE AND BLACK	36"X36"
R		W20-7	ORANGE AND BLACK	36"X36"
S	DETOUR AHEAD	W20-2	ORANGE AND BLACK	36"X36"
Т	ROAD CLOSED AHEAD	W20-3	ORANGE AND BLACK	36"X36"
U	LICENSE SUSPENDED AFTER TWO WORK ZONE SPEEDING TICKETS	NYR9-11	BLACK AND WHITE	24"X42"
W	LEFT SHOULDER CLOSED AHEAD	W21-5bL	ORANGE AND BLACK	36"X36"

LOCATION	<u>SIGN</u>	MUTCD NO.	COLOR	SIZE(S)
X	LEFT SHOULDER CLOSED	W21-5aL	ORANGE AND BLACK	36"X36"
Y		OM3-L	YELLOW AND BLACK	12"X36"





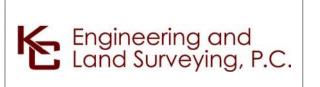




IT IS A VIOLATION OF LAW FOR ANY PERSON, UNLESS THEY
ARE ACTING UNDER THE DIRECTION OF A LICENSED
PROFESSIONAL ENGINEER, ARCHITECT, LANDSCAPE ARCHITECT
OR LAND SURVEYOR TO ALTER AN ITEM IN ANY WAY. IF AN
ITEM BEARING THE STAMP OF A LICENSED PROFESSIONAL IS
ALTERED, THE ALTERING ENGINEER, ARCHITECT, LANDSCAPE
ARCHITECT OR LAND SURVEYOR SHALL STAMP THE DOCUMENT
AND INCLUDE THE NOTATION "ALTERED BY" FOLLOWED BY
THEIR SIGNATURE, THE DATE OF SUCH ALTERATION, AND A
SPECIFIC DESCRIPTION OF THE ALTERATION.

					CHAMDLAIN HUDSON DOWED EVDDESS	KIEWIT PROJECT NO.
					CHAMPLAIN HUDSON POWER EXPRESS	21162
					SEGMENT 7 (PACKAGE 4B) - CSX - PAN AM SOUTHERN	KC PROJECT NO.
					SESMENT (THORNES IB) SON THURSDAY	120174
					SIGNAGE TABLES	DRAWING NO.
						C-502
						C-302
0	07/28/2023	ISSUED FOR CONSTRUCTION SUBMISSION	MS	BD		


DATE SUBMITTAL / REVISION DESCRIPTION


DB APP DRAWN BY: MS DESIGNED BY: MS APPROVED BY: BD REV. NO.

C-502 DATE 0 SH.NO. 07/26/2023 OF

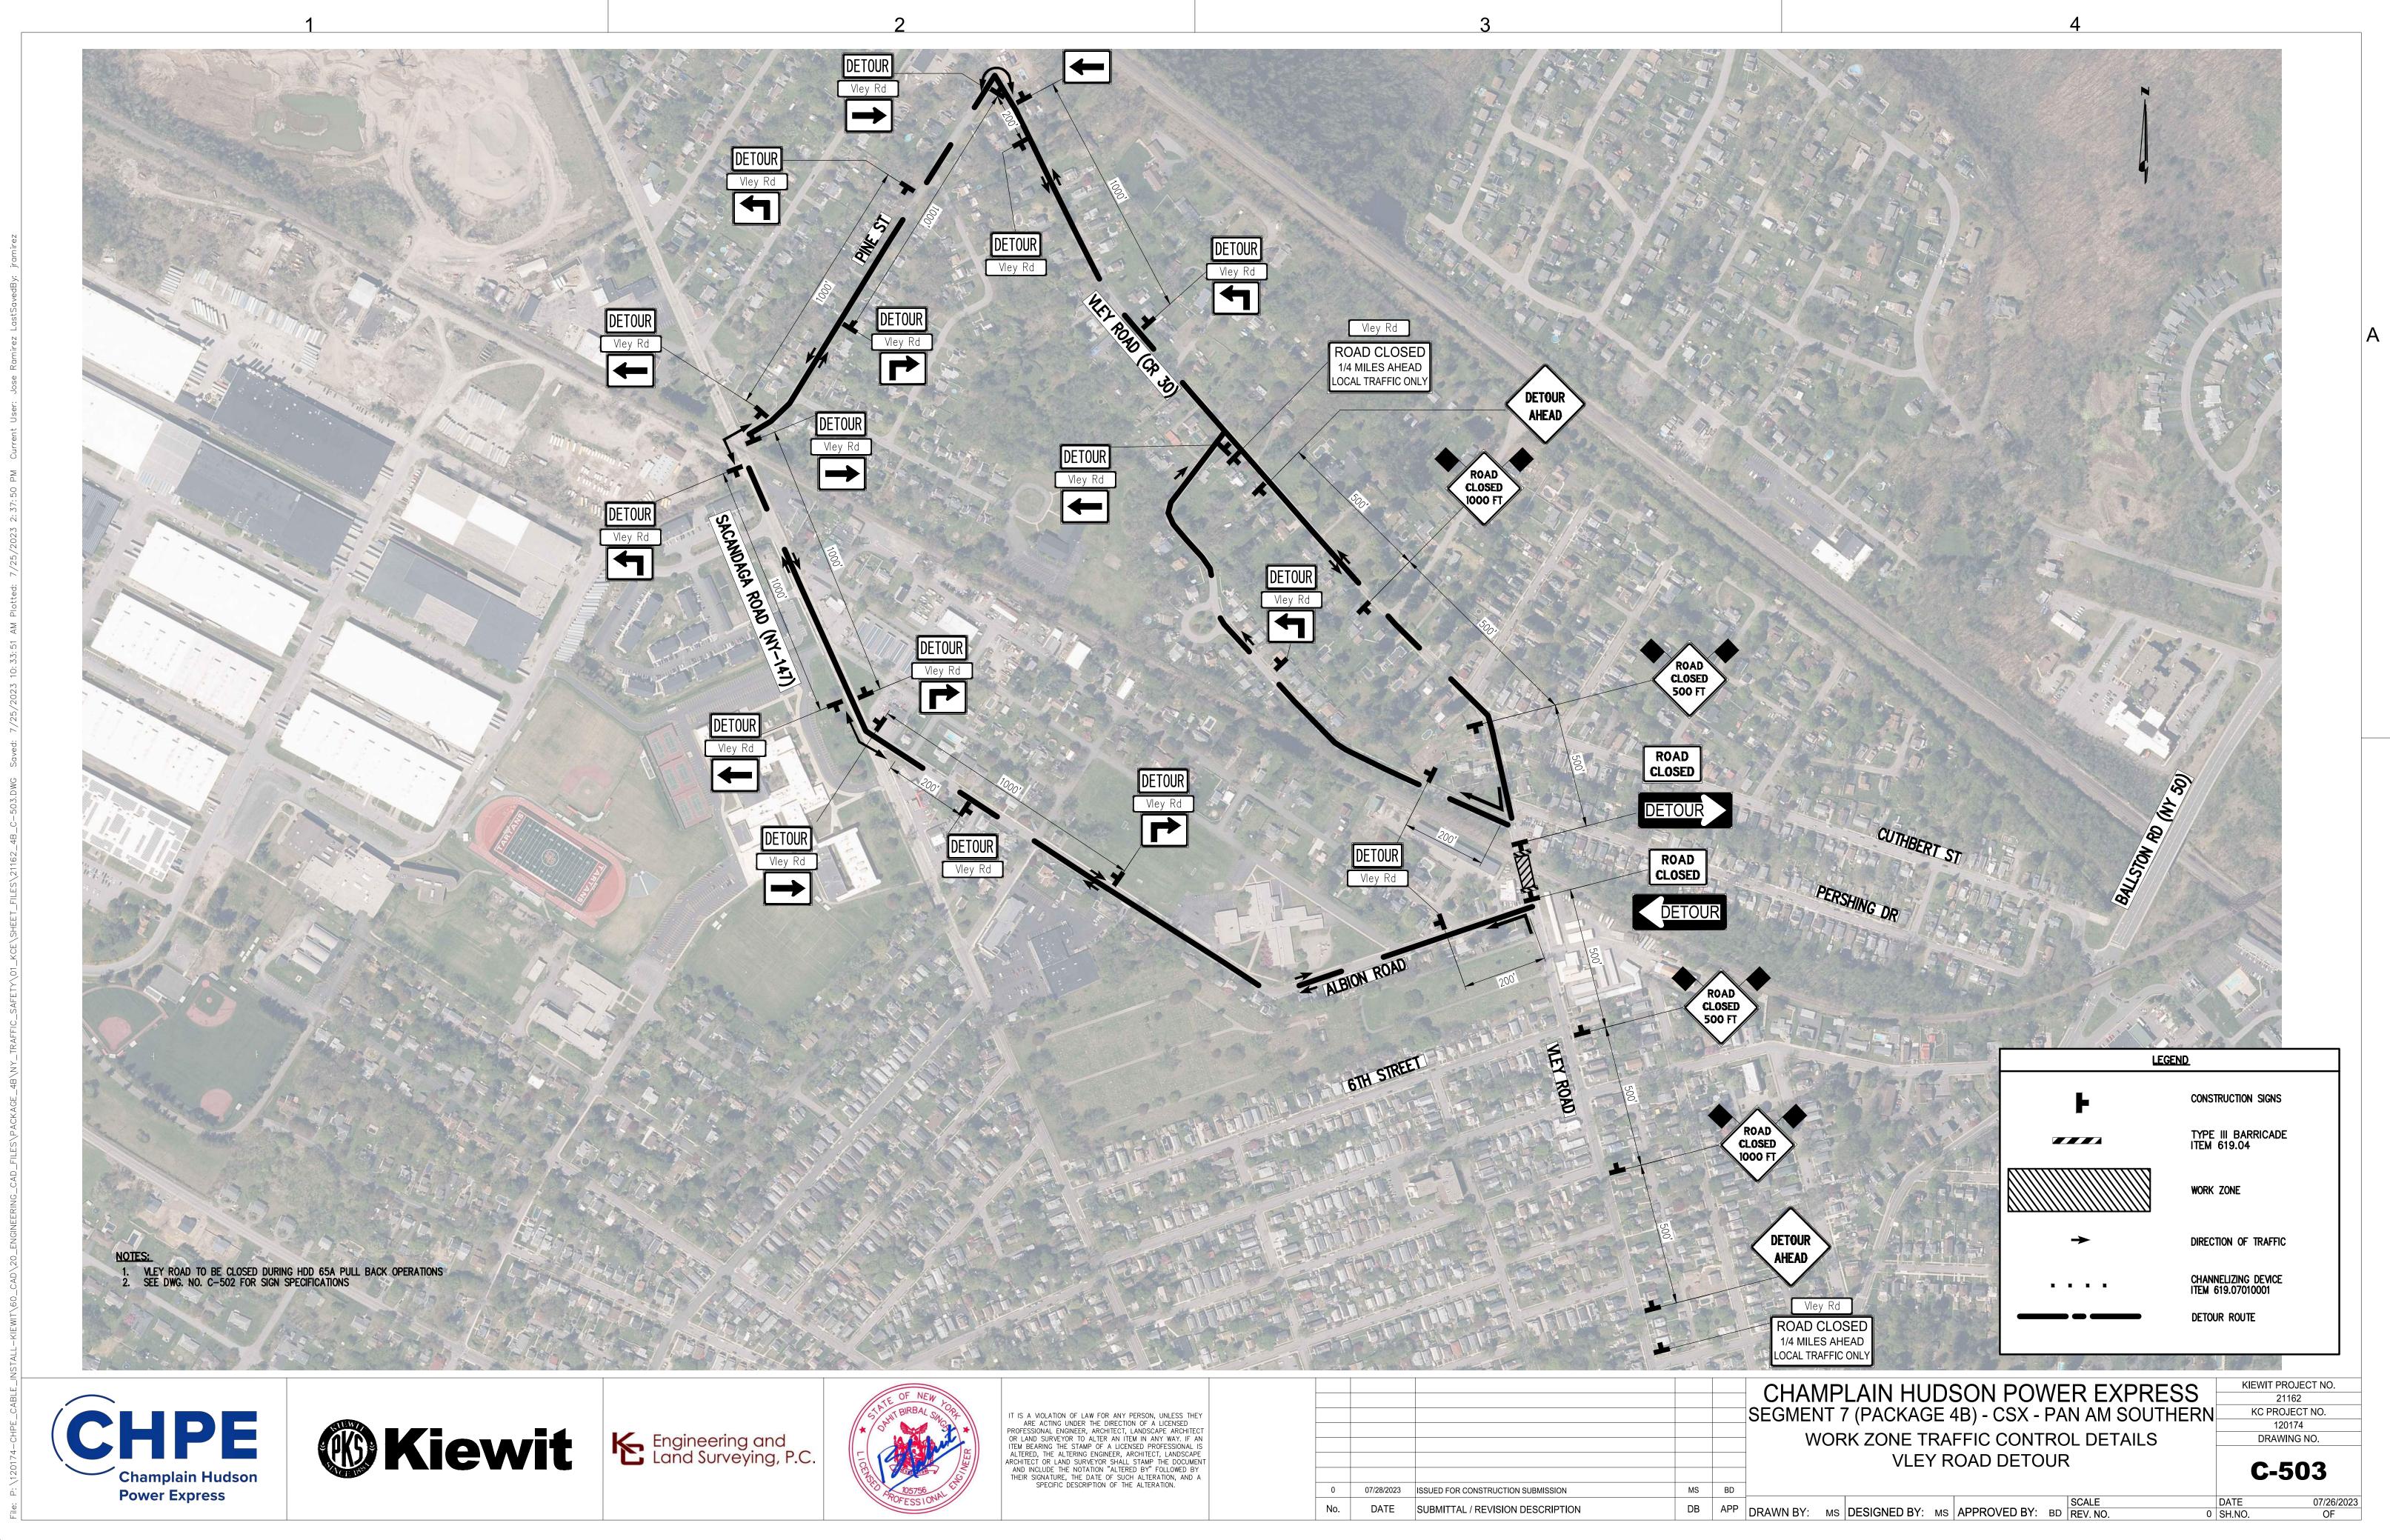

RNOTE

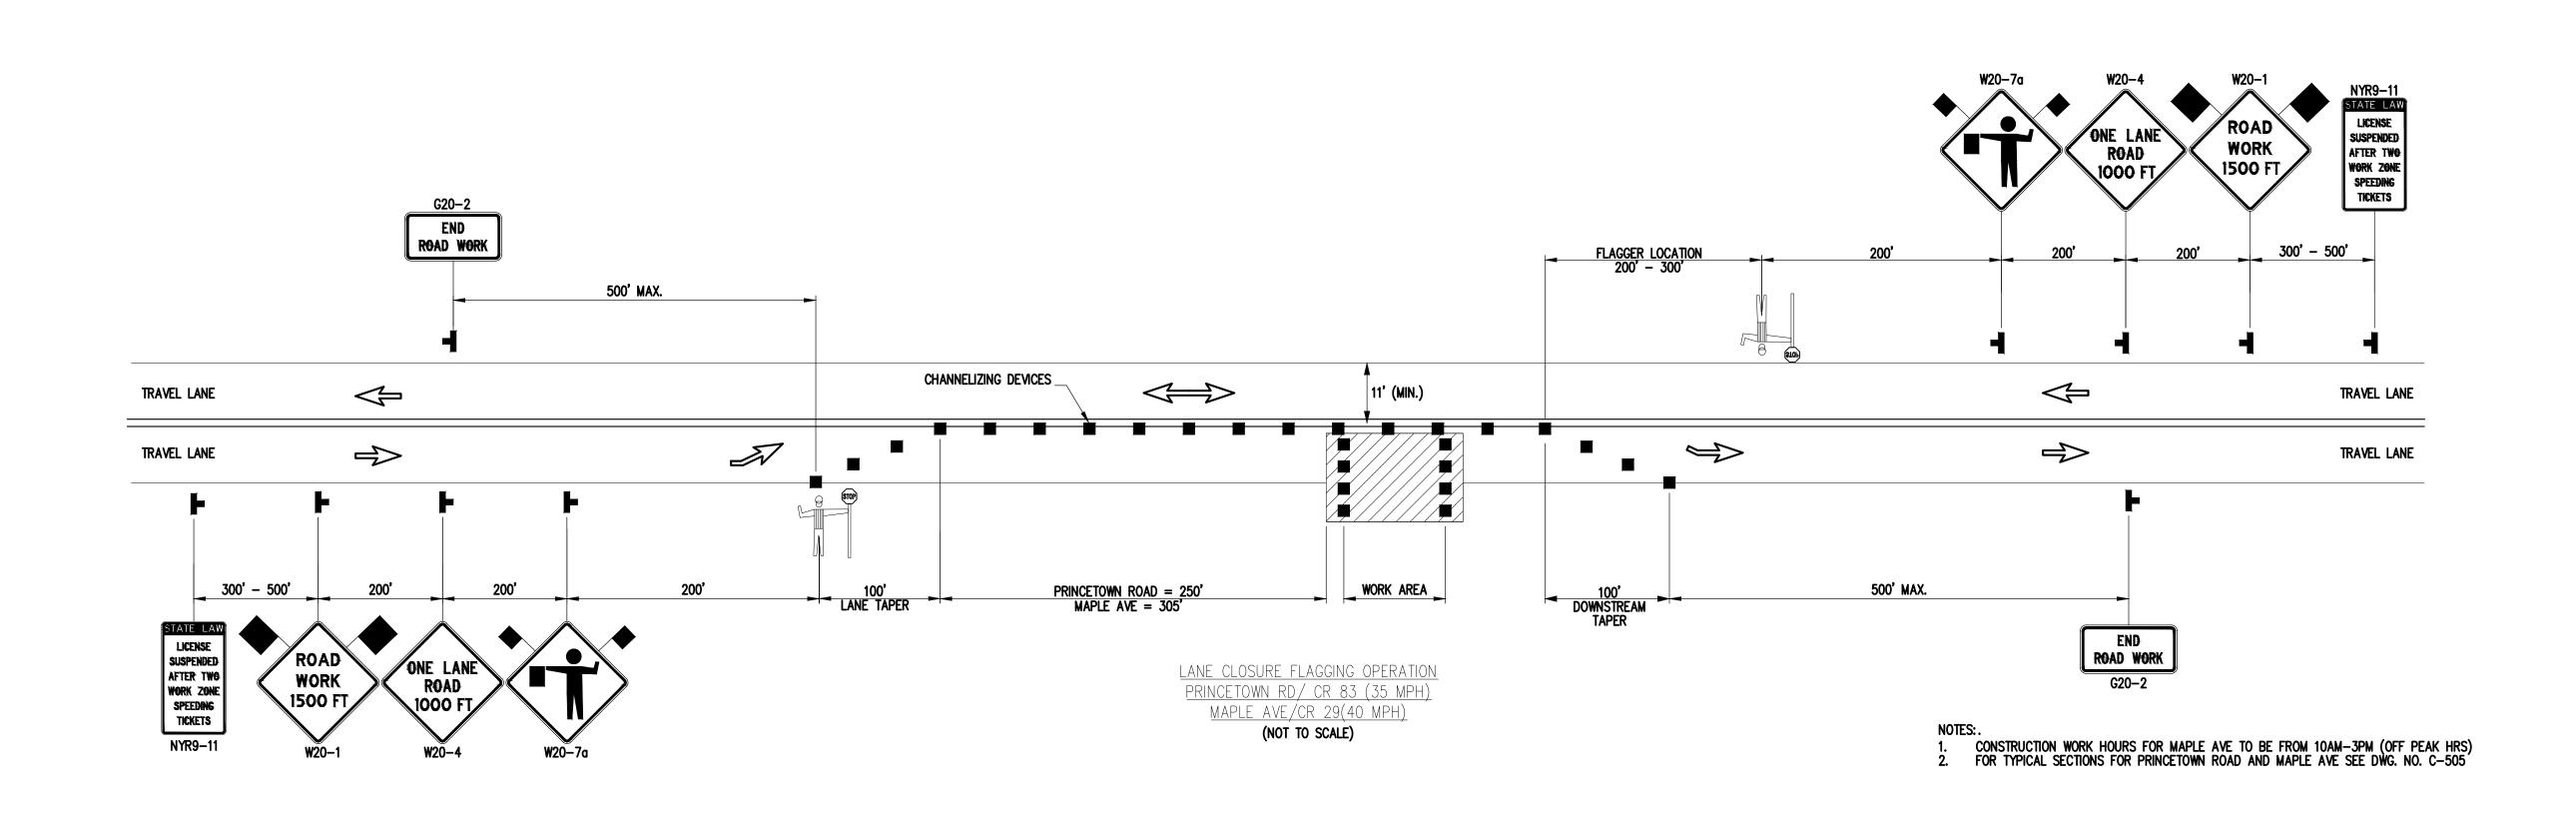

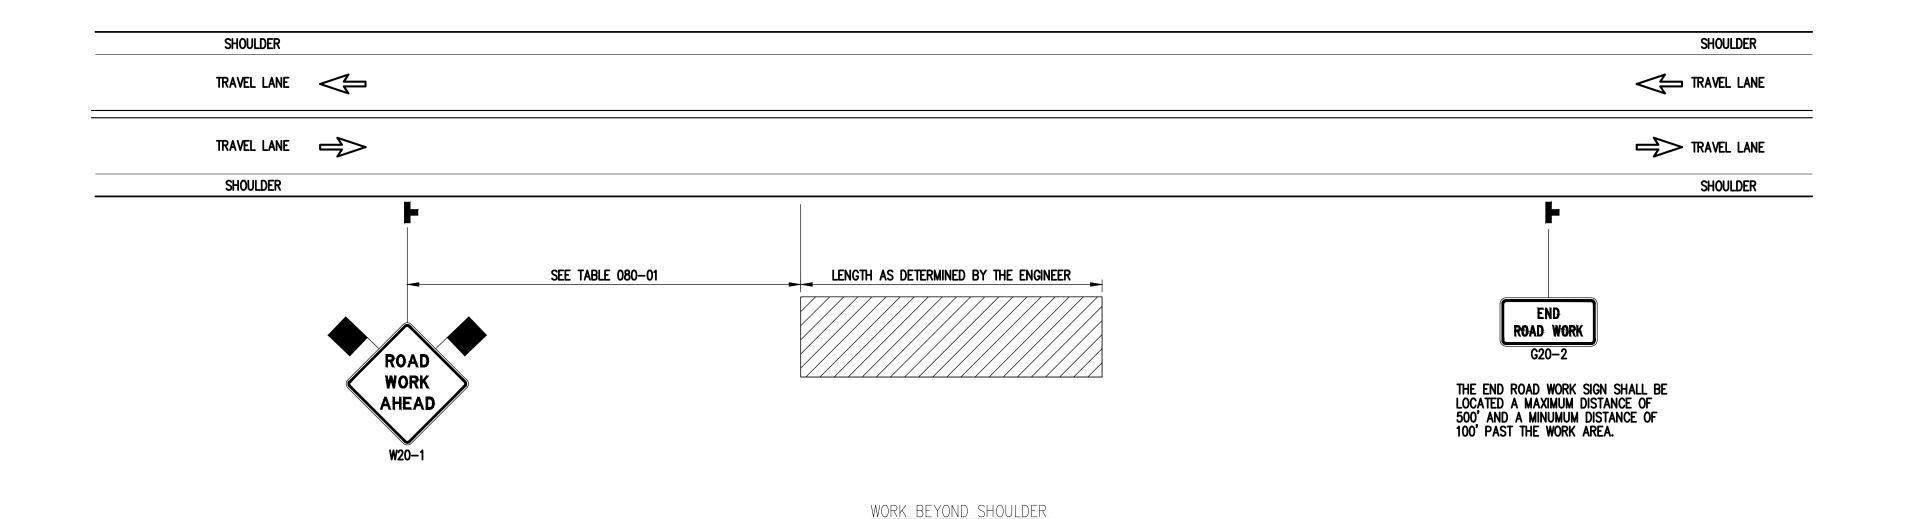

(NOT TO SCALE)

TABLE 080-01: AD	VANCE PLACEMENT SIGN DISTANCE
ROAD TYPE	DISTANCE BETWEEN SIGNS
URBAN (≤ 30 MPH*)	100
URBAN (35-40 MPH*)	200
URBAN (? 40 MPH*)	350
RURAL	500
FREEWAY	1000

*PRECONSTRUCTION POSTED SPEED LIMIT

TABLE U	80-02: REQUIRED SIG	IN SIZES.
SIGN	NON-FREEWAY	FREEWAY
G20-1	36x18	48x24
W20-1	36x36	48x48
WARNING FLAG	18x18	18x18

DB APP DRAWN BY: MS DESIGNED BY: MS APPROVED BY: BD REV. NO.









IT IS A VIOLATION OF LAW FOR ANY PERSON, UNLESS THEY ARE ACTING UNDER THE DIRECTION OF A LICENSED PROFESSIONAL ENGINEER, ARCHITECT, LANDSCAPE ARCHITECT OR LAND SURVEYOR TO ALTER AN ITEM IN ANY WAY. IF AN ITEM BEARING THE STAMP OF A LICENSED PROFESSIONAL IS ALTERED, THE ALTERING ENGINEER, ARCHITECT, LANDSCAPE ARCHITECT OR LAND SURVEYOR SHALL STAMP THE DOCUMENT AND INCLUDE THE NOTATION "ALTERED BY" FOLLOWED BY THEIR SIGNATURE, THE DATE OF SUCH ALTERATION, AND A SPECIFIC DESCRIPTION OF THE ALTERATION.

					\sim L
					SEGM
0	07/28/2023	ISSUED FOR CONSTRUCTION SUBMISSION	MS	BD	


No. DATE SUBMITTAL / REVISION DESCRIPTION


CHAMPLAIN HUDSON POWER EXPRESS	
CHAMPLAIN HUDSON POWER EXPRESS	
EGMENT 7 (PACKAGE 4B) - CSX - PAN AM SOUTHERN	
WORK ZONE TRAFFIC CONTROL DETAILS	

KIEWIT PROJECT NO. 21162 KC PROJECT NO. 120174 DRAWING NO.

C-504


07/26/2023 OF 0 SH.NO.

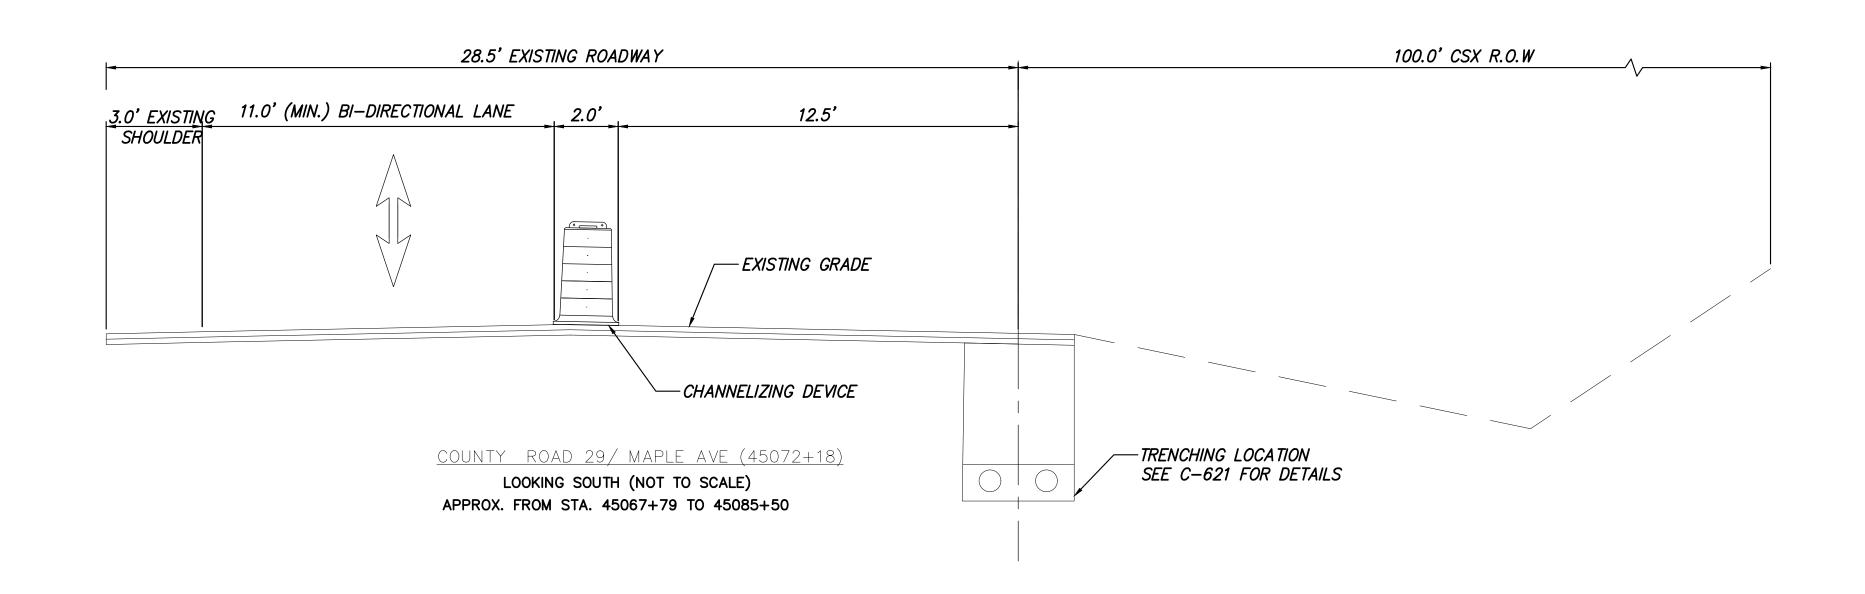

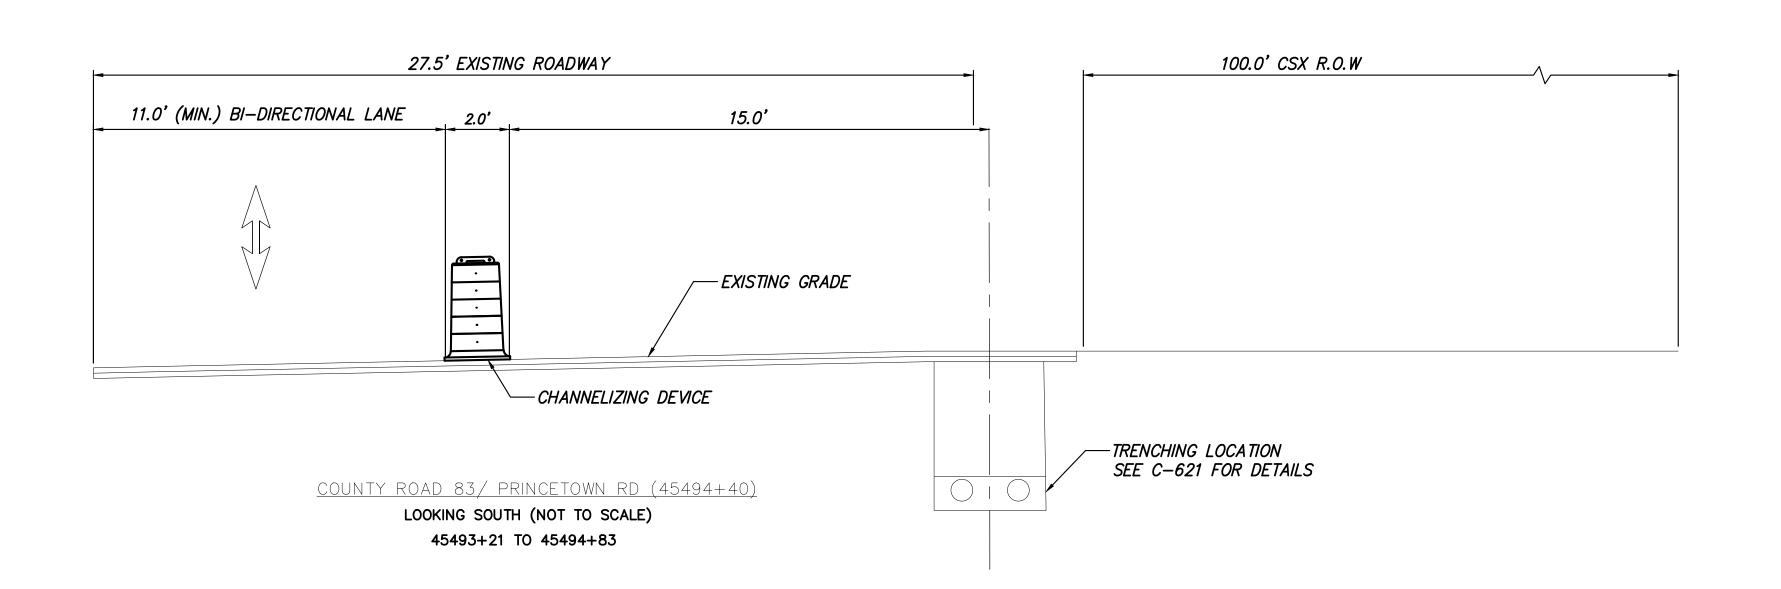





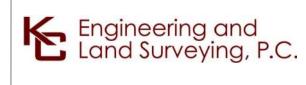



IT IS A VIOLATION OF LAW FOR ANY PERSON, UNLESS THEY ARE ACTING UNDER THE DIRECTION OF A LICENSED PROFESSIONAL ENGINEER, ARCHITECT, LANDSCAPE ARCHITECT OR LAND SURVEYOR TO ALTER AN ITEM IN ANY WAY. IF AN ITEM BEARING THE STAMP OF A LICENSED PROFESSIONAL IS ALTERED, THE ALTERING ENGINEER, ARCHITECT, LANDSCAPE ARCHITECT OR LAND SURVEYOR SHALL STAMP THE DOCUMENT AND INCLUDE THE NOTATION "ALTERED BY" FOLLOWED BY THEIR SIGNATURE, THE DATE OF SUCH ALTERATION, AND A SPECIFIC DESCRIPTION OF THE ALTERATION.


									SON POV	Λ/\Box	\Box
						SEGMENT 7	7 (PACKAG	E 4	1B) - CSX -	PA	N AM S
							WORK ZOI	ΝE	TRAFFIC C	ON	ITROL
-						-	TVD		VI CECTIO	NIC	
-							ITP	10F	AL SECTIO	112	
							Ç	SHE	ET 1 OF 1		
	0	07/28/2023	ISSUED FOR CONSTRUCTION SUBMISSION	MS	BD)			
	No.	DATE	CUDMITTAL / DEVICION DECODIDATION	DB	A DD]					SCALE
	INO.	DATE	SUBMITTAL / REVISION DESCRIPTION		APP	DRAWN BY: MS	DESIGNED BY:	MS	APPROVED BY:	BD	REV. NO.


AMPLAIN HUDSON POWER EXPRESS ENT 7 (PACKAGE 4B) - CSX - PAN AM SOUTHERN WORK ZONE TRAFFIC CONTROL TYPICAL SECTIONS SHEET 1 OF 1


KIEWIT PROJECT NO. 21162 KC PROJECT NO. 120174 DRAWING NO.

C-505


0 SH.NO.

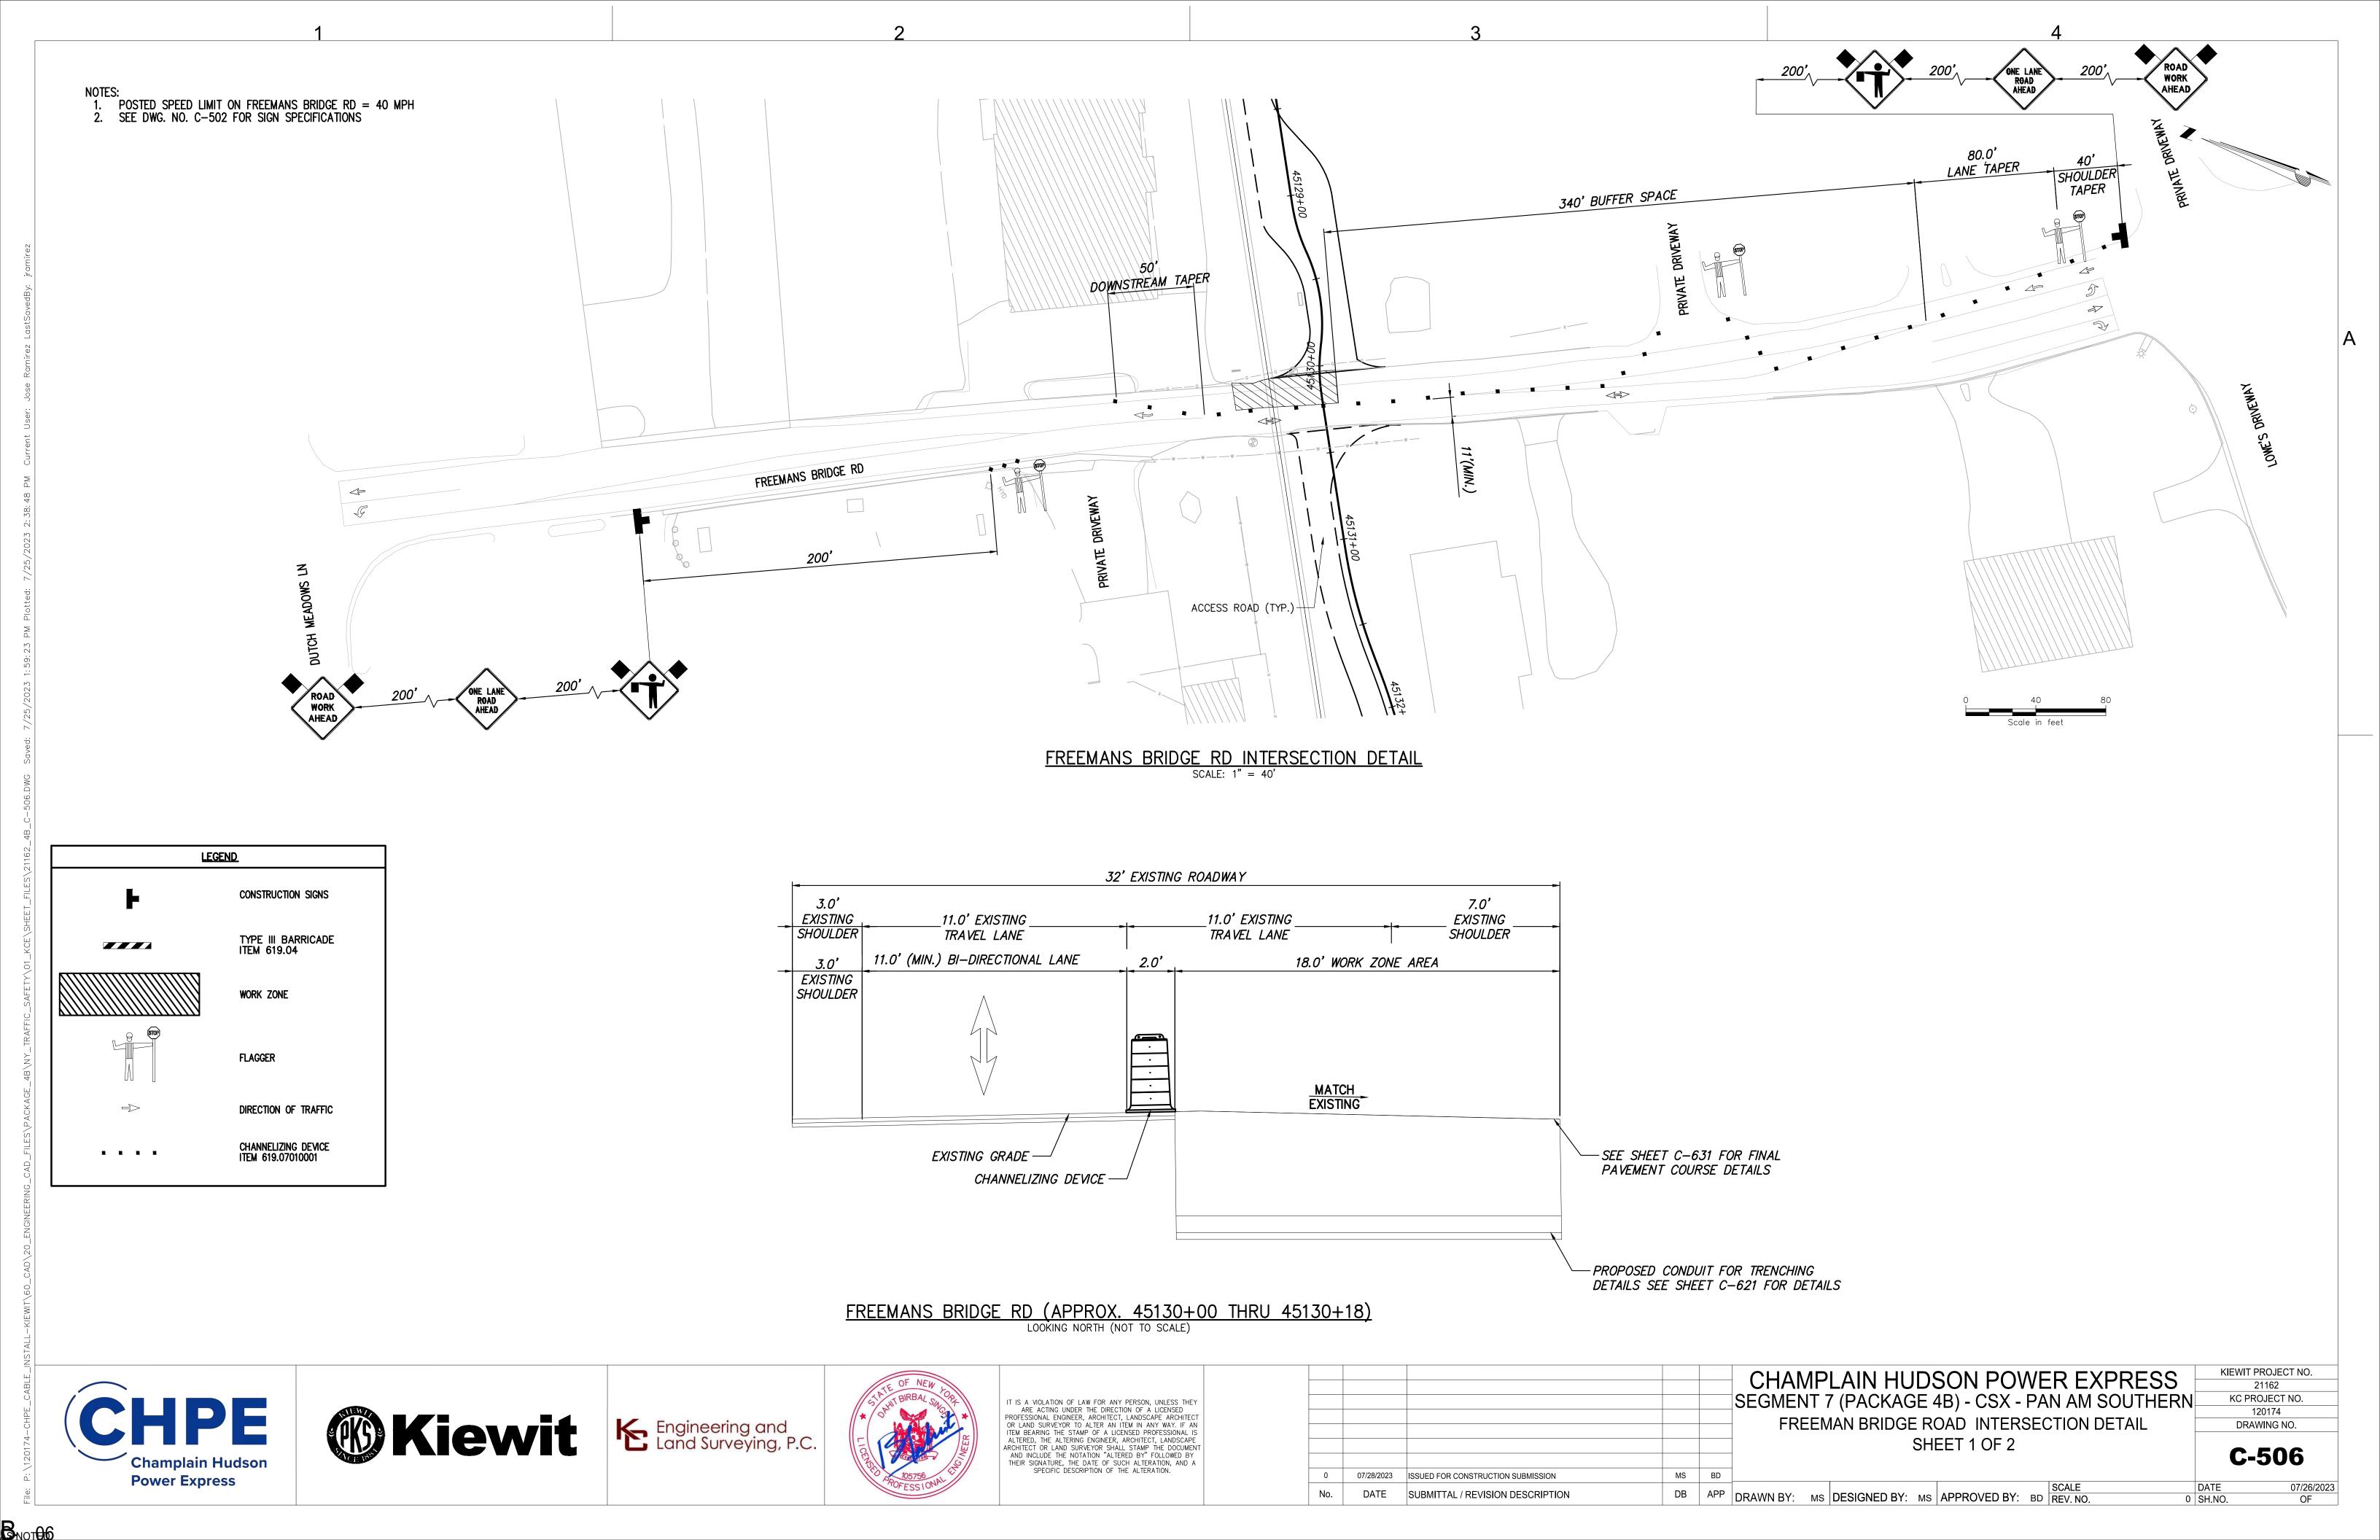

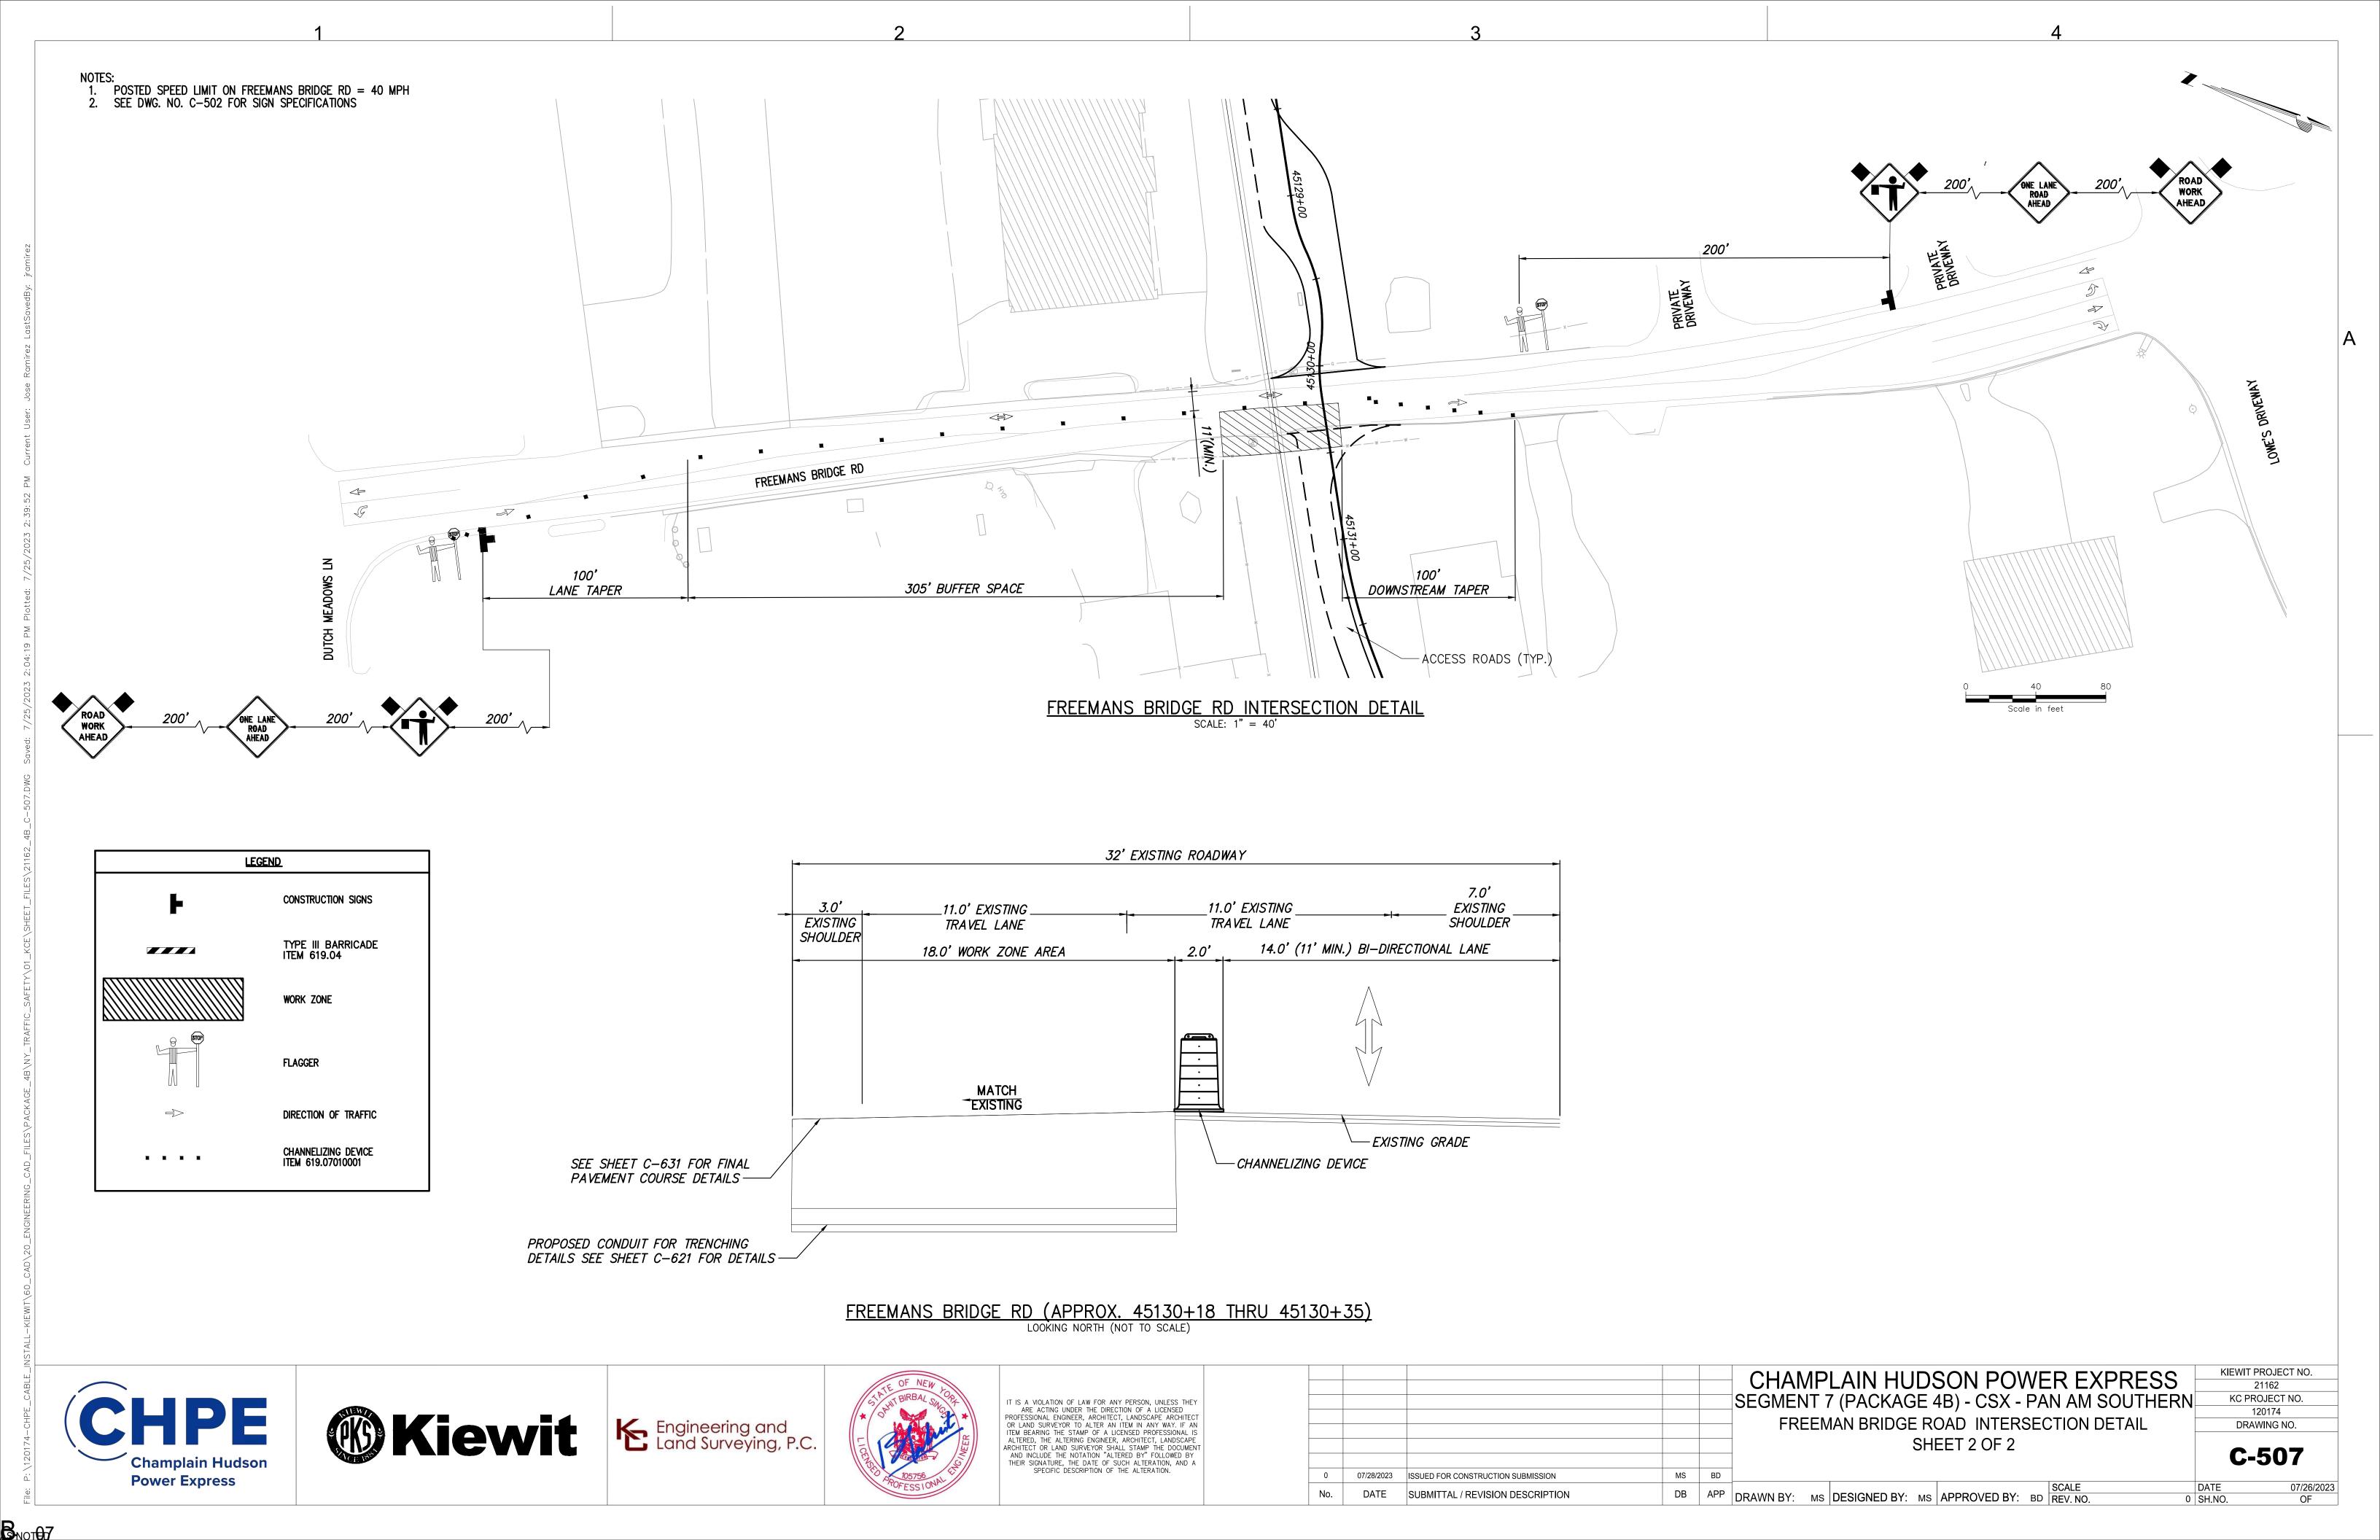


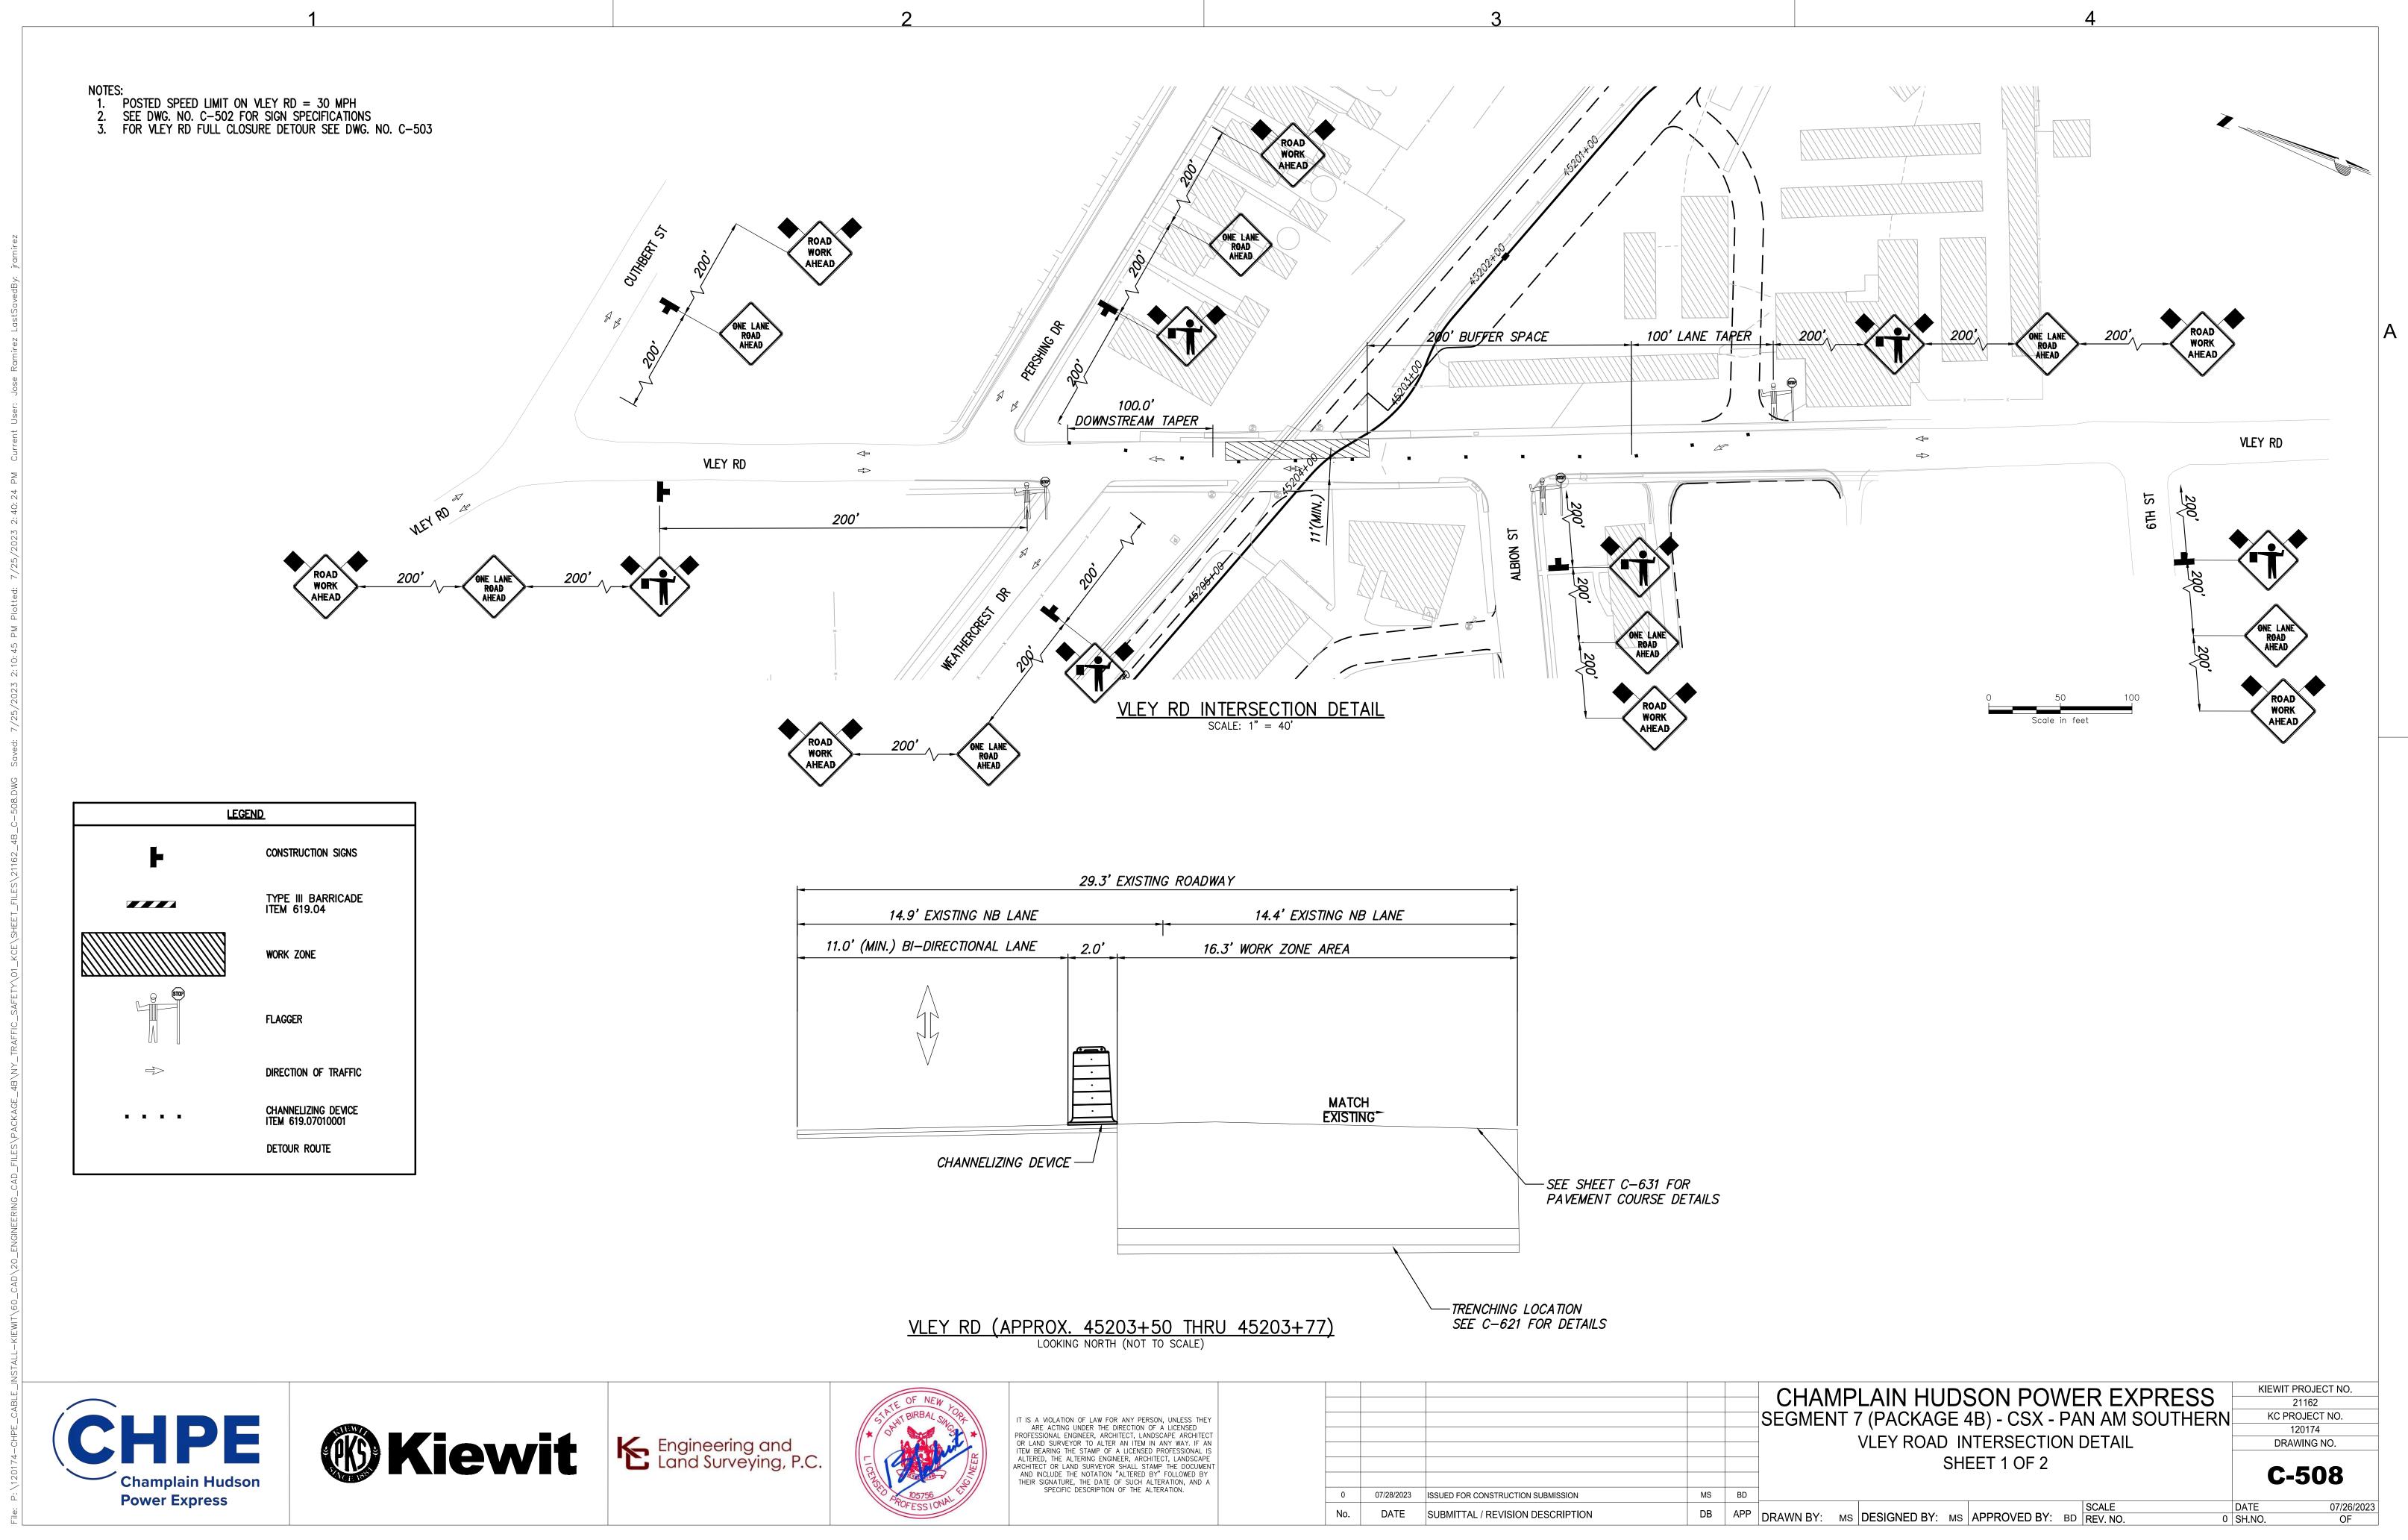


Buoth

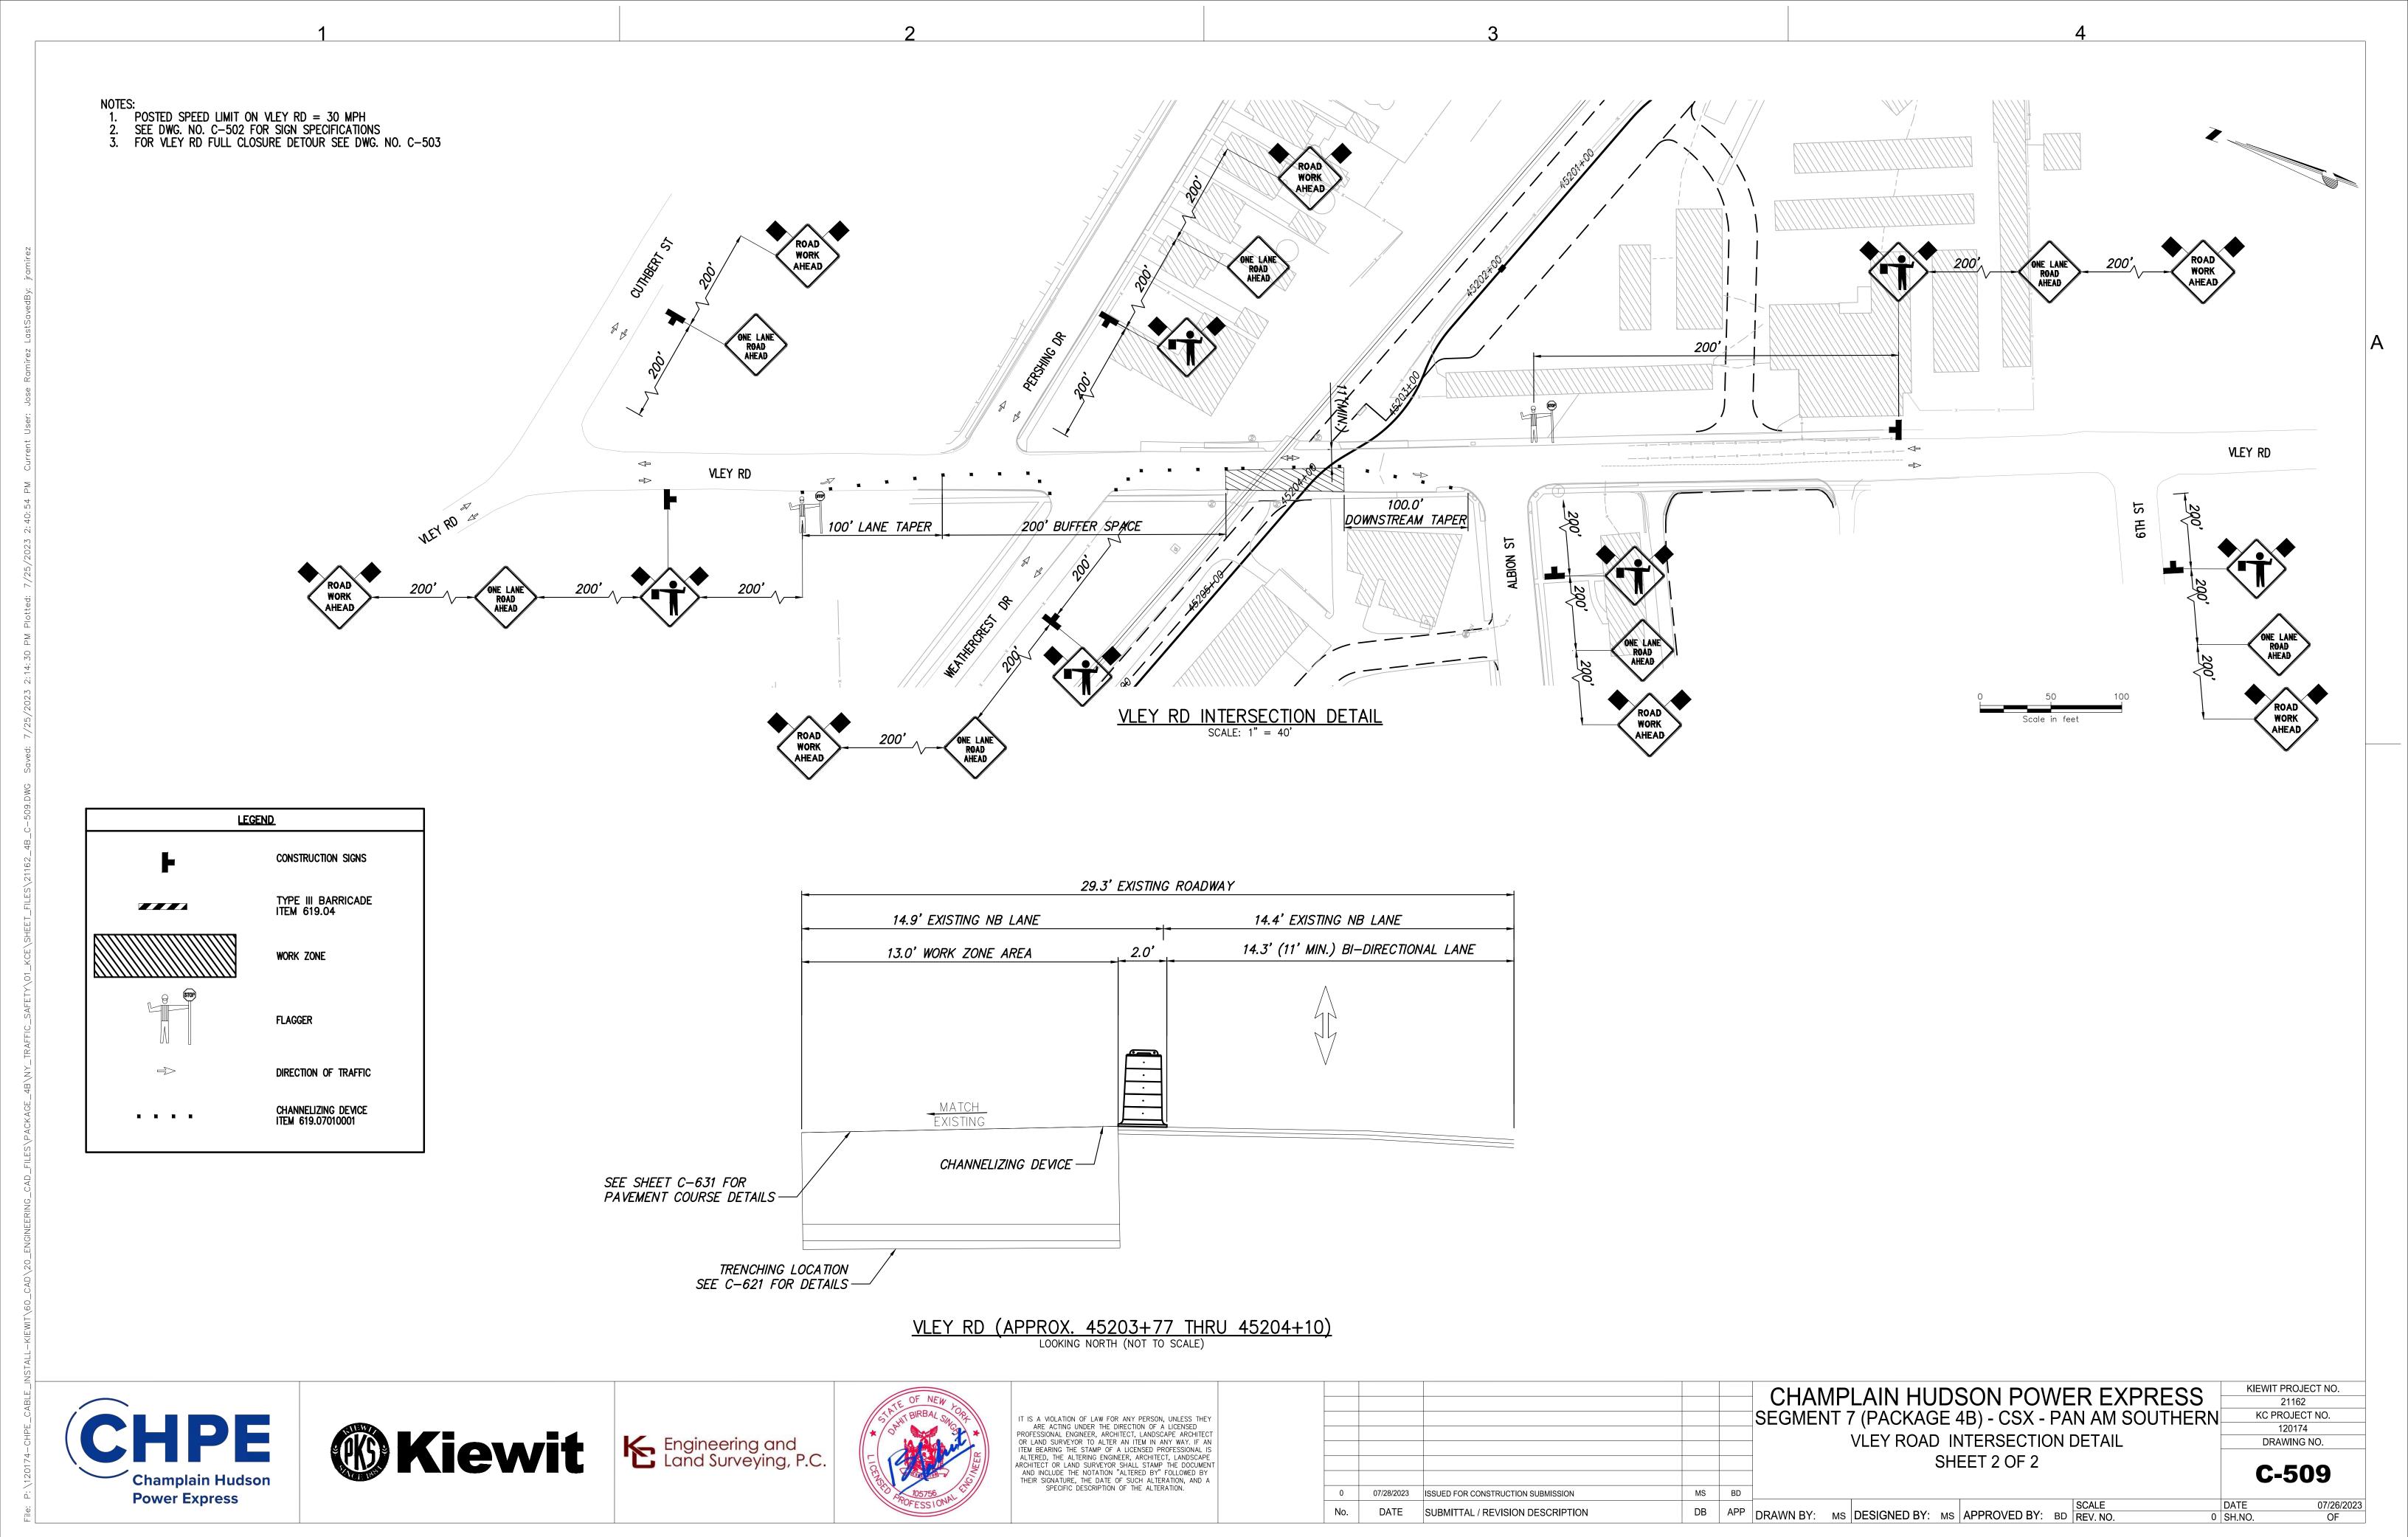


BNOTE

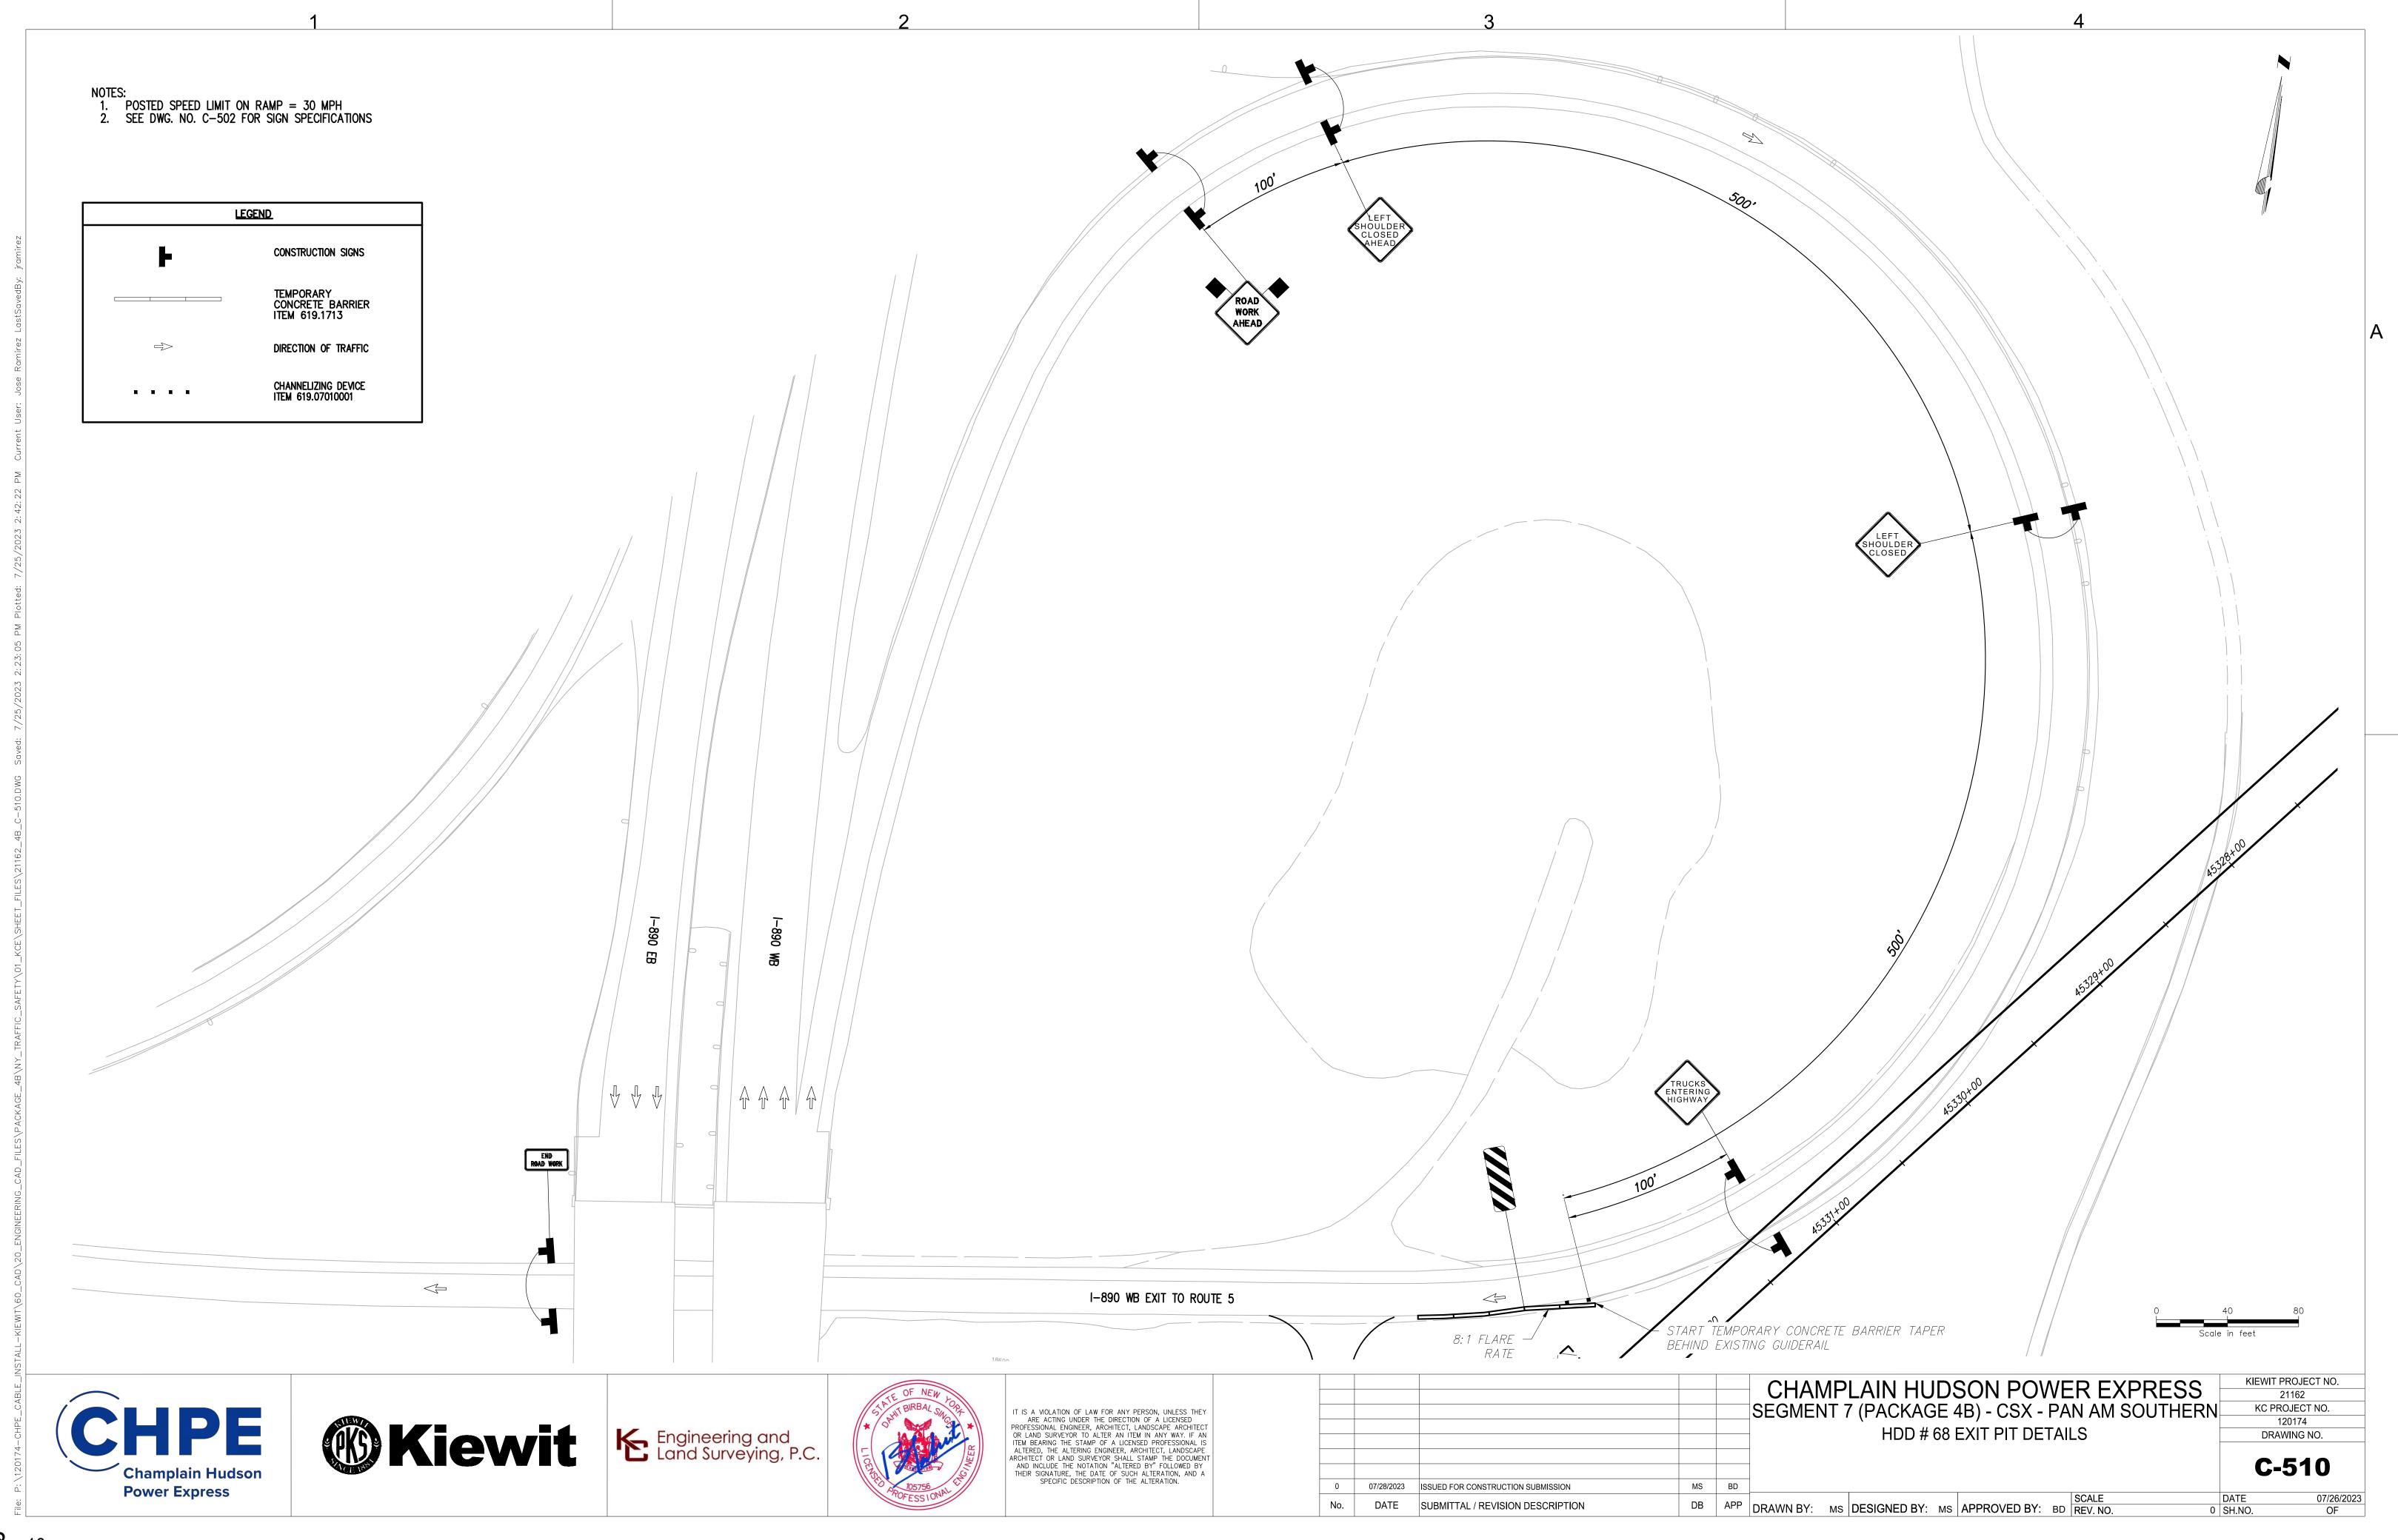

RUCTAR

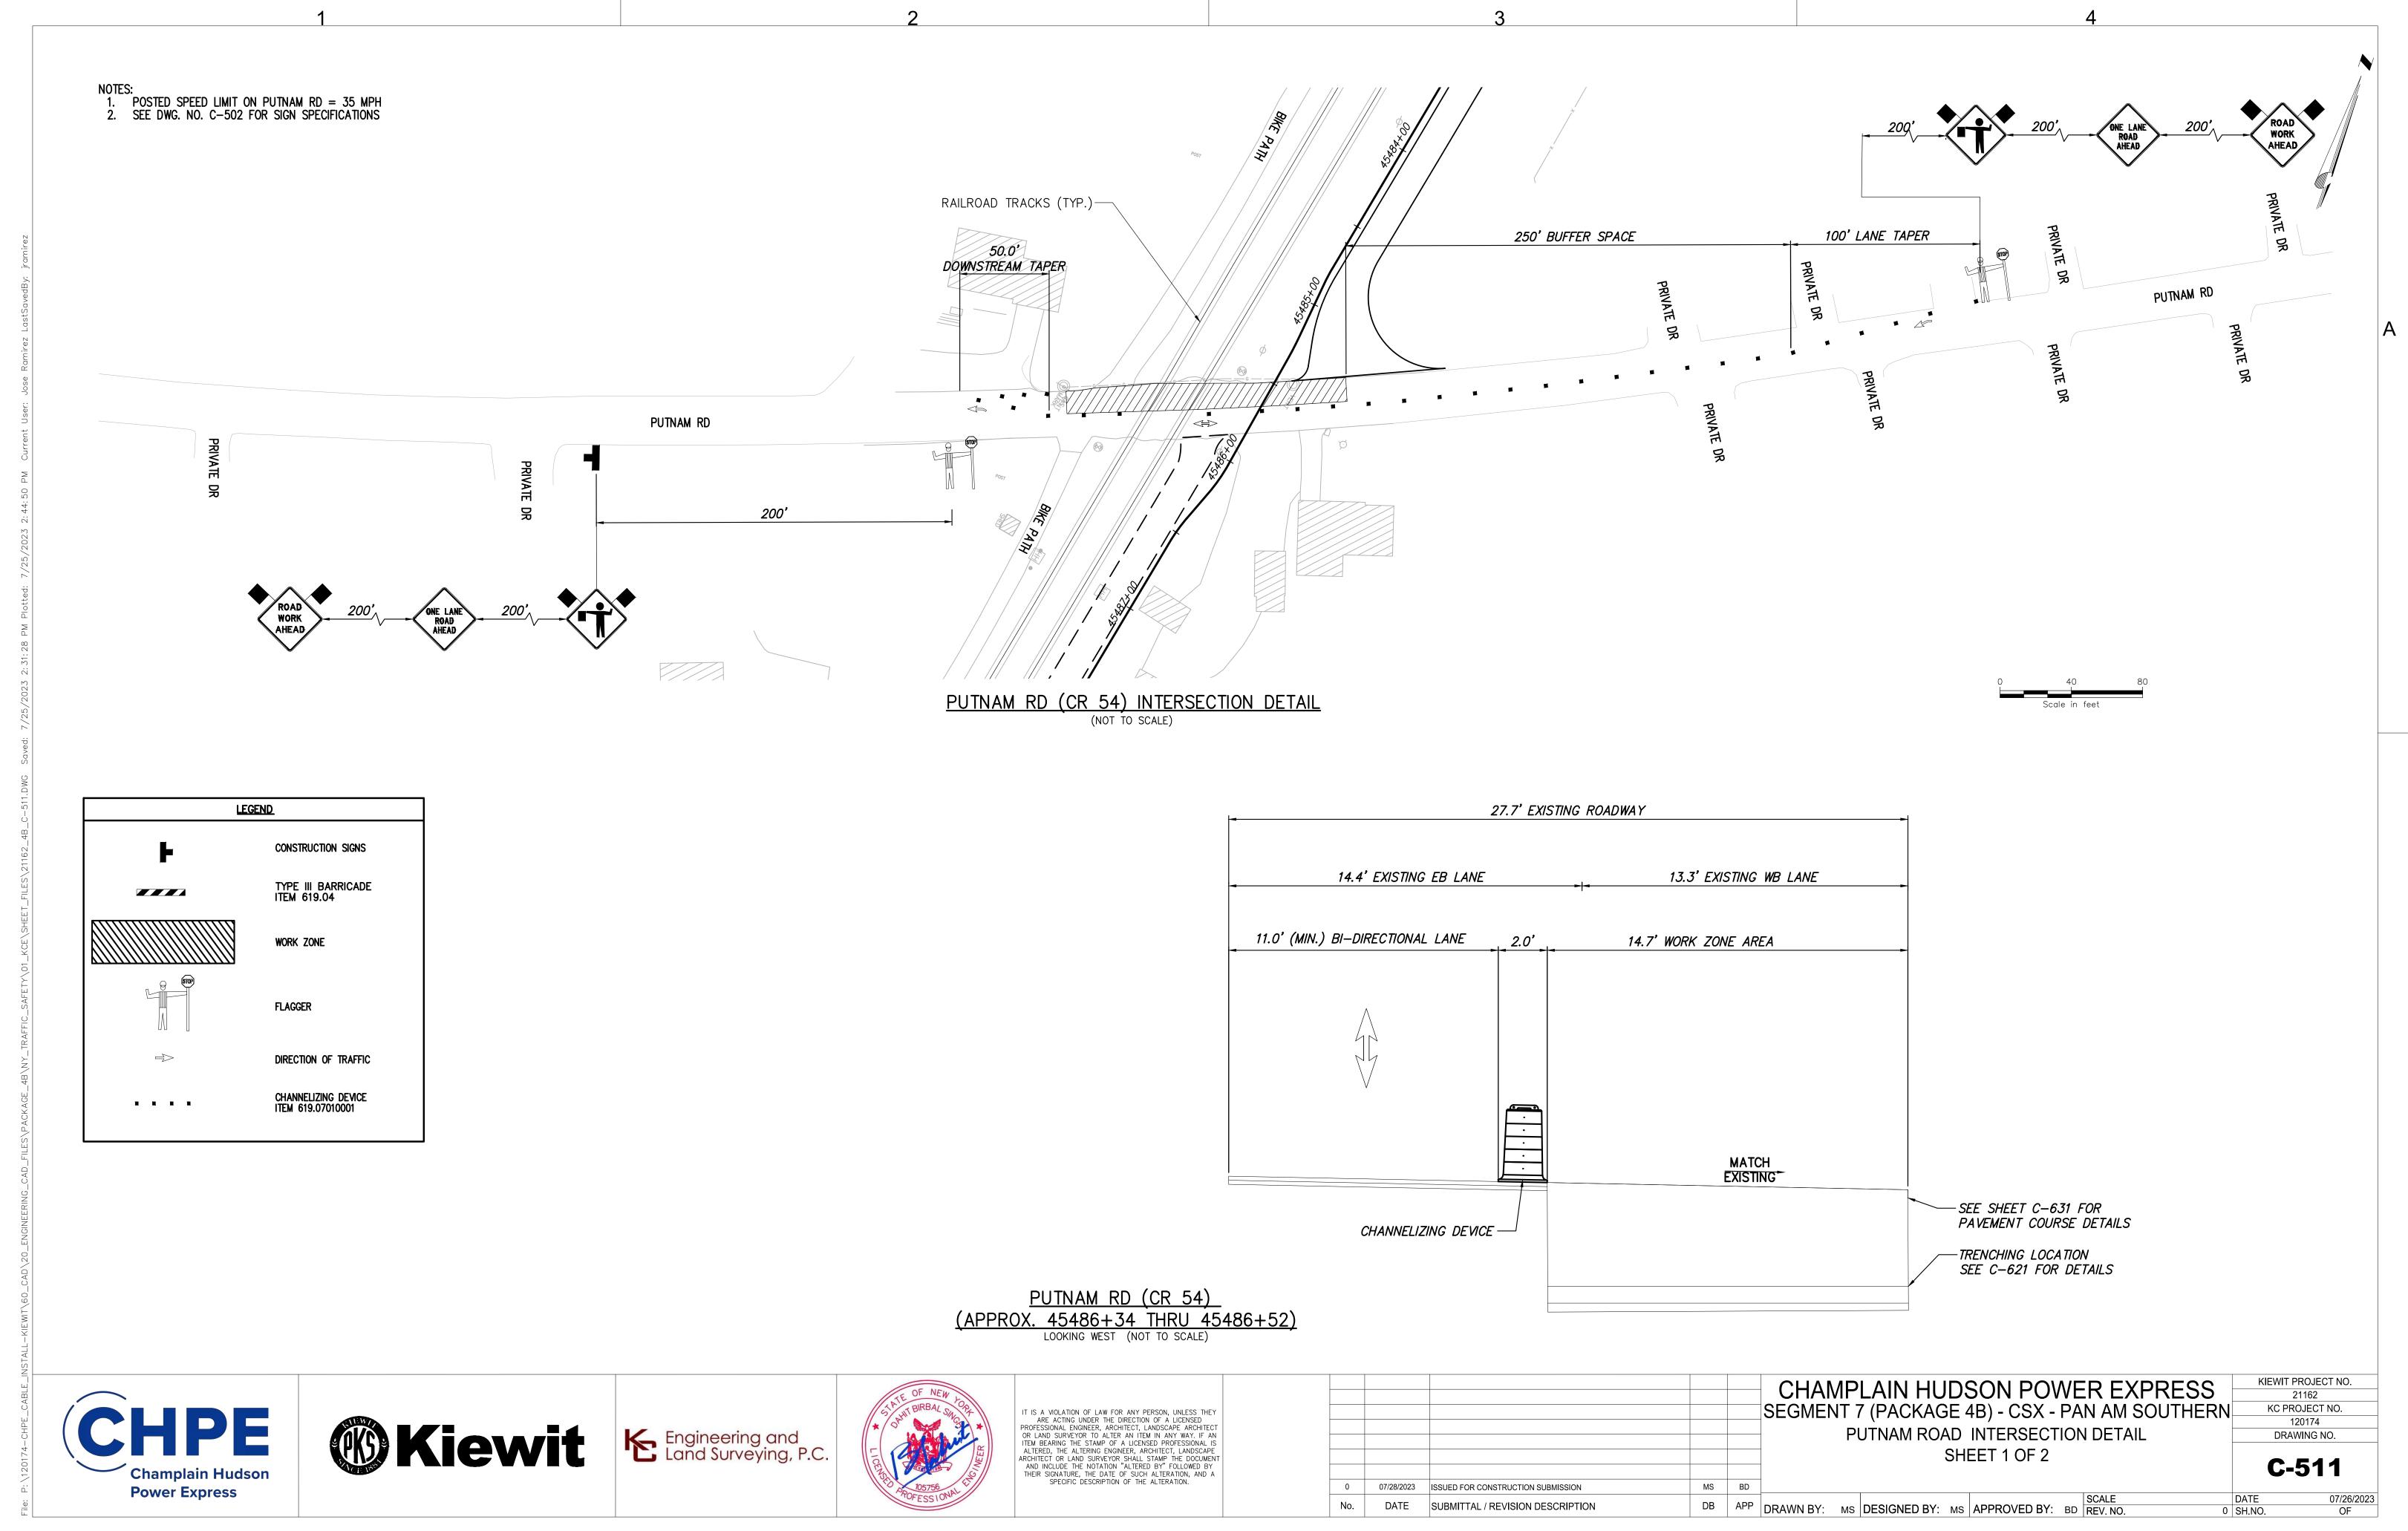

R_{NOT}1

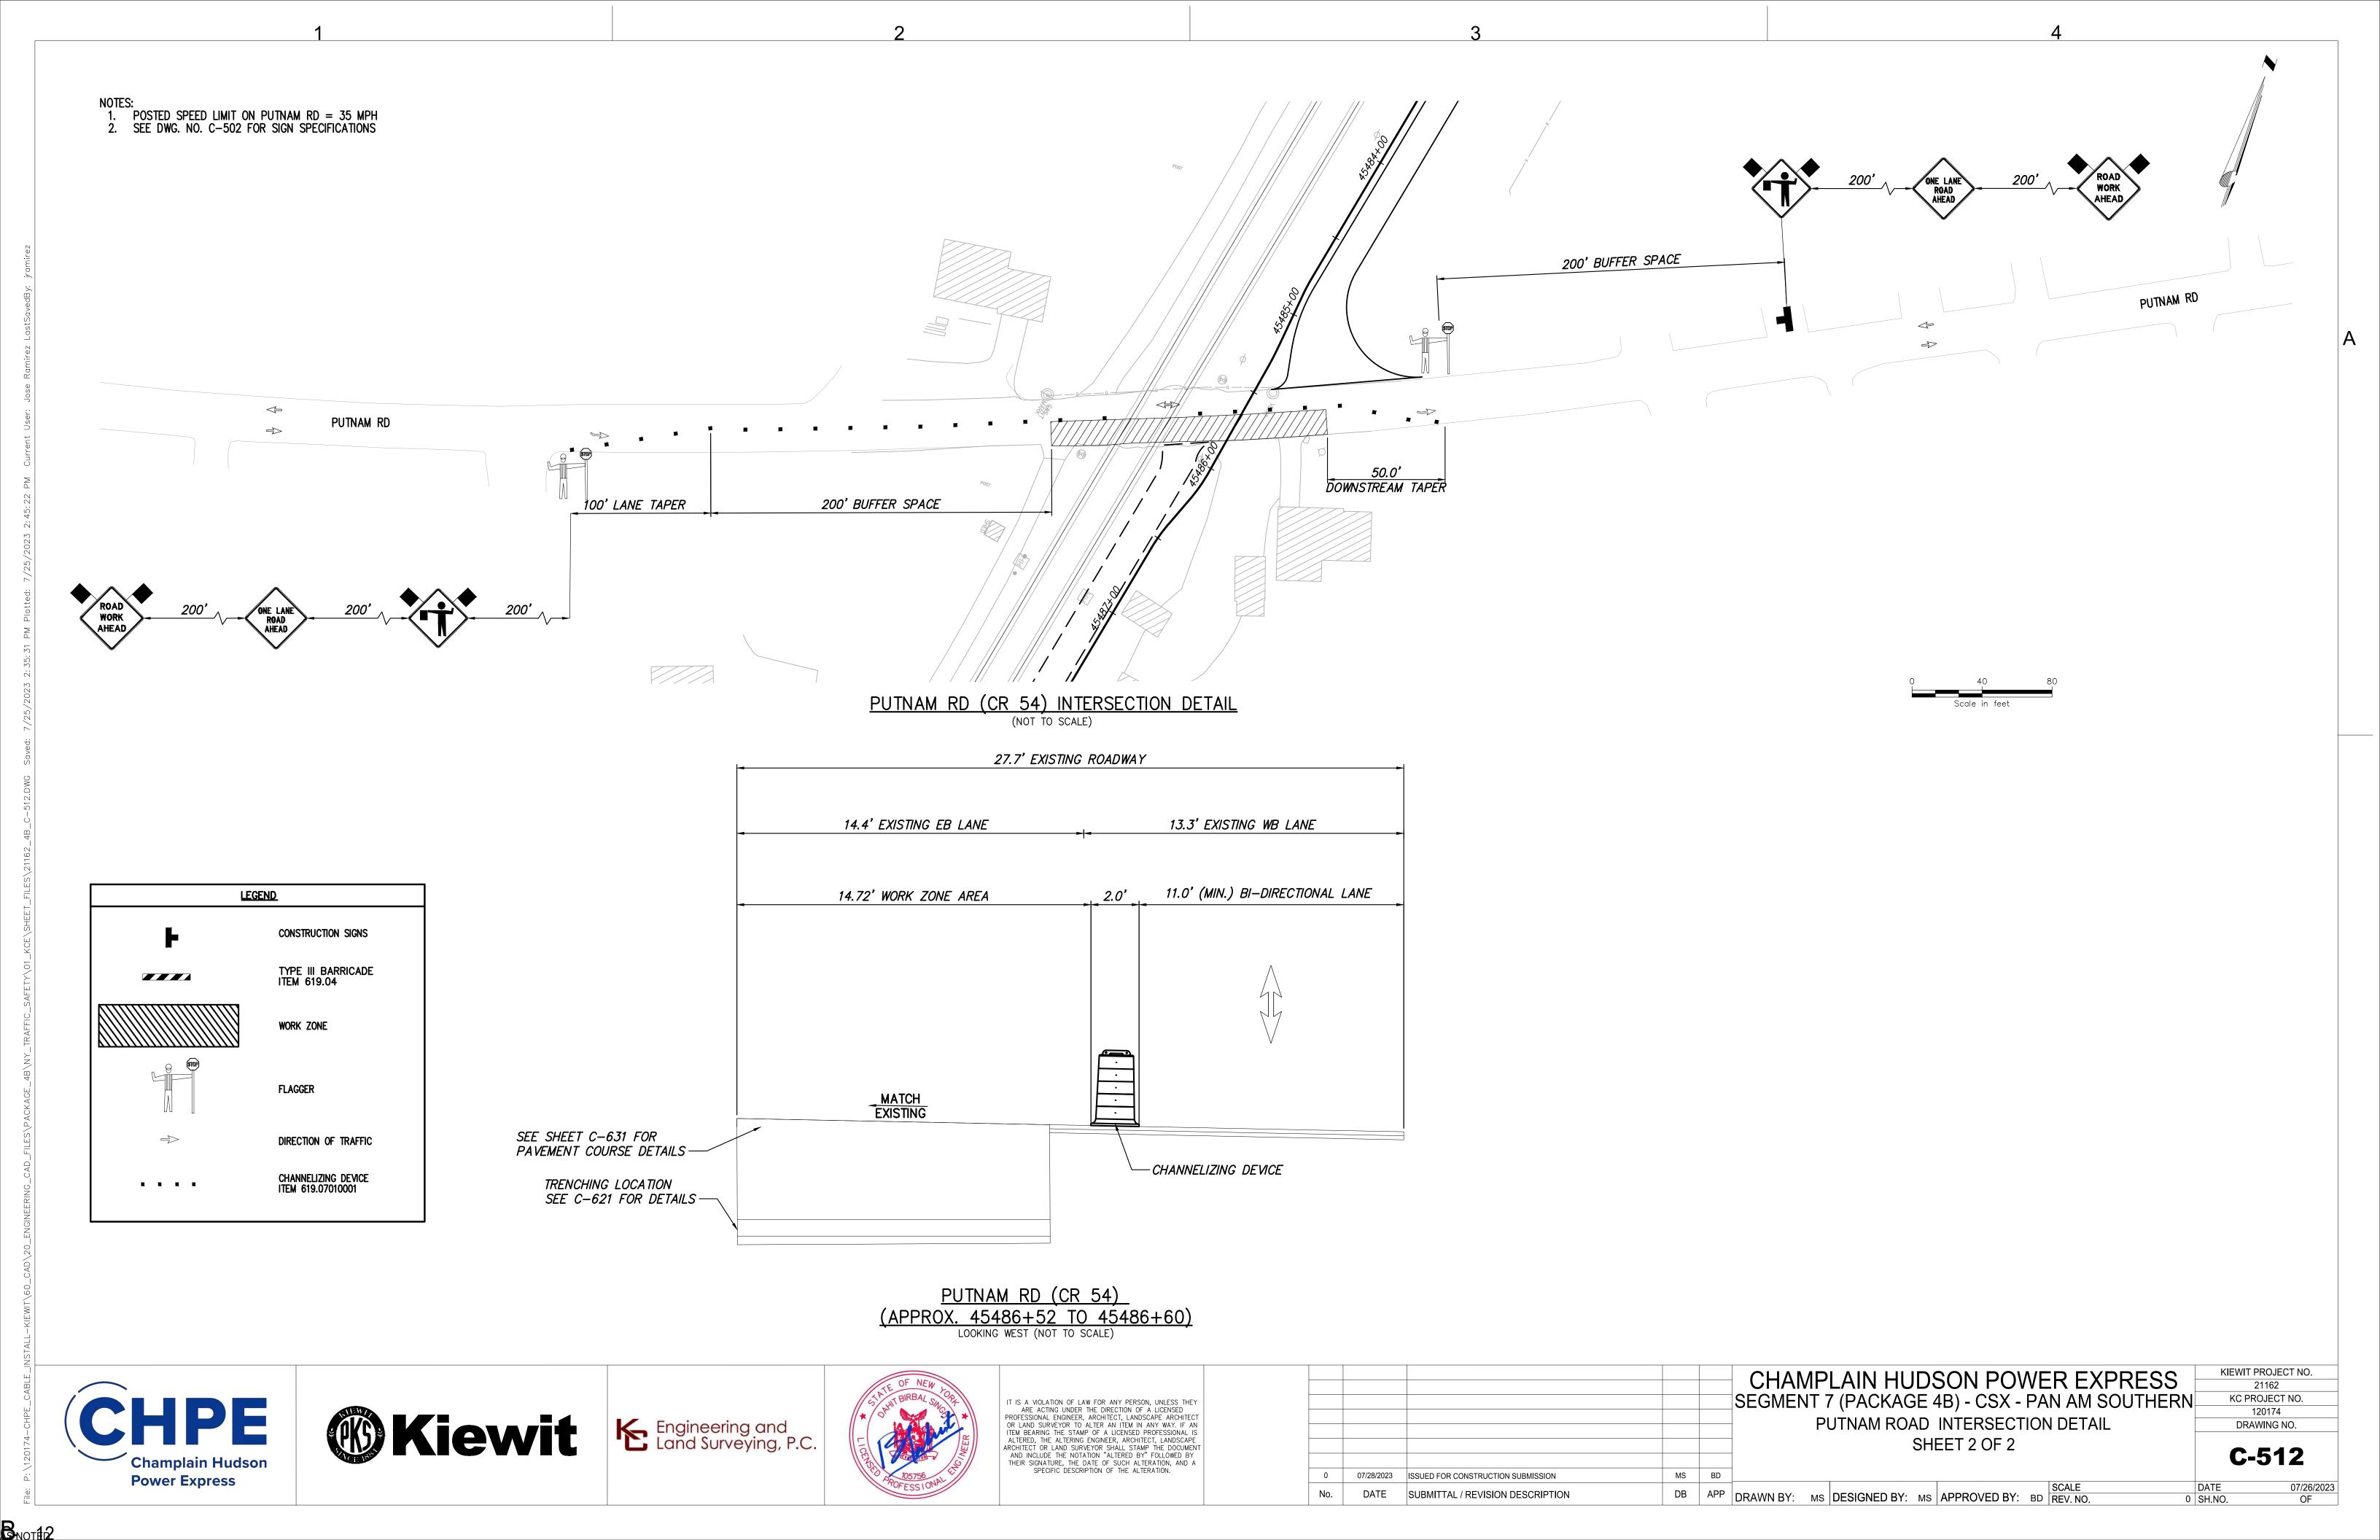


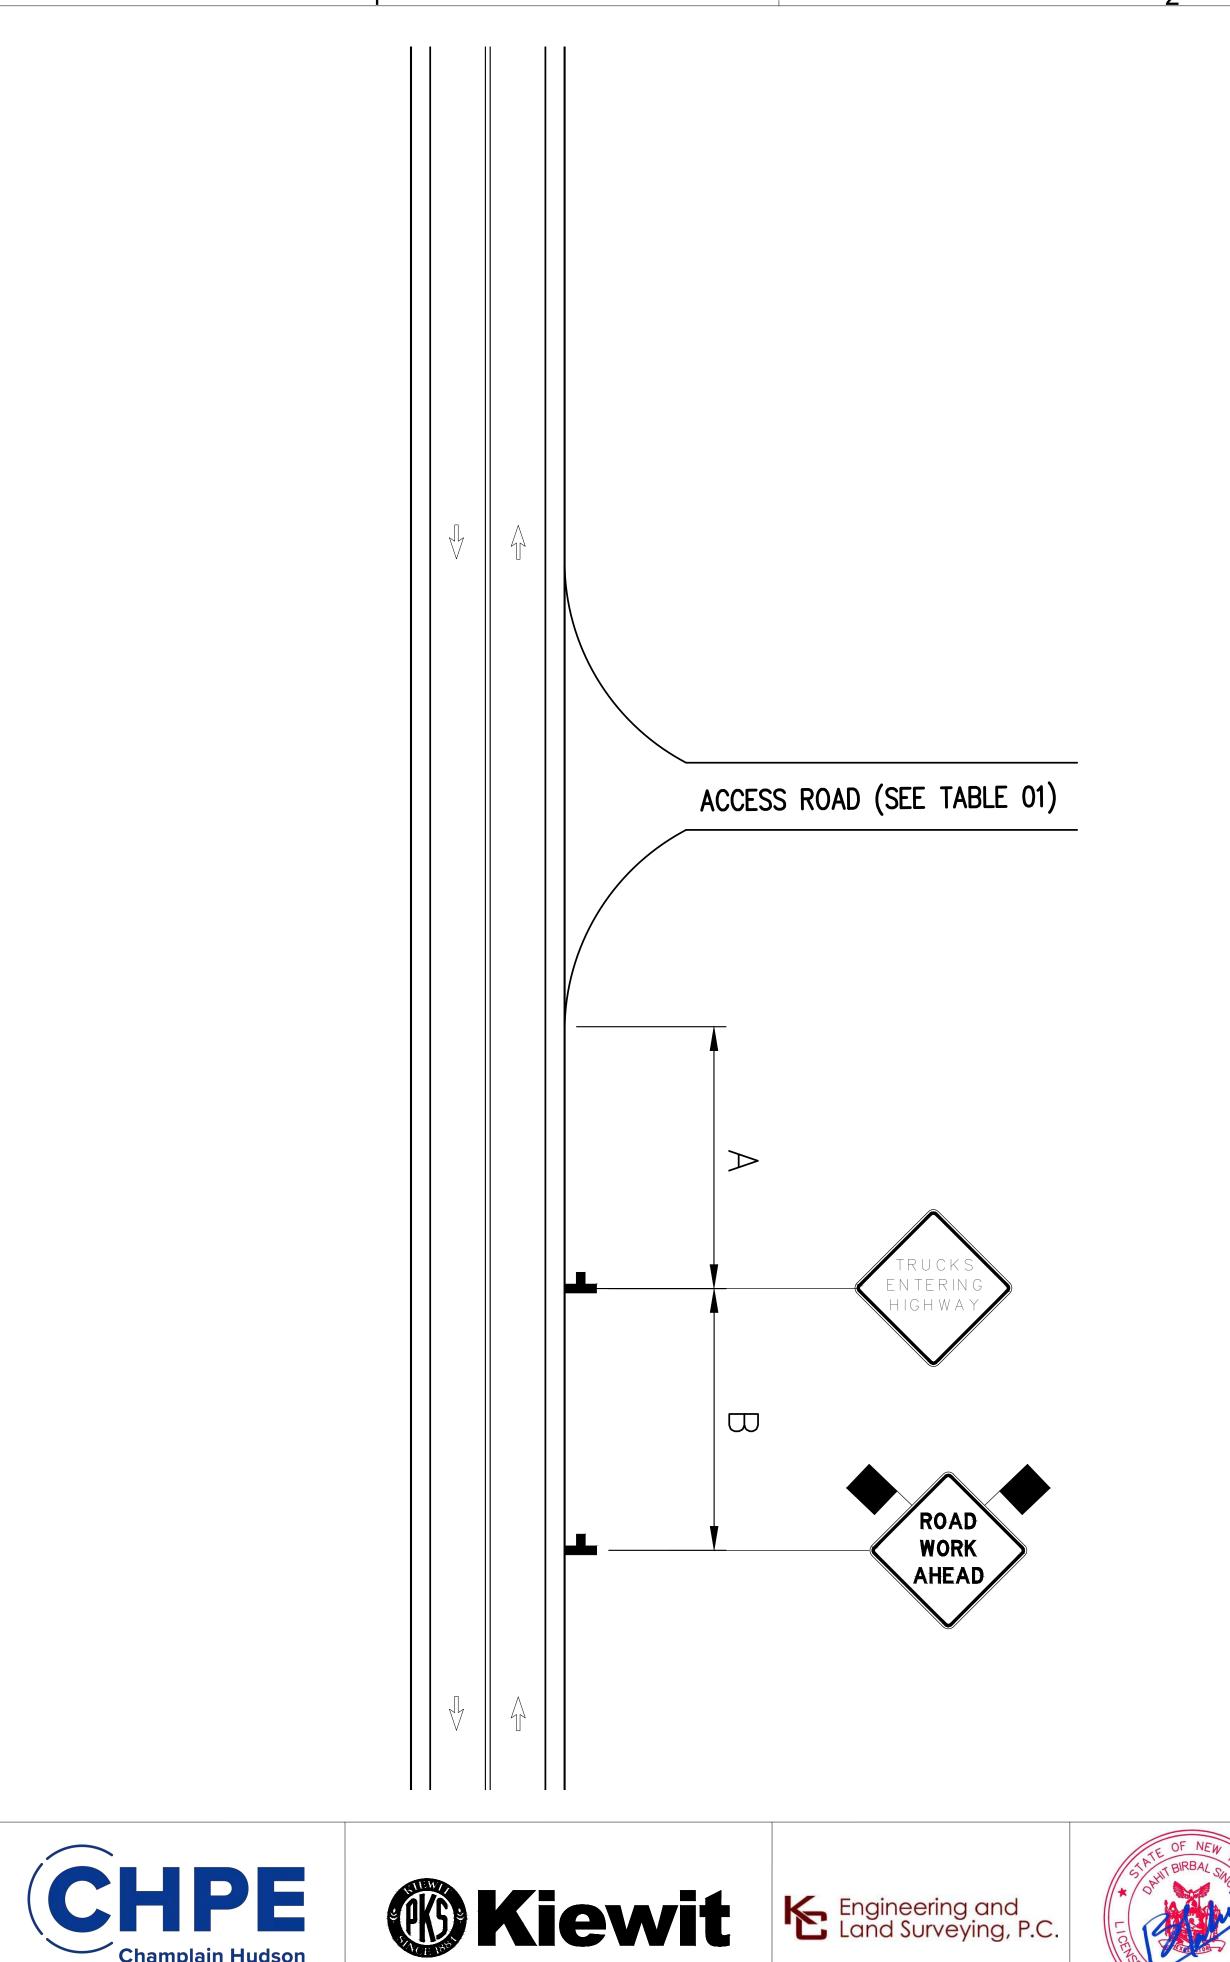


	TABLE 01	
ACCESS ROAD	APPROX. STATION	OFFSET
MAPLE AVE	45004+18	0
VALLEYWOOD DR	45028+47	158.62 RT
RONALD REGAN WAY	45064+88	65.08 LT
MAPLE AVE	45069+03	24.21 LT
MAPLE AVE	45088+38	134.88 LT
FREEMANS BRIDGE RD	45130+21	0
VLEY RD	45203+94	11.82 LT
ZOAR CT	45203+41	166.75 LT
CRAIGIE AVE	45229+51	52.53 LT
SACANDAGA RD	45234+75	16.18 LT
C STREET	45275+57	512.57 LT
B STREET	45282+73	485.50 LT
AMSTERDAM AVE	45315+93	29.38 RT
I-81 EXIT RAMP TO RTE 5	45300+34	152.49 RT
SCHERMERHORN RD	45431+86	1348.94 LT
PUTNAM RD	45485+76	0

ADVANCED WARNING SIGN SPACING							
	DISTANCE BETWEEN SIGNS						
ROADWAY SPEED LIMIT	Α	В	С				
≤ 30 MPH	100	100	100				
35-40 MPH	200	200	200				
≥ 45 MPH	350	350	350				


NOTES:

1. SEE DRAWING NO. C-502 FOR SIGN SPECIFICATIONS

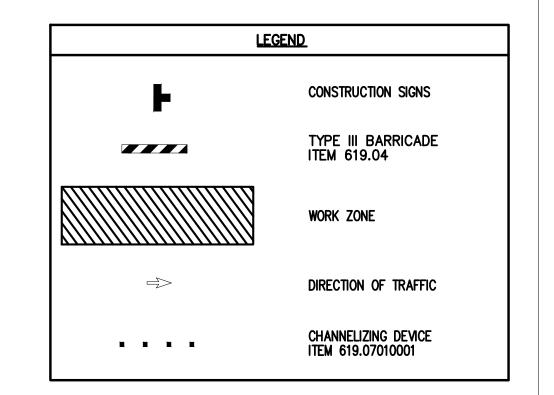





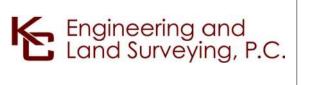




IT IS A VIOLATION OF LAW FOR ANY PERSON, UNLESS THEY ARE ACTING UNDER THE DIRECTION OF A LICENSED PROFESSIONAL ENGINEER, ARCHITECT, LANDSCAPE ARCHITECT OR LAND SURVEYOR TO ALTER AN ITEM IN ANY WAY. IF AN ITEM BEARING THE STAMP OF A LICENSED PROFESSIONAL IS ALTERED, THE ALTERING ENGINEER, ARCHITECT, LANDSCAPE ARCHITECT OR LAND SURVEYOR SHALL STAMP THE DOCUMENT AND INCLUDE THE NOTATION "ALTERED BY" FOLLOWED BY THEIR SIGNATURE, THE DATE OF SUCH ALTERATION, AND A SPECIFIC DESCRIPTION OF THE ALTERATION.

0	07/28/2023	ISSUED FOR CONSTRUCTION SUBMISSION	MS	BD	CHAMPLAIN HUDSON POWER EXPRESS SEGMENT 7 (PACKAGE 4B) - CSX - PAN AM SOUTHERN WORK ZONE TRAFFIC CONTROL DETAILS ACCESS ROAD MPT	
No.	DATE	SUBMITTAL / REVISION DESCRIPTION	DB	APP	SCALE SCALE	DA
1,10.	DATE	OUDIVITIAL / NEVIOION DESCRIPTION		/ \	DRAWN BY: MS DESIGNED BY: MS APPROVED BY: BD REV. NO. 0	SH

KIEWIT PROJECT NO. 21162 KC PROJECT NO. 120174 DRAWING NO.

C-513 DATE 0 SH.NO. 07/26/2023 OF

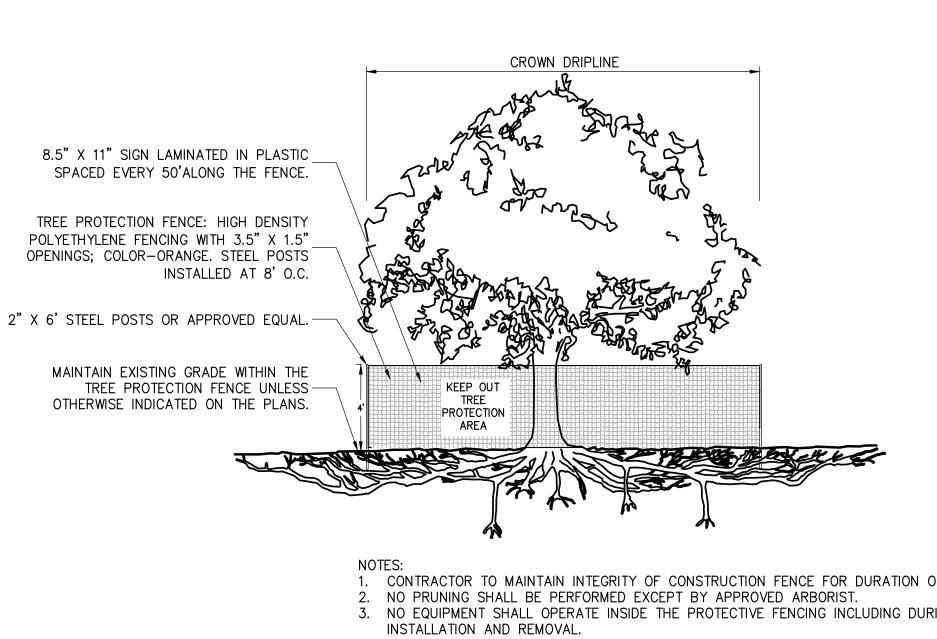


1. CONTRACTOR TO MAINTAIN INTEGRITY OF CONSTRUCTION FENCE FOR DURATION OF PROJECT.

3. NO EQUIPMENT SHALL OPERATE INSIDE THE PROTECTIVE FENCING INCLUDING DURING FENCE

4. SEE EROSION CONTROL PLANS FOR LOCATIONS OF TREE PROTECTION AREAS.


TREE PROTECTION

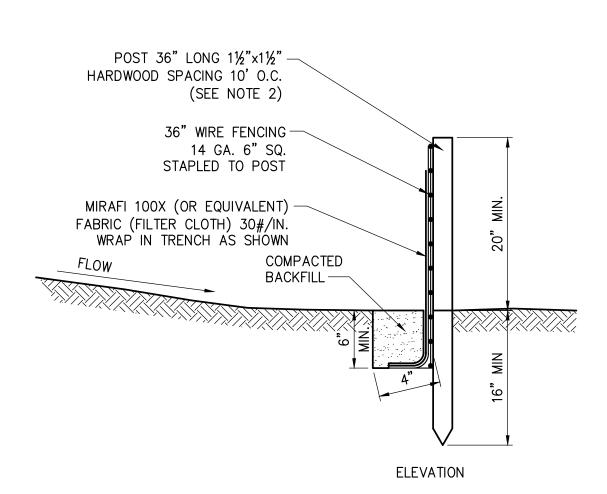

SILT FENCE


SCALE: N.T.S.

- 1. TIE FABRIC TO WIRE FENCE IN ACCORDANCE WITH MANUFACTURERS RECOMMENDATIONS.
- 2. IF EXTRA STRENGTH FABRIC (GREATER THAN 50#/INCH) IS USED, WIRE CAN BE DELETED IF POST SPACING IS REDUCED TO 6' O.C.
- 3. AT THE ENDS OF THE FENCING THE FIRST 20' SHALL BE TURNED UP THE SLOPE 2'.
- POSTS SHOULD BE INCLINED TOWARD THE DIRECTION FLOW CAME
- 5. OVERLAP FABRIC A MINIMUM OF 6" AND FOLDED AT JOINTS. ATTACH FILTER FABRIC TO STAKES ALLOWING EXTENSION INTO TRENCH AS SHOWN; SECURE TO STAKES AS NOTED.
- THE MAXIMUM AREA OF RUNOFF PER 100LF. OF FENCE SHALL NOT EXCEED 0.25 ACRES.
- 7. MAINTENANCE SHALL BE PERFORMED AS NECESSARY. THE FENCING SHALL BE CHECKED AFTER EVERY STORM TO ENSURE THEIR PROPER FUNCTIONING.
- WHEN FENCE IS NO LONGER NEEDED, THE ACCUMULATED SILT, THE POSTS AND FABRIC SHALL BE REMOVED AND TRENCH BACK FILLED WITH TOPSOIL AND SEEDED.
- 9. FENCING SHOULD BE PLACED AS SHOWN ON THE DRAWING OR IF NOT SHOWN, 10' BEYOND THE TOE OF THE SLOPE AND AT A SPACING IN ACCORDANCE WITH THE TABLE.
- 10. EXCAVATE TRENCH AS PER DETAIL AND SET POSTS AT 10' O.C.
- 11. BACKFILL WITH COMPACTED, EXCAVATED SOIL FROM TRENCH.

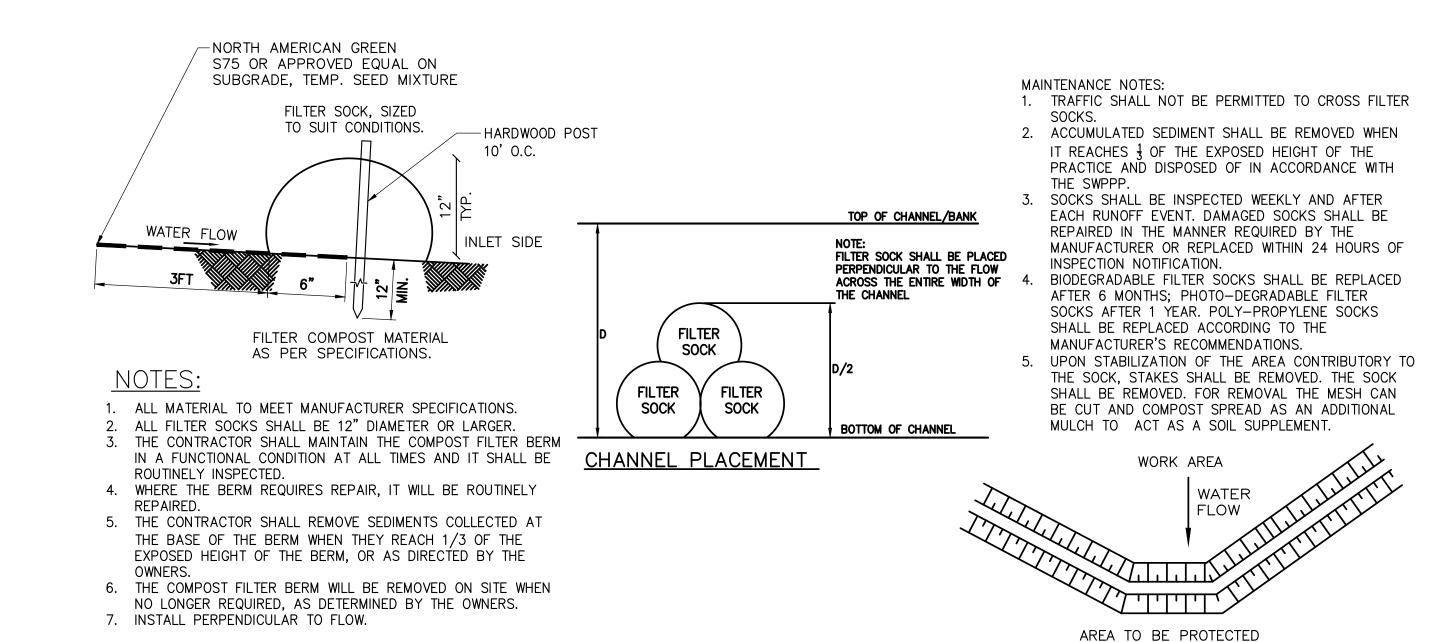


AT GRADE PLACEMENT

COMPOST FILTER SOCK DETAIL

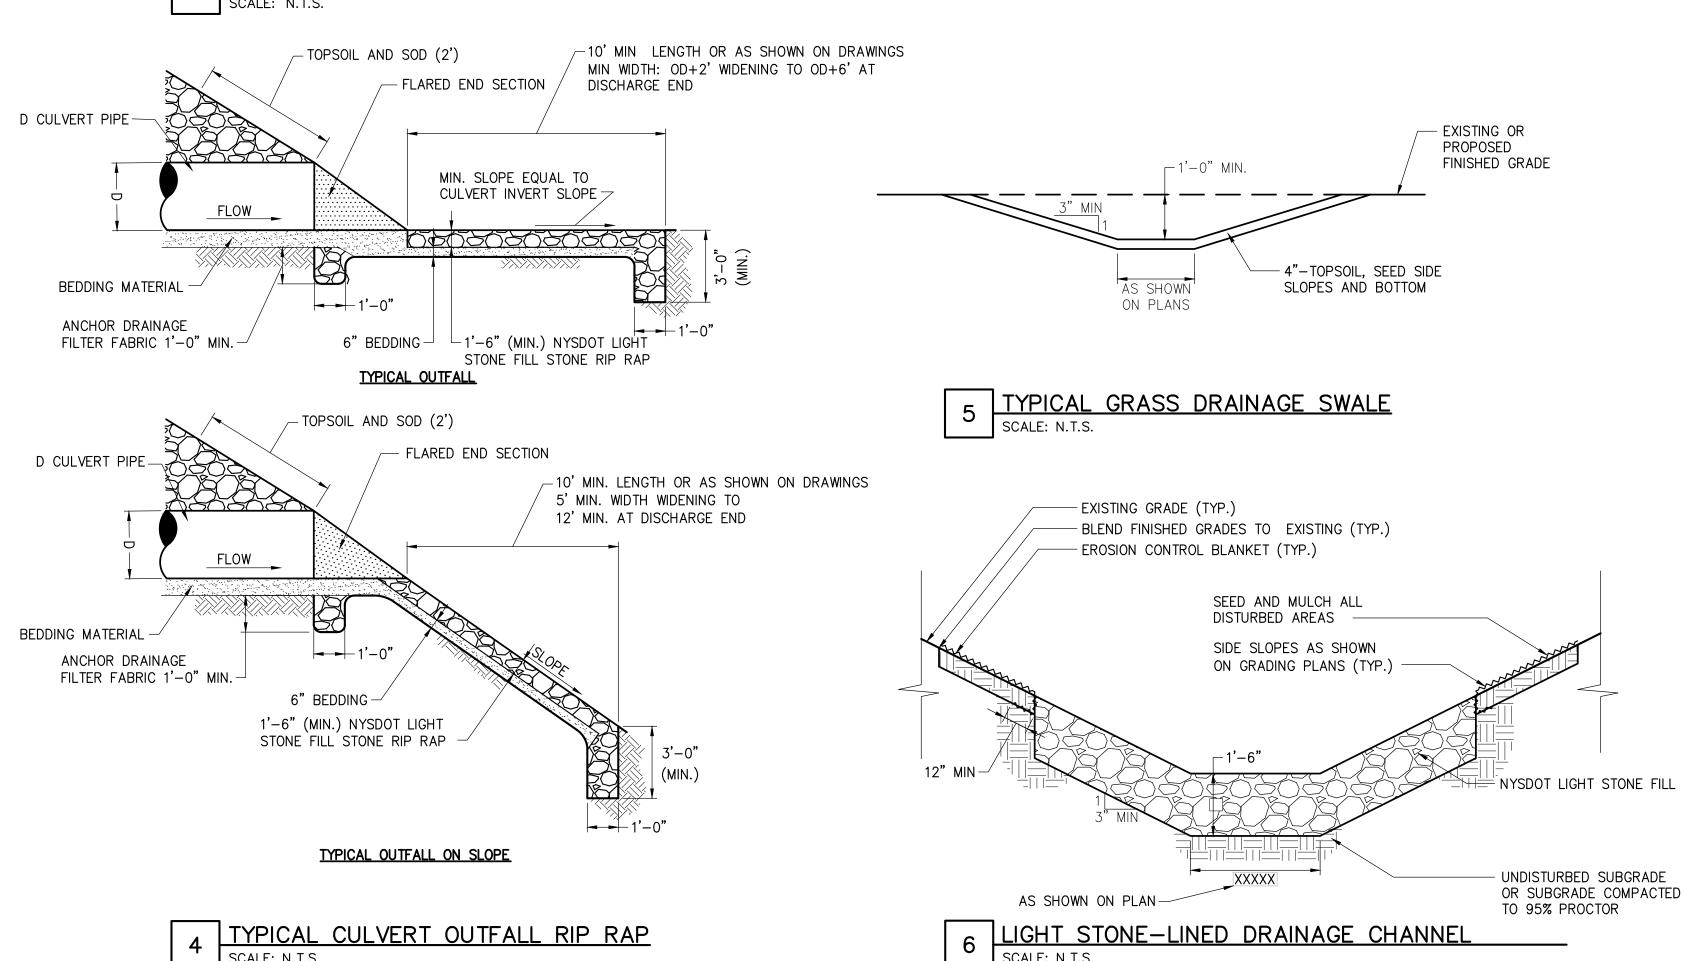


Champlain Hudson Power Express



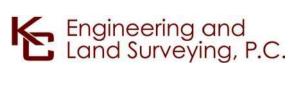



IT IS A VIOLATION OF LAW FOR ANY PERSON, UNLESS THEY ARE ACTING UNDER THE DIRECTION OF A LICENSED PROFESSIONAL ENGINEER, ARCHITECT, LANDSCAPE ARCHITECT OR LAND SURVEYOR TO ALTER AN ITEM IN ANY WAY. IF AN ITEM BEARING THE STAMP OF A LICENSED PROFESSIONAL IS ALTERED, THE ALTERING ENGINEER, ARCHITECT, LANDSCAPE ARCHITECT OR LAND SURVEYOR SHALL STAMP THE DOCUMENT AND INCLUDE THE NOTATION "ALTERED BY" FOLLOWED BY THEIR SIGNATURE, THE DATE OF SUCH ALTERATION, AND A SPECIFIC DESCRIPTION OF THE ALTERATION.

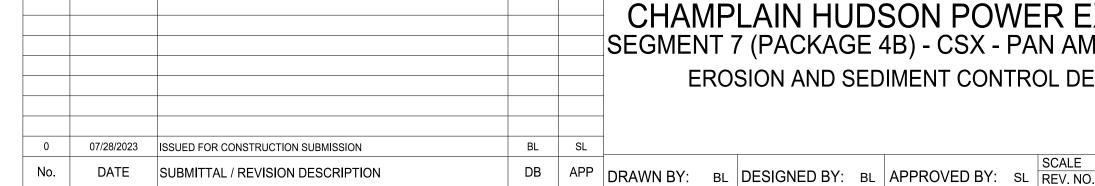

CHAMPLAIN HUDSON POWER EXPRESS SEGMENT 7 (PACKAGE 4B) - CSX - PAN AM SOUTHERN **EROSION AND SEDIMENT CONTROL DETAILS**


KIEWIT PROJECT NO. 21162 KC PROJECT NO. 120174 DRAWING NO.

C-601

07/26/2023

AS NOTED DATE


0 SH.NO.

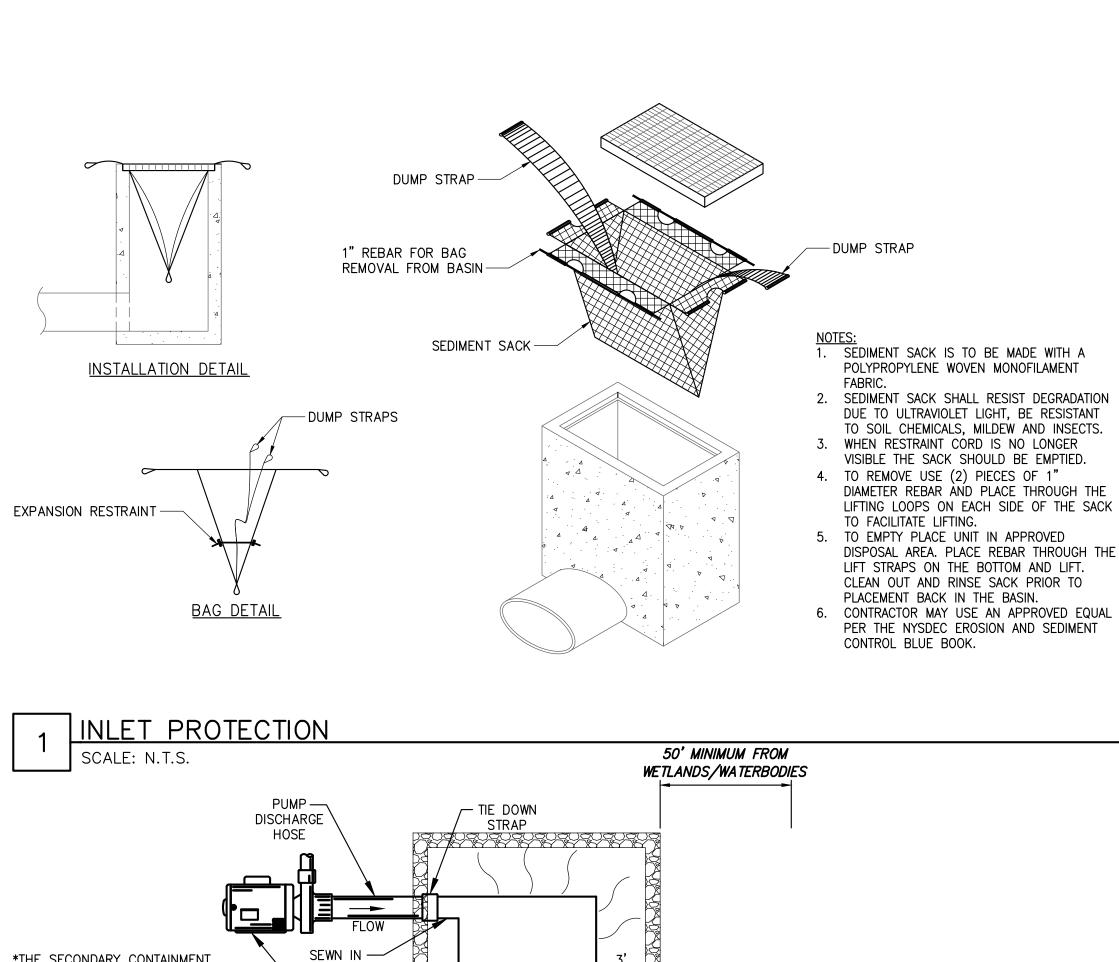


6' LONG 13 GAUGE RUST PROOF -STEEL FENCE POST WITH STABILIZING ANCHOR PLATES -CONSTRUCTION POLYPROPYLENE TWIST ROPE, YELLOW BARRIER ROPE -WARNING SIGN (SEE ADJACENT DETAIL) MAX. (SIGNS SPACED AT 48' ON CENTER±) $^{\perp}$ EXISTING GRADE ELEVATION

1. CONSTRUCTION BARRIER FENCE SHALL BE INSTALLED IN THE LOCATIONS SHOWN ON THE PLANS PRIOR TO BEGINNING ANY WORK ADJACENT TO THESE AREAS.


2. THE CONTRACTOR SHALL INSTALL AT THE BEGINNING OF THE CONTRACT, AND MAINTAIN THROUGHOUT ITS DURATION.

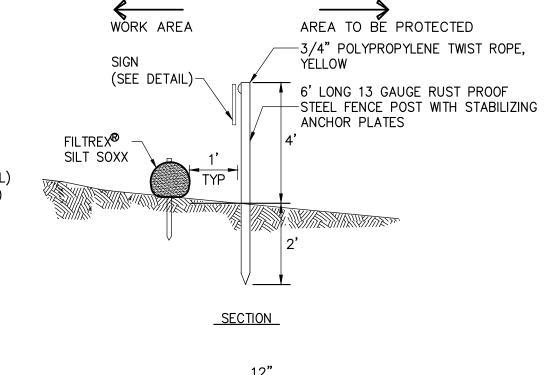

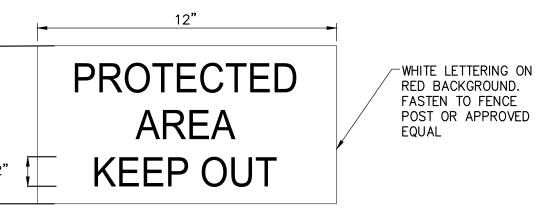

WARNING SIGN DETAIL (OR APPROVED EQUAL)

WETLAND PROTECTION FENCE SCALE: N.T.S.

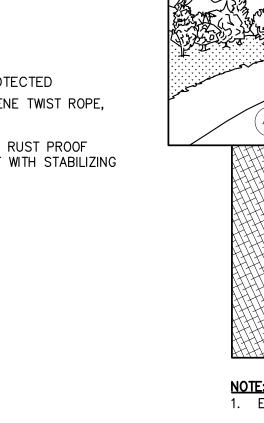

1. EROSION CONTROL BLANKETS TO BE INSTALLED ON SLOPES 3:1 OR GREATER (TYP.)


2. PREPARE SOIL BEFORE INSTALLING BLANKETS, INCLUDING ANY NECESSARY APPLICATION OF LIME, FERTILIZER, AND SEED. NOTE: DO NOT SEED PREPARED AREA. INSTALL WITH PAPER SIDE DOWN. INSTALL ACCORDING TO MANUFACTURERS INSTRUCTIONS.

- 3. BEGIN AT THE TOP OF THE SLOPE BY ANCHORING THE BLANKET IN A 6" DEEP x 6" WIDETRENCH WITH APPROXIMATELY 12" OF BLANKET EXTENDED BEYOND THE UP-SLOPE PORTION OF THE TRENCH. ANCHOR THE BLANKET WITH A ROW OF STAPLES/STAKES APPROXIMATELY 12" APART IN THE BOTTOM OF THE TRENCH. BACKFILL AND COMPACT THE TRENCH AFTER STAPLING. APPLY SEED TO COMPACTED SOIL AND FOLD REMAINING 12" PORTION OF BLANKET BACK OVER SEED AND COMPACTED SOIL. SECURE BLANKET OVER COMPACTED SOIL WITH A ROW OF STAPLES/STAKES SPACED APPROXIMATELY 12" APART ACROSS THE WIDTH OF THE BLANKET.
- 4. ROLL THE BLANKETS (A.) DOWN OR (B.) HORIZONTALLY ACROSS THE SLOPE. BLANKETS WILL UNROLL WITH APPROPRIATE SIDE AGAINST THE SOIL SURFACE. ALL BLANKETS MUST BE SECURELY FASTENED TO SOIL SURFACE BY PLACING STAPLES/STAKES IN APPROPRIATE LOCATIONS. WHEN USING OPTIONAL DOT SYSTEM, STAPLES/STAKES SHOULD BE PLACED THROUGH EACH OF THE COLORED DOTS CORRESPONDING TO THE APPROPRIATE STAPLE PATTERN.
- ENSURE PROPER SEAM ALIGNMENT, PLACE THE EDGE OF THE OVERLAPPING BLANKET (BLANKET BEING INSTALLED ON TOP) EVEN WITH THE COLORED SEAM STITCH ON THE PREVIOUSLY INSTALLED BLANKET 6. CONSECUTIVE BLANKETS SPLICED DOWN THE SLOPE MUST BE PLACED END OVER END (SHINGLE STYLE) WITH AN APPROXIMATE

5. THE EDGES OF PARALLEL BLANKETS MUST BE STAPLED WITH APPROXIMATELY 2"-5" OVERLAP DEPENDING ON BLANKET TYPE. TO

- 3" OVERLAP. STAPLE THROUGH OVERLAPPING AREA APPROXIMATELY 12" APART ACROSS ENTIRE BLANKET WIDTH.
- 7. TO PROPERLY SECURE THE BLANKETS IN LOOSE SOIL CONDITIONS, THE USE OF STAPLES OR STAKES GREATER THAN 6" MAY BE

EROSION CONTROL BANK STABILIZATION DETAIL

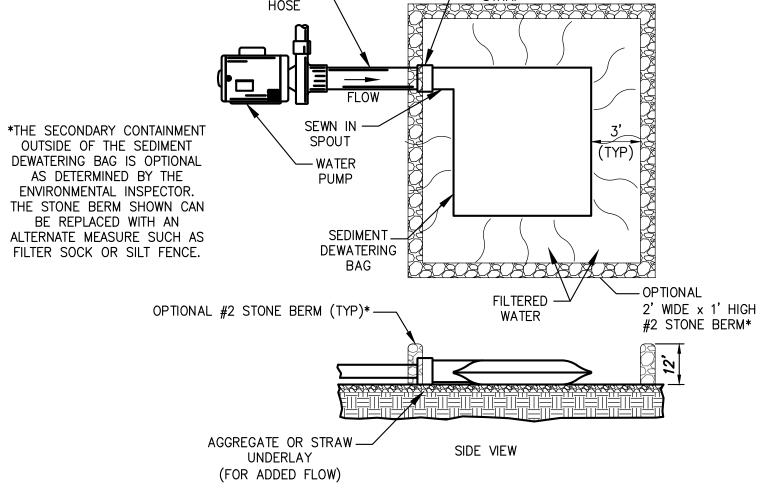


NOTE: THE SEDIMENT DEWATERING BAG WILL BE MANUFACTURED IN THE U.S.A. FROM A NONWOVEN POLYPROPYLENE FABRIC THAT MEETS OR EXCEEDS THE FOLLOWING SPECIFICATIONS:

SEDIMENT DEWATERING BAG SPECIFICATIONS

<u> </u>	0. 2011 1071110110	_	
Mechanical Properties	Test Method	Units	MARV
Grab Tensile Strength	ASTM D 4632	kN (lbs)	0.9 (205) x 0.9 (205)
Grab Tensile Elongation	ASTM D 4632	%	50 x 50
Puncture Strength	ASTM D 4833	kN (lbs)	0.58 (130)
Mullen Burst Strength	ASTM D 3786	kPa (psi)	2618 (380)
Trapezoid Tear Strength	ASTM D 4533	kN (lbs)	0.36 (80) X 0.36 (80)
UV Resistence	ASTM D 4355	%	70
Apparent Opening Size	ASTM D 4751	Mm (US Std Sieve)	0.180 (80)
Flow Rate	ASTM D 4491	1/min/m² (gal/min/ft²)	3866 (95)
Permittivity	ASTM D 4491	Sec ⁻¹	1.2

SEDIMENT DEWATERING BAG SCALE: N.T.S.

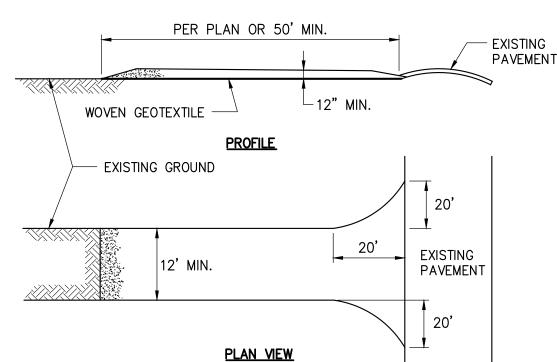

1. STONE SIZE-USE AASHTO M43 SIZE 3 COARSE AGGREGATE, OR RECLAIMED OR RECYCLED CONCRETE EQUIVALENT.

2. LENGTH - NOT LESS THAN 50 FEET (EXCEPT ON A SINGLE RESIDENCE LOT WHERE A 30 FOOT MINIMUM LENGTH WOULD APPLY).

3. THICKNESS - NOT LESS THAN 12".

WIDTH - TWELVE (12) FOOT MINIMUM, BUT NOT LESS THAN THE FULL WIDTH AT POINTS WHERE INGRESS OR EGRESS OCCURS. TWENTY-FOUR (24) FOOT IF SINGLE ACCESS TO SITE.

5. WOVEN GEOTEXTILE FABRIC WILL BE PLACED OVER THE ENTIRE AREA PRIOR TO PLACING OF STONE.


6. EXISTING ROAD SIDE DRAINAGE SHALL BE MAINTAINED.

7. SURFACE WATER - ALL SURFACE WATER FLOWING OR DIVERTED TOWARD CONSTRUCTION ENTRANCES SHALL BE PIPED BENEATH THE ENTRANCE, IF PIPING IS IMPRACTICAL, A MOUNTABLE BERM WITH 5:1 SLOPES WILL BE PERMITTED.

8. MAINTENANCE-THE ACCESS SHALL BE MAINTAINED IN A CONDITION WHICH WILL PREVENT TRACKING OR FLOWING OF SEDIMENT ONTO PUBLIC RIGHTS-OF-WAY. THIS MAY REQUIRE PERIODIC TOP DRESSING WITH ADDITIONAL STONE AS CONDITIONS DEMAND AND REPAIR AND/OR CLEANOUT OF ANY MEASURES USED TO TRAP SEDIMENT. ALL SEDIMENT OR STONE SPILLED, DROPPED, WASHED, OR TRACKED ONTO PUBLIC RIGHTS-OF-WAY MUST BE REMOVED IMMEDIATELY.

9. WHEN WASHING IS REQUIRED, IT SHALL BE DONE ON A AREA STABILIZED WITH STONE AND WHICH DRAINS INTO AN APPROVED SEDIMENT TRAPPING DEVICE.

10. PERIODIC INSPECTION AND NEEDED MAINTENANCE SHALL BE PROVIDED AFTER EACH RAIN.

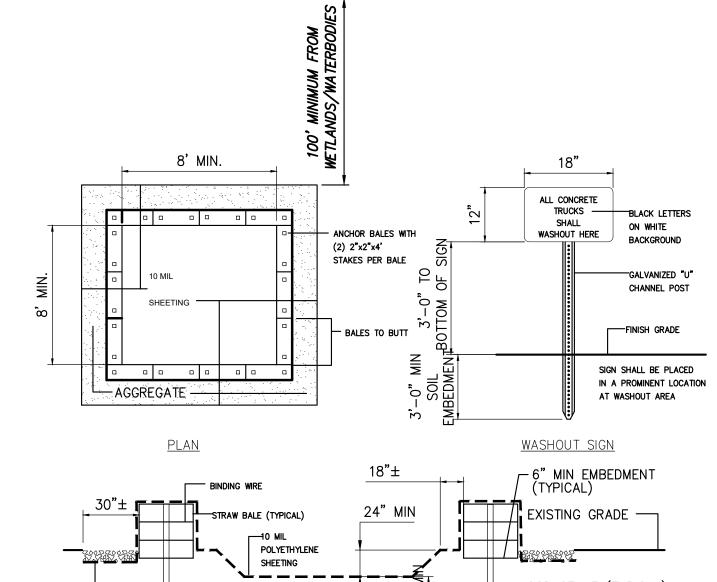

MAINTENANCE NOTES:

1. ALL CONCRETE WASHOUT FACILITIES SHALL BE INSPECTED DAILY. DAMAGED OR LEAKING FACILITATES SHALL BE DEACTIVATED AND REPAIRED OR REPLACED IMMEDIATELY. EXCESS RAINWATER THAT HAS ACCUMULATED OVER HARDENED CONCRETE SHALL BE PUMPED TO A STABILIZED AREA SUCH AS A GRASS

FILTER STRIP. ACCUMULATED HARDENED MATERIAL SHALL BE REMOVED WHEN 75% OF THE STORAGE CAPACITY OF THE STRUCTURE IS FILLED. ANY EXCESS WASH WATER SHALL BE PUMPED INTO A CONTAINMENT VESSEL AND PROPERLY DISPOSED OF OFF SITE.

DISPOSAL OF THE HARDENED MATERIAL SHALL BE OFF-SITE IN A CONSTRUCTION/DEMOLITION

4. THE PLASTIC LINER SHALL BE REPLACED WITH EACH CLEANING OF THE WASHOUT FACILITY. 5. INSPECT THE PROJECT SITE FREQUENTLY TO

ENSURE THAT NO CONCRETE DISCHARGES ARE TAKING PLACE IN NON-DESIGNATED AREAS. 6. LOCATION(S) TO BE DETERMINED IN THE FIELD

BY THE OWNER'S REPRESENTATIVE 7. CONCRETE WASHOUTS SHALL NOT BE

LOCATED WITHIN 200' OF ANY KNOWN WELL.

TYPICAL SECTION CONCRETE WASHOUT AREA


6" MIN DEPTH AGGREGATE

ALL AROUND

SEASONAL HIGH GROUNDWATER TABLE






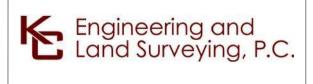



STABILIZED CONSTRUCTION ACCESS

IT IS A VIOLATION OF LAW FOR ANY PERSON, UNLESS THEY ARE ACTING UNDER THE DIRECTION OF A LICENSED PROFESSIONAL ENGINEER, ARCHITECT, LANDSCAPE ARCHITECT OR LAND SURVEYOR TO ALTER AN ITEM IN ANY WAY. IF AN ITEM BEARING THE STAMP OF A LICENSED PROFESSIONAL IS ALTERED, THE ALTERING ENGINEER, ARCHITECT, LANDSCAPE ARCHITECT OR LAND SURVEYOR SHALL STAMP THE DOCUMENT AND INCLUDE THE NOTATION "ALTERED BY" FOLLOWED BY THEIR SIGNATURE, THE DATE OF SUCH ALTERATION, AND A SPECIFIC DESCRIPTION OF THE ALTERATION.

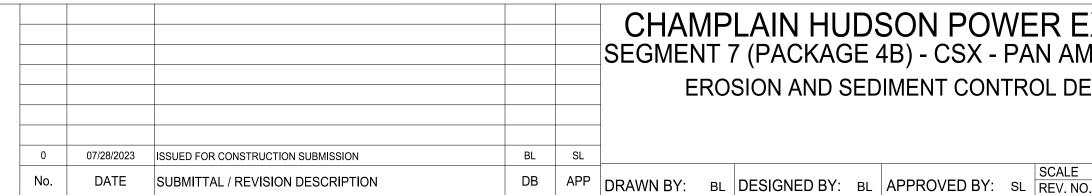

CHAMPLAIN HUDSON POWER EXPRESS SEGMENT 7 (PACKAGE 4B) - CSX - PAN AM SOUTHERN **EROSION AND SEDIMENT CONTROL DETAILS**

-WOOD STAKE (TYPICAL)

KIEWIT PROJECT NO. 21162 KC PROJECT NO. 120174 DRAWING NO.

AS NOTED DATE

0 SH.NO.

-UNDERNEATH

DIRECTION

ROLL

OVERLAP

UPPER ROLL -

C-602

07/26/2023