<u>LEGEND</u>

TEMPORARY
PEDESTRIAN/BIKE DETOUR
USING EXISTING WALKWAY



CLOSED AREA



NIGHT TIME WORK AREA

TEMPORARY PAVEMENT



ACCESS ROAD TO EXISTING PARKING LOT

### NOTES:

- 1. BRONX SHORE ROAD WB WILL BE DETOURED TO BRONX SHORE ROAD EB AS SHOWN ON THE PLAN VIEW ABOVE.
- 2. EXISTING PEDESTRIAN/BIKE WALKWAY BETWEEN APPROXIMATE CONDUIT STATION 80036+00 AND 80038+00 SHOWN WITH SOLID FILL HATCH SHALL BE CLOSED COMPLETELY DURING CONSTRUCTION.
- 3. CONTRACTOR SHALL PLATE OVER OPEN TRENCHES AT THE END OF EACH SHIFT.
- 4. ALL EXISTING CURBS IMPACTED BY THE PROPOSED WORK SHALL BE REPLACED IN ACCORDANCE WITH APPLICABLE STANDARDS FROM NYCDOT, NYCDPR AND AS PER THE DETAIL SHOWN ON C-631.
- 5. SEE SHEET NO. C-504 FOR SECTION A-A.
- 6. CONTRACTOR SHALL MAINTAIN MINIMUM 12' LANE FOR ACCESS TO EXISTING PARKING LOT AT ALL TIMES DURING CONSTRUCTION.
- 7. TEMPORARY PAVEMENT TO BE REMOVED AND SITE TO BE RESTORED TO THE EXISTING CONDITION AT THE END OF CONSTRUCTION. REFER TO RESTORATION DETAIL ON C-631.

WORK ZONE TRAFFIC CONTROL - RANDALL'S ISLAND

SCALE: 1" = 50'




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CHPE

Champlain Hudson

Power Express





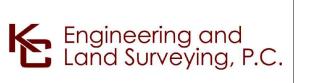

IT IS A VIOLATION OF LAW FOR ANY PERSON, UNLESS THEY ARE ACTING UNDER THE DIRECTION OF A LICENSED PROFESSIONAL ENGINEER, ARCHITECT, LANDSCAPE ARCHITECT OR LAND SURVEYOR TO ALTER AN ITEM IN ANY WAY. IF AN ITEM BEARING THE STAMP OF A LICENSED PROFESSIONAL IS ALTERED, THE ALTERING ENGINEER, ARCHITECT, LANDSCAPE ARCHITECT OR LAND SURVEYOR SHALL STAMP THE DOCUMENT AND INCLUDE THE NOTATION "ALTERED BY" FOLLOWED BY THEIR SIGNATURE, THE DATE OF SUCH ALTERATION, AND A SPECIFIC DESCRIPTION OF THE ALTERATION.

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CHAMPLAIN HUDSON POWER EXPRESS

SEGMENTS 13 TO 15 - PACKAGE 8

TRANSITION VAULT 5 TO ASTORIA CONVERTER STATION


WORK ZONE TRAFFIC CONTROL PLAN 02

RANDALL'S ISLAND

KIEWIT PROJECT NO.
21162
KC PROJECT NO.
120174
DRAWING NO.


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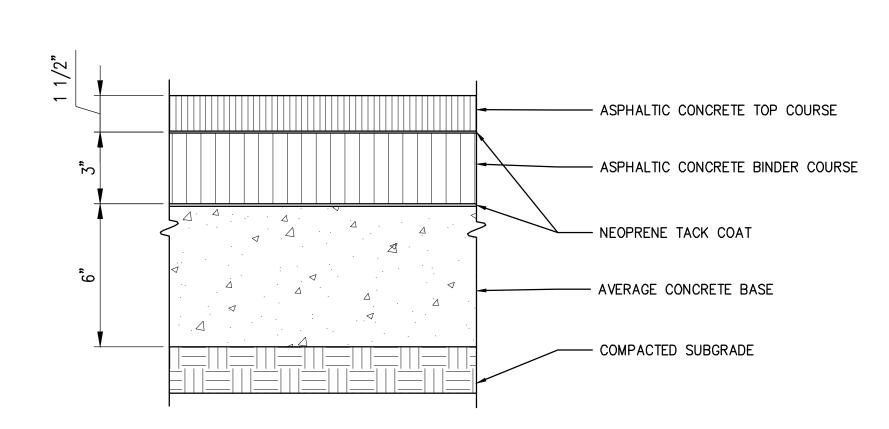
TEMPORARY ROAD PAVEMENT PROFILE

SCALE: H: 1" = 20' V: 1" = 10'

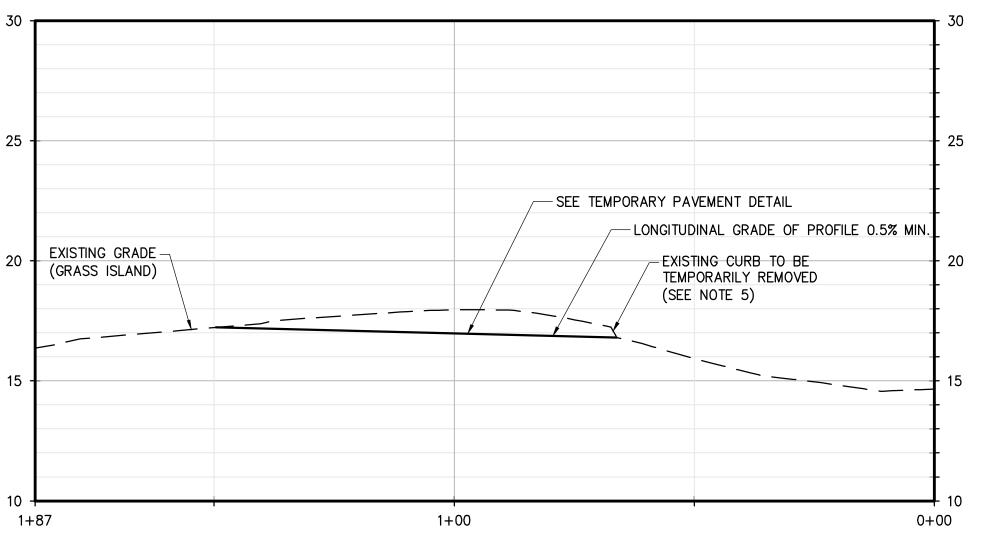


TEMPORARY ROAD PAVEMENT SECTION VIEW AT STA. 1+00

SCALE: H: 1" = 20' V: 1" = 10'

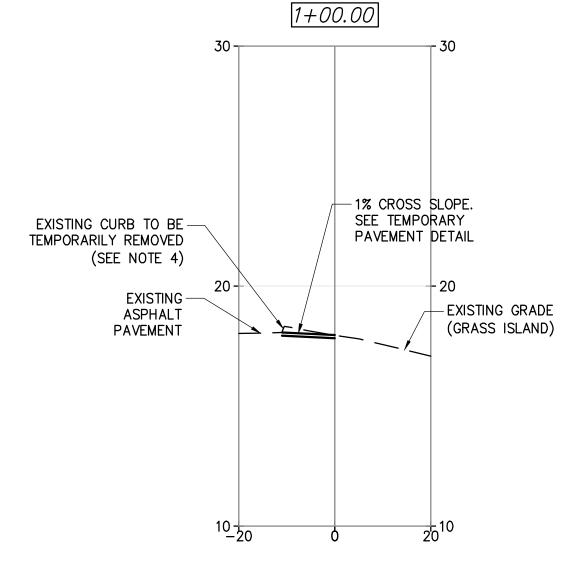


TEMPORARY ROAD PAVEMENT DETAIL

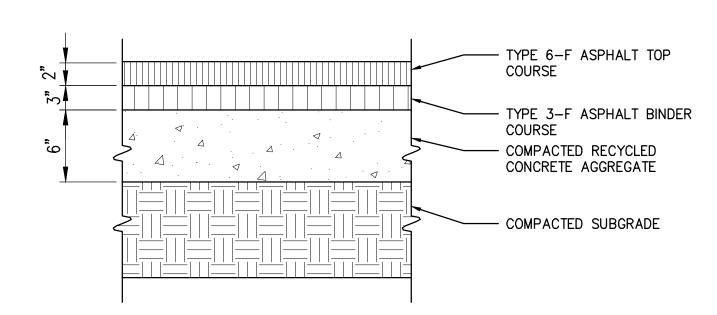

TEMPORARY PEDESTRIAN WALKWAY ASPHALT PAVEMENT





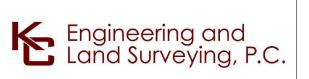



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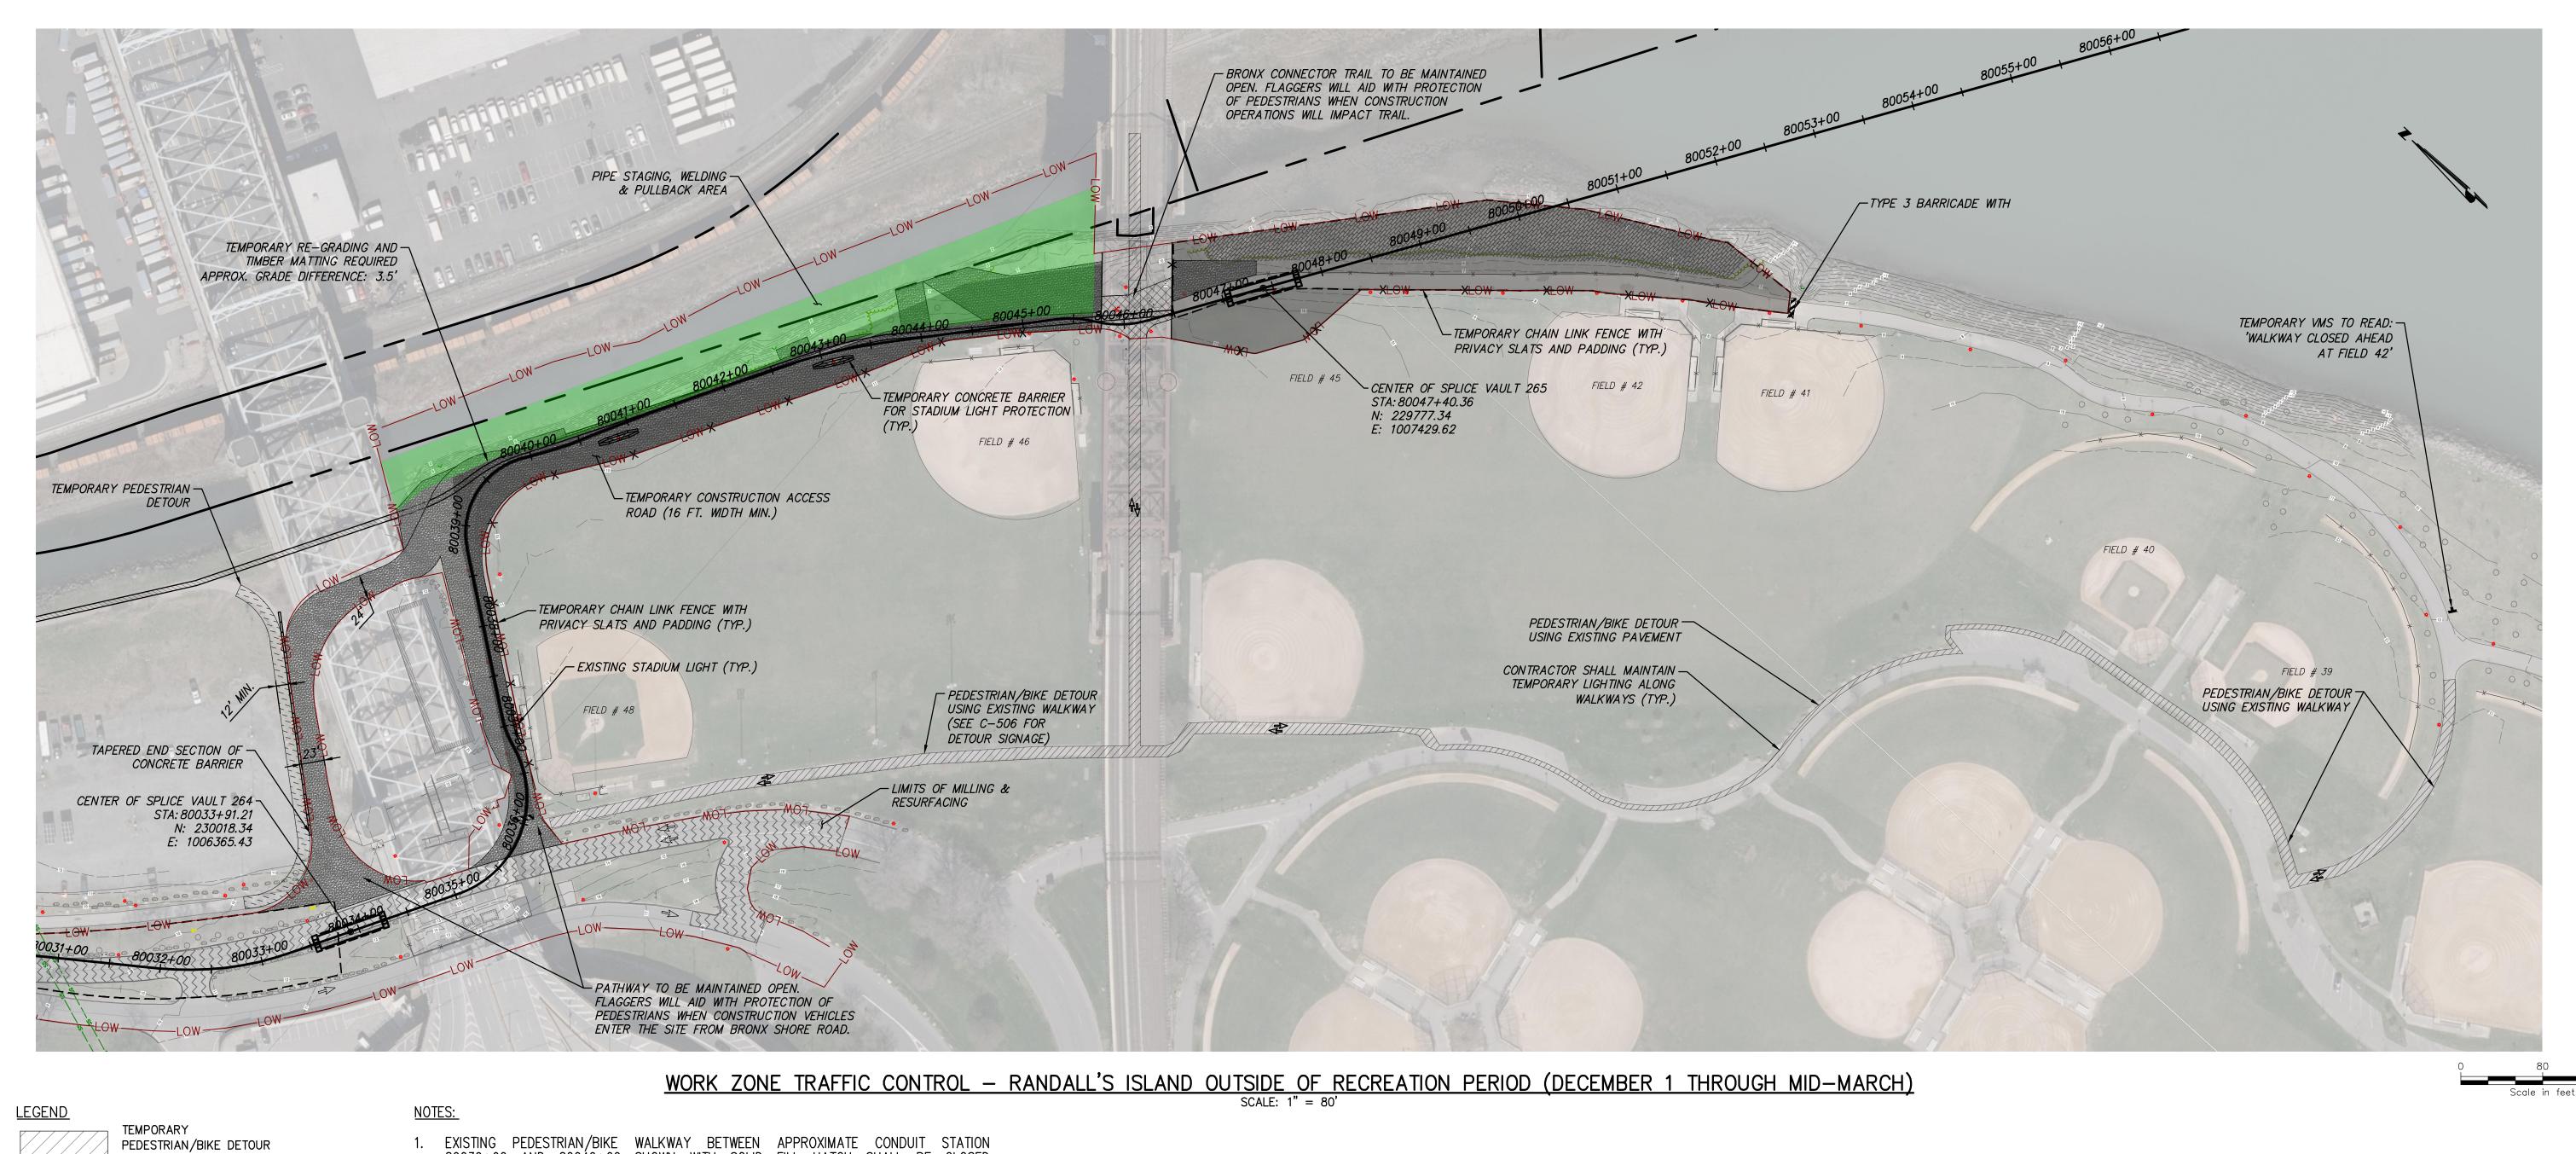
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CHAMPLAIN HUDSON POWER EXPRESS SEGMENTS 13 TO 15 - PACKAGE 8 TRANSITION VAULT 5 TO ASTORIA CONVERTER STATION WORK ZONE TRAFFIC CONTROL PLAN 02

KIEWIT PROJECT NO. 21162 KC PROJECT NO. 120174 DRAWING NO.

C-504

RANDALL'S ISLAND PROFILE AND SECTION VIEW DRAWN BY: MK DESIGNED BY: MK APPROVED BY: CV REV. NO. AS SHOWN DATE 0 SH.NO.



USING EXISTING WALKWAY

CLOSED AREA

NIGHT TIME WORK AREA


BRONX KILL PIPE STAGING, WELDING & PULLBACK AREA 80036+00 AND 80046+00 SHOWN WITH SOLID FILL HATCH SHALL BE CLOSED COMPLETELY DURING CONSTRUCTION.

CONDUIT INSTALLATION BETWEEN APPROXIMATE CONDUIT STATION 80045+00 AND 80047+00 SHOWN WITH CROSS HATCH SHALL BE CONDUCTED USING NIGHT TIME OPERATION.

3. CONTRACTOR SHALL PLATE OVER OPEN TRENCHES AT THE END OF EACH SHIFT FOR THE ROADWAY TO BE USED FOR DAY TIME OPERATIONS.

**Power Express** 



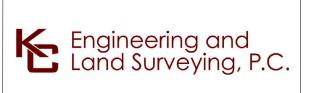



IT IS A VIOLATION OF LAW FOR ANY PERSON, UNLESS THEY ARE ACTING UNDER THE DIRECTION OF A LICENSED ARE ACTING UNDER THE DIRECTION OF A LICENSED PROFESSIONAL ENGINEER, ARCHITECT, LANDSCAPE ARCHITECT OR LAND SURVEYOR TO ALTER AN ITEM IN ANY WAY. IF AN ITEM BEARING THE STAMP OF A LICENSED PROFESSIONAL IS ALTERED, THE ALTERING ENGINEER, ARCHITECT, LANDSCAPE ARCHITECT OR LAND SURVEYOR SHALL STAMP THE DOCUMENT AND INCLUDE THE NOTATION "ALTERED BY" FOLLOWED BY THEIR SIGNATURE, THE DATE OF SUCH ALTERATION, AND A SPECIFIC DESCRIPTION OF THE ALTERATION.

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CHAMPLAIN HUDSON POWER EXPRESS SEGMENTS 13 TO 15 - PACKAGE 8 TRANSITION VAULT 5 TO ASTORIA CONVERTER STATION WORK ZONE TRAFFIC CONTROL PLAN 03

RANDALL'S ISLAND - OUTSIDE OF RECREATION PERIOD RAWN BY: MK DESIGNED BY: MK APPROVED BY: CV REV. NO.


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KIEWIT PROJECT NO.

21162 KC PROJECT NO.

120174

DRAWING NO.

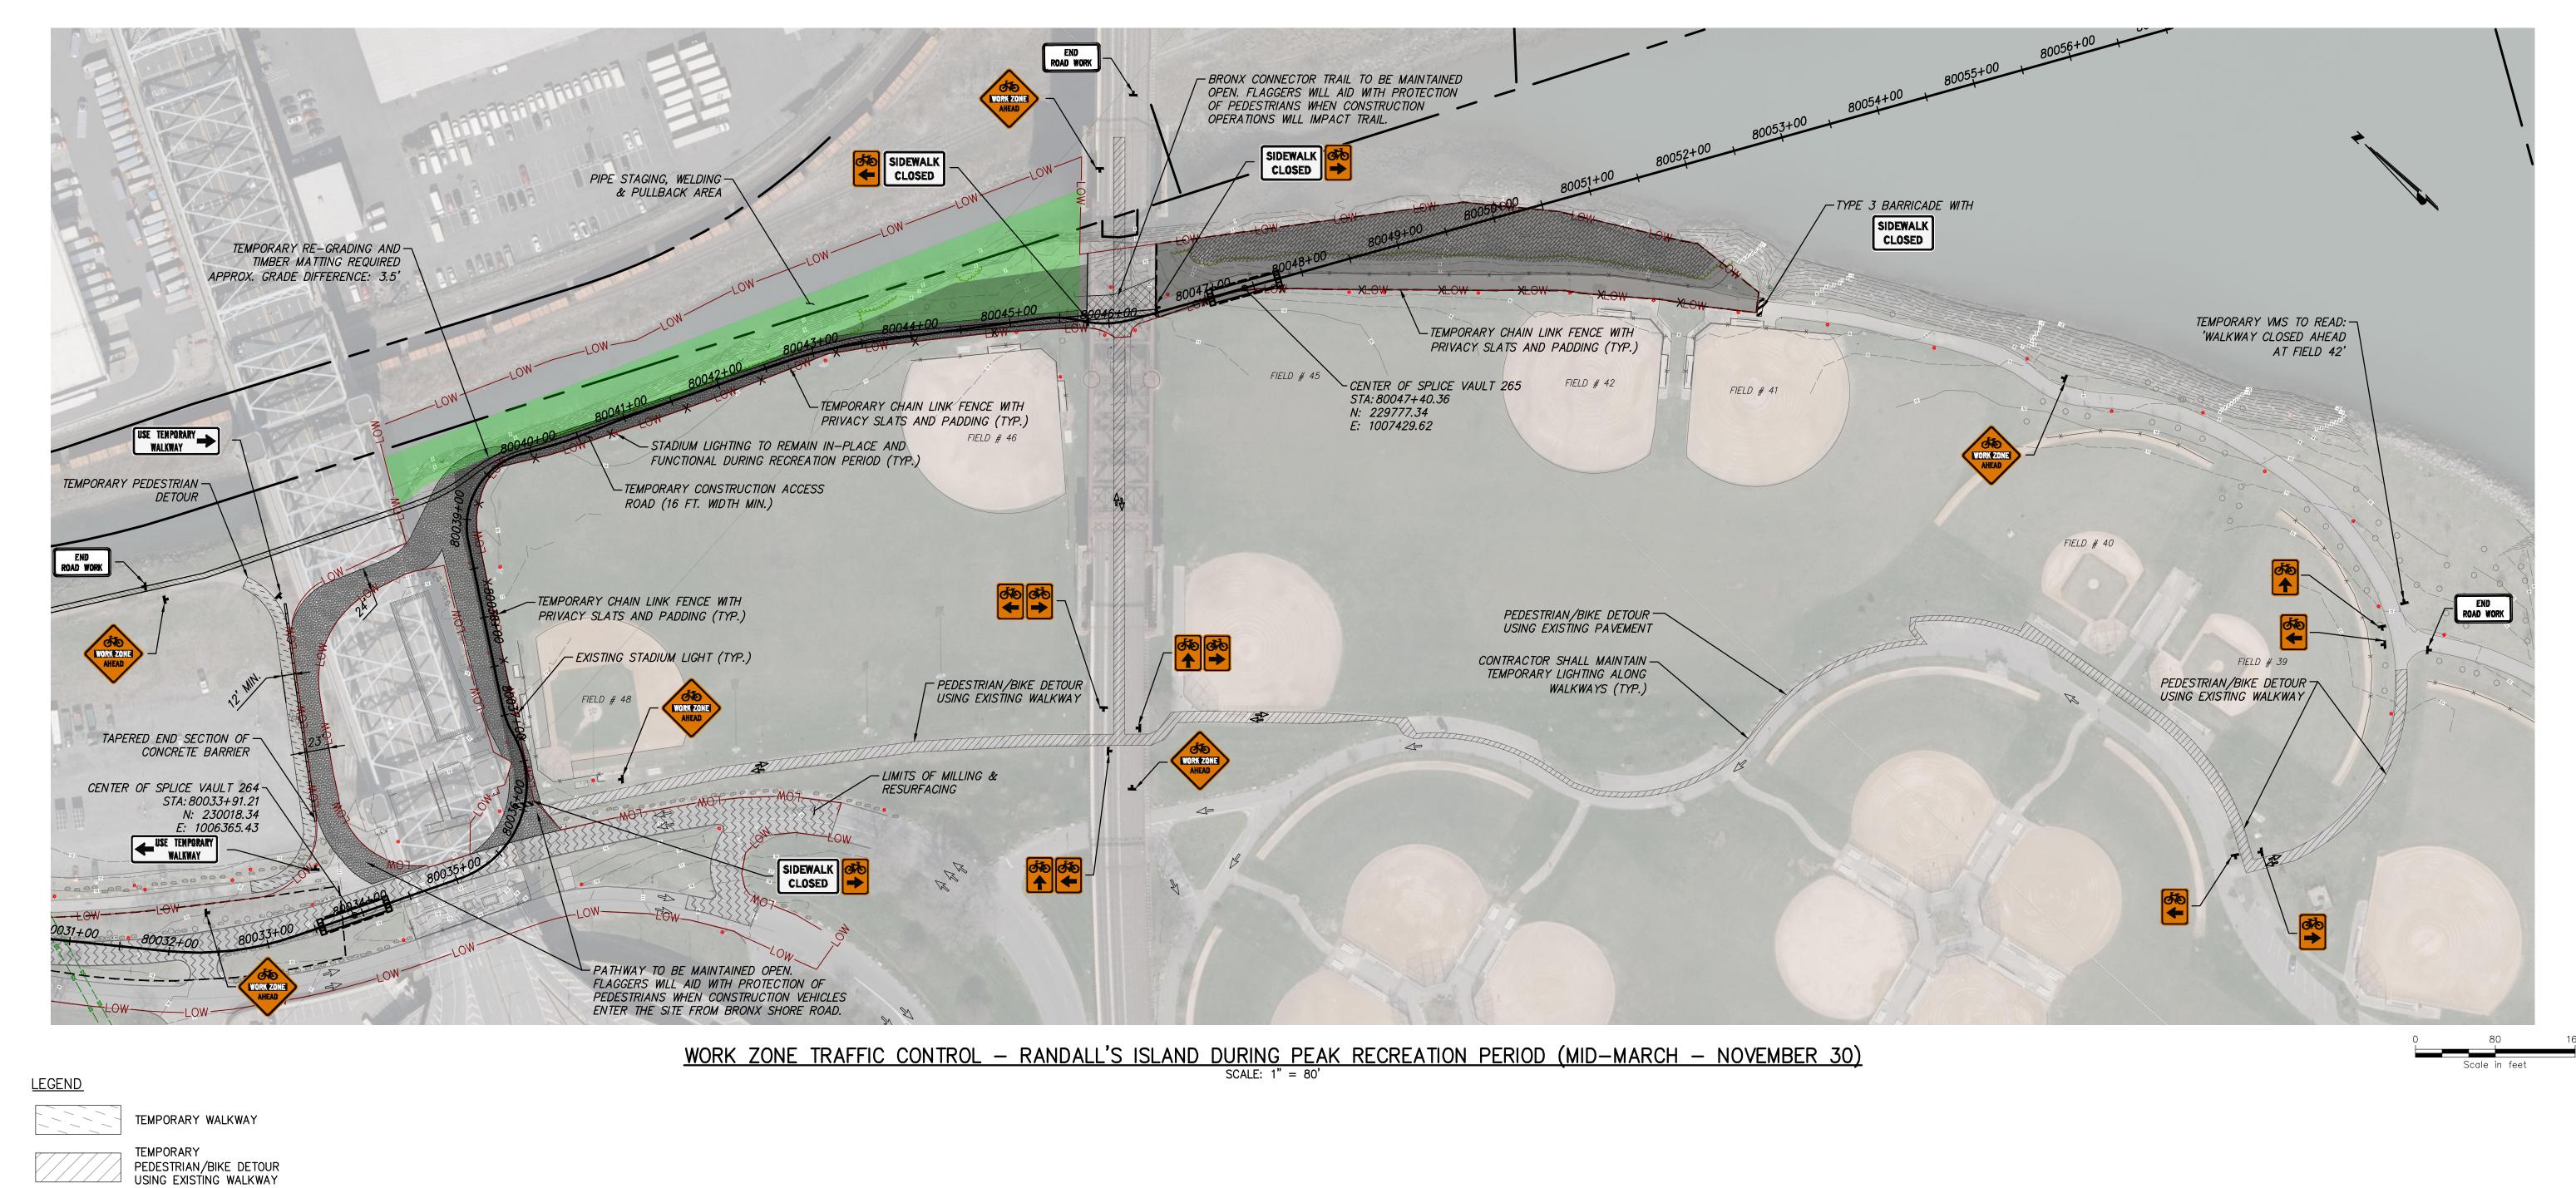


CLOSED AREA

NIGHT TIME WORK AREA

BRONX KILL PIPE STAGING, WELDING & PULLBACK AREA

**Power Express** 



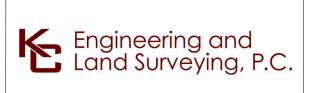



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CHAMPLAIN HUDSON POWER EXPRESS SEGMENTS 13 TO 15 - PACKAGE 8 RANSITION VAULT 5 TO ASTORIA CONVERTER STATION WORK ZONE TRAFFIC CONTROL PLAN 03

KC PROJECT NO. 120174 DRAWING NO. C-506

KIEWIT PROJECT NO.

21162

RANDALL'S ISLAND - PEAK RECREATION PERIOD WN BY: MK DESIGNED BY: MK APPROVED BY: CV REV. NO. AS SHOWN DATE 0 SH.NO.

<u>LEGEND</u>

NOTES:

1. CONDUIT INSTALLATION BETWEEN APPROXIMATE CONDUIT STATION 80103+00 AND 80107+50 SHOWN WITH CROSS HATCH SHALL BE CONDUCTED USING NIGHT TIME

2. CONTRACTOR SHALL PLATE OVER OPEN TRENCHES AT THE END OF EACH SHIFT FOR THE ROADWAY TO BE USED FOR DAY TIME OPERATIONS.

<u>WORK ZONE TRAFFIC CONTROL - ASTORIA</u>



**Power Express** 







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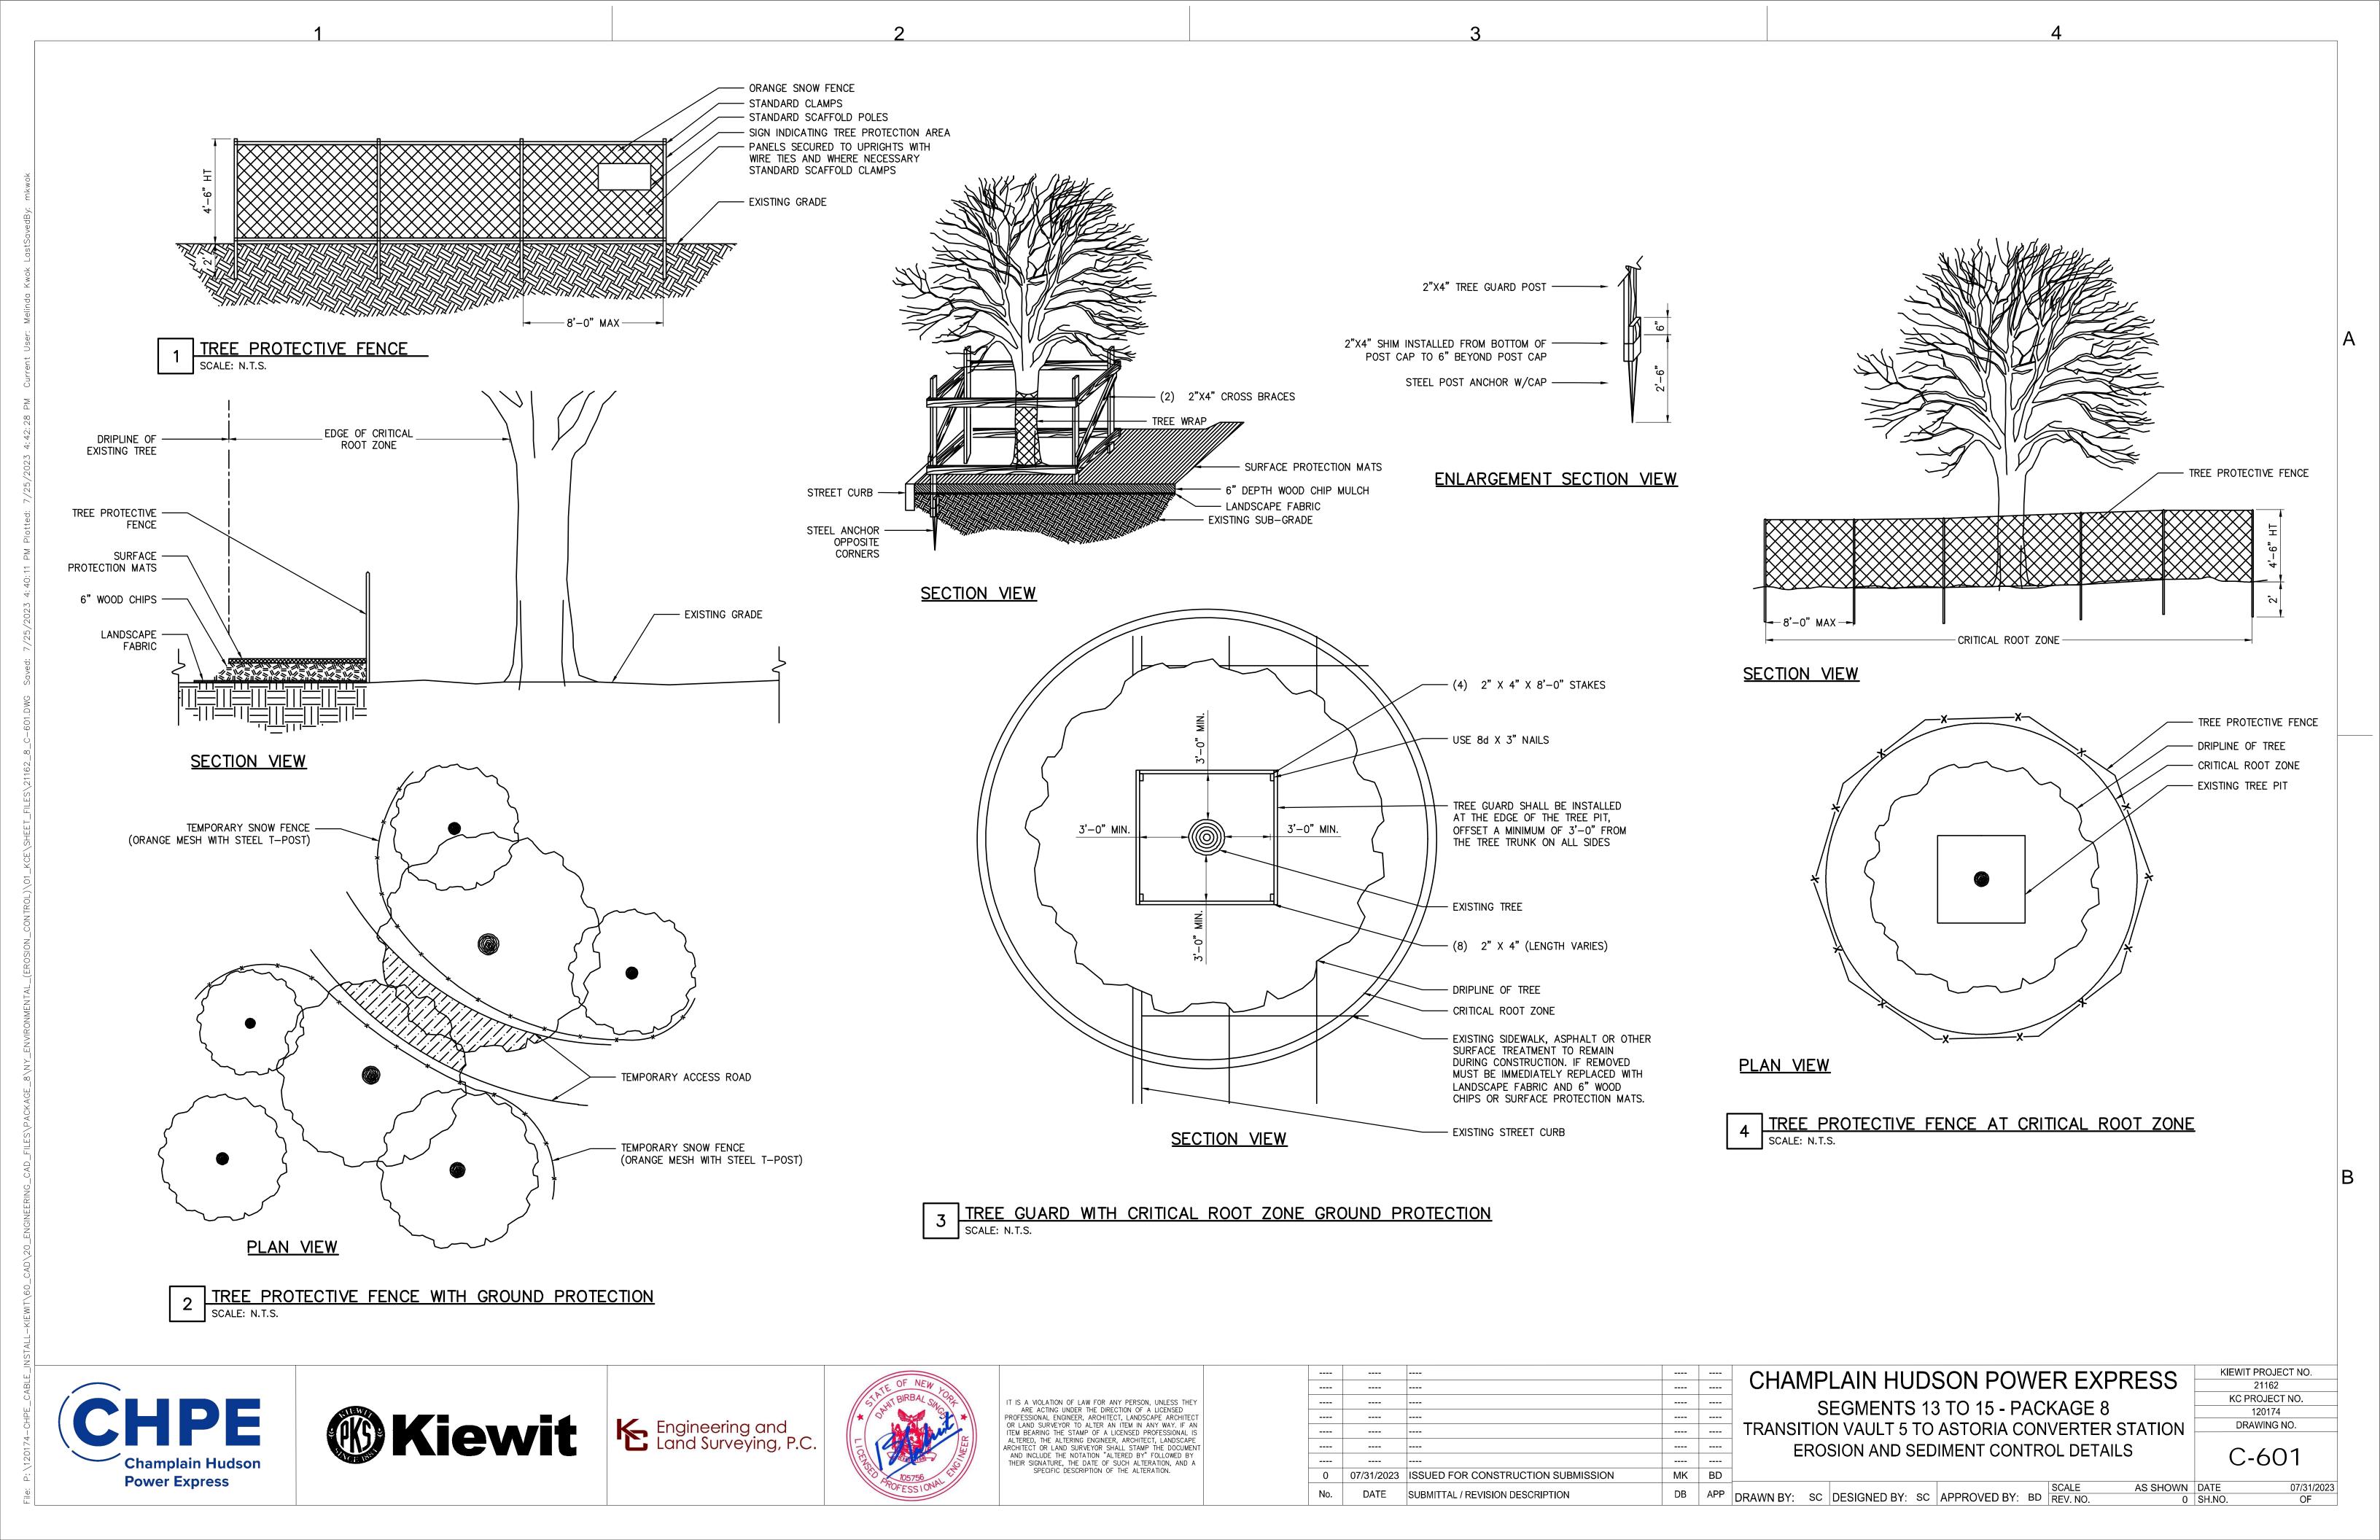
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CHAMPLAIN HUDSON POWER EXPRESS SEGMENTS 13 TO 15 - PACKAGE 8 TRANSITION VAULT 5 TO ASTORIA CONVERTER STATION WORK ZONE TRAFFIC CONTROL PLAN 04

KIEWIT PROJECT NO. 21162 KC PROJECT NO. 120174 DRAWING NO.

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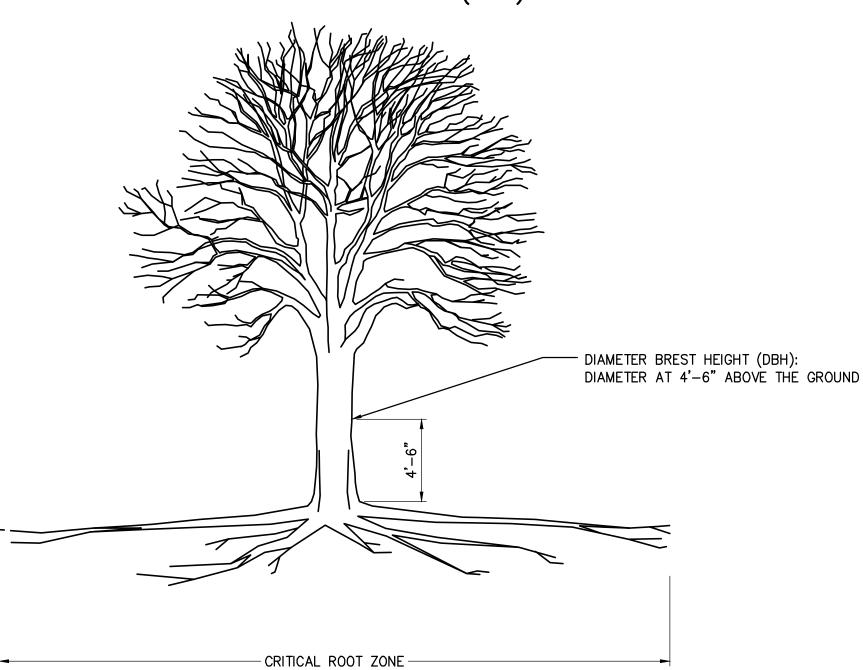
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# SECTION VIEW

TREE PROTECTIVE FENCE FOR GROVES

THE CRITICAL ROOT ZONE (CR2)



SECTION VIEW

NOTE: 12 X DBH(feet) = RADIUS OF CR2(feet)

FOR EXAMPLE, IF A TREE'S DBH IS 10 INCHES THEN THE CRITICAL ROOT ZONE HAS A RADIUS OF 10 FEET FROM THE TRUNK IN ALL DIRECTIONS.

CALCULATING CRITICAL ROOT ZONE

- ANYONE PERFORMING ANY AND ALL WORK PERFORMED WITHIN 50 FEET OF A CITY TREE MUST POSSESS A PERMIT ISSUED BY THE NYC PARKS DEPARTMENT TO AVOID UNSAFE, HAZARDOUS AND OTHER CONDITIONS WHICH MAY BE DETRIMENTAL OR POTENTIALLY DETRIMENTAL TO ANY CITY TREE. IT IS INCUMBENT UPON THE APPLICANT TO ASCERTAIN AS TO WHETHER OR NOT THERE ARE ANY TREES OR TREE ROOTS SITUATED WITHIN THE CITY RIGHT OF WAY. ANY AND ALL TREES THAT FALL WITH THE JURISDICTION OF THE NYC PARKS DEPARTMENT ARE PROTECTED BY LAW FROM ANY AND ALL DAMAGE THERETO INCLUDING BUT NOT LIMITED TO ANY INCIDENTAL DAMAGES, DAMAGE TO THE CANOPY, OR DAMAGE TO THE TRUNK OR ROOT ZONE DURING AND IN THE COURSE OF ANY AND ALL CONSTRUCTION ACTIVITIES, AND ALSO THE AFTERMATH OF ANY AND ALL CONSTRUCTION ACTIVITIES. NO CUTTING OR OTHERWISE DAMAGING OF TREE ROOTS IS PERMITTED. ANY AND ALL TREE WORK MUST BE PERMITTED. TREE WORK PERFORMED ABSENT A PERMIT CAN PRECIPITATE SERIOUS FINANCIAL AND LEGAL REPERCUSSIONS. VIOLATIONS AND MISDEMEANORS ARE PUNISHABLE BY A FINE NOT TO EXCEED \$15,000 AND/OR IMPRISONMENT FOR UP TO ONE YEAR. ANY AND ALL APPLICATIONS RELATING TO CONSTRUCTION ACTIVITIES MUST BE ACCOMPANIED BY THE APPROPRIATE DOCUMENTATION AS REQUESTED PER P-A FORESTRY APPLICATION OR UPON FORESTER REQUEST.
- APPLICANT SHALL NOTIFY NYC PARKS/ FORESTRY AT LEAST 20 BUSINESS DAYS PRIOR TO THE COMMENCEMENT OF ANY WORK REQUIRING A PERMIT.
- TEMPORARY WOODEN TREE GUARDS AND TEMPORARY SNOW FENCE BOUNDARY SHALL BE INSTALLED IMMEDIATELY AROUND EACH TREE IMPACTED BY DEMOLITION AND/OR CONSTRUCTION AND MAINTAINED THROUGHOUT THE COURSE OF THE ENTIRE DEMOLITION AND CONSTRUCTION PROCESS. (HTTP://WWW.NYCGOVPARKS.ORG/PAGEFILES/84

/TREE-PROTECTION-DETAILS.PDF)


- THE CONTRACTOR SHALL TAKE EXTREME CARE TO PROTECT THE ROOT SYSTEMS OF THE EXISTING TREES. BULK MATERIAL, EQUIPMENT, SCAFFOLD FOOTINGS, OR VEHICLES SHALL NOT BE STOCKPILED OR PARKED WITHIN THE CRITICAL ROOT ZONE (CRZ) OF ANY TREE, OR WITHIN TEN (10) FT. OF THE TRUNK (WHICHEVER IS GREATER). THIS IS DONE TO MINIMIZE SURFACE AND SUBSURFACE ROOT AND SOIL COMPACTION. THIS APPLIES TO ALL CRZS WITHIN OR OUTSIDE THE PROJECT LIMIT LINE. EVERY INCH OF DBH(DIAMETER BREAST HEIGHT) OF THE TREE REPRESENTS ONE REQUIRED RADIAL FOOT OF TREE PROTECTION.
- 5. IF STOCKPILING OCCURS WITHIN THE CRZ, A STOP WORK ORDER SHALL BE ISSUED IMMEDIATELY TO THE NYC DEPARTMENT OF BUILDINGS. ADDITIONAL VIOLATIONS MAY BE ISSUED AND MAY REQUIRE REMEDIAL WORK TO REMAIN WITHIN FORESTRY INSPECTOR'S PRESCRIBED TIMEFRAME. WORK SHALL NOT RE-COMMENCE UNTIL ALL STOCKPILED MATERIAL IS REMOVED FROM THE CRZ AND TREE REMEDIATION IS SATISFIED.
- IF ANY MACHINERY IS OPERATING WITHIN THE CRZ THE AFFECTED AREA SHALL BE COVERED WITH MULCH TO A DEPTH OF AT LEAST TWELVE (12)-INCHES AND COVERED WITH PLYWOOD OR METAL PLATES TO DISTRIBUTE WEIGHT IN ORDER TO PROTECT ROOTS FROM DAMAGE CAUSED BY HEAVY EQUIPMENT. SUCH COVERING SHALL BE MAINTAINED DURING THE COURSE OF CONSTRUCTION AND REMOVED BY HAND OR AS SPECIFIED BY THE CONTRACTED CERTIFIED ARBORIST OR FORESTRY INSPECTOR WITH ASSOCIATED PHOTOS REPORTED ACCORDINGLY. HEAT SOURCES, FLAMES, IGNITION SOURCES, AND SMOKING ARE PROHIBITED WITHIN THE CRZ AND WITHIN THE ABOVE MENTIONED MULCHED AREA.

- WHEN A DEFICIENCY IN TREE PROTECTION IS DETERMINED BY A FORESTRY INSPECTOR IT MUST BE REMEDIED IMMEDIATELY. FAILURE TO CORRECT THE DEFICIENCY IMMEDIATELY MAY RESULT IN VIOLATIONS AND SUMMONS.
- ANY DAMAGE TO EXISTING TREES DURING CONSTRUCTION SHALL BE THE CONTRACTOR'S RESPONSIBILITY. THE CONTRACTOR SHALL PERFORM REMEDIAL WORK TO DAMAGED TREES AT THE CONTRACTOR'S EXPENSE; THIS WORK SHALL MEET ALL NYC PARKS REGULATIONS. CONTRACTOR IS RESPONSIBLE FOR OBTAINING ALL NECESSARY PERMITS TO COMPLY WITH NYC PARKS REGULATIONS. ADDITIONAL RESOURCES ARE AVAILABLE AT THE NYC PARKS WEBSITE
  - HTTP: //WWW.NYCGOVPARKS.ORG/SERVICES/FORESTRY/
- CONTRACTOR WILL CONTACT NYC PARKS IF ANY UNDERGROUND INFRASTRUCTURE (GAS, WATER/ELECTRIC ETC.) AFFECTS ANY PROPOSED/EXISTING TREES ONSITE. PROJECT MANAGER IS AWARE THAT ANY WORK DONE ON OR WITHIN 50 FEET OF A CITY TREE REQUIRES A PERMIT FROM NYC PARKS. THIS INCLUDES UTILITY, SIDEWALK, PRUNING, OR ANY OTHER WORK WITHIN THE CRZ OF A TREE (WITHIN THE CITY RIGHT OF WAY) DONE BY THE GENERAL CONTRACTOR OR ANY SUBCONTRACTORS. CONTRACTOR WILL BE FAMILIAR WITH, AND FOLLOW NYC PARKS PLANTING AND FORESTRY SPECIFICATIONS. IN SOME INSTANCES, UTILITIES MAY NOT BE LABELED ON PROPOSED SITE PLAN. IF UTILITIES ARE UNKNOWN, THE PROJECT MANAGER MUST AMEND THE PLANS AND REQUEST THEIR PLANS BE REAPPROVED BY NYC PARKS.
- 10. CONSTRUCTION ACCESS ROUTE IS TO BE DIAGRAMMED AND ROUTED TO MINIMALLY IMPACT ANY EXISTING TREES. FINAL ROUTE SHALL BE ESTABLISHED ON SITE AND APPROVED BY THE FORESTRY INSPECTOR. SITE PLANS ARE TO BE INCLUDED AND AMENDED ACCORDINGLY WHEN REQUESTING NYC PARKS APPROVAL.
- 11. ROOTS OVER ONE (1)-INCH IN DIAMETER SHALL NOT BE CUT WITHOUT THE WRITTEN PERMISSION OF THE BOROUGH DIRECTOR OF FORESTRY.
- 12. TO BEST PROTECT TREE ROOTS THE CONTRACTOR SHALL EXERCISE EXTREME CARE IN REMOVING CONCRETE OR ASPHALT WITHIN THE CRZ OF EXISTING TREES. PAVEMENT SHOULD BE LIFTED RATHER THAN DRAGGED. ANY EXCAVATION WITHIN THE CRZ, OR ELSEWHERE ON SITE, AS INDICATED ON TREE PROTECTION PLAN, SHALL BE DONE BY HAND OR PNEUMATIC EXCAVATION AND IN THE PRESENCE OF THE FORESTRY INSPECTOR OR CONTRACTED CERTIFIED ARBORIST WITH ASSOCIATED PHOTOS AND REPORT TO BE FILED WITH NYC PARKS FORESTRY INSPECTOR. CONTRACTOR IS TO SCHEDULE APPOINTMENT WITH FORESTRY INSPECTOR ACCORDINGLY
- 13. THE EXCAVATION AREA WITHIN THE CRZ SHALL BE BACKFILLED IMMEDIATELY AND/OR ROOTS SHALL BE KEPT CONSTANTLY MOIST WITH BURLAP COVERED WITH WHITE PLASTIC AND CHECKED A MINIMUM OF TWO (2) TIMES A DAY, ONCE IN THE MORNING AND ONCE IN THE AFTERNOON, FOR A MAXIMUM OF FORTY-EIGHT (48) HOURS, UNTIL BACKFILL IS COMPLETE AS DIRECTED BY THE DIRECTOR OF LANDSCAPE CONSTRUCTION AND THE RESIDENT ENGINEER, IF DIRECTED, SOAKER HOSES SHALL BE INSTALLED TO FACILITATE PROPERLY MOIST CONDITIONS, NO POOLING OF WATER OR CONTINUOUS RUNNING WATER SHALL OCCUR WITHIN THE DRIP LINE OF EXISTING TREES OR WITHIN THE TREE PROTECTION ZONES OTHER THAN THAT DURING THE IRRIGATION PROCESS.

- 14. IF ROOTS ARE TO BE EXPOSED FOR A PERIOD GREATER THAN FORTY-EIGHT (48)-HOURS, THE EXPOSED AREA SHALL BE COVERED WITH AT LEAST SIX (6)-INCHES OF MULCH AND MAINTAINED MOIST DURING THE COURSE OF CONSTRUCTION UNTIL THE AREA CAN BE PROPERLY BACKFILLED. PHOTOS TO BE TAKEN PERIODICALLY AND REPORTED TO THE FORESTRY INSPECTOR BY LANDSCAPE CONTRACTOR OR CONTRACTED CERTIFIED ARBORIST.
- 15. NO RUNOFF OR SPILLAGE OF NOXIOUS MATERIALS WHILE MIXING, PLACING, OR STORING CONSTRUCTION MATERIAL SHALL OCCUR WITHIN THE TREE PIT OR CRZ. NO PONDING, ERODING, OR EXCESSIVE WETTING CAUSED BY DEWATERING OPERATIONS SHALL OCCUR WITHIN TREE PIT OR CRITICAL ROOT ZONE.
- 16. ALL EXISTING TREES BEING PROTECTED ON PROPOSED JOBSITE ARE TO BE WATERED 20 GALLONS ONCE WEEKLY BETWEEN MARCH 1 AND OCTOBER 30 ACCORDINGLY TO BEST PRESERVE EXISTING TREES DURING DEMOLITION AND CONSTRUCTION PROCESSES. WATERING SHALL BE DONE IN A MANNER THAT THERE SHOULD NOT BE STANDING WATER AROUND THE TREE.
- 17. UNLESS OTHERWISE NOTED IT IS BEST TO KEEP EXISTING CONCRETE WITHIN TREE PROTECTION ZONE AS LONG AS POSSIBLE UNTIL REMOVAL AND REINSTALLATION OF NEW SIDEWALK. CONCRETE SHOULD BE LEFT INTACT THROUGHOUT THE DEMOLITION AND CONSTRUCTION PROCESS TO PREVENT FURTHER SOIL COMPACTION ON EXISTING TREE ROOTS. OTHER WORK MAY BE SPECIFIED BY FORESTRY INSPECTOR TO BE DONE WITHIN A PRESCRIBED TIMEFRAME. METAL GRATES ARE TO BE REMOVED IMMEDIATELY. COBBLESTONES ARE TO BE REMOVED IMMEDIATELY AND THE VOID CREATED IS TO BE AMENDED WITH SOIL LEVEL TO THE SIDEWALK. PIT EXPANSION MAY BE REQUIRED BY FORESTRY
- 18. PREPARATORY PRUNING WORK SHALL BE PERFORMED ONLY WHEN DIRECTED BY A FORESTRY INSPECTOR. THIS WORK SHALL BE PERFORMED IN ACCORDANCE WITH ANSI A300 STANDARDS AND BY A QUALIFIED, LICENSED & INSURED ARBORIST OR TREE SERVICE COMPANY. CONTRACTOR IS TO FOLLOW ALL NYC PARKS FORESTRY PERMIT & WORK ORDER REGULATIONS. CONTRACTOR IS RESPONSIBLE FOR SCHEDULING THE APPOINTMENT WITH FORESTRY INSPECTOR.
- 19. ALL NEW INDICATED TREE PITS ARE TO BE FULLY EXCAVATED TO THE DIMENSIONS LABELED AND REPLACED WITH NEW QUALITY TOPSOIL TO NYC PARKS STANDARDS.

**Power Express** 



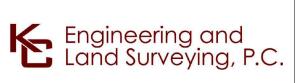



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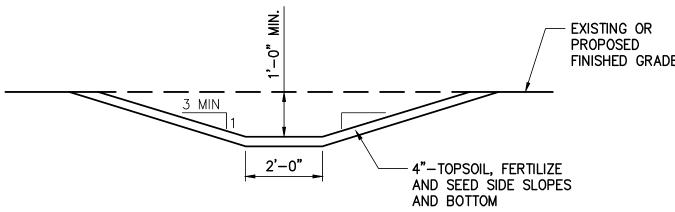
CHAMPLAIN HUDSON POWER EXPRESS SEGMENTS 13 TO 15 - PACKAGE 8 TRANSITION VAULT 5 TO ASTORIA CONVERTER STATION **EROSION AND SEDIMENT CONTROL DETAILS** 

KIEWIT PROJECT NO. 21162 KC PROJECT NO. 120174


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3 TYPICAL GRASS DRAINAGE SWALE SCALE: N.T.S.




### NOTES:

- 1. ALL MATERIAL TO MEET MANUFACTURER SPECIFICATIONS. 2. ALL FILTER SOCKS SHALL BE 12" DIAMETER UNLESS INDICATED
- 3. THE CONTRACTOR SHALL MAINTAIN THE COMPOST FILTER BERM CHANNEL PLACEMENT IN A FUNCTIONAL CONDITION AT ALL TIMES AND IT SHALL BE ROUTINELY INSPECTED.
- 4. WHERE THE BERM REQUIRES REPAIR, IT WILL BE ROUTINELY REPAIRED.
- 5. THE CONTRACTOR SHALL REMOVE SEDIMENTS COLLECTED AT THE BASE OF THE BERM WHEN THEY REACH 1/3 OF THE EXPOSED HEIGHT OF THE BERM, OR AS DIRECTED BY THE
- 6. THE COMPOST FILTER BERM WILL BE REMOVED ON SITE WHEN NO LONGER REQUIRED, AS DETERMINED BY THE OWNERS.
- 7. INSTALL PERPENDICULAR TO FLOW.

MAINTENANCE NOTES:

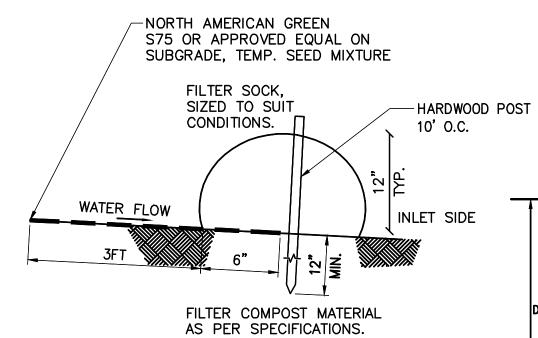- 1. TRAFFIC SHALL NOT BE PERMITTED TO CROSS FILTER
- 2. ACCUMULATED SEDIMENT SHALL BE REMOVED WHEN IT REACHES \$\frac{1}{3}\$ OF THE EXPOSED HEIGHT OF THE PRACTICE AND DISPOSED OF IN ACCORDANCE WITH
- 3. SOCKS SHALL BE INSPECTED WEEKLY AND AFTER EACH RUNOFF EVENT. DAMAGED SOCKS SHALL BE REPAIRED IN THE MANNER REQUIRED BY THE MANUFACTURER OR REPLACED WITHIN 24 HOURS OF INSPECTION NOTIFICATION.
- FILTER SOCK SHALL BE PLACED PERPENDICULAR TO THE FLOW ACROSS THE ENTIRE WIDTH OF BIODEGRADABLE FILTER SOCKS SHALL BE REPLACED AFTER 6 MONTHS: PHOTO-DEGRADABLE FILTER SOCKS AFTER 1 YEAR. POLY-PROPYLENE SOCKS SHALL BE REPLACED ACCORDING TO THE
  - MANUFACTURER'S RECOMMENDATIONS. 5. UPON STABILIZATION OF THE AREA CONTRIBUTORY TO THE SOCK, STAKES SHALL BE REMOVED. THE SOCK SHALL BE REMOVED. FOR REMOVAL THE MESH CAN BE CUT AND COMPOST SPREAD AS AN ADDITIONAL

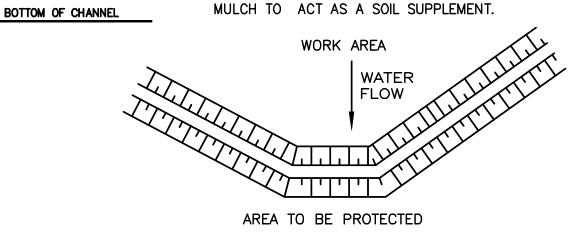

AT GRADE PLACEMENT

TOP OF CHANNEL/BANK

THE CHANNEL

FILTER

SOCK


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COMPOST FILTER SOCK DETAIL SCALE: N.T.S.




- 1. AREA CHOSEN FOR STOCKPILING OPERATIONS SHALL BE DRY, STABILIZED AND LOCATED AWAY FROM KNOWN WORK AREAS TO PREVENT RELOCATION.
- MAXIMUM STOCKPILE HEIGHT SHALL BE 12 FEET. 3. EACH PILE SHALL BE SURROUNDED WITH SILT FENCING, INSTALLED PER SILT FENCE DETAIL, THEN STABILIZED IN ACCORDANCE WITH THE NYSDEC STANDARD AND SPECIFICATIONS FOR TEMPORARY CONSTRUCTION AREA SEEDING WITHIN 7
- DAYS OF COMPLETION. 4. A PERIMETER DIKE/SWALE SHALL BE LOCATED UP-SLOPE OF THE TOPSOIL STOCKPILE TO DIVÉRT STORMWATER AROUND THE STOCKPILE.

STABILIZED SOIL STOCKPILE SCALE: N.T.S.

**Power Express** 

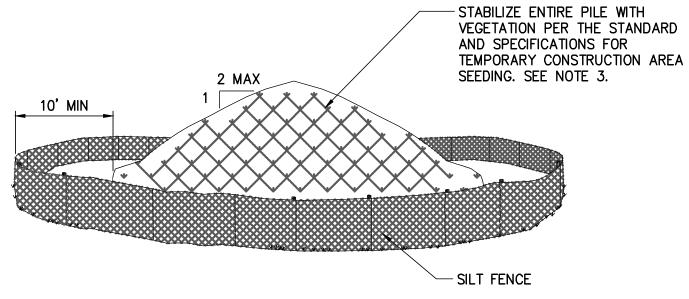

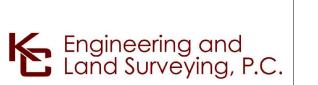



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CHAMPLAIN HUDSON POWER EXPRESS SEGMENTS 13 TO 15 - PACKAGE 8

RANSITION VAULT 5 TO ASTORIA CONVERTER STATION **EROSION AND SEDIMENT CONTROL DETAILS** 


DRAWING NO. C-603

KIEWIT PROJECT NO.

21162 KC PROJECT NO.

120174


AS SHOWN DATE

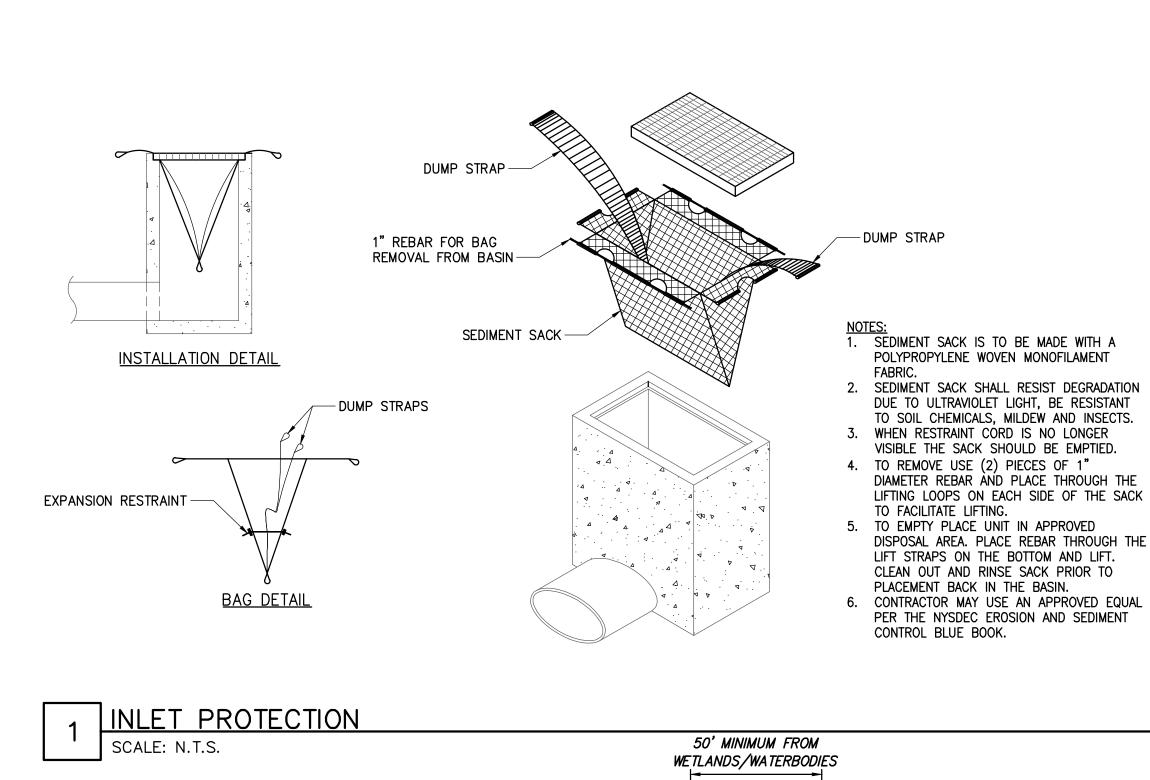

6' LONG 13 GAUGE RUST PROOF -STEEL FENCE POST WITH STABILIZING ANCHOR PLATES -CONSTRUCTION 3/4" POLYPROPYLENE TWIST ROPE, YELLOW BARRIER ROPE -WARNING SIGN (SEE ADJACENT DETAIL) MAX. (SIGNS SPACED AT 48' ON CENTER±) ∠EXISTING GRADE

CONSTRUCTION BARRIER FENCE SHALL BE INSTALLED IN THE LOCATIONS SHOWN ON THE PLANS PRIOR TO BEGINNING ANY WORK ADJACENT TO THESE AREAS.

2. THE CONTRACTOR SHALL INSTALL AT THE BEGINNING OF THE CONTRACT, AND MAINTAIN THROUGHOUT ITS DURATION.

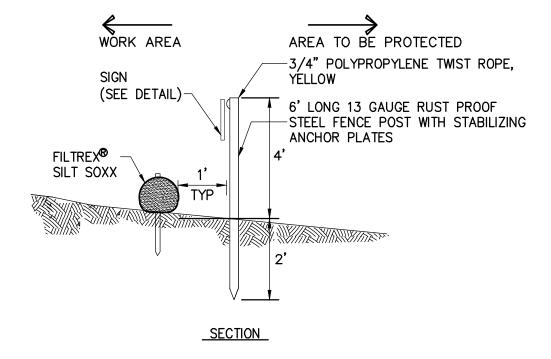




WETLAND PROTECTION FENCE

- EXISTING


PAVEMENT

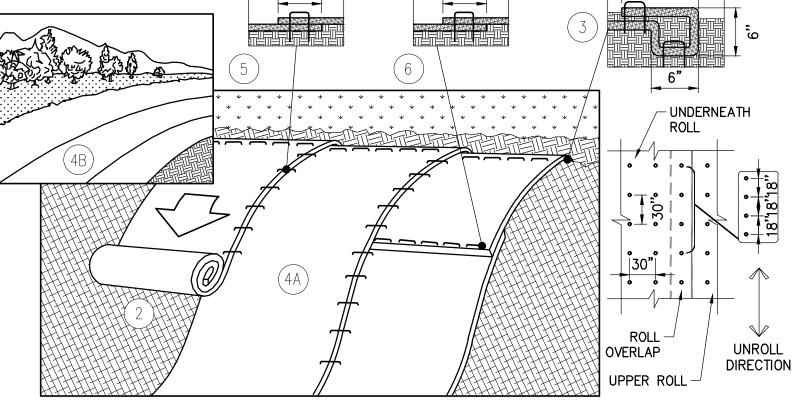

1. EROSION CONTROL BLANKETS TO BE INSTALLED ON SLOPES 3:1 OR GREATER (TYP.)

- 2. PREPARE SOIL BEFORE INSTALLING BLANKETS, INCLUDING ANY NECESSARY APPLICATION OF LIME, FERTILIZER, AND SEED. NOTE: DO NOT SEED PREPARED AREA. INSTALL WITH PAPER SIDE DOWN. INSTALL ACCORDING TO MANUFACTURERS INSTRUCTIONS.
- BEGIN AT THE TOP OF THE SLOPE BY ANCHORING THE BLANKET IN A 6" DEEP x 6" WIDETRENCH WITH APPROXIMATELY 12" OF BLANKET EXTENDED BEYOND THE UP-SLOPE PORTION OF THE TRENCH. ANCHOR THE BLANKET WITH A ROW OF STAPLES/STAKES APPROXIMATELY 12" APART IN THE BOTTOM OF THE TRENCH. BACKFILL AND COMPACT THE TRENCH AFTER STAPLING. APPLY SEED TO COMPACTED SOIL AND FOLD REMAINING 12" PORTION OF BLANKET BACK OVER SEED AND COMPACTED SOIL. SECURE BLANKET OVER COMPACTED SOIL WITH A ROW OF STAPLES/STAKES SPACED APPROXIMATELY 12" APART ACROSS THE WIDTH OF THE BLANKET.
- 4. ROLL THE BLANKETS (A.) DOWN OR (B.) HORIZONTALLY ACROSS THE SLOPE. BLANKETS WILL UNROLL WITH APPROPRIATE SIDE AGAINST THE SOIL SURFACE. ALL BLANKETS MUST BE SECURELY FASTENED TO SOIL SURFACE BY PLACING STAPLES/STAKES IN APPROPRIATE LOCATIONS. WHEN USING OPTIONAL DOT SYSTEM, STAPLES/STAKES SHOULD BE PLACED THROUGH EACH OF THE COLORED DOTS CORRESPONDING TO THE APPROPRIATE STAPLE PATTERN.
- 5. THE EDGES OF PARALLEL BLANKETS MUST BE STAPLED WITH APPROXIMATELY 2"-5" OVERLAP DEPENDING ON BLANKET TYPE. TO ENSURE PROPER SEAM ALIGNMENT, PLACE THE EDGE OF THE OVERLAPPING BLANKET (BLANKET BEING INSTALLED ON TOP) EVEN WITH THE COLORED SEAM STITCH ON THE PREVIOUSLY INSTALLED BLANKET.
- 6. CONSECUTIVE BLANKETS SPLICED DOWN THE SLOPE MUST BE PLACED END OVER END (SHINGLE STYLE) WITH AN APPROXIMATE 3" OVERLAP. STAPLE THROUGH OVERLAPPING AREA APPROXIMATELY 12" APART ACROSS ENTIRE BLANKET WIDTH.
- 7. TO PROPERLY SECURE THE BLANKETS IN LOOSE SOIL CONDITIONS, THE USE OF STAPLES OR STAKES GREATER THAN 6" MAY BE

**EROSION CONTROL BANK STABILIZATION DETAIL** 

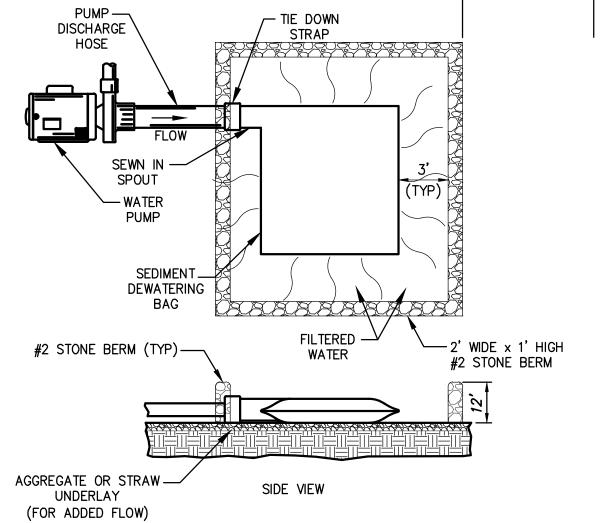


NOTE: THE SEDIMENT DEWATERING BAG WILL BE MANUFACTURED IN THE U.S.A. FROM A NONWOVEN POLYPROPYLENE FABRIC THAT MEETS OR EXCEEDS THE FOLLOWING

SPECIFICATIONS:

### SEDIMENT DEWATERING BAG SPECIFICATIONS

Mechanical Properties	Test Method	Units	MARV
Grab Tensile Strength	ASTM D 4632	kN (lbs)	0.9 (205) x 0.9 (205)
Grab Tensile Elongation	ASTM D 4632	%	50 × 50
Puncture Strength	ASTM D 4833	kN (lbs)	0.58 (130)
Mullen Burst Strength	ASTM D 3786	kPa (psi)	2618 (380)
Trapezoid Tear Strength	ASTM D 4533	kN (lbs)	0.36 (80) X 0.36 (80)
UV Resistence	ASTM D 4355	%	70
Apparent Opening Size	ASTM D 4751	Mm (US Std Sieve)	0.180 (80)
Flow Rate	ASTM D 4491	1/min/m² (gal/min/ft²)	3866 (95)
Permittivity	ASTM D 4491	Sec <sup>-1</sup>	1.2

SEDIMENT DEWATERING BAG

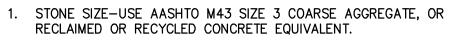

2. LENGTH - NOT LESS THAN 50 FEET (EXCEPT ON A SINGLE RESIDENCE LOT WHERE A 30 FOOT MINIMUM LENGTH WOULD

3. THICKNESS - NOT LESS THAN 12".

4. WIDTH - TWELVE (12) FOOT MINIMUM, BUT NOT LESS THAN THE FULL WIDTH AT POINTS WHERE INGRESS OR EGRESS OCCURS. TWENTY-FOUR (24) FOOT IF SINGLE ACCESS TO SITE.

5. WOVEN GEOTEXTILE FABRIC WILL BE PLACED OVER THE ENTIRE AREA PRIOR TO PLACING OF STONE.

6. EXISTING ROAD SIDE DRAINAGE SHALL BE MAINTAINED.

7. SURFACE WATER - ALL SURFACE WATER FLOWING OR DIVERTED TOWARD CONSTRUCTION ENTRANCES SHALL BE PIPED BENEATH THE ENTRANCE. IF PIPING IS IMPRACTICAL, A MOUNTABLE BERM WITH 5:1 SLOPES WILL BE PERMITTED.

MAINTENANCE-THE ACCESS SHALL BE MAINTAINED IN A CONDITION WHICH WILL PREVENT TRACKING OR FLOWING OF SEDIMENT ONTO PUBLIC RIGHTS-OF-WAY. THIS MAY REQUIRE PERIODIC TOP DRESSING WITH ADDITIONAL STONE AS CONDITIONS DEMAND AND REPAIR AND/OR CLEANOUT OF ANY MEASURES USED TO TRAP SEDIMENT. ALL SEDIMENT OR STONE SPILLED, DROPPED, WASHED, OR TRACKED ONTO PUBLIC RIGHTS-OF-WAY MUST BE REMOVED IMMEDIATELY.

9. WHEN WASHING IS REQUIRED, IT SHALL BE DONE ON A AREA STABILIZED WITH STONE AND WHICH DRAINS INTO AN APPROVED SEDIMENT TRAPPING DEVICE.


10. PERIODIC INSPECTION AND NEEDED MAINTENANCE SHALL BE PROVIDED AFTER EACH RAIN.

SHEETING -- AGGREGATE -<u>PLAN</u>

8' MIN. 18" ALL CONCRETE TRUCKS BLACK LETTERS SHALL ON WHITE WASHOUT HERE BACKGROUND (2) 2"x2"x4' STAKES PER BALE GALVANIZED "U" -POLYETHYLENE CHANNEL POST BALES TO BUTT IN A PROMINENT LOCATION AT WASHOUT AREA WASHOUT SIGN

6" MIN IMBEDMENT (TYPICAL) EXISTING GRADE — POLYETHYLENE SHEETING **\_\_\_\_\_** -WOOD STAKE (TYPICAL) SEASONAL HIGH 6" MIN DEPTH AGGREGATE ALL AROUND TYPICAL SECTION

CONCRETE WASHOUT AREA SCALE: N.T.S.

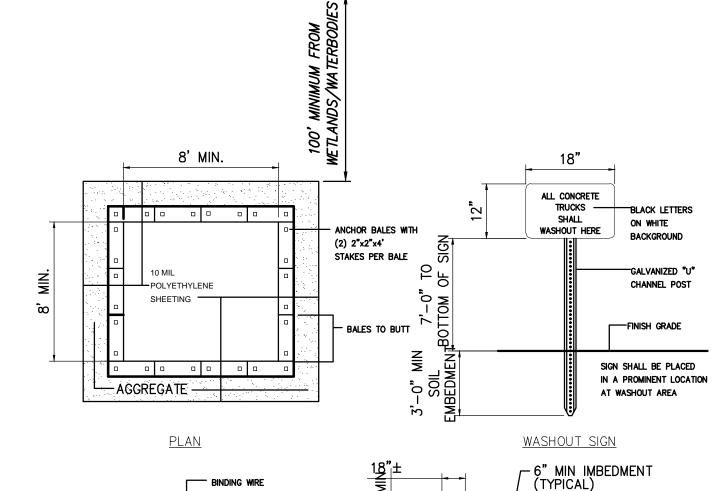

EACH CLEANING OF THE WASHOUT FACILITY. 5. INSPECT THE PROJECT SITE FREQUENTLY TO ENSURE THAT NO CONCRETE DISCHARGES ARE TAKING PLACE IN NON-DESIGNATED AREAS.

LANDFILL.

MAINTENANCE NOTES:

FILTER STRIP.

DISPOSED OF OFF SITE.

6. LOCATION(S) TO BE DETERMINED IN THE FIELD BY THE OWNER'S REPRESENTATIVE

1. ALL CONCRETE WASHOUT FACILITIES SHALL BE

INSPECTED DAILY. DAMAGED OR LEAKING

FACILITATES SHALL BE DEACTIVATED AND

A STABILIZED AREA SUCH AS A GRASS

A CONTAINMENT VESSEL AND PROPERLY

REPAIRED OR REPLACED IMMEDIATELY. EXCESS

RAINWATER THAT HAS ACCUMULATED OVER

HARDENED CONCRETE SHALL BE PUMPED TO

ACCUMULATED HARDENED MATERIAL SHALL BE REMOVED WHEN 75% OF THE STORAGE

CAPACITY OF THE STRUCTURE IS FILLED. ANY

DISPOSAL OF THE HARDENED MATERIAL SHALL

4. THE PLASTIC LINER SHALL BE REPLACED WITH


BE OFF-SITE IN A CONSTRUCTION/DEMOLITION

EXCESS WASH WATER SHALL BE PUMPED INTO

7. CONCRETE WASHOUTS SHALL NOT BE

LOCATED WITHIN 200' OF ANY KNOWN WELL.



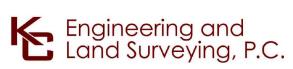



PER PLAN OR 50' MIN.

**PROFILE** 

PLAN VIEW

5 STABILIZED CONSTRUCTION ACCESS

20'

**EXISTING** 

PAVEMEN1

WOVEN GEOTEXTILE

EXISTING GROUND

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CHAMPLAIN HUDSON POWER EXPRESS SEGMENTS 13 TO 15 - PACKAGE 8 TRANSITION VAULT 5 TO ASTORIA CONVERTER STATION

**EROSION AND SEDIMENT CONTROL DETAILS** 

21162 KC PROJECT NO. 120174 DRAWING NO.

KIEWIT PROJECT NO.


AS SHOWN DATE

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**Power Express** 

SCALE: N.T.S.

OR LAND SURVEYOR TO ALTER AN ITEM IN ANY WAY. IF AN ITEM BEARING THE STAMP OF A LICENSED PROFESSIONAL IS ARCHITECT OR LAND SURVEYOR SHALL STAMP THE DOCUMENT

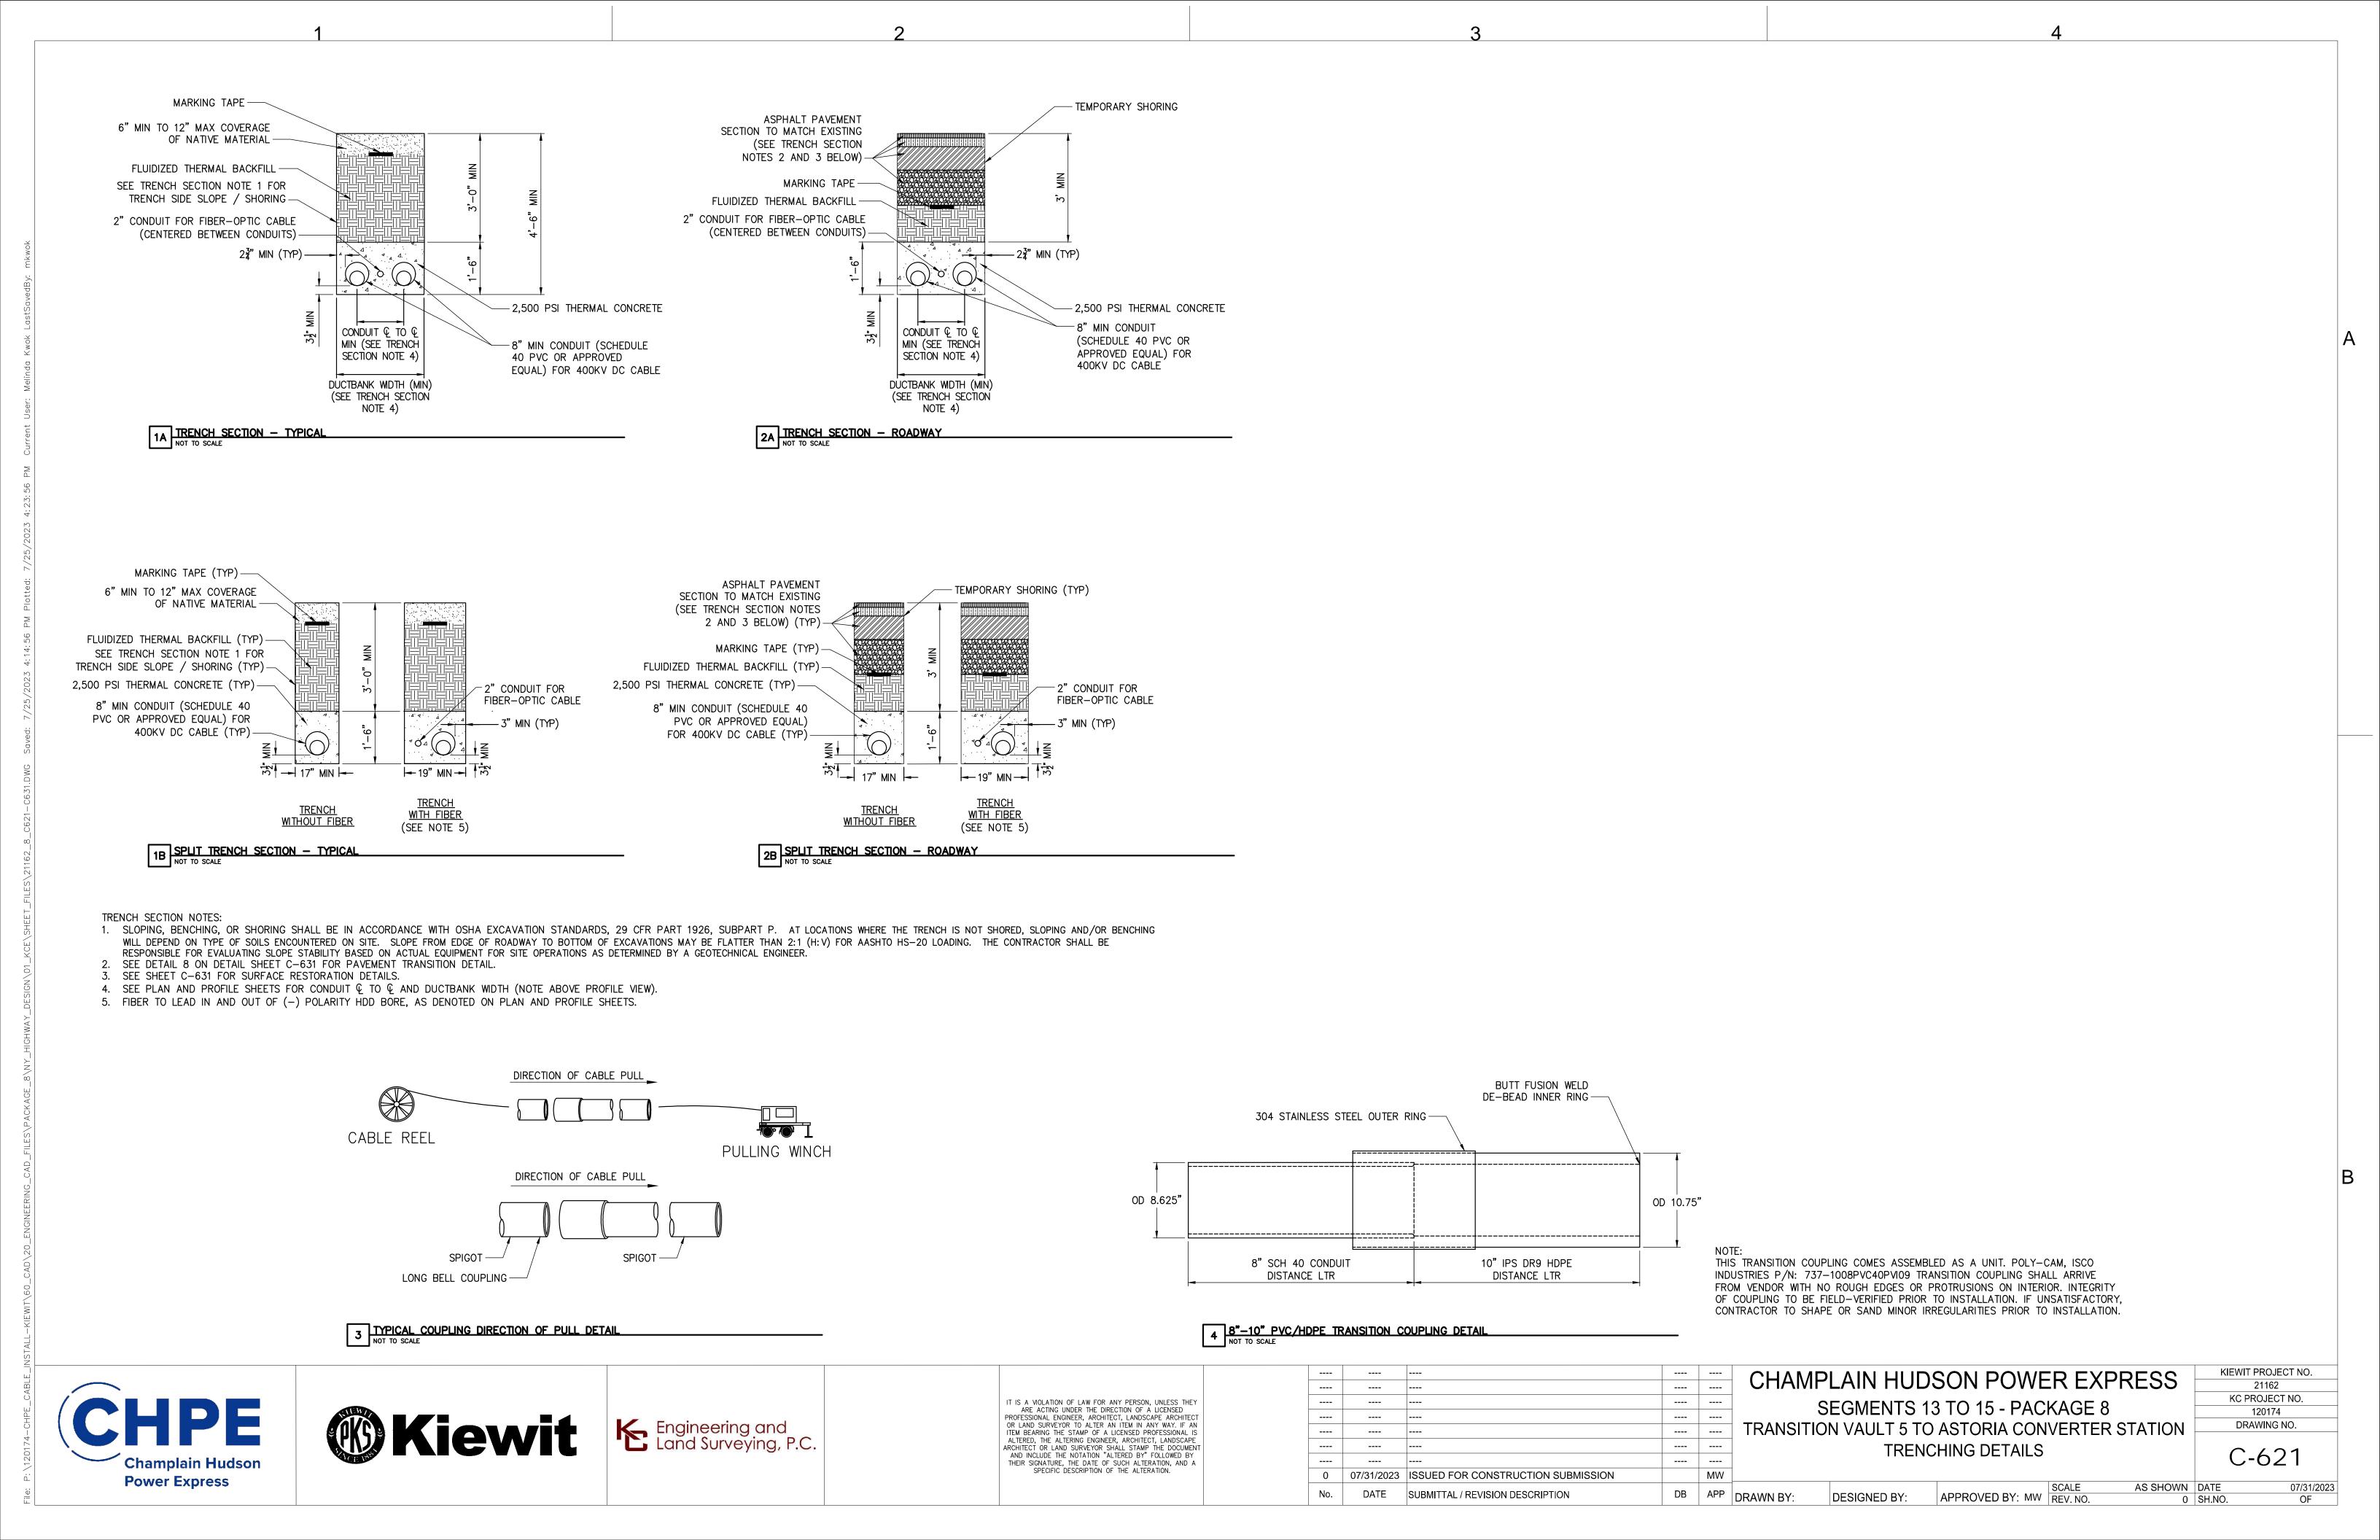

NO. 3 STONE, NO. 4 STONE OR GRADED AGGREGATE BASE

## **WETLAND WORKING SURFACE PLAN**

STACKED TIMBER ORIENTATION MATS 90 MAT 8"x4'x16' OR DEGREES TO PREVIOUS 12"x4'x16' MAT, TYP LAYER WHEN STACKING MATS NONWOVEN **GEOTEXTILE** 



### NOTES:


- 1. TIMBER MATS SHOULD BE INSTALLED IN WETLANDS AND OTHER AREAS IF NECESSARY TO PREVENT
- 2. BASED ON ACTUAL SITE CONDITIONS, NUMBER OF TIMBER MAT LAYERS TO BE DETERMINED ON SITE. 3. TIMBER MAT SURFACE SHOULD BE LEVEL TO PREVENT EQUIPMENT AND VEHICLES FROM SLIDING OFF
- DURING MUDDY OR ICING CONDITIONS, AND PREVENT TIMBERS FROM BREAKING. 4. SEDIMENT TRACKED ONTO TIMBER MATTING SHOULD BE REMOVED AS NECESSARY TO PREVENT SEDIMENT FROM ENTERING WETLAND AND AGRICULTURAL LAND DURING RAIN EVENTS. SEDIMENT SHOULD BE REMOVED TO A STABILIZED SOIL STOCKPILE OR OTHER APPROVED LOCATION.
- PERIMETER EROSION AND SEDIMENT CONTROLS ARE REQUIRED TO BE INSTALLED PRIOR TO PLACING
- 6. UNLESS PERMITTED FROM REMOVAL, STUMPS WITHIN THE WETLAND SHOULD REMAIN. THIS MAY
- REQUIRE ADDITIONAL TIMBERS TO BRIDGE ABOVE. 7. UPON REMOVAL OF TIMBER MATTING ALL SPLINTERED WOOD SHOULD BE REMOVED. IF EXPOSED SOILS
- ARE PRESENT STRAW MULCH SHOULD BE APPLIED.
- 8. REFER TO EM+CP PLANS FOR EROSION CONTROL DETAILS.
- 9. REFER TO EM+CP PLANS FOR RESTORATION OF WETLAND.

# **GENERAL NOTES:**

- 1. TIMBER: A. TIMBER SHALL BE SELECT STRUCTURAL MIXED OAK WITH A MINIMUM BENDING STRESS OF 1250 PSI OR BETTER.
- 2. CONTRACTOR TO VERIFY ALL DIMENSIONS AND SITE CONDITIONS PRIOR TO COMMENCING WORK. ANY
- ERRORS, OMISSIONS, OR UNUSUAL CONDITIONS ARE TO BE REPORTED TO THE ENGINEER IMMEDIATELY. NONWOVEN GEOTEXTILE SHALL BE MIRAFI 180N OR EQUIVALENT APPROVED BY EOR.





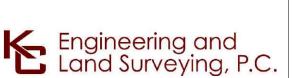



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CHAMPLAIN HUDSON POWER EXPRESS SEGMENTS 13 TO 15 - PACKAGE 8 TRANSITION VAULT 5 TO ASTORIA CONVERTER STATION WETLAND WORKING SURFACE

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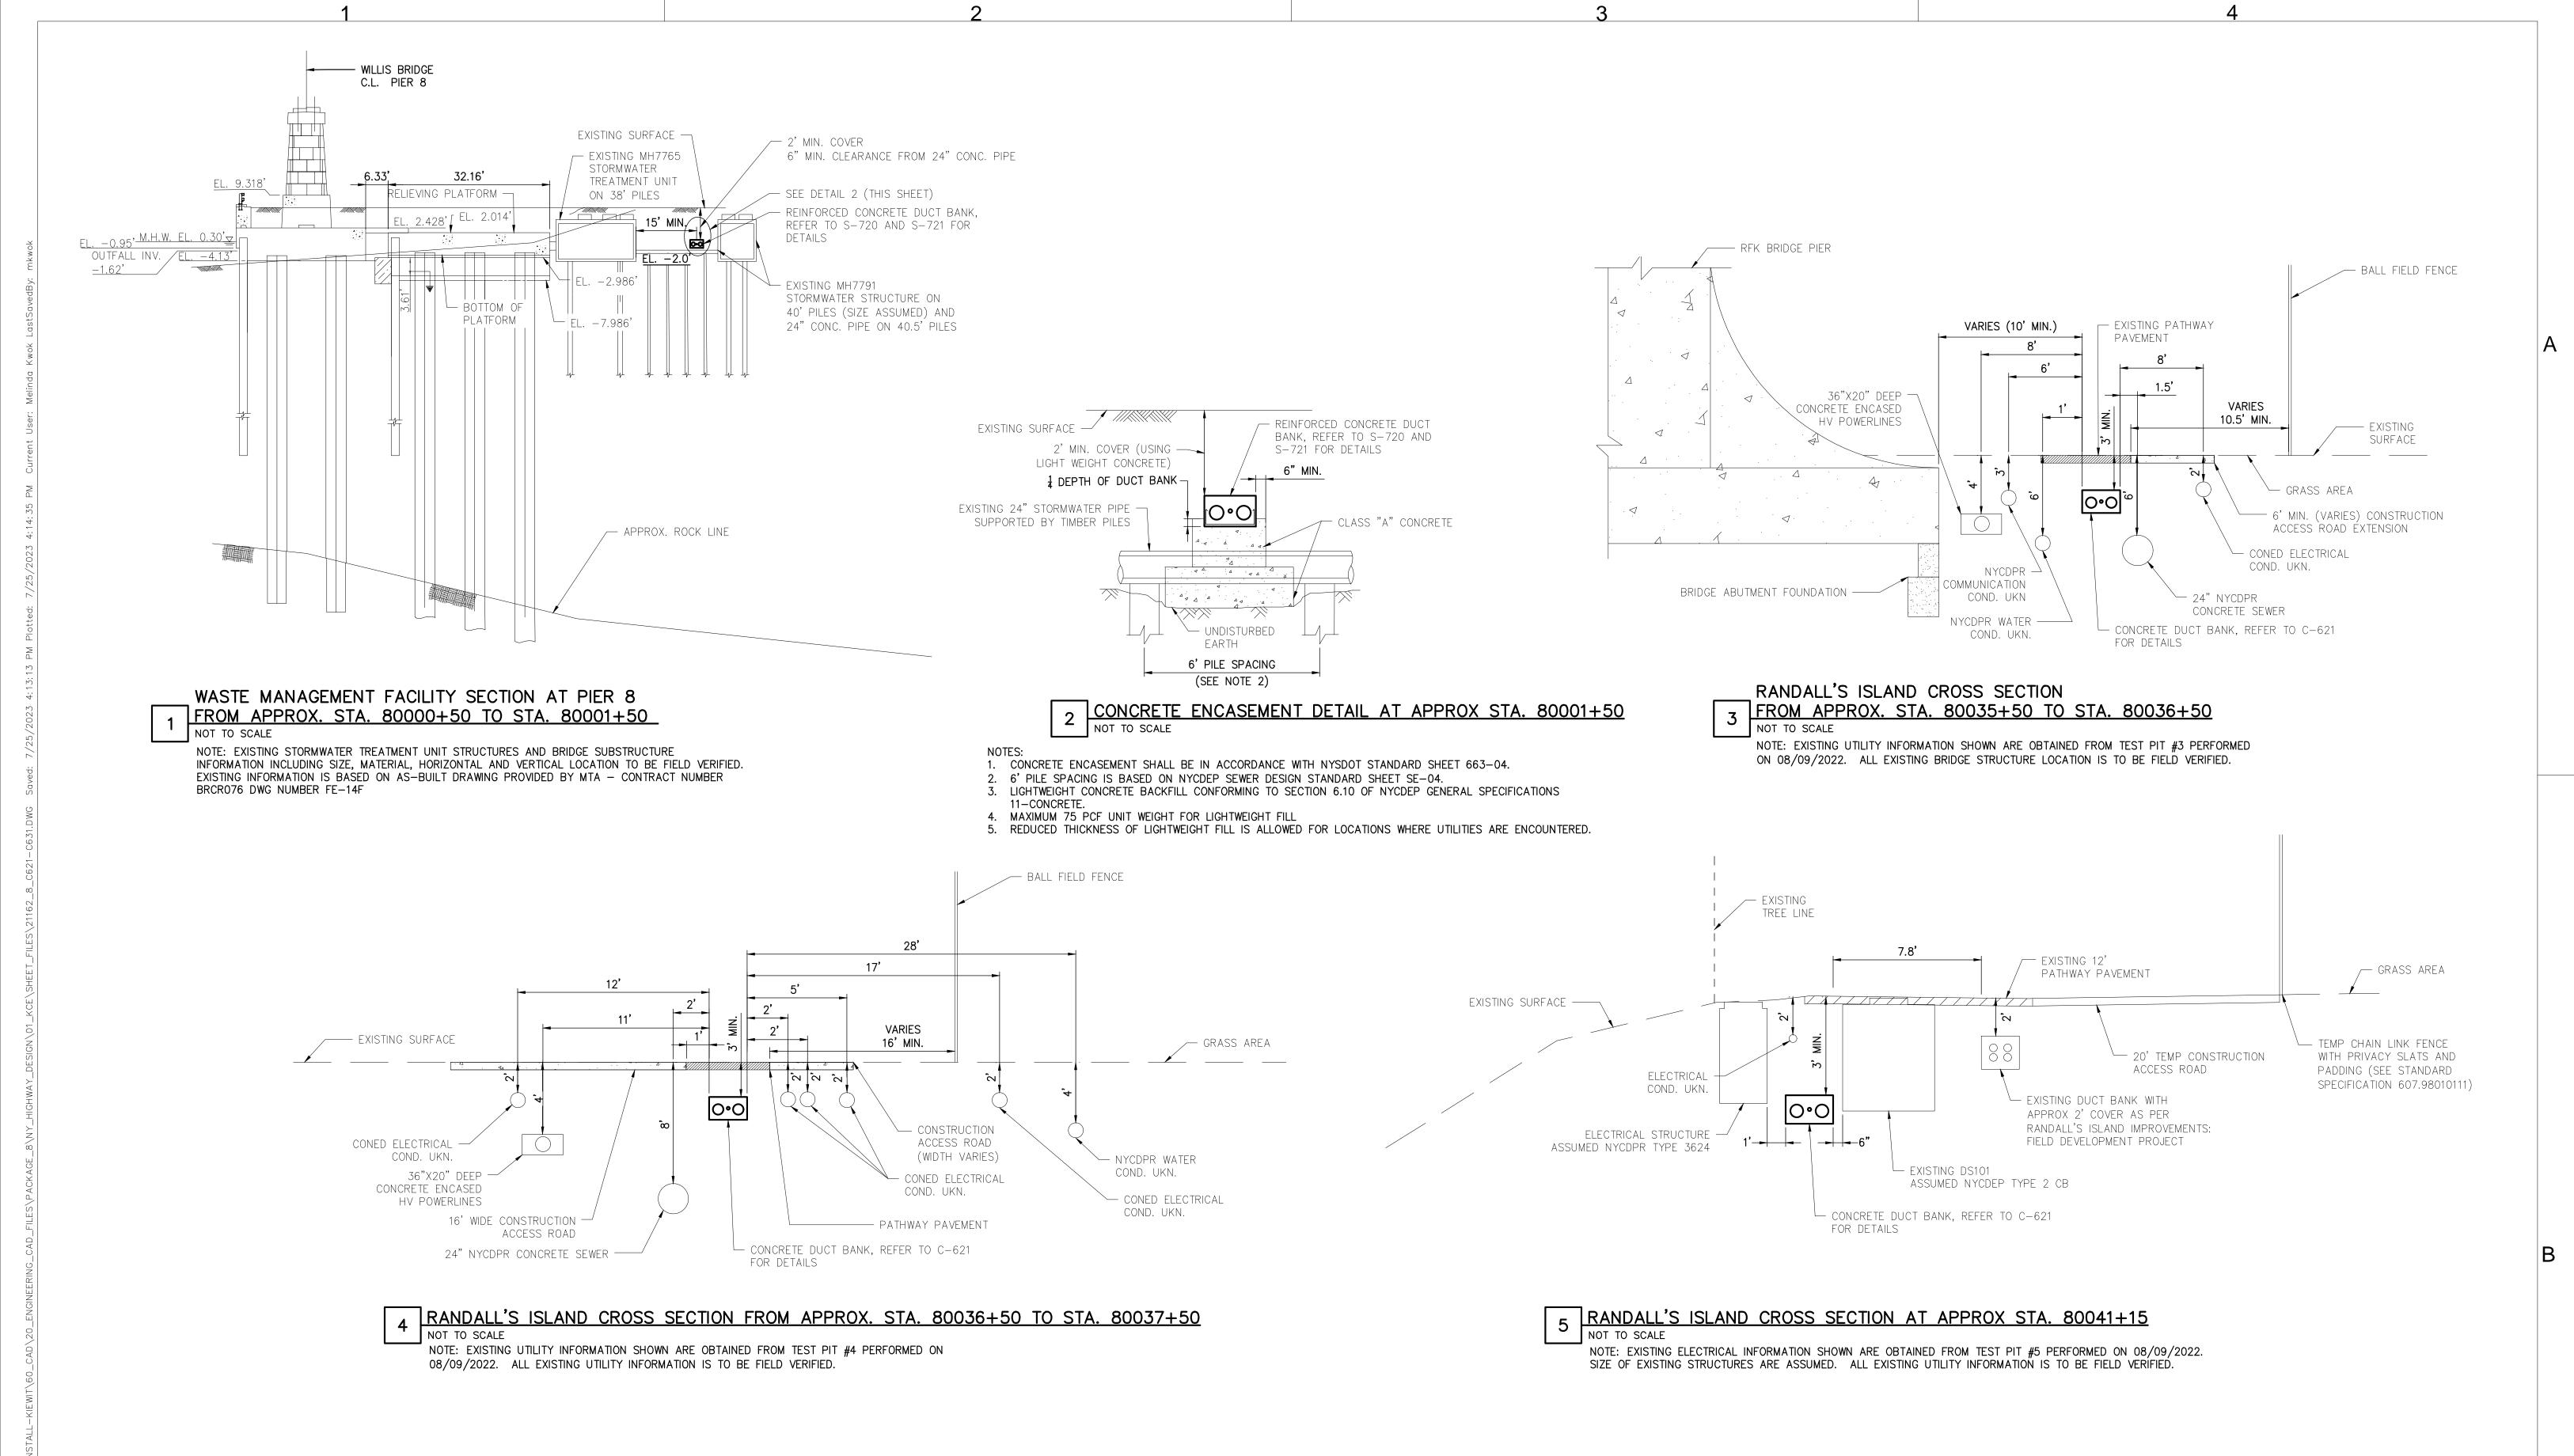
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KIEWIT PROJECT NO.

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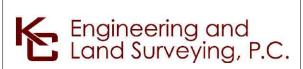
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CHAMPLAIN HUDSON POWER EXPRESS

SEGMENTS 13 TO 15 - PACKAGE 8

TRANSITION VAULT 5 TO ASTORIA CONVERTER STATION


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21162
KC PROJECT NO.
120174
DRAWING NO.

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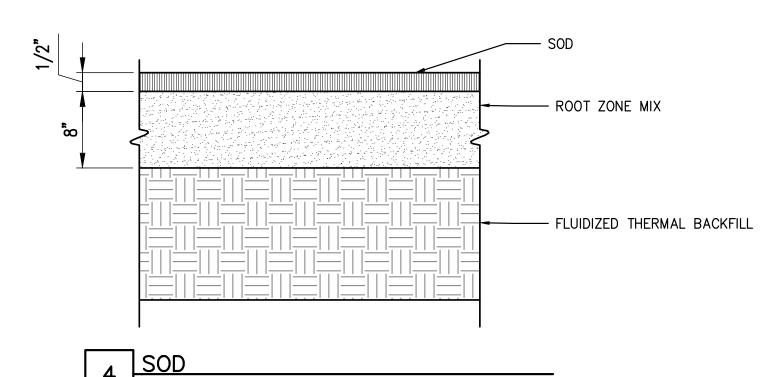
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### ASPHALT PAVEMENT FOR PARK ROADS NOT TO SCALE


NOTE: DETAILS AND DIMENSIONS BASED ON CITY OF NEW YORK PARKS & RECREATION STANDARD DETAILS — 15, DRAWING TITLE: PAVEMENT DETAILS NO. 1



NOTE: DETAILS AND DIMENSIONS BASED ON BRONX SHORE PATHWAYS PROJECT NYCEDC CONTRACT NO. 52370001, DWG. NO: L.5.0

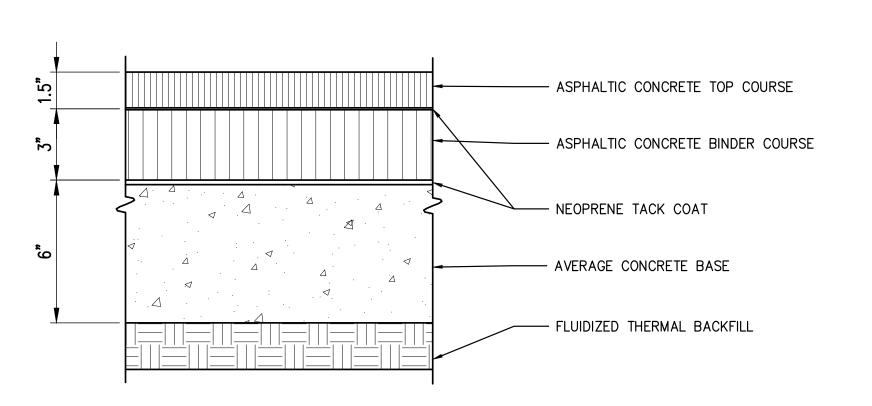NOT TO SCALE

TACK COAT

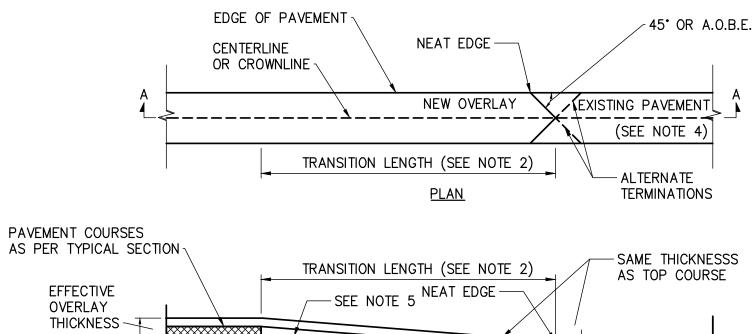


EXISTING HMA OR

CONCRETE PAVEMENT


SECTION A-A

MIX ASPHALT OVERLAY SPLICE

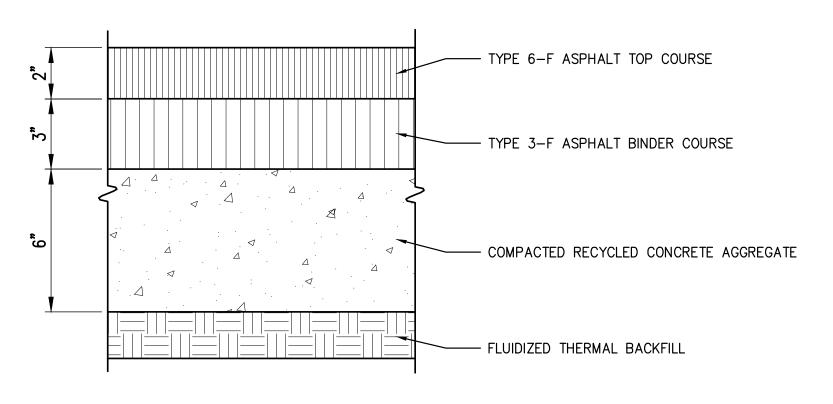

# PEDESTRIAN WALKWAY ASPHALT PAVEMENT

NOTE: DETAILS AND DIMENSIONS BASED ON BRONX SHORE PATHWAYS PROJECT NYCEDC CONTRACT NO. 52370001, DWG. NO: L.5.1

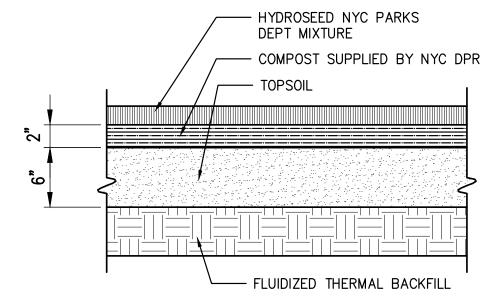

NOT TO SCALE

NOTE: DETAILS AND DIMENSIONS BASED ON BRONX SHORE PATHWAYS PROJECT NYCEDC CONTRACT NO. 52370001, DWG. NO: L.5.0


HOT MIX ASPHALT (HMA) OVERLAY SPLICES SHALL BE USED AT: ENDS OF HMA OVERLAY HIGHWAY SECTIONS, MAJOR INTERSECTIONS, AND OTHER LOCATIONS INDICATED IN THE PLANS.

THE TRANSITION LENGTH IN FEET SHALL NOT BE LESS THAN THE VALUE OBTAINED BY MULTIPLYING THE EFFECTIVE OVERLAY THICKNESS IN INCHES (DIFFERENCE BETWEEN THE EXISTING AND THE OVERLAID ELEVATIONS) BY THE K VALUE FROM THE TABLE FOR THE POSTED SPEED OF THE HIGHWAY. THE MINIMUM TRANSITION LENGTH IS 30'.

EXAMPLE: IF THE POSTED SPEED IS 55 MPH. EFFECTIVE OVERLAY THICKNESS = 2" THEN THE MINIMUM TRANSITION LENGTH = 2" INCHES X 30 FT/IN = 60 FEET

- 3. ALL SURFACES OF THE HMA OVERLAY SPLICE TRANSTION AREA SHALL BE CLEANED AND TACK-COATED PRIOR TO HMA PLACEMENT. THE COST OF MILLING REBATES, AND TACK COAT IN THE HMA OVERLAY SPLICE TRANSITION AREA SHALL BE PAID FOR UNDER THEIR RESPECTIVE ITEMS. COST OF LEAVING A NEAT EDGE SHALL BE INCLUDED IN THE MILLING ITEM.
- SAW CUTS SHALL BE MADE SO THAT SURFACE RUNOFF IS DIRECTED TO THE EDGE OF PAVEMENT.
- 5. IN THE TRANSITION AREA, PAVEMENT COURSES OTHER THAN THE TOP COURSE SHALL BE FEATHERED OUT USING TOP COURSE OR OTHER APPROPRIATE MATERIAL. PAYMENT SHALL BE MADE UNDER THE APPROPRIATE ITEM.

k value table ft/in										
POSTED SPEED MPH	30	35	40	45	50	55	60	65		
К	16.67	19.17	21.67	24.17	27.50	30.00	32.50	35.0		

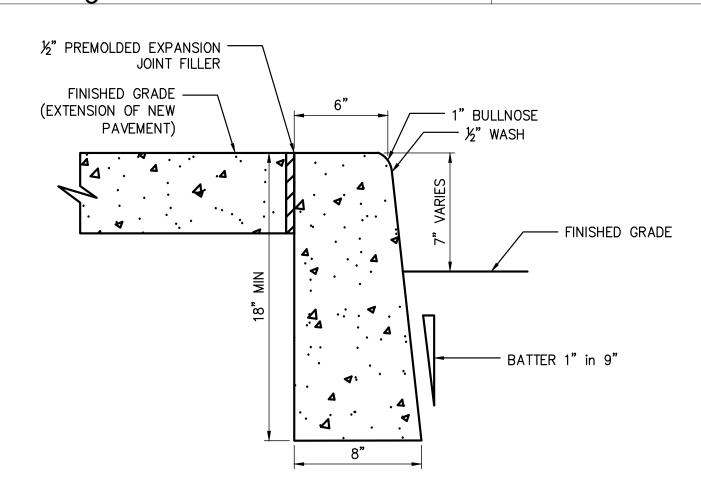

- ALL WORK WITHIN RANDALL'S ISLAND SHALL CONFIRM TO THE CURRENT DESIGN STANDARDS AND SPECIFICATIONS OF NEW YORK CITY DEPARTMENT OF DESIGN AND CONSTRUCTION INCLUDING NYCDOT STANDARD HIGHWAY SPECIFICATIONS OF MAY 2022.
- 2. BRONX SHORE ROAD IN RANDALL'S ISLAND SHALL BE MILLED AND RESURFACED USING 3" ASPHALTIC CONCRETE SURFACE TOP COURSE CURB TO CURB WITHIN LIMITS SHOWN ON PLANS.

CONCRETE STREET CURB

NOTE: DETAILS AND DIMENSIONS BASED ON CITY OF NEW YORK PARKS & RECREATION STANDARD DETAILS - 18, DRAWING TITLE: CURBS, RAMPS, AND MISCELLANEOUS DETAILS

TEMPORARY ACCESS ROAD SECTION <sup>1,2,3,4</sup>							
CBR <sup>5</sup>	UNSTABILIZED	MIRAFI 180N GEOTEXTILE <sup>6</sup>	TENSAR BX1200 GEOGRID <sup>6</sup>	MIRAFI RSI SERIES GEOTEXTILE <sup>6</sup>			
0.5		20 INCH RIP RAP <sup>7</sup> + 6 INCH AGGREGATE		20 INCH RIP RAP <sup>7</sup> + 4 INCH AGGREGATE (RS580I			
1.0		18 INCH AGGREGATE	12 INCH AGGREGATE	15 INCH AGGREGATE (RS280I)			
1.5		12 INCH AGGREGATE	9 INCH AGGREGATE	9 INCH AGGREGATE (RS280I)			
2.0	18 INCH AGGREGATE	11 INCH AGGREGATE	6 INCH AGGREGATE	9 INCH AGGREGATE (RS280I)			
3.0+	15 INCH AGGREGATE	8 INCH AGGREGATE	6 INCH AGGREGATE	9 INCH AGGREGATE (RS280I)			

TEMPORARY ACCESS ROAD SECTIONS PER KIEWIT ENGINEERING (NY) CORP.

AGGREGATE SHALL BE NYSDOT TYPE 2 CRUSHED AGGREGATE OR APPROVED ALTERNATIVE.

<sup>3</sup> DESIGN CONSIDERS 1,000 PASSES OF MAXIMUM 22—KIP AXLE LOAD AND A DESIGN RUT DEPTH OF 3 INCHES. ADDITIONAL AXLE PASSES, HEAVIER AXLE LOADS, AND DETERIORATED SUBGRADE CONDITIONS MAY REQUIRE THICKER AGGREGATE SECTIONS OR ADDITIONAL MAINTENANCE. <sup>4</sup> ALTERNATE TEMPORARY ACCESS ROAD DESIGNS MAY BE PROVIDED BY KIEWIT ENGINEERING, AS REQUIRED, BASED ON FIELD CONDITIONS AND

<sup>5</sup> ESTIMATE CBR IN THE FIELD USING A DYNAMIC CONE PENETROMETER OR ALTERNATIVE METHOD APPROVED BY GEOTECHNICAL ENGINEER OF RECORD (EOR). CBR OF IN-SITU SOIL MAY VARY SEASONALLY DUE TO FREEZE/THAW AND BASED ON MOISTURE CONDITIONS.

- GEOGRID AND GEOTEXTILE A GEOGRID AND GEOTEXTILES SHALL BE INSTALLED PER MANUFACTURER'S SPECIFICATION INCLUDING OVERLAP AND EDGE DETAILS.
- B SPECIFIED GEOTEXTILE OR GEOGRID MAY BE REPLACED BY EQUIVALENT MATERIAL APPROVED BY EOR.
- <sup>C</sup> GEOTEXTILE IS REQUIRED IN REGULATED WETLANDS AND AGRICULTURAL LANDS.
- D GEOTEXTILE SEPARATOR FABRIC IS REQUIRED BENEATH GEOGRID ON COHESIVE SUBGRADE 7 RIP RAP
- A RIP RAP SHALL BE NYSDOT LIGHT STONE FILL OR APPROVED ALTERNATIVE. B A LAYER OF #57 STONE IS RECOMMENDED ON TOP OF GEOTEXTILE TO PREVENT DAMAGING OR PUNCHING OF THE GEOTEXTILE FABRIC WHERE RIP RAP IS USED.

TEMPORARY ACCESS ROAD

-SLOPE AS INDICATED ON PLAN


-LAYER THICKNESS PER TABLE

-FLUIDIZED THERMAL BACKFILL

GEOTEXTILE FABRIC AND/OR

GEOGRID, AS REQUIRED6

ON THIS SHEET

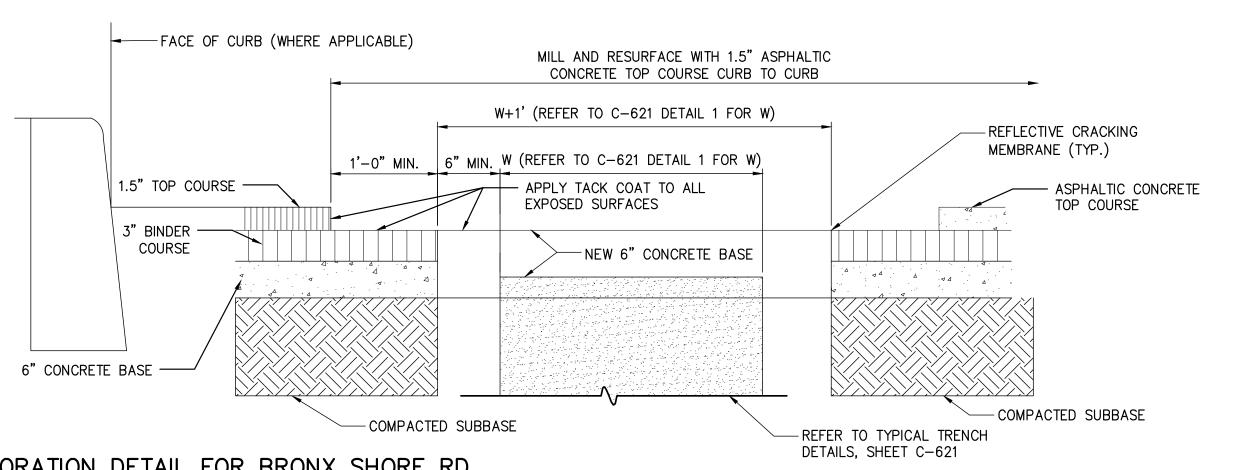

RESTORATION DETAIL FOR BRONX SHORE RD NOT TO SCALE



MILLED REBATE

25' (MIN.)

-PAVEMENT REMOVAL

FOR SPLICE RECESS

("REBATE")



IT IS A VIOLATION OF LAW FOR ANY PERSON, UNLESS THEY ARE ACTING UNDER THE DIRECTION OF A LICENSED ROFESSIONAL ENGINEER, ARCHITECT, LANDSCAPE ARCHITECT OR LAND SURVEYOR TO ALTER AN ITEM IN ANY WAY. IF AN ITEM BEARING THE STAMP OF A LICENSED PROFESSIONAL IS ALTERED, THE ALTERING ENGINEER, ARCHITECT, LANDSCAPE ARCHITECT OR LAND SURVEYOR SHALL STAMP THE DOCUMENT AND INCLUDE THE NOTATION "ALTERED BY" FOLLOWED BY THEIR SIGNATURE, THE DATE OF SUCH ALTERATION, AND A SPECIFIC DESCRIPTION OF THE ALTERATION.

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					SEGMENTS 13 TO 15 - PACKAGE
					TRANSITION VAULT 5 TO ASTORIA CONVERTE
					SURFACE RESTORATION DETAILS
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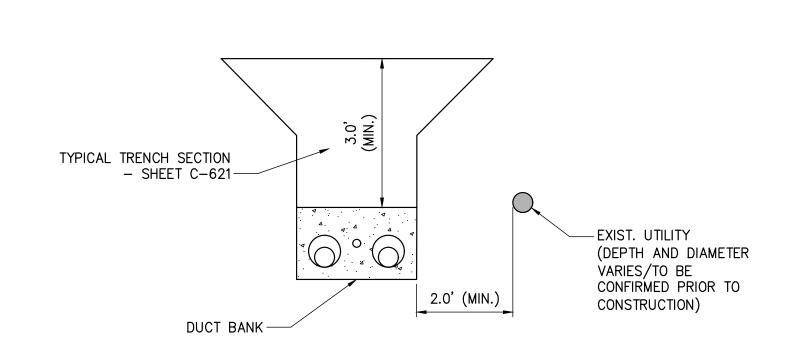
CHAMPLAIN HUDSON POWER EXPRESS **SEGMENTS 13 TO 15 - PACKAGE 8** TRANSITION VAULT 5 TO ASTORIA CONVERTER STATION SURFACE RESTORATION DETAILS

KIEWIT PROJECT NO. 21162 KC PROJECT NO. 120174 DRAWING NO.


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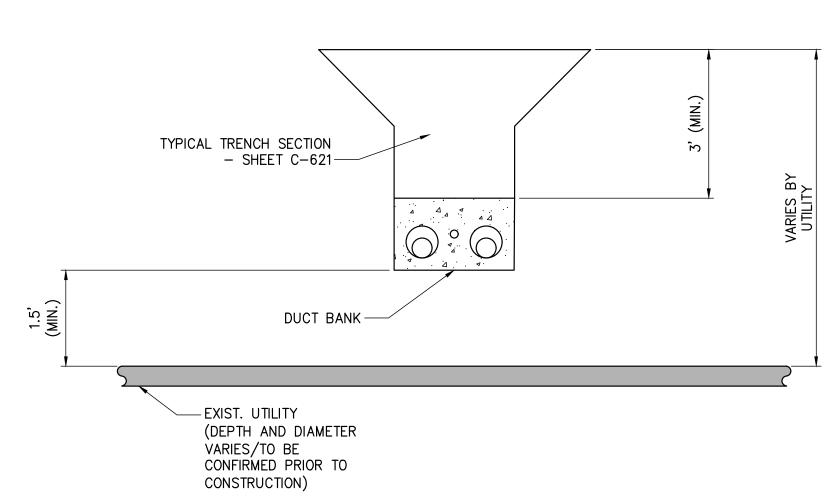
**Power Express** 




1 OPEN TRENCH - HORIZONTAL SEPARATION
NOT TO SCALE




3 OPEN TRENCH - VERTICAL SEPARATION (UNDER)
NOT TO SCALE

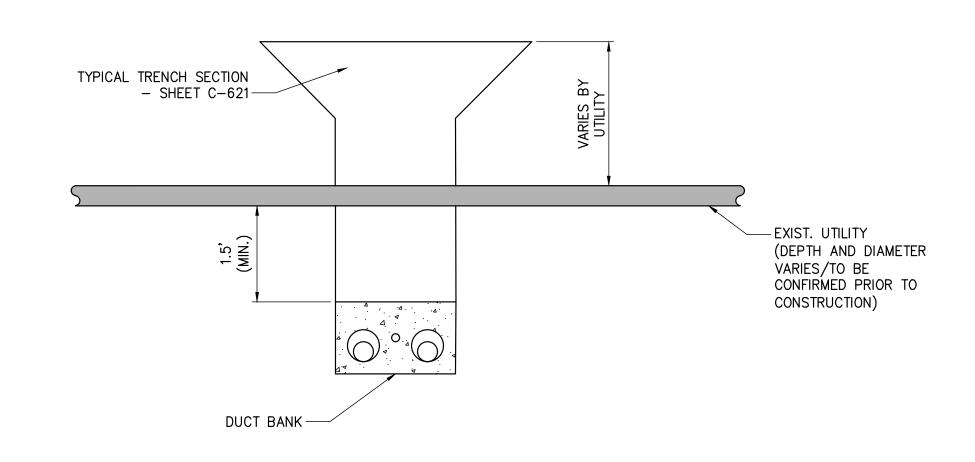


5 OPEN TRENCH - VERTICAL SEPARATION (OVER)
NOT TO SCALE

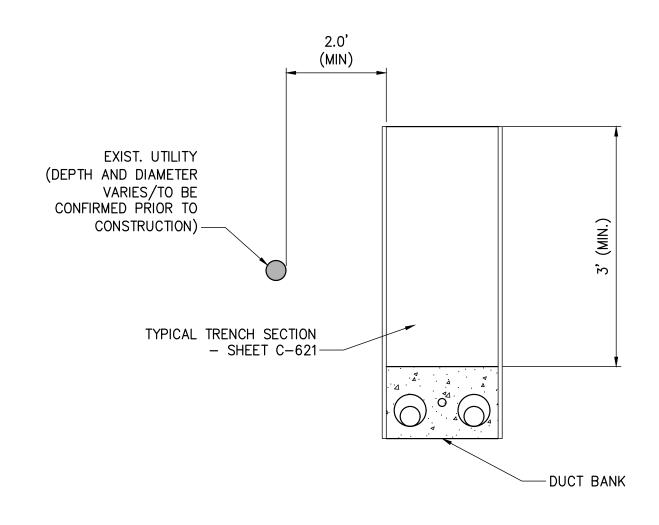

2 TYPICAL DUCTBANK IN ROADWAY - HORIZONTAL SEPARATION
NOT TO SCALE

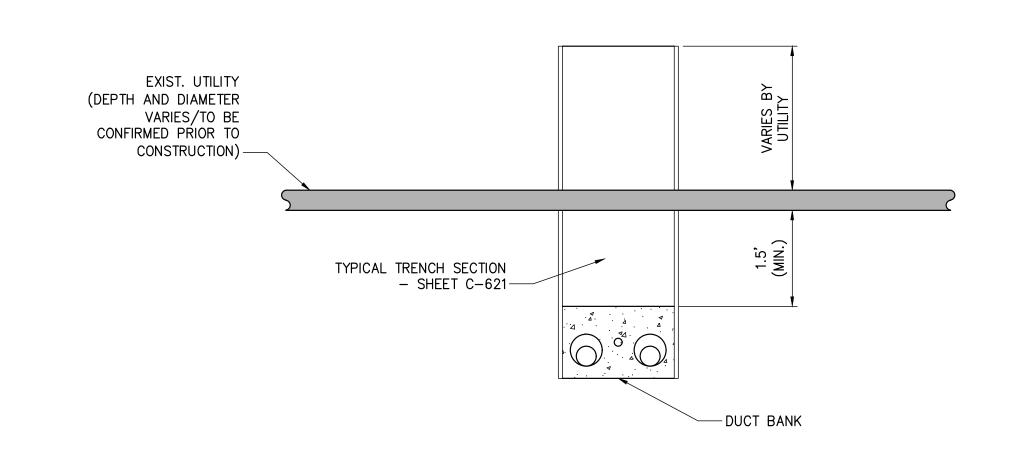

4 TYPICAL DUCTBANK IN ROADWAY - VERTICAL SEPARATION (UNDER)
NOT TO SCALE

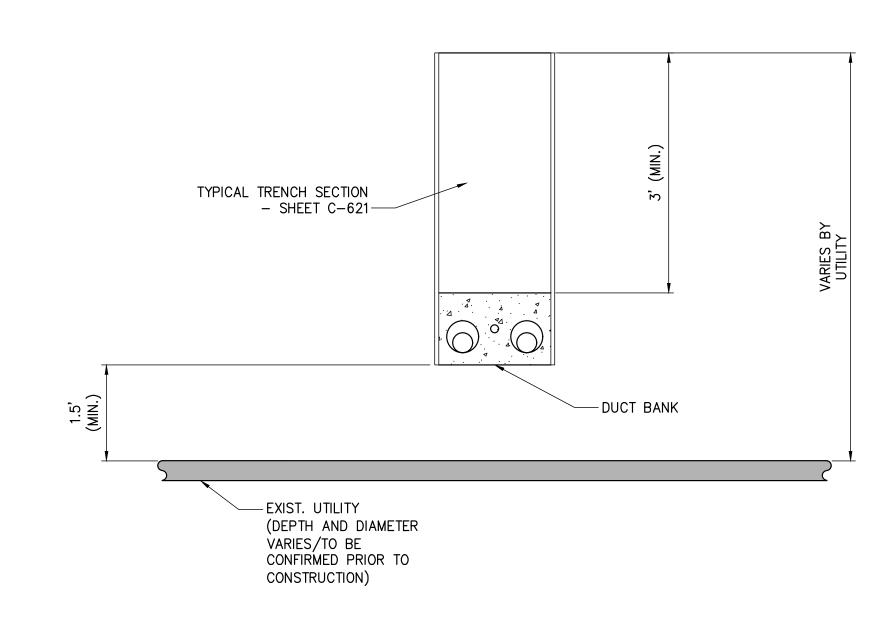

6 TYPICAL DUCTBANK IN ROADWAY - VERTICAL SEPARATION (OVER)
NOT TO SCALE

**Power Express** 



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No.	DATE	SUBMITTAL / REVISION DESCRIPTION	DB	APP	DRAWN BY:

CHAMPLAIN HUDSON POWER EXPRESS SEGMENTS 13 TO 15 - PACKAGE 8 RANSITION VAULT 5 TO ASTORIA CONVERTER STATION UTILITY TYPICAL SEPARATION DETAILS

DESIGNED BY:

APPROVED BY: MW REV. NO.

KIEWIT PROJECT NO. 21162 KC PROJECT NO. 120174 DRAWING NO.

C-901

AS NOTED DATE 0 SH.NO.

### **APPENDIX K – FEMA FIRM MAPS**