


CONTRACTOR TO MAINTAIN INTEGRITY OF CONSTRUCTION FENCE FOR DURATION OF PROJECT.

- NO PRUNING SHALL BE PERFORMED EXCEPT BY APPROVED ARBORIST. 3. NO EQUIPMENT SHALL OPERATE INSIDE THE PROTECTIVE FENCING INCLUDING DURING FENCE
- INSTALLATION AND REMOVAL 4. SEE EROSION CONTROL PLANS FOR LOCATIONS OF TREE PROTECTION AREAS.


TREE PROTECTION

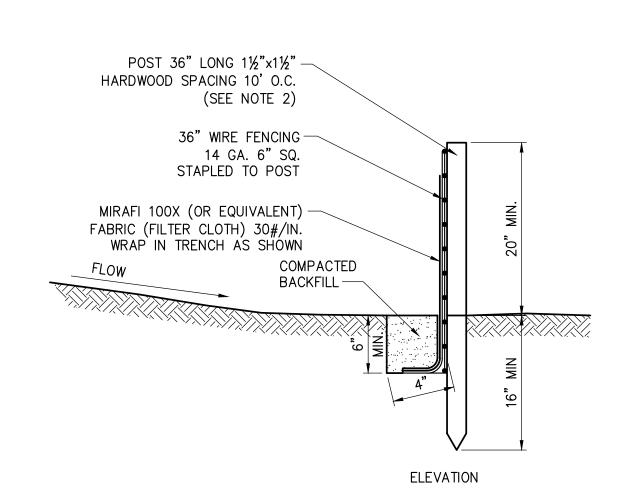

- 1. TIE FABRIC TO WIRE FENCE IN ACCORDANCE WITH MANUFACTURERS RECOMMENDATIONS.
- 2. IF EXTRA STRENGTH FABRIC (GREATER THAN 50#/INCH) IS USED, WIRE CAN BE DELETED IF POST SPACING IS REDUCED TO 6' O.C.
- 3. AT THE ENDS OF THE FENCING THE FIRST 20' SHALL BE TURNED UP THE SLOPE 2'.
- 4. POSTS SHOULD BE INCLINED TOWARD THE DIRECTION FLOW CAME
- 5. OVERLAP FABRIC A MINIMUM OF 6" AND FOLDED AT JOINTS. ATTACH FILTER FABRIC TO STAKES ALLOWING EXTENSION INTO TRENCH AS SHOWN; SECURE TO STAKES AS NOTED.
- 6. THE MAXIMUM AREA OF RUNOFF PER 100LF. OF FENCE SHALL NOT EXCEED 0.25 ACRES.
- MAINTENANCE SHALL BE PERFORMED AS NECESSARY. THE FENCING SHALL BE CHECKED AFTER EVERY STORM TO ENSURE THEIR PROPER FUNCTIONING.
- WHEN FENCE IS NO LONGER NEEDED, THE ACCUMULATED SILT, THE POSTS AND FABRIC SHALL BE REMOVED AND TRENCH BACK FILLED WITH TOPSOIL AND SEEDED.
- 9. FENCING SHOULD BE PLACED AS SHOWN ON THE DRAWING OR IF NOT SHOWN, 10' BEYOND THE TOE OF THE SLOPE AND AT A SPACING IN ACCORDANCE WITH THE TABLE.
- 10. EXCAVATE TRENCH AS PER DETAIL AND SET POSTS AT 10' O.C.
- 11. BACKFILL WITH COMPACTED, EXCAVATED SOIL FROM TRENCH.


-NORTH AMERICAN GREEN S75 OR APPROVED EQUAL ON SUBGRADE, TEMP. SEED MIXTURE MAINTENANCE NOTES: 1. TRAFFIC SHALL NOT BE PERMITTED TO CROSS FILTER FILTER SOCK, SIZED TO SUIT CONDITIONS. -HARDWOOD POST 2. ACCUMULATED SEDIMENT SHALL BE REMOVED WHEN 10' O.C. IT REACHES \(\frac{1}{3}\) OF THE EXPOSED HEIGHT OF THE PRACTICE AND DISPOSED OF IN ACCORDANCE WITH THE SWPPP. 3. SOCKS SHALL BE INSPECTED WEEKLY AND AFTER TOP OF CHANNEL/BANK EACH RUNOFF EVENT. DAMAGED SOCKS SHALL BE REPAIRED IN THE MANNER REQUIRED BY THE WATER FLOW INLET SIDE MANUFACTURER OR REPLACED WITHIN 24 HOURS OF FILTER SOCK SHALL BE PLACED PERPENDICULAR TO THE FLOW INSPECTION NOTIFICATION. BIODEGRADABLE FILTER SOCKS SHALL BE REPLACED ACROSS THE ENTIRE WIDTH OF THE CHANNEL AFTER 6 MONTHS; PHOTO-DEGRADABLE FILTER SOCKS AFTER 1 YEAR. POLY-PROPYLENE SOCKS SHALL BE REPLACED ACCORDING TO THE **FILTER** FILTER COMPOST MATERIAL MANUFACTURER'S RECOMMENDATIONS. SOCK AS PER SPECIFICATIONS. 5. UPON STABILIZATION OF THE AREA CONTRIBUTORY TO THE SOCK, STAKES SHALL BE REMOVED. THE SOCK FILTER SHALL BE REMOVED. FOR REMOVAL THE MESH CAN 1. ALL MATERIAL TO MEET MANUFACTURER SPECIFICATIONS. SOCK SOCK BE CUT AND COMPOST SPREAD AS AN ADDITIONAL MULCH TO ACT AS A SOIL SUPPLEMENT. 2. ALL FILTER SOCKS SHALL BE 12" DIAMETER OR LARGER. BOTTOM OF CHANNEL 3. THE CONTRACTOR SHALL MAINTAIN THE COMPOST FILTER BERM CHANNEL PLACEMENT IN A FUNCTIONAL CONDITION AT ALL TIMES AND IT SHALL BE WORK AREA ROUTINELY INSPECTED. 4. WHERE THE BERM REQUIRES REPAIR. IT WILL BE ROUTINELY REPAIRED. 5. THE CONTRACTOR SHALL REMOVE SEDIMENTS COLLECTED AT THE BASE OF THE BERM WHEN THEY REACH 1/3 OF THE EXPOSED HEIGHT OF THE BERM, OR AS DIRECTED BY THE 6. THE COMPOST FILTER BERM WILL BE REMOVED ON SITE WHEN NO LONGER REQUIRED. AS DETERMINED BY THE OWNERS. 7. INSTALL PERPENDICULAR TO FLOW. AREA TO BE PROTECTED

COMPOST FILTER SOCK DETAIL

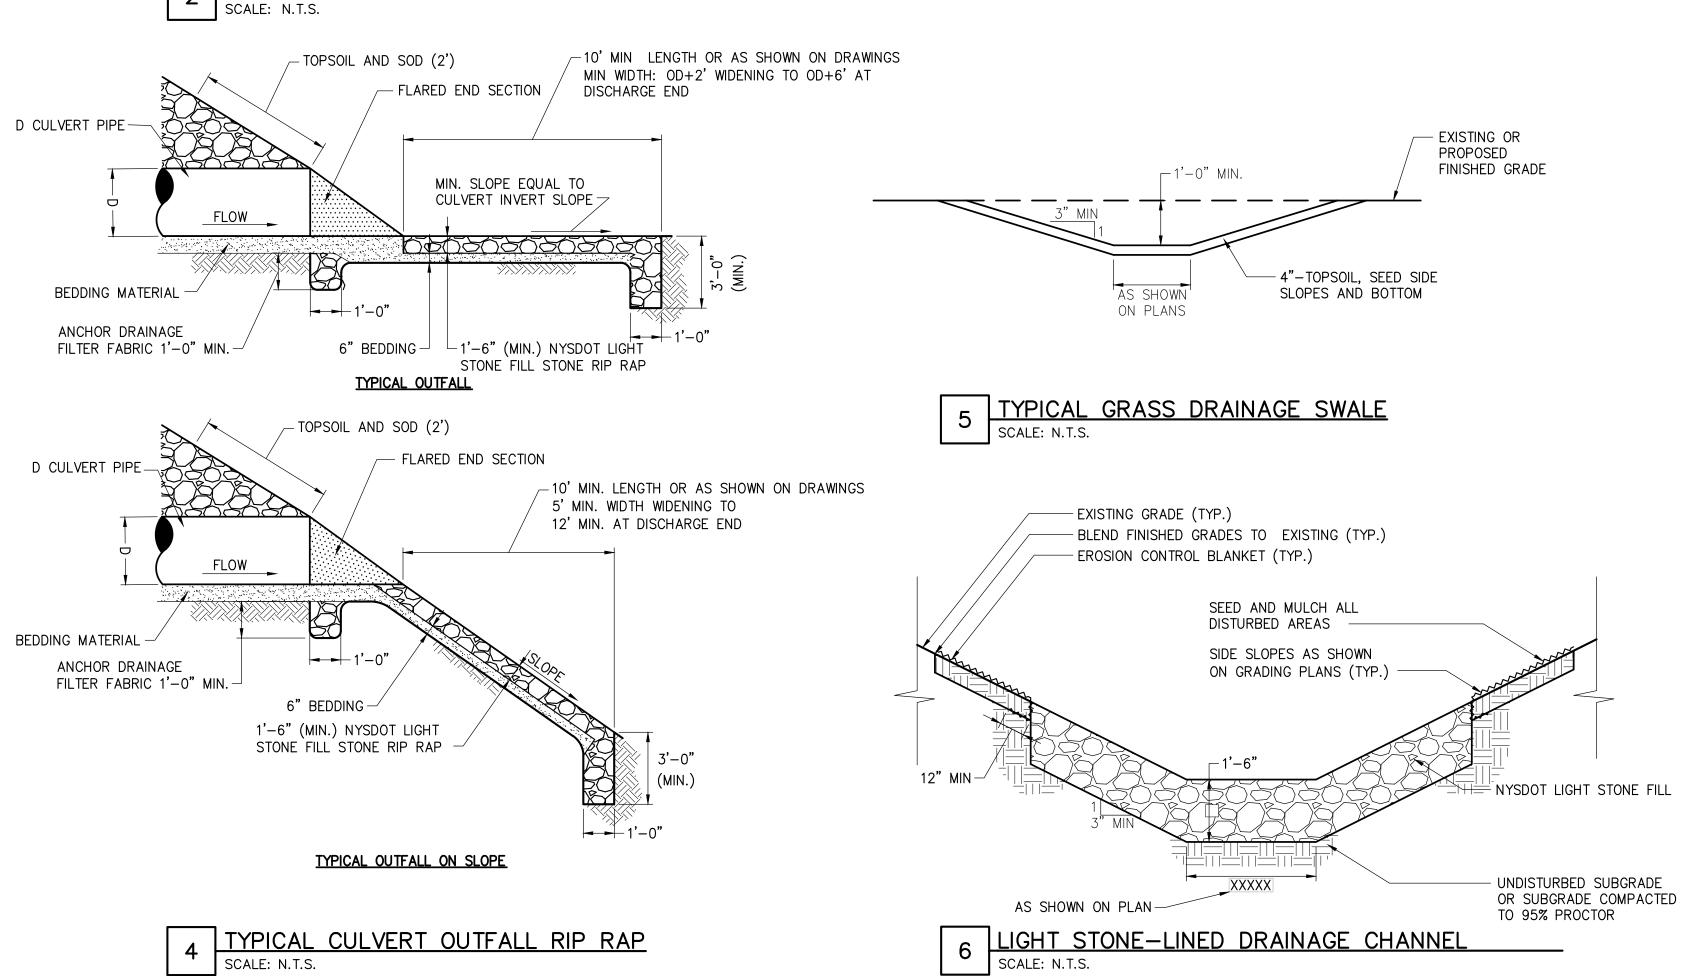

SILT FENCE



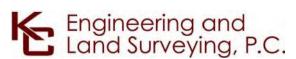

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CHAMPLAIN HUDSON POWER EXPRESS SEGMENT 12 (PACKAGE 7B) - ROUTE 9W: ROCKLAND **EROSION AND SEDIMENT CONTROL DETAILS**


AT GRADE PLACEMENT

KIEWIT PROJECT NO. 21162 KC PROJECT NO. 120174 DRAWING NO.

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Power Express

AS SHOWN DATE XX OF XXX

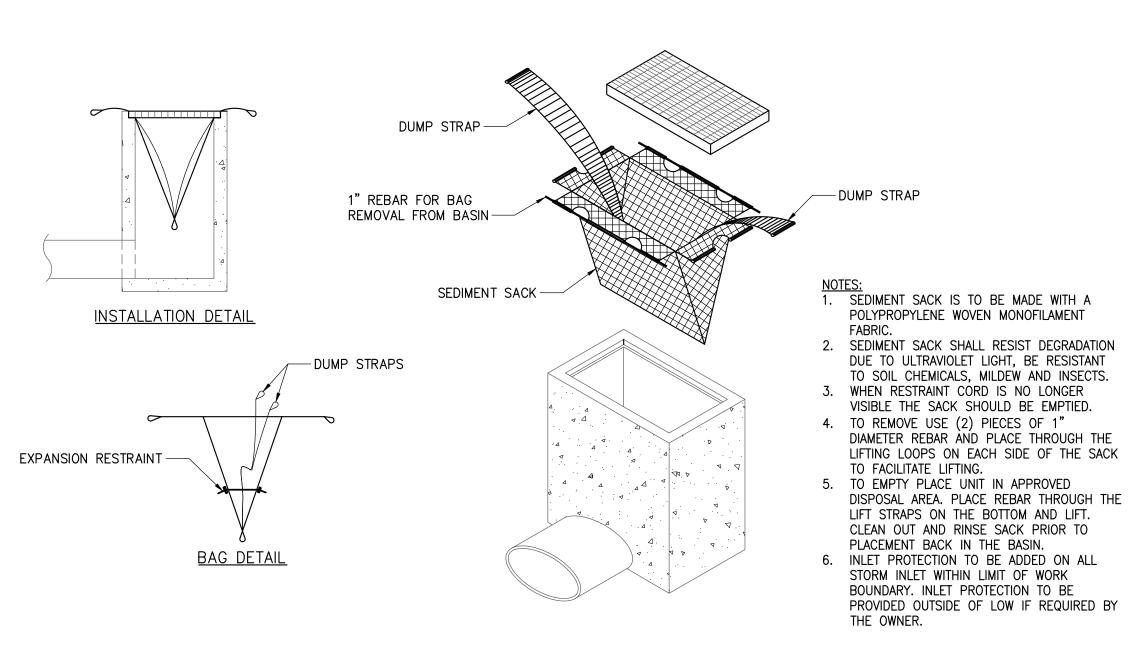


6' LONG 13 GAUGE RUST PROOF -STEEL FENCE POST WITH STABILIZING ANCHOR PLATES -CONSTRUCTION _3/4" POLYPROPYLENE TWIST ROPE, YELLOW BARRIER ROPE -WARNING SIGN (SEE ADJACENT DETAIL) MAX. (SIGNS SPACED AT 48' ON CENTER±) ←EXISTING GRADE

1. CONSTRUCTION BARRIER FENCE SHALL BE INSTALLED IN THE LOCATIONS SHOWN ON THE PLANS PRIOR TO BEGINNING ANY WORK ADJACENT TO THESE AREAS.

- 2. THE CONTRACTOR SHALL INSTALL AT THE BEGINNING OF THE CONTRACT, AND MAINTAIN THROUGHOUT ITS DURATION.
- 3. SET BOTTOM OF CONSTRUCTION BARRIER FENCE FLUSH WITH EXISTING
- 4. CONSTRUCTION BARRIER FENCE SHALL HAVE A MINIMUM TENSILE STRENGTH OF 2000 PSI.

PAVEMENT

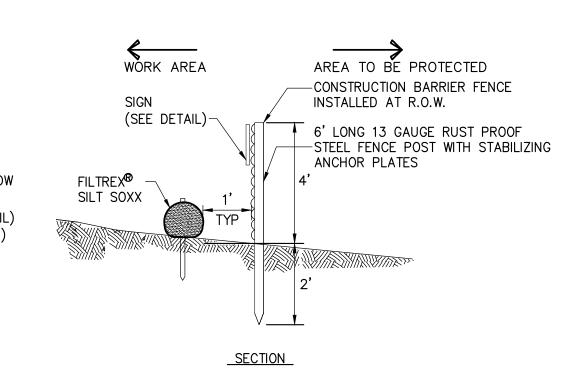



1. EROSION CONTROL BLANKETS TO BE INSTALLED ON SLOPES 3:1 OR GREATER (TYP.)


2. PREPARE SOIL BEFORE INSTALLING BLANKETS, INCLUDING ANY NECESSARY APPLICATION OF LIME, FERTILIZER, AND SEED. NOTE: DO NOT SEED PREPARED AREA. INSTALL WITH PAPER SIDE DOWN. INSTALL ACCORDING TO MANUFACTURERS INSTRUCTIONS.

- BEGIN AT THE TOP OF THE SLOPE BY ANCHORING THE BLANKET IN A 6" DEEP x 6" WIDETRENCH WITH APPROXIMATELY 12" OF BLANKET EXTENDED BEYOND THE UP-SLOPE PORTION OF THE TRENCH. ANCHOR THE BLANKET WITH A ROW OF STAPLES/STAKES APPROXIMATELY 12" APART IN THE BOTTOM OF THE TRENCH. BACKFILL AND COMPACT THE TRENCH AFTER STAPLING. APPLY SEED TO COMPACTED SOIL AND FOLD REMAINING 12" PORTION OF BLANKET BACK OVER SEED AND COMPACTED SOIL. SECURE BLANKET OVER COMPACTED SOIL WITH A ROW OF STAPLES/STAKES SPACED APPROXIMATELY 12" APART ACROSS THE WIDTH OF THE BLANKET.
- 4. ROLL THE BLANKETS (A.) DOWN OR (B.) HORIZONTALLY ACROSS THE SLOPE. BLANKETS WILL UNROLL WITH APPROPRIATE SIDE AGAINST THE SOIL SURFACE. ALL BLANKETS MUST BE SECURELY FASTENED TO SOIL SURFACE BY PLACING STAPLES/STAKES IN APPROPRIATE LOCATIONS. WHEN USING OPTIONAL DOT SYSTEM, STAPLES/STAKES SHOULD BE PLACED THROUGH EACH OF THE COLORED DOTS CORRESPONDING TO THE APPROPRIATE STAPLE PATTERN.
- 5. THE EDGES OF PARALLEL BLANKETS MUST BE STAPLED WITH APPROXIMATELY 2"-5" OVERLAP DEPENDING ON BLANKET TYPE. TO ENSURE PROPER SEAM ALIGNMENT, PLACE THE EDGE OF THE OVERLAPPING BLANKET (BLANKET BEING INSTALLED ON TOP) EVEN WITH THE COLORED SEAM STITCH ON THE PREVIOUSLY INSTALLED BLANKET.
- 6. CONSECUTIVE BLANKETS SPLICED DOWN THE SLOPE MUST BE PLACED END OVER END (SHINGLE STYLE) WITH AN APPROXIMATE 3" OVERLAP. STAPLE THROUGH OVERLAPPING AREA APPROXIMATELY 12" APART ACROSS ENTIRE BLANKET WIDTH.
- 7. TO PROPERLY SECURE THE BLANKETS IN LOOSE SOIL CONDITIONS, THE USE OF STAPLES OR STAKES GREATER THAN 6" MAY BE

EROSION CONTROL BANK STABILIZATION DETAIL

INLET PROTECTION SCALE: N.T.S

WETLAND PROTECTION FENCE

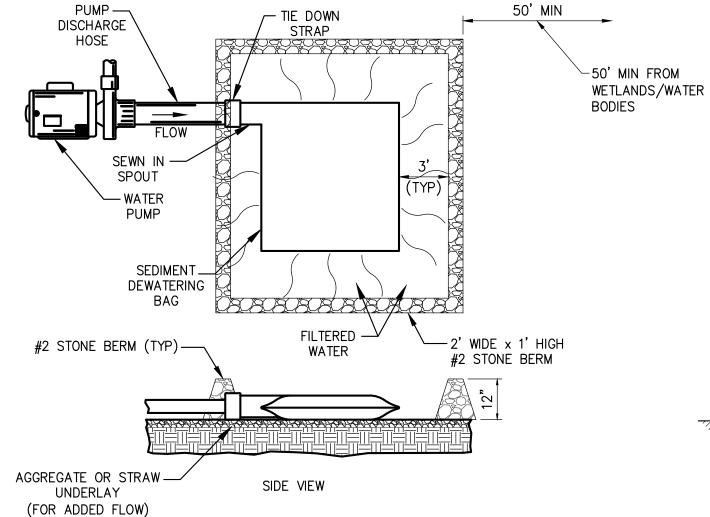


NOTE: THE SEDIMENT DEWATERING BAG WILL BE MANUFACTURED IN THE U.S.A. FROM A NONWOVEN POLYPROPYLENE FABRIC THAT MEETS OR EXCEEDS THE FOLLOWING SPECIFICATIONS:

SEDIMENT DEWATERING BAG SPECIFICATIONS

Mechanical Properties	Test Method	Units	MARV
· ·			
Grab Tensile Strength	ASTM D 4632	kN (lbs)	0.9 (205) x 0.9 (205)
Grab Tensile Elongation	ASTM D 4632	%	50 x 50
Puncture Strength	ASTM D 4833	kN (lbs)	0.58 (130)
Mullen Burst Strength	ASTM D 3786	kPa (psi)	2618 (380)
Trapezoid Tear Strength	ASTM D 4533	kN (lbs)	0.36 (80) X 0.36 (80)
UV Resistence	ASTM D 4355	%	70
Apparent Opening Size	ASTM D 4751	Mm (US Std Sieve)	0.180 (80)
Flow Rate	ASTM D 4491	1/min/m² (gal/min/ft²)	3866 (95)
Permittivity	ASTM D 4491	Sec ⁻¹	1.2

SEDIMENT DEWATERING BAG SCALE: N.T.S.

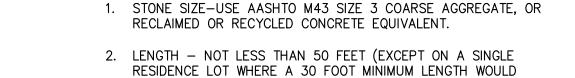

3. THICKNESS - NOT LESS THAN 12".

4. WIDTH - TWELVE (12) FOOT MINIMUM, BUT NOT LESS THAN THE FULL WIDTH AT POINTS WHERE INGRESS OR EGRESS OCCURS. TWENTY-FOUR (24) FOOT IF SINGLE ACCESS TO SITE.

5. WOVEN GEOTEXTILE FABRIC WILL BE PLACED OVER THE ENTIRE AREA PRIOR TO PLACING OF STONE.

6. EXISTING ROAD SIDE DRAINAGE SHALL BE MAINTAINED.

7. SURFACE WATER - ALL SURFACE WATER FLOWING OR DIVERTED TOWARD CONSTRUCTION ENTRANCES SHALL BE PIPED BENEATH THE ENTRANCE. IF PIPING IS IMPRACTICAL, A MOUNTABLE BERM WITH 5:1 SLOPES WILL BE PERMITTED.

8. MAINTENANCE-THE ACCESS SHALL BE MAINTAINED IN A CONDITION WHICH WILL PREVENT TRACKING OR FLOWING OF SEDIMENT ONTO PUBLIC RIGHTS-OF-WAY. THIS MAY REQUIRE PERIODIC TOP DRESSING WITH ADDITIONAL STONE AS CONDITIONS DEMAND AND REPAIR AND/OR CLEANOUT OF ANY MEASURES USED TO TRAP SEDIMENT. ALL SEDIMENT OR STONE SPILLED, DROPPED, WASHED, OR TRACKED ONTO PUBLIC RIGHTS-OF-WAY MUST BE REMOVED IMMEDIATELY.

9. WHEN WASHING IS REQUIRED, IT SHALL BE DONE ON A AREA STABILIZED WITH STONE AND WHICH DRAINS INTO AN APPROVED SEDIMENT TRAPPING DEVICE.

10. PERIODIC INSPECTION AND NEEDED MAINTENANCE SHALL BE PROVIDED AFTER EACH RAIN.

-100' MIN FROM WETLANDS/WATER **BODIES** 8' MIN. 18" ALL CONCRETE SHALL NCHOR BALES WITH WASHOUT HERE (2) 2"x2"x4' STAKES PER BALE -POLYETHYLENE BALES TO BUTT -AGGREGATE — <u>PLAN</u> WASHOUT SIGN (TYPICAL) EXISTING GRADE -STRAW BALE (TYPICAL) POLYETHYLENE

-WHITE LETTERING ON

RED BACKGROUND.

FASTEN TO FENCE

FENCE POST

-6" MIN IMBEDMENT SHEETING **_**______ ---WOOD STAKE (TYPICAL) SEASONAL HIGH 6" MIN DEPTH AGGREGATE

TYPICAL SECTION CONCRETE WASHOUT AREA

TRUCKS BLACK LETTERS ON WHITE BACKGROUND GALVANIZED "U" CHANNEL POST -FINISH GRADE IN A PROMINENT LOCATION AT WASHOUT AREA

> 6. LOCATION(S) TO BE DETERMINED IN THE FIELD BY THE OWNER'S REPRESENTATIVE

LANDFILL.

MAINTENANCE NOTES:

FILTER STRIP

DISPOSED OF OFF SITE.

1. ALL CONCRETE WASHOUT FACILITIES SHALL BE

INSPECTED DAILY. DAMAGED OR LEAKING

FACILITATES SHALL BE DEACTIVATED AND

A STABILIZED AREA SUCH AS A GRASS

REMOVED WHEN 75% OF THE STORAGE

A CONTAINMENT VESSEL AND PROPERLY

3. DISPOSAL OF THE HARDENED MATERIAL SHALL

4. THE PLASTIC LINER SHALL BE REPLACED WITH

5. INSPECT THE PROJECT SITE FREQUENTLY TO

EACH CLEANING OF THE WASHOUT FACILITY.

ENSURE THAT NO CONCRETE DISCHARGES ARE

AS SHOWN DATE

TAKING PLACE IN NON-DESIGNATED AREAS.

2. ACCUMULATED HARDENED MATERIAL SHALL BE

CAPACITY OF THE STRUCTURE IS FILLED. ANY

EXCESS WASH WATER SHALL BE PUMPED INTO

BE OFF-SITE IN A CONSTRUCTION/DEMOLITION

REPAIRED OR REPLACED IMMEDIATELY. EXCESS

RAINWATER THAT HAS ACCUMULATED OVER

HARDENED CONCRETE SHALL BE PUMPED TO

7. CONCRETE WASHOUTS SHALL NOT BE LOCATED WITHIN 200' OF ANY KNOWN WELL.

SCALE: N.T.S.

ALL AROUND

5 STABILIZED CONSTRUCTION ACCESS SCALE: N.T.S.

PER PLAN OR 50' MIN.

PROFILE

PLAN VIEW

20'

EXISTING


PAVEMEN⁻

WOVEN GEOTEXTILE

EXISTING GROUND

Power Express



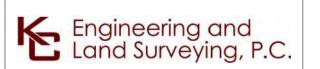

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CHAMPLAIN HUDSON POWER EXPRESS SEGMENT 12 (PACKAGE 7B) - ROUTE 9W: ROCKLAND

KIEWIT PROJECT NO. 21162 KC PROJECT NO. 120174 DRAWING NO.

- UNDERNEATH

UNROLL

DIRECTION

ROLL

//

OVERLAP


UPPER ROLL

C-602

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EROSION AND SEDIMENT CONTROL DETAILS BL BD


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WATERWAY FLOW REFER TO NOTE 6 -APPROXIMATE WETLAND BOUNDARY -TIMBER MAT -SWALE OR WATERBAR (IF NECESSARY) (REFER TO DETAIL ON <u>PLAN VIEW</u> DWG. C-612)

8"X4'X16' MAT OR 12"X4'X16' MAT (TYP.)— EXISTING GRADE — ! APPROXIMATE WETLAND! BOUNDARY - TRANSITION TO TIMBER MATS AS NECESSARY SECTION A-A'

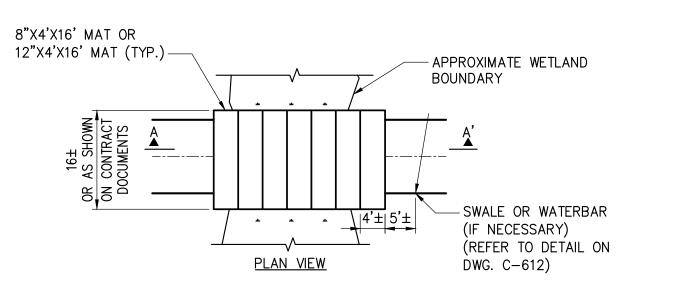- 1. TIMBER MATS SHOULD BE INSTALLED IN WETLANDS AND OTHER AREAS IF NECESSARY TO PREVENT RUTTING.
- 2. FOR CROSSINGS WITH LARGER SPANS THE CONTRACTOR SHALL CONSULT WITH THE TEMPORARY STRUCTURES AND CONSTRUCTION DEVICES ENGINEER.
- 3. TIMBER MAT SURFACE SHOULD BE LEVEL TO PREVENT EQUIPMENT AND VEHICLES FROM SLIDING OFF DURING MUDDY OR ICING CONDITIONS, AND PREVENT TIMBERS FROM BREAKING. 4. SEDIMENT TRACKED ONTO TIMBER MATTING SHOULD BE REMOVED AS NECESSARY TO PREVENT SEDIMENT FROM ENTERING WETLAND DURING RAIN EVENTS. SEDIMENT SHOULD BE
- REMOVED TO A STABILIZED SOIL STOCKPILE OR OTHER APPROVED LOCATION. 5. PERIMETER EROSION AND SEDIMENT CONTROLS ARE REQUIRED TO BE INSTALLED PRIOR TO PLACING TIMBER MATTING.
- 6. UNLESS PERMITTED FROM REMOVAL, STUMPS WITHIN THE WETLAND SHOULD REMAIN. THIS MAY REQUIRE ADDITIONAL TIMBERS TO BRIDGE ABOVE.
- 7. UPON REMOVAL OF TIMBER MATTING ALL SPLINTERED WOOD SHOULD BE REMOVED. IF
- EXPOSED SOILS ARE PRESENT STRAW MULCH SHOULD BE APPLIED. 8. ALL EQUIPMENTS SHOULD MAINTAIN A MINIMUM OF 2 FT SETBACK FROM EDGE OF THE MATS WHILE CROSSING.
- 9. SINGLE OR MULTIPLE LAYERS OF MATS SHALL BE PLACED BASED ON EXISTING SOIL CONDITIONS.



- 1. IN-STREAM EXCAVATION SHOULD BE COMPLETED IN ACCORDANCE WITH "TEMPORARY ACCESS WATERWAY CROSSING" ON PAGE 2.32 OF THE 2016 NYSDEC STANDARDS AND SPECIFICATIONS FOR EROSION AND SEDIMENT CONTROL (OR NEWEST VERSION) AND IN
- ACCORDANCE WITH SECTION 9.1 WATER BODIES IN THE PROJECT EM&CP. 2. THE CONSTRUCTION OF ANY CROSSING SHOULD NOT CAUSE A SIGNIFICANT WATER LEVEL DIFFERENCE BETWEEN THE UPSTREAM AND DOWNSTREAM WATER SURFACE ELEVATIONS. FISH SPAWNING OR MIGRATION DATES CAN VARY ACROSS NEW YORK, AND RESTRICTIONS IMPOSED BY THE NYSDEC MY VARY AND MUST BE VERIFIED. REFER TO CERTIFICATE OF CONDITIONS.
- 3. ALL FILL MATERIALS ASSOCIATED WITH THE ROADWAY APPROACH SHOULD BE LIMITED TO A MAXIMUM HEIGHT OF 2 FT ABOVE THE EXISTING FLOOD PLAIN ELEVATION.
- 4. A WATER DIVERTING STRUCTURE SUCH AS A SWALE OR WATER BAR SHOULD BE CONSTRUCTED (ACROSS THE ROADWAY ON BOTH ROADWAY APPROACHES) 50 FEET (MAXIMUM) ON EITHER SIDE OF THE WATERWAY CROSSING. THIS WILL PREVENT ROADWAY SURFACE RUNOFF FROM DIRECTLY ENTERING THE WATERWAY. THE 50 FEET MEASURED IS MEASURED FROM THE TOP OF THE WATERWAY BANK. IF THE ROADWAY APPROACH IS CONSTRUCTED WITH A REVERSE GRADE AWAY FROM THE WATERWAY, A SEPARATE DIVERTING STRUCTURE IS NOT REQUIRED.
- 5. ALL EQUIPMENTS SHOULD MAINTAIN A MINIMUM OF 2 FT SETBACK FROM EDGE OF THE MATS WHILE CROSSING.
- CONTRACTOR SHALL CONSULT WITH TEMPORARY STRUCTURES AND CONSTRUCTION DEVICES ENGINEER FOR APPROPRIATE MATTING SIZES AND LENGTHS AND REQUIRED SOIL BEARING PRESSURES.

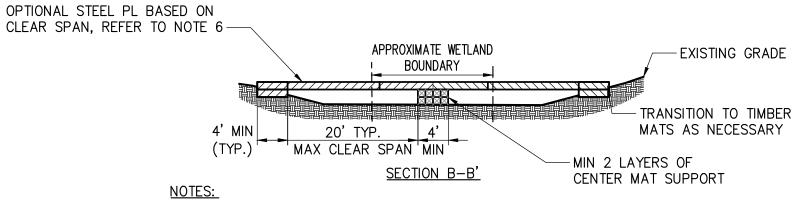TIMBER MATTING (WETLAND CROSSING)

GENERAL NOTES:

- 1. TIMBER SHALL BE SELECT STRUCTURAL MIXED OAK WITH A MINIMUM BENDING STRESS OF 1250 PSI OR BETTER.
- CONTRACTOR TO VERIFY ALL DIMENSIONS AND SITE CONDITIONS PRIOR TO COMMENCING WORK. ANY ERRORS, OMISSIONS, OR UNUSUAL CONDITIONS ARE TO BE REPORTED TO THE TEMPORARY STRUCTURES AND CONSTRUCTION DEVICES ENGINEER







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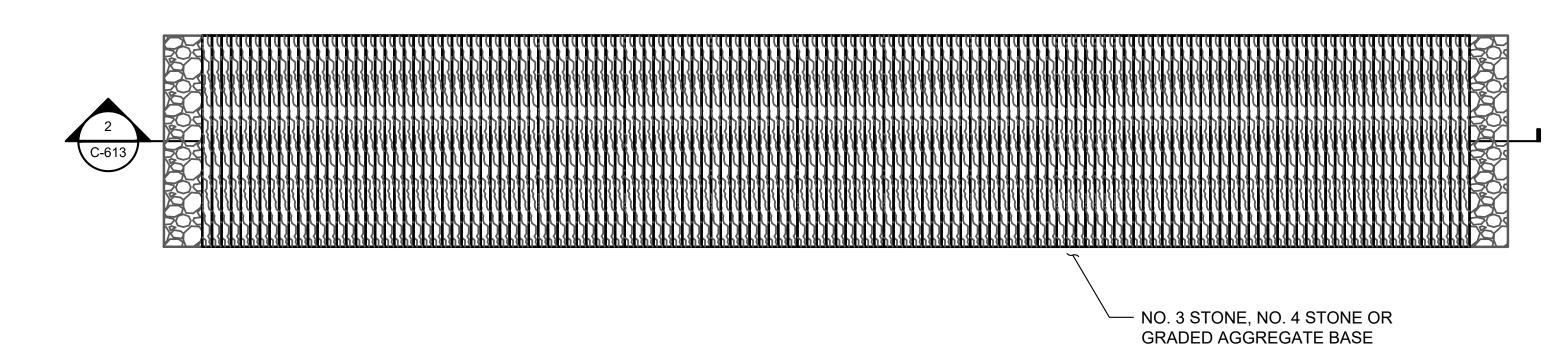
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CHAMPLAIN HUDSON POWER EXPRESS SEGMENT 12 (PACKAGE 7B) - ROUTE 9W: ROCKLAND WETLAND CROSSING DETAILS

KIEWIT PROJECT NO. 21162 KC PROJECT NO. 120174 DRAWING NO.


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AS SHOWN DATE DB | APP | DRAWN BY: BL | DESIGNED BY: BL | APPROVED BY: BD | REV. NO. XX OF XXX



WETLAND WORKING SURFACE PLAN - OPTION A

WETLAND WORKING SURFACE PLAN - OPTION B

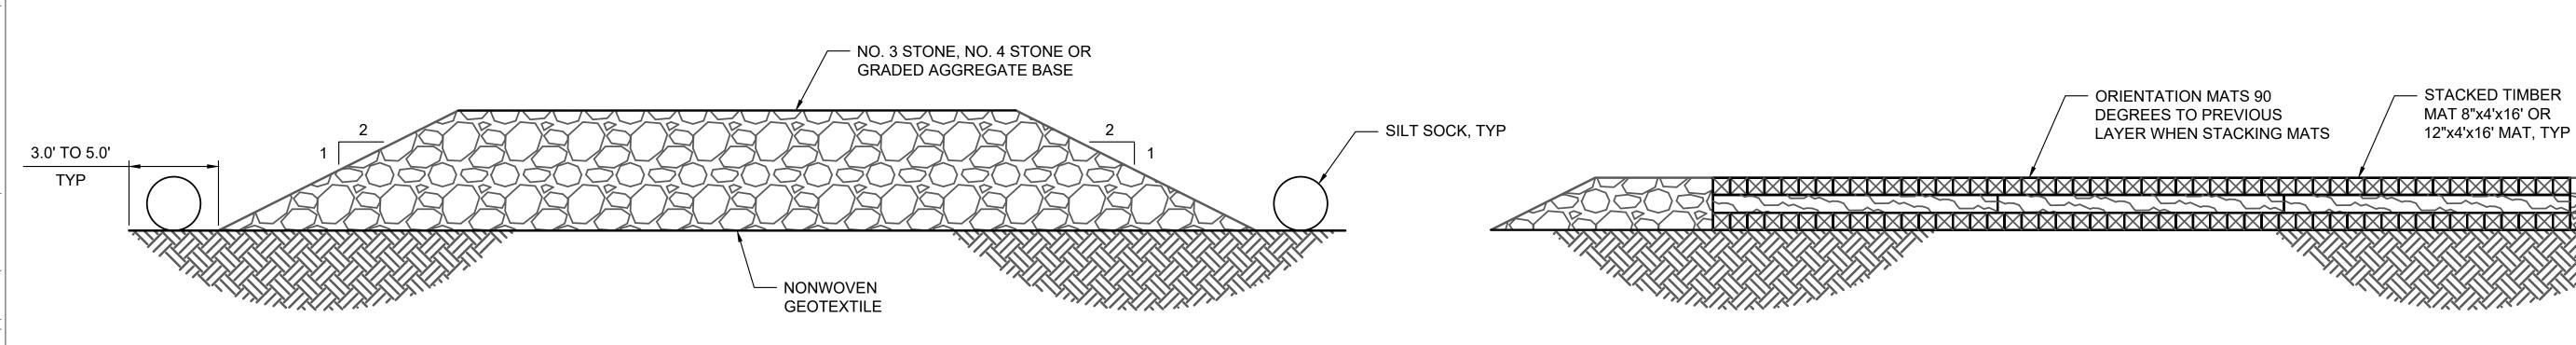

SECTION NOT TO SCALE

NOTES:

- 1. UNDERCUT AND REMOVE TOP SOIL PRIOR TO PLACING GEOTEXTILE FABRIC.
- 2. A LAYER OF CLEAN CRUSHED STONE SHALL BE LAID ON
- TOP OF THE GEOTEXTILE FABRIC.
- GEOTEXTILE FABRIC SHALL EXTEND AT LEAST 3 FT TO 5 FT BEYOND THE EDGE OF STONE PLACEMENT TO MINIMIZE STONE ENTERING THE WETLAND AND FACILITATE REMOVAL OF THE ROAD.
- 4. SUITABLE CROSS DRAINING SHALL BE PROVIDED ACROSS THE ROAD FOR STREAM CHANNELS AND SURFACE FLOW.

GENERAL NOTES:

- TIMBER:
 - A. TIMBER SHALL BE SELECT STRUCTURAL MIXED OAK WITH A MINIMUM BENDING STRESS OF 1250 PSI
- 2. CONTRACTOR TO VERIFY ALL DIMENSIONS AND SITE CONDITIONS PRIOR TO COMMENCING WORK. ANY ERRORS, OMISSIONS, OR UNUSUAL CONDITIONS ARE TO BE REPORTED TO THE TEMPORARY STRUCTURES AND CONSTRUCTION DEVICES ENGINEER IMMEDIATELY.




NOTES:

- 1. TIMBER MATS SHOULD BE INSTALLED IN WETLANDS AND OTHER AREAS IF NECESSARY TO PREVENT RUTTING.
- 2. BASED ON ACTUAL SITE CONDITIONS, NUMBER OF TIMBER MAT
- LAYERS TO BE DETERMINED ON SITE.
- TIMBER MAT SURFACE SHOULD BE LEVEL TO PREVENT EQUIPMENT AND VEHICLES FROM SLIDING OFF DURING MUDDY OR ICING CONDITIONS, AND PREVENT TIMBERS FROM BREAKING.
- SEDIMENT TRACKED ONTO TIMBER MATTING SHOULD BE REMOVED AS NECESSARY TO PREVENT SEDIMENT FROM ENTERING WETLAND DURING RAIN EVENTS. SEDIMENT SHOULD BE REMOVED TO A STABILIZED SOIL STOCKPILE OR OTHER APPROVED LOCATION.
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- 7. UPON REMOVAL OF TIMBER MATTING ALL SPLINTERED WOOD SHOULD BE REMOVED. IF EXPOSED SOILS ARE PRESENT STRAW MULCH SHOULD BE APPLIED.
- 8. GEOTEXTILE FABRIC TO BE INSTALLED UNDER MATTING. (TYP)





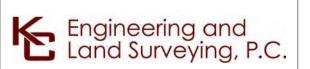

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CHAMPLAIN HUDSON POWER EXPRESS SEGMENT 12 (PACKAGE 7B) - ROUTE 9W: ROCKLAND WETLAND WORKING SURFACE

KIEWIT PROJECT NO. 21162 KC PROJECT NO. 120174 DRAWING NO.

C-613

AS SHOWN DATE DB APP DRAWN BY: BL DESIGNED BY: BL APPROVED BY: BD REV. NO. F SH.NO. XX OF XXX

NONWOVEN

GEOTEXTILE

DUCTBANK OUTSIDE OF NYSDOT ROW

1. SLOPING, BENCHING, OR SHORING SHALL BE IN ACCORDANCE WITH OSHA EXCAVATION STANDARDS, 29 CFR PART 1926, SUBPART P. AT LOCATIONS WHERE THE TRENCH IS NOT SHORED, SLOPING AND/OR BENCHING WILL DEPEND ON TYPE OF SOILS ENCOUNTERED ON SITE. SLOPE FROM EDGE OF ROADWAY TO BOTTOM OF EXCAVATIONS MAY BE FLATTER THAN 2:1 (H: V) FOR AASHTO HS-20 LOADING. THE CONTRACTOR SHALL BE RESPONSIBLE FOR EVALUATING SLOPE STABILITY BASED ON ACTUAL EQUIPMENT FOR SITE OPERATIONS AS DETERMINED BY A GEOTECHNICAL ENGINEER.

2. SEE DETAIL 1 ON DETAIL SHEET C-631 FOR PAVEMENT TRANSITION DETAIL.


3. SEE SHEET C-631 FOR SURFACE RESTORATION DETAILS. PARK ROAD RESTORATION IN STONY POINT SHALL HAVE 2" HMA SURFACE COURSE, 3" HMA BINDER BASE COURSE, AND 8" DENSE GRADE AGGREGATE SUB-BASE.


4. SEE PLAN AND PROFILE SHEETS FOR CONDUIT & TO & AND DUCTBANK SIZE TRENCH WIDTH (NOTE ABOVE PROFILE VIEW).

ROCKLAND COUNTY DUCTBANK IN NYSDOT ROW

5. DEPTH OF COVER TO CONCRETE DUCTBANK SHALL BE 3' MIN OUTSIDE NYSDOT ROW.

1 TYPICAL TRENCHING DETAILS
NOT TO SCALE

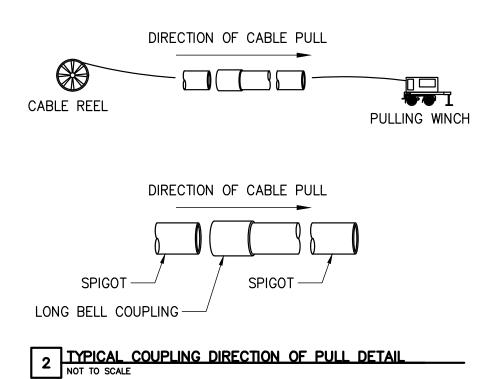

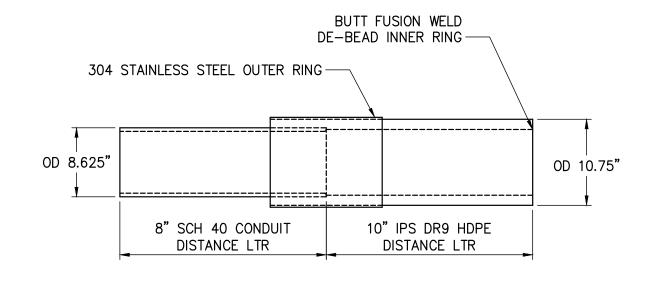

DUCT BANK IN GRASS AREA

3 8"-10" PVC/HDPE TRANSITION COUPLING DETAIL

NOT TO SCALE

THIS TRANSITION COUPLING COMES ASSEMBLED AS A UNIT. POLY-CAM, ISCO INDUSTRIES P/N: 737-1008PVC40PVI09 TRANSITION COUPLING SHALL ARRIVE FROM VENDOR WITH NO ROUGH EDGES OR PROTRUSIONS ON INTERIOR. INTEGRITY OF COUPLING TO BE FIELD-VERIFIED PRIOR TO INSTALLATION. IF UNSATISFACTORY, CONTRACTOR TO SHAPE OR SAND MINOR IRREGULARITIES PRIOR TO INSTALLATION.







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	Е	03/01/2023	DRAFT FINAL REV 1 SUBMISSION	BV	TK		•		,	, -			
ISSUED FOR	D	11/16/2022	DRAFT FINAL SUBMISSION	BV	TK		ROCKLAND						
PERMITTING	С	05/20/2022	60% DESIGN SUBMISSION	BV	TK		TR	EN	CH DETAILS	;			
	В	03/23/2022	PRELIMINARY DESIGN DEVELOPMENT	BV	TK								
	Α	02/18/2022	PRELIMINARY PROGRESS	BV	TK								
	No.	DATE	SUBMITTAL / REVISION DESCRIPTION	DB	APP	DD 414/11 D) (4 D	DEGLONED DV	D) (4 DDD 0) (ED D) (SCALE		
	140.	DATE	SUDIVITITAL / REVISION DESCRIPTION	DB	\ \ \alpha \cdot \	DRAWN BY: AR	DESIGNED BY:	BV	APPROVED BY:	IK	REV. NO.		


CHAMPLAIN HUDSON POWER EXPRESS SEGMENT 12 (PACKAGE 7B) - ROUTE 9W: ROCKLAND TRENCH DETAILS

KIEWIT PROJECT NO. 21162 TT PROJECT NO. 204-3701 DRAWING NO.

AS SHOWN DATE

C-621

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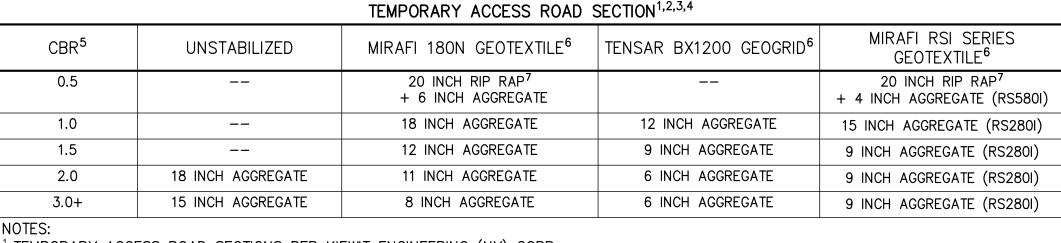


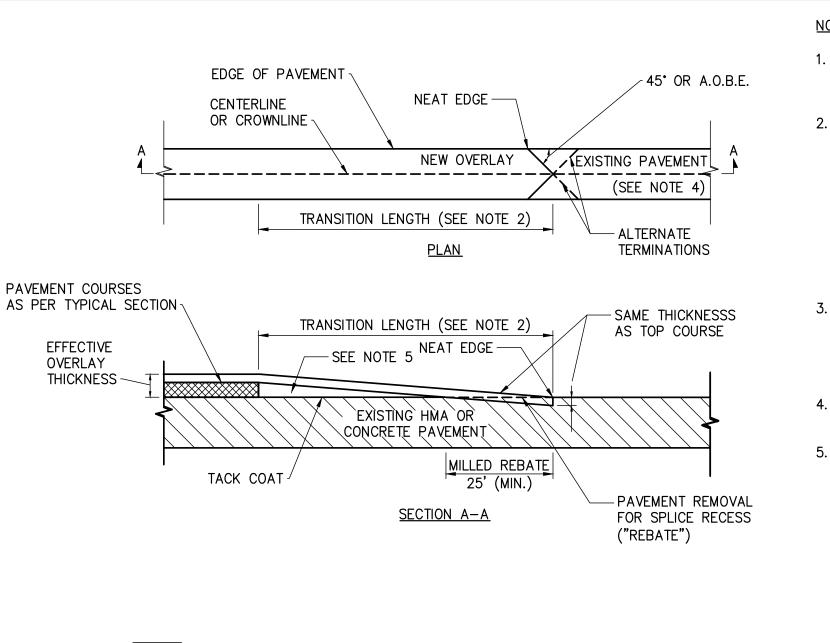- HOT MIX ASPHALT (HMA) OVERLAY SPLICES SHALL BE USED AT: ENDS OF HMA OVERLAY HIGHWAY SECTIONS, MAJOR INTERSECTIONS, AND OTHER LOCATIONS INDICATED IN THE PLANS.
- THE TRANSITION LENGTH IN FEET SHALL NOT BE LESS THAN THE VALUE OBTAINED BY MULTIPLYING THE EFFECTIVE OVERLAY THICKNESS IN INCHES (DIFFERENCE BETWEEN THE EXISTING AND THE OVERLAID ELEVATIONS) BY THE K VALUE FROM THE TABLE FOR THE POSTED SPEED OF THE HIGHWAY. THE MINIMUM TRANSITION LENGTH IS 30'.

EXAMPLE: IF THE POSTED SPEED IS 55 MPH. EFFECTIVE OVERLAY THICKNESS = 2" THEN THE MINIMUM TRANSITION LENGTH = 2" INCHES X 30 FT/IN = 60 FEET

- 3. ALL SURFACES OF THE HMA OVERLAY SPLICE TRANSTION AREA SHALL BE CLEANED AND TACK-COATED PRIOR TO HMA PLACEMENT. THE COST OF MILLING REBATES, AND TACK COAT IN THE HMA OVERLAY SPLICE TRANSITION AREA SHALL BE PAID FOR UNDER THEIR RESPECTIVE ITEMS. COST OF LEAVING A NEAT EDGE SHALL BE INCLUDED IN THE MILLING ITEM.
- SAW CUTS SHALL BE MADE SO THAT SURFACE RUNOFF IS DIRECTED TO THE EDGE OF PAVEMENT.
- IN THE TRANSITION AREA, PAVEMENT COURSES OTHER THAN THE TOP COURSE SHALL BE FEATHERED OUT USING TOP COURSE OR OTHER APPROPRIATE MATERIAL. PAYMENT SHALL BE MADE UNDER THE APPROPRIATE ITEM.

K VALUE TABLE FT/IN										
POSTED SPEED MPH	30	35	40	45	50	55	60	65		
К	16.67	19.17	21.67	24.17	27.50	30.00	32.50	35.00		



- TEMPORARY ACCESS ROAD SECTIONS PER KIEWIT ENGINEERING (NY) CORP.
- AGGREGATE SHALL BE NYSDOT TYPE 2 CRUSHED AGGREGATE OR APPROVED ALTERNATIVE. DESIGN CONSIDERS 1,000 PASSES OF MAXIMUM 22-KIP AXLE LOAD AND A DESIGN RUT DEPTH OF 3 INCHES. ADDITIONAL AXLE PASSES,
- HEAVIER AXLE LOADS, AND DETERIORATED SUBGRADE CONDITIONS MAY REQUIRE THICKER AGGREGATE SECTIONS OR ADDITIONAL MAINTENANCE. ALTERNATE TEMPORARY ACCESS ROAD DESIGNS MAY BE PROVIDED BY KIEWIT ENGINEERING, AS REQUIRED, BASED ON FIELD CONDITIONS AND
- ESTIMATE CBR IN THE FIELD USING A DYNAMIC CONE PENETROMETER OR ALTERNATIVE METHOD APPROVED BY GEOTECHNICAL ENGINEER OF RECORD (EOR). CBR OF IN-SITU SOIL MAY VARY SEASONALLY DUE TO FREEZE/THAW AND BASED ON MOISTURE CONDITIONS. GEOGRID AND GEOTEXTILE
- A GEOGRID AND GEOTEXTILES SHALL BE INSTALLED PER MANUFACTURER'S SPECIFICATION INCLUDING OVERLAP AND EDGE DETAILS.
- B SPECIFIED GEOTEXTILE OR GEOGRID MAY BE REPLACED BY EQUIVALENT MATERIAL APPROVED BY EOR.
- ^C GEOTEXTILE IS REQUIRED IN REGULATED WETLANDS AND AGRICULTURAL LANDS. D GEOTEXTILE SEPARATOR FABRIC IS REQUIRED BENEATH GEOGRID ON COHESIVE SUBGRADE
- RIP RAP
- A RIP RAP SHALL BE NYSDOT LIGHT STONE FILL OR APPROVED ALTERNATIVE.
- B A LAYER OF #57 STONE IS RECOMMENDED ON TOP OF GEOTEXTILE TO PREVENT DAMAGING OR PUNCHING OF THE GEOTEXTILE FABRIC WHERE RIP RAP IS USED.



TEMPORARY ACCESS ROAD


- SLOPE AS INDICATED ON PLAN


-LAYER THICKNESS PER TABLE

- COMPACTED SUBGRADE

GEOGRID, AS REQUIRED⁶


- GEOTEXTILE FABRIC AND/OR

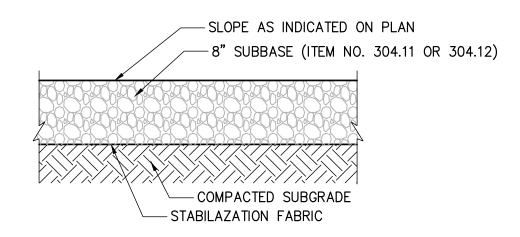

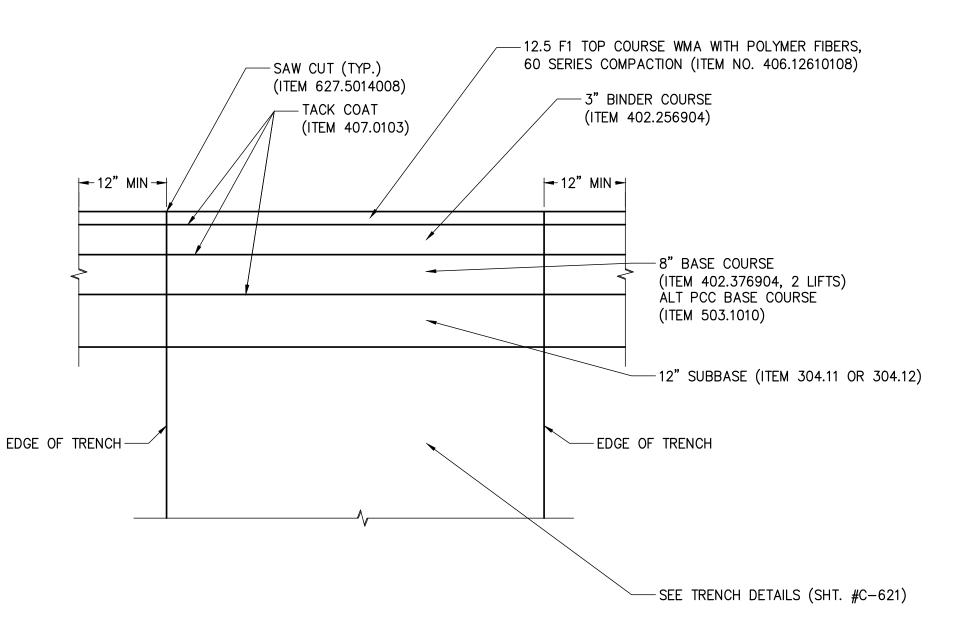

CEMENT CONCRETE PAVEMENT ASPHALT CONCRETE SEE NOTE 1 <u>PAVEMENT</u> EXISTING ASPHALT 12.5 F1 TOP COURSE WMA WITH POLYMER FIBERS. CONCRETE PAVEMENT 60 SERIES COMPACTION (ITEM NO. 406.12610108) □ 3" BINDER COURSE unjun 8" BASE COURSE SAW CUT FULL DEPTH SUB BASE COURSE (ITEM 304.11 DRILL AND GROUT IN \SAW CUT FULL DEPTH OR 304.12) OR CONTROLLED LOW PLACE NO. 8 DOWELS STRENGTH BACKFILL | MATERIAL 🔻 🗎 (12" MIN) 18" (450 mm) 0.C. 2'-0" LONG (600 mm) (TYPICAL) --12"± (300 mm) -BACKFILL (SEE NOTE 2) NOTES:


- 1. WHEN CONCRETE IS USED, IT SHALL BE REINFORCED PORTLAND CEMENT CONCRETE WITH DOWELS INSTALLED AT THE REQUIRED SPACING, WHEN ASPHALT CONCRETE IS USED, IT SHALL CONSIST OF BASE, BINDER, AND TOP COURSES. THE TOTAL PAVEMENT THICKNESS SHALL MATCH EXISTING, UNLESS OTHERWISE REQUIRED BY REGION.
- 2 WHEN "W" IS LESS THAN 18" (450 mm), CONTROLLED LOW STRENGTH BACKFILL MATERIAL SHALL BE USED. WHEN "W" IS 18" (450 mm) OR MORE, BACKFILL SHALL BE SELECT GRANULAR MATERIAL FROM THE BOTTOM OF THE TRENCH TO THE BOTTOM OF THE SUBBASE COURSE, PLACEMENT SHALL BE AS DESCRIBED IN SECTION 200, EARTHWORK OF THE NEW YORK STATE DEPARTMENT OF TRANSPORTATION CURRENT SPECIFICATIONS AND AGENDA.

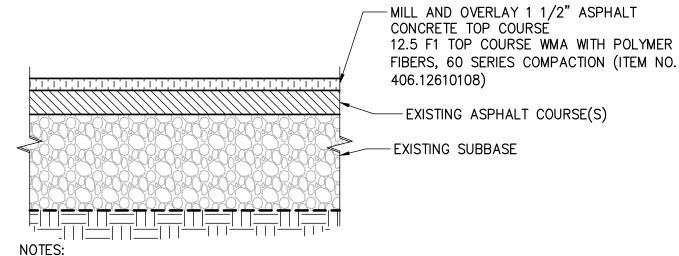

1. APPLY TACKCOAT TO MILLED SURFACE PRIOR TO PLACING ASPHALT

CONCRETE TOP COURSE. 2. ALL MATERIALS TO MEET NYSDOT STANDARD SPECIFICATIONS

MILL AND OVERLAY ASPHALT CONCRETE PAVEMENT DETAIL SCALE: N.T.S.

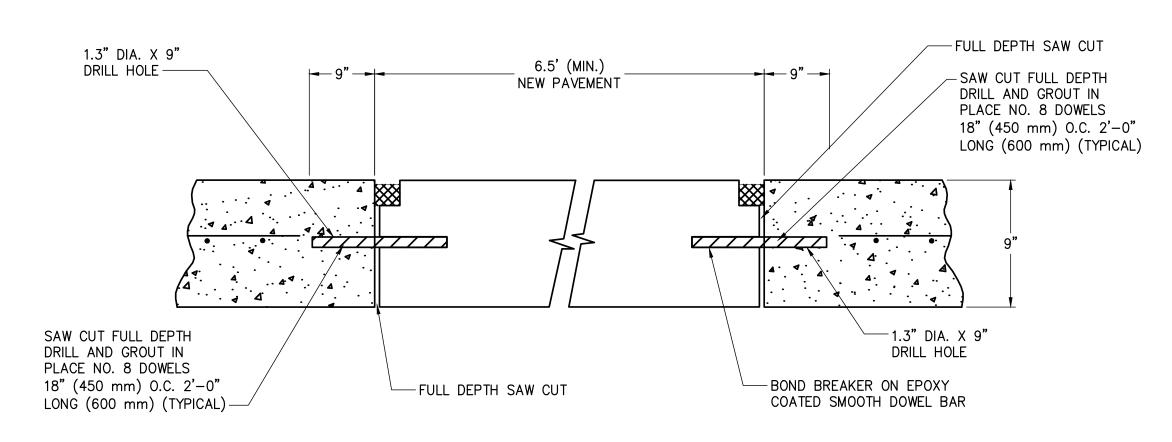

PAVEMENT RESTORATION DETAIL

PAVEMENT REPLACEMENT DETAIL OF OPEN CUT CROSSING







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ISSUED FOR PERMITTING

------------BV TK 04/14/2023 FINAL SUBMISSION BV TK 03/01/2023 DRAFT FINAL REV 1 SUBMISSION 11/16/2022 DRAFT FINAL SUBMISSION BV TK 05/20/2022 | 60% DESIGN SUBMISSION BV TK 03/23/2022 PRELIMINARY DESIGN DEVELOPMENT BV TK 02/18/2022 PRELIMINARY PROGRESS BV TK SUBMITTAL / REVISION DESCRIPTION

CHAMPLAIN HUDSON POWER EXPRESS SEGMENT 12 (PACKAGE 7B) - ROUTE 9W: ROCKLAND SURFACE RESTORATION DETAILS


KIEWIT PROJECT NO. 21162 TT PROJECT NO. 204-3701 DRAWING NO.


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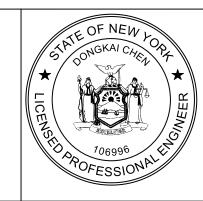
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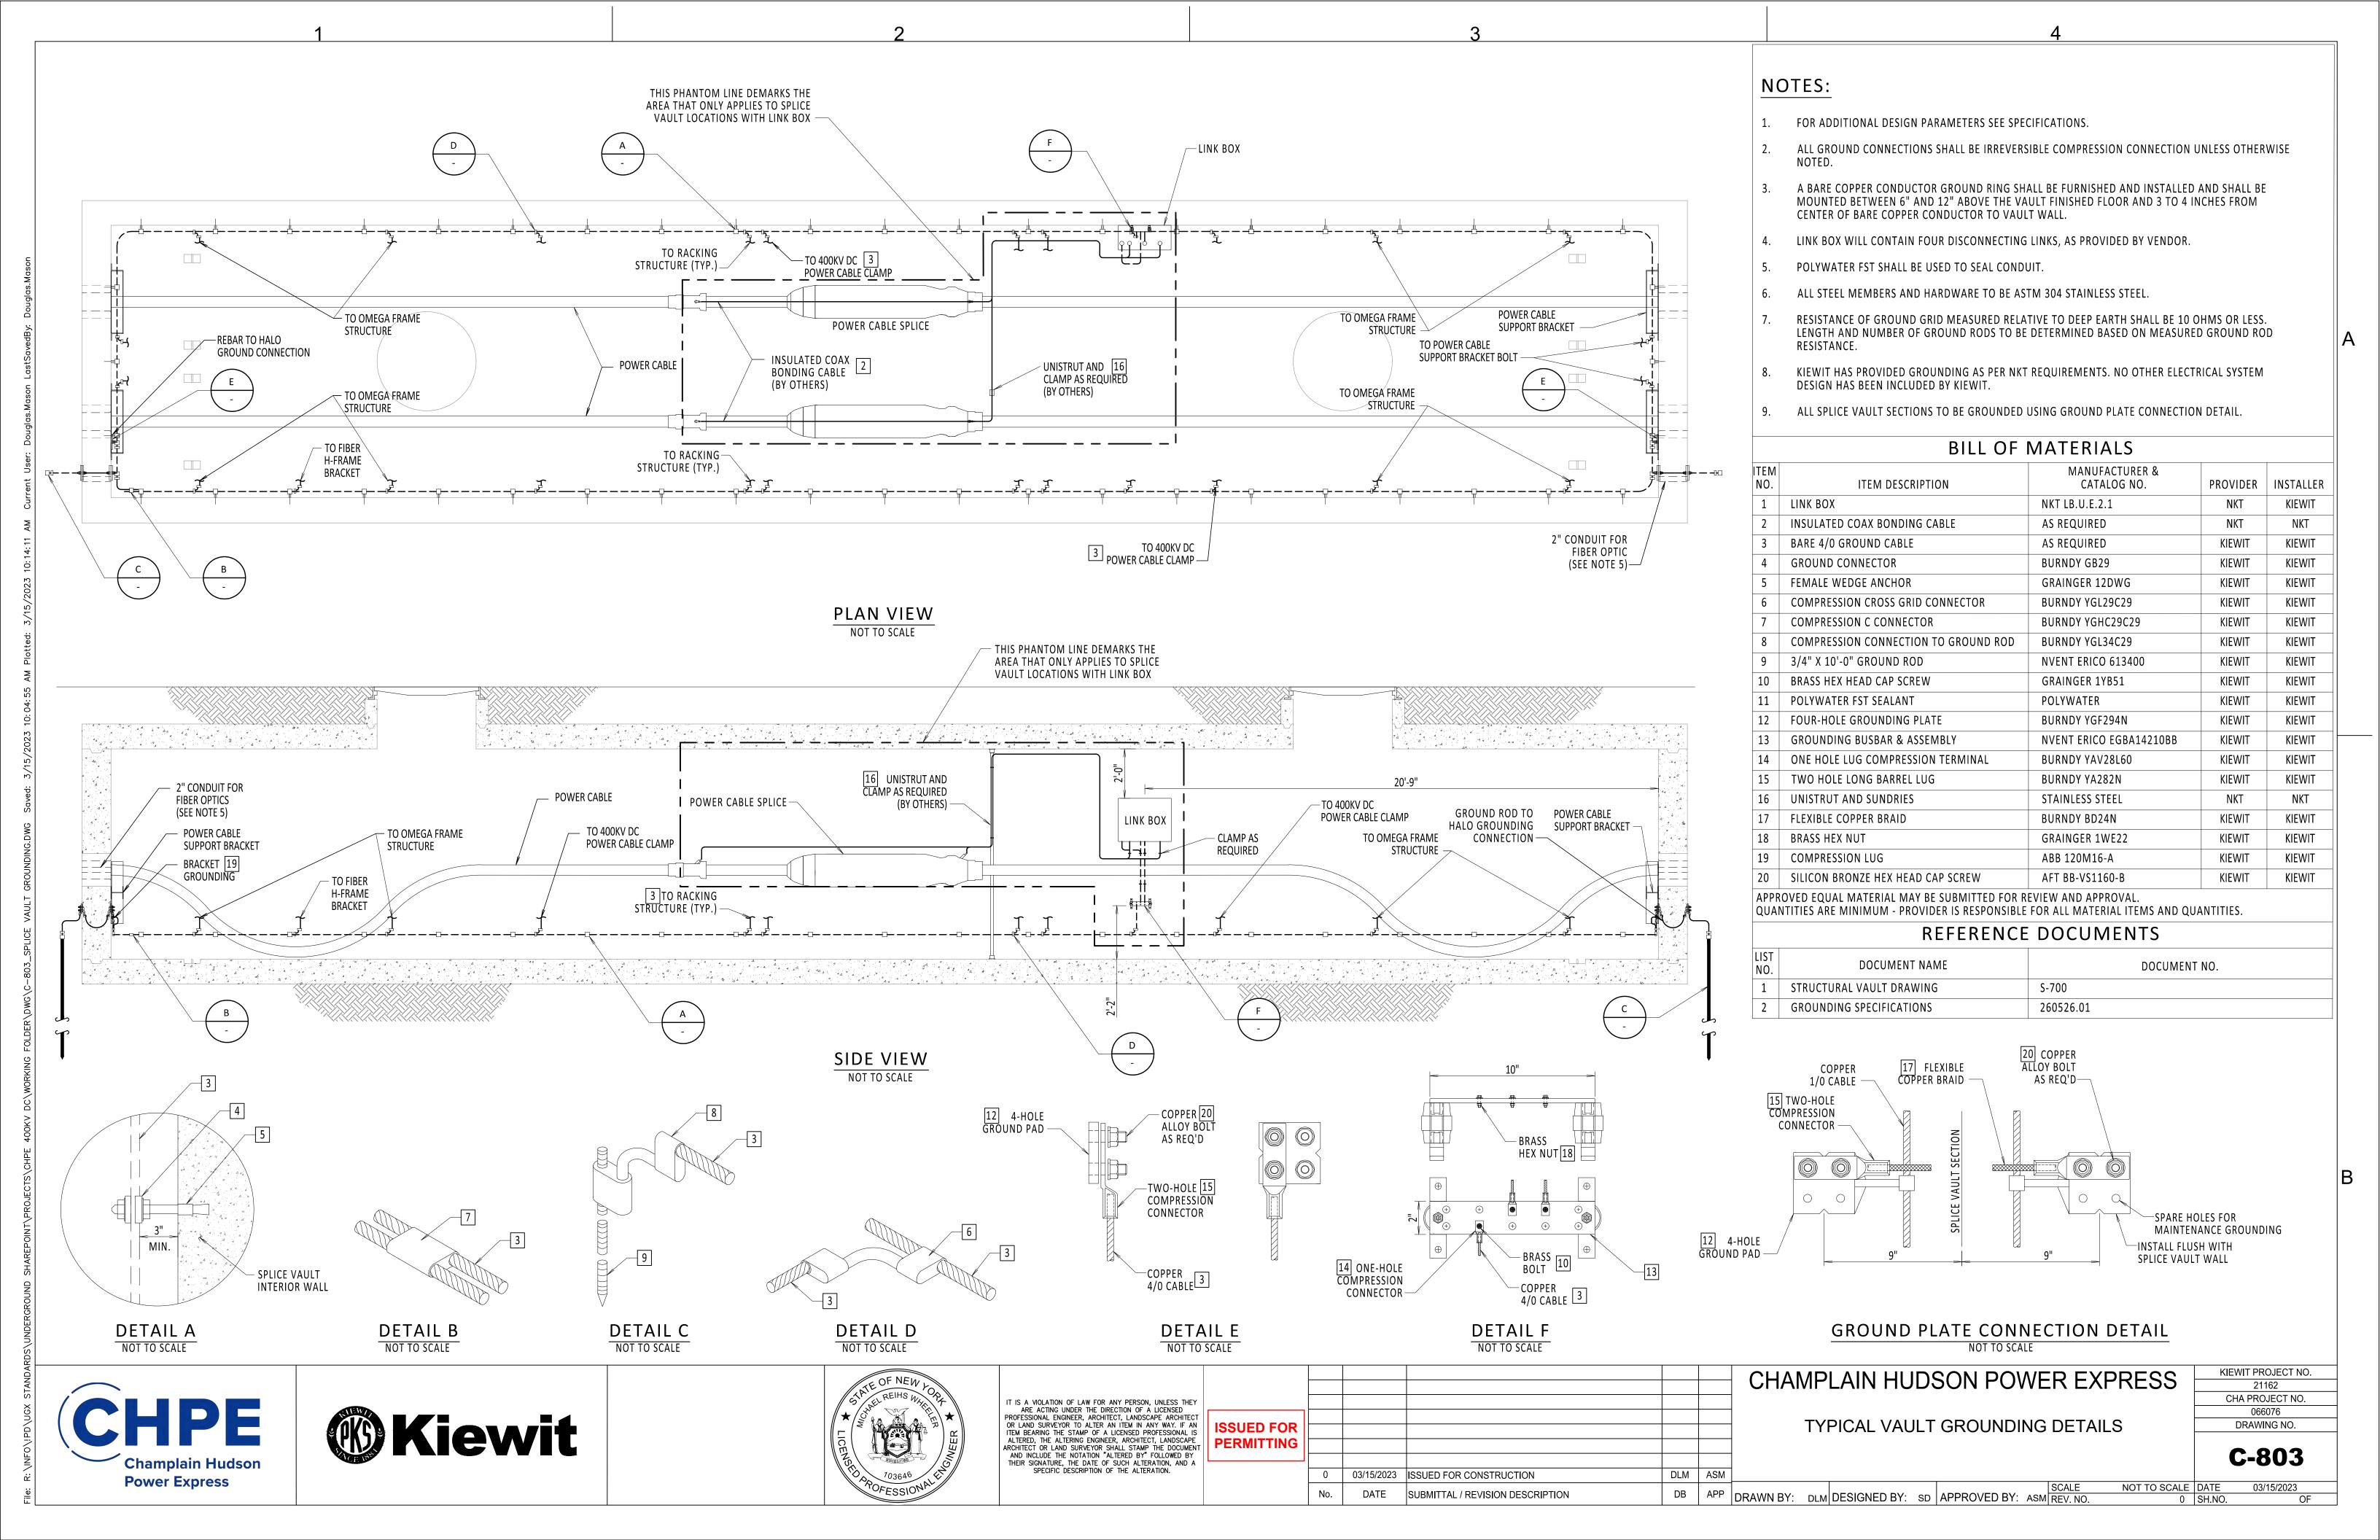
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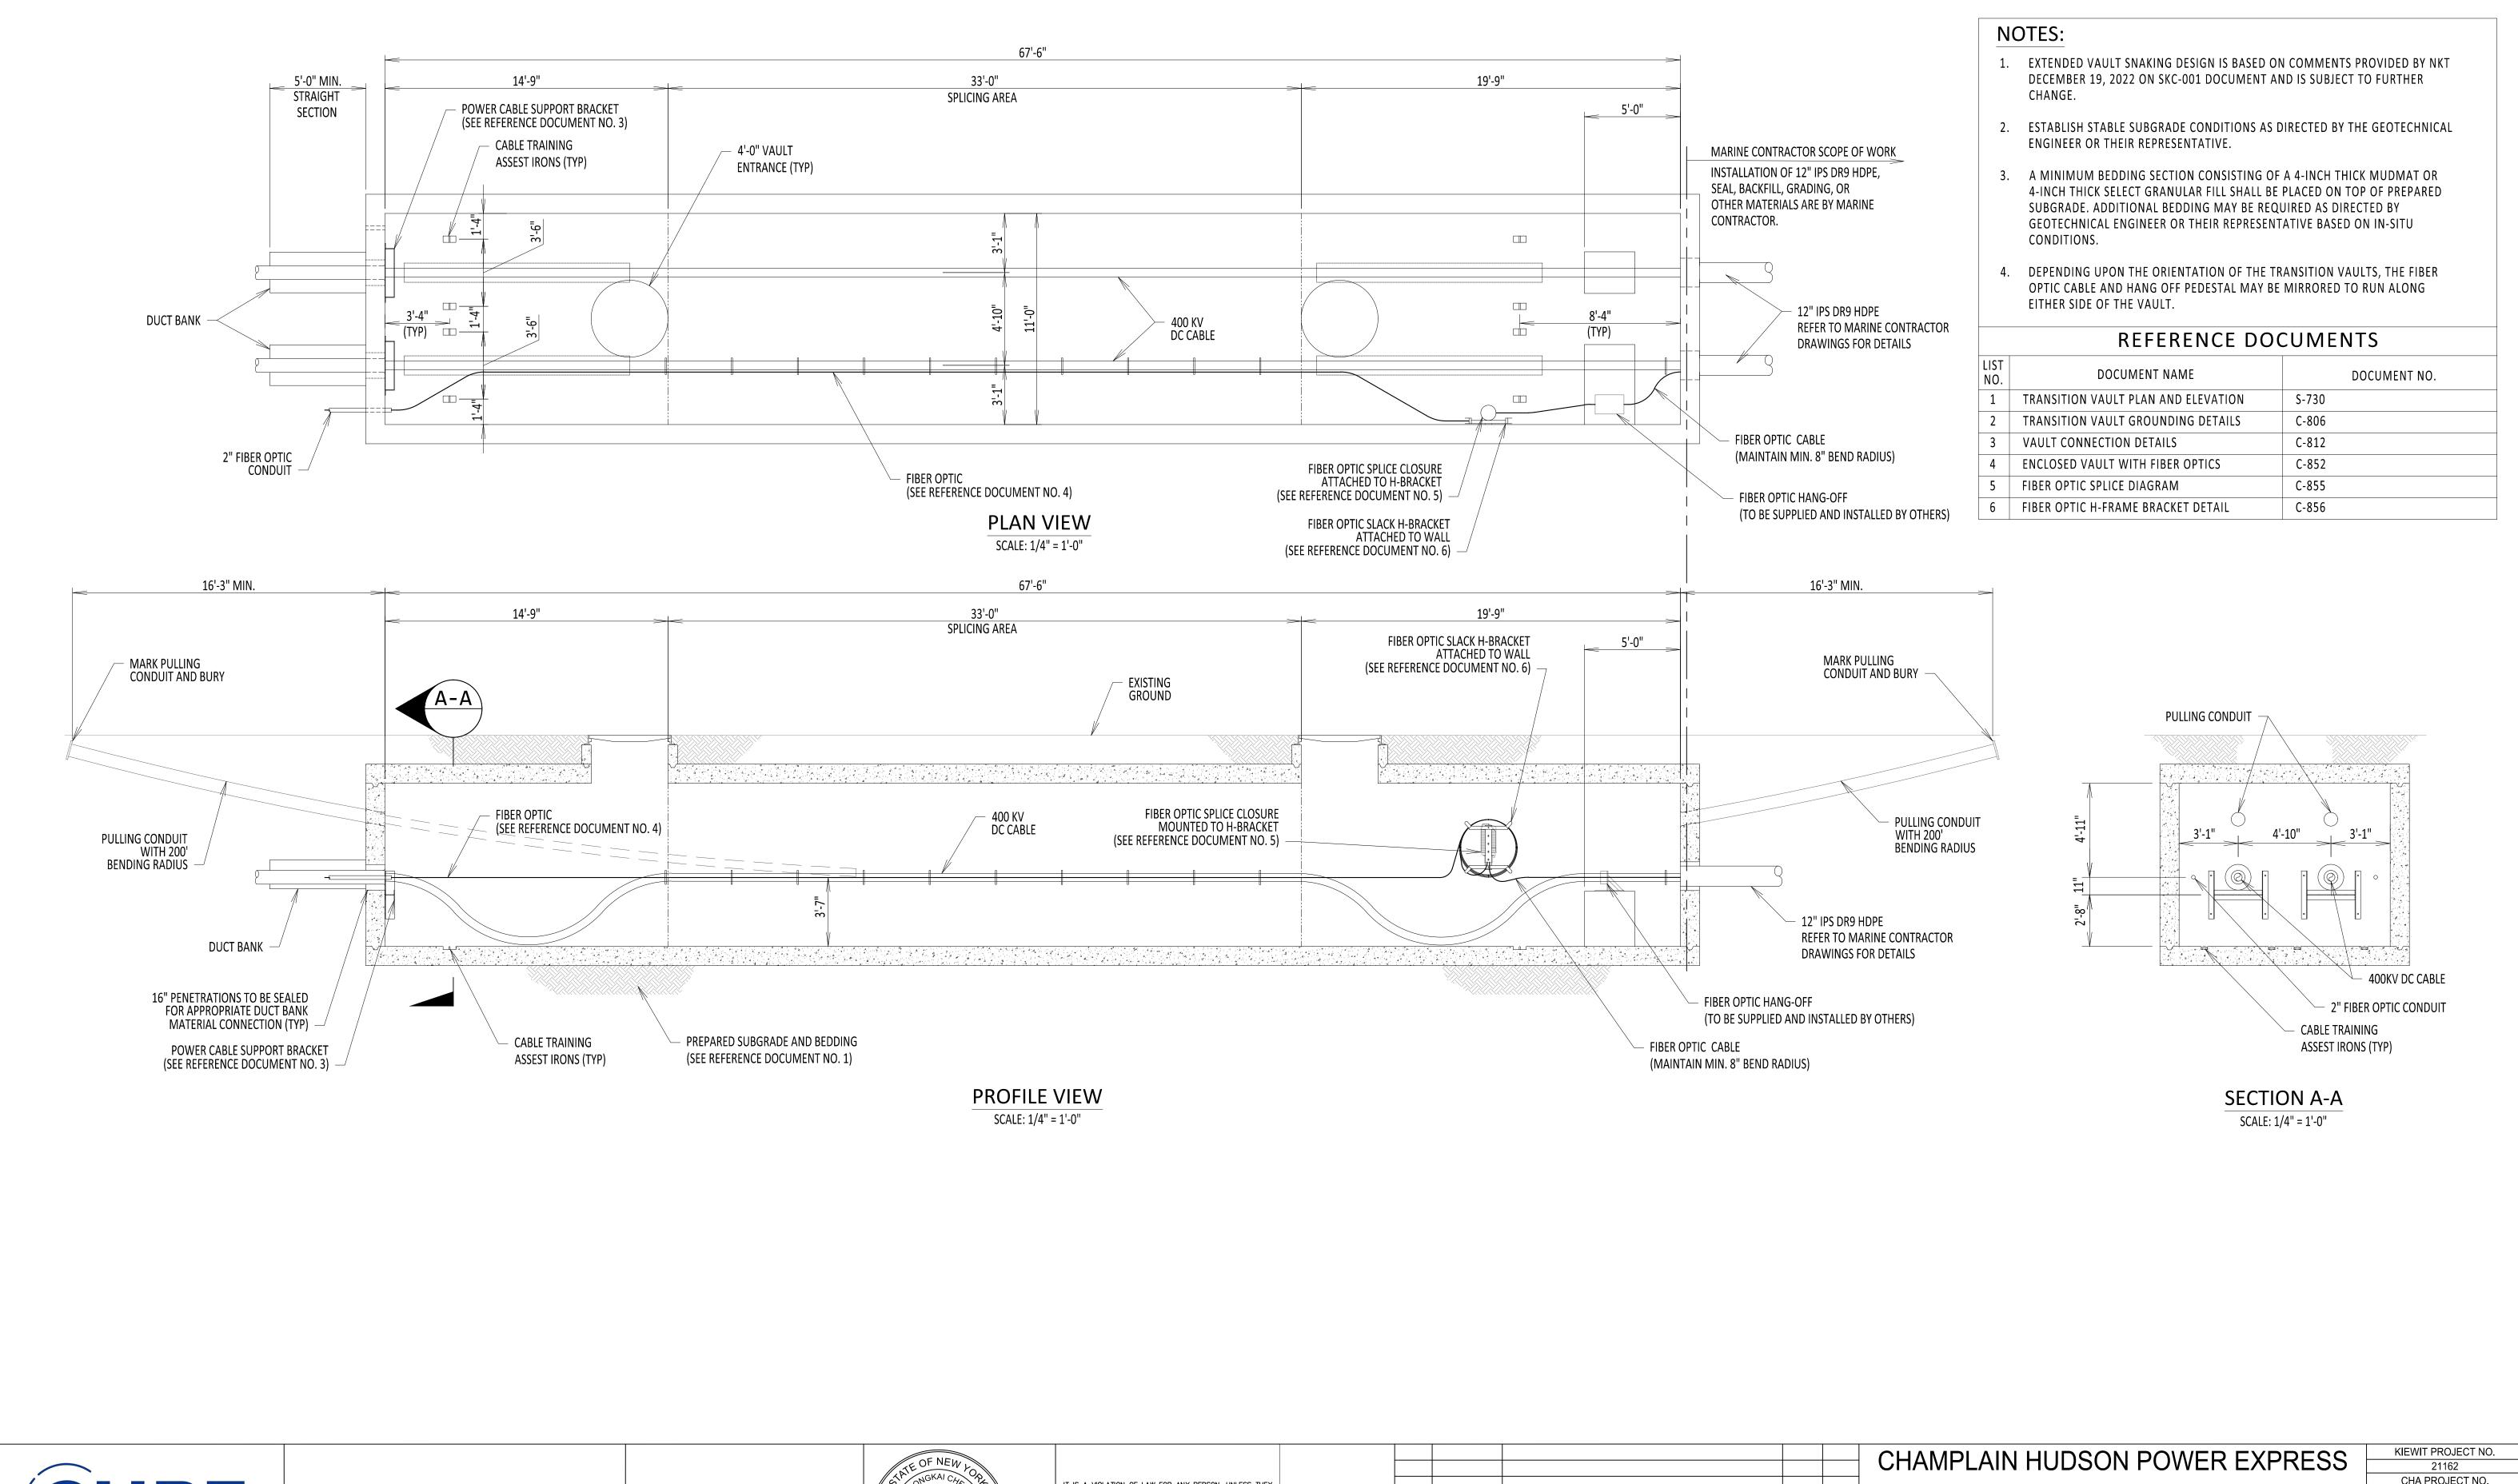
CHAMPLAIN HUDSON POWER EXPRESS TYPICAL VAULT **DETAILS**

KIEWIT PROJECT NO. 21162 CHA PROJECT NO. 066076 DRAWING NO.

C-802

03/15/2023

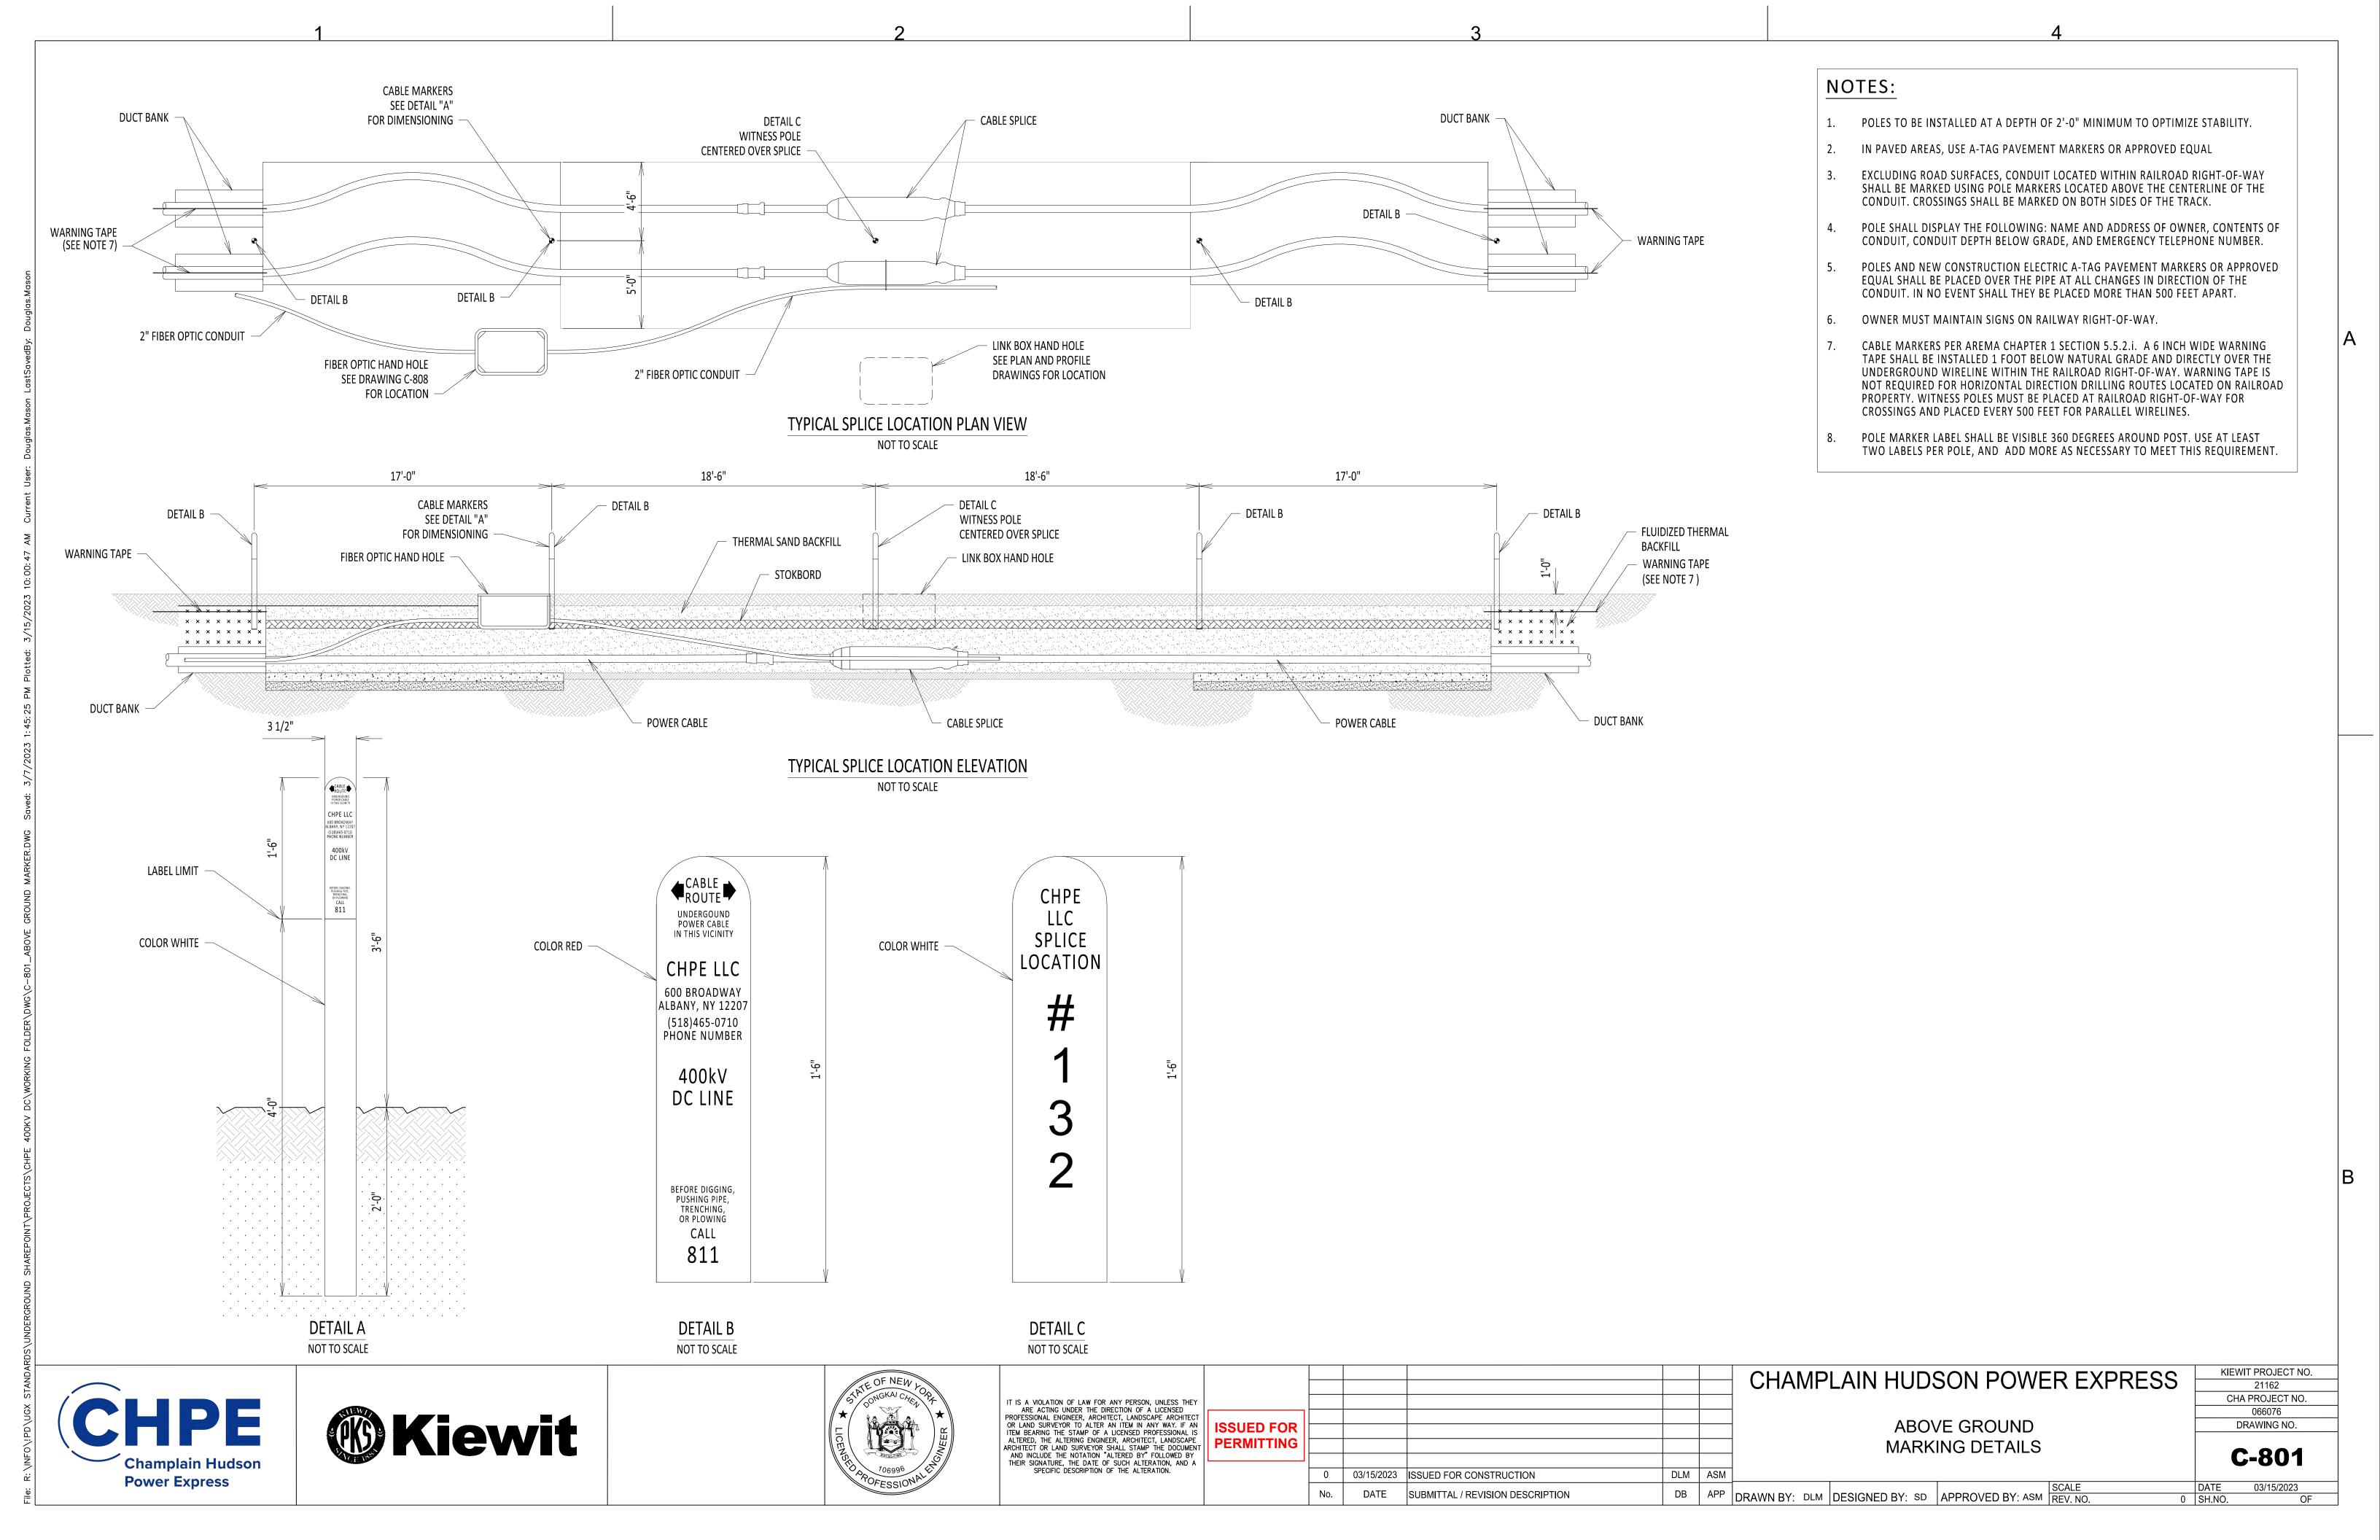

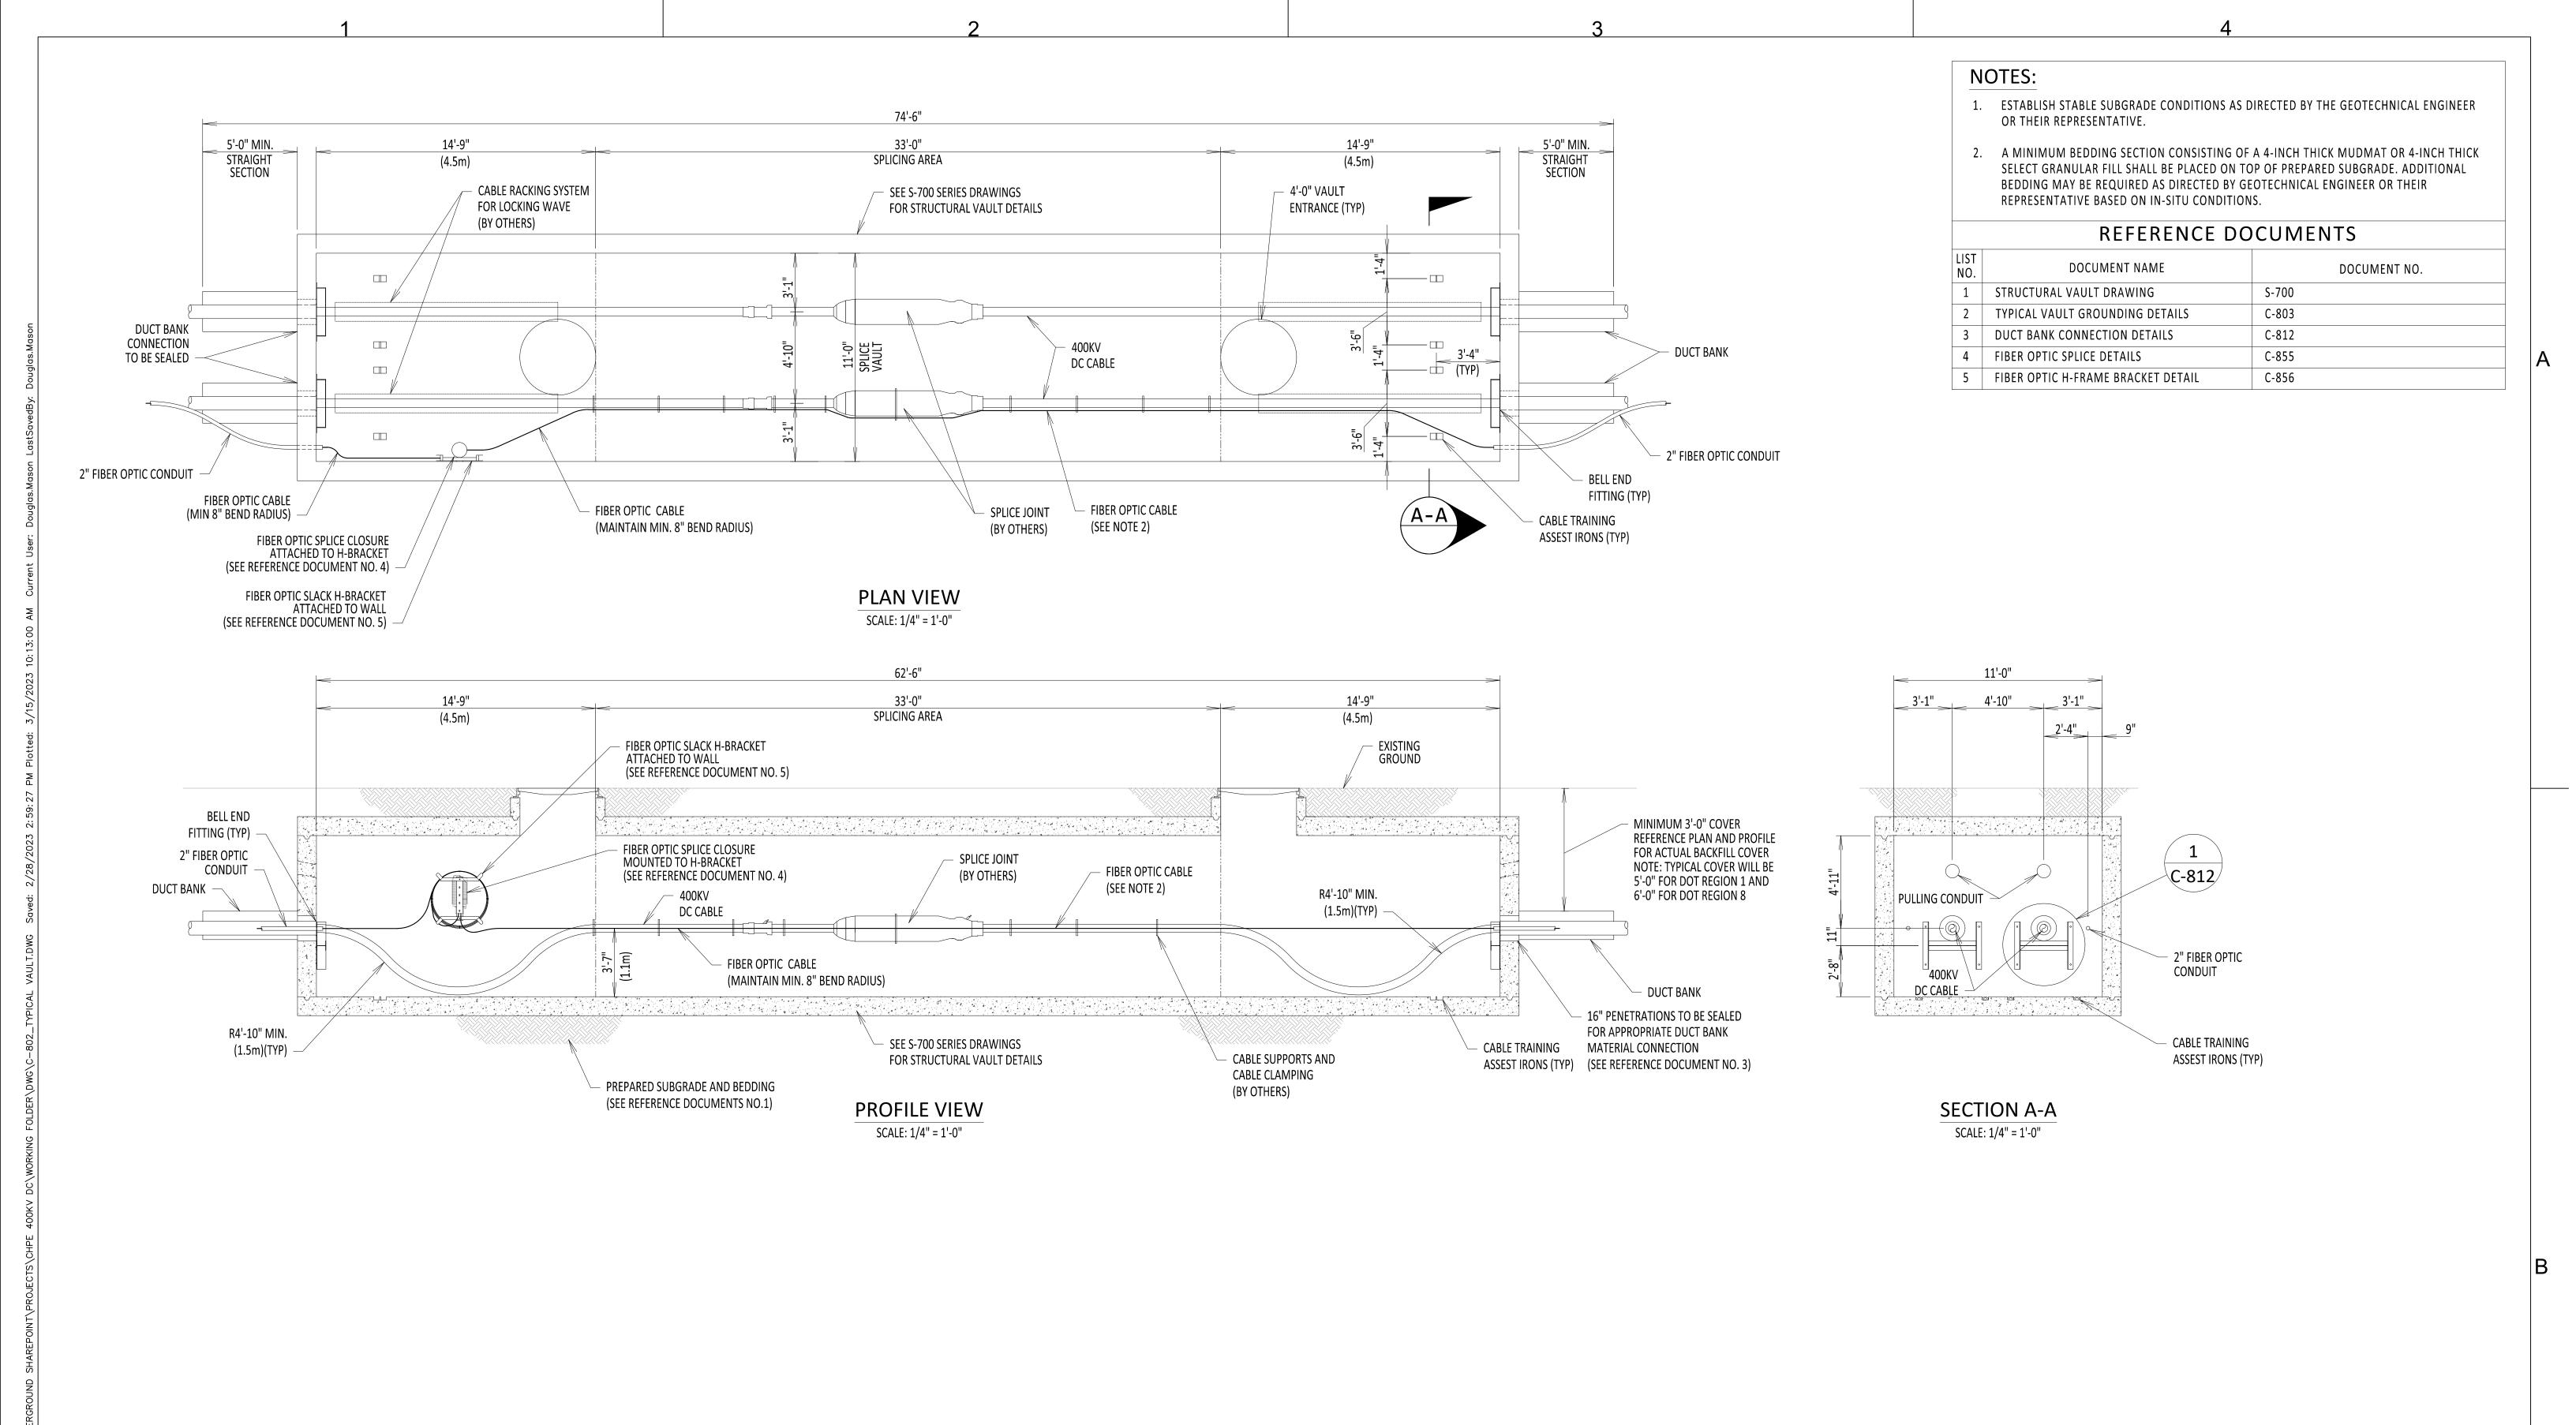







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ARCHITECT OR LAND SURVEYOR SHALL STAMP THE DOCUMENT AND INCLUDE THE NOTATION "ALTERED BY" FOLLOWED BY THEIR SIGNATURE, THE DATE OF SUCH ALTERATION, AND A SPECIFIC DESCRIPTION OF THE ALTERATION.


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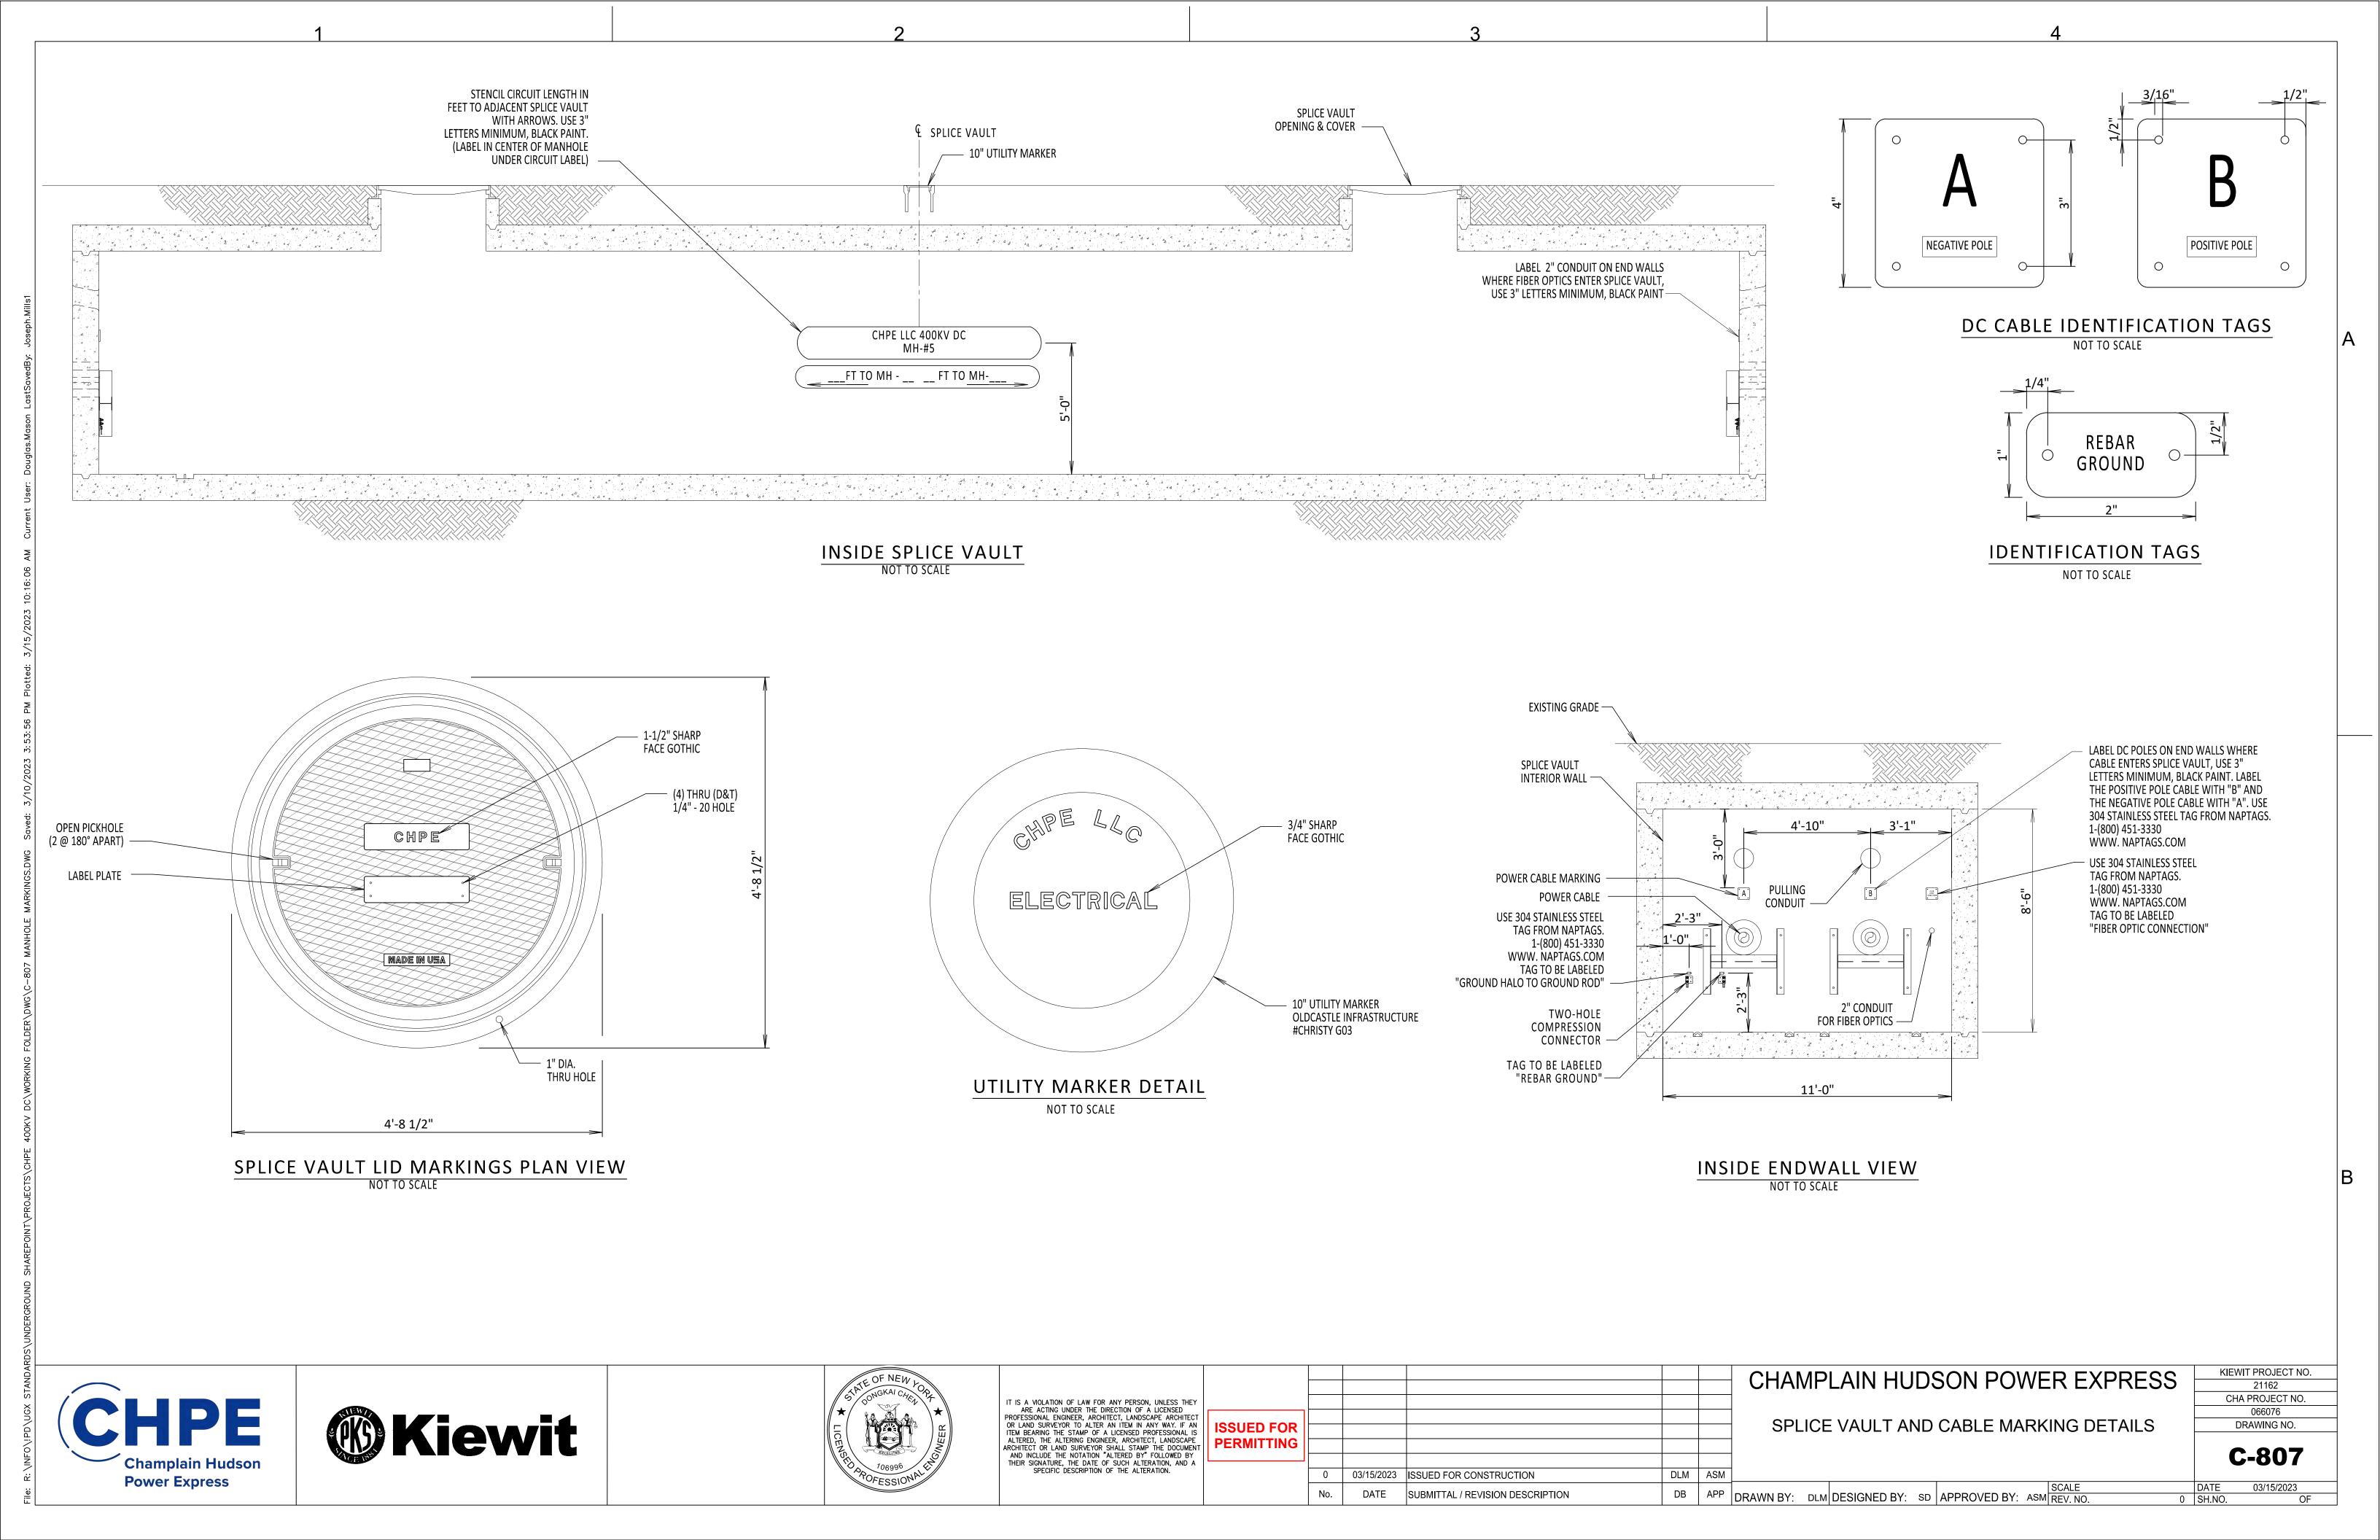
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	No.	DATE	SUBMITTAL / REVISION DESCRIPTION	DB	APP	DRAWN BY: [DLM	DESIGNED BY:	SS	APPROVED BY:	ASM	SCALE REV. NO.


CHA PROJECT NO. 066076 DRAWING NO.


C-805


DATE 0 SH.NO. 03/15/2023




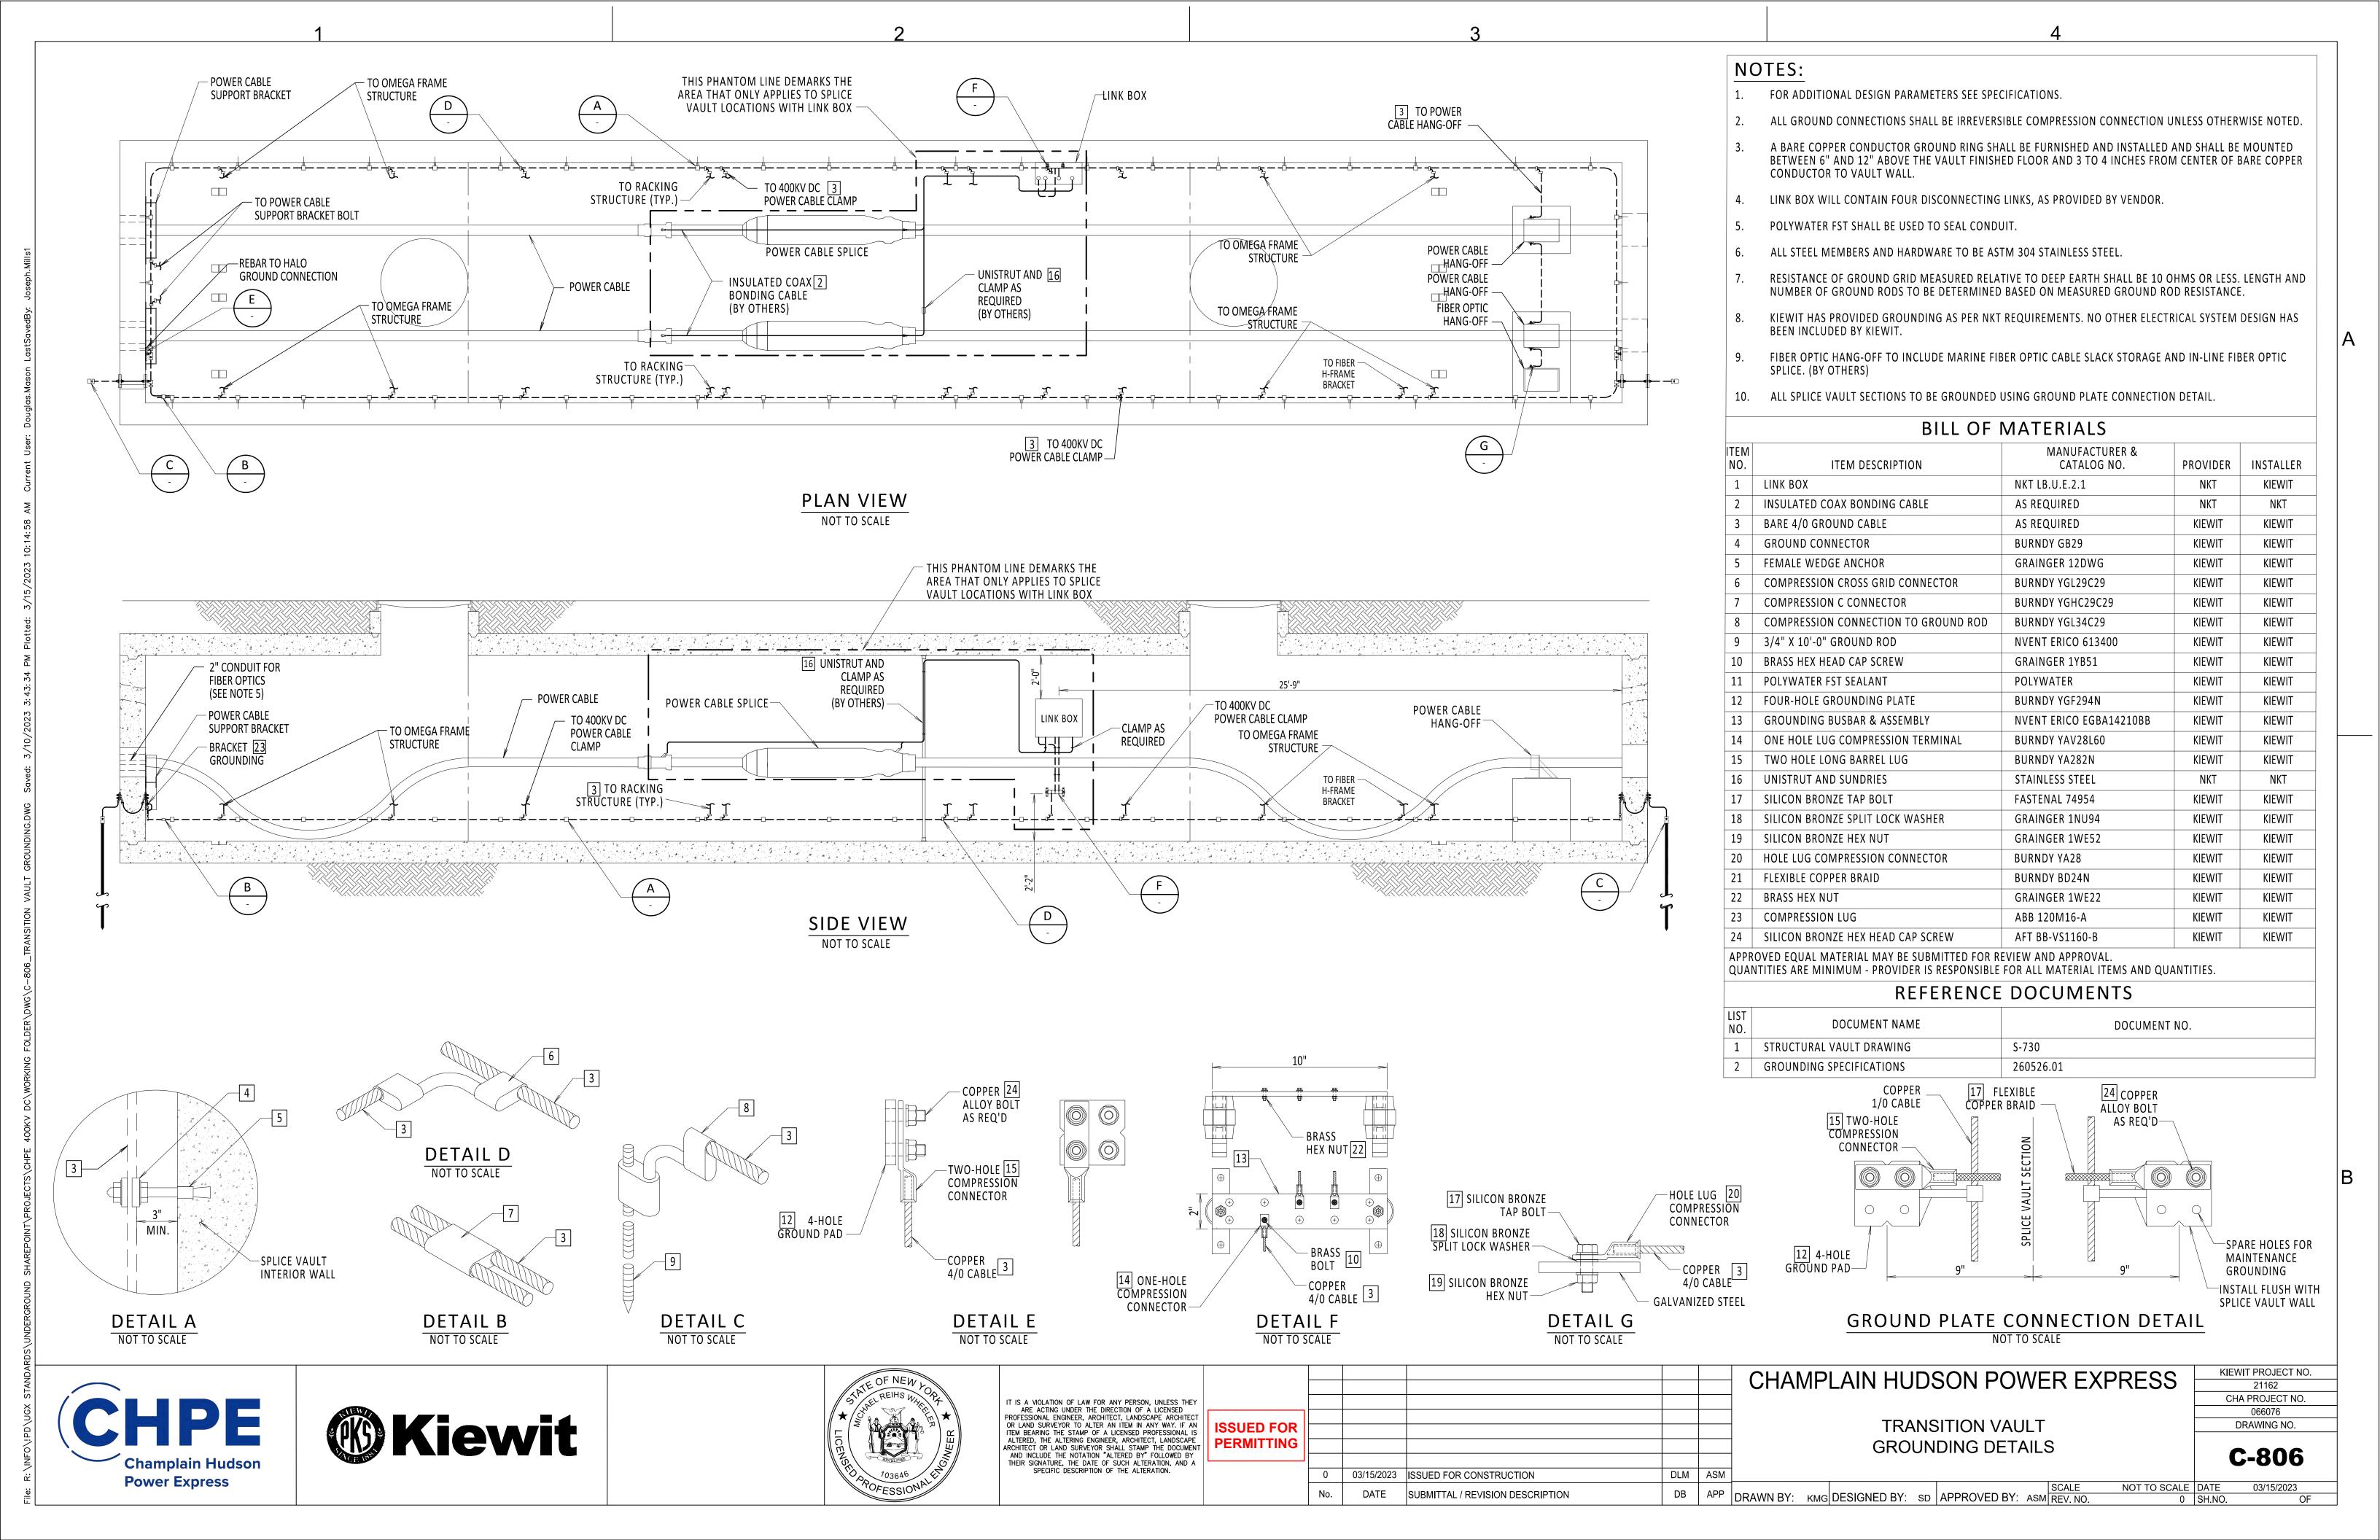

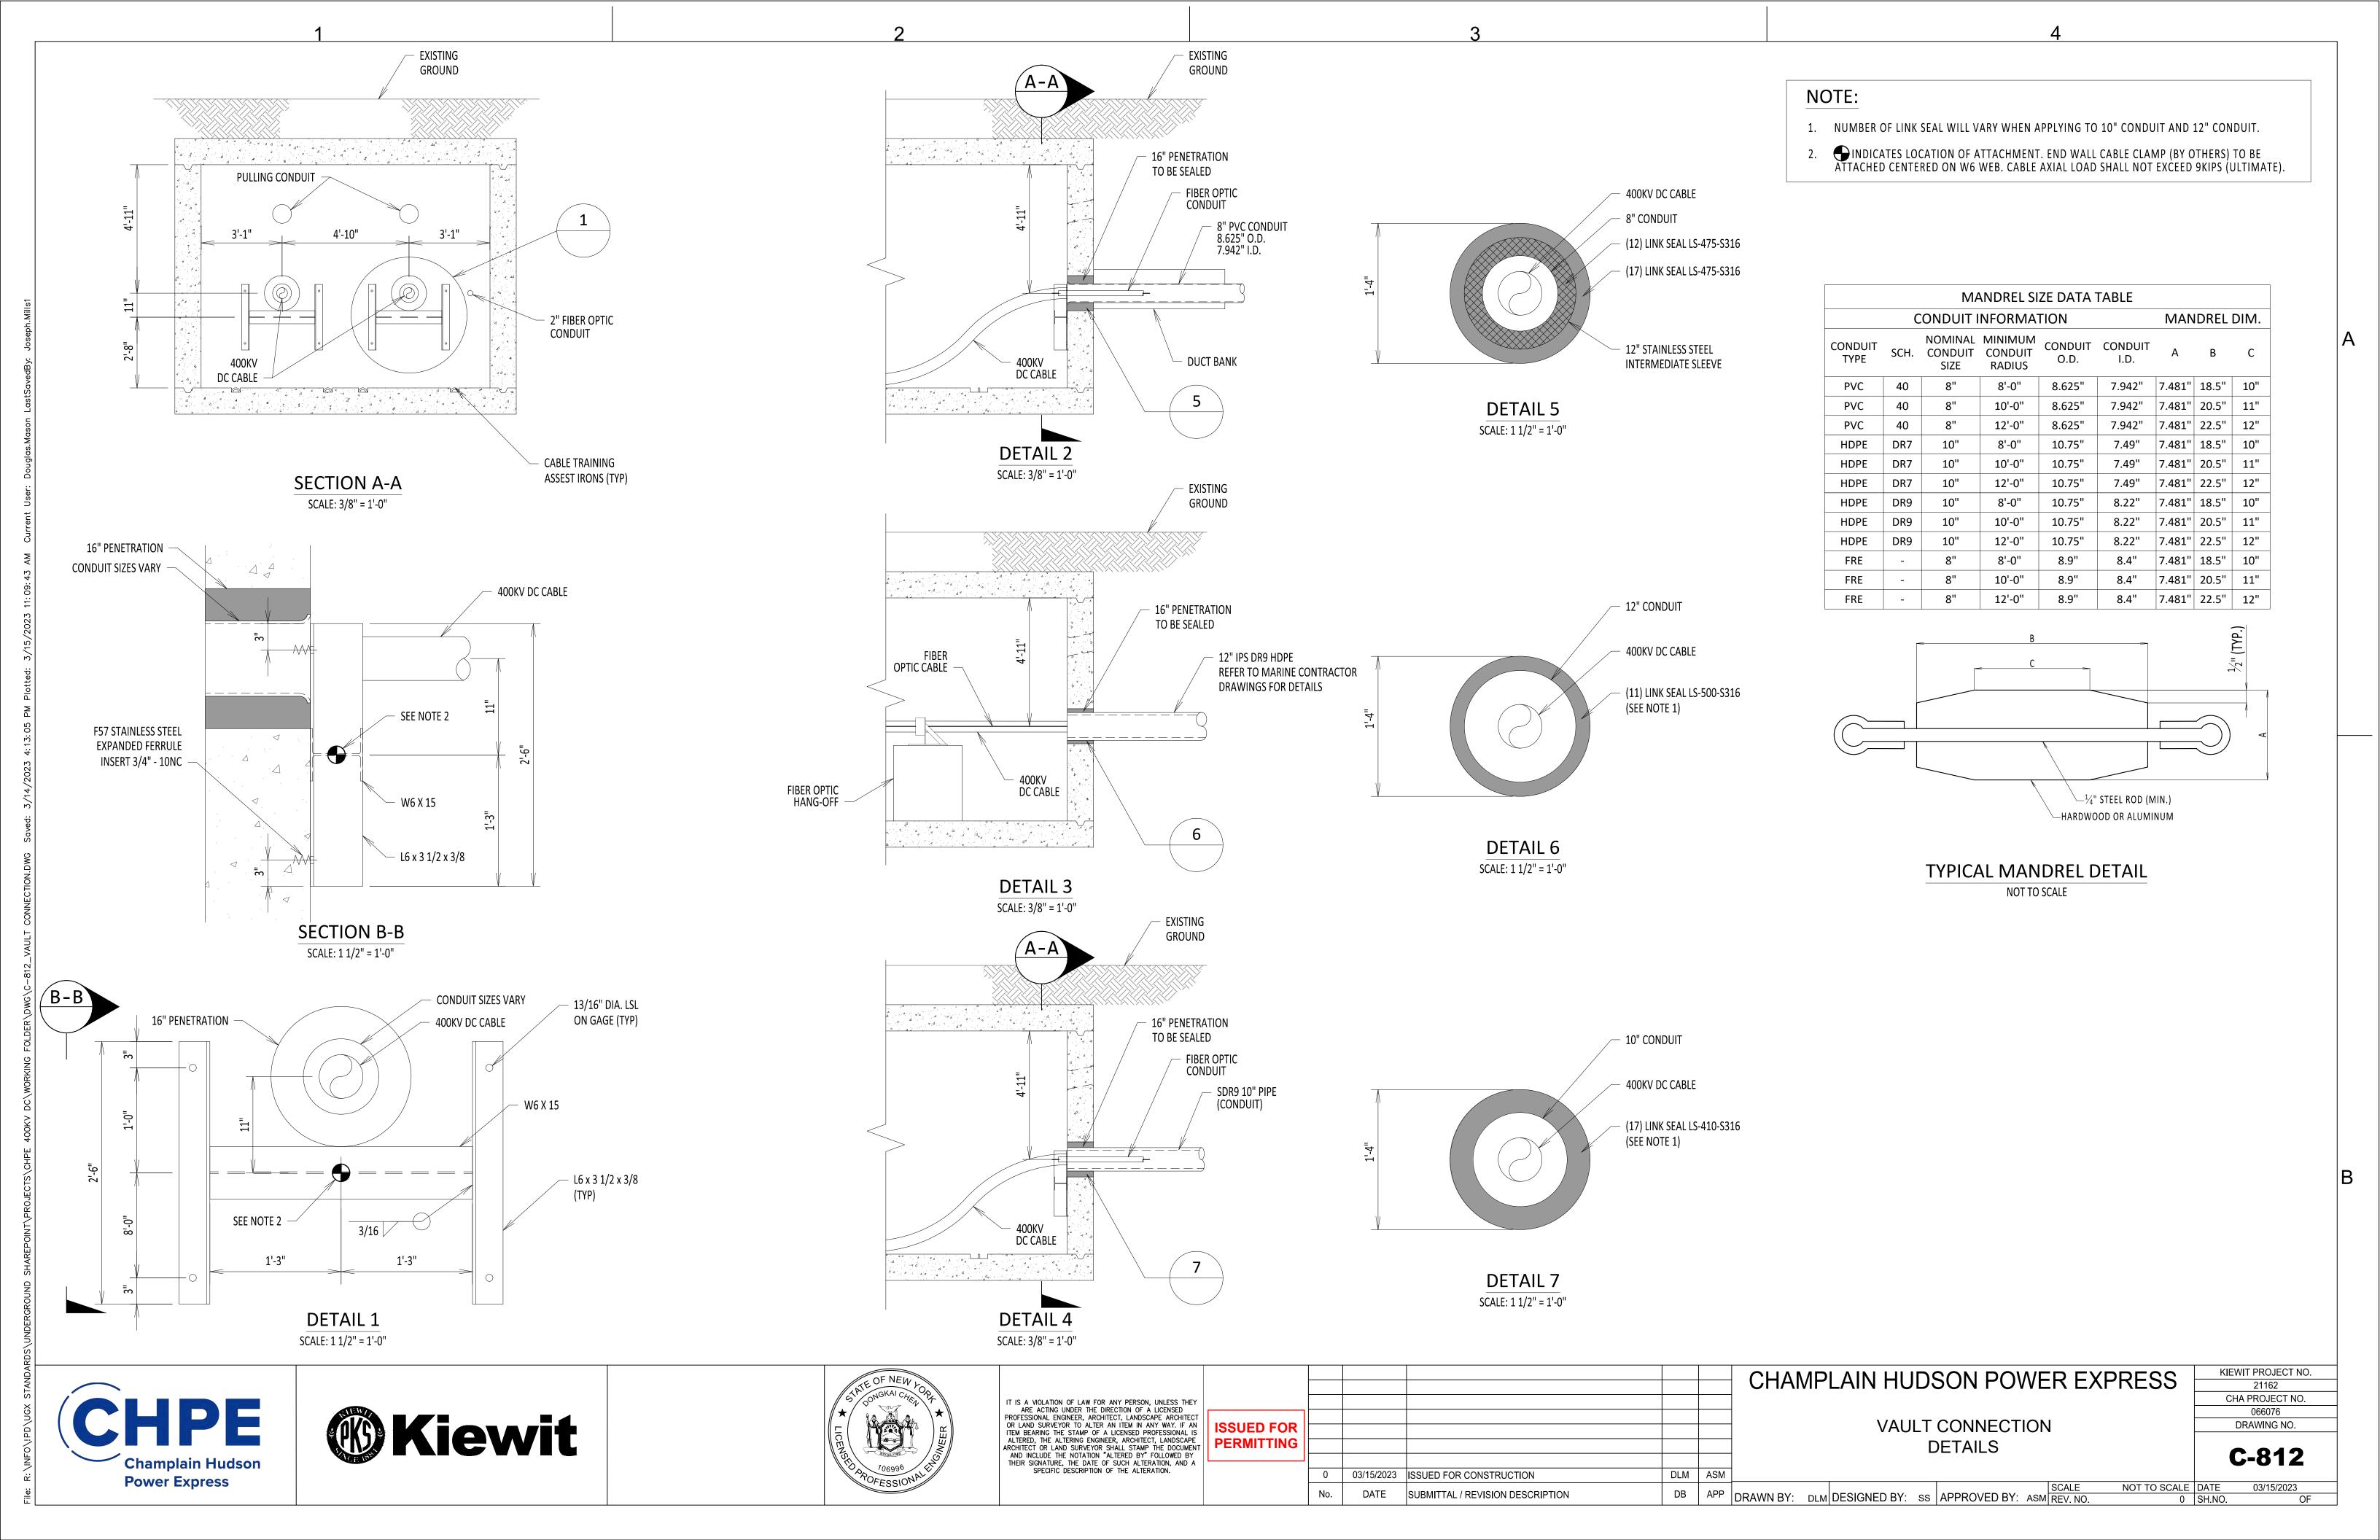

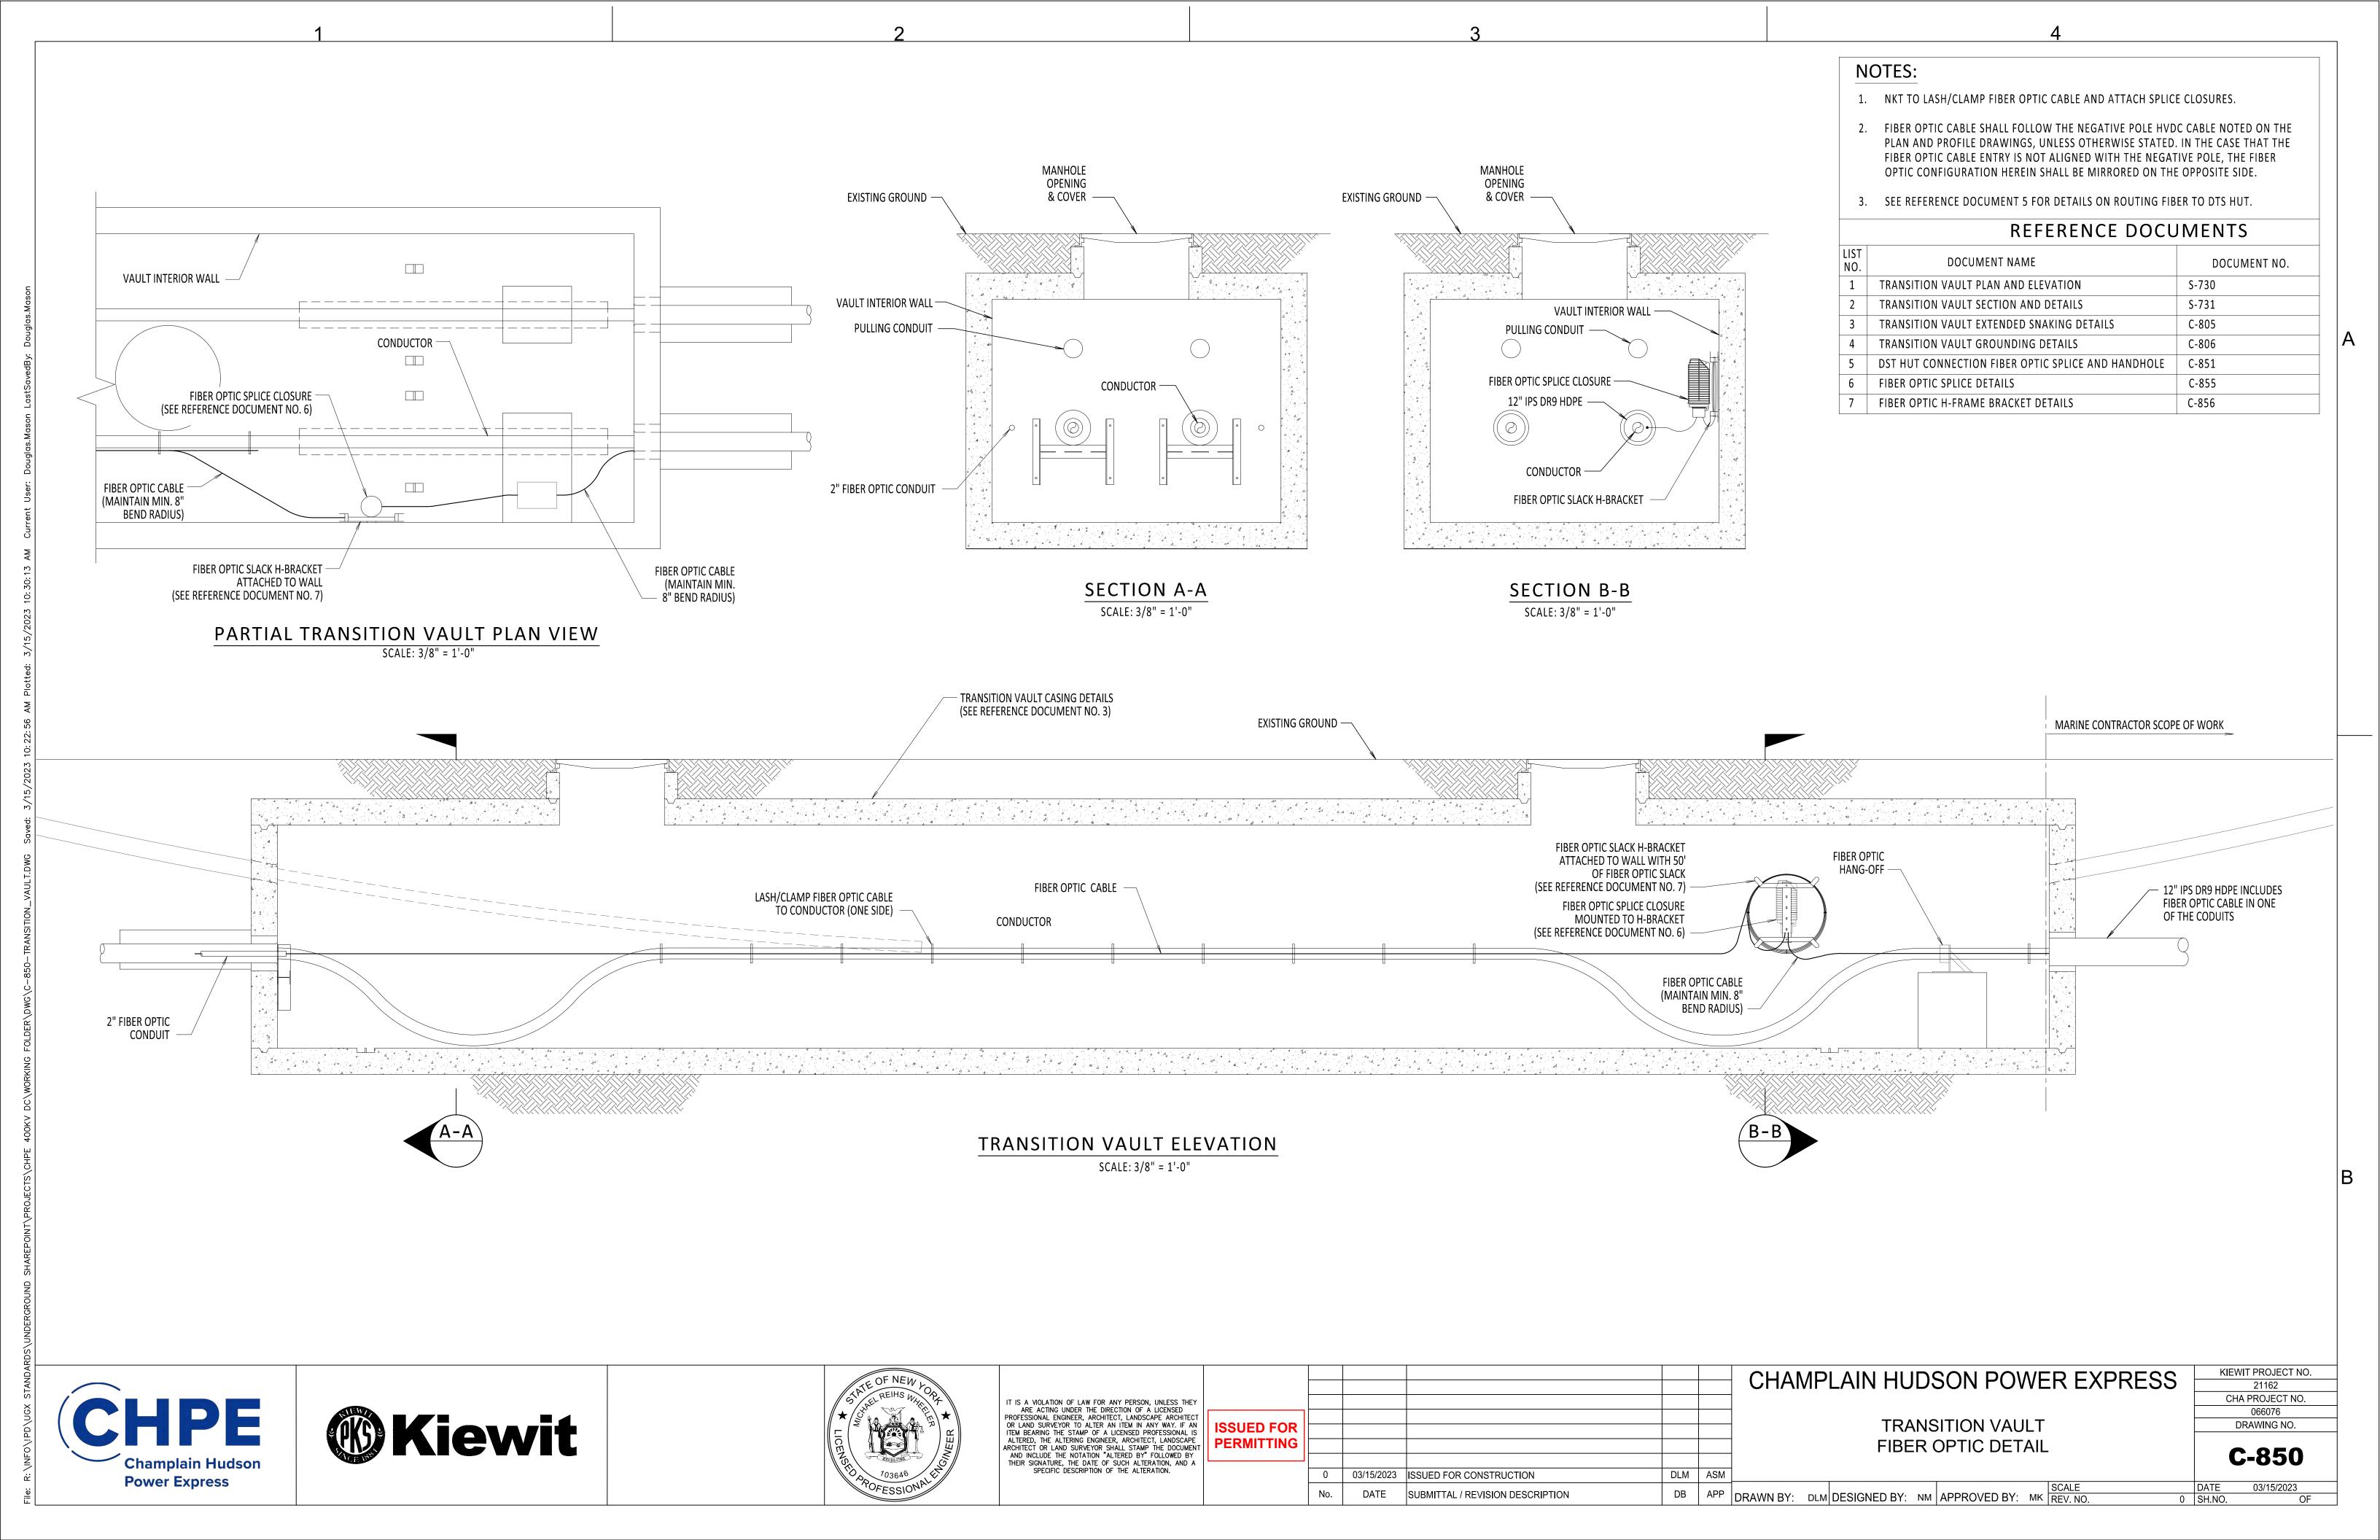

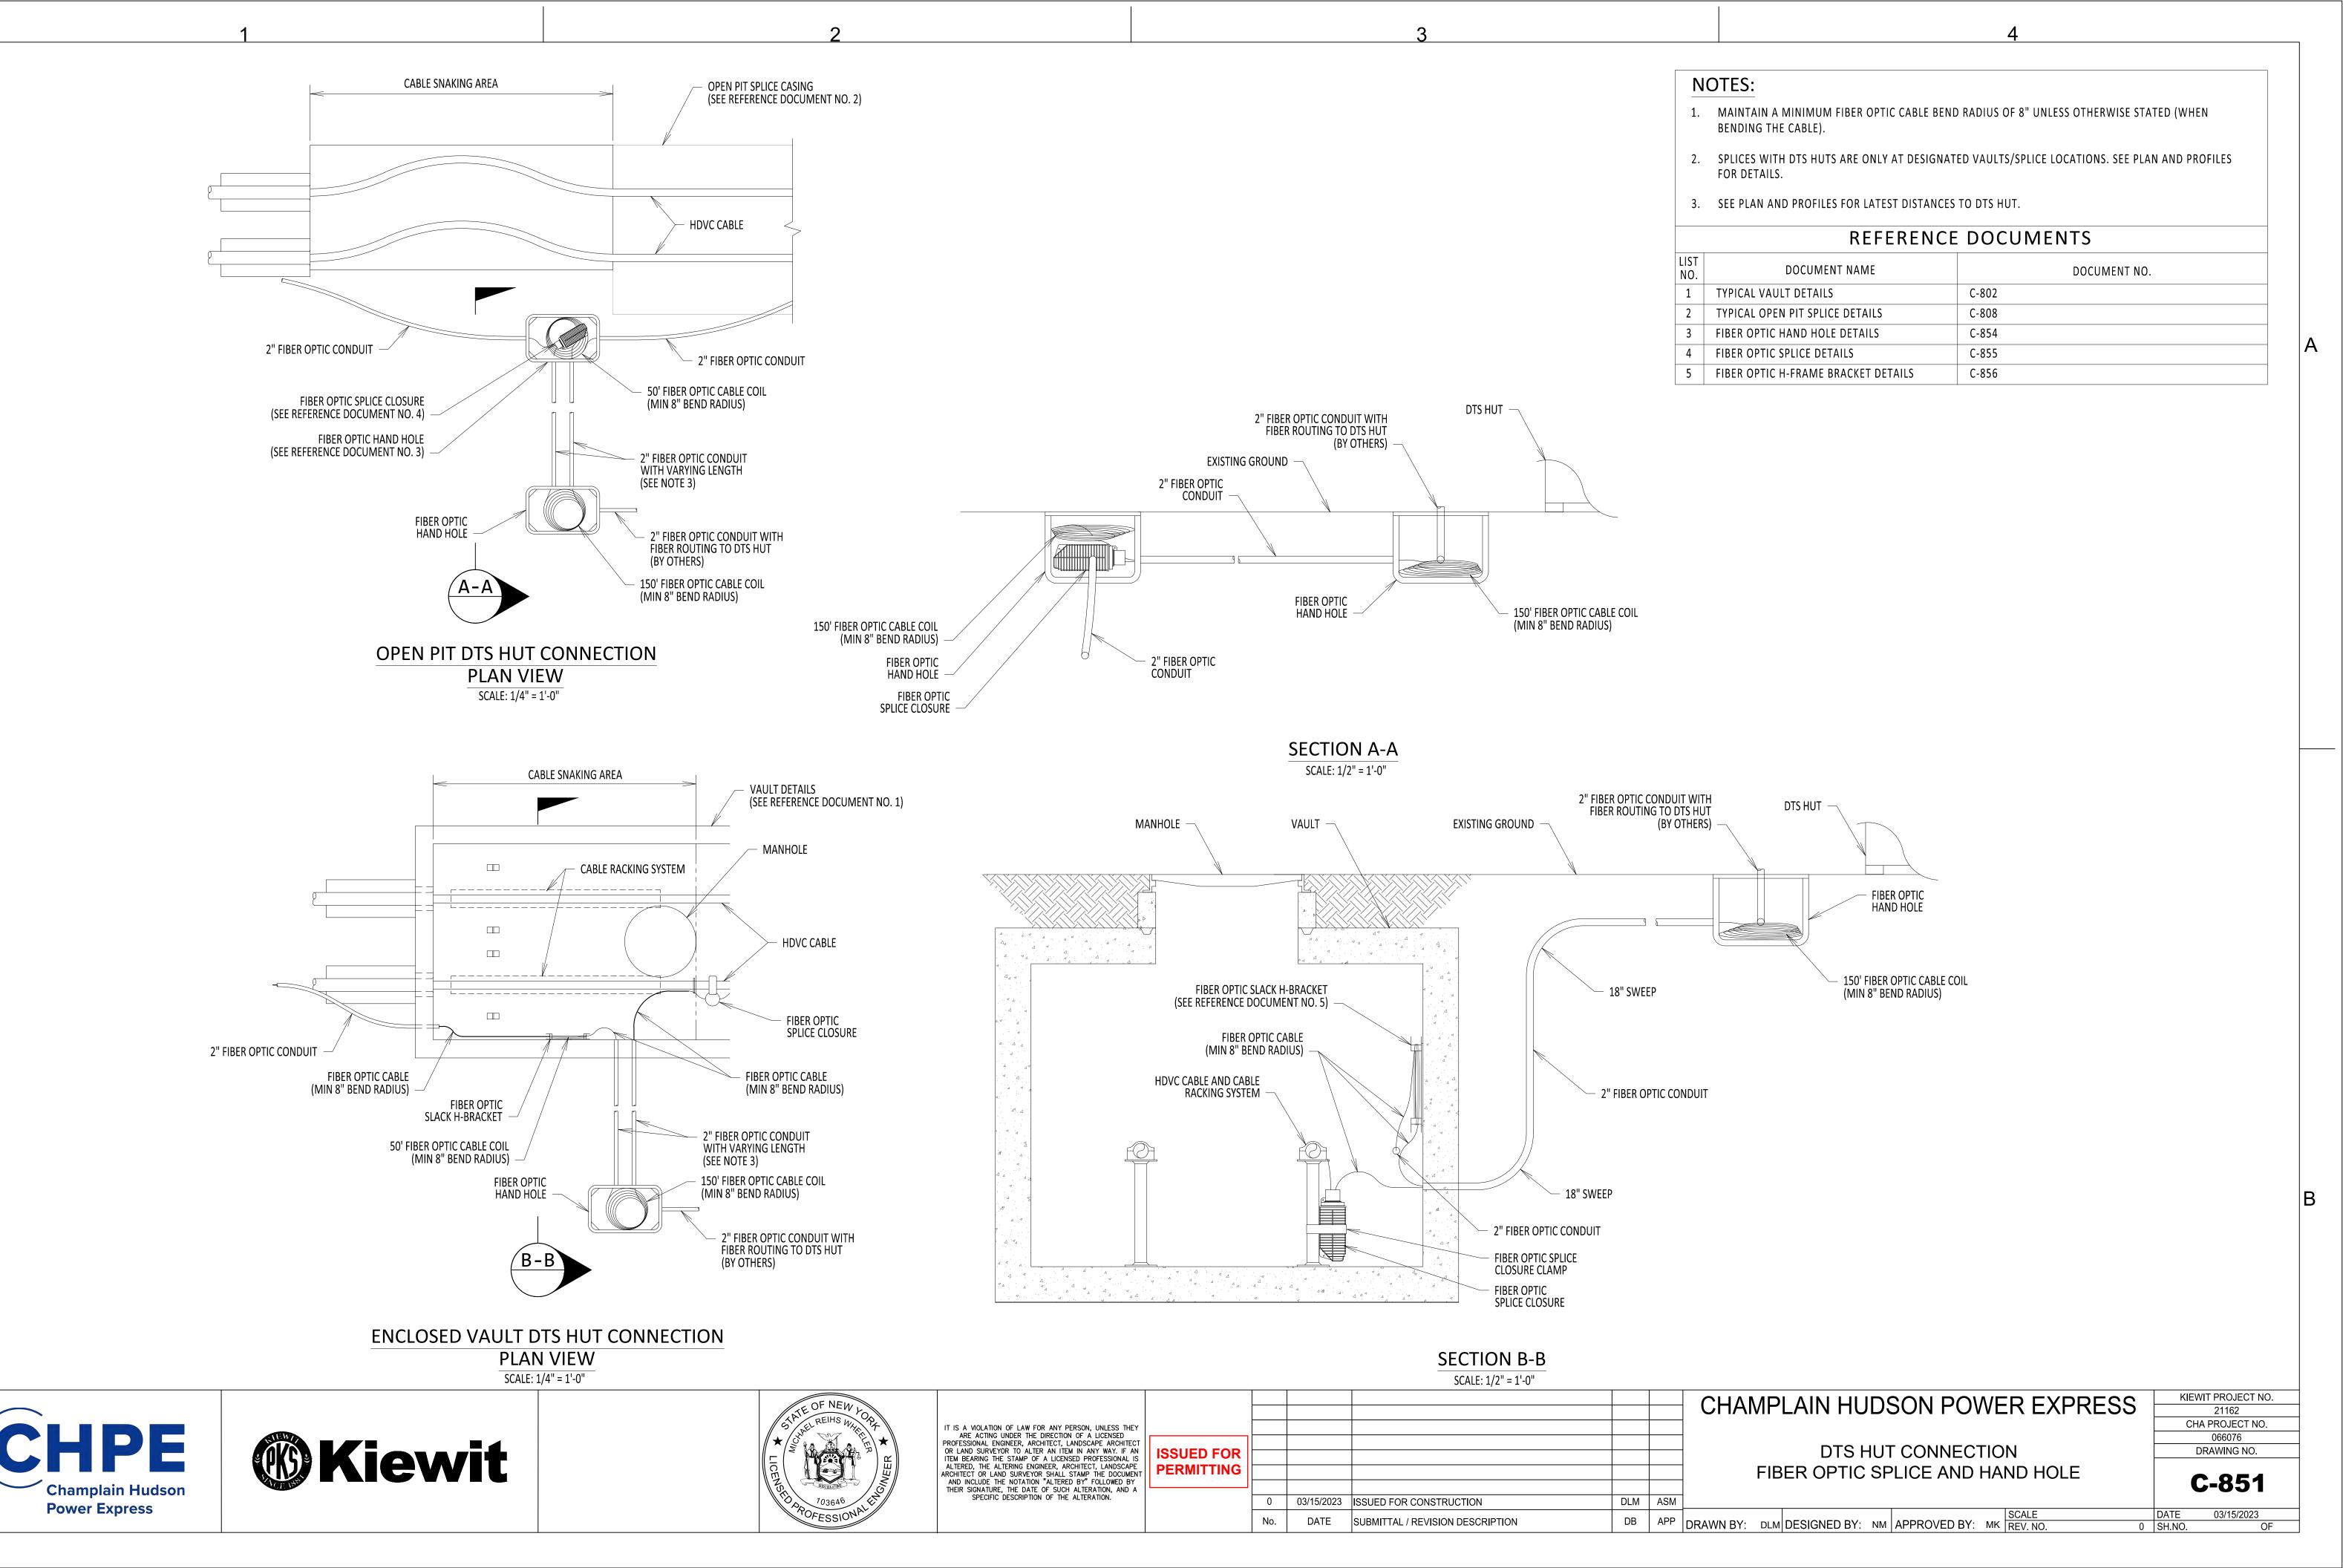

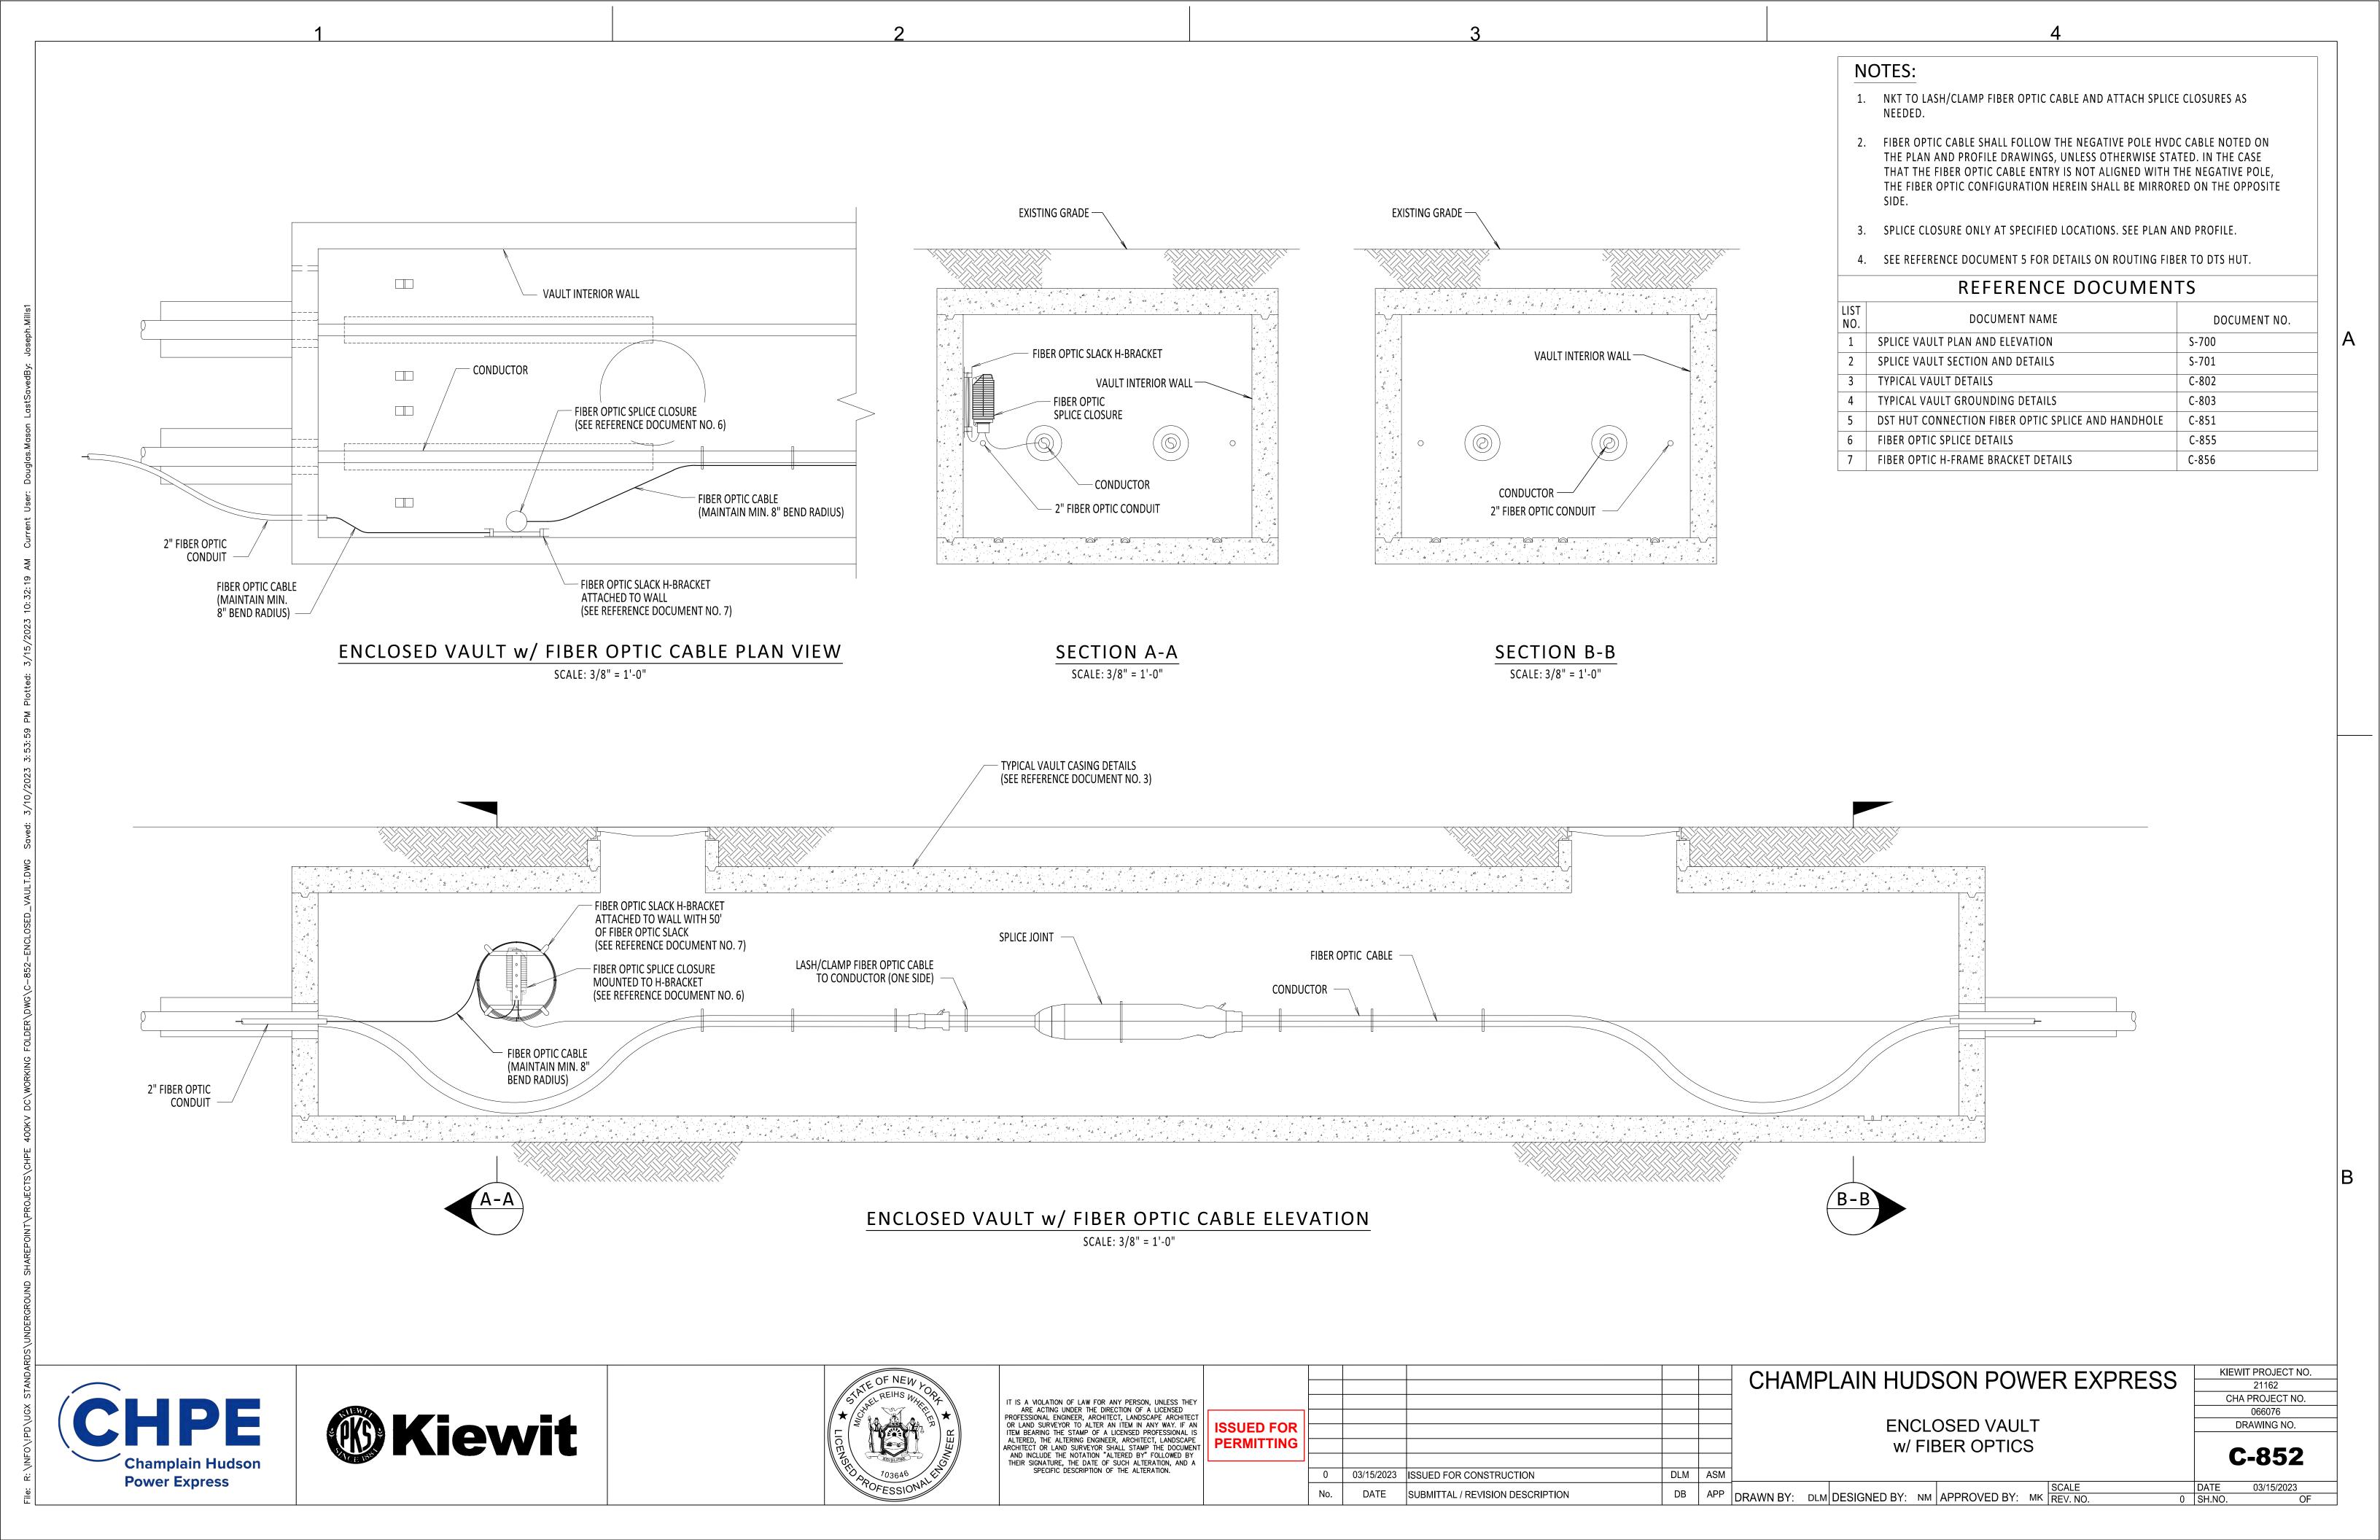


- 1. MAINTAIN 18" SWEEPS ON ALL CONDUITS.
- 2. DTS HUT FIBERS WILL SPLICE TO BLUE TUBE FIBER COLORS BLUE, ORANGE, GREEN AND BROWN.
- 3. SEE REFERENCE DOCUMENTS 2, 3, 4 AND 5 FOR PLACEMENT DETAILS.
- 4. FIBER OPTIC SPLICE CLOSURE ONLY IN SPECIFIC LOCATIONS. SEE PLAN AND PROFILES FOR DETAILS.


	REFERENCE DOCUMENTS							
LIST NO.	DOCUMENT NAME	DOCUMENT NO.						
1	FIBER OPTIC SPLICE CLOSURE	COMMSCOPE: MODEL NO. FOSC450-B6-6-24-1-B3V						
2	TRANSITION VAULT FIBER OPTIC DETAIL	C-850						
3	DTS HUT CONNECTION FIBER OPTIC SPLICE AND HANDHOLE	C-851						
4	ENCLOSED VAULT w/FIBER OPTICS	C-852						
5	OPEN VAULT W/FIBER OPTICS HAND HOLE	C-853						

FIBER OPTIC SPLICE CLOSURE


NOT TO SCALE

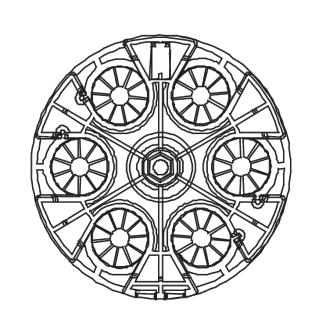


FIBER OPTIC SPLICE CLOSURE GEL-BLOCK PROFILE NOT TO SCALE

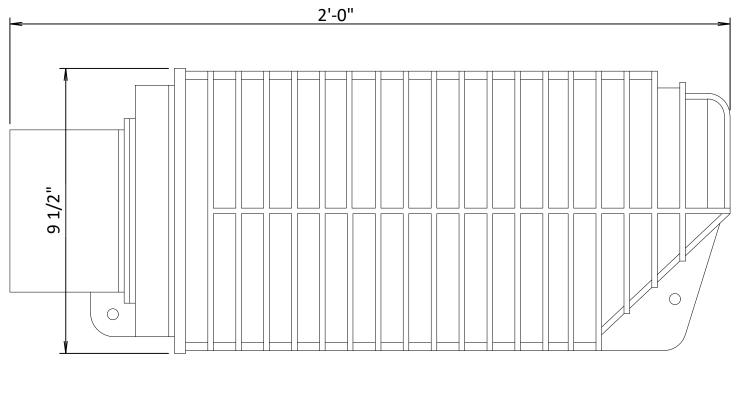

FIBER OPTIC SPLICE CLOSURE NOT TO SCALE

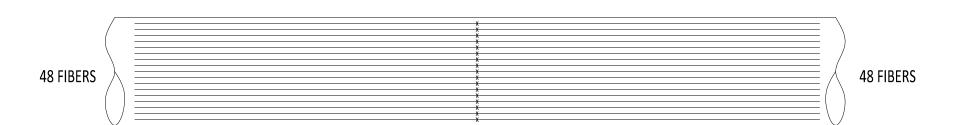

FIBER OPTIC CABLE SPLICE DIAGRAM TYPICAL NOT TO SCALE

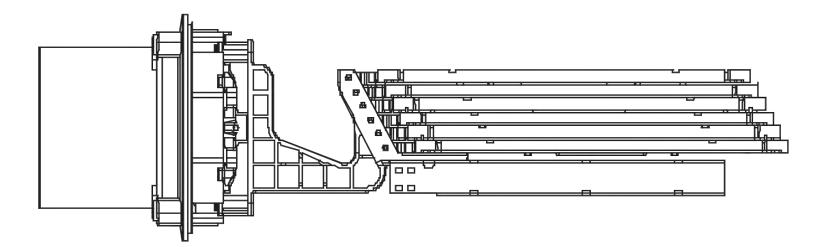


FIBER OPTIC SPLICE CLOSURE INSIDE DIAGRAM NOT TO SCALE





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03/15/2023 ISSUED FOR CONSTRUCTION DLM ASM SUBMITTAL / REVISION DESCRIPTION

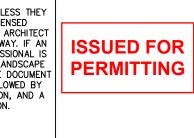CHAMPLAIN HUDSON POWER EXPRESS

FIBER OPTIC SPLICE DETAILS

21162 CHA PROJECT NO. 066076 DRAWING NO. **C-855**

KIEWIT PROJECT NO.

03/15/2023 OF

Kiewit

DB APP DRAWN BY: DLM DESIGNED BY: NM APPROVED BY: MK REV. NO.

- FIBER OPTIC H-BRACKET

(SEE REFERENCE DOCUMENT 1)

- FIBER OPTIC CABLE

2. IN VAULT PULL FROM DISTANT MANHOLE THEN COIL AND PLACE ON H-FRAME BRACKET.

3. H-FRAME IS ONLY USED IN ENCLOSED VAULTS. SEE REFERENCE DOCUMENTS 2 AND 3 FOR PLACEMENT DETAILS.

4. H-FRAME BRACKET DEPTH IS 4.50".


5. H-FRAME BRACKET TO BE GROUNDED TO THE GROUNDING HALO WITHIN AN ENCLOSED VAULT. SEE DRAWING C-803 FOR ENCLOSED VAULT GROUNDING DETAILS.

6. H-FRAME BRACKET IS MADE OF 12GA GALVANIZED STEEL.

7. 1/2" LAG BOLT DOES NOT COME WITH H-BRACKET ASSEMBLY AND NEEDS TO BE PROCURED AS NEEDED. BOLT TO BE INSTALLED INTO VAULT WALL BY FIELD PERSONNEL.

REFERENCE DOCUMENTS

LIST NO.	DOCUMENT NAME	DOCUMENT NO.
1	AMERICAN PRODUCT	H-FRAME POLE BRACKET MODEL NO: AM-3432-FSF-G-B x2
2	TYPICAL VAULT GROUNDING DETAILS	C-803
3	TRANSITION VAULT FIBER OPTIC DETAILS	C-850
4	ENCLOSED VAULT w/FIBER OPTICS	C-852

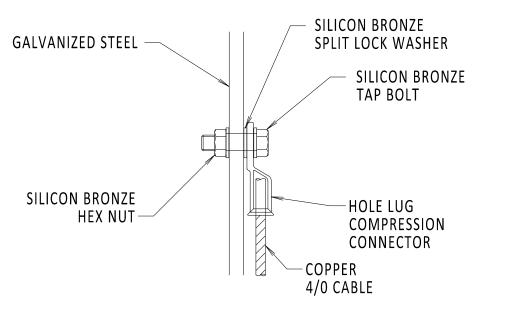

DETAIL A NOT TO SCALE




NOT TO SCALE







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- CABLE TIE (AS PER FIELD REQUIREMENT)

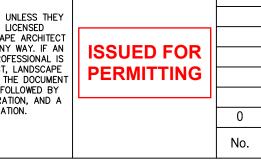— 1/2" LAG BOLT

- COPPER 4/0 GROUNDING CABLE

- CLAMP TO VAULT WALL (USE AS NEEDED)

— 1/2" LAG BOLT

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CHAMPLAIN HUDSON POWER EXPRESS

FIBER OPTIC H-FRAME BRACKET DETAIL

KIEWIT PROJECT NO. 21162 CHA PROJECT NO. 066076 DRAWING NO.

C-856

TYPICAL TRENCH SECTION - SHEET C-621-— EXIST. UTILITY (DEPTH AND DIAMETER VARIES/TO BE CONFIRMED PRIOR TO CONSTRUCTION)


TYPICAL TRENCH SECTION
- SHEET C-621-DUCT BANK — - EXIST. UTILITY (DEPTH AND DIAMETER VARIES/TO BE CONFIRMED PRIOR TO CONSTRUCTION)

1 OPEN TRENCH - HORIZONTAL SEPARATION NOT TO SCALE


3 OPEN TRENCH - VERTICAL SEPARATION (UNDER)
NOT TO SCALE

DUCT BANK —


5 OPEN TRENCH - VERTICAL SEPARATION (OVER)
NOT TO SCALE

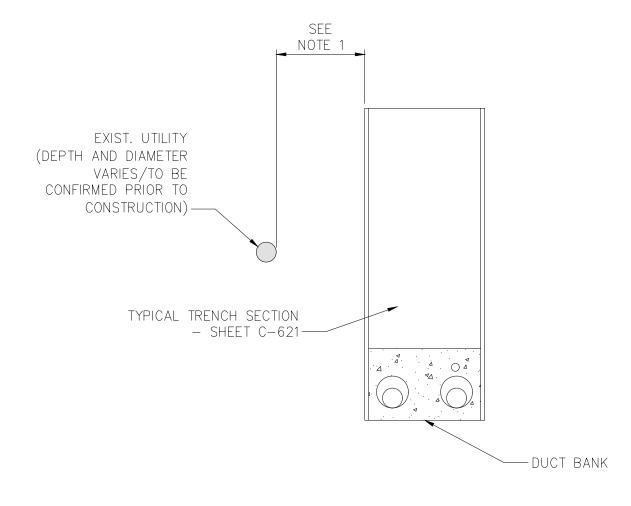

2 TYPICAL DUCTBANK IN ROADWAY - HORIZONTAL SEPARATION
NOT TO SCALE

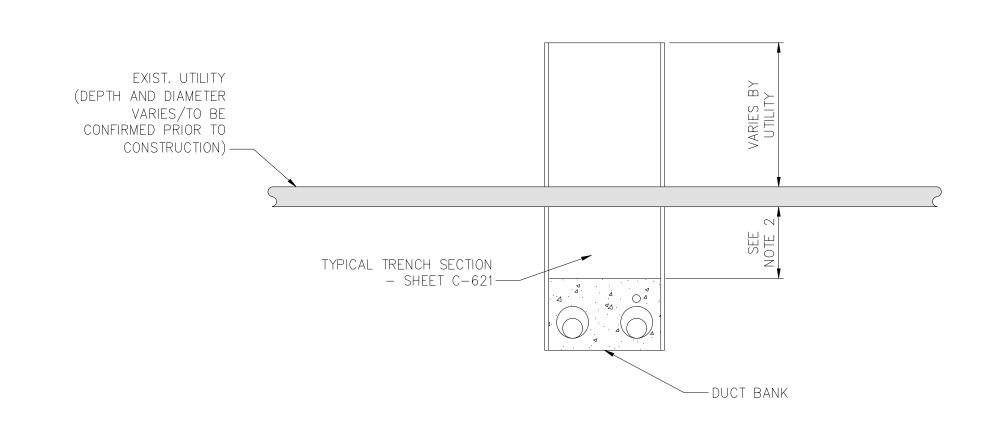

4 TYPICAL DUCTBANK IN ROADWAY - VERTICAL SEPARATION (UNDER)
NOT TO SCALE

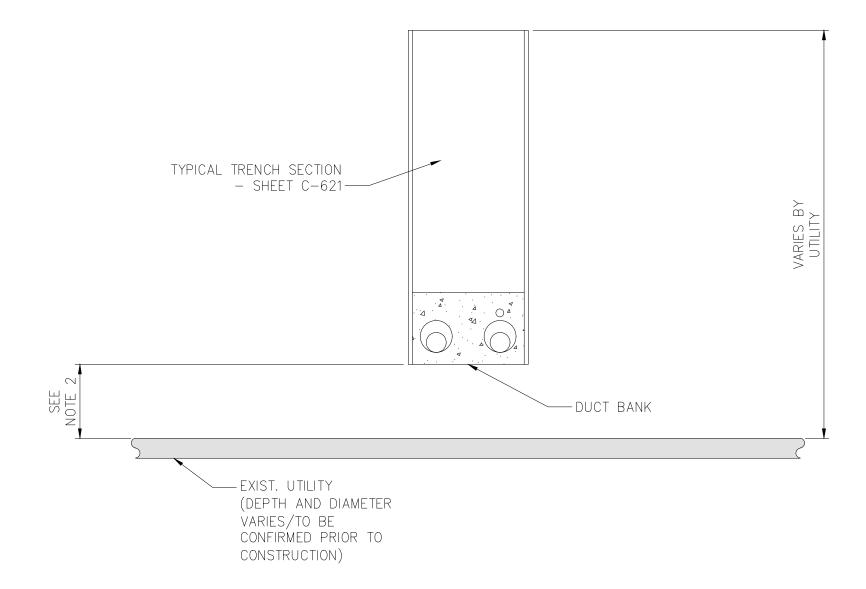

6 TYPICAL DUCTBANK IN ROADWAY - VERTICAL SEPARATION (OVER)

1. 2.0' MIN HORIZONTAL SEPARATION FOR ALL EXISTING UTILITIES, EXCEPT 5.0' MIN FOR GAS DISTRIBUTION LINES 2. 1.5' MIN VERTICAL SEPARATION FOR ALL EXISTING UTILITIES, EXCEPT 2.0' MIN FOR GAS DISTRIBUTION LINES







TETRA TECH ENGINEERING AND SURVEYING P.C.

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	F	04/14/2023	FINAL SUBMISSION	BV	TK	SEGMENT 12 (PACKAGE 7B) - ROU							
	E	03/01/2023	DRAFT FINAL REV 1 SUBMISSION	BV	TK		,		,				
2	D	11/16/2022	DRAFT FINAL SUBMISSION	BV	TK			R	DCKLAND				
•	С	05/20/2022	60% DESIGN SUBMISSION	BV	TK	UTILITY TYPICAL							
	В	03/23/2022	PRELIMINARY DESIGN DEVELOPMENT	BV	TK		SEPERATION DETAILS						
	Α	02/18/2022	PRELIMINARY PROGRESS	BV	TK		SEP		ATION DETAILS				
	No.	DATE	SUBMITTAL / REVISION DESCRIPTION	DB	APP	DD 414/41 D)/	DEGLONIED DV	5) /	4 DDD 0) (ED D) (- T) (SCALE			
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HAMPLAIN HUDSON POWER EXPRESS
SEGMENT 12 (PACKAGE 7B) - ROUTE 9W:
ROCKLAND
UTILITY TYPICAL
SEPERATION DETAILS

KIEWIT PROJECT NO.
21162
TT PROJECT NO.
204-3701
DRAWING NO.
C-901

AS NOTED DATE

6-30 I 04/14/2023 ---- OF **--** TEMPORARY ACCESS ROAD
(REFER TO SHT. C-631 DETAIL 2 FOR PAVEMENT DETAILS) (TO BE RESTORED TO ORIGINAL CONDITION AT CONCLUSION OF WORK)

TRANSITION VAULT 3
(SEE SHEETS C-805 AND S-731 FOR DETAILS)

1 TRANSITION VAULT #3 AT STONY POINT AT STA. 72495+50

SCALE: 1" = 5'

EXISTING
GRADE


ACCESS ROAD

SEE C-631 DETAIL 6 FOR RESTORATION DETAIL.

HDD 124 ENTRY PIT AT STA. 72496+70

TRENCH FROM TV-3 TO ENTRY PIT OF HDD 124


SCALE: 1" = 5'

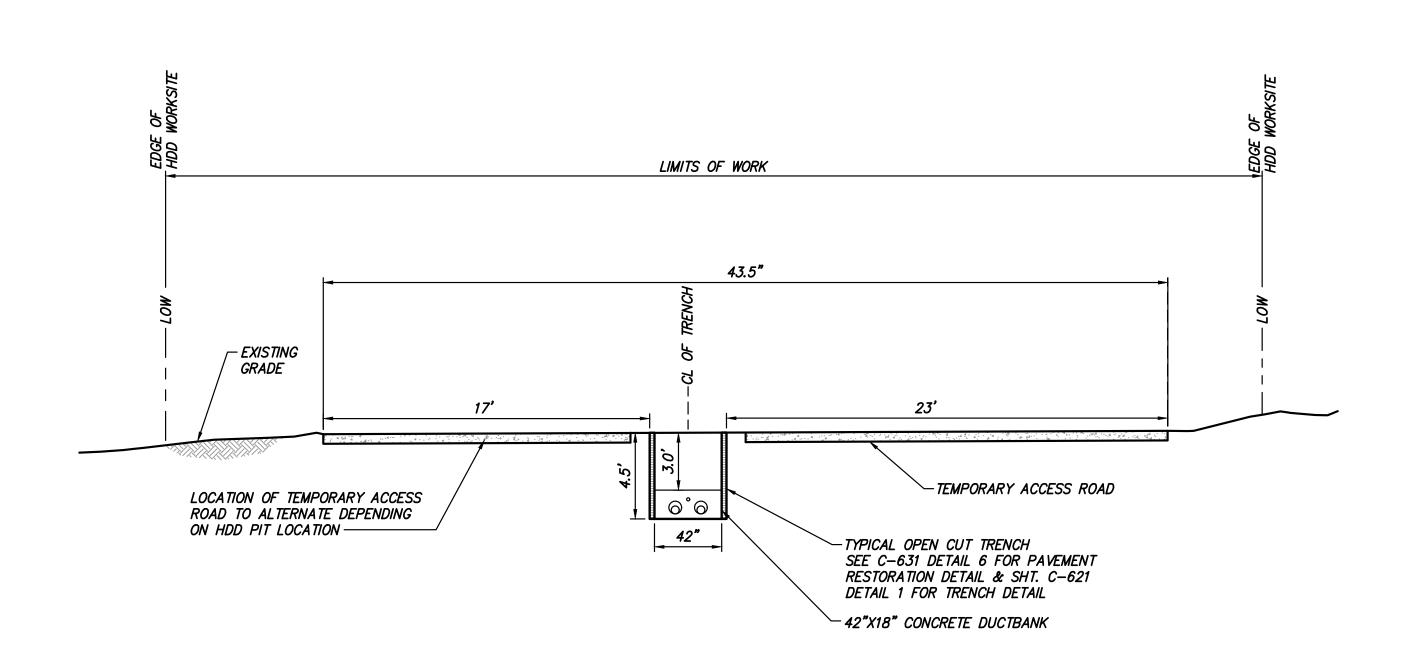

TRENCH AT STA. 72496+25

TRENCH FROM TV-3 TO ENTRY PIT OF HDD 124

SCALE: 1" = 5'

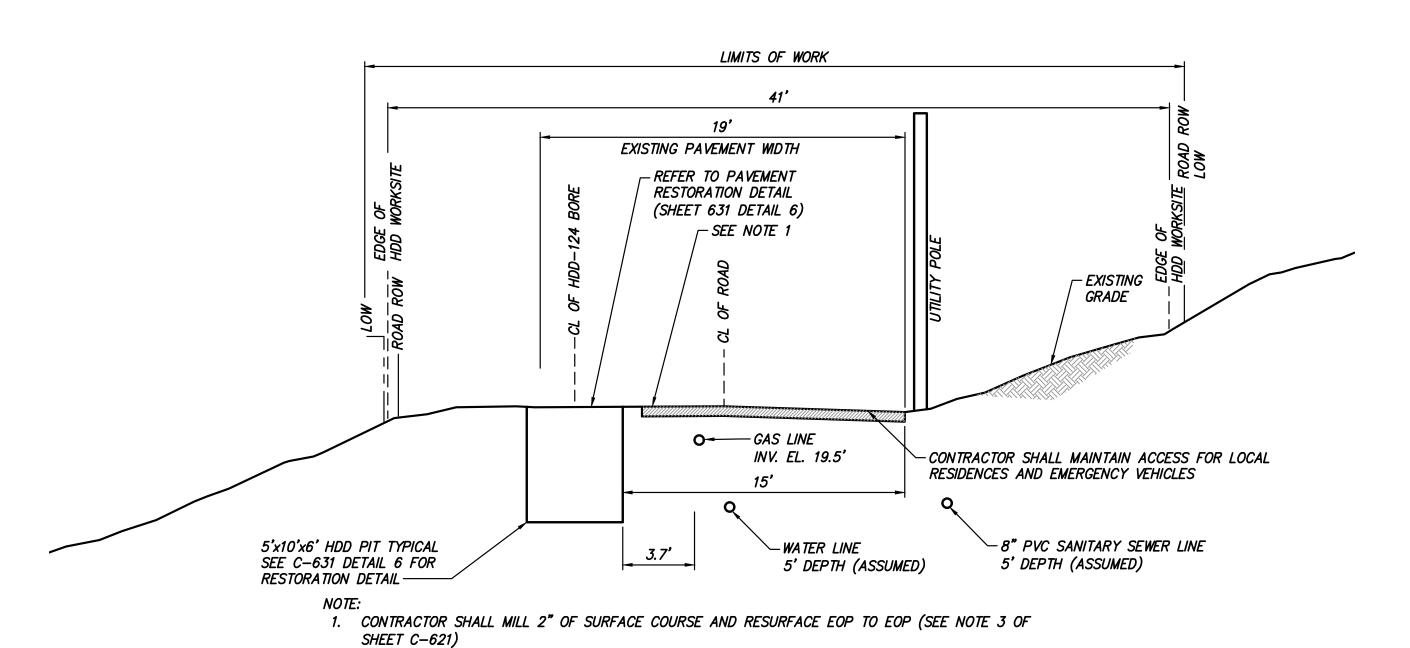

HDD 124 EXIT PIT AT STA. 72504+15

TRENCH FROM EXIT PIT OF HDD 124 TO INERSECTION OF PARK AVE AND BATTLEFIELD ROAD

SCALE: 1" = 5'







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SURVEYOR TO ALTER AN ITEM IN ANY WAY. IF AN ITEM BEARING THE STAMP OF A LICENSED PROFESSIONAL IS ALTEREDS SUFERFOR ENGINEER, ARCHITECT, LANDSCAPE ARCHITECT OR LAND.

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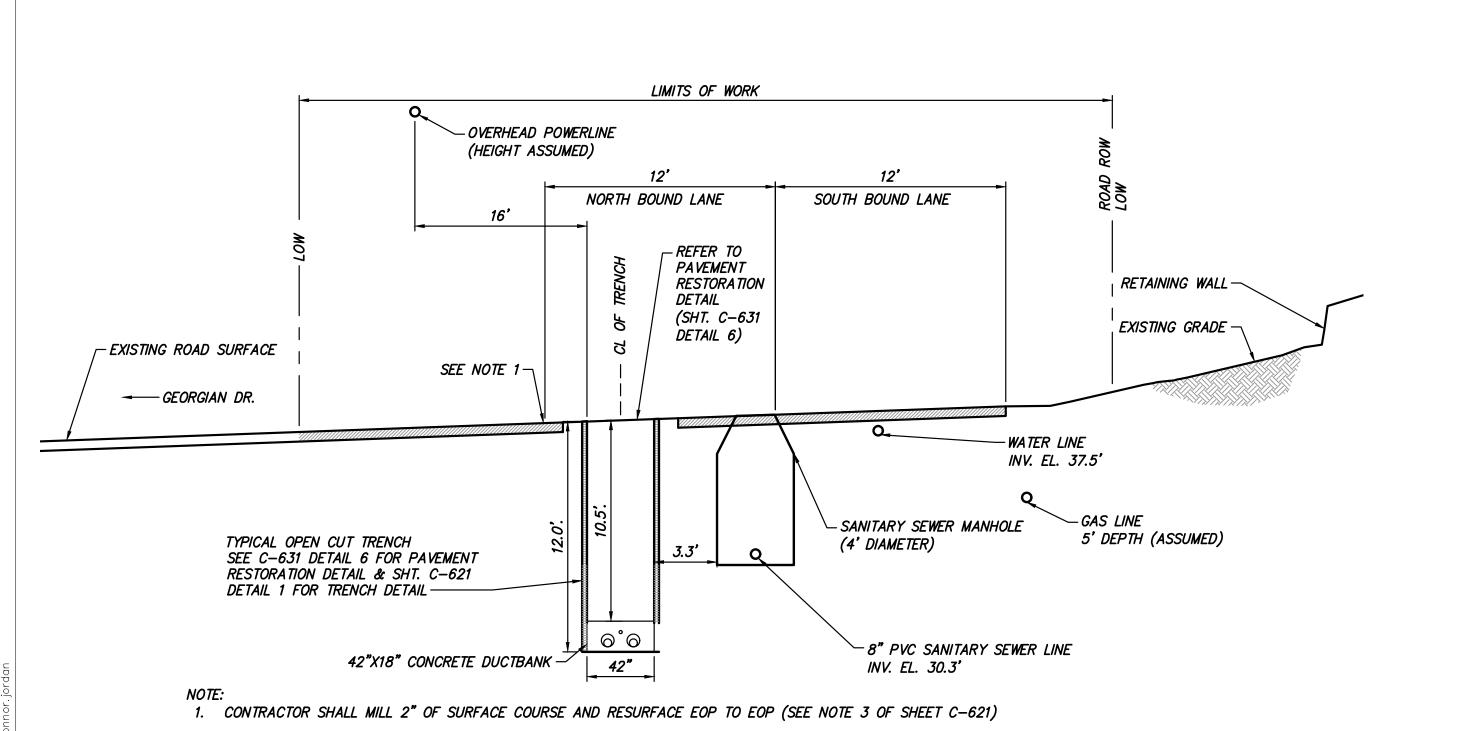
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Ц	В	03/01/2023	DRAFT FINAL REV 1 SUBMISSION	MP	JL]
	Α	10/21/2022	DOT PROGRESS SUBMISSION	MP	AR	
	No.	DATE	SUBMITTAL / REVISION DESCRIPTION	DB	APP	DRA

CHAMPLAIN HUDSON POWER EXPRESS
SEGMENT 12 (PACKAGE 7B) - ROUTE 9W:
ROCKLAND
ROAD SECTION EXHIBIT

KIEWIT PROJECT NO.
21162
TT PROJECT NO.
204-3701
DRAWING NO.

STA. 72495+50 TO STA. 72504+15

DRAWN BY: WJ DESIGNED BY: AC APPROVED BY: JL SCALE AS SHOWN DATE 04/14/REV. NO. C SH.NO. OF




TRENCH AT STA. 72506+50

TRENCH FROM EXIT PIT OF HDD 124 TO INERSECTION OF PARK AVE AND BATTLEFIELD ROAD SCALE: 1" = 5

LIMITS OF WORK SHLDR NORTH BOUND LANE SOUTH BOUND LANE SHOULDER ROAD SURFACE - OVERHEAD POWERLINE - REFER TO (HEIGHT ASSUMED) **PAVEMENT RESTORATION** DETAIL (SHT. GUARDRAIL -C-631 DETAIL 6) RETAINING WALL-EXISTING GRADE --8" PVC SANITARY SEWER LINE INV. EL. 74.5' ଚ°ଚ -WATER LINE 5' DEPTH (ASSUMED) ~ 42"X18" CONCRETE DUCTBANK TYPICAL OPEN CUT TRENCH
SEE C-631 DETAIL 6 FOR PAVEMENT
RESTORATION DETAIL & SHT. C-621
DETAIL 1 FOR TRENCH DETAIL——— 5' DEPTH (ASSUMED)


1. CONTRACTOR SHALL MILL 2" OF SURFACE COURSE AND RESURFACE EOP TO EOP (REFER TO SHEET C-631 FOR PAVEMENT RESTORATION DETAILS) 2. CONTRACTOR MAY REMOVE THE EXISTING GUARDRAIL DURING CONSTRUCTION, IF NÈEDED. IF REMOVED, IT SHOULD BE REPLACED IN KIND AT THE END OF THE WORK. POSITIVE PROTECTION MUST BE PROVIDED TO THE APPROACH END OF GUARDRAIL AND/OR OTHER EXISTING OBSTRUCTION(S).

TRENCH AT STA. 72518+00
TRENCH FROM INTERSECTION OF PARK AVE & RT 9W TO NORTH OF JAMES FARLEY BRIDGE

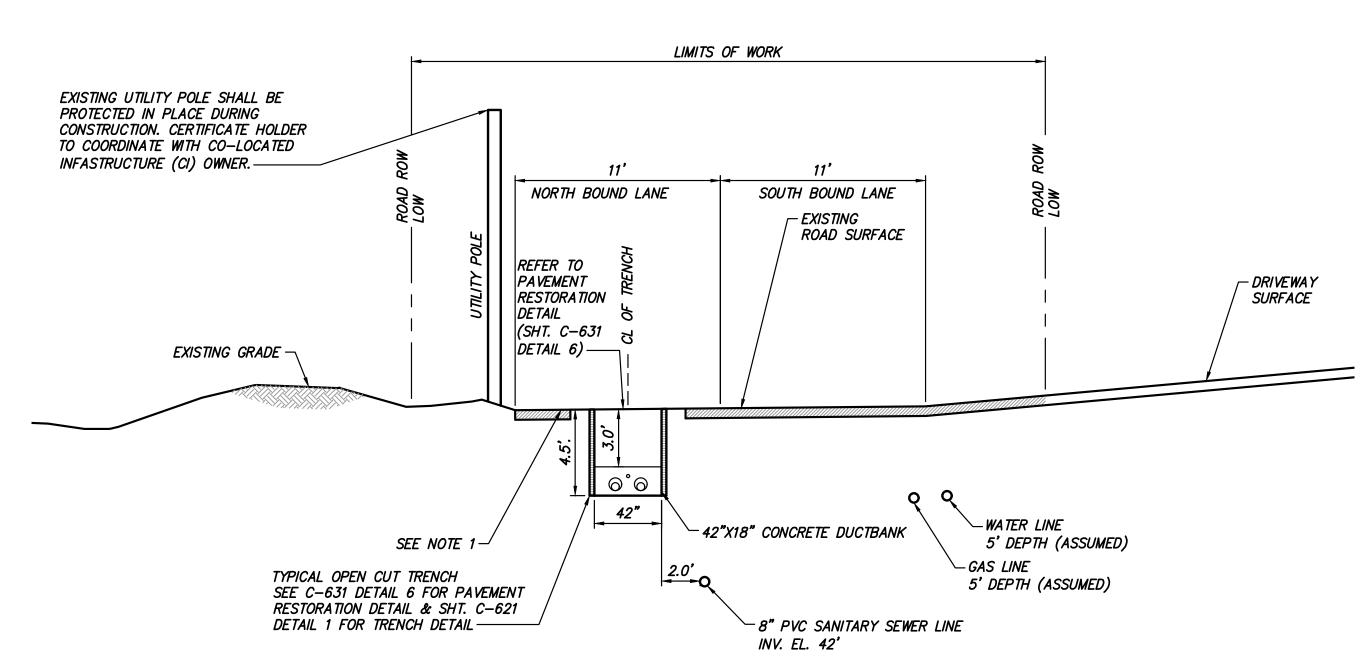

1. CONTRACTOR SHALL MILL 2" OF SURFACE COURSE AND RESURFACE EOP TO EOP (SEE NOTE 3 OF SHEET C-621)

TRENCH AT STA. 72512+70 TRENCH FROM EXIT PIT OF HDD 124 TO INERSECTION OF PARK AVE AND BATTLEFIELD ROAD

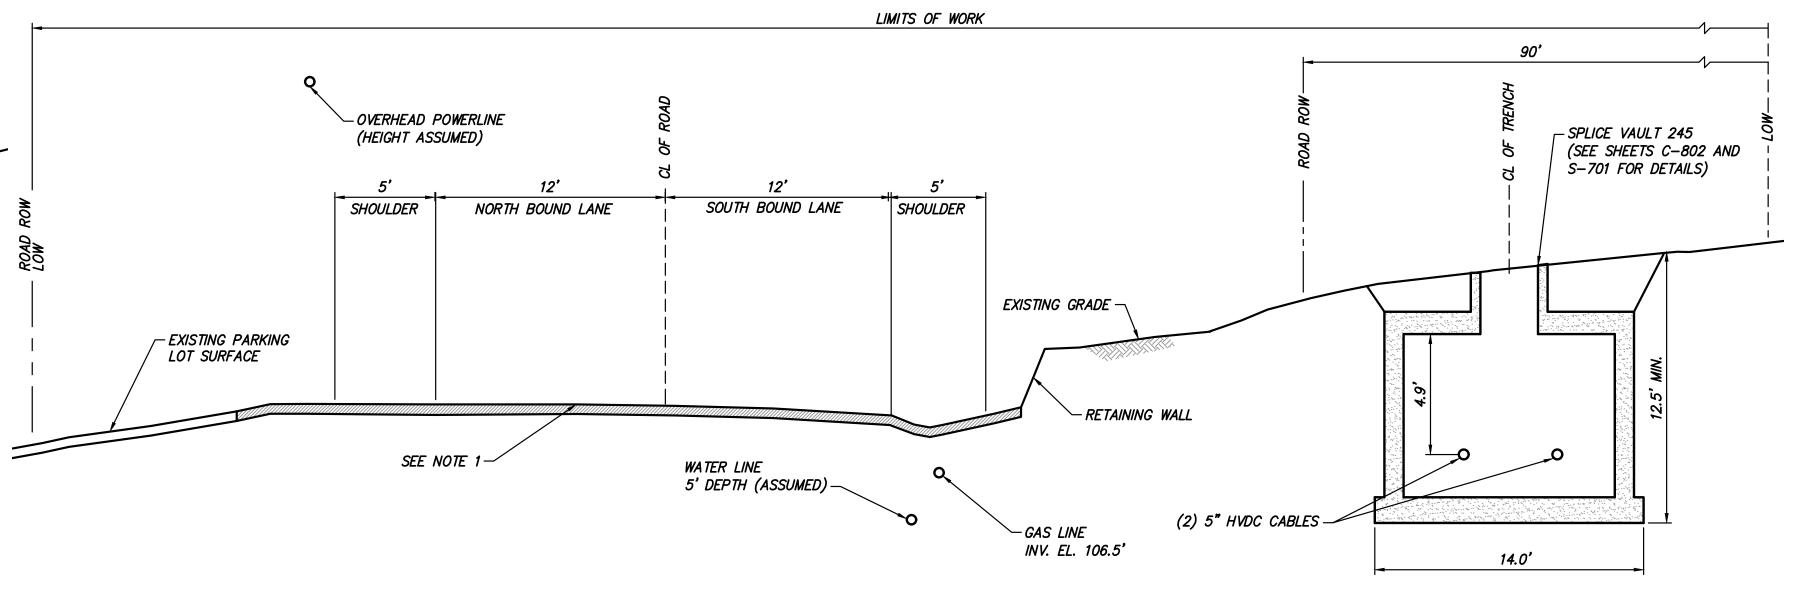

1. CONTRACTOR SHALL MILL 2" OF SURFACE COURSE AND RESURFACE EOP TO EOP (REFER TO SHEET C-631 FOR PAVEMENT RESTORATION DETAILS)

4 SPLICE VAULT 245 AT STA. 72527+50

SCALE: 1" = 5'

Power Express





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SURVEYOR SHALL STAMP THE DOCUMENT AND PRERMITHETING
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OF THE ALTERATION.


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•	С	04/14/2023	FINAL SUBMISSION	WJ	JL	
Ш	В	03/01/2023	DRAFT FINAL REV 1 SUBMISSION	MP	JL	
	Α	10/21/2022	DOT PROGRESS SUBMISSION	MP	AR	
	No.	DATE	SUBMITTAL / REVISION DESCRIPTION	DB	APP	DRA

CHAMPLAIN HUDSON POWER EXPRESS SEGMENT 12 (PACKAGE 7B) - ROUTE 9W: ROCKLAND **ROAD SECTION EXHIBIT** STA. 72506+50 TO STA. 72527+50

KIEWIT PROJECT NO. 21162 TT PROJECT NO. 204-3701 DRAWING NO.

C-1002

(A NEW YORK PROFESSIONAL CORPORATION) RAWN BY: WJ DESIGNED BY: AC APPROVED BY: JL REV. NO. AS SHOWN DATE

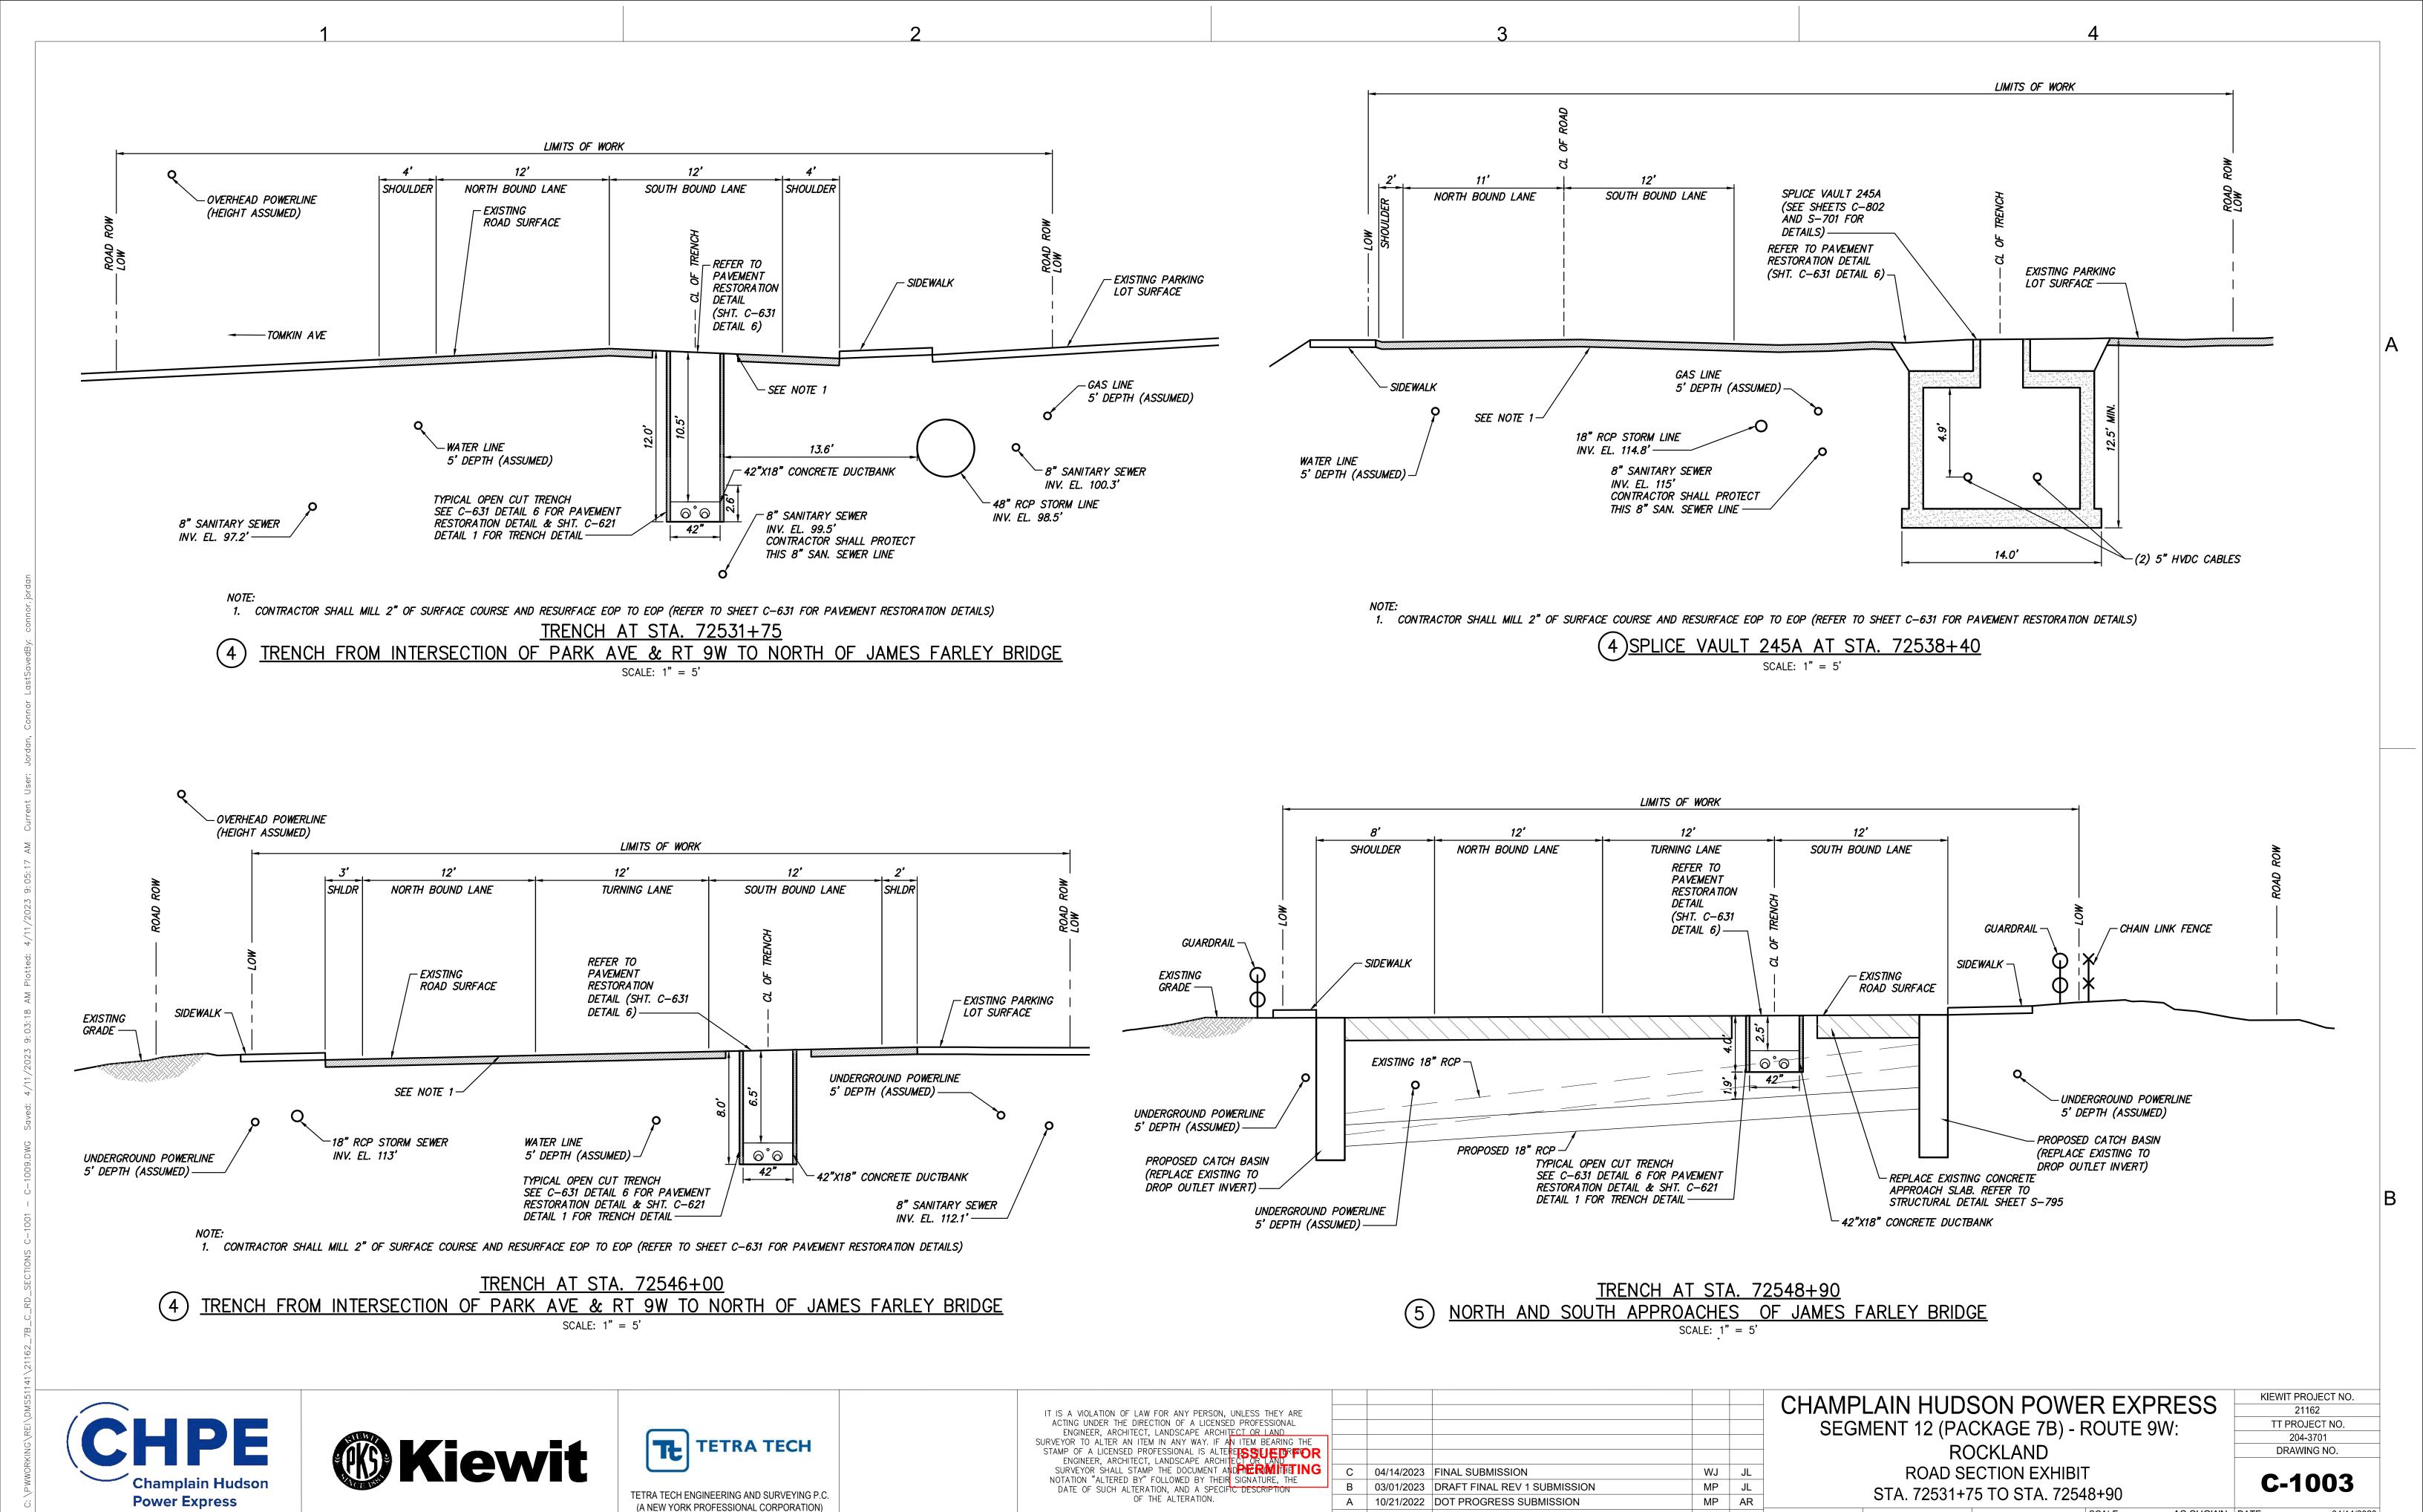



AS SHOWN DATE


DB APP DRAWN BY: WJ DESIGNED BY: AC APPROVED BY: JL REV. NO.

DATE SUBMITTAL / REVISION DESCRIPTION

04/14/2023

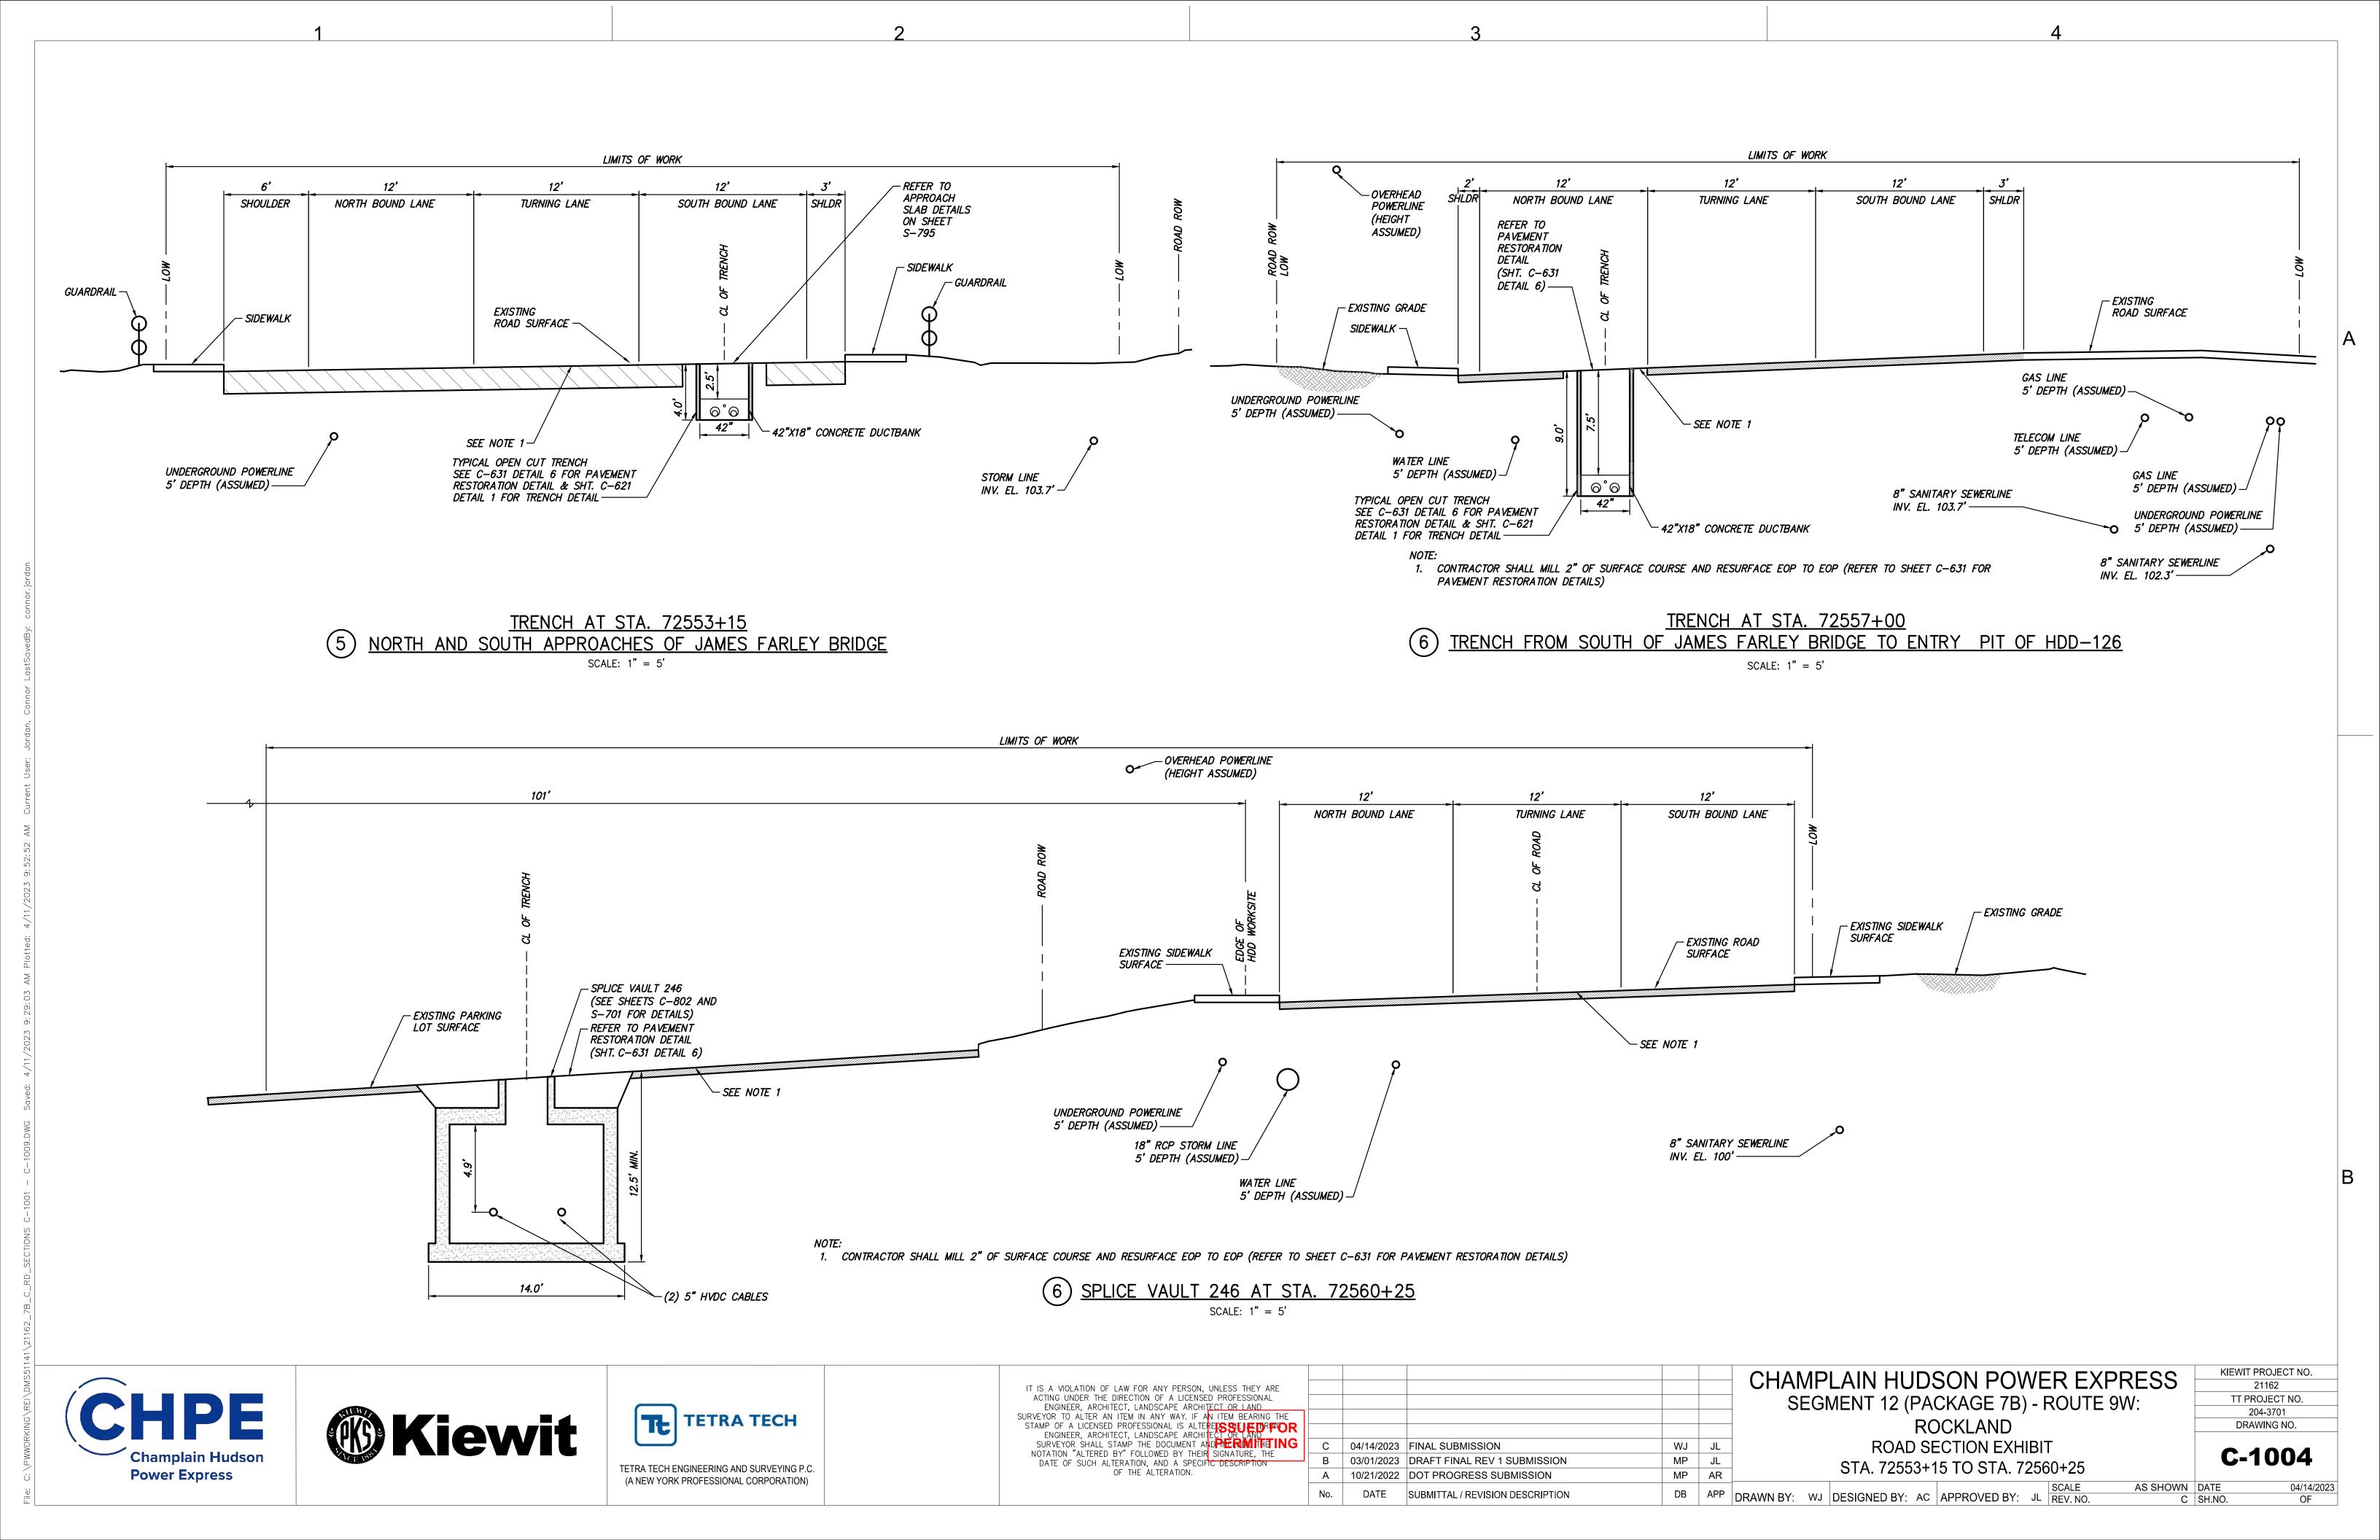

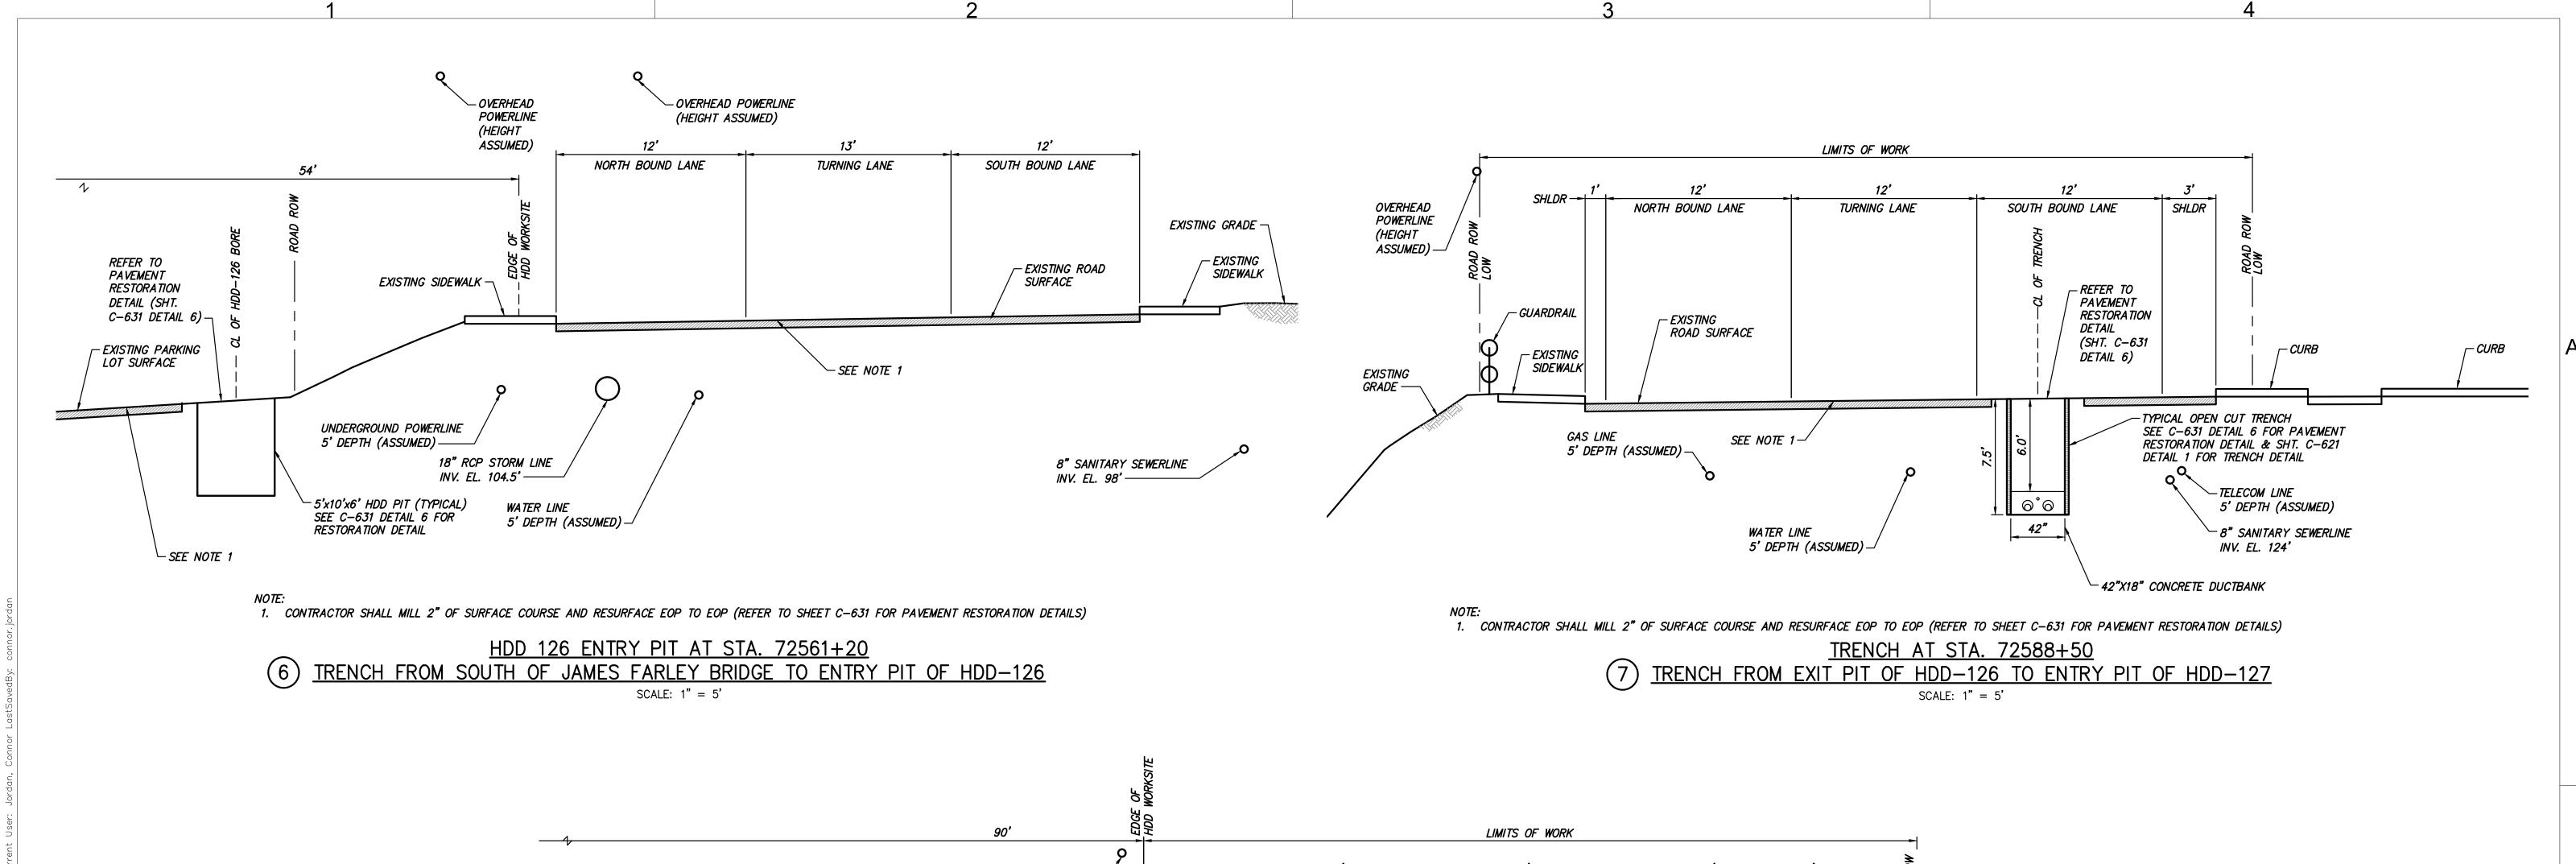

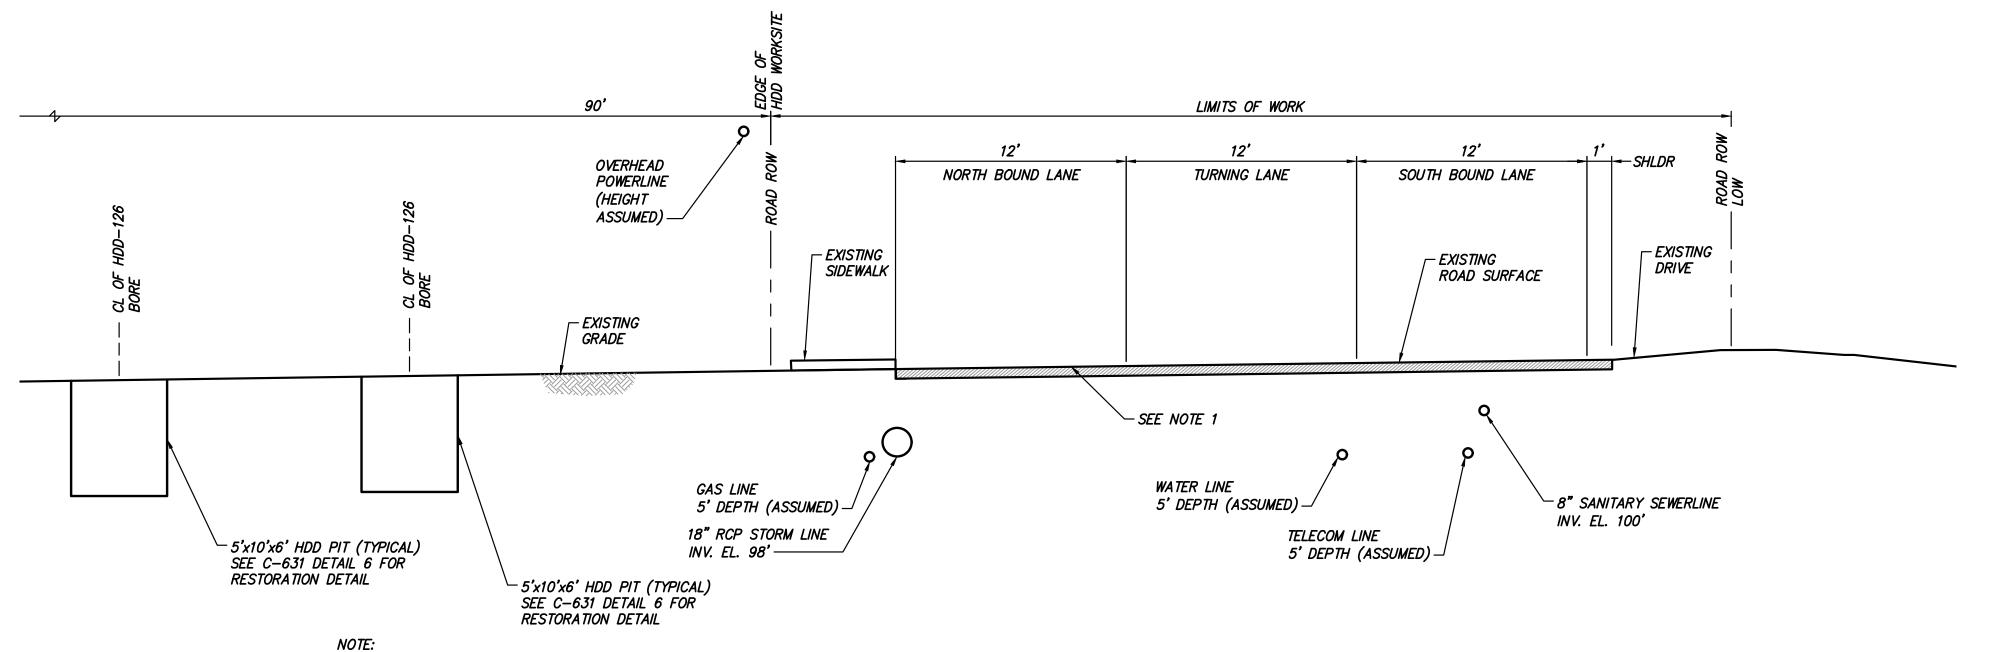

HDD 126 EXIT PIT AT STA. 72582+80
TRENCH FROM EXIT PIT OF HDD-126 TO ENTRY PIT OF HDD-127


SCALE: 1" = 5'

1. CONTRACTOR SHALL MILL 2" OF SURFACE COURSE AND RESURFACE EOP TO EOP (REFER TO SHEET C-631 FOR PAVEMENT RESTORATION DETAILS)







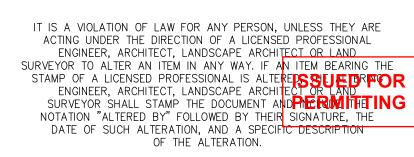



						→ CHAMPLAIN HUDSON POWER EX				
_						SEGMENT 12 (PACKAGE 7B) - ROUT				
2						ROCKLAND				
•	С	04/14/2023	FINAL SUBMISSION	WJ	JL	ROAD SECTION EXHIBIT				
	В	03/01/2023	DRAFT FINAL REV 1 SUBMISSION	MP	JL	STA. 72561+20 TO STA. 72588+50				
	Α	10/21/2022	DOT PROGRESS SUBMISSION	MP	AR	31A. 72301+20 TO 31A. 72300+30				
	No.	DATE	SUBMITTAL / REVISION DESCRIPTION	DB	APP	DRAWN BY: WJ DESIGNED BY: AC APPROVED BY: JL REV. NO.				

CHAMPLAIN HUDSON POWER EXPRESS
SEGMENT 12 (PACKAGE 7B) - ROUTE 9W:
ROCKLAND
ROAD SECTION EXHIBIT
STA. 72561+20 TO STA. 72588+50

KIEWIT PROJECT NO.
21162
TT PROJECT NO.
204-3701
DRAWING NO.
C-1005

C-1003 AS SHOWN DATE 04/14/2023

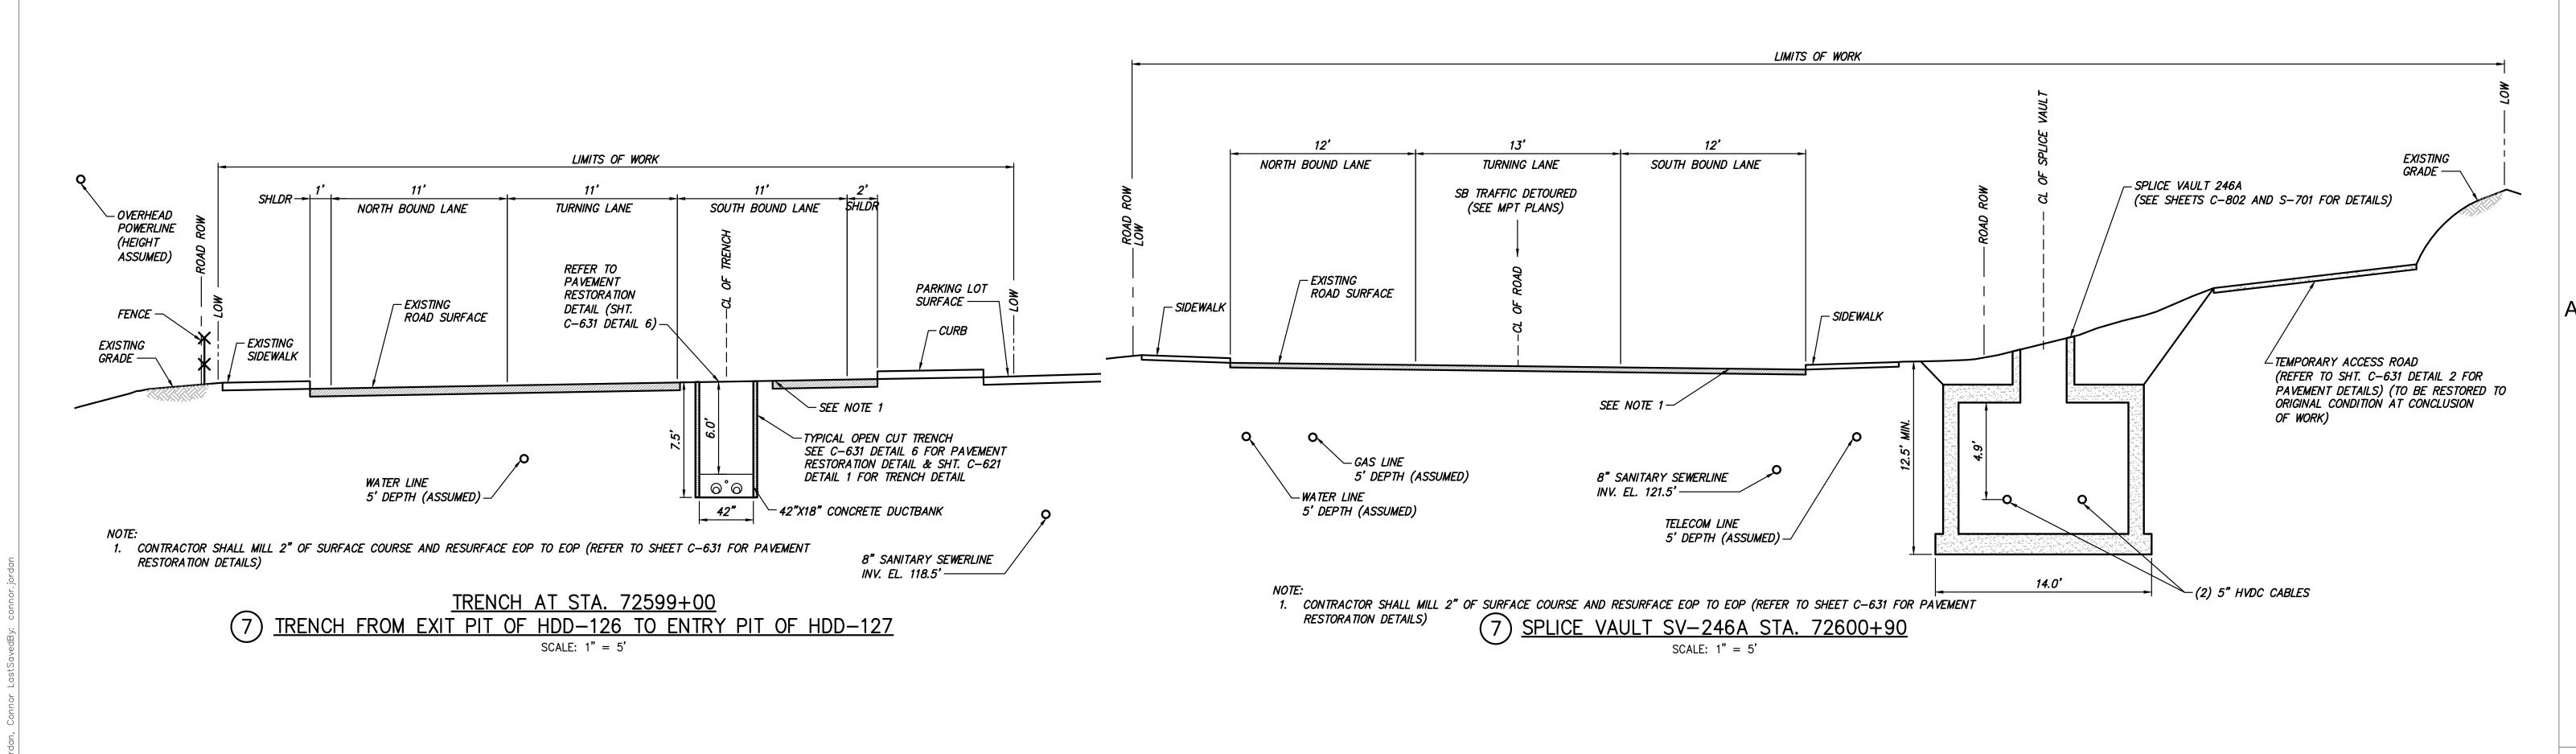

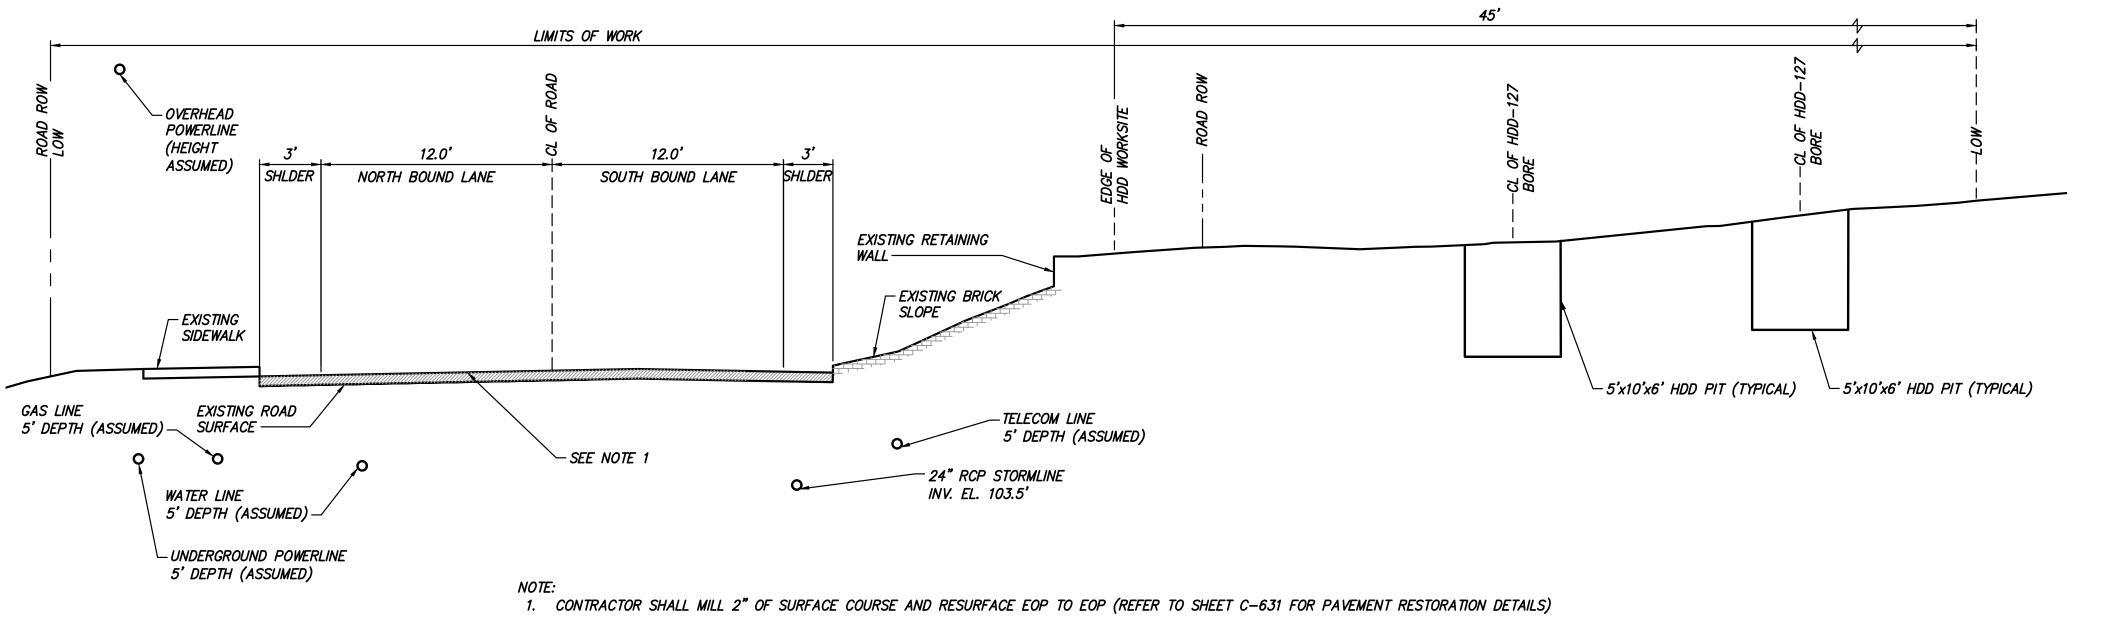

HDD 127 ENTRY PIT AT STA. 72611+00
TRENCH FROM EXIT PIT OF HDD-126 TO ENTRY PIT OF HDD-127 SCALE: 1" = 5'







(A NEW YORK PROFESSIONAL CORPORATION)


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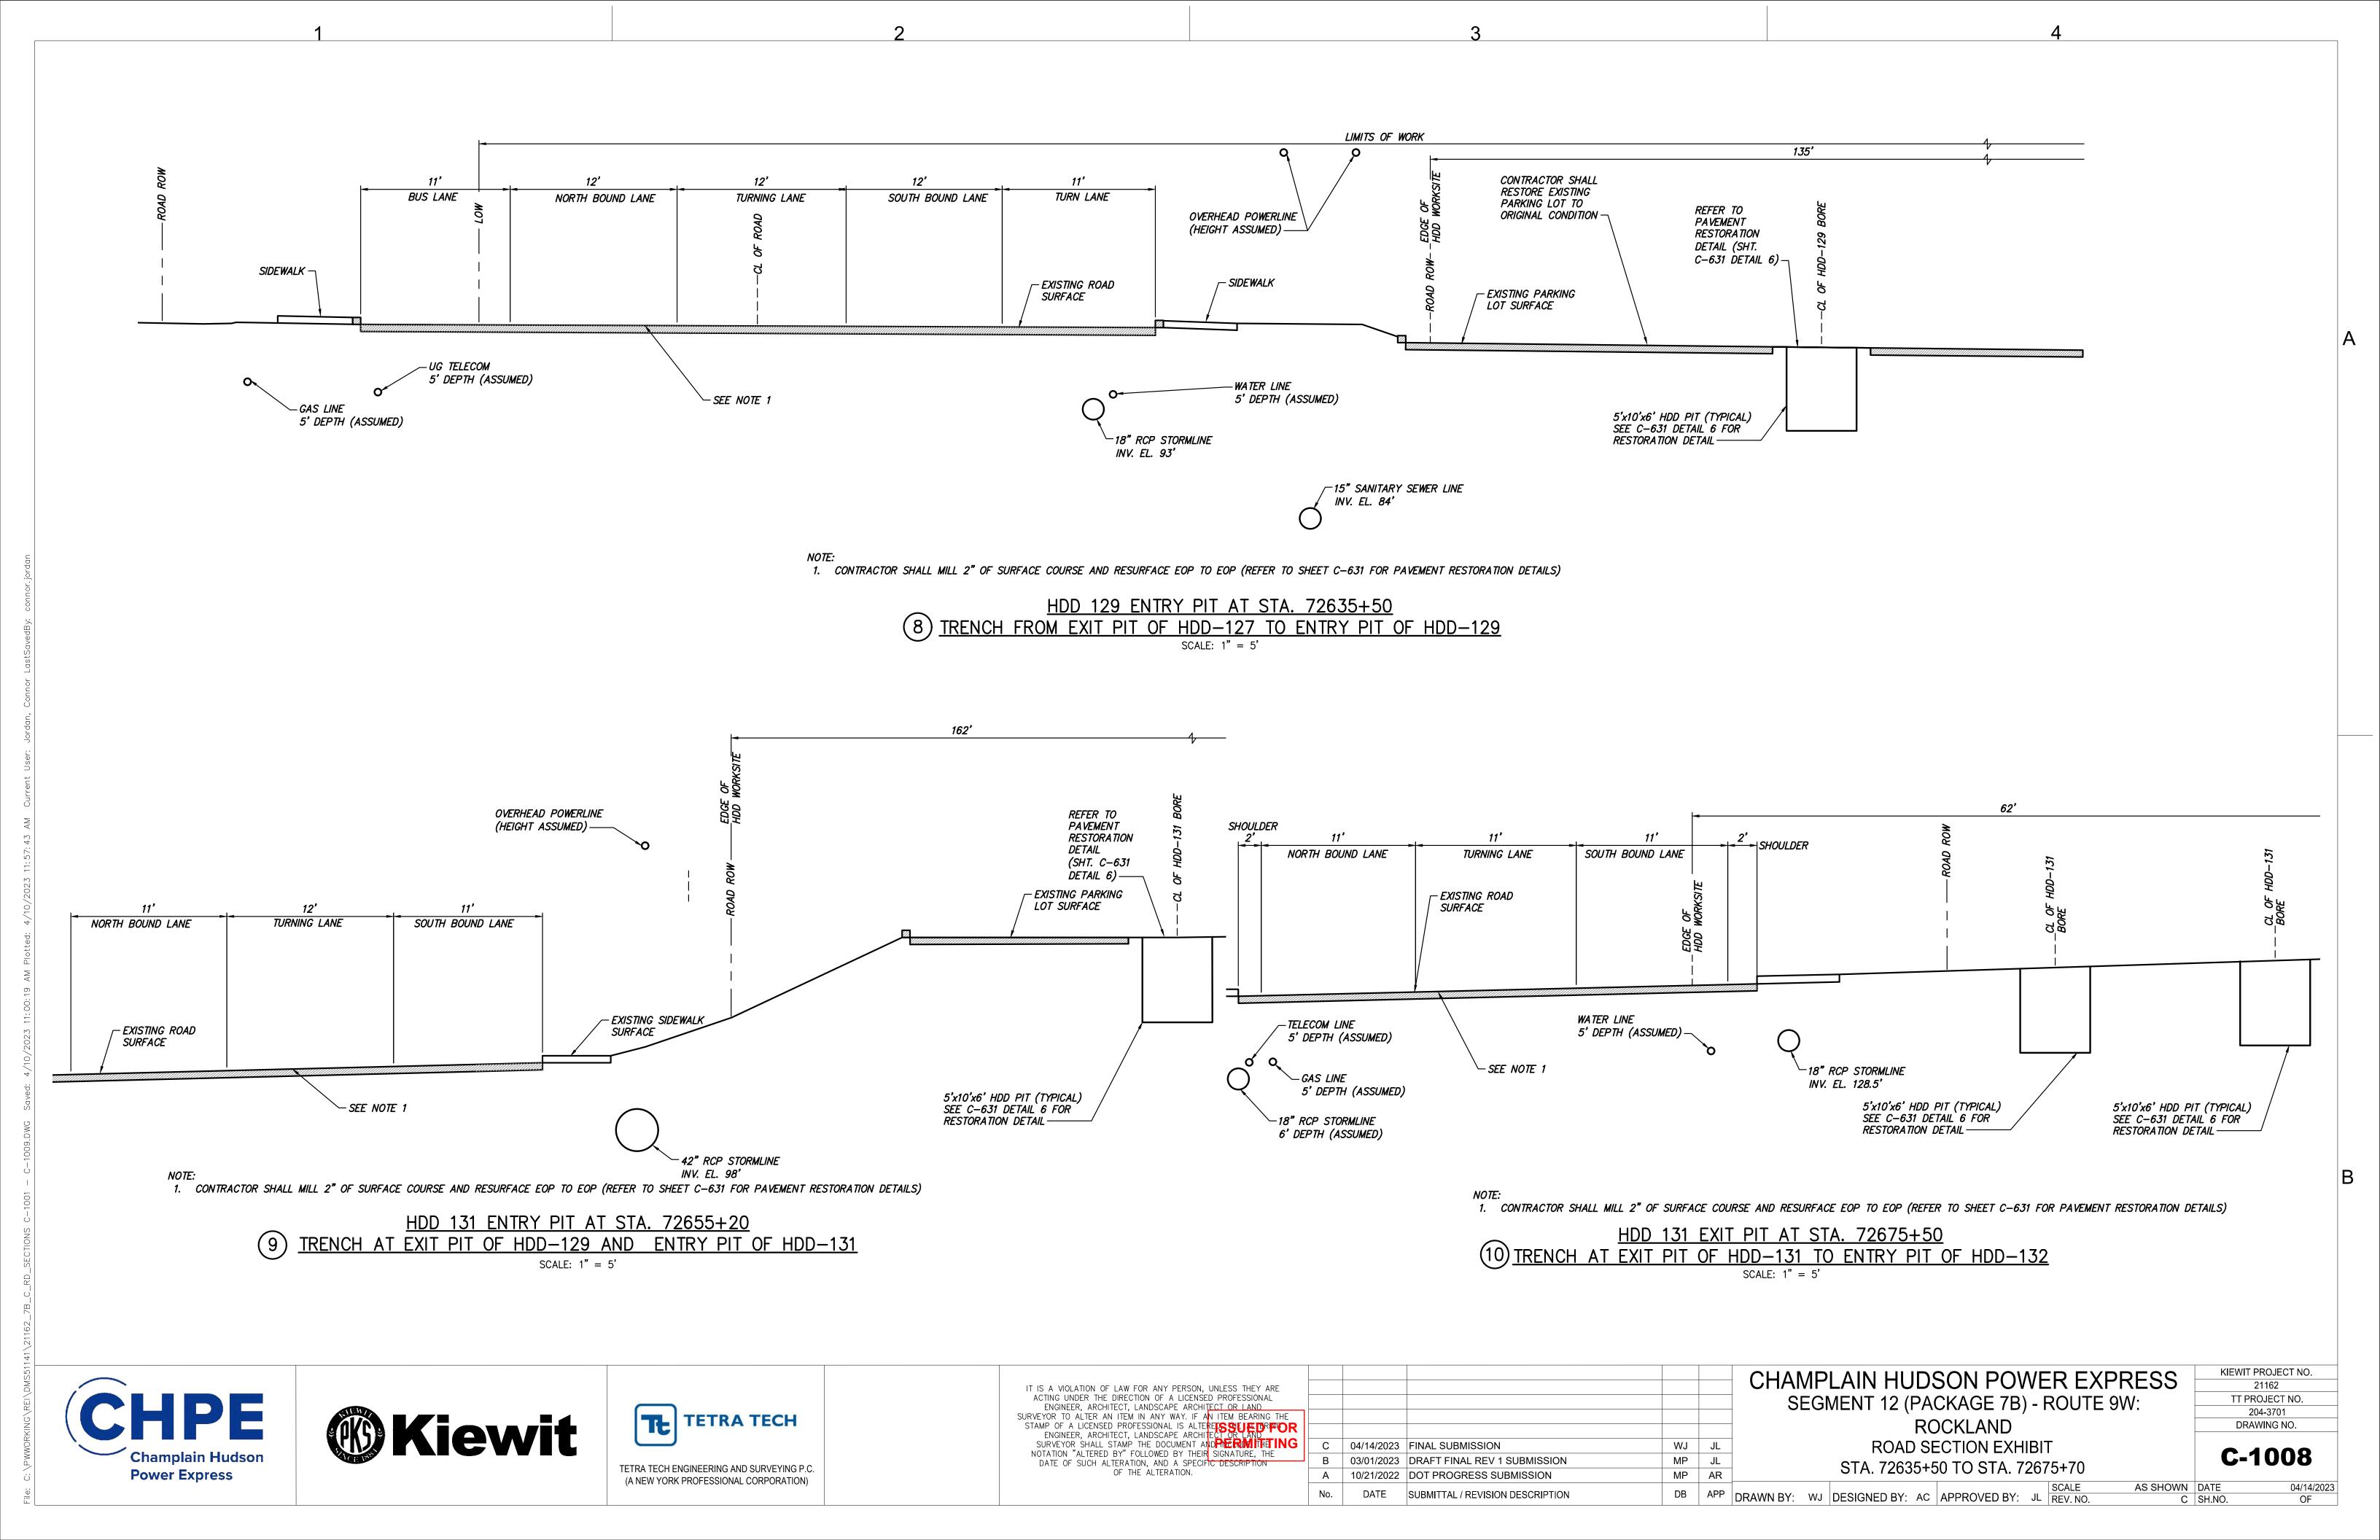
									SON POW CKAGE 7B)		
R							`		CKLAND		
G	С	04/14/2023	FINAL SUBMISSION	WJ	JL	ROAD SECTION EXHIBIT					-
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	Α	10/21/2022	DOT PROGRESS SUBMISSION	MP	AR		31A. 12098	7 T C	0 10 31A.12	O I	1+00
	No.	DATE	SUBMITTAL / REVISION DESCRIPTION	DB	APP	DRAWN BY: WJ	DESIGNED BY: A	4C	APPROVED BY:		SCALE REV. NO.


CHAMPLAIN HUDSON POWER EXPRESS
SEGMENT 12 (PACKAGE 7B) - ROUTE 9W:
ROCKLAND
ROAD SECTION EXHIBIT
STA. 72599+00 TO STA.72611+00


KIEWIT PROJECT NO.
21162
TT PROJECT NO.
204-3701
DRAWING NO.
C-1006

6-1000 AS SHOWN DATE 04/14/2023



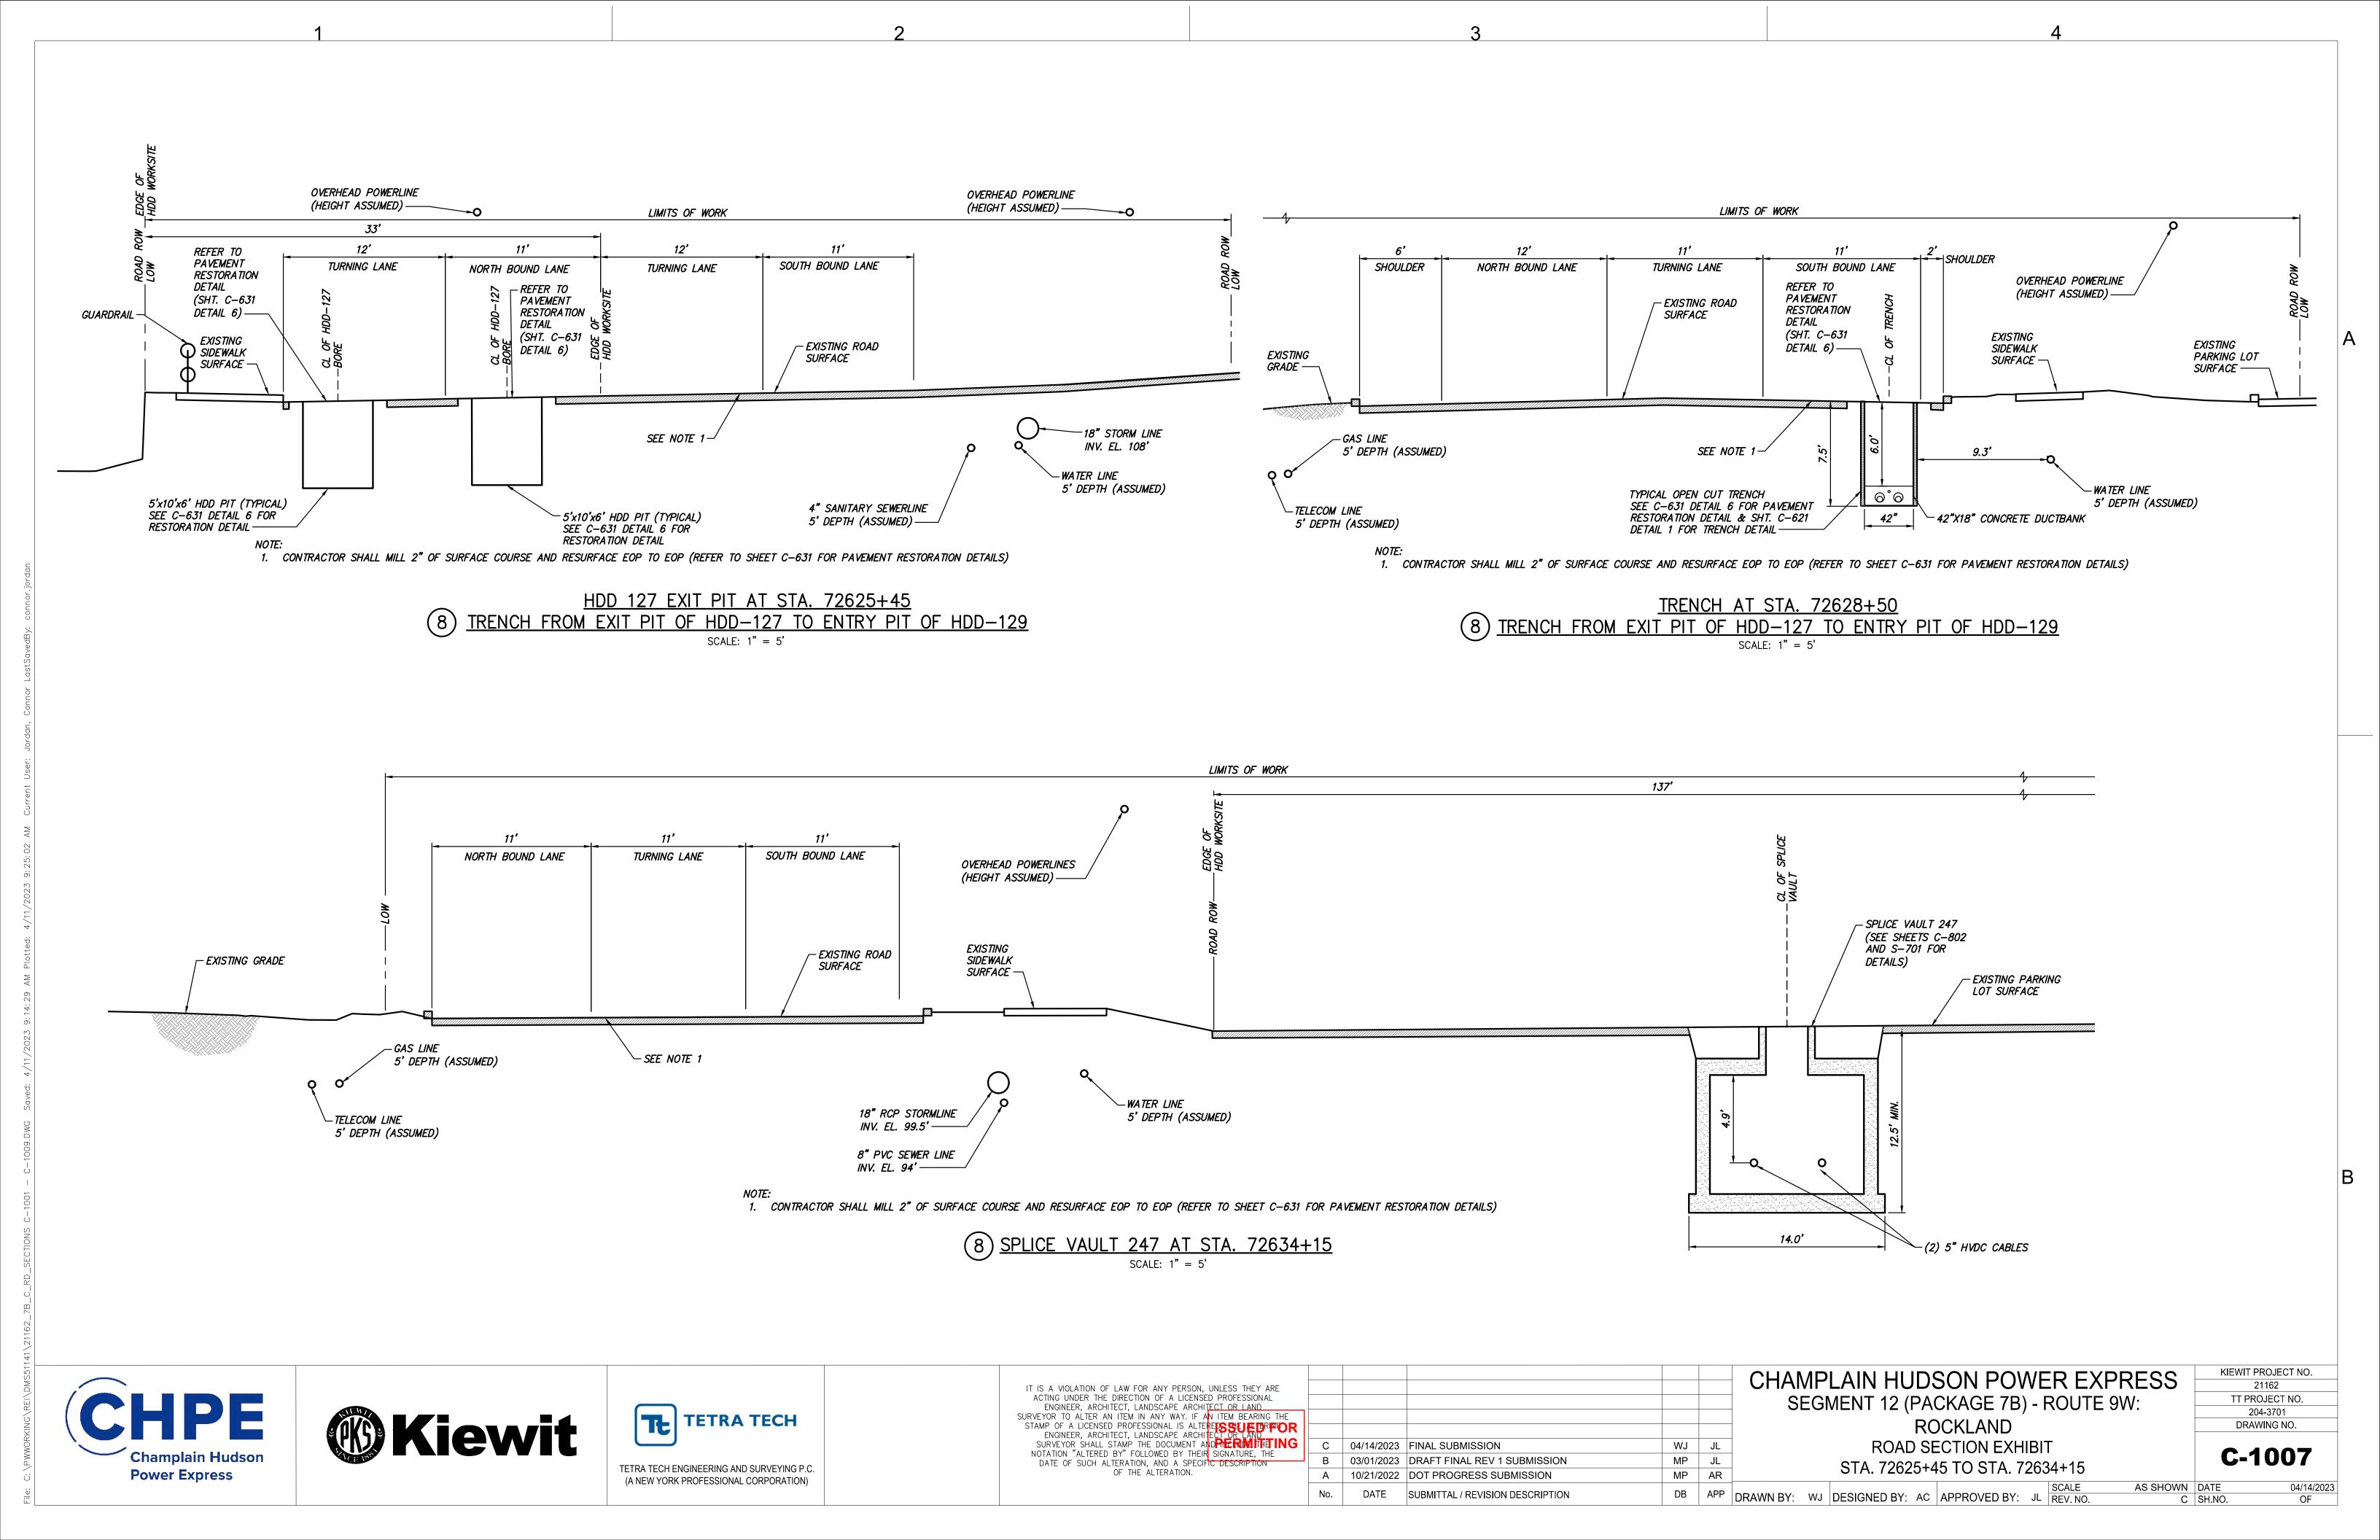

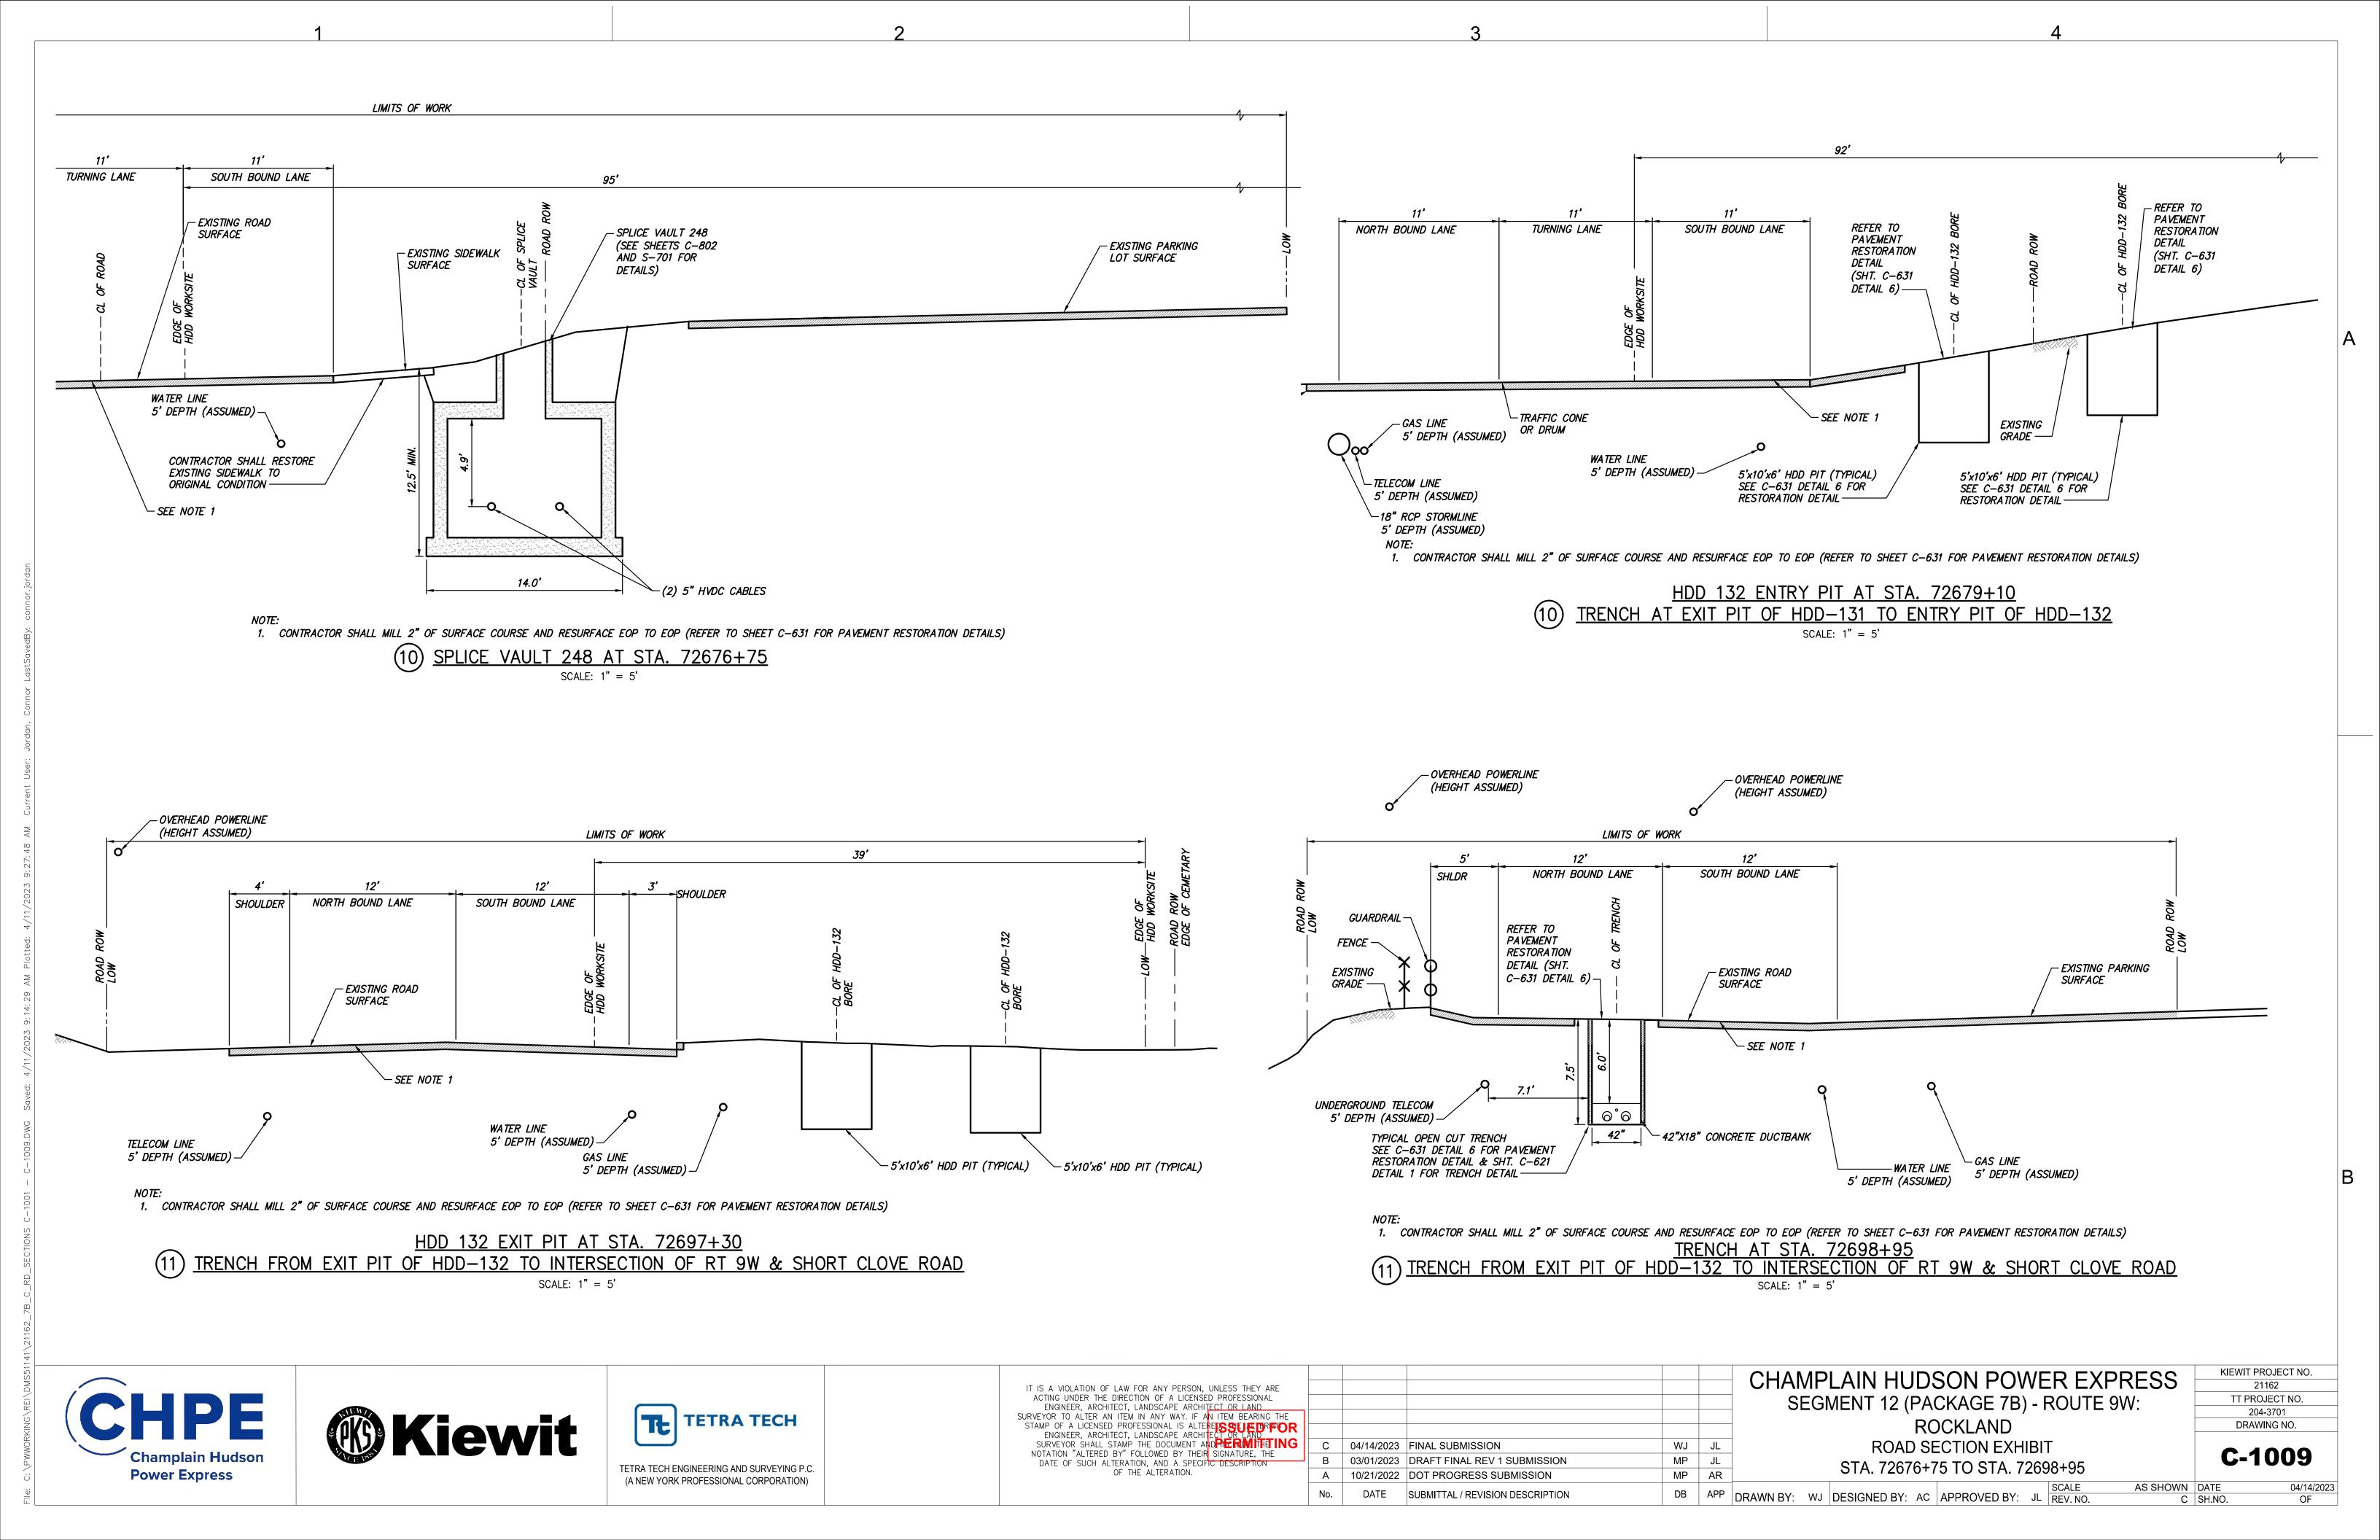

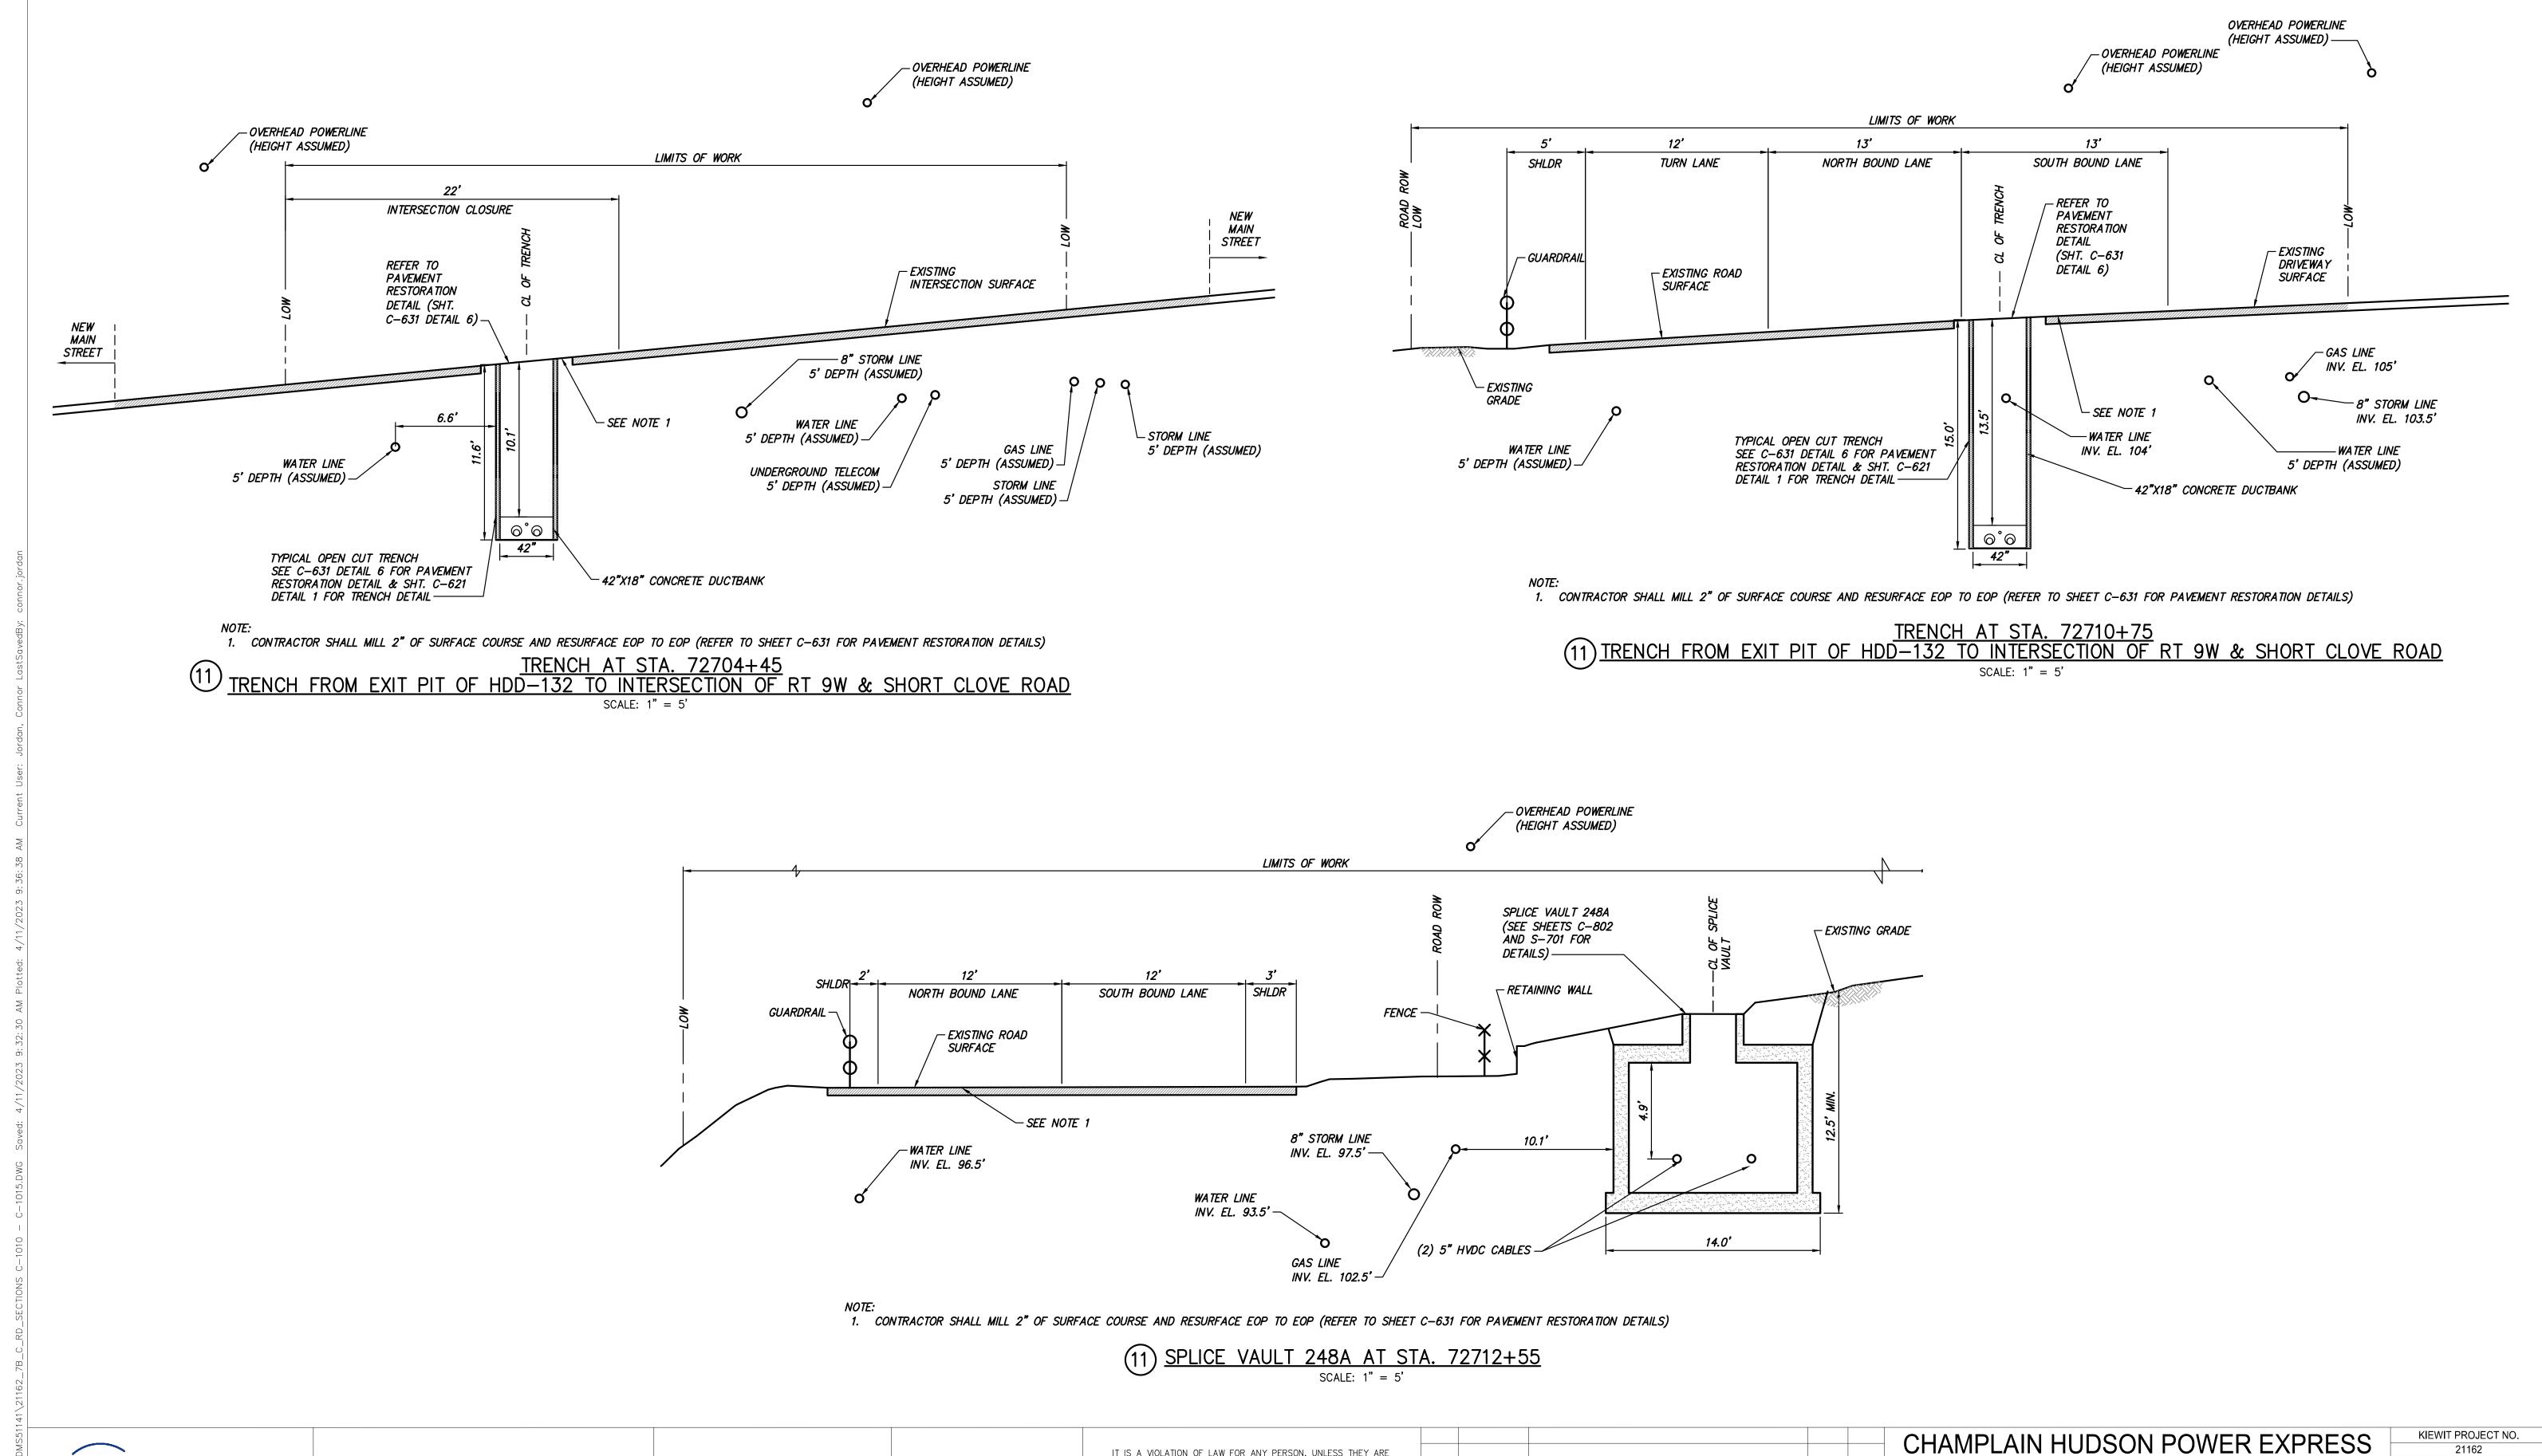

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Power Express





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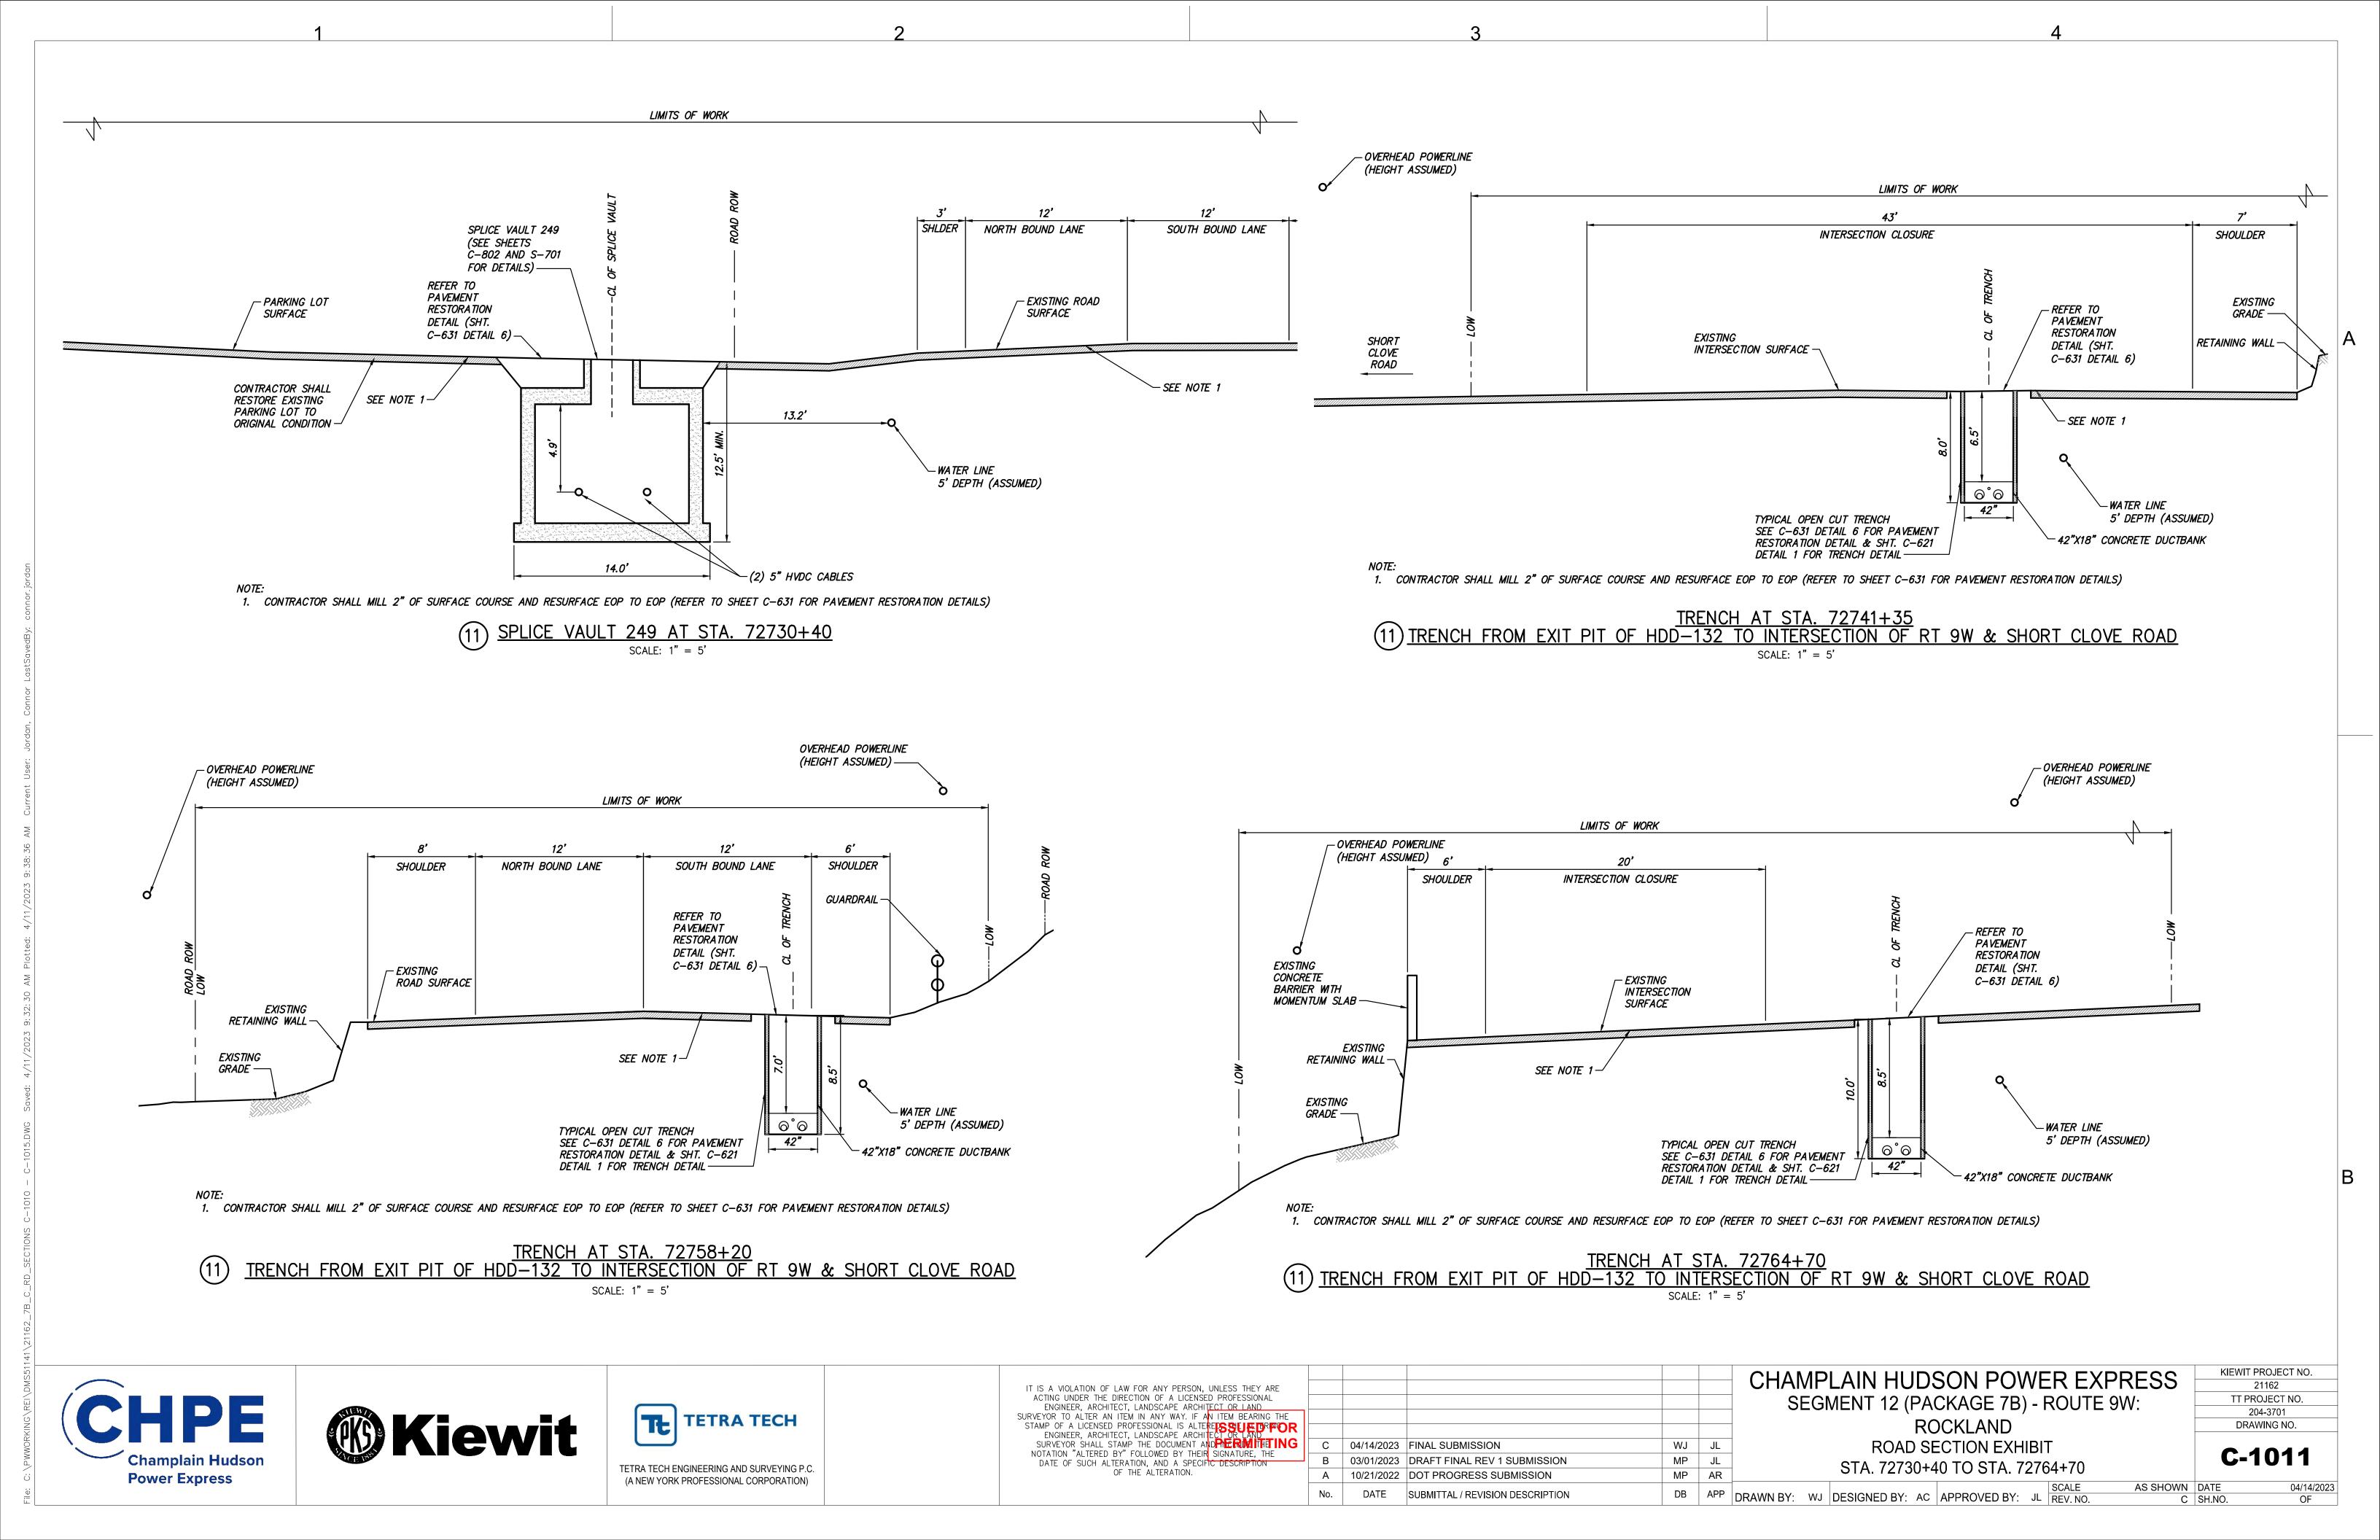
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3	С	04/14/2023	FINAL SUBMISSION	WJ	JL	
	В	03/01/2023	DRAFT FINAL REV 1 SUBMISSION	MP	JL	
	Α	10/21/2022	DOT PROGRESS SUBMISSION	MP	AR	
	No.	DATE	SUBMITTAL / REVISION DESCRIPTION	DB	APP	


AMPLAIN HUDSON POWER EXPRESS
SEGMENT 12 (PACKAGE 7B) - ROUTE 9W:
ROCKLAND
ROAD SECTION EXHIBIT
STA. 72704+45 TO STA. 72712+55


KIEWIT PROJECT NO.
21162
TT PROJECT NO.
204-3701
DRAWING NO.

C-1010

DRAWN BY: WJ DESIGNED BY: AC APPROVED BY: JL SCALE AS SHOWN DATE 04/1



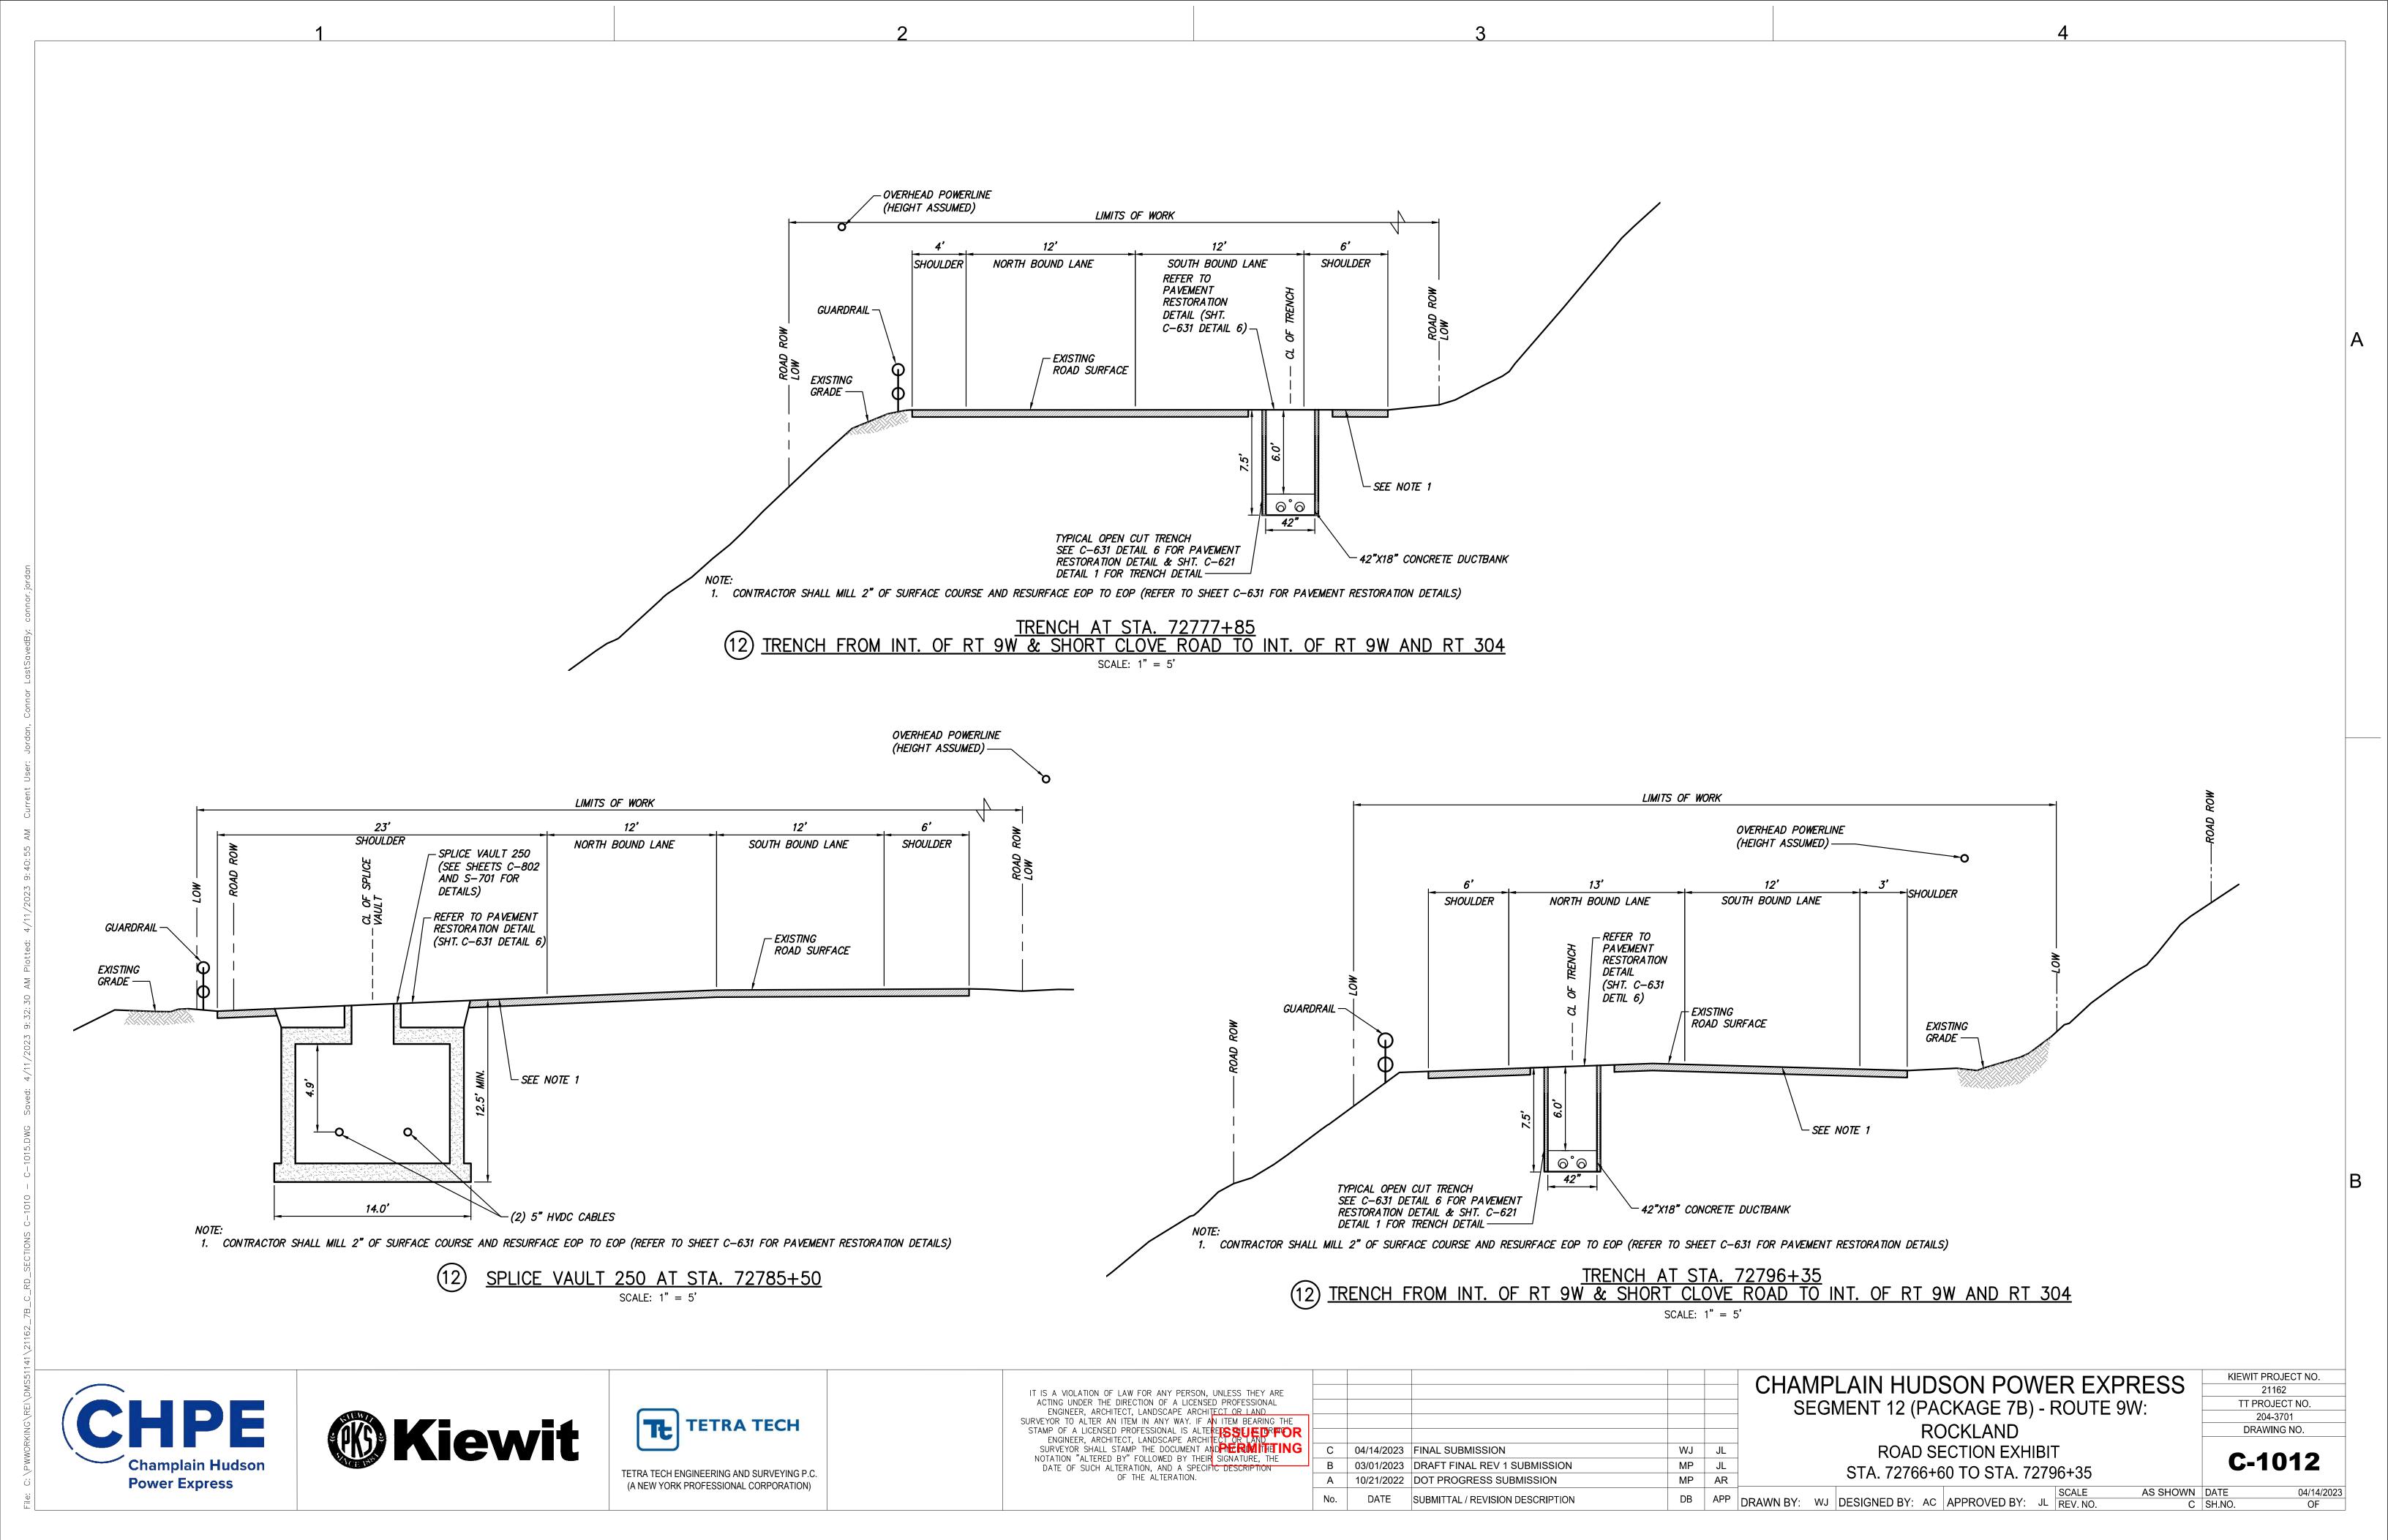

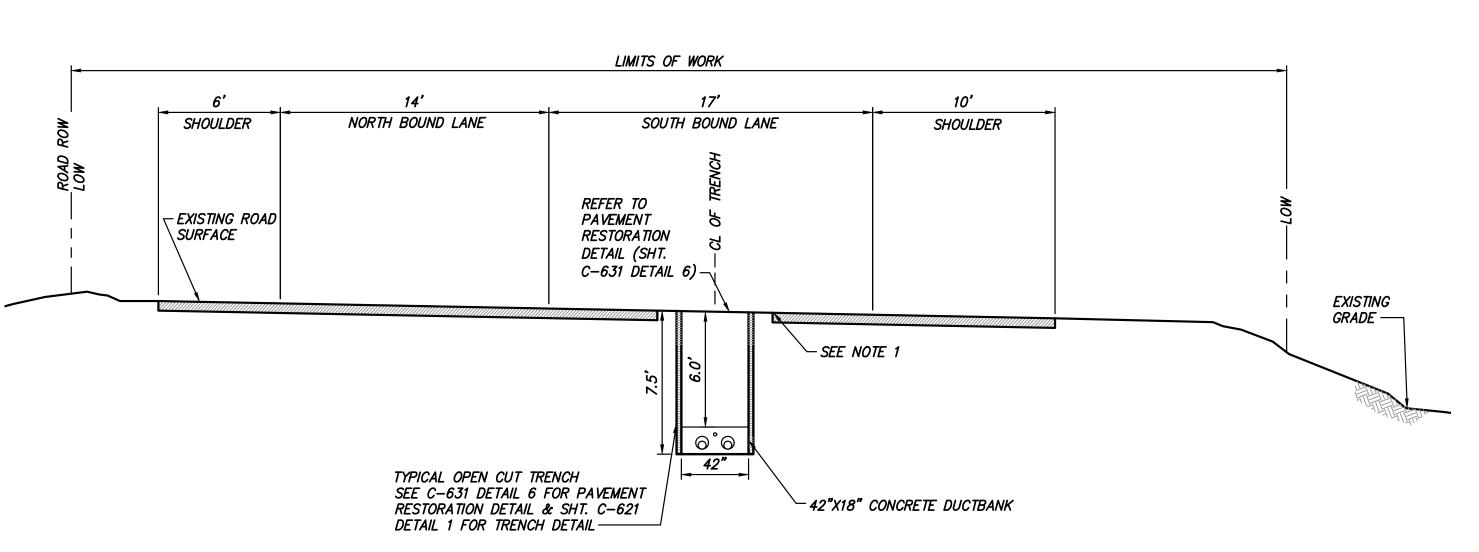

TRENCH AT STA. 72809+25

(12) TRENCH FROM INT. OF RT 9W & SHORT CLOVE ROAD TO INT. OF RT 9W AND RT 304


1. CONTRACTOR SHALL MILL 2" OF SURFACE COURSE AND RESURFACE EOP TO EOP (REFER TO SHEET C-631 FOR PAVEMENT RESTORATION DETAILS)

LIMITS OF WORK 6' 12'
SHOULDER NORTH BOUND LANE - REFER TO PAVEMENT RESTORATION __ EXISTING INTERSECTION SURFACE DETAIL (SHT. C-631 DETAIL 6) _ EXISTING GRADE - SEE NOTE 1 TYPICAL OPEN CUT TRENCH
SEE C-631 DETAIL 6 FOR PAVEMENT
RESTORATION DETAIL - 42"X18" CONCRETE DUCTBANK


1. CONTRACTOR SHALL MILL 2" OF SURFACE COURSE AND RESURFACE EOP TO EOP (REFER TO SHEET C-631 FOR PAVEMENT RESTORATION DETAILS)

TRENCH AT STA. 72815+75

12 TRENCH FROM INT. OF RT 9W & SHORT CLOVE ROAD TO INT. OF RT 9W AND RT 304

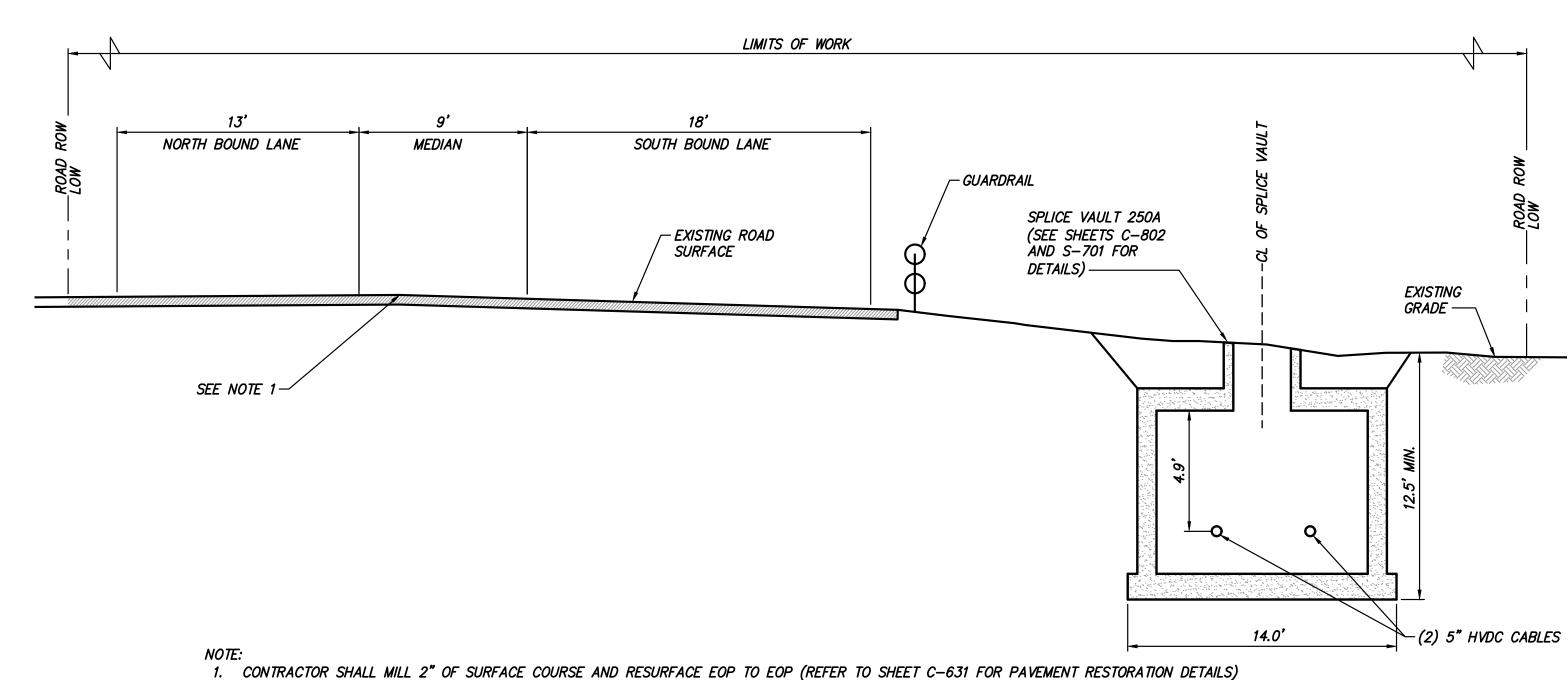

12) <u>SPLICE VAULT 250A AT STA. 72811+10</u>
SCALE: 1" = 5'

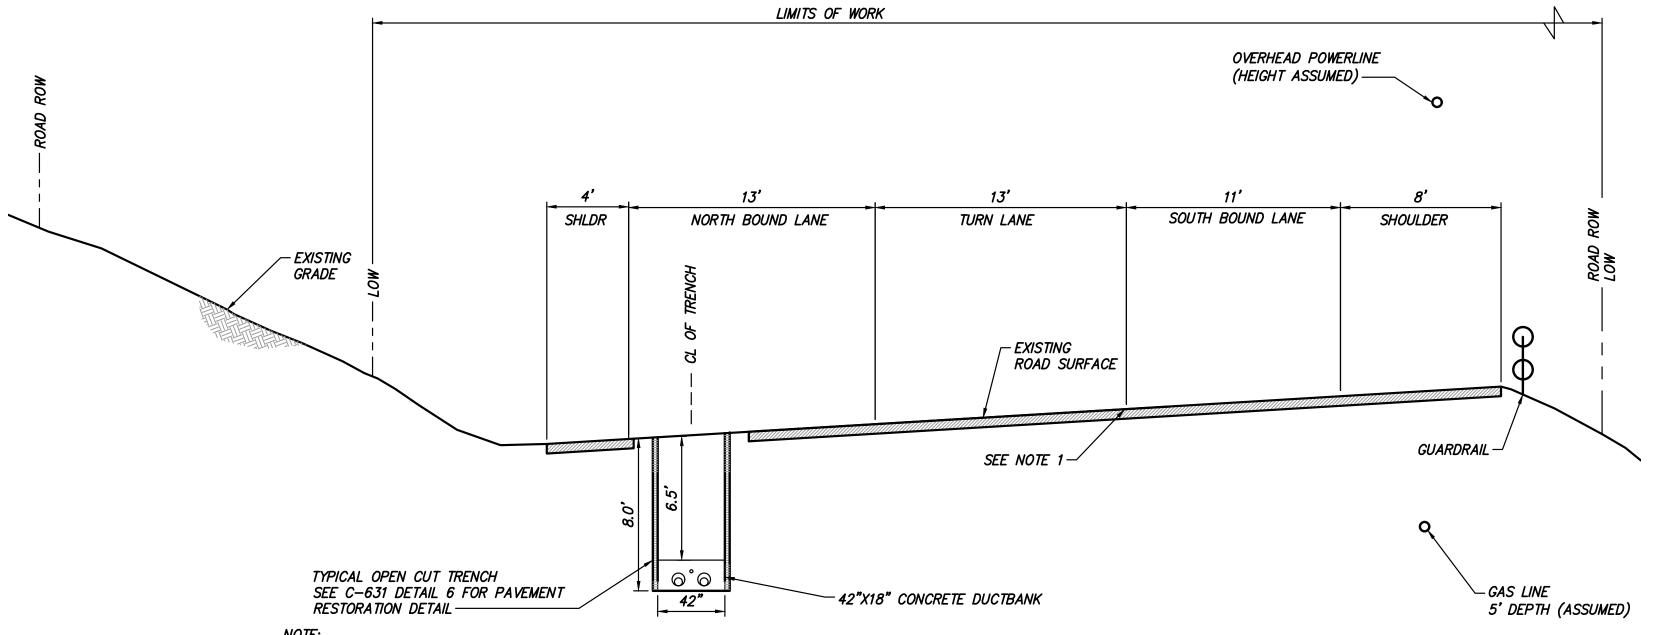

1. CONTRACTOR SHALL MILL 2" OF SURFACE COURSE AND RESURFACE EOP TO EOP (REFER TO SHEET C-631 FOR PAVEMENT RESTORATION DETAILS)

TRENCH AT STA. 72820+75

(13) TRENCH FROM INTERSECTION OF RT 9W AND RT 304 TO INTERSECTION WITH RT 303







(A NEW YORK PROFESSIONAL CORPORATION)


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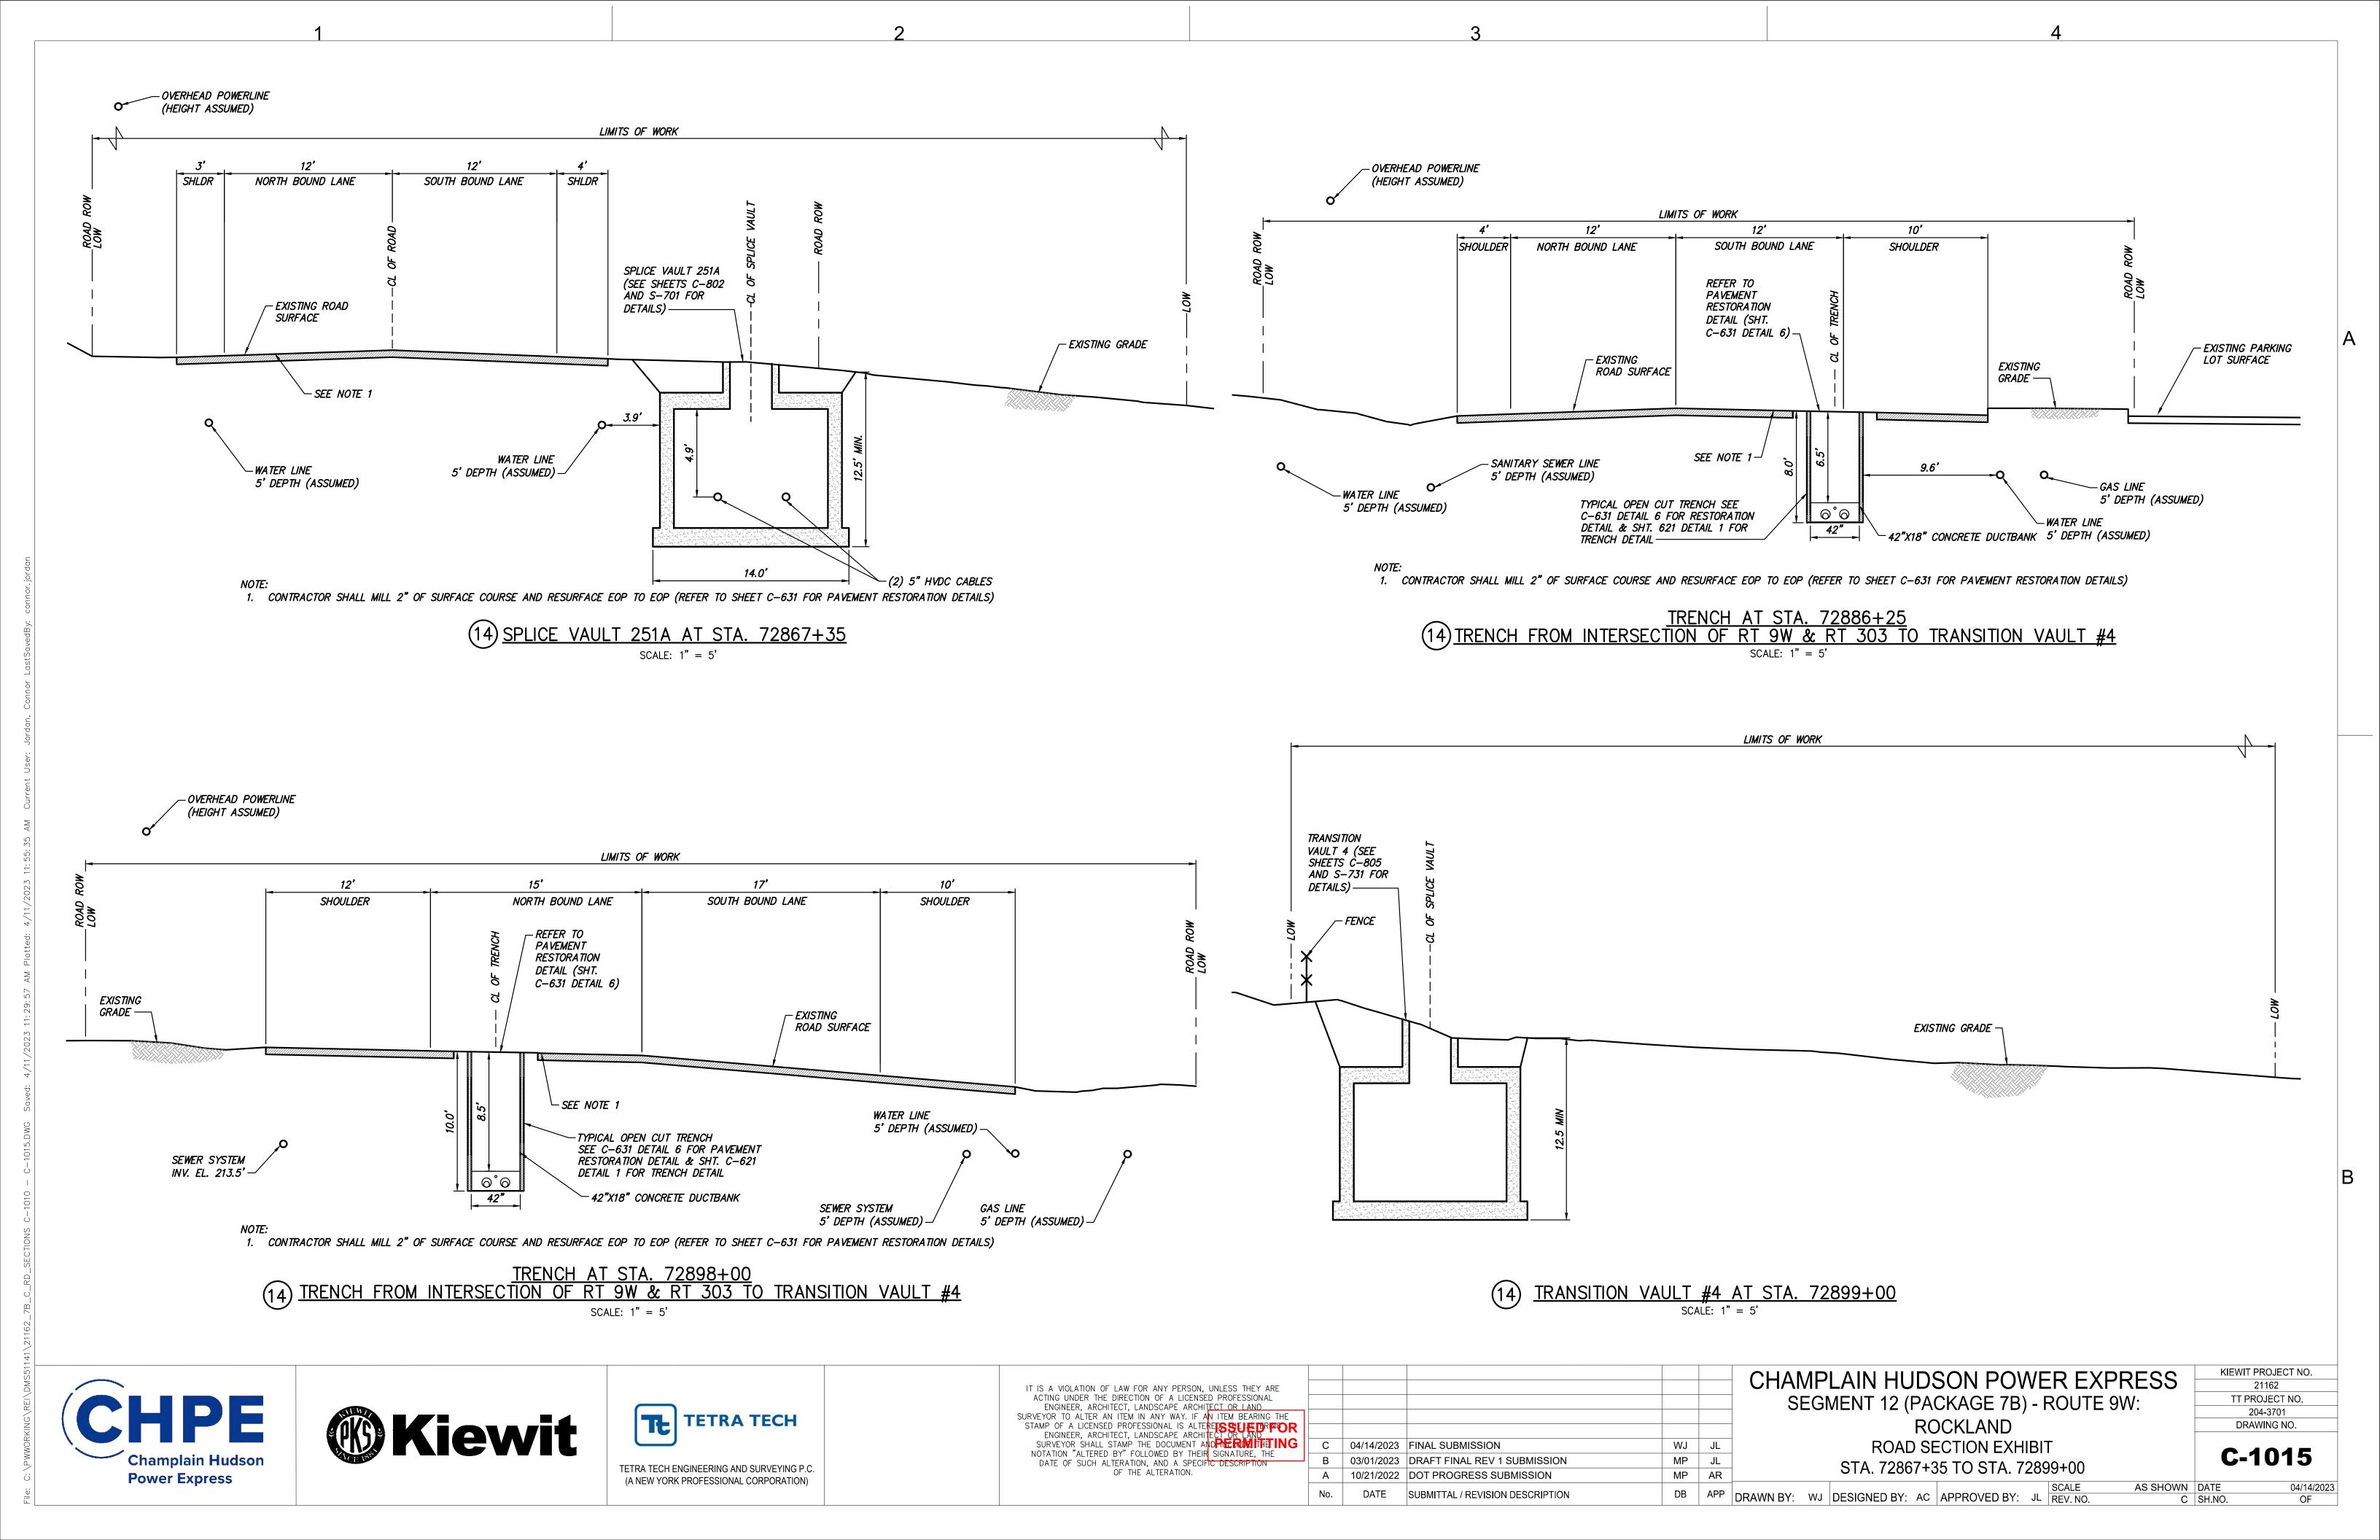
_						CHAMPLAIN HUDSON POWER EX SEGMENT 12 (PACKAGE 7B) - ROUTE
						ROCKLAND
	С	04/14/2023	FINAL SUBMISSION	WJ	JL	ROAD SECTION EXHIBIT
	В	03/01/2023	DRAFT FINAL REV 1 SUBMISSION	MP	JL	STA. 72809+25 TO STA. 72820+75
	Α	10/21/2022	DOT PROGRESS SUBMISSION	MP	AR	31A. 12009+25 TO STA. 12020+15
	No.	DATE	SUBMITTAL / REVISION DESCRIPTION	DB	APP	DRAWN BY: WJ DESIGNED BY: AC APPROVED BY: JL SCALE REV. NO.

CHAMPLAIN HUDSON POWER EXPRESS SEGMENT 12 (PACKAGE 7B) - ROUTE 9W: ROCKLAND **ROAD SECTION EXHIBIT** STA. 72809+25 TO STA. 72820+75

KIEWIT PROJECT NO. 21162 TT PROJECT NO. 204-3701 DRAWING NO.

C-1013 AS SHOWN DATE



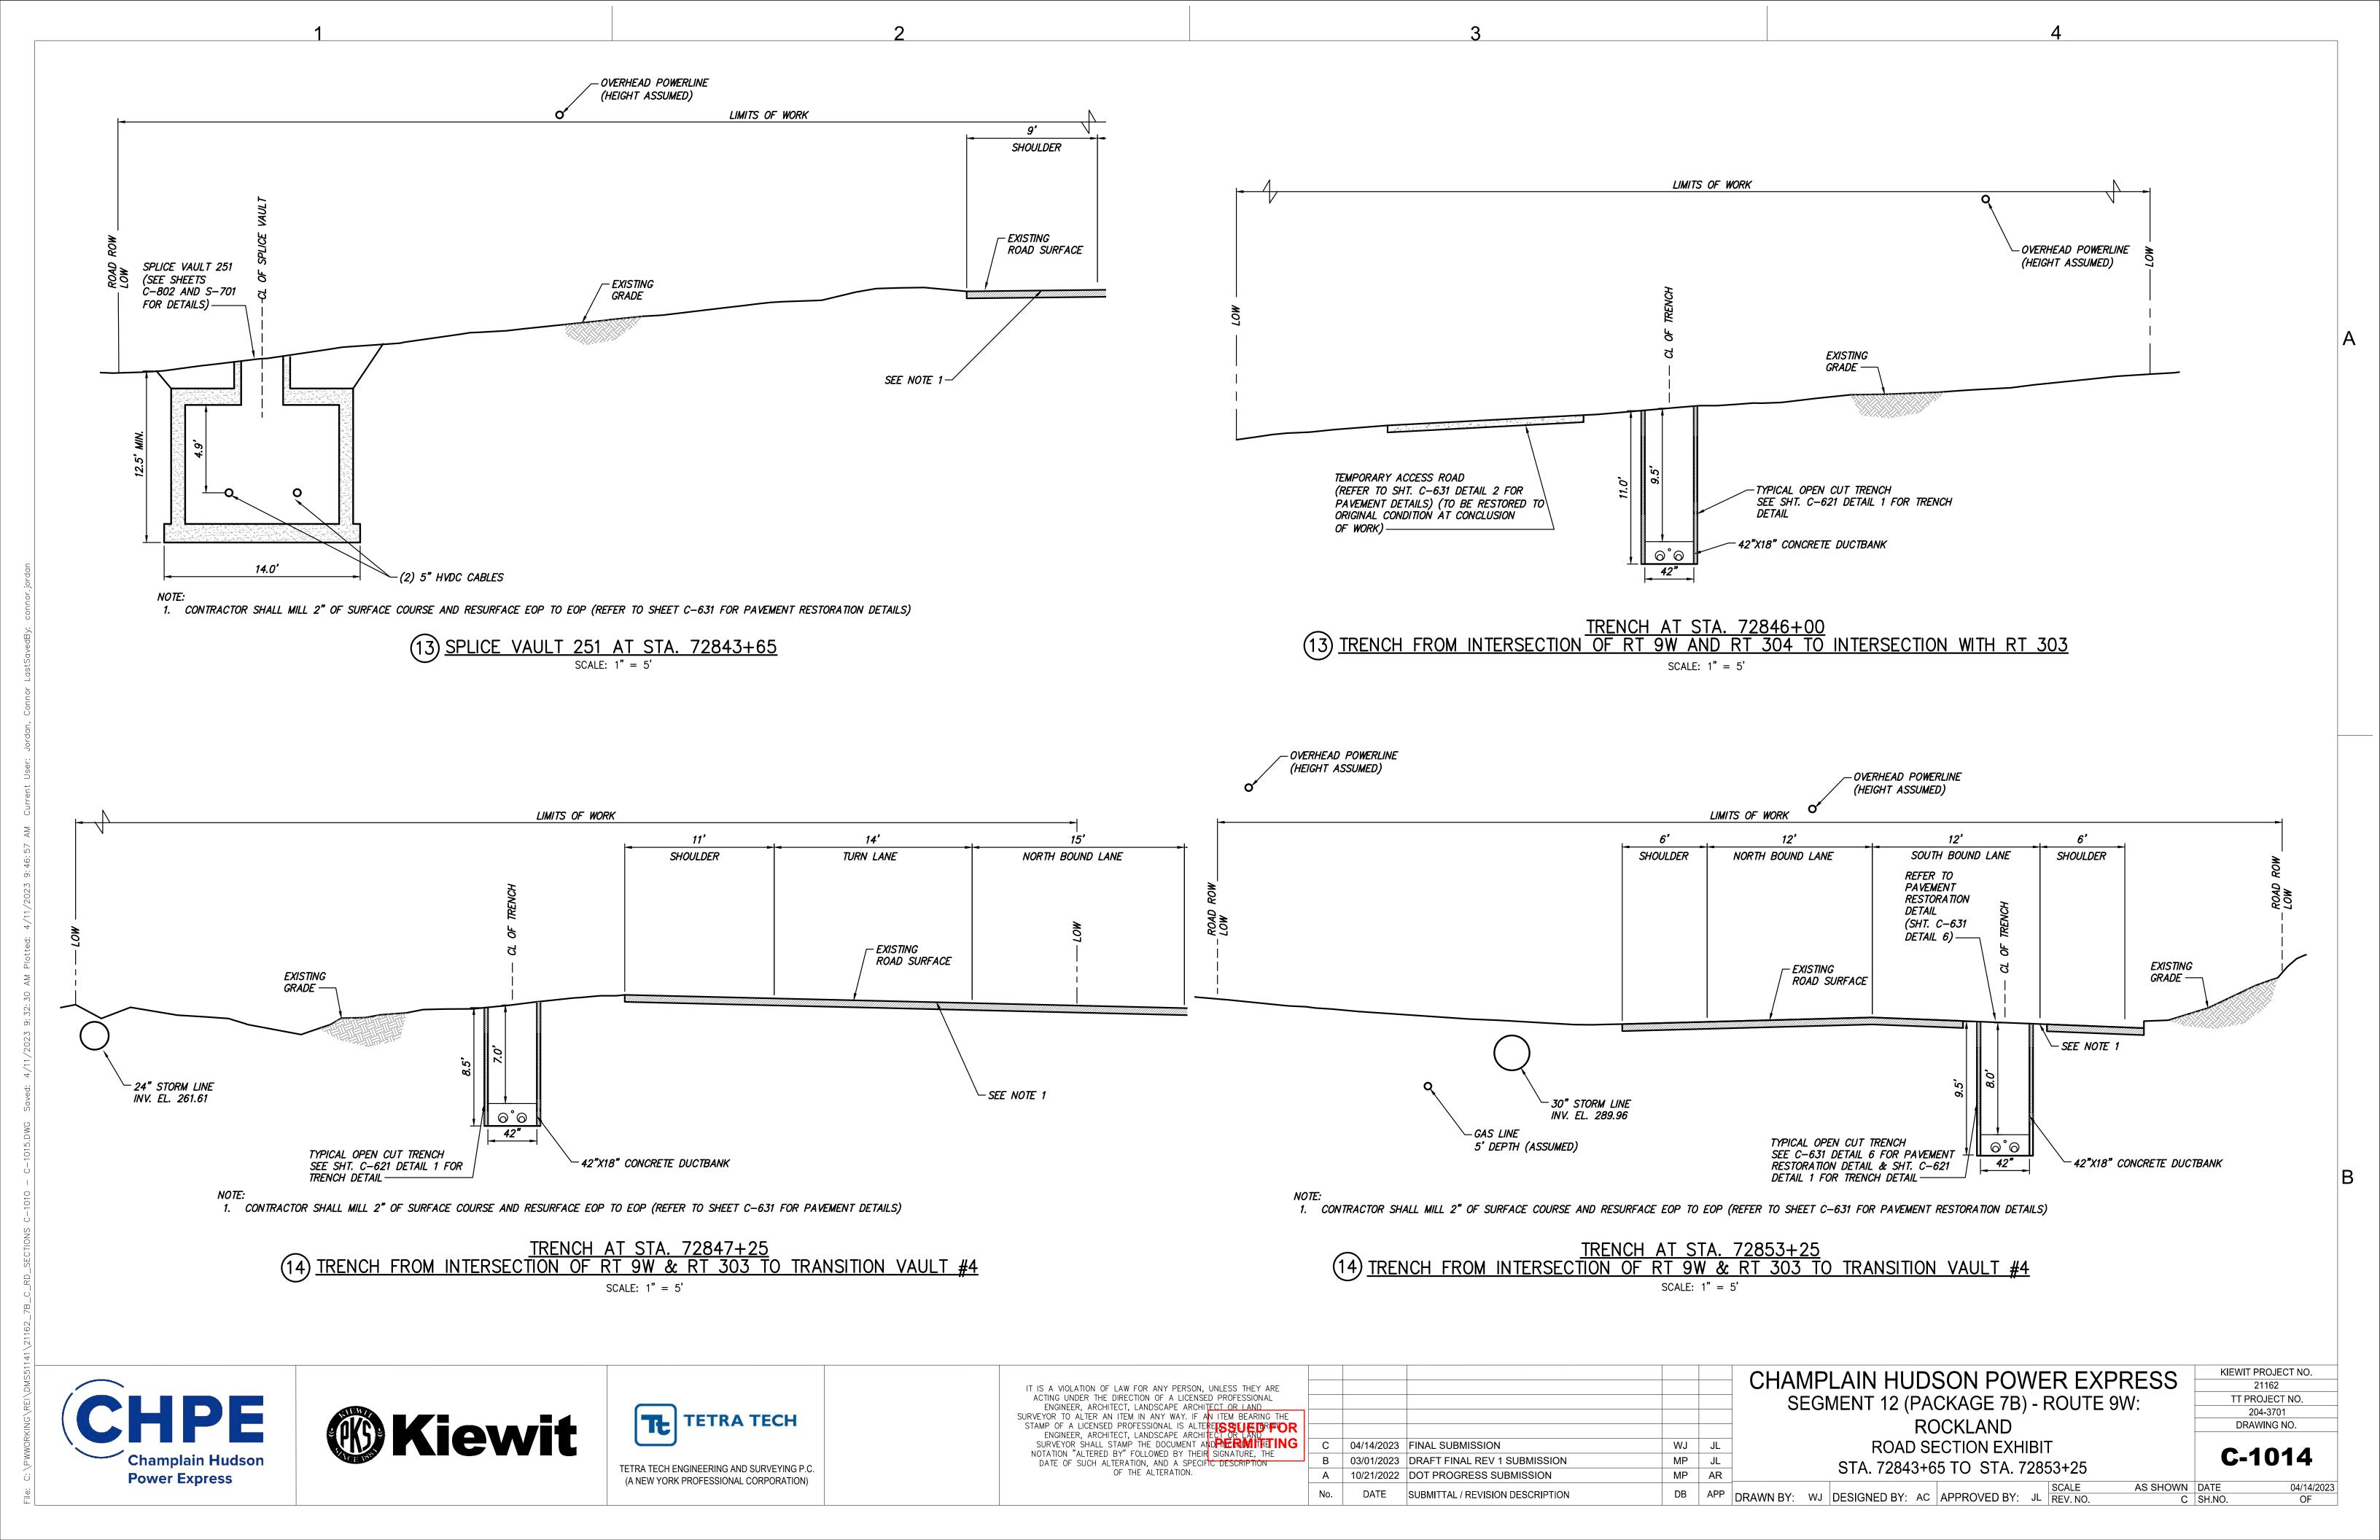

- B. PAYMENT FOR WORK ZONE TRAFFIC CONTROL WILL BE MADE IN ACCORDANCE WITH SECTION 109-05B AND 109-05C OF THE STANDARD SPECIFICATIONS. SECTIONS 619-4 AND 619-5 OF THE STANDARD SPECIFICATIONS DO NOT APPLY.
- C. THE CONTRACTOR MUST SUBMIT TO THE ENGINEER, IN WRITING, PROPOSED REVISIONS TO THE WORK ZONE TRAFFIC CONTROL PLAN FOR REVIEW AND APPROVAL BY THE REGIONAL DIRECTOR OR HIS/HER DESIGNEE A MINIMUM OF SEVEN (7) CALENDAR DAYS PRIOR TO THE PLANNED IMPLEMENTATION OF SUCH PRÓPOSED REVISIONS, EXCEPT FOR CHANGES THAT ALTER THE BASIC CONCEPT OR SCOPE OF THE WORK ZONE TRAFFIC CONTROL PLAN SUCH CHANGES TO THE BASIC CONCEPT OR SCOPE MUST BE SUBMITTED TO THE ENGINEER FOR APPROVAL BY THE REGIONAL DIRECTOR OR HIS/HER DESIGNEE A MINIMUM OF FORTY—FIVE (45) CALENDAR DAYS PRIOR TO IMPLEMENTATION OF SUCH REVISIONS.
- D. ALL MAINTENANCE AND PROTECTION OF TRAFFIC WORK SHALL CONFORM TO THE CONTRACT DRAWINGS. MAINTENANCE AND PROTECTION OF TRAFFIC SCHEMES SHOWN ON THE CONTRACT DRAWINGS SHALL NOT BE CHANGED BY THE CONTRACTOR WITHOUT THE WRITTEN PERMISSION OF THE ENGINEER
- E. THE TEMPORARY MAINTENANCE OF TRAFFIC AND WORK AREA PROTECTION DEVICE LOCATIONS SHOWN ON THE CONTRACT DRAWINGS ARE SCHEMATIC EXCEPT AS NOTED. LOCATION OF TRAFFIC CONTROL DEVICES MAY BE MODIFIED TO MEET FIELD CONDITIONS AS APPROVED BY THE ENGINEER.
- F. ALL CLOSURES SHALL BE COORDINATED WITH THE ENGINEER. A SCHEDULE OF WORK SHALL BE SUBMITTED AT LEAST TWO WEEKS IN ADVANCE FOR APPROVAL BY THE ENGINEER.
- G. THERE MAY BE ONGOING CONSTRUCTION CONTRACTS WITHIN THE VICINITY OF THE WORK AREA. DO NOT MOVE, MODIFY, OR RELOCATE ANY ITEM ASSOCIATED WITH THESE CONTRACTS WITHOUT PROPER APPROVAL OF AND COORDINATION WITH THE ENGINEER.
- H. PERFORM WORK IN SUCH A MANNER AND SEQUENCE AS TO INTERFERE AS LITTLE AS POSSIBLE WITH THE PASSAGE OF VEHICLES, PEDESTRIANS, AND OTHER KINDS OF PUBLIC TRAFFIC.
- CONTRACTOR SHALL TAKE CARE TO PREVENT DAMAGE TO EXISTING UTILITIES WITHIN THE LIMIT OF WORK. DAMAGED UTILITIES SHALL BE IMMEDIATELY REPAIRED BY CONTRACTOR AT THE CONTRACTOR'S EXPENSE. EXISTING AND PROPOSED UTILITIES ARE SHOWN FOR INFORMATION ONLY, SEE PNP SHEETS FOR ACCURATE INFORMATION.
- J. THE COST AND RESPONSIBILITY TO PROVIDE AND MAINTAIN SAFE AND ADEQUATE ACCESS FOR INTERSECTING ROADWAYS, HOMES, AND BUSINESSES, AT ALL TIMES, TO THE SATISFACTION OF THE ENGINEER, SHALL BE INCLUDED AS PER NYSDOT STANDARD PAY ITEM 619.01.
- K. ACCESS TO RESIDENTIAL AND COMMERCIAL DRIVEWAYS SHALL BE MAINTAINED AT ALL TIMES. UNLESS OTHER AGREEMENTS SUITABLE TO THE PROPERTY OWNERS CAN BE MADE, PROPERTY OWNERS WHOSE DRIVEWAYS WILL BE MADE INACCESSIBLE SHALL BE NOTIFIED BY THE CONTRACTOR AT LEAST 24 HOURS PRIOR TO RESTRICTING USE OF THE DRIVEWAY. THE CONTRACTOR SHALL MAINTAIN ACCESS TO COMMERCIAL DRIVEWAYS AT ALL TIMES WHEN A FACILITY IS IN USE. FOR MULTIPLE ACCESS PROPERTIES, ONLY ONE DRIVEWAY MAY BE CLOSED AT ANY ONE TIME. ACCESS SHALL BE RESTORED TO ALL DRIVEWAYS AS SOON AS POSSIBLE, OR AS DIRECTED Y THE ENGINEER. CONTRACTOR SHALL PLATE OVER OPEN TRENCHES AT THE END OF EACH SHIFT FOR THE ROADWAY TO BE USED FOR DAYTIME
- ACCESS FOR EMERGENCY VEHICLES SHALL BE MAINTAINED AT ALL TIMES. THE CONTRACTOR SHALL NOTIFY ALL AFFECTED EMERGENCY RESPONDERS AND TOWN/VILLAGE/CITY OFFICIAL AT LEAST FOURTEEN (14) DAYS IN ADVANCE OF ANY LANE/ROAD CLOSING.
- CONTRACTOR SHALL COORDINATE WITH LOCAL SCHOOLS AND FIRE DEPARTMENTS TO MAKE THEM AWARE OF ANY UPCOMING WORK, CLOSURES, AND DETOUR ROUTES.
- N. ALL TRAFFIC CONTROL AND WORK AREA PROTECTIONS DEVICES WITH NYSDOT ROADS SHALL BE FABRICATED AND INSTALLED IN ACCORDANCE WITH NYSDOT STANDARDS
- NYSDOT STANDARD SHEET REFERENCES 619-001, 619-002, 619-004, 619-010, 619-011, 619-012, 619-080, 619-090, 619-091, 619-201, 619-307, 619-308, 619-310, 619-323, 619-324, 619-407, 619-410, 619-414, 619-421, 619-422, 619-501. 619-502, 619-503, 619-504, 619-519, 619-520, 619-524
- P. CONTRACTOR SHALL SAFELY MANEUVER CONSTRUCTION EQUIPMENTS AND VEHICLES IN AND AROUND THE WORK AREA AS APPLICABLE PER NYSDOT
- Q. ALL TEMPORARY TRAFFIC CONTROL AND WORK AREA PROTECTION DEVICES SHALL BE FURNISHED AND INSTALLED BY THE CONTRACTOR UNLESS OTHERWISE NOTED ON THE CONTRACT DRAWINGS AND APPROVED BY THE ENGINEER PRIOR TO COMMENCING WORK
- R. CONSTRUCTION SPEED LIMIT SHALL BE DETERMINED USING EXHIBIT 16-9 IN CHAPTER 16 OF THE NYSDOT HIGHWAY DESIGN MANUAL.
- S. CONTRACTOR MAY PERFORM OPEN CUT TRENCHING DURING LANE CLOSURES OF HDD WORK. CONTRACTOR SHALL LIMIT WORK TO NIGHT TIME OPERATIONS WHEN IN THE VICINITY OF BUSINESS AREAS, AND DAY TIME WORK WHEN IN THE VICINITY OF RESIDENTIAL AREAS.
- T. CONTRACTOR SHALL COORDINATE WITH BUS COMPANIES TO MAINTAIN EXISTING BUS STOPS.
- U. ON DETOUR ROUTES CONTRACTOR SHALL TAKE PHOTOGRAPHS TO DOCUMENT THE EXISTING CONDITION OF THE ROADS. IF AFTER COMPLETION OF THE PROJECT, THE DETOUR ROADS ARE DEEMED TO HAVE SIGNIFICANT DETERIORATION, BY THE ENGINEER, CONTRACTOR SHALL MILL AND OVERLAY THE AFFECTED ROADWAYS.

2. WORK ZONE REQUIREMENTS

- A. TRAFFIC LANES AND OTHER AREAS CLOSED BY THE CONTRACTOR DURING PERMITTED WORK HOURS SHALL BE CLEARED OF ALL MATERIAL, EQUIPMENT, AND DEBRIS, AND SAFELY REOPENED TO TRAFFIC BY THE END OF THE WORK PERIOD UNLESS OTHERWISE INDICATED ON THE CONTRACT
- B. CONTRACTOR SHALL PLATE OVER OPEN TRENCHES AT THE END OF EACH SHIFT FOR THE ROADWAY TO BE USED DURING NON-CONSTRUCTION
- C. IF THE CONTRACTOR REQUIRES A LANE CLOSURE TO PERFORM OPERATIONS, THEY MAY DO SO WITH THE APPROVAL OF THE ENGINEER. ANY LANE CLOSURES WILL BE IN ACCORDANCE WITH NYS STANDARD SHEETS UNLESS OTHERWISE SHOWN IN CONTRACT PLANS.
- D. NO WORK ACTIVITY OR STORAGE OF EQUIPMENT, VEHICLES, OR MATERIAL SHOULD OCCUR WITHIN A BUFFER SPACE.
- E. EXISTING STRIPING THAT CONFLICTS WITH PROPOSED WORKZONE TRAFFIC LOW SHALL BE REMOVED AND TEMPORARY STRIPING SHALL BE PUT IN PLACE IN ORDER TO FACILITATE WORK ZONE TRAFFIC FLOW.

3. TIME / DATE RESTRICTIONS

- A. THE CONTRACTOR'S ATTENTION IS DIRECTED TO THE FACT THAT THE FOLLOWING HOLIDAY WORK RESTRICTIONS ARE APPLICABLE TO THIS PROJECT. DURING THESE HOLIDAY PERIODS, THE CONTRACTOR WILL NOT BE ALLOWED TO PERFORM ANY WORK THAT WILL BE DISRUPTIVE TO TRAFFIC, INCLUDING BUT NOT LIMITED TO LANE CLOSURE AND DETOURS. LANE CLOSURES AND DETOURS WILL NOT BE PERMITTED DURING THE FOLLOWING STATE RECOGNIZED HOLIDAYS:
 - NEW YEAR'S DAY SUNDAY, JANUARY 1, 2023 MEMORIAL DAY LABOR DAY

CHRISTMAS DAY

- MONDAY, MAY 29, 2023 INDEPENDENCE DAY - TUESDAY, JULY 4, 2023 - MONDAY, SEPTEMBER 4, 2023 THANKSGIVING DAY - THURSDAY, NOVEMBER 23, 2023
- MONDAY, DECEMBER 25, 2023) NEW YEAR'S DAY - MONDAY, JANUARY 1, 2024 MEMORIAL DAY - MONDAY, MAY 27, 2024 10) LABOR DAY
- INDEPENDENCE DAY THURSDAY, JULY 4, 2024 MONDAY, SEPTEMBÉR 2. 2024) THANKSGIVING DAY - THURSDAY, NOVEMBER 28, 2024 12) CHRISTMAS DAY WEDNESDAY, DECEMBER 25, 2024
- 13) NEW YEAR'S DAY WEDNESDAY, JANUARY 1, 2025 14) MEMORIAL DAY 15) INDEPENDENCE DAY — FRIDAY, JULY 4, 2025 16) LABOR DAY
- MONDAY, MAY 26, 2025 - MONDAY, SEPTEMBER 1, 2025 ') THANKSGIVING DAY — THURSDAY, NOVEMBER 27, 2025 18) CHRISTMAS DAY - THURSDAY, DECEMBER 25, 2025
- B. LANE CLOSURES AND DETOURS SHALL BE SUSPENDED AS FOLLOWS:
- BEGINNING 6AM, FRIDAY DECEMBER 30, 2022 AND ENDING 10AM, TUESDAY JANUARY 3, 2023
- BEGINNING 6AM, FRIDAY MAY 26, 2023 AND ENDING 10AM, TUESDAY MAY 30 2023 - BEGINNING 6AM, FRIDAY JUEN 10, 2023 AND ENDING 10AM,
- WEDNESDAY JULY 5, 2023 BEGINNING 6AM, FRIDAY SEPTEMBER 1, 2023 AND ENDING 10AM, TUESDAY SEPTEMBER 5, 2023
- BEGINNING 6AM, WEDNESDAY NOVEMBER 22, 2023 AND ENDING 10AM, MONDAY NOVEMBER 27, 2023 BEGINNING 6AM, FRIDAY DECEMBER 22, 2023 AND ENDING 10AM, TUESDAY DECEMBER 26, 2023
- BEGINNING 6AM, FRIDAY DECEMBER 29, 2023 AND ENDING 10AM, TUESDAY JANUARY 2, 2024
- BEGINNING 6AM, FRIDAY MAY 24, 2024 AND ENDING 10AM, TUESDAY MAY 28, 2024 BEGINNING 6AM, THURSDAY JULY 4, 2024 AND ENDING 10AM
- BEGINNING 6AM, FRIDAY AUGUST 30, 2024 AND ENDING 10AM, TUESDAY SEPTEMBER 3, 2024 BEGINNING 6AM, WEDNESDAY NOVEMBER 27, 2024 AND ENDING 10AM, MONDAY DECEMBER 2, 2024
- BEGINNING 6AM, SATURDAY DECEMBER 22, 2024 AND ENDING 10AM, THURSDAY DECEMBER 26, 2024
- BEGINNING 6AM, SUNDAY DECEMBER 29, 2024 AND ENDING 10AM, THURSDAY JANUARY 2, 2025 BEGINNING 6AM, FRIDAY MAY 23, 2025 AND ENDING 10AM,
- TUESDAY MAY 27, 2025 BEGINNING 6AM, FRIDAY JULY 4, 2025 AND ENDING 10AM, TUESDAY JULY 8, 2025 BEGINNING 6AM, FRIDAY AUGUST 29, 2025 AND ENDING 10AM,
- TUESDAY SEPTEMBER 2, 2025 BEGINNING 6AM, WEDNESDAY NOVEMBER 26, 2025 AND ENDING 10AM MONDAY DECEMBER 1 2029

BEGINNING 6AM, MONDAY DECEMBER 22, 2025 AND ENDING 10AM,

C. DURING WINTER STORM EVENTS, NO WORK WITHIN THE WORK AREA OR RIGHT-OF-WAY IS PERMITTED TO ALLOW FOR SNOW REMOVAL, PLOWING ACTIVITIES

FRIDAY DECEMBER 26, 2025

- D. ANY EARTHWORK DONE BETWEEN NOVEMBER 1ST AND APRIL 1ST MUST CONFORM TO NYSDOT STANDARD SPECIFICATION SECTION 203-1.01 P.
- E. DURING WINTER MORATORIUM, COVER EXCAVATION WITH TEMPORARY ASPHALT AND OPEN ALL LANES TO TRAFFIC.
- WHEN PERFORMING DAYTIME WORK ON ROUTE 9W (KEY CORRIDOR), LANE CLOSURES SHALL BE LIMITED TO HOURS OF 9:00 AM TO 3:30 PM, UNLESS OTHERWISE COORDINATED WITH NYSDOT.

- 4. CONSTRUCTION VEHICLES, EQUIPMENT AND MATERIALS
- A. IF CONDITION WARRANTS, PROTECTIVE VEHICLE WITH APPROPRIATE ROLL AHEAD DISTANCE MAY BE USED IN ADVANCE OF THE WORK AREA. TO USE PROTECTIVE VEHICLE, BUFFER SPACE SHALL BE PROVIDED ACCORDINGLY, AND THE WHEELS SHALL BE ALIGNED WITH THE LANE STRIPING.
- B. ALL VEHICLES AND EQUIPMENT WITHIN THE CONTRACT LIMITS AND ON TRAVEL LANES AND/OR SHOULDERS SHALL BE EQUIPPED WITH AND SHALL OPERATE A MINIMUM OF ONE AMBER ROTATING OR FLASHING LIGHT EMITTING DIODE (LED) BEACON VISIBLE FROM ALL DIRECTIONS FOR A MINIMUM OF 1000 FEÉT DURING DAYLIGHT. IF VISIBILITY OF A SINGLE BEACON IS BLOCKED BY A PORTION OF THE VEHICLE OR EQUIPMENT ADDITIONAL BEACONS SHALL BE PROVIDED. BEACONS SHALL BE MOUNTED IN A MANNER WHICH DOES NOT CAUSE GLARE FOR DRIVERS USING THE ROADWAY OR THE OPERATOR OF THE VEHICLE OR EQUIPMENT.
- C. ALL BARRIER/SHADOW VEHICLES SHALL WEIGH A MINIMUM OF 24,000 LB AND SHALL BE EQUIPPED WITH TRUCK-MOUNTED IMPACT ATTENUATORS AND TRUCK-MOUNTED ARROW PANELS. IMPACT ATTENUATORS SHALL MEET THE REQUIREMENTS OF NCHRP 350 TEST LEVEL 3 AND SECTION 729-12 OF THE STANDARD SPECIFICATIONS. ARROW PANELS SHALL B TRUCK-MOUNTED SERIES B OR C PANELS MEETING THE REQUIREMENTS OF SECTION 729-15 OF THE STANDARD SPECIFICATIONS AND SECTION 6F.61 OF THE MUTCD. THE PRICE OF TRUCK-MOUNTED IMPACT ATTENUATORS AND TRUCK-MOUNTED ARROW PANELS SHALL BE INCLUDED IN THE PRICE BID FOR THE BASIC WORK ZONE TRAFFIC CONTROL ITEM.

5. CHANNELIZING DEVICES

- A. RECOMMENDED PRACTICES FOR CHANNELIZING DEVICES ARE PROVIDED IN THE MUTCD AND SECTION 619-3.02 J OF NYSDOT THE STANDARD
- B. TALL CONES, MEETING THE REQUIREMENTS OF SECTION 729-02 OF THE STANDARD SPECIFICATIONS, ARE NORMALLY ADEQUATE FOR WORK ZONES SET UP AND REMOVED ON A DAILY BASIS DURING DAYLIGHT HOURS. DRUMS OR OVERSIZED VERTICAL PANELS ARE PREFERRED FOR ALL OTHER WORK ZONES AND AT ANY LOCATIONS WHERE THE RISK OF INTRUSION IS HIGH, AS DETERMINED BY THE ENGINEER.
- THE CONTRACTOR SHALL MAKE FREQUENT CHECKS COMMENSURATE WITH TRAFFIC CONDITIONS TO IDENTIFY AND RESET CHANNELIZING DEVICES DISLODGED BY TRAFFIC.
- D. CHANNELIZING DEVICE SPACING (CENTER TO CENTER) SHALL NOT EXCEED 20' IN THE ACTIVE WORK SPACE, UNLESS OTHERWISÉ NOTED, FOR INTERMEDIATE OR LONG TERM OPERATIONS. CHANNELIZING DEVICE SPACING (CENTER TO CENTER) SHALL NOT EXCEED 40' IN THE ACTIVE WORK SPACE, ÀND 20' IN TAPER SPACE FOR SHORT TERM OR MOBILE OPERATIONS, UNLESS OTHERWISE NOTED.
- E. CHANNELIZING DEVICES SHALL BE PLACED TRANSVERSELY A MINIMUM OF EVERY 800' AS SHOWN WHEN A PAVED SHOULDER HAVING A WIDTH OF 8' OR GREATER IS CLOSED FOR A DISTANCE GREATER THAN 800'.
- F. DURING NON-WORK HOURS, LEAVE CHANNELIZING DEVICES AND TEMPORARY CONCRETE BARRIER (TCB) IN PLACE, OR AS DIRECTED AT THE ENGINEER.
- 6. FLAGGING AND TRAFFIC CONTROL
- A. TO INSURE A PROPER LEVEL OF TRAFFIC SAFETY, EACH FLAGGER SHALL BE EQUIPPED WITH A TWO-WAY RADIO DEVICE. THE COST SHALL BE INCLUDED IN THE BASIC WORK ZONE TRAFFIC CONTROL ITEM.
- B. ALL FLAGGER STATIONS SHALL BE ENHANCED WITH ADDITIONAL CONES AND A FLAG TREE AS SHOWN ON THE WORK ZONE TRAFFIC CONTROL (619 SERIES) STANDARD SHEETS AND AS DIRECTED BY THE ENGINEER. FLAG TREE SHALL MEET THE REQUIREMENTS OF SECTION 6F.62 OF THE MUTCD EXCEPT THAT A MINIMUM OF THREE (3) FLAGS ARE REQUIRED. THIS SETUP SHALL BE USED FOR ALL FLAGGER STATIONS EXCEPT THOSE THAT ARE CONSTANTLY MOVING. ALL COSTS ASSOCIATED WITH THESE REQUIREMENTS SHALL BE INCLUDED UNDER THE BASIC WORK ZONE TRAFFIC
- FLAGGER SIGN (W20-7a) AND ONE LANE ROAD AHFAD SIGN (W20-4) SHALL BE REMOVED, COVERED OR TURNED AWAY FROM ROAD USERS WHEN FLAGGING OPERATIONS ARE NOT OCCURRING.
- D. ALL FLAGGERS SHALL USE 24" (MIN.) OCTAGON SHAPED STOP/SLOW PADDLES HAVING 6' STAFF. THE PADDLE IS THE PREFERRED DEVICE, BUT THE FLAG MAY BE USED AT INTERSECTIONS WHERE THE STOP/SLOW PADDLE WOULD OFFER CONTRADICTING INFORMATION TO DRIVERS TRAVELING IN OPPOSITE DIRECTIONS/LEGS OF THE INTERSECTION OR DURING INCIDENT MANAGEMENT SITUATIONS.
- CENTERLINE CONES MAY BE ADDED TO ENHANCE THE VISIBILITY OF THE FLAGGER STATION. IF CONES ARE USED, PLACE THEM 100 FT. (MINIMUM) FROM FLAGGER.
- F. WHEN A SIDE ROAD OR DRIVEWAY INTERSECTS THE ROADWAY WITHIN A WORK ZONE TRAFFIC CONTROL AREA, ADDITIONAL TEMPORARY TRAFFIC CONTROL DEVICES AND/OR FLAGGERS SHALL BE PLACED AS NEEDED. ADDITIONAL FLAGGERS SHALL BE LOCATED AT ALL INTERSECTIONS AND COMMERCIAL DRIVEWAYS LOCATED WITHIN OR NEAR THE ACTIVE WORK SPACE. NO WORK ACTIVITY, EQUIPMENT, OR STORAGE OF VEHICLES, OR MATERIAL SHALL OCCUR WITHIN THE BUFFER SPACE AT ANY TIME.

7. SIGNS AND DEVICES

- A. TRAFFIC CONTROL DEVICES SHALL NOT BE PLACED AT ANY LOCATIONS WHERE THEY MAY OBSCURE OR INTERFERE WITH THE MOTORIST VIEW OF APPROACHING, MERGING, OR INTERSECTING TRAFFIC; OBSTRUCT OTHER TEMPORARY OR PERMANENT TRAFFIC CONTRO DEVICES WHICH ARE STILL APPLICABLE TO ROADWAY CONDITIONS; MISLEAD OR MISDIRECT MOTORISTS, OR ARE BLOCKED BY OTHER TEMPORARY OR PERMANENT OBJECTS.
- B. ALL EXISTING ROADWAY ITEMS SUCH AS GUIDE RAILS, PAVEMENT MARKINGS, CURBS, SIGNALS AND SIGNS DAMAGED BY THE CONTRACTOR SHALL BE RESTORED BY THE CONTRACTOR TO THE SATISFACTION OF THE ENGINEER AT NO ADDITIONAL COST.
- C. ALL TEMPORARY MAINTENANCE OF TRAFFIC AND WORK AREA PROTECTION SIGN SUPPORTS AND MOUNTING SHALL BE IN CONFORMANCE WITH NYSDOT STANDARD SHEETS AND
- D. ALL CONSTRUCTION SIGNS SHALL BE COVERED WITH THICK PLASTIC WHEN THE WORK THEY ARE INTENDED FOR IS NOT IN PROGRESS.
- E. ALL TRAFFIC CONTROL DEVICES SHALL BE INSTALLED PRIOR TO THE COMMENCEMENT OF THE WORK TO WHICH THEY APPLY, AND SHALL BE MAINTAINED BY THE CONTRACTOR THEREAFTER. THE DEVICES SHALL REMAIN IN PLACE AS LONG AS THEY ARE APPLICABLE.
- F. WHEN THE DISTANCE BETWEEN THE ADVANCE WARNING SIGNS AND WORK IS 2 MILES TO 5 MILES, A SUPPLEMENTAL DISTANCE PLAQUE (W7-3aP) SHOULD BE USED WITH THE SHOULDER WORK SIGN (W21-5).
- WORK AHEAD SIGN (W20-1) IF WORK LOCATIONS OCCUR OVER A DISTANCE OF MORE H. IF THE TRAFFIC IS EXPECTED TO QUEUE PAST THE W20-4 SIGN, A W3-4 SIGN SHOULD

G. THE ROAD WORK NEXT XX MILES SIGN (G20-1) MAY BE USED INSTEAD OF THE ROAD

BE ADDED HALFWAY BETWEEN THE W20-4 AND W20-1 SIGNS.

- I. THE NY9-11 SIGN IS RECOMMENDED. IT SHALL BE PLACED IN ADVANCE OF THE FIRST ADVANCE WARNING SIGN. THE PLACEMENT DISTANCE SHALL BE 1000' FOR POSTED SPEED LIMITS OF 45 MPH OR HIGHER, AND 300' - 500' FOR POSTED SPEED LIMITS OF LESS
- J. EXISTING TRAFFIC SIGNAL TIMING SHALL BE ADJUSTED FOR TEMPORARY CONDITIONS. ALL EXISTING VIDEO AND LOOP DETECTORS SHALL BE ADJUSTED TO REFLECT THE CHANGE IN SIGNAL TIMING. CONTRACTOR SHALL ALSO COVER ALL SIGNALS HEADS THAT ARE NOT IN
- K. ALL ADDITIONAL TEMPORARY SIGNAGE, NOT COVERED IN FHWA MUTCD, SHALL COMPLY WITH NYS SUPPLEMENT TO MANUAL OF UNIFORM TRAFFIC CONTROL DEVICES.
- L. THE CONTRACTOR SHALL INSTALL PVMS AT MAJOR INTERSECTIONS/LOCATIONS IN ADVANCE OF ROAD CLOSURE, IN CONSULTATION WITH THE ENGINEER, LOCAL
- M. THE CONTRACTOR SHALL COORDINATE THE PROPERTY OWNER AND OBTAIN THEIR WRITTEN CONSENSUS, BEFORE INSTALLING ANY PVMS ON THEIR PROPERTY.
- N. "END ROAD WORK" SIGN G20-2 SHALL BE LOCATED A MINIMUM DISTANCE OF 80 FT. AND MAXIMUM OF 400 FT. PAST THE END OF THE DOWNSTREAM ON ALL WORKZONE SETUPS.

8. NIGHTTIME WORK GENERAL NOTES:

MUNICIPALITIES AND NYSDOT.

- A. WORK OCCURRING AFTER SUNSET AND BEFORE SUNRISE WILL BE CONSIDERED NIGHTTIME
- B. ALL SIGNS, STOP/SLOW PADDLES AND RED FLAGS USED TO WARN/ALERT/CONTROL TRAFFIC SHALL BE RETROREFLECTIVE.
- C. ALL WORKERS INVOLVED SHALL WEAR PROTECTIVE HELMET AND NIGHTTIME APPAREL IN ACCORDANCE WITH 107-05A. HIGH VISIBILITY APPAREL AT ALL TIMES.
- VEHICLES OPERATING ON THE PAVEMENT OF A CLOSED ROADWAY OR TRAVEL LANE SHALL DISPLAY ROTATING AMBER BEACONS OR FLASHING LED BEACON AT ALL TIMES.
- E. LEVEL I ILLUMINATION SHALL BE PROVIDED NEAR THE BEGINNING OF LANE CLOSURE TAPERS AND AT ROAD CLOSURES, INCLUDING THE SETUP AND REMOVAL OF THE CLOSURE
- F. LEVEL II ILLUMINATION SHALL BE PROVIDED FOR FLAGGING STATIONS, ASPHALT PAVING, MILLING, AND CONCRETE PLACEMENT AND/OR REMOVAL OPERATIONS, INCLUDING BRIDGE DECKS, 50 FEET AHEAD OF AND 100 FEET BEHIND A PAVING OR MILLING
- G. LEVEL III ILLUMINATION SHALL BE PROVIDED FOR PAVEMENT OR STRUCTURAL CRACK FILLING, JOINT REPAIR, PAVEMENT PATCHING AND REPAIRS, INSTALLATION OF SIGNAL EQUIPMENT OR OTHER ELECTRICAL/MECHANICAL, AND OTHER TASKS INVOLVING FINE DETAILS OR INTRICATE PARTS AND EQUIPMENT.
- H. ALL LIGHTING SHALL BE DESIGNED, INSTALLED, AND OPERATED TO AVOID GLARE THAT AFFECTS TRAFFIC ON THE ROADWAY OR THAT CAUSES ANNOYANCE OR DISCOMFORT FOR RESIDENCES ADJOINING THE ROADWAY.
- I. PRIOR TO THE START OF NIGHTIME OPERATIONS, A WRITTEN NIGHTIME OPERATIONS AND LIGHTING PLAN IS REQUIRED FOR APPROVAL.
- REFER TO NYSDOT HIGHWAY DESIGN MANUAL (HDM) SECTION 16.5.7 (NIGHTTIME CONSTRUCTION), AND NYSDOT STANDARD SPECIFICÁTIONS 619 FOR ADDITIONAL REQUIREMENTS AND CONSIDERATIONS.

9. BICYCLISTS AND PEDESTRIANS:

- A. THE CONTRACTOR SHALL MAINTAIN PEDESTRIAN AND BICYCLE TRAFFIC THROUGH OR AROUND EACH WORK AREA FOR THE DURATION OF THE CONSTRUCTION. MATERIAL, EQUIPMENT OR OTHER SUCH BARRIERS SHALL NOT BE PLACED OR PARKED IN SUCH A MANNER AS TO OBSTRUCT PEDESTRIAN OR BICYCLE TRAFFIC OR TO PRESENT A SAFETY HAZARD TO THE NON-MOTORIZED PUBLIC. WHERE PEDESTRIAN TRAFFIC MUST BE RELOCATED OFF THE EXISTING FACILITY, WALKWAYS SHALL BE CLEARLY MARKED AND HAVE LOGICAL START AND TERMINUS. SEE NYSDOT STANDARD SHEET 619-519 FOR DETAILS.
- B. THE CONTRACTOR SHALL PROVIDE, DELINEATE AND MAINTAIN A USABLE TRAVEL PATH FOR PEDESTRIANS EITHER THROUGH OR AROUND WORK ZONES FOR THE DURATION OF THIS PROJECT, THE TRAVEL PATH SHALL COMPLY WITH THE CONTINUOUS PASSAGE PROVISIONS OF THE CURRENT AMERICANS WITH DISABILITIES ACT (ADA) GUIDELINES. SEE NYSDOT STANDARD SHEET 619-519 FOR DETAILS.
- C. TEMPORARY SAFETY FENCING SHALL BE PLACED ALONG ANY SIDEWALK ADJACENT TO ANY EXCAVATION OR VERTICAL DROP-OFF OVER SIX (6) INCHES. SAFETY FENCING SHALL BE CONTINUOUS PLASTIC FLUORESCEN ORANGE SUPPORTED BY WOOD POSTS. THE FENCING SHALL BE A MINIMUM OF FOUR (4) FEET IN HEIGHT AND MAY INCLUDE A TOP AND BOTTOM RAIL TO PROVIDE ADDITIONAL SUPPORT, AOBE. THE SAFETY FENCE SHALL CONFORM TO SECTION 107-05 OF THE STANDARD SPECIFICATIONS. ALL LABOR, MATERIALS AND EQUIPMENT NECESSARY TO INSTALL AND REMOVE TEMPORARY SAFETY FENCING SHALL BE INCLUDED IN THE PRICE BID FOR BASIC WORK ZONE TRAFFIC CONTROL, ITEM 619.01.
- D. THE CONTRACTOR SHALL PROVIDE A USABLE TRAVEL PATH AT ALL BUS STOP LOCATIONS TO PROVIDE SAFE ACCESS TO AND FROM THE BUS.

TEMPORARY SIGN

CHANGEABLE MESSAGE SIGN (PVMS)

WORK ZONE

■ ■ CHANNELIZING DEVICE TCB (UNPINNED)

FLAGGER

24,000 LB PROTECTIVE VEHICLE

WITH TRUCK/TRAILER MOUNTED ATTENUATOR (TMIA)

RROW PANEL (CAUTION MODE)

ROW PANEL

TYPE III BARRICADE

ARROW PANEL TRAILER OR SUPPORT



TEMPORARY IMPACT ATTENUATOR

ABBREVIATIONS

- AADT AVERAGE ANNUAL DAILY TRAFFIC
- COUNTY ROUTE
- DHV DIRECTIONAL HOURLY VOLUME
- FLASHING ARROW SIGN UNIT FEDERAL HIGHWAY ADMINISTRATION
- MILE POST
- MAX. MAXIMUM
- MILES PER HOUR
- MANUAL ON UNIFORM TRAFFIC CONTROL DEVICES NEW YORK STATE
- NYSDOT NEW YORK STATE DEPARTMENT OF TRANSPORTATION RTE

TCB TEMPORARY CONCRETE BARRIER

STA.

STATION

SEGMENT 12 (PACKAGE 7B) - ROUTE 9W: ROCKLAND WORK ZONE TRAFFIC CONTROL

CHAMPLAIN HUDSON POWER EXPRESS

GENERAL NOTES & ABBREVIATIONS

KC PROJECT NO. 120174 DRAWING NO.

O-001

KIEWIT PROJECT NO.

21162







IT IS A VIOLATION OF LAW FOR ANY PERSON, UNLESS THEY ARE ACTING UNDER THE DIRECTION OF A LICENSED PROFESSIONAL ENGINEER, ARCHITECT, LANDSCAPE ARCHITECT OR LAND SURVEYOR TO ALTER AN ITEM IN ANY WAY. IF AN ITEM BEARING THE STAMP OF A LICENSED PROFESSIONAL IS ALTERED, THE ALTERING ENGINEER, ARCHITECT, LANDSCAPE ARCHITECT OR LAND SURVEYOR SHALL STAMP THE DOCUMENT AND INCLUDE THE NOTATION "ALTERED BY" FOLLOWED BY THEIR SIGNATURE, THE DATE OF SUCH ALTERATION, AND A SPECIFIC DESCRIPTION OF THE ALTERATION.

ISSUED FOR

MS SB 04/14/2023 FINAL SUBMISSION MS SB 03/01/2023 DRAFT FINAL REV 1 SUBMISSION MS SB 11/16/2022 DRAFT FINAL SUBMISSION MS SB 05/20/2022 | 60% DESIGN SUBMISSION 03/23/2022 PRELIMINARY DESIGN DEVELOPMENT 02/18/2022 PRELIMINARY PROGRESS MS DATE SUBMITTAL / REVISION DESCRIPTION

MS SB DB APP DRAWN BY

DESIGNED BY: JM APPROVED BY: SB REV. NO.

AS SHOWN DATI

XX OF XXX

						PACKAGE 7B	WZTC WITH DETOUR	INFORMATION AND	WORK DESCRI	PTIONS						
	DETOUR INFORMATION					Construction	Construction Work Hours			WORK TO BE COMPLETED						
STAGE	9W Length (Miles)	Detour Length (Miles)	EXISTING TRAVEL LANES	TRAFFIC TO BE MAINTAINED ON 9W DURING CONSTRUCTION	TRAFFIC TO BE DETOURED	Detour Description	Day Time	Night Time	Approx. Length of Trench (ft.)	ESTIMATED TIMEFRAME TO COMPLETE TRENCH*	Transition, Splice, and Link vaults	HDD#	HDD Start Sta.	HDD End Sta.	Total length of HDD (ft.)	ESTIMATED TIMEFRAME TO COMPLETE HDD (DAYS)
STAGE 1	1	N/A	1 NB 1 SB	BI-DIRECTIONAL	N/A	N/A	7AM-3PM	7PM-5AM	5200	104	Transition Vault 4 (72899+15) Splice Vault 251A (72867+28)	N/A	N/A	N/A	N/A	N/A
STAGE 2	0.6	N/A	1 NB 1 SB	BI-DIRECTIONAL	N/A	N/A	9AM-3PM	7PM-5AM	3300	66	Splice Vault 251 (72843+58)	N/A	N/A	N/A	N/A	N/A
STAGE 3	0.96	N/A	1 NB 1 SB	BI-DIRECTIONAL	N/A	N/A	9AM-3PM	7PM-5AM	5000	100	Splice Vault 250A (72811+08) Splice Vault 250 (72785+36) Splice Vault 249A (72766+56)	N/A	N/A	N/A	N/A	N/A
STAGE 4	1.87	N/A	1 NB 1 SB 1 TL	BI-DIRECTIONAL	N/A	N/A	N/A	7PM-5AM	6900	138	Splice Vault 249 (72730+20) Splice Vault 248A (72712+54)	HDD 132	72678+86	72697+21	1842	75
CTACE F	1.15	N1/A	1 ND 1 CD 1 TI	DI DIDECTIONAL	NI/A	N/A	0444 2044	7004 5004	1500	20	Splice Vault 248 (72677+18)	HDD 131	72655+17	72675+66	2055	82
STAGE 5	1.15	N/A	1 NB 1 SB 1 TL	BI-DIRECTIONAL	N/A	N/A	9AM-3PM	7PM-5AM	1500	28	Splice Vault 247 (72631+66)	HDD 129	72637+71	72654+26	2011	81
STAGE 6	0.6	N/A	1 NB 1 SB 1 TL	BI-DIRECTIONAL	N/A	N/A	9AM-3PM	7PM-5AM	1870	34	Splice Vault 246A (72600+93)	HDD 127	72610+99	72625+39	1603	66
STAGE 7	0.63	N/A	1 NB 1 SB 1 TL	BI-DIRECTIONAL	N/A	N/A	9AM-3PM	7PM-5AM	1000	19	Splice Vault 246 (72560+03) Splice Vault 246BB (72584+05)	HDD 126	72561+10	72582+80	2177	86
STAGE 8	0.22	0.48	1 NB 1 SB 1 TL	SB TRAFFIC	NB	Detour permanent during duration of stage	9AM-3PM	7PM-5AM	1200	22	N/A	N/A	N/A	N/A	N/A	N/A
STAGE 9	0.6	N/A	1 NB 1 SB	BI-DIRECTIONAL	N/A	N/A	7AM-5PM (Including Saturday's)	7PM-5AM (including Saturday)	3200	59	Splice Vault 245 (72527+57) Splice Vault 245A (72538+41)	N/A	N/A	N/A	N/A	N/A
STAGE 10	0.26	0.54	1 WB 1 EB	PARTIALLY CLOSED	NB & SB LOCAL	Detour permanent during duration of stage	7AM-5PM (Including Saturday's)	7PM-5AM (including Saturday)	1300	24	Transition Vault 3 (72495+67)	HDD 124	72496+78	72504+16	738	36

619-503

*ASSUMING 50 FEET OF TRENCH PER SHIFT, AT 1 SHIFT PER DAY. PER NYSDOT CORRESPONDENCE DATED 04/07/2021 **FOR DRIVEWAY CLOSURES REFER TO NOTE 1-K ON O-001.


WZTC Standards for Mill and Inlay (M&I) Operation on route 9W					
Stage	NYSDOT Standard sheets	M&I Start	M&I End		
Stage 10	619-407, 619-421, 402-01	72499+00	72575+00		
Stage 9	619-407, 619-421, 402-01	72575+00	72547+00		
Stage 8	619-407, 619-421, 619-422, 402-01	72547+00	72559+50		
Stage 7	619-421, 619-422, 402-01	72583+00	72592+50		
Stage 6	619-407, 619-421, 619-422, 402-01	72592+50	72610+00		
Stage 5	619-421, 619-422, 402-01	72625+50	72637+50		
Stage 4	619-407, 619-421, 402-01	72698+00	72766+00		
Stage 3	619-407, 619-421, 402-01	72766+00	72815+00		
Stage 2	619-407, 619-421, 402-01	72815+00	72841+00		
Stage 1	619-407, 619-421, 402-01	72847+00	72898+00		
All Intersection	619-421				

MILL AND INLAY NOTES:

- 1. MILL AND INLAY TO BE PLACED/REPLACED AS APPROVED BY ENGINEER OF
- 2. LEVEL II ILLUMINATIONATION SHALL BE PROVIDED FOR FLAGGING STATIONS, ASPHALT PAVING, MILLING, AND CONCRETE PLACEMENT AND/OR REMOVAL OPERATIONS, INCLUDING BRIDGE DECKS, 50 FEET AHEAD OF AND 100 FEET BEING PAVING OR MILLING MACHINE
- 3. NO MILLING AND INLAYING IS REQUIRED OVER BRIDGE, UNLESS OTHERWISE
- 4. WORK ZONE TRAFFIC CONTROL FOR INTERSECTIONS SHALL FOLLOW NYSDOT STANDARD SHEET 619-421
- 5. THIS TABLE SHALL ALSO APPLY FOR PERMANENT RESTRIPING OPERATIONS





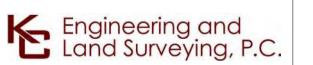

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OR LAND SURVEYOR TO ALTER AN ITEM IN ANY WAY. IF AN
ITEM BEARING THE STAMP OF A LICENSED PROFESSIONAL IS
ALTERED, THE ALTERING ENGINEER, ARCHITECT, LANDSCAPE ALTERED, THE ALTERING ENGINEER, ARCHITECT, LANDSCAPE
ARCHITECT OR LAND SURVEYOR SHALL STAMP THE DOCUMENT
AND INCLUDE THE NOTATION "ALTERED BY" FOLLOWED BY
THEIR SIGNATURE, THE DATE OF SUCH ALTERATION, AND A
SPECIFIC DESCRIPTION OF THE ALTERATION.

	F	04/14/2023	FINAL SUBMISSION	MS	SB
	E	03/01/2023	DRAFT FINAL REV 1 SUBMISSION	MS	SB
SSUED FOR	D	11/16/2022	DRAFT FINAL SUBMISSION	MS	SB
PERMITTING	С	05/20/2022	60% DESIGN SUBMISSION	MS	SB
	В	03/23/2022	PRELIMINARY DESIGN DEVELOPMENT	MS	SB
	Α	02/18/2022	PRELIMINARY PROGRESS	MS	SB
	No.	DATE	SUBMITTAL / REVISION DESCRIPTION	DB	APP

CHAMPLAIN HUDSON POWER EXPRESS SEGMENT 12 (PACKAGE 7B) - ROUTE 9W: ROCKLAND WORK ZONE TRAFFIC CONTROL TABLES

KIEWIT PROJECT NO. 21162 KC PROJECT NO. 120174 DRAWING NO.

0-002

AS SHOWN DATE DRAWN BY: BM DESIGNED BY: BM APPROVED BY: SB REV. NO. XX OF XXX

	NYSDOT STANDARD SHEET / SHEET NUMBER
245	619-080 WORK BEYOND SHOULDER
246BB	619-080 WORK BEYOND SHOULDER
248	619-080 WORK BEYOND SHOULDER
248A	619-080 WORK BEYOND SHOULDER
249	619-080 WORK BEYOND SHOULDER
250A	619-080 WORK BEYOND SHOULDER
251	619-080 WORK BEYOND SHOULDER
251A	619-080 WORK BEYOND SHOULDER



WZTC KEY PLAN SCALE: 1" = 2000'





Engineering and Land Surveying, P.C.	
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1	D	11/16/
PERMITTING	С	05/20/
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	D	11/16/2022	DRAFT FINAL SUBMISSION	MX	88
	С	05/20/2022	60% DESIGN SUBMISSION	MX	XX
┚┃	В	03/23/2022	PRELIMINARY DESIGN DEVELOPMENT	MX	XX
	Α	02/18/2022	PRELIMINARY PROGRESS	MX	XX
	No.	DATE	SUBMITTAL / REVISION DESCRIPTION	DB	APP

CHAMPLAIN HUDSON POWER EXPRESS SEGMENT 12 (PACKAGE 7B) - ROUTE 9W: ROCKLAND WORK ZONE TRAFFIC CONTROL **KEY PLAN** DRAWN BY: MS DESIGNED BY: MS APPROVED BY: SB SCALE REV. NO.

KC PROJECT NO. 120174 DRAWING NO. **O-003**

AS SHOWN DATE

KIEWIT PROJECT NO.

21162


LOCATION	SIGN	MUTCD NO.	COLOR	SIZE(S)
А	DETOUR	M4-8	ORANGE AND BLACK	24"X12"
В	END DETOUR	M4-8a	ORANGE AND BLACK	24"X18"
С	North	M3-1	BLACK AND WHITE	24"X12"
D	South	M3-3	BLACK AND WHITE	24"X12"
E	EAST	M3-2	BLACK AND WHITE	24"X12"
F	WEST	M3-4	BLACK AND WHITE	24"X12"
G	TRUCK	M4-4	BLACK AND WHITE	24"X12"
Н	900	M1-4	BLACK AND WHITE	24"X24"
l	202	M1-4t	BLACK AND WHITE	30"X24"
J	PARK RD	D1-2	BLACK AND WHITE	24"X30"
K	SAMSONDALE PLAZA	D1-2	BLACK AND WHITE	24"X30"
L	LICENSE SUSPENDED AFTER TWO WORK ZONE SPEEDING TICKETS	NYR9-11	BLACK AND WHITE	24"X42"
М	END ROAD WORK	G20-2	ORANGE AND BLACK	36"X18"
N	ROAD WORK AHEAD	W20-1	ORANGE AND BLACK	36"X36"
0	BE PREPARED TO STOP	W3-4	ORANGE AND BLACK	36"X36"

LOCATION	<u>SIGN</u>	MUTCD NO.	COLOR	SIZE(S)
Р	ONE LANE ROAD AHEAD	W20-4	ORANGE AND BLACK	36"X36"
Q		W20-7	ORANGE AND BLACK	36"X36"
R	DETOUR AHEAD	W20-2	ORANGE AND BLACK	36"X36"
S	ROAD CLOSED AHEAD	W20-3	ORANGE AND BLACK	36"X36"
Т		R3-2	BLACK AND WHITE	24"X24"
U		R3-1	BLACK AND WHITE	24"X24"
V	ROAD CLOSED	R11-2	BLACK AND WHITE	48"X30"
W	LANE	NYW8-33	ORANGE AND BLACK	48"X24"
X		W1-6L	ORANGE AND BLACK	48"X24"
Υ		W1-6R	ORANGE AND BLACK	48"X24"
Z		W4-R2	ORANGE AND BLACK	36"X36"
	<u> </u>			

2		M6-3	BLACK AND WHITE	21"X15"
		ME 11		
3		M6-1L	BLACK AND WHITE	21"X15"
		M6-1R	BLACK AND WHITE	21"X15"
6		M5-1L	BLACK AND WHITE	21"X15"
7		M5-1R	BLACK AND WHITE	21"X15"
8		M6-4	BLACK AND WHITE	21"X15"
9		W1 – 4L	ORANGE AND BLACK	36"X36"
10		W1 – 4R	ORANGE AND BLACK	36"X36"
11		W24-1L	ORANGE AND BLACK	36"X36"
12	CENTER LANE CLOSED AHEAD	W20-5	ORANGE AND BLACK	36"X36"
13		R4-7	BLACK AND WHITE	24"X30"





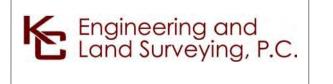

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R	D	11/16/2022	DRAFT FINAL SUBMISSION	MS	SB	
IG	С	05/20/2022	60% DESIGN SUBMISSION	MS	SB	
	В	03/23/2022	PRELIMINARY DESIGN DEVELOPMENT	MS	SB	
	Α	02/18/2022	PRELIMINARY PROGRESS	MS	SB	
	No.	DATE	SUBMITTAL / REVISION DESCRIPTION	DB	APP	DF
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CHAMPLAIN HUDSON POWER EXPRESS
SEGMENT 12 (PACKAGE 7B) - ROUTE 9W: ROCKLAND
WORK ZONE TRAFFIC CONTROL
SIGNAGE TABLES
SHEET 1 OF 2

DESIGNED BY: MS APPROVED BY: SB REV. NO.

KIEWIT PROJECT NO.
21162
KC PROJECT NO.
120174
DRAWING NO.

AS SHOWN DATE


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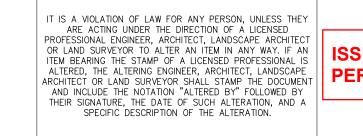
LOCATION	<u>SIGN</u>	MUTCD NO.	COLOR	SIZE(S)
14	ROAD CLOSED TO THRU TRAFFIC	R11-4	WHITE AND BLACK	60"X30"
15	ROAD CLOSED 1/4 MILES AHEAD LOCAL TRAFFIC ONLY	R11-3A	WHITE AND BLACK	60"X30"
16	DETOUR	M4-10R	ORANGE AND BLACK	48"X18"
17	DETOUR	M4-10L	ORANGE AND BLACK	48"X18"
18		OM3-R	YELLOW AND BLACK	12"X36"
19	KENNEDY DR	D3-1	BLACK AND WHITE	24"X12"
20	W RAILROAD AVE	D3-1	BLACK AND WHITE	24"X12"
21	RIGHT SHOULDER CLOSED	W21-5a	ORANGE AND BLACK	36"X36"
22	RIGHT SHOULDER CLOSED 1/2 MILE	W21-5b	ORANGE AND BLACK	36"X36"

LOCATION	<u>SIGN</u>	MUTCD NO.	COLOR	SIZE(S)
23	SIDEWALK	R9-9	WHITE AND BLACK	24"X12"
24	SIDEWALK CLOSED USE OTHER SIDE	R9-10	WHITE AND BLACK	24"X12"
25	SIDEWALK CLOSED AHEAD CROSS HERE	R9-11L	WHITE AND BLACK	24"X18"
26	SIDEWALK CLOSED AHEAD CROSS HERE	R9–11R	WHITE AND BLACK	24"X18"
27	DO NOT ENTER	R5–1	WHITE AND RED	36"X36"
28		M6-2R	BLACK AND WHITE	21"X15"







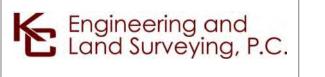

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	В	03/23/2022	PRELIMINARY DESIGN DEVELOPMENT	MS	SB		
	Α	02/18/2022	PRELIMINARY PROGRESS	MS	SB		
	No.	DATE	SUBMITTAL / REVISION DESCRIPTION	DB	APP	DRAWN BY:	

	CHAMPLAIN HUDSON POWER EXPRESS	
,	SEGMENT 12 (PACKAGE 7B) - ROUTE 9W: ROCKLAND	
,	WORK ZONE TRAFFIC CONTROL	
,	SIGNAGE TABLES	
-	SHEET 2 OF 2	

DESIGNED BY: MS APPROVED BY: SB REV. NO.

21162 KC PROJECT NO. 120174 DRAWING NO. **O-005**

04/12/2023

XX OF XXX

AS SHOWN DATE

KIEWIT PROJECT NO.

RTE 9W NB BYPASS ROUTES SCALE: N.T.S.

- START BYPASS ROUTE AT INTERSECTION OF 9W AND NY RTE 52/I-84 end SB 9W bypass route at intersection of I-287 and route 303. Install PVMs at the following locations:
- I. I-287 WB: 1,200 FEET UPSTREAM OF EXIT 11 (RIGHT SIDE)
 J. I-287 WB: 1,200 FEET UPSTREAM IF EXIT 10 (RIGHT SIDE)
 K. I-287 WB: ENTRANCE RAMP GORE FROM ROUTE 9 (EAST OF MARIO CUOMO BRIDGE) (RIGHT SIDE)
 L. I-287 EB: 1,300 FEET SOUTH OF ENTRANCE RAMP FROM ROUTE 17
 M. I-287 EB: 2,300 FEET SOUTH OF ENTRANCE RAMP FROM ROUTE 17
 N. 9W NB: 200 FEET SOUTH OF INTERSECTION OF 9W AND SHADYSIDE AVE.

RD WRK RTE 9W BYPASS

SCREEN 2 USE ALT RTES I-87, 287

SCREEN 3 & PALISADES PKWY

L	<u>EGEND</u>
 	CONSTRUCTION SIGNS
A OR A	PROPOSED SIGN LOCATION ID (SIGNS STACKED PER MUTCD)
	DETOUR ROUTE
	DIRECTION OF TRAFFIC





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ISSUED FOR

MS SB 04/14/2023 FINAL SUBMISSION MS SB 03/01/2023 DRAFT FINAL REV 1 SUBMISSION MS SB 11/16/2022 DRAFT FINAL SUBMISSION MS SB 05/20/2022 | 60% DESIGN SUBMISSION MS SB 03/23/2022 PRELIMINARY DESIGN DEVELOPMENT MS SB 02/18/2022 PRELIMINARY PROGRESS DATE SUBMITTAL / REVISION DESCRIPTION

CHAMPLAIN HUDSON POWER EXPRESS SEGMENT 12 (PACKAGE 7B) - ROUTE 9W: ROCKLAND WORK ZONE TRAFFIC CONTROL NB BYPASS ALTERNATE TRAFFIC ROUTES

KIEWIT PROJECT NO. 21162 KC PROJECT NO. 120174 DRAWING NO. **O-006**


DB APP DRAWN BY: MS DESIGNED BY: MS APPROVED BY: SB SCALE REV. NO. AS SHOWN DATE XX OF XXX

Nappingers Falls Hopewell Junction START BYPASS ROUTE. SEE NOTE 1. Montgomery, lew Windsor Fahnestock State Park West Point Chester | BYPASS ROUTE L=44.7 MILES Peekskill Yorktown Height PALISADES INTERSTATE
PARKWAY (NO TRUCKS) od Lake RTE 9W WORK LIMITS BYPASS ROUTE te Park (L=7.5 MILES)L=18 MILES END BYPASS ROUTE. SEE NOTE 2. Mahwah Data SIO, NOAA, U.S. Navy, NGARGEBO

RTE 9W SB BYPASS ROUTES SCALE: N.T.S.

- START SB 9W BYPASS ROUTE AT INTERSECTION OF 9W AND NY RTE 52/I-84 END SB 9W BYPASS ROUTE AT INTERSECTION OF I-287 AND ROUTE 303. INSTALL PVMS AT THE FOLLOWING LOCATIONS
 - A. I-84 WB: 570 FEET DOWNSTREAM FROM ENTRANCE RAMP FROM RTE 9D (RIGHT SIDE)
 B. I-84 WB: 750 FEET UPSTREAM OF EXIT 39B (RIGHT SIDE)
 C. I-84 EB: 1300 FEET UPSTREAM OF EXIT 36A (RIGHT SIDE)
 D. I-84 EB: 1.4 MILES UPSTREAM OF EXIT 36A (RIGHT SIDE)
 D. ROUTE 9W SB: 500 FEET NORTH OF ON ROUTE 9W AND FIREFIGHTERS MEMORIAL DRIVE

SCREEN 3 RD WRK RTE 9W BYPASS USE ALT RTES I-87, 287 & PALISADES PKWY

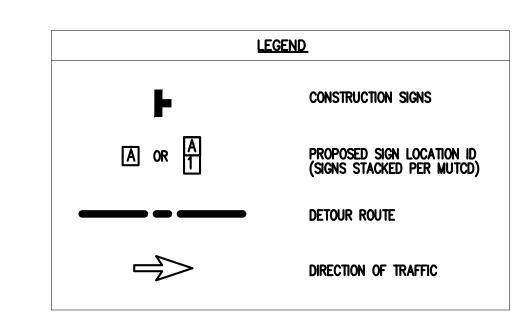





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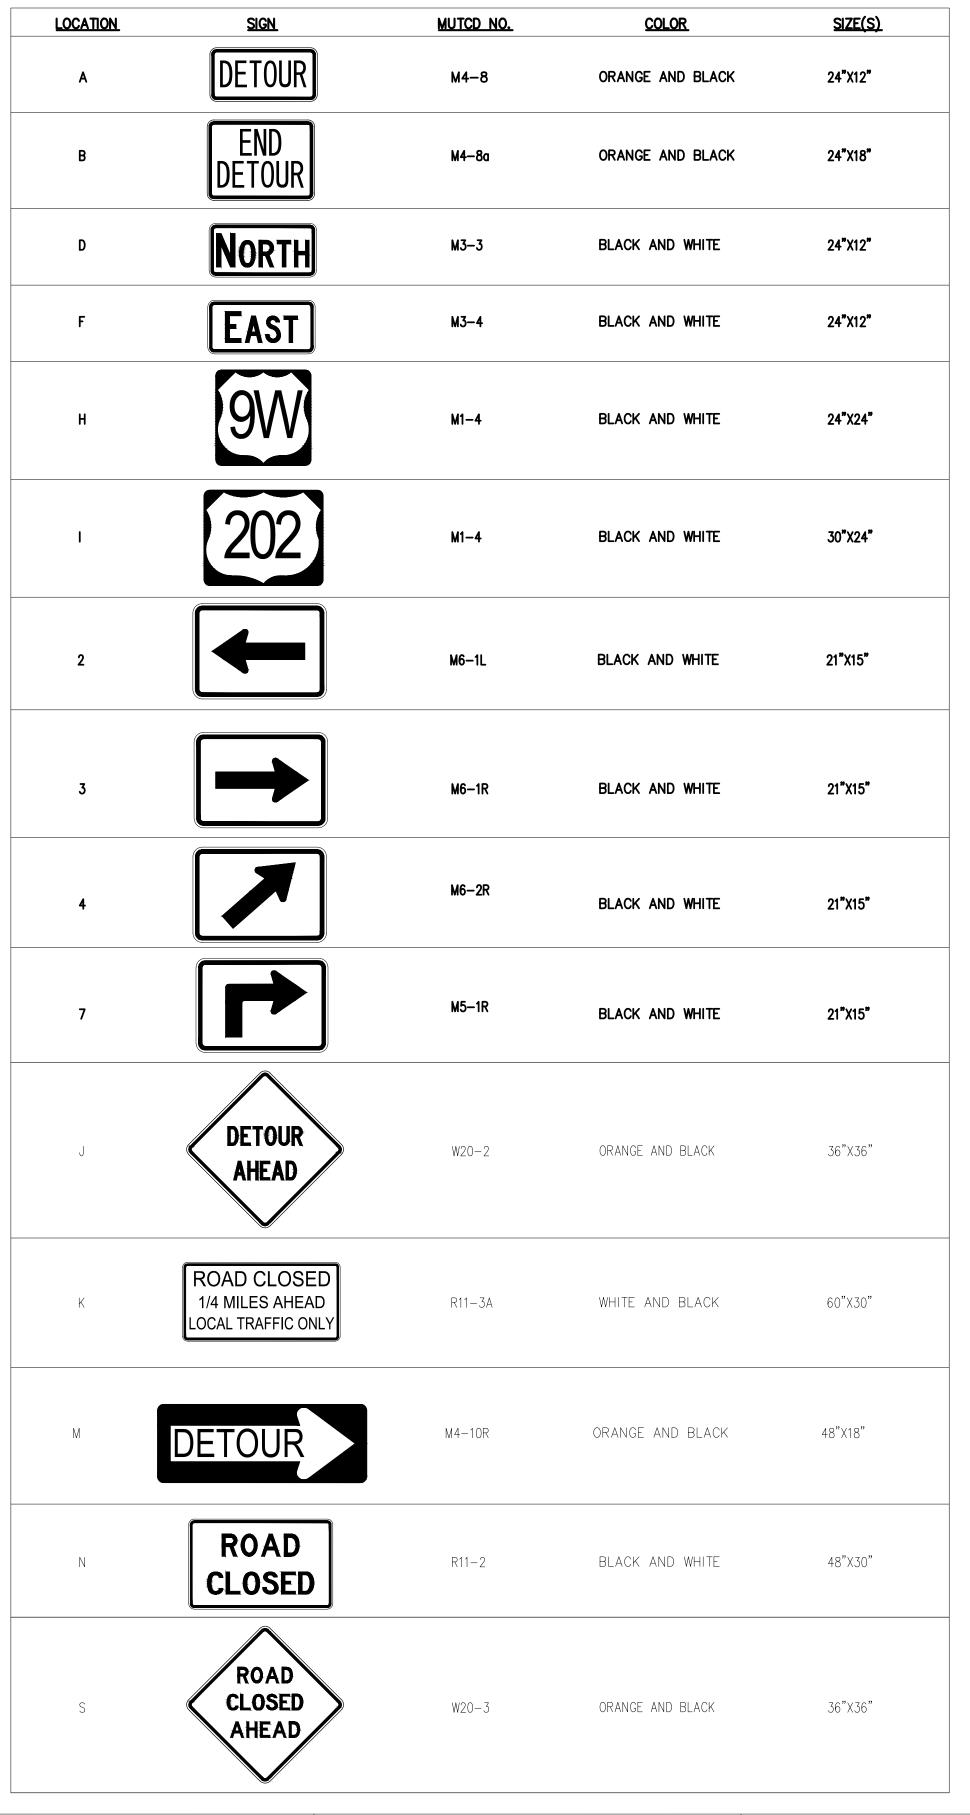
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CHAMPLAIN HUDSON POWER EXPRESS SEGMENT 12 (PACKAGE 7B) - ROUTE 9W: ROCKLAND WORK ZONE TRAFFIC CONTROL SB BYPASS ALTERNATE TRAFFIC ROUTES AS SHOWN DATE

KIEWIT PROJECT NO. 21162 KC PROJECT NO. 120174 DRAWING NO. **O-007**

XX OF XXX



1. INSTALL PVMS AT 650' FEET SOUTH OF ROUTE 9W/LOWLAND HILL RD INTERSECTION, FACING NB

RTE 9W CLOSED

- 2. THE CONTRACTOR SHALL COVER CONFLICTING SIGNAGE WITH THICK PLASTIC. REMOVE PRIOR TO END OF STAGE.
- 3. DURING WINTER MORATORIUM, COVER EXCAVATION WITH TEMPORARY ASPHALT AND OPEN ALL LANES TO TRAFFIC.
- 4. DRUMS SHALL BE LEFT IN PLACE DURING NON-WORKING HOURS


SCREEN #2


DETOUR

5. MINIMUM LANE WIDTHS FOR THRU TRAFFIC ON ROUTE 9W/202 SHALL BE 11'

SUMMARY OF TRAFFIC CONTROL:

- 1. NIGHTTIME WORK
- 2. SB ROUTE 9W TRAFFIC REMAINS OPEN AT ALL TIMES
- 3. ACCESS/EGRESS TO LOCAL COMMERCIAL AN RESIDENTIAL PROPERTIES SHALL BE MAINTAINED AT ALL TIMES
- 4. DETOUR ROUTE LENGTH: 0.48 MILE
- 5. NB ROUTE 9W IS CLOSED FROM RT 210 (CENTRAL DRIVE) TO CR 108 (WEST MAIN ST.). LENGTH: 0.22 MILE

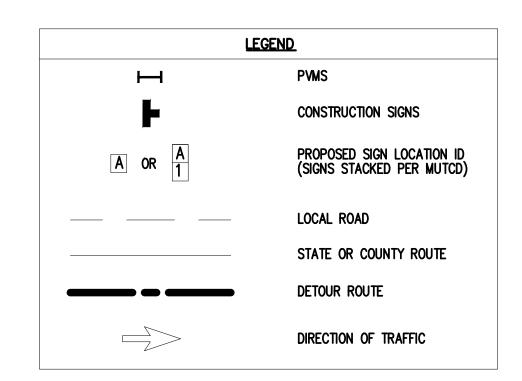


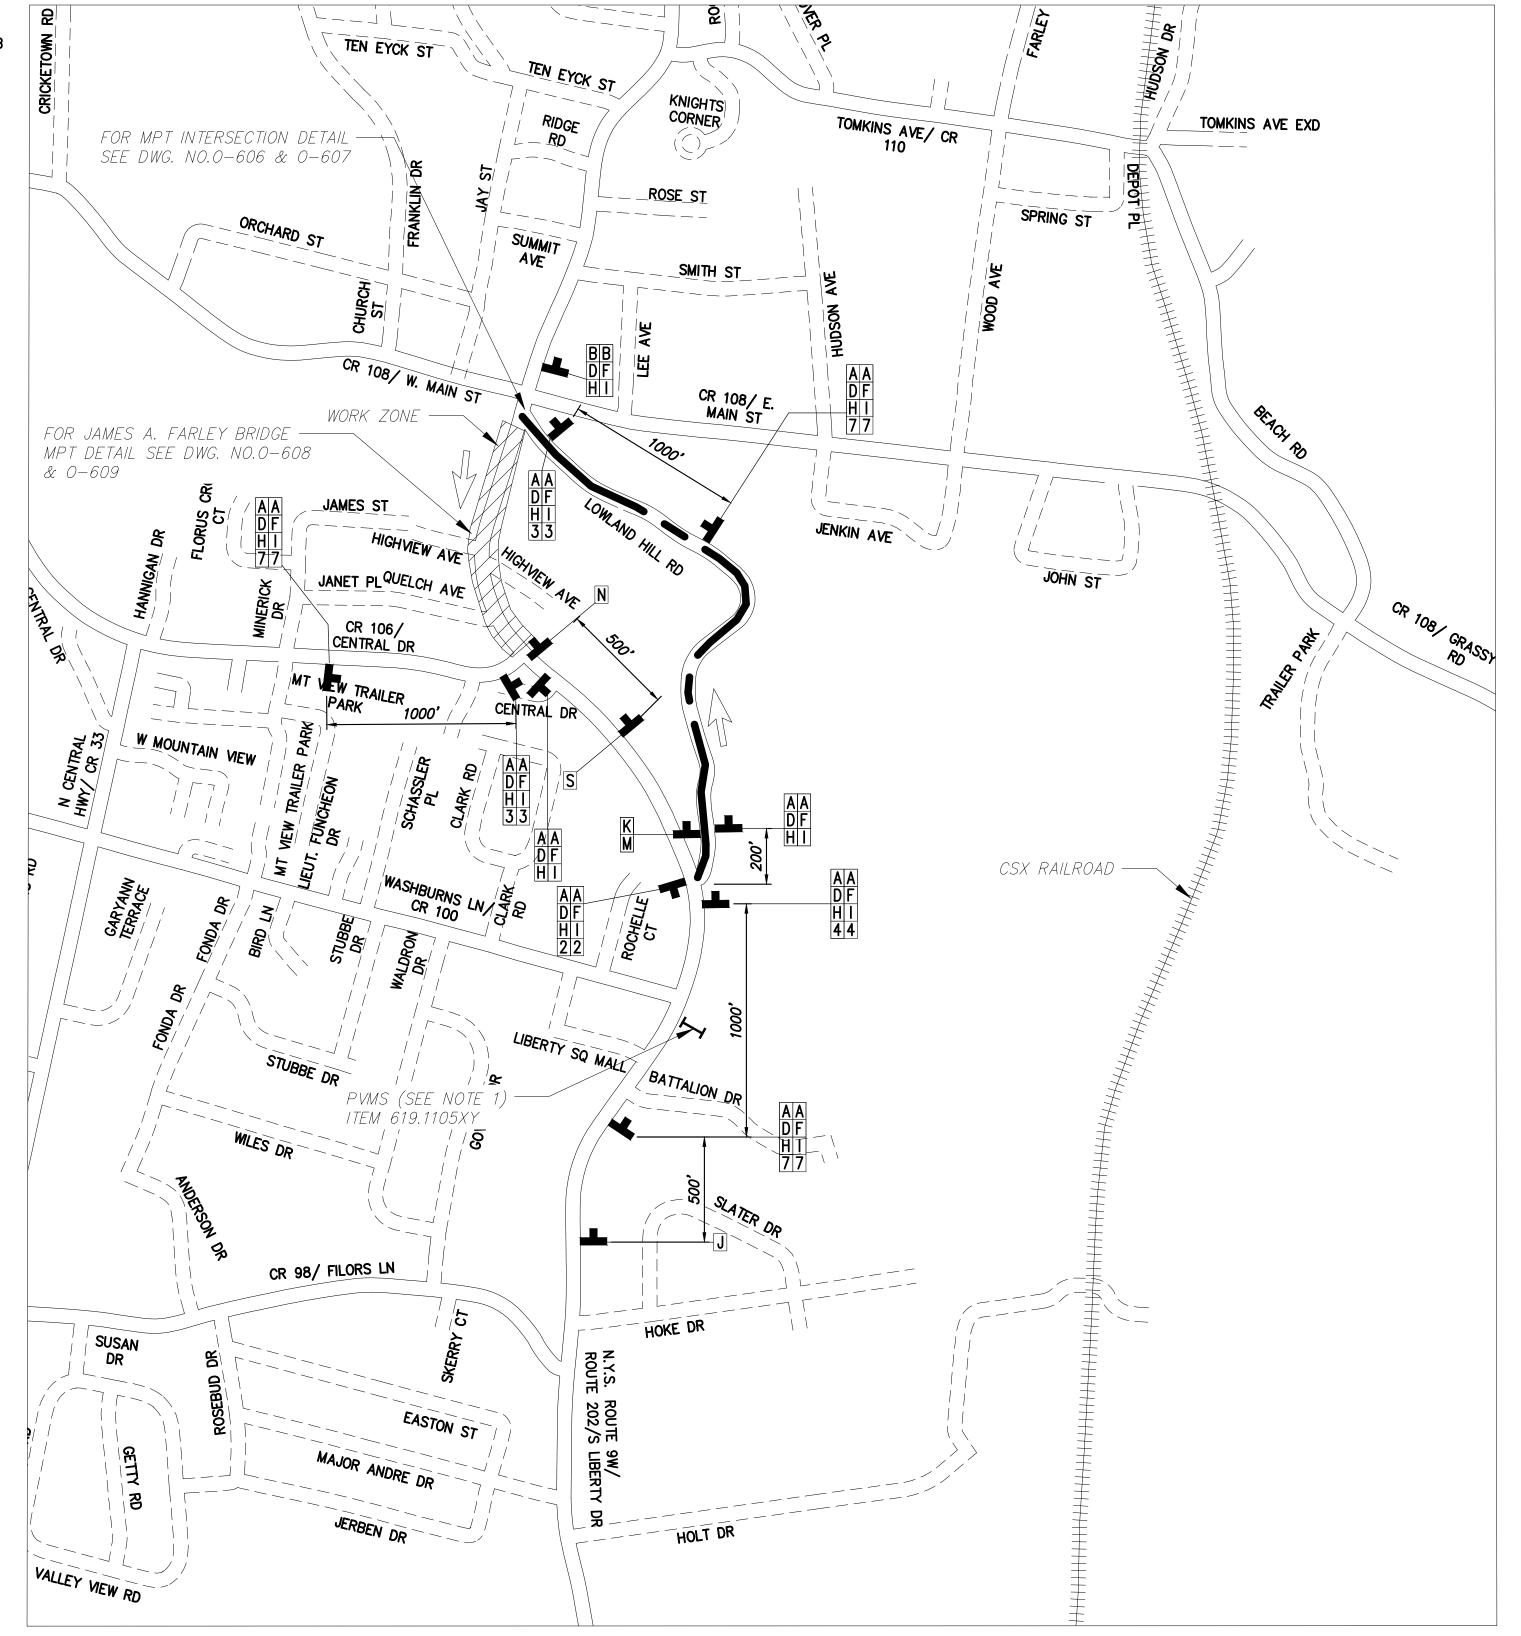

STAGE 8 / JAMES A. FARLEY MEMORIAL BRIDGE ROUTE 9W NB DETOUR FOR ALL TRAFFIC PLAN VIEW





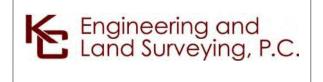

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ISSUED FOR


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IG	С	05/20/2022	60% DESIGN SUBMISSION	MS	SB	STAGE 8 / JAMES A. FARLEY MEMO				RIAL BI	
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CHAMPLAIN HUDSON POWER EXPRESS SEGMENT 12 (PACKAGE 7B) - ROUTE 9W: ROCKLAND WORK ZONE TRAFFIC CONTROL STAGE 8 / JAMES A. FARLEY MEMORIAL BRIDGE **DETOUR PLAN**

KIEWIT PROJECT NO. 21162 KC PROJECT NO. 120174 DRAWING NO. 0-401

XX OF XXX


AS SHOWN DATE

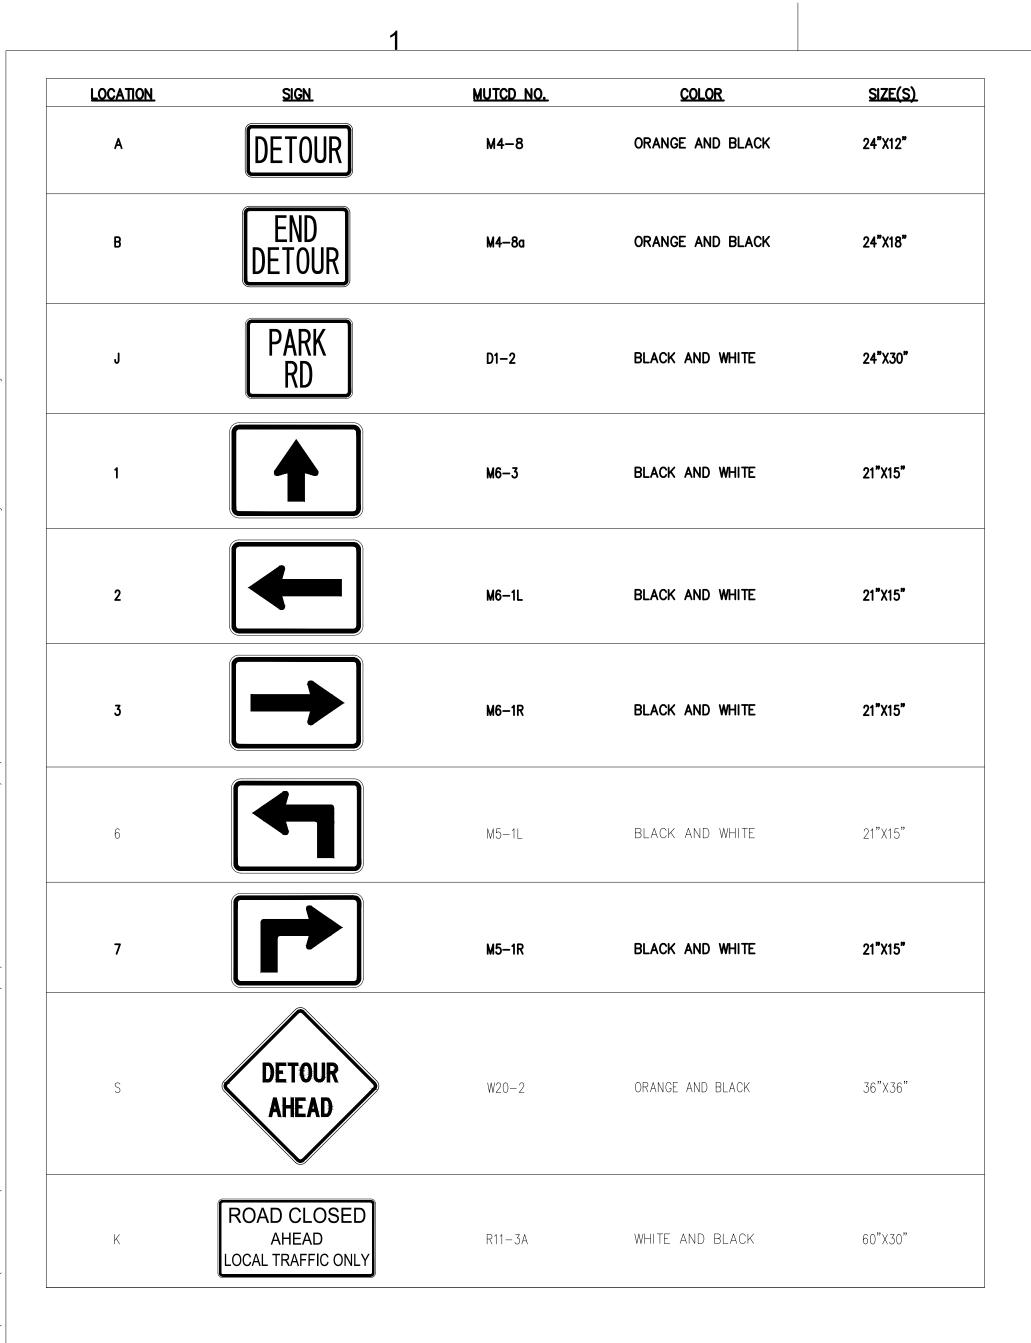

SUMMARY OF TRAFFIC CONTROL:

- 1. DAYTIME WORK
- 2. DIVERT PARK RD TRAFFIC TO DETOUR
- 3. ACCESS/EGRESS RESIDENTIAL PROPERTIES SHALL BE MAINTAINED AT ALL TIMES
- 4. DETOUR ROUTE LENGTH: 0.54 MILE
- 5. PARK ROAD CLOSE FROM ROUTE 9W TO BATTLEFIELD RD (LENGTH: 0.26 MILE)


- THE CONTRACTOR SHALL COVER CONFLICTING SIGNAGE WITH THICK PLASTIC. REMOVE PRIOR TO END OF STAGE.
- 2. DURING WINTER MORATORIUM, COVER EXCAVATION WITH TEMPORARY ASPHALT AND OPEN ALL
- 3. DURING NON-WORK HOURS, RELOCATE DRUMS TO EDGE OF WORK ZONE AND OPEN TRAFFIC TO PARK ROAD SOUTHBOUND. COVER PARK RD DETOUR SIGN PANELS.
- 4. MINIMUM LANE WIDTHS FOR THRU TRAFFIC ON ROUTE 9W/202 SHALL BE 11'
- 5. PARK ROAD IS A NARROW LOCAL ROAD WITH SEVERAL RESIDENCIES. THE CONTRACTOR SHALL STAGE THEIR CONSTRUCTION ACTIVITIES SO THAT ACCESS TO ALL RESIDENCES AND LOCAL ROADS (GEORGIAN DRIVE AND BATTLEFIELD ROAD), INCLUDING ACCESS TO BIKE WAY, EMERGENCY VEHICLES AND FIRE TRUCKS SHALL BE PROVIDED AT ALL TIMES.

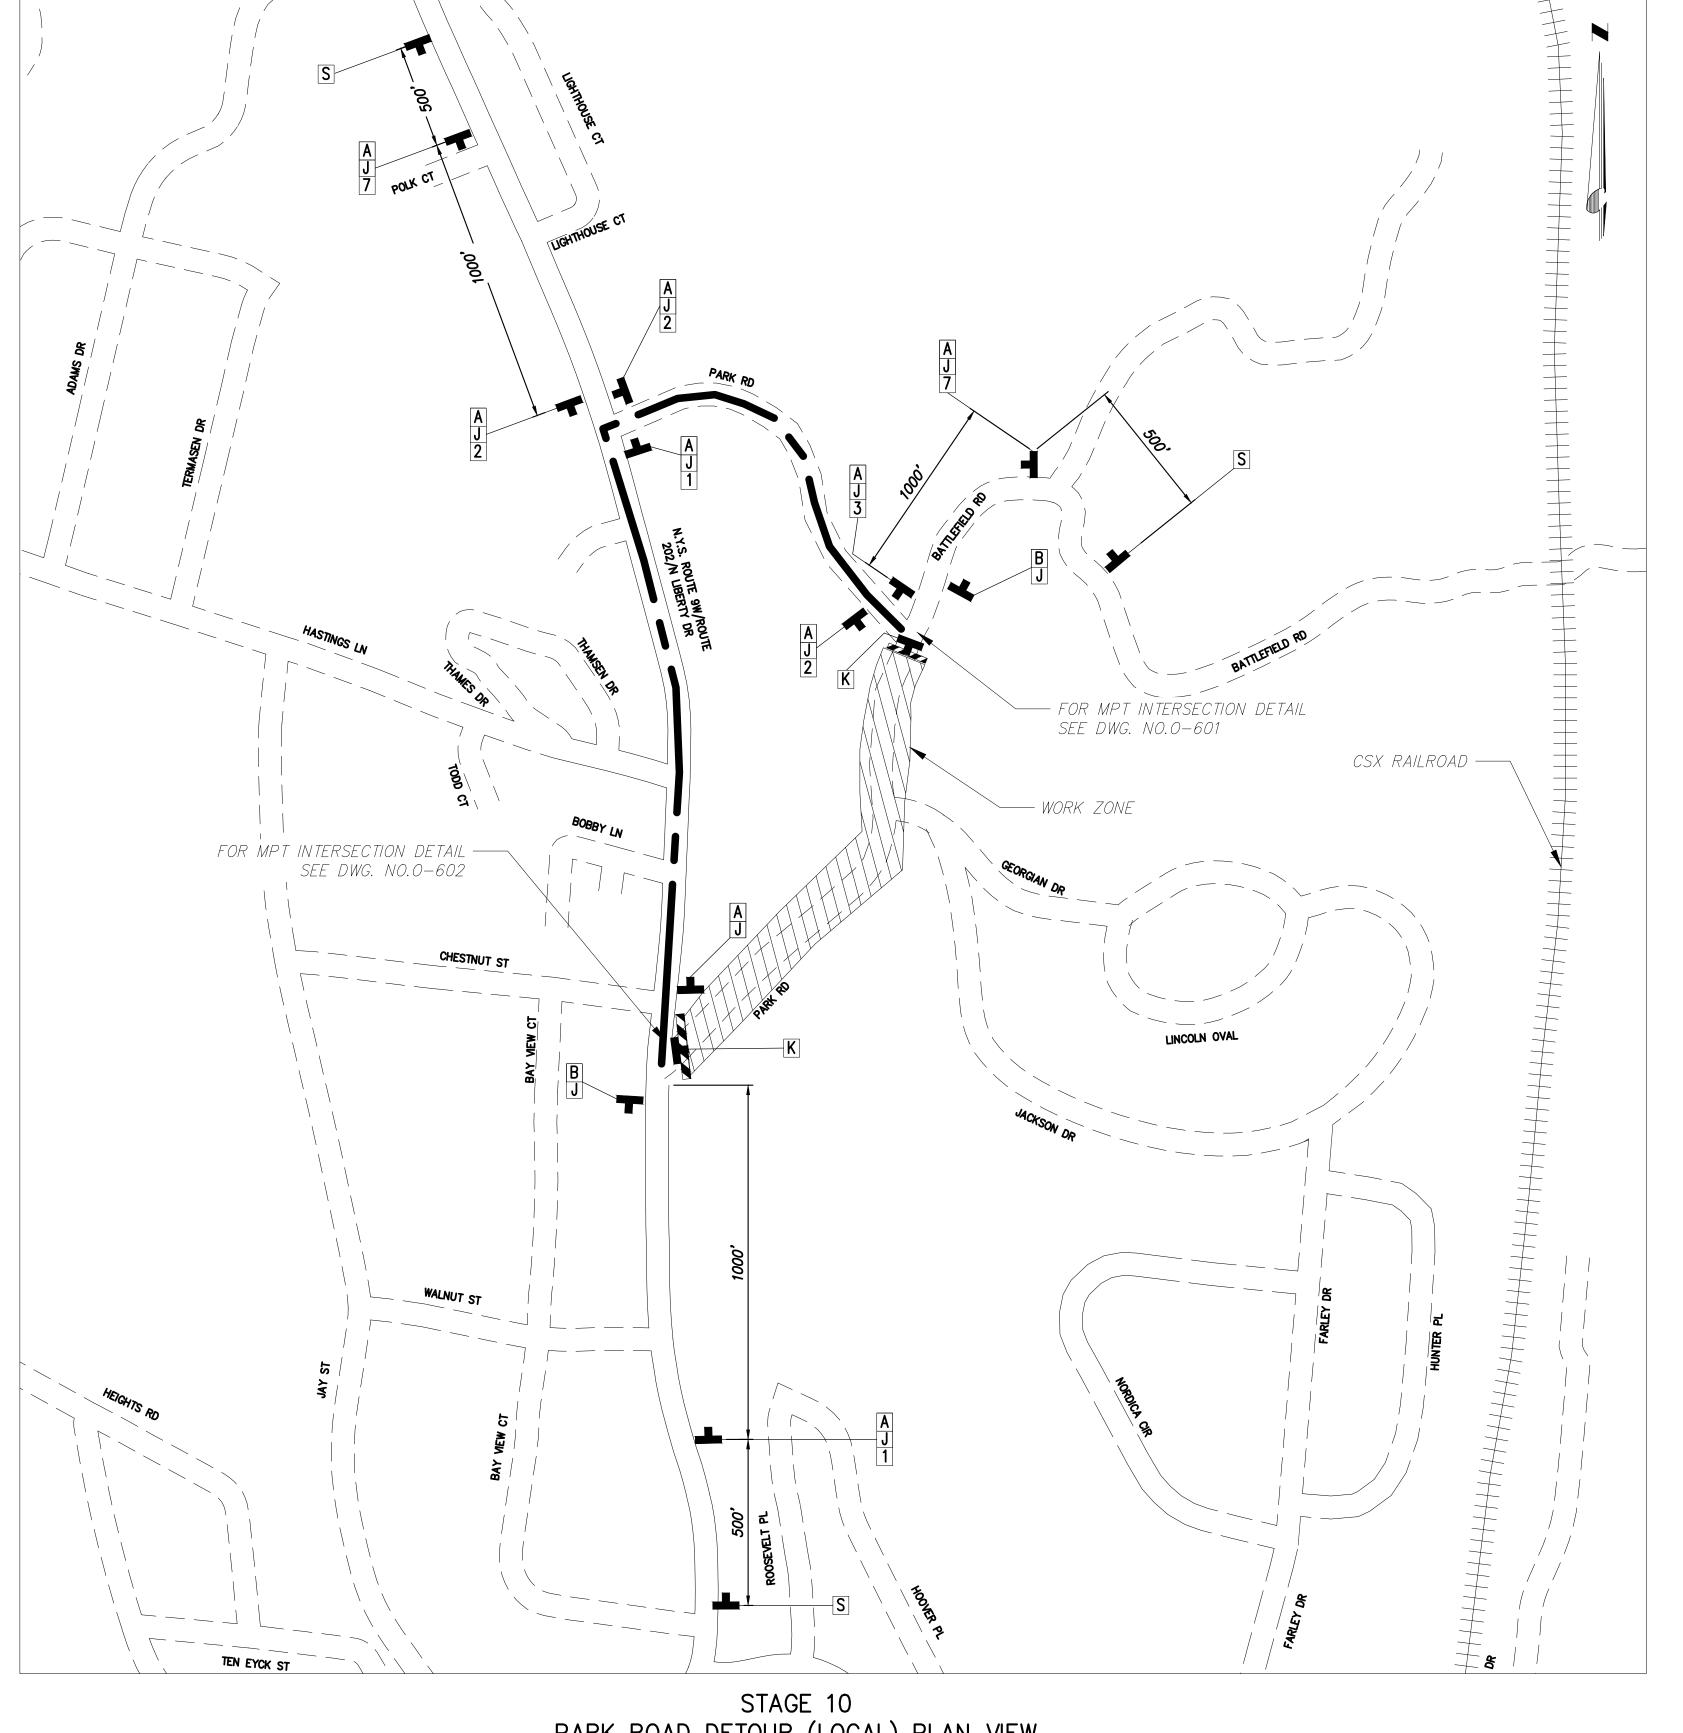

PARK ROAD DETOUR (LOCAL) PLAN VIEW SCALE: NTS





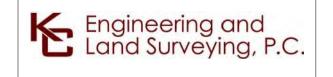

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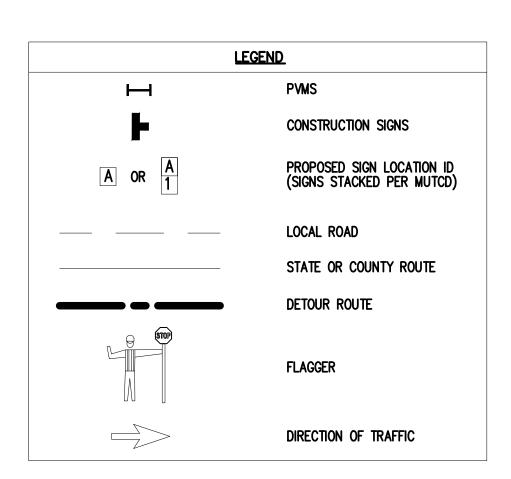
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	D	11/16/2022	DRAFT FINAL SUBMISSION	MS	SB	WORK ZONE TRAFFIC CONTROL
	С	05/20/2022	60% DESIGN SUBMISSION	MS	SB	STAGE 10 DETOUR PLAN
	В	03/23/2022	PRELIMINARY DESIGN DEVELOPMENT	MS	SB	
	Α	02/18/2022	PRELIMINARY PROGRESS	MS	SB	
	No.	DATE	SUBMITTAL / REVISION DESCRIPTION	DB	APP	DRAWN BY: MS DESIGNED BY: MS APPROVED BY: SB SCALE REV. NO.

CHAMPLAIN HUDSON POWER EXPRESS SEGMENT 12 (PACKAGE 7B) - ROUTE 9W: ROCKLAND WORK ZONE TRAFFIC CONTROL STAGE 10 DETOUR PLAN

KIEWIT PROJECT NO. 21162 KC PROJECT NO. 120174 DRAWING NO. 0-402


XX OF XXX

AS SHOWN DATE



NOTES:

- 1. THE CONTRACTOR SHALL COVER CONFLICTING SIGNAGE WITH PLASTIC. REMOVE PRIOR TO END OF STAGE.
- 2. DETOUR TO BE ACTIVE DURING HDD 127 CONSTRUCTION, SEE DWG. NO. 0-705 & 0-706 FOR WORKZONE DETAILS.
- 3. DURING WINTER MORATORIUM, COVER EXCAVATION WITH TEMPORARY ASPHALT AND OPEN ALL LANES TO TRAFFIC
- 4. MINIMUM LANE WIDTHS FOR THRU TRAFFIC ON ROUTE 9W/202 SHALL BE 11'

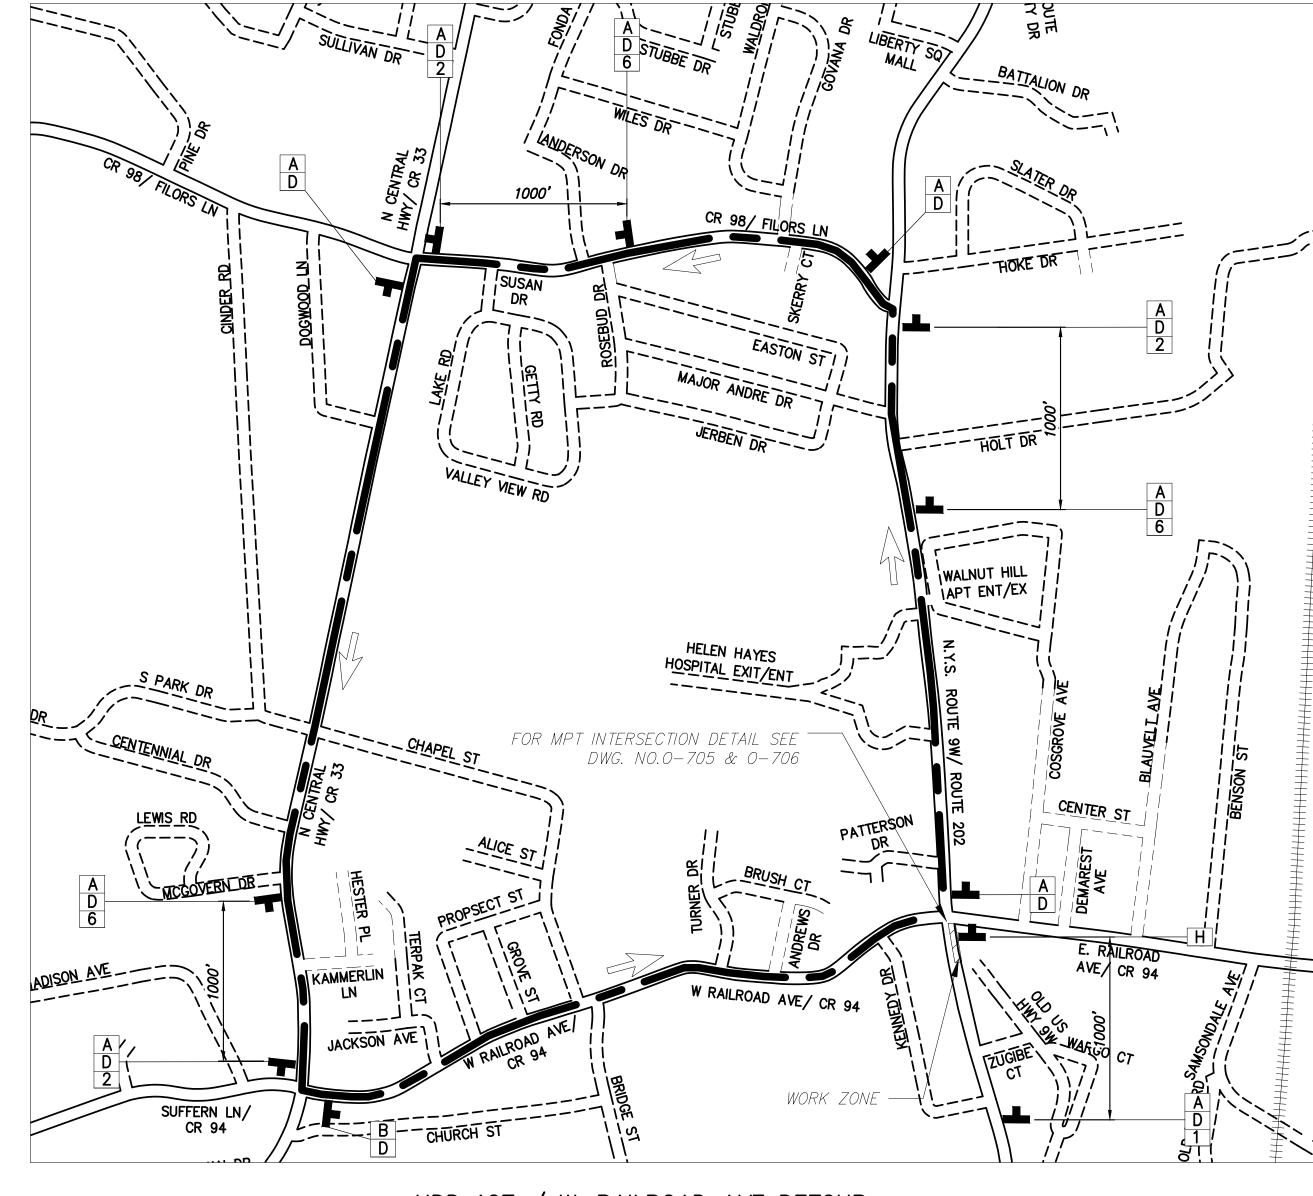

HDD 127 / W. RAILROAD AVE DETOUR


SCALE: N.T.S.

SUMMARY OF TRAFFIC CONTROL:

- 1. WORK ZONE TO BE ACTIVE FOR LONGER THAN 3 DAYS
- 2. DIVERT WB RAILROAD AVE TRAFFIC FROM ROUTE 9W TRAFFIC TO DETOUR.
- 3. ACCESS/EGRESS TO LOCAL COMMERCIAL AND RESIDENTIAL PROPERTIES SHALL BE MAINTAINED AT ALL TIMES.
- 4. DETOUR ROUTE LENGTH: 2.47 MILES.





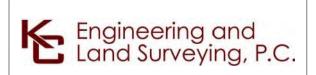

IT IS A VIOLATION OF LAW FOR ANY PERSON, UNLESS THEY
ARE ACTING UNDER THE DIRECTION OF A LICENSED
PROFESSIONAL ENGINEER, ARCHITECT, LANDSCAPE ARCHITECT
OR LAND SURVEYOR TO ALTER AN ITEM IN ANY WAY. IF AN
ITEM BEARING THE STAMP OF A LICENSED PROFESSIONAL IS
ALTERED, THE ALTERING ENGINEER, ARCHITECT, LANDSCAPE
ARCHITECT OR LAND SURVEYOR SHALL STAMP THE DOCUMENT
AND INCLUDE THE NOTATION "ALTERED BY" FOLLOWED BY
THEIR SIGNATURE, THE DATE OF SUCH ALTERATION, AND A
SPECIFIC DESCRIPTION OF THE ALTERATION.

	F	04/14/2023	FINAL SUBMISSION	MS	SB
	Е	03/01/2023	DRAFT FINAL REV 1 SUBMISSION	MS	SB
ISSUED FOR	D	11/16/2022	DRAFT FINAL SUBMISSION	MS	SB
PERMITTING	С	05/20/2022	60% DESIGN SUBMISSION	MS	SB
	В	03/23/2022	PRELIMINARY DESIGN DEVELOPMENT	MS	SB
	Α	02/18/2022	PRELIMINARY PROGRESS	MS	SB
	No.	DATE	SUBMITTAL / REVISION DESCRIPTION	DB	APP

CHAMPLAIN HUDSON POWER EXPRESS	
SEGMENT 12 (PACKAGE 7B) - ROUTE 9W: ROCKLAND	
WORK ZONE TRAFFIC CONTROL	
HDD 127 / RAILROAD AVE DETOUR	

DESIGNED BY: JM APPROVED BY: SB REV. NO.

DRAWN BY:

KIEWIT PROJECT NO. 21162 KC PROJECT NO. 120174 DRAWING NO. 0-403

XX OF XXX

AS SHOWN DATE