

APPENDIX C
CASE 10-T-0189
PLAN AND PROFILES, ESC, MPT

CHAMPLAIN HUDSON POWER EXPRESS

SEGMENT 1 (PACKAGE 1A) - PUTNAM TO DRESDEN

WASHINGTON COUNTY, NEW YORK

FINAL EM&CP SUBMISSION

(SEPTEMBER 21, 2022)



SITE LOCATION MAP
SCALE: 1" = 3000'



NOT FOR CONSTRUCTION
FOR EM&CP PERMIT ONLY



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0	09/21/2022	FINAL EM&CP SUBMISSION				JM	JR		
No.	DATE	SUBMITTAL / REVISION DESCRIPTION				DB	APP		

CHAMPLAIN HUDSON POWER EXPRESS
SEGMENT 1 (PACKAGE 1A) PUTNAM TO DRESDEN
COVER SHEET

DRAWN BY: JJE DESIGNED BY: JTM APPROVED BY: JPR SCALE AS NOTED DATE 09/21/2022
REV. NO. X SH.NO. XXX OF XXX

KIEWIT PROJECT NO.	21162
CHA PROJECT NO.	066076
DRAWING NO.	G-000

File: V:\PROJECTS\ANY\6\066076.000\09_Design\Drawings\01_SHEETS\DESIGN PACKAGE 1A\066076_1A_G-002.DWG Saved: 9/16/2022 3:12:22 PM Plotted: 9/19/2022 3:26:16 PM Current User: Bouillon, Hugo LastSavedBy: 7895

GENERAL NOTES:

1.

THE PLANS SHOW SUBSURFACE STRUCTURES, ABOVE GROUND STRUCTURES AND/OR UTILITIES FROM FIELD LOCATION AND RECORD MAPPING, EXACT LOCATION OF WHICH MAY VARY FROM THE LOCATIONS INDICATED. IN PARTICULAR, THE CONTRACTOR IS WARNED THAT THE EXACT OR EVEN APPROXIMATE LOCATION OF SUCH PIPELINES, SUBSURFACE STRUCTURES AND/OR UTILITIES IN THE AREA MAY BE DIFFERENT FROM THAT SHOWN OR MAY NOT BE SHOWN, AND IT SHALL BE HIS RESPONSIBILITY TO PROCEED WITH GREAT CARE IN EXECUTING ANY WORK. 48 HOURS BEFORE YOU DIG, DRILL, OR BLAST, CALL U.F.P.O. 1-(800)-962-7962 TOLL FREE.
2.

THE ENGINEER SHALL BE NOTIFIED IN WRITING OF ANY CONDITIONS THAT VARY FROM THOSE SHOWN ON THE PLANS. THE CONTRACTOR'S WORK SHALL NOT VARY FROM THE PLANS WITHOUT THE EXPRESSED APPROVAL OF THE ENGINEER. CHANGES TO THE PLAN SHALL BE DONE IN ACCORDANCE WITH THE EM&CP SECTION 3.2.6.
3.

THE CONTRACTOR SHALL RESTORE LAWNS, DRIVEWAYS, CULVERTS, SIGNS AND OTHER PUBLIC OR PRIVATE PROPERTY DAMAGED OR REMOVED TO AT LEAST AS GOOD A CONDITION AS BEFORE BEING DISTURBED AS DETERMINED BY THE ENGINEER.
4.

THE CONTRACTOR AND/OR CERTIFICATE HOLDER SHALL BE RESPONSIBLE FOR OBTAINING AND INCURRING THE COST OF ALL CONSTRUCTION PERMITS, INSPECTIONS, CERTIFICATES, ETC. AND SHALL COMPLY WITH ALL REQUIRED PERMITS.
5.

ALL WORK SHALL BE DONE IN STRICT COMPLIANCE WITH ALL APPLICABLE NATIONAL, STATE, AND LOCAL CODES, STANDARDS, ORDINANCES, RULES, AND REGULATIONS.
6.

ALL PROPOSED UTILITIES AND APPURTENANCES TO BE CONSTRUCTED IN COMPLIANCE WITH THE LOCAL MUNICIPALITIES' CODES AND REGULATIONS GOVERNING THE INSTALLATION OF SUCH UTILITIES.
7.

THE ENGINEER RESERVES THE RIGHT TO EXAMINE ANY WORK DONE ON THIS PROJECT AT ANY TIME TO DETERMINE THE CONFORMANCE WITH THE REQUIREMENTS OF THE CONTRACT DOCUMENTS OF THIS PROJECT.
8.

THE CONTRACTOR SHALL PROTECT EXISTING PROPERTY LINE MONUMENTATION. ANY MONUMENTATION DISTURBED OR DESTROYED, AS JUDGED BY THE ENGINEER OR OWNER, SHALL BE REPLACED AT THE CONTRACTOR'S EXPENSE UNDER THE SUPERVISION OF A NEW YORK STATE LICENSED LAND SURVEYOR.
9.

IT IS THE CONTRACTOR'S RESPONSIBILITY TO EXAMINE ALL PLAN SHEETS.
10.

THE CONTRACTOR SHALL:

A.

VERIFY ALL CONDITIONS IN THE FIELD PRIOR TO COMMENCEMENT OF WORK AND NOTIFY THE ENGINEER OF ANY DISCREPANCIES.

B.

EXAMINE THE SITE AND INCLUDE IN HIS WORK THE EFFECT OF ALL EXISTING CONDITIONS ON THE WORK.

C.

PROVIDE AND INSTALL ALL MATERIALS AND PERFORM ALL WORK IN ACCORDANCE WITH RECOGNIZED GOOD STANDARD PRACTICE.
11.

ALL TRENCH EXCAVATION AND ANY REQUIRED SHEETING AND SHORING SHALL BE DONE IN ACCORDANCE WITH THE LATEST REVISIONS OF NEW YORK STATE INDUSTRIAL CODE RULE 23 AND OSHA REGULATIONS FOR CONSTRUCTION. SHEET PILING SHALL BE DESIGNED AND SEALED BY A NEW YORK STATE PROFESSIONAL ENGINEER. WHERE WITHIN RAIL ROAD ROW, ANY EXCAVATION AND SHORING SHALL BE DESIGNED TO MINIMUM CP AND AREMA REQUIREMENTS.
12.

CONTRACTOR SHALL BE RESPONSIBLE FOR DEWATERING AND THE MAINTENANCE OF SURFACE DRAINAGE DURING THE COURSE OF WORK IN CONFORMANCE WITH REFERENCE SECTION 4.3.2 DEWATERING METHODS IN THE EM&CP. CONTRACTOR SHALL MAINTAIN EXISTING SITE DRAINAGE PATTERNS THROUGHOUT CONSTRUCTION UNLESS OTHERWISE SHOWN ON THE PLANS.
13.

MAINTAIN FLOW FOR ALL EXISTING UTILITIES.
14.

ALL FRAMES AND COVER TO BE SET AT ELEVATIONS CONSISTENT WITH THE PROJECT DETAILS.
15.

TEMPORARY PAVEMENT SHALL BE PLACED WITHIN 48 HOURS OF COMPLETION OF BACKFILL OPERATIONS WITHIN THE EXISTING PAVEMENT LIMITS.
16.

CONTRACTOR SHALL MAINTAIN ALL TRAFFIC IN ALL AREAS IN ACCORDANCE WITH THE NYSDOT MANUAL OF UNIFORM TRAFFIC CONTROL DEVICES.
17.

ALL EXCAVATIONS SHALL BE PROTECTED AT THE END OF EACH WORK DAY PER OSHA AND NYSDOT REQUIREMENTS.
18.

WITHIN NYSDOT ROW ALL OPEN EXCAVATIONS TO BE PROTECTED BY CONCRETE BARRIERS OR BE COVERED BY A STEEL PLATE, 3/4" THICK MINIMUM. A SINGLE PLATE SHOULD COVER THE ENTIRE EXCAVATION AND HAVE ENOUGH BEARING ON SURROUNDING SURFACES TO SUPPORT A VEHICLE.
19.

CONTRACTOR SHALL TAKE CARE TO PREVENT DAMAGE TO EXISTING UTILITIES. UTILITIES DAMAGED BY CONTRACTOR SHALL BE IMMEDIATELY REPAIRED BY CONTRACTOR AT THE CONTRACTOR'S EXPENSE. IF DURING EXCAVATION PREVIOUSLY DAMAGED UTILITIES ARE UNCOVERED, CONTRACTOR SHALL DOCUMENT THE DAMAGE AND REPORT DAMAGE TO THE APPROPRIATE OWNER.
20.

DEPTH OF BURY FOR EXISTING CABLED UTILITIES FIBER / ELECTRICAL / TELECOM AND WATERLINES UNKNOWN. ASSUMED DEPTH OF BURY FOR CABLED UTILITIES IS 30" UNLESS OTHERWISE SHOWN. ASSUMED DEPTH OF BURY FOR WATERLINES IS 5' UNLESS OTHERWISE SHOWN.
21.

CONTRACTOR TO COORDINATE ALL DRIVEWAY CROSSINGS WITH THE PROPERTY OWNERS PRIOR TO EXCAVATING. ACCESS TO ALL DRIVEWAYS FOR THE RESIDENTS AND COMMERCIAL PROSPERITIES WILL NEED TO BE MAINTAINED DURING THE PROJECT. ALL EXCAVATIONS IN THE ENTRANCES/DRIVEWAYS WILL NEED TO BE BACKFILLED AT THE END OF EACH WORKDAY, OR STEEL PLATES SHALL BE INSTALLED TO ALLOW ACCESS DURING CONSTRUCTION. REFER TO THE EM&CP FOR EMERGENCY ACCESS MANAGEMENT PLAN.
22.

ALL WORK WITHIN AGRICULTURAL LANDS WILL BE PERFORMED IN COMPLIANCE WITH APPLICABLE NEW YORK STATE DEPARTMENT OF AGRICULTURE AND MARKETS (NYSDAM) GUIDANCE INCLUDING "NYSDAM GUIDELINES FOR CONSTRUCTION MITIGATIONS FOR AGRICULTURAL LANDS IN AGRICULTURAL AREAS". RESTORATION WORK WILL FOLLOW APPLICABLE SECTIONS OF NYSDAM GUIDANCE "FERTILIZING LIME, AND SEEDING RECOMMENDATIONS FOR RESTORATION OF CONSTRUCTION PROJECTS ON FARMLAND IN NYS".
23.

SERVICE CONNECTIONS TO BE FIELD LOCATED PRIOR TO CONSTRUCTION.
24.

REFER TO EM&CP DOCUMENT FOR ADDITIONAL ITEMS FOR ALL GENERAL NOTES.

EROSION CONTROL NOTES

1.

SEE C-400 SERIES OF SHEETS FOR EROSION AND SEDIMENT CONTROL SHEETS.
2.

LAND DISTURBING ACTIVITIES SHALL NOT COMMENCE UNTIL APPROVAL TO DO SO HAS BEEN RECEIVED BY GOVERNING AUTHORITIES.
3.

THE GENERAL CONTRACTOR SHALL STRICTLY ADHERE TO THE STORM WATER POLLUTION PREVENTION PLAN (SWPPP) AND FOLLOW THE EM&CP DOCUMENTS DURING CONSTRUCTION OPERATIONS.
4.

NO LAND CLEARING OR GRADING SHALL BEGIN UNTIL ALL PERIMETER EROSION AND SEDIMENT CONTROL MEASURES HAVE BEEN INSTALLED. (WETLAND PROTECTION FENCE, SILT FENCE AND STABILIZED CONSTRUCTION ENTRANCE)
5.

SITE DISTURBANCE SHALL NOT EXCEED FIVE (5) ACRES OF SOIL AT ANY ONE TIME WITHOUT PRIOR WRITTEN AUTHORIZATION FROM NYSDEC DIVISION OF WATER.
6.

ALL EXPOSED AREAS SHALL BE SEEDED AND MULCHED AS SPECIFIED WITHIN 14 DAYS OF FINAL GRADING. FOR DISTURBED WETLAND AND SENSITIVE AREAS, AREA TO BE RESTORED IN ACCORDANCE WITH THE EM&CP SECTIONS 8.1 AND 13.
7.

INACTIVE PORTIONS OF THE SITE ARE TO BE SEEDED AND MULCHED AS SPECIFIED WITHIN 14 DAYS. FOR DISTURBED WETLAND AND SENSITIVE AREAS, AREA TO BE RESTORED IN ACCORDANCE WITH THE EM&CP 8.1 AND 13.
8.

SEDIMENT AND EROSION CONTROL MEASURES SHALL BE INSPECTED AT LEAST ONCE EVERY SEVEN (7) DAYS OR MORE FREQUENTLY IF REQUIRED. ALL MAINTENANCE REQUIRED BY INSPECTION SHALL COMMENCE WITHIN 24 HOURS AND BE COMPLETED WITHIN 48 HOURS OF REPORT.
9.

THIS PLAN SHALL NOT BE CONSIDERED ALL INCLUSIVE AS THE GENERAL CONTRACTOR SHALL TAKE ALL NECESSARY PRECAUTIONS TO PREVENT SOIL SEDIMENT FROM LEAVING THE SITE.
10.

GENERAL CONTRACTOR SHALL COMPLY WITH ALL STATE AND LOCAL ORDINANCES THAT APPLY.
11.

ADDITIONAL EROSION AND SEDIMENT CONTROL MEASURES WILL BE INSTALLED IF DEEMED NECESSARY FOLLOWING SITE INSPECTION. THE SWPPP AND/OR ENVIRONMENTAL INSPECTOR HAS THE AUTHORITY TO REQUIRE ADDITIONAL EROSION CONTROL MEASURES IF THE INSPECTOR DEEMS NECESSARY.
12.

GENERAL CONTRACTOR SHALL BE RESPONSIBLE TO TAKE REASONABLE MEANS NECESSARY TO ESTABLISH PERMANENT SOIL STABILIZATION.
13.

AT THE END OF EACH WORK DAY DISTURBED SOILS ARE TO BE REGRADED TO DRAIN INTO THE TEMPORARY DIVERSION SWALES AND DISCHARGES FROM DEWATERING ACTIVITIES ARE TO BE DIRECTED INTO CATCH BASINS OR SWALES.
14.

CONCRETE WASHOUTS DEPICTED ON PLANS ARE FOR REFERENCE ONLY. CONTRACTOR TO FIELD LOCATE WASHOUTS AS NECESSARY. FIELD LOCATED WASHOUTS SHALL BE CONSTRUCTED IN ACCORDANCE WITH THE EM&CP AND SHALL BE A MINIMUM OF 100' FROM ADJACENT WETLANDS AND 200' FROM ANY EXISTING WELLS.

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No.	DATE	SUBMITTAL / REVISION DESCRIPTION	DB	APP	

CHAMPLAIN HUDSON POWER EXPRESS
SEGMENT 1 (PACKAGE 1A) PUTNAM TO DRESDEN
GENERAL NOTES

DRAWN BY: JJE DESIGNED BY: JTM APPROVED BY: JPR SCALE AS NOTED REV. NO. X

KIEWIT PROJECT NO.	21162
CHA PROJECT NO.	066076
DRAWING NO.	G-002
DATE	09/21/2022
SH.NO.	XXX OF XXX



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NYSDOT NOTES

1. MAINTAIN EXISTING GUIDE RAIL, MEDIAN BARRIER, AND BRIDGE RAIL WHEN CONSTRUCTION OPERATIONS REQUIRE THE TEMPORARY REMOVAL OF EXISTING BRIDGE RAIL, GUIDE RAIL OR MEDIAN BARRIER; OR WHEN EXISTING RAIL WILL BE REMOVED AND REPLACED WITH NEW RAIL, THE CONTRACTOR SHALL SCHEDULE OPERATIONS TO MINIMIZE THE TIME PERIOD THAT RAIL IS NOT INSTALLED.
2. UNLESS OTHERWISE SPECIFIED IN THE CONTRACT DOCUMENTS, GUIDE RAIL OR MEDIAN BARRIER SHALL BE REPLACED OR THE LOCATION OTHERWISE PROTECTED WITHIN 14 CALENDAR DAYS. BRIDGE RAIL SYSTEMS SHALL BE MAINTAINED IN SERVICE AT ALL TIMES ON ANY STRUCTURE ON WHICH VEHICLE OR PEDESTRIAN TRAFFIC IS MAINTAINED, UNLESS A TEMPORARY BARRIER IS INSTALLED, OR OTHER MEANS ARE USED TO ENSURE THAT VEHICLES, BICYCLISTS AND PEDESTRIANS ARE NOT EXPOSED TO THE UNPROTECTED EDGE OF A BRIDGE.
3. DURING NON-WORK HOURS WHEN TRAFFIC IS BEING MAINTAINED ON THE FACILITY, ALL TEMPORARY ENDS (FREE ENDS) OF GUIDE RAIL, MEDIAN BARRIER AND BRIDGE RAIL SHALL BE TEMPORARILY TERMINATED AND MARKED WITH A CHANNELIZING DRUM OR OBJECT MARKER EQUIPPED WITH A TYPE A FLASHING WARNING LIGHT. CORRUGATED BEAM GUIDE RAIL AND MEDIAN BARRIER, AND HEAVY-POST, BLOCKED-OUT, CORRUGATED BEAM GUIDE RAIL AND MEDIAN BARRIER SHALL BE TEMPORARILY TERMINATED BY HAVING THE EXPOSED ENDS (FREE ENDS) DROPPED TO THE GROUND AND PINNED.
4. THE APPROACH ENDS OF BOX BEAM GUIDE RAIL, MEDIAN BARRIER AND BRIDGE RAIL SHALL BE TEMPORARILY TERMINATED WITH BOX BEAM GUIDE RAIL END ASSEMBLIES UTILIZING TWO SPLICE PLATES AND THE PROPER NUMBER OF BOLTS PER CONNECTION. NO POSTS FOR ANCHORAGES WILL BE REQUIRED. SPECIAL TEMPORARY SPLICE PLATES ARE REQUIRED TO ADAPT BOX BEAM GUIDE RAIL END ASSEMBLIES TO BOX BEAM MEDIAN BARRIERS.
5. DURING ANY OVERNIGHT PERIOD WHEN EXISTING GUIDE RAIL OR MEDIAN BARRIER IS TEMPORARILY REMOVED, THE CONTRACTOR SHALL INSTALL CHANNELIZING DEVICES IN THE LOCATION WHERE THE GUIDE RAIL OR MEDIAN BARRIER WAS REMOVED IN ACCORDANCE WITH §619-3.02J.6. REMOVED EXISTING GUIDE RAIL OR MEDIAN BARRIER.
6. GUIDERAIL REPLACEMENT TYPE TO BE COORDINATED WITH NYSDOT.
7. THE PLANS DEPICT AREAS OF EXPANDED LIMIT OF WORK AT EXISTING CULVERTS THAT WILL BE EVALUATED WITH NYSDOT AND THE CERTIFICATE HOLDERS FOR POTENTIAL REPLACEMENT OR REPAIR. IF ANY REPAIRS OR REPLACEMENTS ARE DETERMINED, THE WORK WILL BE DONE IN ACCORDANCE WITH NYSDOT SPECIFICATIONS.

DISTURBANCE NOTE:

1. THE PROPOSED DISTURBANCE FOR THE TRENCH DETAIL WILL BE LIMITED TO THE WIDTH OF THE TRENCH SECTIONS DEPICTED ON C-621.
2. AREAS OF THE LIMIT OF WORK ACROSS THE ALIGNMENT HAVE BEEN EXPANDED TO INCLUDE AREAS OFF THE ROADWAY WITHIN LAWN AREAS THAT ARE SUITABLE FOR POTENTIAL TEMPORARY STAGING AREAS DURING CONSTRUCTION. SHOULD THESE AREAS BE UTILIZED AND DISTURBED THE AREAS SHOULD BE RESTORED TO EXISTING CONDITION PER THE PROJECT RESTORATION NOTES AND DETAILS. EROSION AND SEDIMENT CONTROL MEASURES HAVE BEEN DEVELOPED TO INCORPORATE THESE POTENTIALLY DISTURBED AREAS.

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CHAMPLAIN HUDSON POWER EXPRESS
SEGMENT 1 (PACKAGE 1A) PUTNAM TO DRESDEN
PACKAGE SPECIFIC NOTES

DRAWN BY: JJE DESIGNED BY: JTM APPROVED BY: JPR SCALE AS NOTED
REV. NO. X

KIEWIT PROJECT NO.	21162
CHA PROJECT NO.	066076
DRAWING NO.	G-003
DATE	09/21/2022
SH.NO.	XXX OF XXX



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1

2

3

4

LEGEND & ABBREVIATIONS

- HH EXIST. FIBER OPTIC LINE HANDHOLE
- P EXIST. FIBER OPTIC LINE PEDESTAL
- DH EXIST. FIBER OPTIC LINE DOGHOUSE
- MH EXIST. FIBER OPTIC LINE MANHOLE
- V EXIST. FIBER OPTIC LINE VAULT
- BP EXIST. FIBER OPTIC LINE BORE PIT
- LB EXIST. FIBER OPTIC LOCK BOX
- EXIST. GROUND ROD
- EXIST. FIBER OPTIC MARKER POST
- EXIST. FIBER STORAGE
- EXIST. FIRE HYDRANT
- EXIST. WATER VALVE
- EXIST. WATER MANHOLE
- EXIST. WATER MARKER
- EXIST. SANITARY SEWER MANHOLE
- EXIST. SANITARY SEWER VENT
- EXIST. STORM SEWER MANHOLE
- EXIST. STORM SEWER CATCH BASIN
- EXIST. CULVERT INVERT
- EXIST. GAS MANHOLE
- EXIST. GAS VALVE
- EXIST. GAS MARKER
- EXIST. GAS PIPELINE VENT
- EXIST. LIGHT POLE
- EXIST. UTILITY POLE
- EXIST. ELEC. POLE
- EXIST. TRAFFIC LIGHT
- EXIST. ELEC. METER
- EXIST. ELEC. MANHOLE
- EXIST. ELEC. TRANSFORMER
- EXIST. ELEC. VAULT
- EXIST. ELEC. HANDHOLE
- EXIST. ELEC. PEDESTAL/BOX
- EXIST. ELEC. MARKER POST
- EXIST. ELEC. GUY ANCHOR/WIRE
- EXIST. TELE. RISER/BOX
- EXIST. TELE. MANHOLE
- EXIST. TELE. HANDHOLE
- EXIST. TELE. VAULT
- EXIST. TELE. PEDESTAL
- EXIST. TELE. DOGHOUSE
- EXIST. TELE. MARKER POST
- EXIST. TELE. JUNCTION BOX
- EXIST. TRAFFIC SIGNAL BOX
- EXIST. CELL TOWER
- EXIST. CABLE BOX
- EXISTING MANHOLE UNKNOWN
- EXISTING UTILITY BOX UNKNOWN
- EXISTING ANTENNA
- EXISTING CAPPED IRON ROD
- EXISTING IRON PIPE
- EXISTING CONCRETE MONUMENT
- EXISTING POST
- EXISTING REFLECTOR MARKER
- EXISTING SYMBOL

- SIGN
- EXIST. STRUCTURE POST
- EXIST. STRUCTURE MAILBOX
- EXIST. WETLAND FLAG
- EXIST. GAS LINE
- EXIST. UNDERGROUND TELE.
- EXIST. FIBER OPTIC
- EXIST. OVERHEAD TELE.
- EXIST. UNDERGROUND ELEC.
- EXIST. OVERHEAD ELEC.
- EXIST. CULVERT
- EXIST. SANITARY SEWER
- EXIST. STORM SEWER
- EXIST. POTABLE WATER LINE
- EXIST. RAILROAD TRACK
- EXIST. WETLANDS
- CERTIFIED ROUTE PROVIDED BY CHPE KMZ
- EXIST. CONTOUR, INDEX
- EXIST. CONTOUR, DEPRESSION INDEX
- EXIST. CONTOUR, INTERMEDIATE
- EXIST. CONTOUR, DEPRESSION INTERMEDIATE
- EXIST. SPOT ELEVATION
- EXIST. CULTURAL DEBRIS
- EXIST. CULTURAL FIELD LINE
- EXIST. CULTURAL LANDSCAPE AREA
- EXIST. CULTURAL PILE
- EXIST. CULTURAL STORAGE AREA
- EXIST. HYDROGRAPHIC
- EXIST. CULVERT
- EXIST. INUNDATED AREA
- EXIST. RIP-RAP
- EXIST. STREAM
- EXIST. SWAMP
- WATER LEVEL
- EXIST. NATURAL BOULDER
- EXIST. NATURAL SHRUB LINE
- EXIST. NATURAL TREE LINE
- EXIST. NATURAL SINGLE TREE/BUSH
- EXIST. STRUCTURAL BUILDING
- EXIST. PAVED DRIVE
- EXIST. PAVED ROAD
- EXIST. PAVED SHOULDER
- EXIST. PAVED SIDEWALK
- EXIST. GUARDRAIL
- EXIST. RAILROAD
- EXIST. TRAIL
- EXIST. FENCE
- EXIST. WALL
- EXIST. RETAINING WALL
- EXIST. MILEPOST NUMBER
- EXIST. MAPPING BOUNDARY
- EXIST. GROUND CONTROL
- PROP. RIGHT-OF-WAY
- PROP. ABUTTER

- EXISTING SIGN
- EXIST. STRUCTURE POST
- EXIST. STRUCTURE MAILBOX
- EXIST. WETLAND FLAG
- EXIST. GAS LINE
- EXIST. UNDERGROUND TELE.
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- PROP. ABUTTER

- PEM – PALUSTRINE EMERGENT
- PSS – PALUSTRINE SCRUB-SHRUB
- PFO – PALUSTRINE FORESTED
- PUB – PALUSTRINE UNCONSOLIDATED BOTTOM
- L1 – LACUSTRINE LIMNETIC
- L2 – LACUSTRINE LITTORAL
- NYSDEC FWW 100-FOOT ADJACENT BUFFER AREA
- GIS – WETLAND
- JD BOUNDARY
- PROP. WETLAND PROTECTION FENCE
- PROP. COMPOST FILTER SOCK (OR SILT SOCK)
- PROP. LIMITS OF WORK/DISTURBANCE
- PROP. LIMITS OF CLEARING/LIMITS OF WORK IN CLEARING AREAS (SEE NOTE 1)
- PROP. CONCRETE WASHOUT
- PROP. ACCESS ROAD ROUTE (EXISTING ROAD OR SURFACE)
- PROP. REFURBISHED ACCESS ROAD
- PROP. ACCESS ROAD OR OFF SITE ACCESS ROAD
- PROP. TIMBER MATTING ACCESS ROAD
- PROP. SPLICE LOCATION
- PROP. SPLICE VAULT
- PROP. LINK BOX HANDHOLE
- PROP. FIBER SPLICE HANDHOLE
- PROP. BORING LOCATION
- PROP. ALIGNMENT STATIONING
- PROP. RIGHT-OF-WAY
- PROP. ABUTTER
- PROP. ALIGNMENT CENTERLINE
- PROP. TEMPORARY EASEMENT
- PROP. PERMANENT EASEMENT
- PROP. TEMPORARY ACCESS EASEMENT
- APPROXIMATE SNOWMOBILE TRAIL LOCATION

NOTES:

- 1. LIMIT OF WORK (LOW) – THE BOUNDARY IN WHICH ALL CONSTRUCTION ACTIVITIES, STOCKPILE MATERIALS, EQUIPMENT STORAGE, ACCESS, PARKING, GRADING, LANDSCAPING, RESTORATION, AND ANY OTHER CONSTRUCTION RELATED ACTIVITIES SHALL OCCUR. ADDITIONALLY, THE LOW IS THE BOUNDARY FOR ALL POTENTIAL DISTURBANCE DURING CONSTRUCTION. UNLESS OTHERWISE SPECIFIED, WHEN THE LIMIT OF CLEARING AND GRUBBING IS SHOWN ON THE PLANS, IT SHALL ALSO BE THE LOW. THE LOW INCLUDES THE AREA THAT WOULD BE CONSIDERED THE LIMIT OF DISTURBANCE (LOD).

- APP APPROVED
- CL CENTERLINE
- CMP CORRUGATED METAL PIPE
- CONC CONCRETE
- DB DESIGNED BY
- DEC NEW YORK STATE DEPARTMENT OF ENVIRONMENTAL CONSERVATION
- DEG DEGREES
- DR DRIVE
- DZ DEVIATION ZONE
- E EASTING
- ELECTRIC ELECTRIC CABLE
- ELEV ELEVATION
- FIBER FIBER OPTIC CABLE
- FT FEET
- GAS GAS PIPE
- H HORIZONTAL
- HDD HORIZONTAL DIRECTIONAL DRILLING
- HVDC HIGH-VOLTAGE DIRECT CURRENT TRANSMISSION LINE
- INV INVERT ELEVATION
- LOW LIMITS OF WORK
- MAX MAXIMUM
- MIN MINIMUM
- N NORTHING
- NO NUMBER
- NY NEW YORK
- P# PACKAGE #
- PVC POLYVINYL CHLORIDE
- PVI POINT OF VERTICAL INTERSECTION
- R RADIUS
- RCP REINFORCED CONCRETE PIPE
- RD ROAD
- REV REVISION
- ROW RIGHT-OF-WAY
- RTE ROUTE
- SEWER SANITARY SEWER PIPE
- SH SHEET
- ST STREET
- STA STATION
- STORM STORM DRAIN PIPE
- TELECOM TELECOMMUNICATIONS CABLE
- TEMP TEMPORARY
- TR THERMAL RESISTIVITY
- TYP TYPICAL
- V VERTICAL
- WATER WATERLINE

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0	09/21/2022	FINAL EM&CP SUBMISSION	JM	JR	
No.	DATE	SUBMITTAL / REVISION DESCRIPTION	DB	APP	

CHAMPLAIN HUDSON POWER EXPRESS
SEGMENT 1 (PACKAGE 1A) PUTNAM TO DRESDEN
LEGEND AND ABBREVIATIONS

DRAWN BY: JJE DESIGNED BY: JTM APPROVED BY: JPR SCALE AS NOTED X SH.NO. XXX OF XXX

KIEWIT PROJECT NO.	21162
CHA PROJECT NO.	066076
DRAWING NO.	G-004
DATE	09/21/2022
SH.NO.	XXX OF XXX

File: V:\PROJECTS\ANY\6\066076.000\09_Design\Drawings\01_Sheets\Design Package 1A\066076_1A_G-005.DWG Saved: 9/18/2022 3:29:13 PM Current User: Bouillon, Hugo LastSavedBy: 7895

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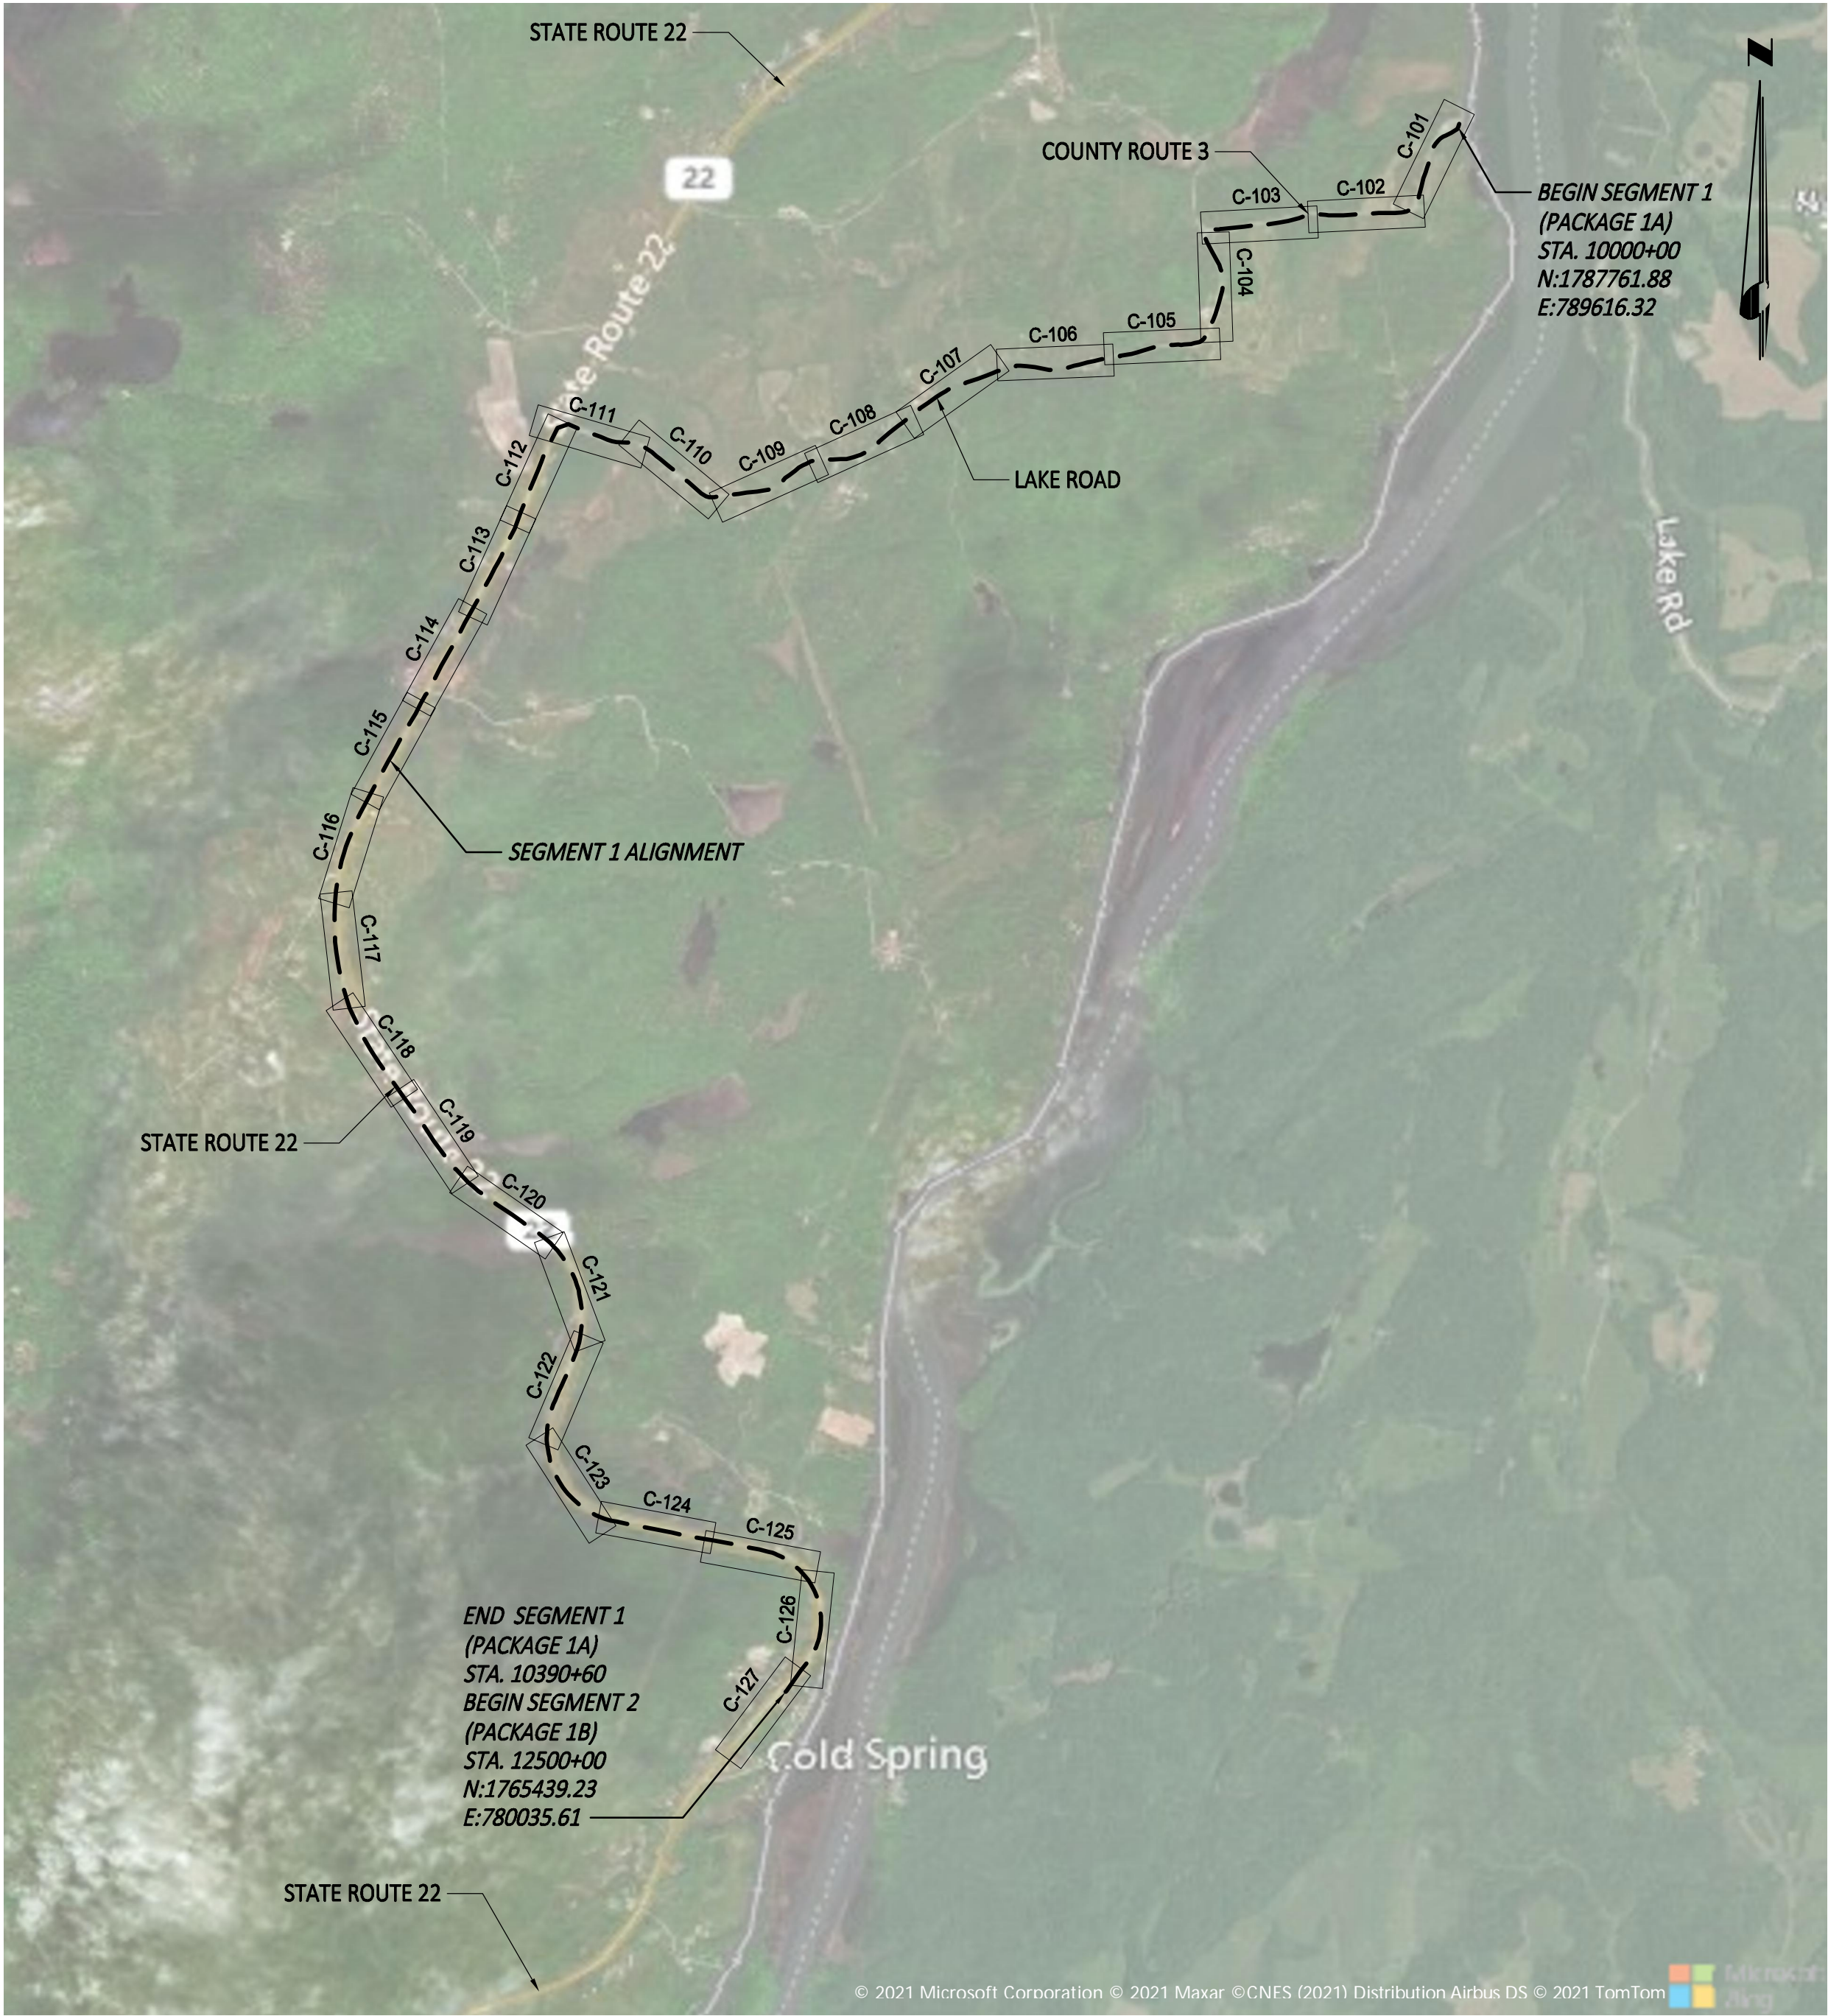
0	09/21/2022	FINAL EM&CP SUBMISSION	JM	JR	
No.	DATE	SUBMITTAL / REVISION DESCRIPTION	DB	APP	

CHAMPLAIN HUDSON POWER EXPRESS
SEGMENT 1 (PACKAGE 1A) PUTNAM TO DRESDEN
KEYPLAN

DRAWN BY: JJE DESIGNED BY: JTM APPROVED BY: JPR SCALE AS NOTED
REV. NO. X

KIEWIT PROJECT NO.	21162
CHA PROJECT NO.	066076
DRAWING NO.	G-005
DATE	09/21/2022
X SH.NO.	XXX OF XXX

Structure Table				
Structure Name	Station	Northing	Easting	Finished Grade
SPLICE VAULT 007	10206+28.77	1779438.15	774817.33	RIM = 287.51
SPLICE VAULT 008	10236+13.74	1776726.94	773638.62	RIM = 426.50
SPLICE VAULT 009	10262+38.28	1774246.93	774320.37	RIM = 418.54
SPLICE VAULT 010	10294+56.47	1771925.62	776498.30	RIM = 550.80
SPLICE VAULT 011	10324+78.45	1769230.42	776677.38	RIM = 355.16
SPLICE VAULT 012	10357+23.46	1767631.02	779037.26	RIM = 133.36
SPLICE VAULT 013	10388+73.43	1765562.50	780173.87	RIM = 141.20



PLAN AND PROFILE KEY MAP
SCALE: 1" = 2000'

TABLE 7.1: SEGMENT 1 – TREE AND VEGETATION CLEARING LOCATIONS		
DESCRIPTION	LOCATION (APPROXIMATE – SEE DRAWINGS FOR DETAILS)	TREE & VEGETATION CLEARING METHOD TYPE
TREE CLEARING AND VEGETATION CLEARING. TREE REMOVAL ANTICIPATED.	NEAR 10000+00 (C–101)	TYPE I AND TYPE II. WITHIN APA BOUNDARY SEE SECTION 7.1.4 FOR STANDARDS AND SPECIFICATIONS FOR CLEARING IN ADIRONDACK PARK.
TREE TRIMMING AND VEGETATION CLEARING. NO TREE REMOVAL ANTICIPATED.	10032+50 TO 10033+25 (C–103)	TYPE I AND TYPE II WITHIN APA BOUNDARY. SEE SECTION 7.1.4 FOR STANDARDS AND SPECIFICATIONS FOR CLEARING IN ADIRONDACK PARK
TREE TRIMMING AND VEGETATION CLEARING. NO TREE REMOVAL ANTICIPATED.	10046+50 TO 10054+00, 10056+20 TO 10056+50 (C–104)	TYPE I AND TYPE II. WITHIN APA BOUNDARY.
TREE TRIMMING AND VEGETATION CLEARING. NO TREE REMOVAL ANTICIPATED.	10063+00 TO 10075+00, 10069+00 TO 10070+11, 10070+50 TO 10072+75, 10073+00 TO 10074+16 (C–105)	TYPE I AND TYPE II. WITHIN APA BOUNDARY.
TREE TRIMMING AND VEGETATION CLEARING. NO TREE REMOVAL ANTICIPATED.	10075+00 TO 10090+00, 10076+00 TO 10077+15, 10077+50 TO 10078+00, 10079+00 TO 10079+50, 10079+75 TO 10081+25, 10081+50 TO 10083+50, 10082+75 TO 10083+25, 10083+50 TO 10083+75, 10084+25 TO 10085+00, 10086+00 TO 10086+25, 10086+50 TO 10088+00, 10088+75 TO 10090+00 (C–106)	TYPE I AND TYPE II. WITHIN APA BOUNDARY.
TREE TRIMMING AND VEGETATION CLEARING. NO TREE REMOVAL ANTICIPATED.	10090+00 TO 10105+00, 10090+06 TO 10090+25, 10091+00 TO 10091+50, 10091+75 TO 10092+25, 10092+75, 10096+25 TO 10097+50, 10098+25 TO 10100+50, 10102+00 TO 10103+25, 10103+50 TO 10105+00 (C–107)	TYPE I AND TYPE II. WITHIN APA BOUNDARY.
TREE TRIMMING AND VEGETATION CLEARING. NO TREE REMOVAL ANTICIPATED.	10105+00 TO 10120+00, 10105+00 TO 10105+75, 10106+00 TO 10106+25, 10106+50 TO 10109+00, 10110+00 TO 10113+75, 10115+00 TO 10116+25, 10117+25 TO 10117+50, 10117+75 TO 10118+00, 10118+25 TO 10119+25, 10119+75 TO 10120+00 (C–108)	TYPE I AND TYPE II. WITHIN APA BOUNDARY.
TREE TRIMMING AND VEGETATION CLEARING. NO TREE REMOVAL ANTICIPATED.	10120+00 TO 10121+50, 10120+75 TO 10121+00, 10121+50 TO 10122+25, 10125+25 TO 10128+25, 10128+50 TO 10130+50, 10131+00 TO 10133+75 (C–109)	TYPE I AND TYPE II. WITHIN APA BOUNDARY.
TEMPORARY ACCESS ROAD FOR LAKE ROAD HDD 1. TREE TRIMMING AND VEGETATION CLEARING. NO TREE REMOVAL ANTICIPATED.	10138+25 TO 10138+50 (C–110)	TYPE I AND TYPE II. WITHIN APA BOUNDARY.
TEMPORARY ACCESS ROAD FOR SPLICE LOCATION 007. TREE TRIMMING AND VEGETATION CLEARING. NO TREE REMOVAL ANTICIPATED.	10207+50 TO 10208+50 (C–115)	TYPE I AND TYPE II. WITHIN APA BOUNDARY.
TEMPORARY ACCESS ROAD FOR SPLICE LOCATION 008. TREE TRIMMING AND VEGETATION CLEARING. NO TREE REMOVAL ANTICIPATED.	10235+25 TO 10238+25 (C–117)	TYPE I AND TYPE II. WITHIN APA BOUNDARY.
TEMPORARY ACCESS ROAD FOR SPLICE LOCATION 009. TREE TRIMMING AND VEGETATION CLEARING. NO TREE REMOVAL ANTICIPATED.	10261+00 TO 10264+00 (C–118)	TYPE I AND TYPE II. WITHIN APA BOUNDARY.
TEMPORARY ACCESS ROAD FOR SPLICE LOCATION 010. TREE TRIMMING AND VEGETATION CLEARING. NO TREE REMOVAL ANTICIPATED.	10292+00 (C–120) TO 10296+50 (C–121)	TYPE I AND TYPE II. WITHIN APA BOUNDARY.
TREE TRIMMING AND VEGETATION CLEARING. NO TREE REMOVAL ANTICIPATED.	10331+00 TO 10333+00, 10332+00 TO 10334+00, 10334+50 TO 10335+50, 10337+00 TO 10340+00 (C–123)	TYPE I AND TYPE II. WITHIN APA BOUNDARY.
TREE TRIMMING AND VEGETATION CLEARING. NO TREE REMOVAL ANTICIPATED.	10340+00 TO 10340+75, 10342+00 TO 10344+00, 10345+75 TO 10347+00 (C–124)	TYPE I AND TYPE II. WITHIN APA BOUNDARY.
TREE TRIMMING AND VEGETATION CLEARING. NO TREE REMOVAL ANTICIPATED.	10355+00 TO 10359+00, 10360+50 TO 10362+00, 10363+50 TO 10364+25, 10367+25 TO 10370+00 (C–125)	TYPE I AND TYPE II. WITHIN APA BOUNDARY.
TREE TRIMMING AND VEGETATION CLEARING. NO TREE REMOVAL ANTICIPATED.	10372+50 TO 10373+25 (C–126)	TYPE I AND TYPE II. WITHIN APA BOUNDARY.
TEMPORARY ACCESS ROAD FOR SPLICE LOCATION 013. TREE TRIMMING AND VEGETATION CLEARING. NO TREE REMOVAL ANTICIPATED.	10388+25 TO 10390+25 (C–127)	TYPE I AND TYPE II. WITHIN APA BOUNDARY.

NOTE: THE TABLE ABOVE SUMMARIZES THE LOCATION AND CLEARING TYPE THAT WILL OCCUR WITHIN THIS SEGMENT. SECTION 7.0 OF THE EM&CP SUMMARIZES THE CLEARING METHODS AND PROCEDURES FOR VEGETATION AND TREES.

SEGMENT 1 – TREE AND CLEARING LOCATIONS

TABLE 4.1 – HDD LOCATIONS	
STAGING AREA DESCRIPTION	LOCATION (APPROXIMATE – SEE DRAWINGS FOR DETAILS)
HDD–1 ENTRY AREA	10154+00 (C–111)
HDD–1 EXIT AREA	10145+00 (C–110)

NOTE: SECTION 4.2 AND APPENDIX J OF THE EM&CP SUMMARIZE THE PROCEDURES AND SPECIFICATIONS TO BE FOLLOWED FOR ALL HDD CONSTRUCTION.

SEGMENT 1 – HDD LOCATIONS

TABLE 7.2 SEGMENT 1 – TREE AND VEGETATION CLEARING METHODS		
METHOD TYPE	METHOD TITLE	METHOD DESCRIPTION
TYPE I	HAND CUTTING (HC)	THIS METHOD EMPLOYS A HAND–HELD CHAIN SAW. IT IS SELECTIVE BUT IS SLOWER AND MORE EXPENSIVE THAN MOTORIZED MECHANICAL DEVICES. RESIDENTIAL AREAS, BUFFER ZONES, WETLANDS, AND HIGHWAY SCREENS ARE AREAS WHERE HAND CUTTING IS TYPICALLY PRESCRIBED.
TYPE II	MECHANICAL CLEARING MACHINE (HA)	THIS TERM USUALLY REFERS TO A MACHINE KNOWN AS THE HYDRO–AX OR KERSHAW MOWER. THIS MACHINE CAN CUT TREES UP TO TEN (10) INCHES IN DIAMETER AT THE RATE OF SEVERAL ACRES A DAY, DEPENDING ON STEM DENSITY AND TERRAIN. IT IS ESSENTIALLY NONSELECTIVE AND A GOOD DEVICE FOR CLEARING RIGHTS–OF–WAY THAT ARE COMPOSED OF YOUNG UNDESIRABLE SPECIES IN A RELATIVELY UNIFORM STAND.
TYPE III	MOWING	THIS TECHNIQUE IS PRIMARILY USED IN AREAS OF HERBACEOUS VEGETATION. TERRAIN MUST BE RELATIVELY FLAT WITH NO GULLIES OR ROCKS.
TYPE IV	MECHANICAL WHOLE–TREE FELLING EQUIPMENT	THIS METHOD ALLOWS CONTROLLED FELLING AND LOADING OF WHOLE TREES WHILE MINIMIZING DAMAGE TO ADJACENT TREES. WHERE VEGETATION IS CLEARED, EROSION AND SEDIMENT CONTROL MEASURES WILL BE INSTALLED AND MONITORED UNTIL THE TOPSOIL IS STABILIZED AND CAN SUPPORT GRASSY VEGETATION.

NOTE: THE TABLE ABOVE SUMMARIZES THE CLEARING TYPE THAT WILL OCCUR WITHIN THIS SEGMENT. SECTION 7.0 AND 7.1 OF THE EM&CP SUMMARIZES THE CLEARING METHODS AND PROCEDURES FOR VEGETATION AND TREE CLEARING AND REMOVAL INCLUDING STANDARDS AND SPECIFICATIONS FOR CLEARING IN ENVIRONMENTALLY SENSITIVE AREAS. IF PREVIOUSLY UNIDENTIFIED TREES ARE ENCOUNTERED THAT REQUIRE TRIMMING/CLEARING WITHIN THE APPROVED CLEARING WINDOW AS TO NOT IMPACT THREATENED AND ENDANGERED SPECIES, THEY WILL BE CHIPPED AND SPREAD IF THEY ARE IN UPLAND AREAS OR DISPOSED OF OFF–SITE AT A NYSDEC APPROVED LOCATION (SEE APPENDIX L IN THE EM&CP).

1. WETLANDS: SECTION 7.1.5 AND SECTION 8.1 OF THE EM&CP.
2. STREAM CROSSING: SECTION 7.1.5 AND SECTION 8.1 OF THE EM&CP.
3. THREATENED AND ENDANGERED SPECIES/SENSITIVE HABITATS: SECTION 8.2 OF THE EM&CP.
4. ADIRONDACK PARK: SECTION 7.1.4 OF THE EM&CP.
5. AGRICULTURAL LANDS: SECTION 7.1.6 OF THE EM&CP.

SEGMENT 1 – TREE AND VEGETATION CLEARING METHODS

TABLE 7.3 SEGMENT 1 – TREE AND VEGETATION DISPOSAL METHODS		
METHOD TYPE	METHOD TITLE	METHOD DESCRIPTION
TYPE A	CONSTRUCTION USE	LOGS MAY BE UTILIZED AS NEEDED DURING CONSTRUCTION FOR WETLAND ACCESS, CRIBBING, RETAINING WALLS, OR OTHER USES. FOLLOWING USE, ANY LOGS UNSUITABLE FOR FIREWOOD, SAW LOGS, OR CHIPPING WILL BE TRANSPORTED OFF THE RIGHT–OF–WAY TO AN APPROVED DISPOSAL SITE.
TYPE B	LOG PILES	LOGS NOT NEEDED FOR CONSTRUCTION WILL BE REMOVED FROM THE RIGHT–OF–WAY TO AN APPROVED DISPOSAL AREA.
TYPE C	SALE	WHERE SUFFICIENT MERCHANTABLE VOLUME EXISTS ON THE SITE, LOGS MAY BE SOLD TO A THIRD PARTY. WHERE APPROPRIATE AND PRACTICAL, AND WITH THE AGREEMENT OF LANDOWNERS, UNSOLD LOGS WILL BE HAULED TO ACCESSIBLE LOCATIONS FOR SALVAGE BY THE GENERAL PUBLIC IN ACCORDANCE WITH THE SUBSTANTIVE REQUIREMENTS OF 6 NYCRR PART 192.5, FIREWOOD RESTRICTIONS TO PROTECT FORESTS FROM INVASIVE SPECIES.
TYPE D	TREE/LOG CHIPPING	WHEN LOGS CANNOT BE REUSED OR SOLD, THEY WILL BE CHIPPED ON SITE. THE RESULTING WOOD CHIPS WILL BE PILED IN UPLAND AREAS WITHIN THE RIGHT–OF–WAY OR TRANSPORTED OFF RIGHT–OF–WAY TO AN APPROVED DISPOSAL SITE. WOOD CHIPS WILL BE SPREAD THREE (3) TO FIVE (5) INCHES THICK WITH FERTILIZER SPREAD OVER THE CHIPS TO MINIMIZE SOIL NITROGEN DEPLETION DUE TO CELLULOSE DECOMPOSITION.
TYPE E	VEGETATION CHIPPING	VEGETATION INCLUDING TREE LIMBS MAY BE CHIPPED TO REDUCE DEBRIS VOLUME. SEE TYPE D DESCRIPTION ABOVE FOR THE DISPOSAL OF CHIPS.
TYPE F	VEGETATION HAULING	VEGETATION AND STUMPS MAY BE HAULED TO A NYSDEC APPROVED LANDFILL OR OTHER SUITABLE OFF–SITE LOCATION WITH THE APPROVAL OF THE LANDOWNER AND ALL APPLICABLE PERMITTING AGENCIES.
TYPE G	VEGETATION BURIAL	STUMPS MAY BE BURIED ON THE RIGHT–OF–WAY WITH LANDOWNER AGREEMENT. THE BURIAL AREAS WILL BE SUFFICIENTLY COMPACTED AND MONITORED AFTER CONSTRUCTION TO ASSURE THAT SETTLING DOES NOT OCCUR. WHERE SIGNIFICANT SETTLING AFTER CONSTRUCTION HAS BEEN IDENTIFIED BY THE CONSTRUCTION INSPECTOR ET. AL., FINISHED GRADE WILL BE RE–ESTABLISHED USING LOCALLY OBTAINED RUN–OF–BANK MATERIAL AND/OR TOPSOIL AND RE–SEEDED AS APPROPRIATE AS SPECIFIED IN SECTIONS 14.2. AREAS WHERE SIGNIFICANT AMOUNTS OF STUMP BURIAL OCCURS WILL BE NOTED ON AS–BUILT DRAWINGS, AND MONITORED FOR SETTLING DURING ROW CONDITION SURVEYS AND MAINTENANCE ACTIVITIES.

NOTE: SECTION 7.3 OF THE EM&CP SUMMARIZES THE TREE AND VEGETATION DISPOSAL PROCEDURES FOR THIS SEGMENT. NO BURNING OF ANY VEGETATIVE OR TREE DEBRIS IS PERMITTED WITHIN THE WORK AREAS OF THIS SEGMENT. DISPOSAL SITES MENTIONED IN THE TABLE ABOVE ARE PROVIDED IN APPENDIX L – SOIL MANAGEMENT PLAN. DISPOSAL OF ALL DISEASED TREES WILL OCCUR WITHIN FOUR (4) DAYS AFTER CUTTING BY A DISPOSAL METHOD TO PREVENT THE SPREAD OF THE ASH BORER AND ASIAN LONGHORN BEETLE AS DESCRIBED IN SECTION 8.3.3 OF THE EM&CP. ALL APPLICABLE NYSDEC REGULATIONS REGARDING INVASIVE SPECIES WILL BE FOLLOWED WHEN DISPOSING OF VEGETATION.

SEGMENT 1 – TREE AND VEGETATION DISPOSAL METHODS

Table 8.2: SEGMENT 1 – SUMMARY OF WETLAND IMPACT						
WETLAND ID	JURISDICTION	APPROXIMATE STATION & SHEET NUMBER	ECOLOGICAL COMMUNITY TYPE	PERMANENT ROW IMPACTS (SQUARE FEET)	TEMPORARY CONSTRUCTION IMPACTS (SQUARE FEET)	STATE WETLAND BUFFER TEMPORARY CONSTRUCTION IMPACTS (SQUARE FEET)
WETLAND C–P	USACE	10146+50 TO 10148+00 (SEGMENT 1 C–110)	PEM	0	2131	N/A
WETLAND C–Q	USACE	10152+50 TO 10158+00 (SEGMENT 1 C–111)	PEM	810	1979	N/A
WETLAND C–T	USACE	10178+50 TO 10182+50 (SEGMENT 1 C–113)	PEM	1514	3292	N/A
WETLAND C–Y	USACE	10207+00 TO 10209+00 (SEGMENT 1 C–115)	PEM	251	322	N/A
WETLAND C2B	USACE	10262+00 TO 10263+50 (SEGMENT 1 C–118)	PEM	0	1480	N/A
WETLAND 1A	USACE	10355+00 TO 10357+00 (SEGMENT 1 C–125)	PEM	1025	789	N/A
WETLAND SA–4	USACE	CONSTRUCTION ENTRANCE FOR RYDER ROAD STAGING AND LAYDOWN AREA (SEGMENT 1 & 2 C–201)	PEM	0	341	N/A
TOTAL				3600 SF (0.083 ACRES)	10,334 (SF) (0.24 ACRES)	N/A

NOTES:

1. SECTION 8.1 OF THE EM&CP AND THE WETLAND DELINEATION REPORT IN APPENDIX M OF THE EM&CP DESCRIBE THE IMPACTS TO WETLANDS WITHIN THIS SEGMENT AS WELL AS THE AVOIDANCE AND MINIMIZATION MEASURES. THE TABLE ABOVE SUMMARIZES THE PERMANENT ROW IMPACTS (0.083 ACRES), TEMPORARY CONSTRUCTION IMPACTS (0.24 ACRES), AND TEMPORARY CONSTRUCTION IMPACTS TO STATE WETLAND BUFFERS (0 ACRES) IN SEGMENT 1. THE RYDER ROAD STAGING AND LAYDOWN AREA WETLAND IMPACTS ARE INCLUDED IN BOTH SEGMENT 1 AND 2

2. SECTION 8.1 OF THE EM&CP AND THE WATERBODY INVENTORY IN APPENDIX M OF THE EM&CP DESCRIBE THE IMPACTS TO STREAMS AND WATERBODIES WITHIN THIS SEGMENT AS WELL AS THE AVOIDANCE AND MINIMIZATION MEASURES.

SEGMENT 1 – IMPACTS TO WETLANDS

TABLE 12.1 SEGMENT 1 – CO–LOCATED INFRASTRUCTURE CONSULTATION SUMMARY							
OWNER	UTILITY	INITIAL CONTACT DATE	INITIAL CI–OWNER RESPONSE	OUTREACH MAILING #2	OUTREACH MAILING #3	OUTREACH MAILING #4	SUMMARY OF CI–OWNER RESPONSE
AT&T	FIBER/TELEPHONE	9/9/22	CROSSING CONDITIONS RECEIVED	1/27/22 EMAIL SENT WITH KMZ DIGITAL MAP OF ROUTE AND REQUEST FOR RECORDS, DATA & INFORMATION OF CI ALONG PROJECT ROUTE.	4/13/22 PLAN & PROFILE DRAWINGS PROVIDED FOR REVIEW. RESPONSES REQUESTED BY 4/29/22.	N/A	NO AT&T CORE FACILITIES IN WASHINGTON COUNTY.
LEVEL 3 COMMUNICATIONS (NOW LUMEN TECHNOLOGIES)	FIBER	9/10/22	SUPPORT SERVICES AGREEMENT IN PLACE. CROSSING CONDITIONS RECEIVED. REIMBURSEMENT FUND ESTABLISHED.	1/27/22 EMAIL SENT WITH KMZ DIGITAL MAP OF ROUTE AND REQUEST FOR RECORDS, DATA & INFORMATION OF CI ALONG PROJECT ROUTE.	4/13/22 PLAN & PROFILE DRAWINGS PROVIDED FOR REVIEW. RESPONSES REQUESTED BY 4/29/22.	7/11/22 UPDATED PLAN AND PROFILE DRAWINGS PROVIDED FOR REVIEW	CONCURRED THAT ALIGNMENT IS ACCEPTABLE PROVIDED THAT THE SPECIFIED SEPARATION DISTANCES AND CONCRETE ENCASEMENT ARE OBSERVED/PROVIDED
NATIONAL GRID/EAST/ELECTRIC	ELECTRIC/GAS	9/10/22	CROSSING CONDITIONS RECEIVED.	1/27/22 EMAIL SENT WITH KMZ DIGITAL MAP OF ROUTE AND REQUEST FOR RECORDS, DATA & INFORMATION OF CI ALONG PROJECT ROUTE. RECEIVED LOCATIONS OF OVERHEAD ELECTRIC LINES.	4/29/22 PLAN & PROFILE DRAWINGS PROVIDED FOR REVIEW. RESPONSES REQUESTED BY 4/29/22.	ON–GOING COORDINATION	CI OWNER PROVIDED ADDITIONAL UTILITY LOCATION INFORMATION WHICH HAS BEEN INCLUDED IN REVISED PLAN/PROFILE
TIME WARNER CABLE (CHARTER COMMUNICATIONS /SPECTRUM)	FIBER/CATV	8/10/22	NO ACTION REQUIRED UNTIL PLANS ARE AVAILABLE FOR REVIEW.	1/27/22 EMAIL SENT WITH KMZ DIGITAL MAP OF ROUTE AND REQUEST FOR RECORDS, DATA & INFORMATION OF CI ALONG PROJECT ROUTE.	4/14/22 PLAN & PROFILE DRAWINGS PROVIDED FOR REVIEW. RESPONSES REQUESTED BY 4/29/22.	ON–GOING COORDINATION	NOTED CROSSINGS MISSING FROM MATRIX PROVIDED. NO SEPARATION REQUIREMENT SPECIFIED.
VERIZON OR VERIZON/EAST	TELECOM; FIBER/TELEPHONE	8/10/22	NO ACTION REQUIRED UNTIL PLANS ARE AVAILABLE FOR REVIEW.	1/27/22 EMAIL SENT WITH KMZ DIGITAL MAP OF ROUTE AND REQUEST FOR RECORDS, DATA & INFORMATION OF CI ALONG PROJECT ROUTE.	4/14/22 PLAN & PROFILE DRAWINGS PROVIDED FOR REVIEW. RESPONSES REQUESTED BY 4/29/22.	NOT NEEDED	VERIZON RESPONDED THAT THEY WILL NOT NEED TO RELOCATE ANY OF THEIR FACILITIES/INFRASTRUCTURE. MAY PROVIDE FOREMAN CONTRACTOR IF AN IMMEDIATE RESPONSE IS REQUIRED. NO SEPARATION REQUIREMENT SPECIFIED.
NYSDOT ALBANY REGION 1	TRAFFIC SIGNALS HIGHWAY	ONGOING FOR A NUMBER OF YEARS. SEE TABLE 11.3 IN THE EM&CP	N/A	N/A	1/27/22 PLAN & PROFILE DRAWINGS PROVIDED FOR REVIEW.	ON–GOING COORDINATION	PROVIDED SIGN/SEALED DRAWINGS TO NYSDOT ON 9/20/22 IN RESPONSE TO MOST RECENT NYSDOT COMMENTS AND ASKED FOR CONFIRMATION THAT COMMENTS HAVE BEEN SUFFICIENTLY ADDRESSED
WASHINGTON COUNTY	STORM SEWER/SANITARY SEWER/WATER	8/31/22	N/A	N/A	N/A	ON–GOING COORDINATION	AWAITING RESPONSE
TOWN OF DRESDEN	STORM SEWER/SANITARY SEWER	8/7/22	DRAFT PLAN & PROFILE SENT FOR REVIEW.	N/A	1/27/22 PLAN & PROFILE DRAWINGS PROVIDED FOR REVIEW.	ON–GOING COORDINATION	NO CONCERNS EXPRESSED BY TOWN
TOWN OF WHITEHALL	TRAFFIC SIGNALS/STORM SEWER/CULVERTS/SANITARY SEWER/WATER	8/7/22	DRAFT PLAN & PROFILE SENT FOR REVIEW.	N/A	1/27/22 PLAN & PROFILES DRAWINGS SENT FOR REVIEW.	ON–GOING COORDINATION	NO CONCERNS EXPRESSED BY TOWN
VILLAGE OF WHITEHALL	TRAFFIC SIGNALS/STORM SEWER/CULVERT S/SANITARY SEWER/WATER	8/8/22	DRAFT PLAN & PROFILE SENT FOR REVIEW.	N/A	1/27/22 PLAN & PROFILE DRAWINGS SENT FOR REVIEW.	ON–GOING COORDINATION	DPW CONFIRMED CONCURRENCE WITH ALIGNMENT

SEGMENT 1 – CO–LOCATED INFRASTRUCTURE CONSULTATION SUMMARY


CHAMPLAIN HUDSON POWER EXPRESS
SEGMENT 1 (PACKAGE 1A) PUTNAM TO DRESDEN
EM&CP DATA TABLES

KIEWIT PROJECT NO.	21162
CHA PROJECT NO.	068076
DRAWING NO.	G-013

G-013

DRAWN BY:	JJE	DESIGNED BY:	JTM	APPROVED BY:	JPR	SCALE	AS NOTED	DATE	09/21/2022
No.	DATE	SUBMITTAL / REVISION DESCRIPTION			DB	APP	REV. NO.	X	SH.NO. XXX OF XXX

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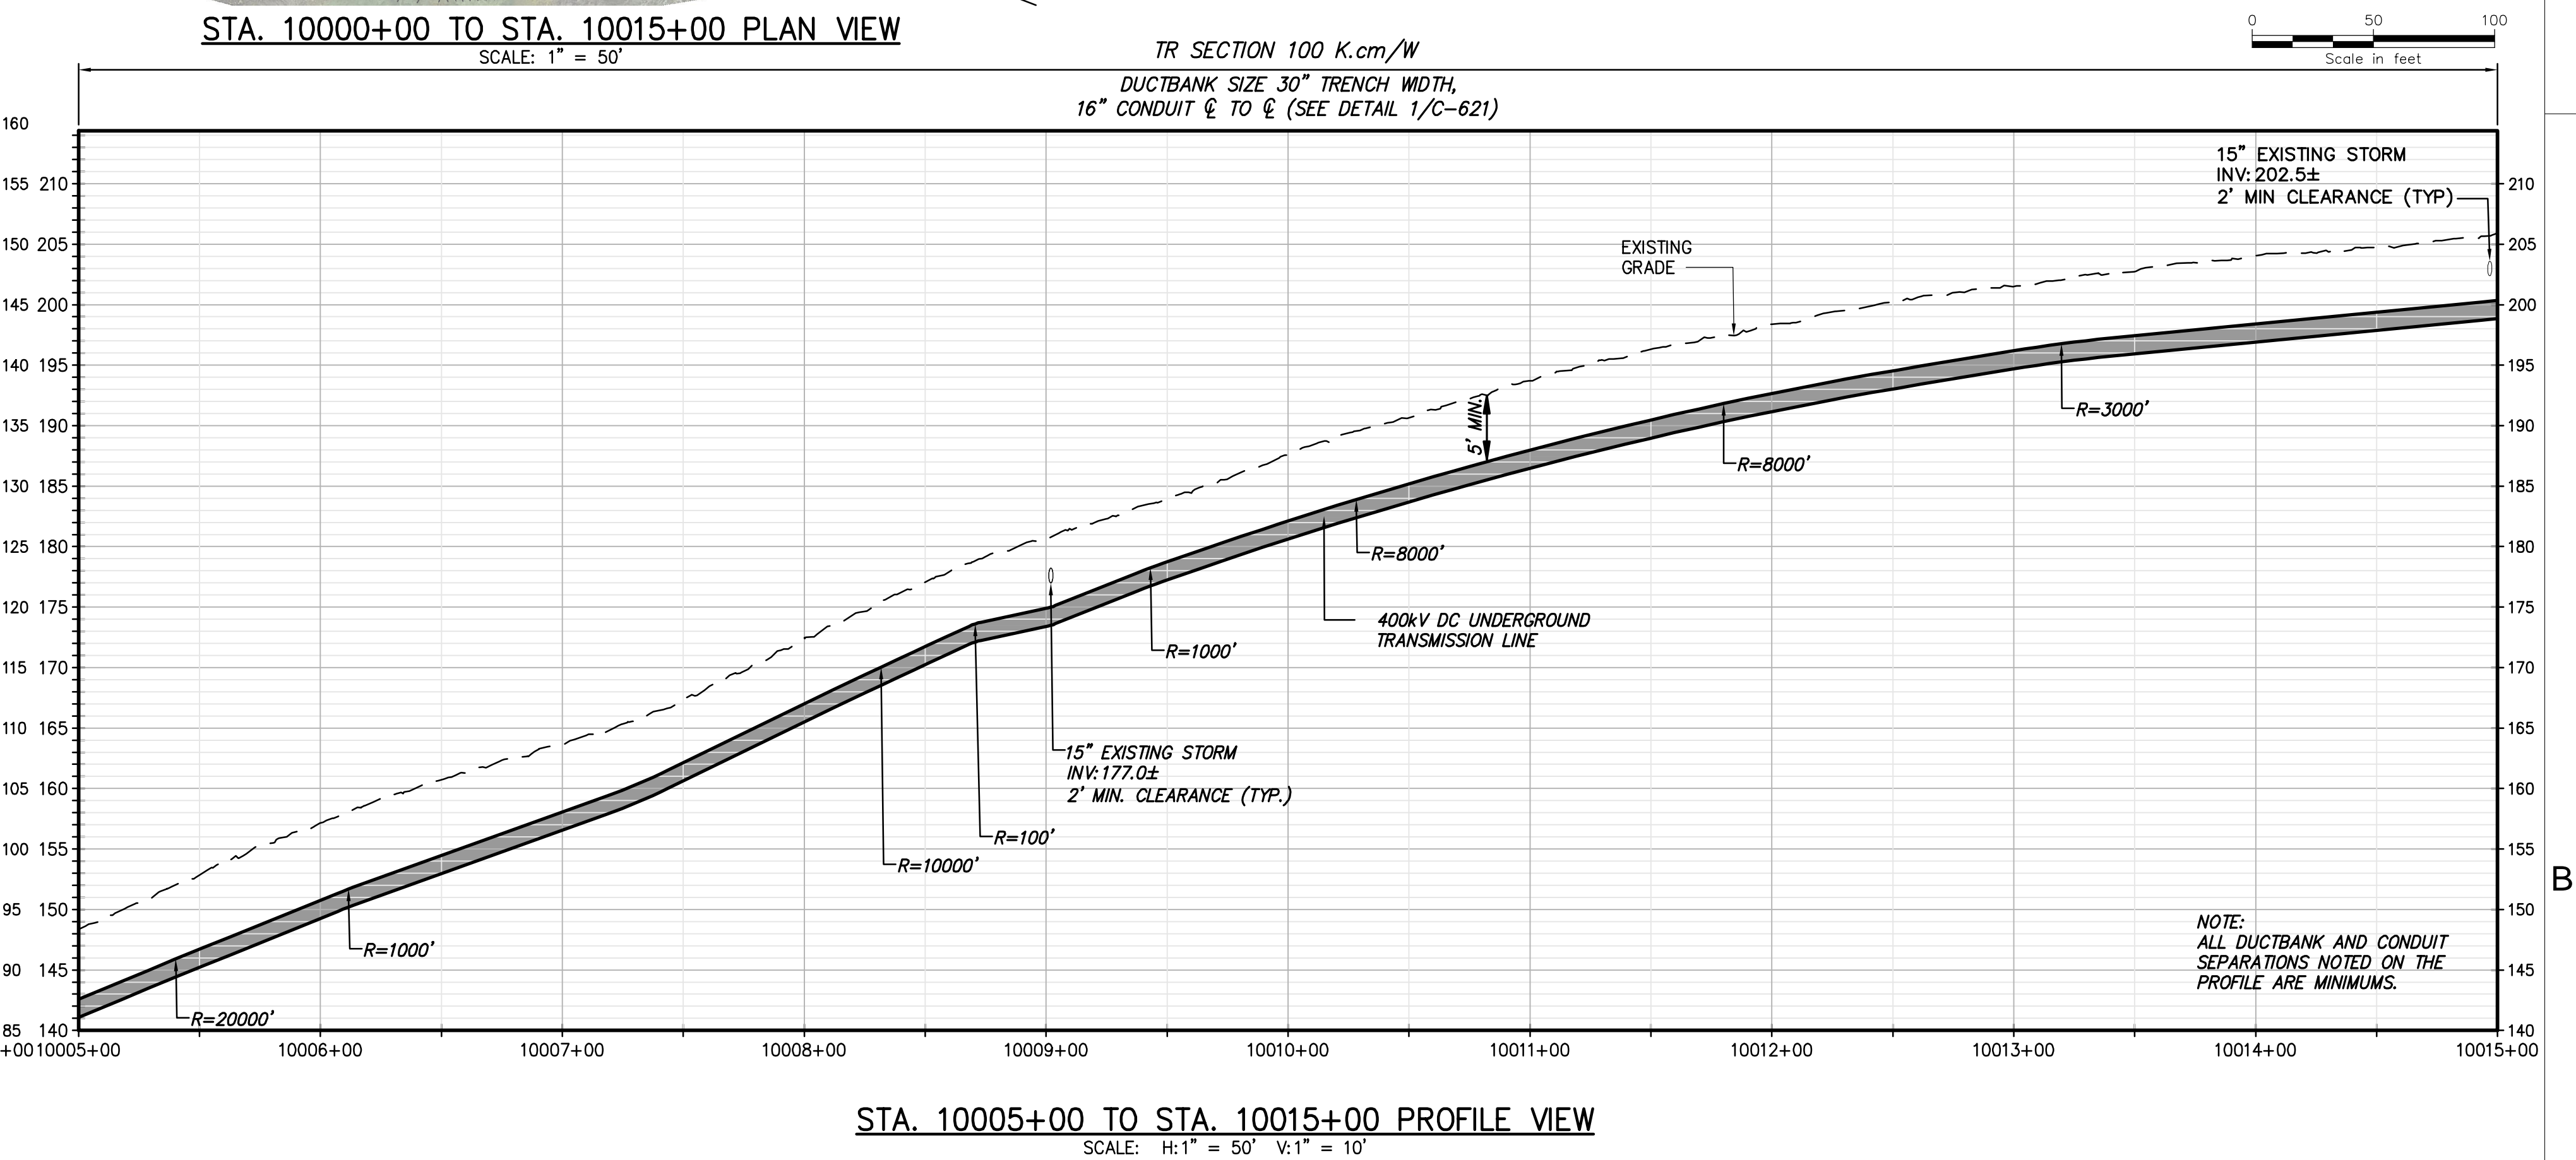
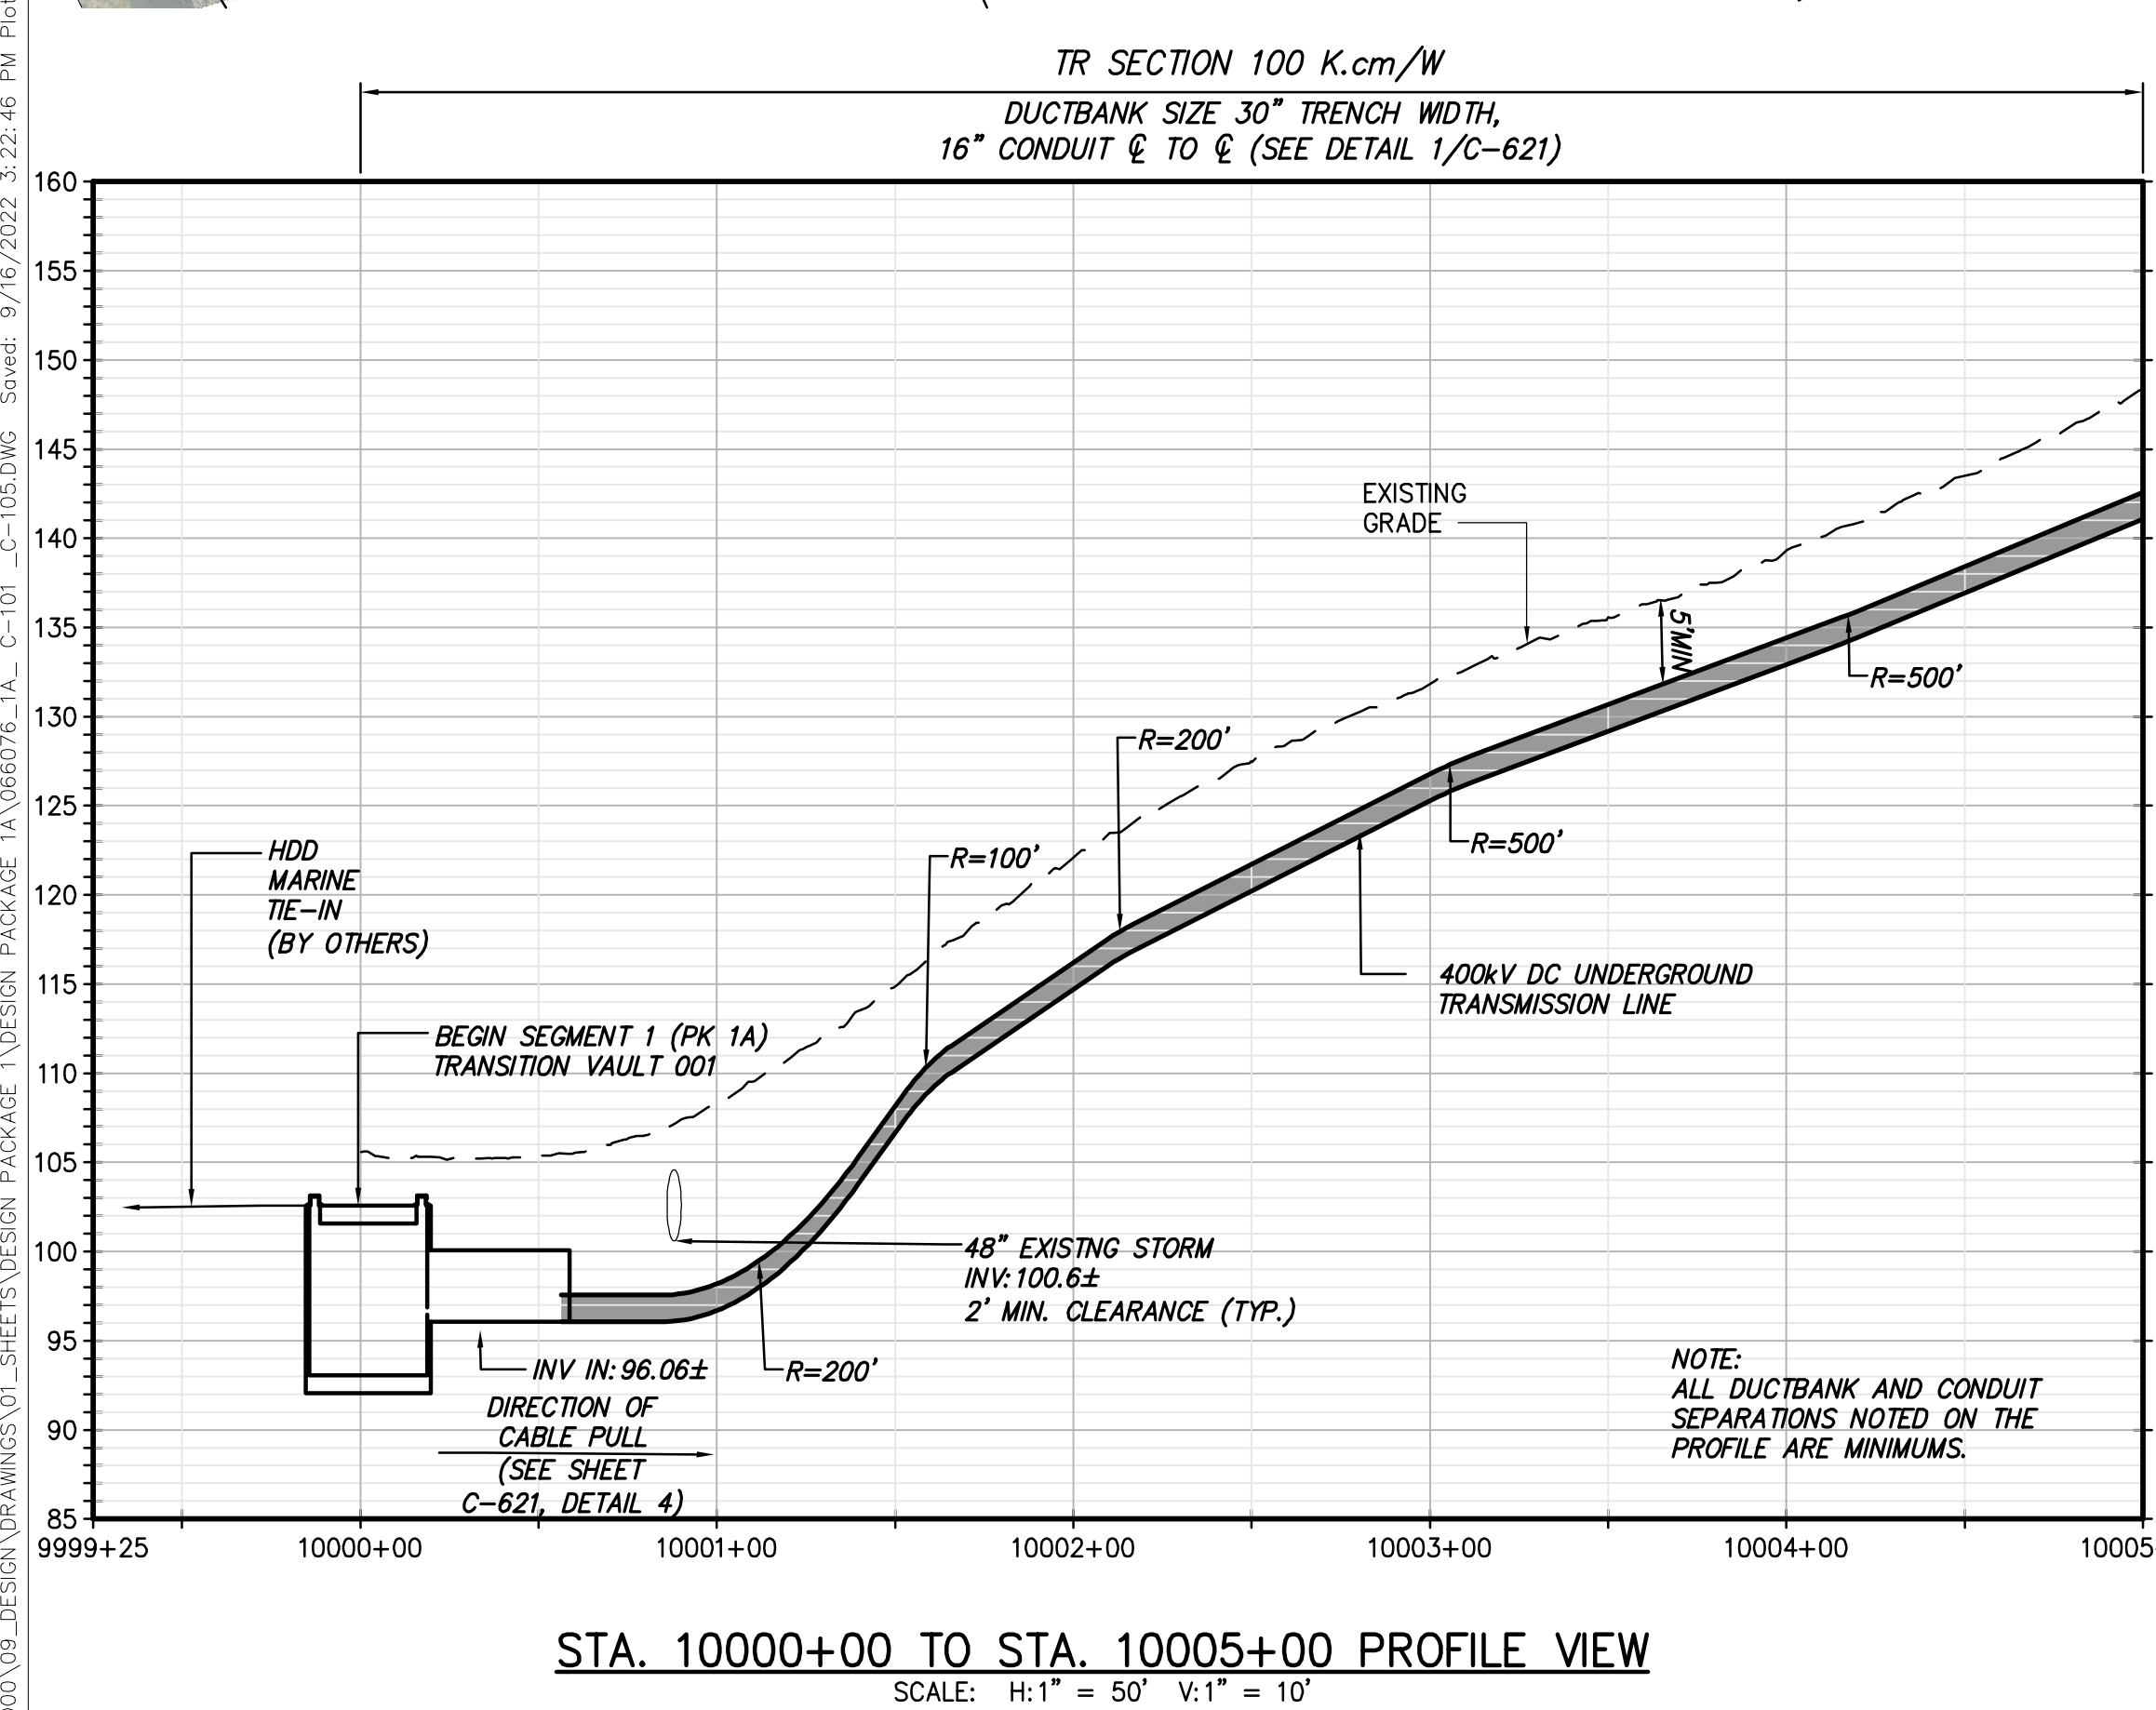
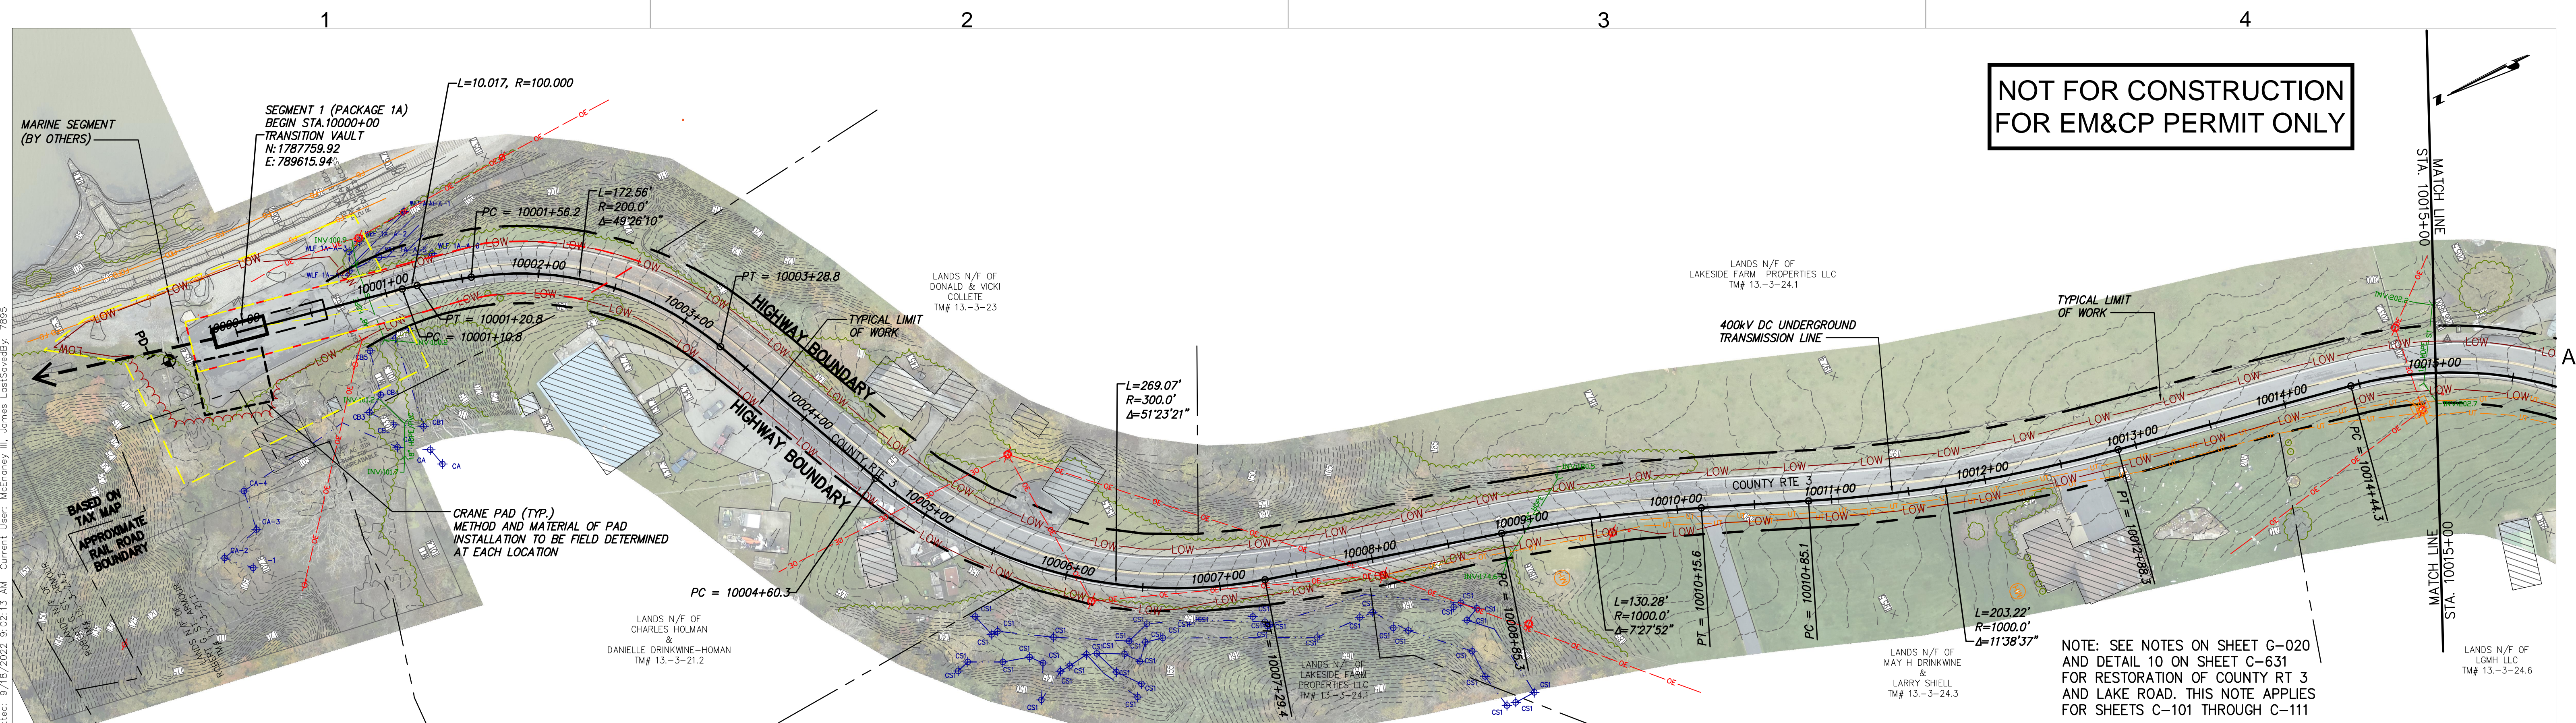


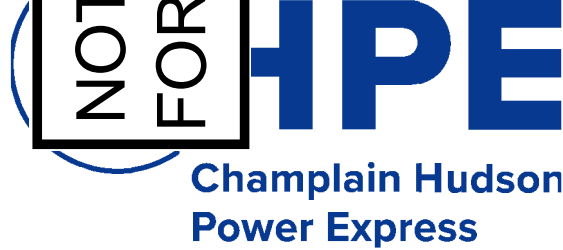
09/21/2022

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
A

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





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09/18/2022

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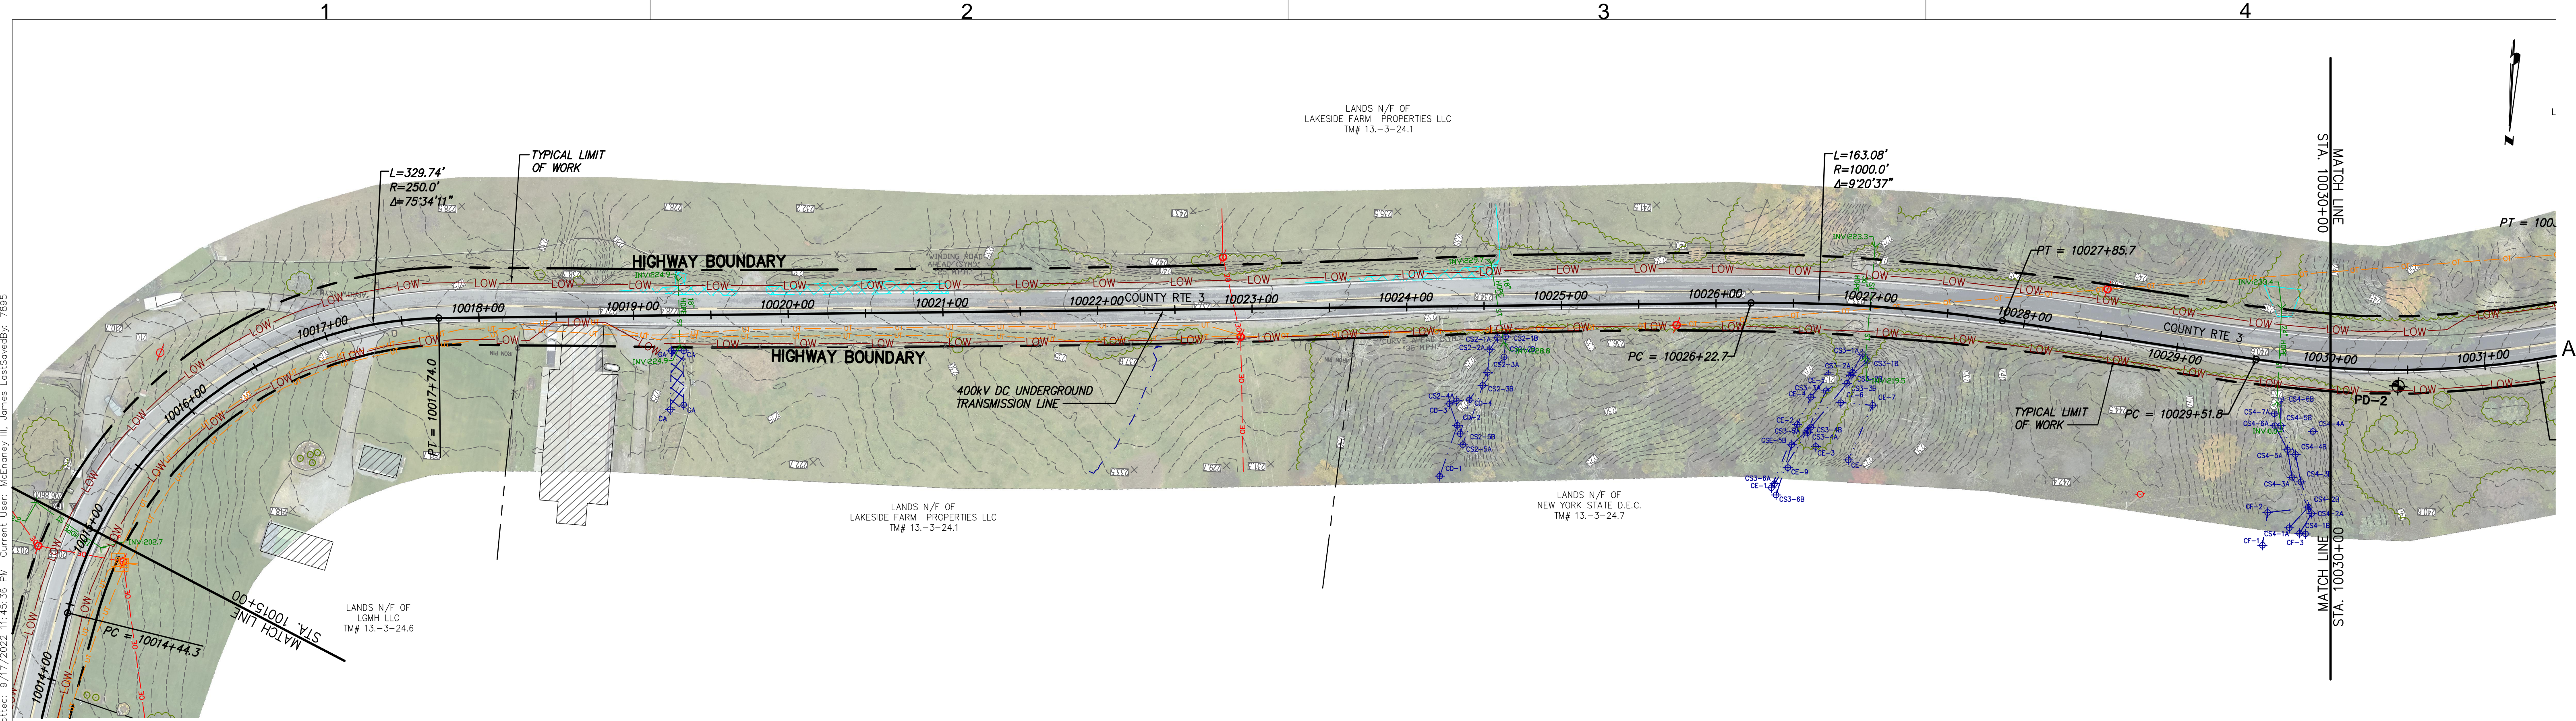
No.	DATE	SUBMITTAL / REVISION DESCRIPTION	DB	APP
0	09/21/2022	FINAL EM&CP SUBMISSION	JM	JR

CHAMPLAIN HUDSON POWER EXPRESS
SEGMENT 1 (PACKAGE 1A) PUTNAM TO DRESDEN
STA. 10000+00 TO STA. 10015+00



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SCALE	AS NOTED	DATE	09/21/2022	SH.NO.	XXX OF XXX

KIEWIT PROJECT NO. 21162
CHA PROJECT NO. 066076
DRAWING NO. **C-101**

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


STA. 10015+00 TO STA. 10030+00 PLAN VIEW
SCALE: 1" = 50'

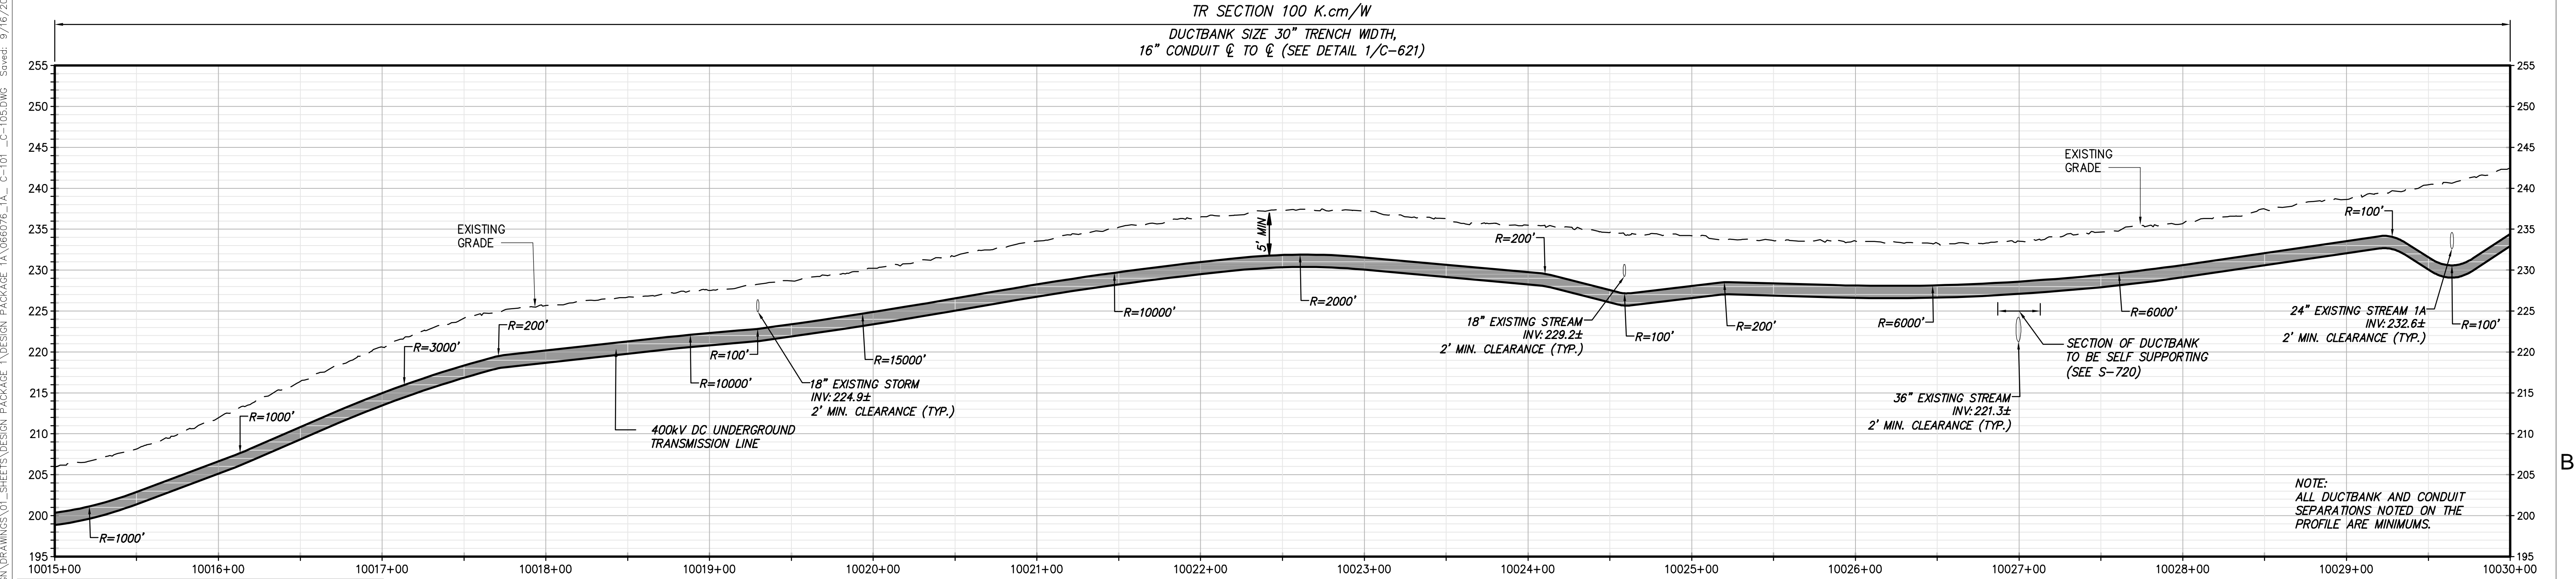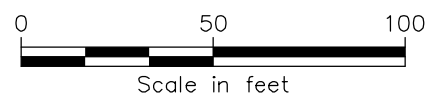


STA. 10015+00 TO STA. 10030+00 PROFILE VIEW
SCALE: H:1" = 50' V:1" = 10'


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
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LICENSED PROFESSIONAL ENGINEER
081993
09/18/2022


IT IS A VIOLATION OF LAW FOR ANY PERSON, UNLESS THEY ARE ACTING UNDER THE DIRECTION OF A LICENSED PROFESSIONAL ENGINEER, ARCHITECT, LANDSCAPE ARCHITECT OR LAND SURVEYOR TO ALTER AN ITEM IN ANY WAY. IF AN ITEM BEARING THE STAMP OF A LICENSED PROFESSIONAL IS ALTERED, THE ALTERING ENGINEER, ARCHITECT, LANDSCAPE ARCHITECT OR LAND SURVEYOR SHALL STAMP THE DOCUMENT AND INCLUDE THE NOTATION "ALTERED BY" FOLLOWED BY THEIR SIGNATURE, THE DATE OF SUCH ALTERATION, AND A SPECIFIC DESCRIPTION OF THE ALTERATION.

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CHAMPLAIN HUDSON POWER EXPRESS
SEGMENT 1 (PACKAGE 1A) PUTNAM TO DRESDEN
STA. 10015+00 TO STA. 10030+00


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JTM	JTM	JPR	REV. NO.	X

KIEWIT PROJECT NO.	21162
CHA PROJECT NO.	066076
DRAWING NO.	C-102
DATE	09/21/2022
SH.NO.	XXX OF XXX

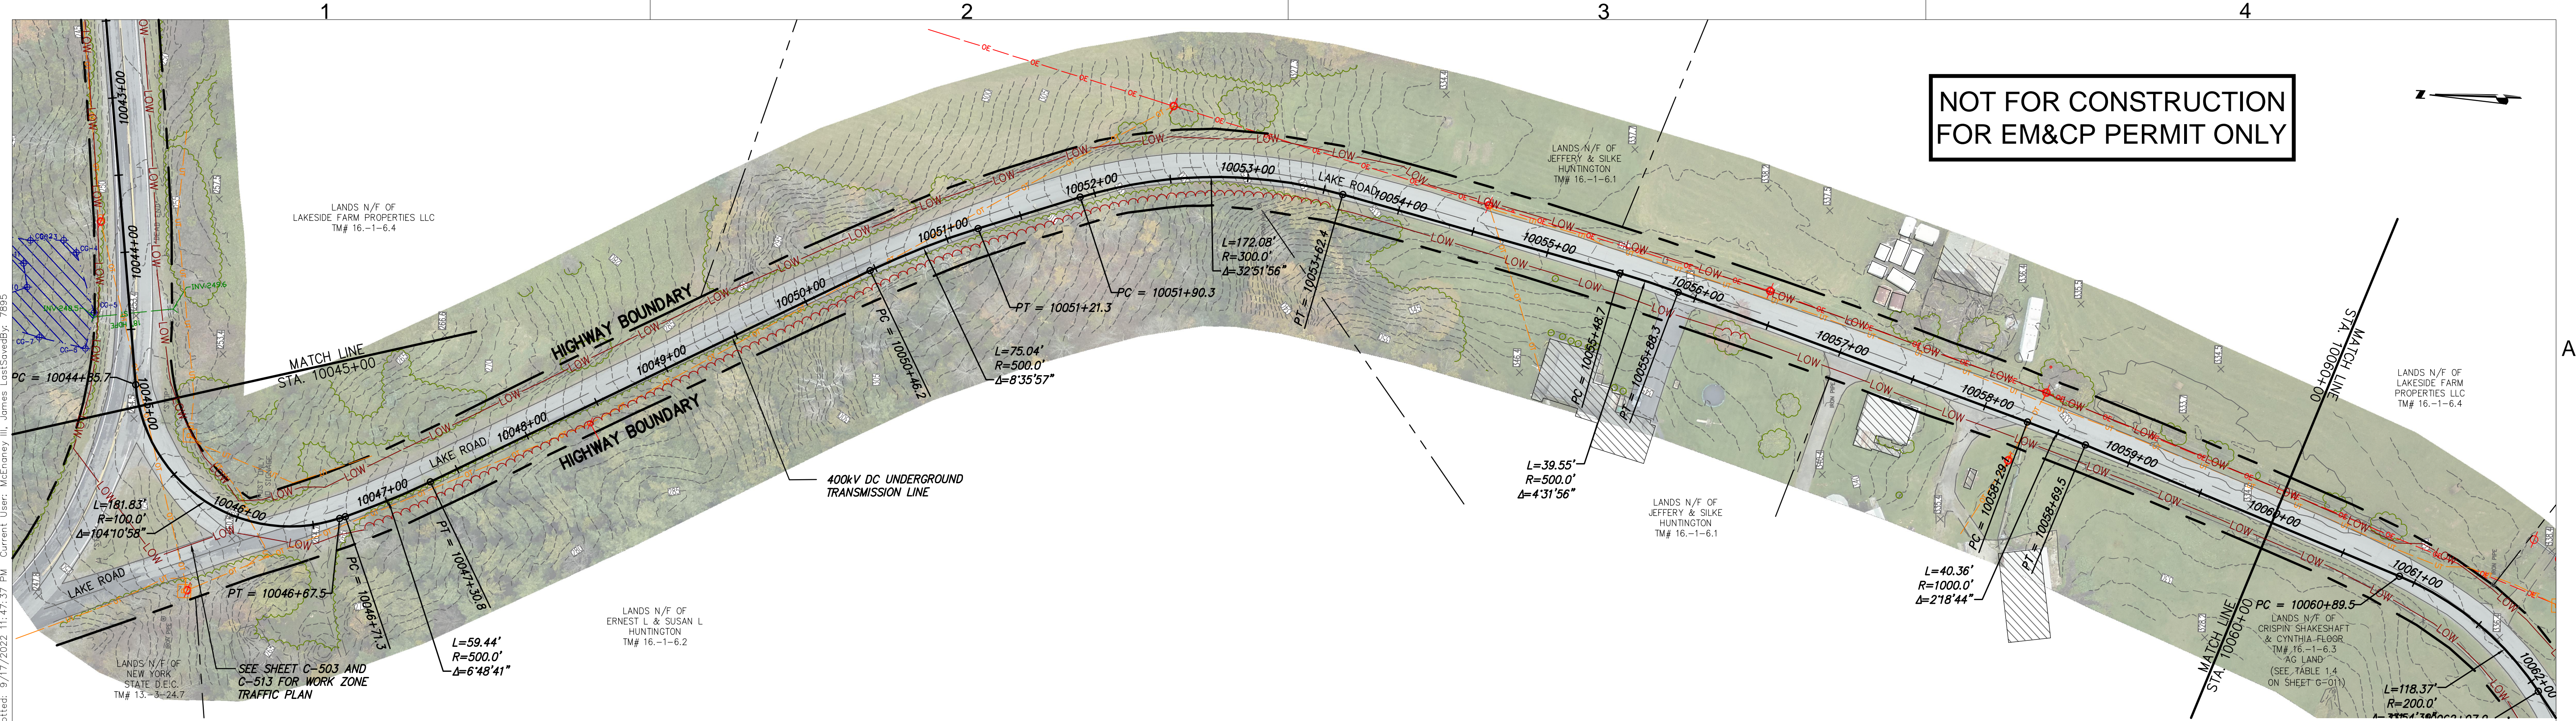


STA. 10045+00 TO STA. 10060+00 PLAN VIEW

SCALE: 1" = 50'

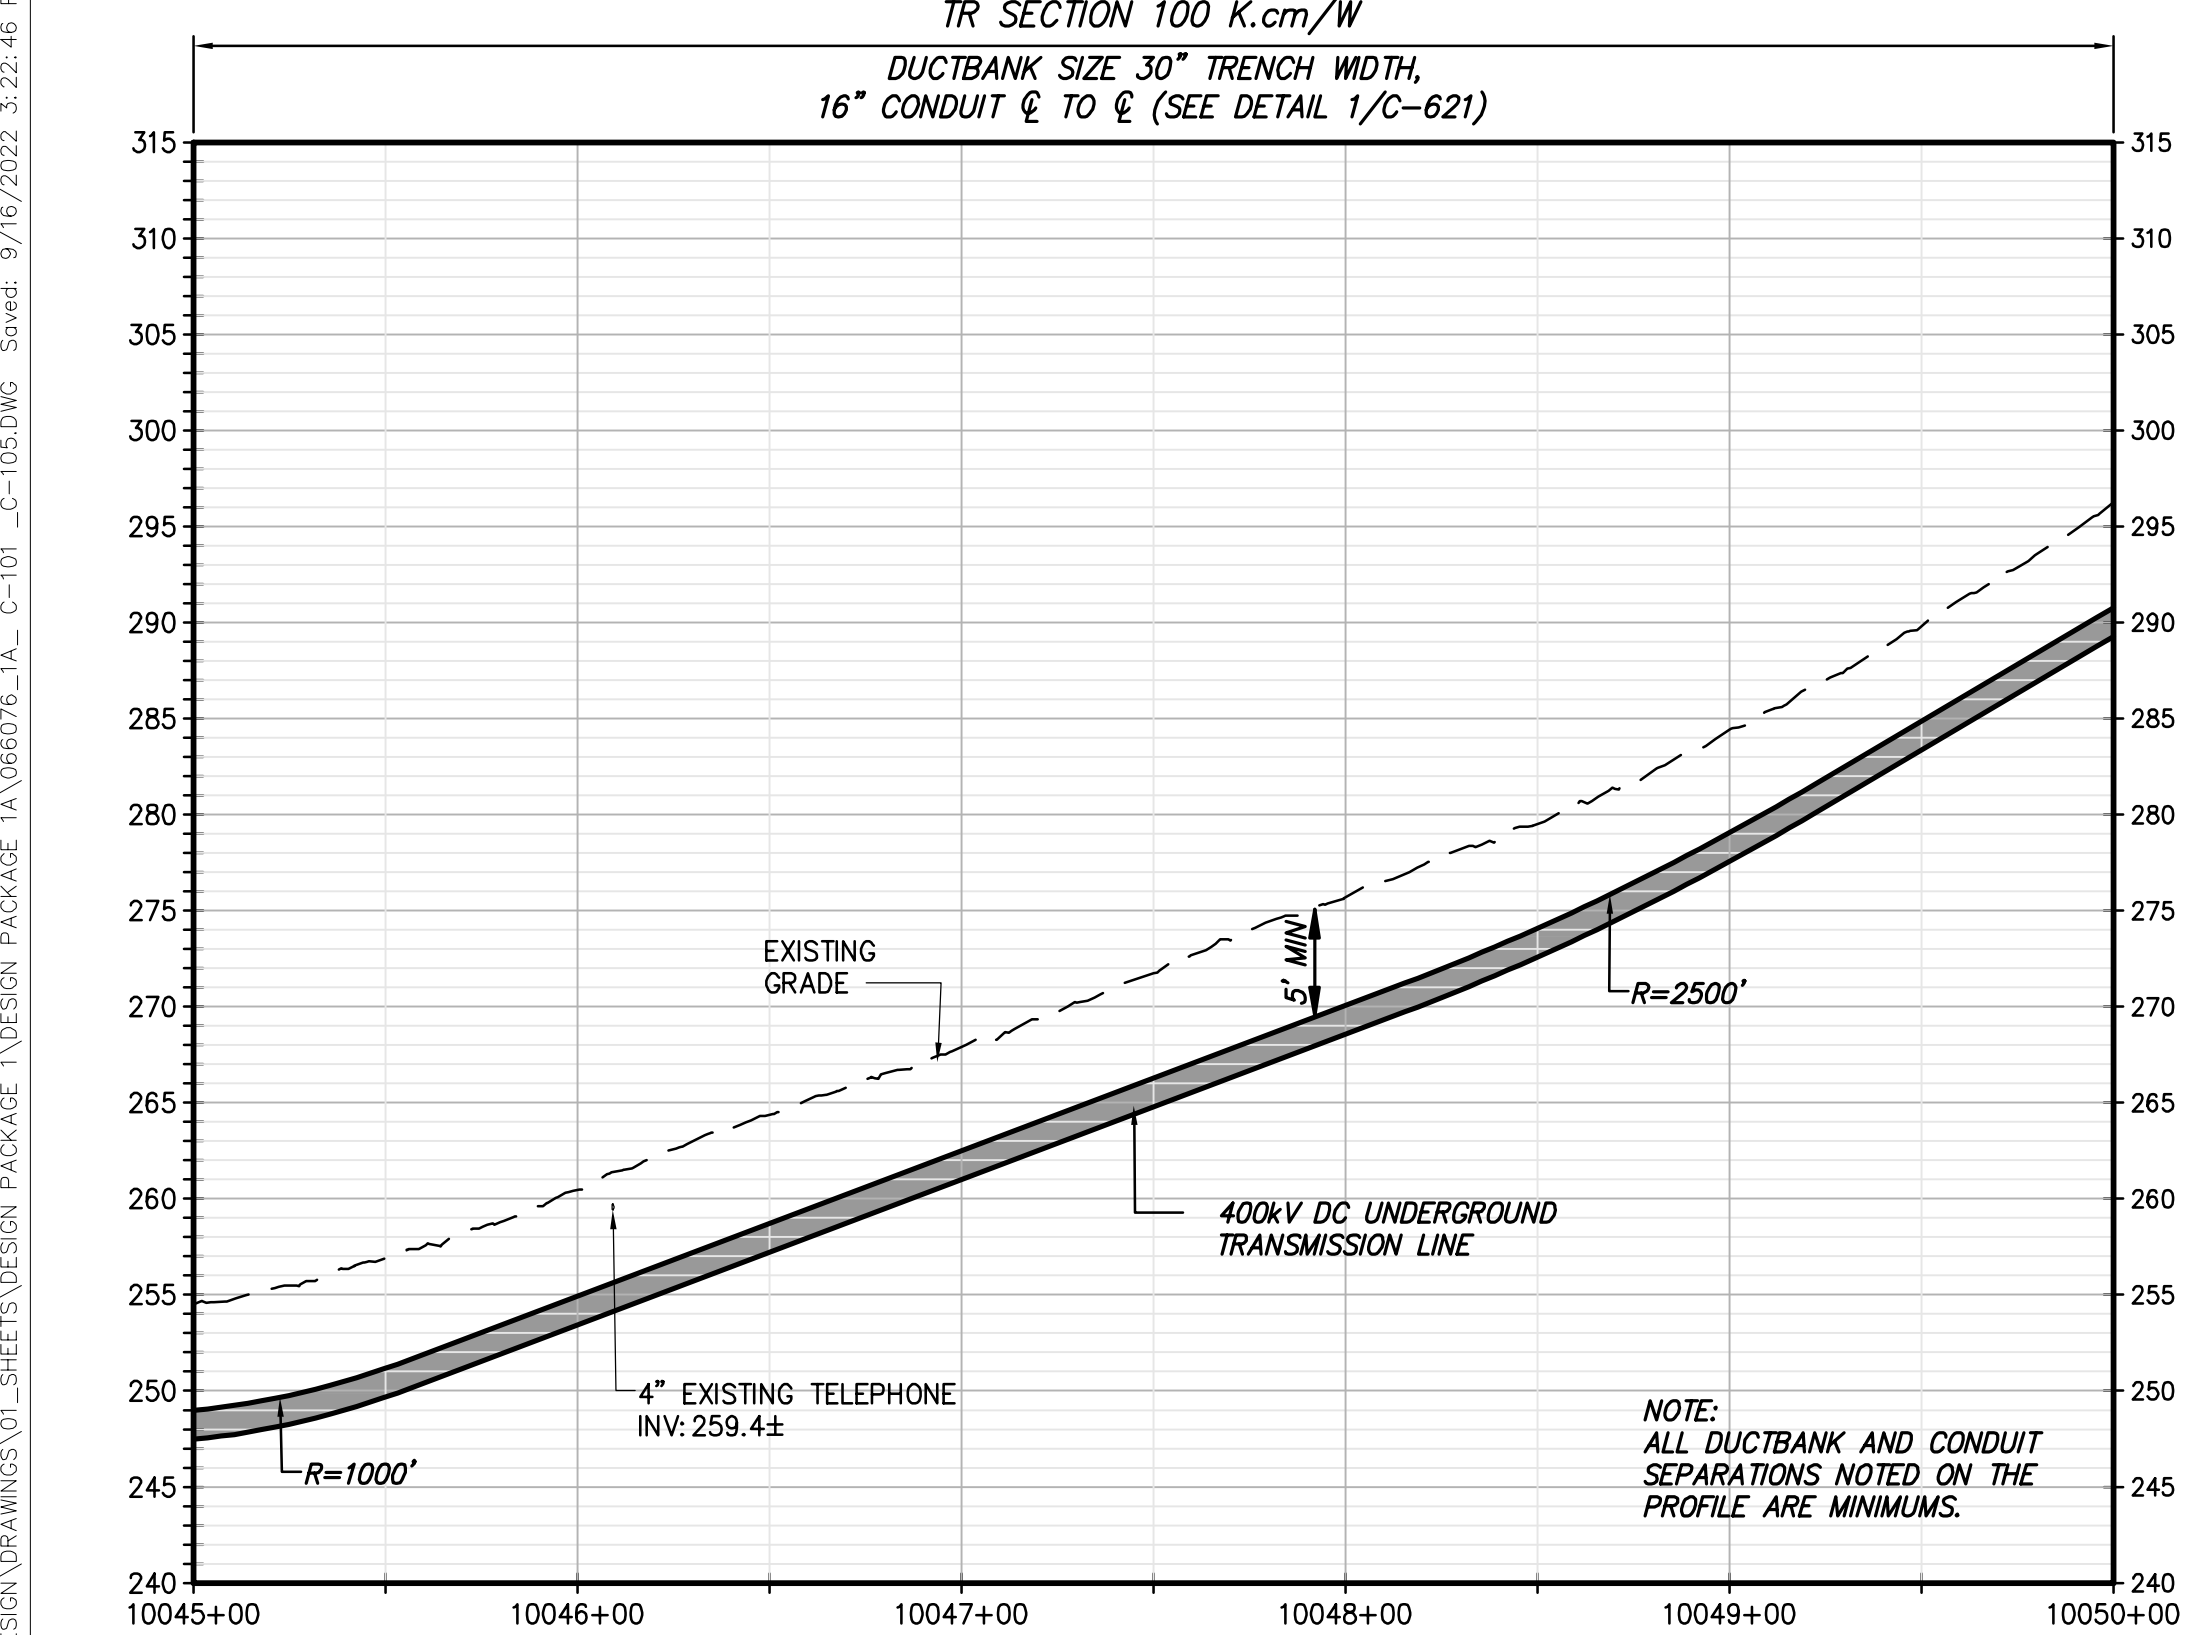


STA. 10045+00 TO STA. 10050+00 PROFILE VIEW

SCALE: H: 1" = 50' V: 1" = 10'

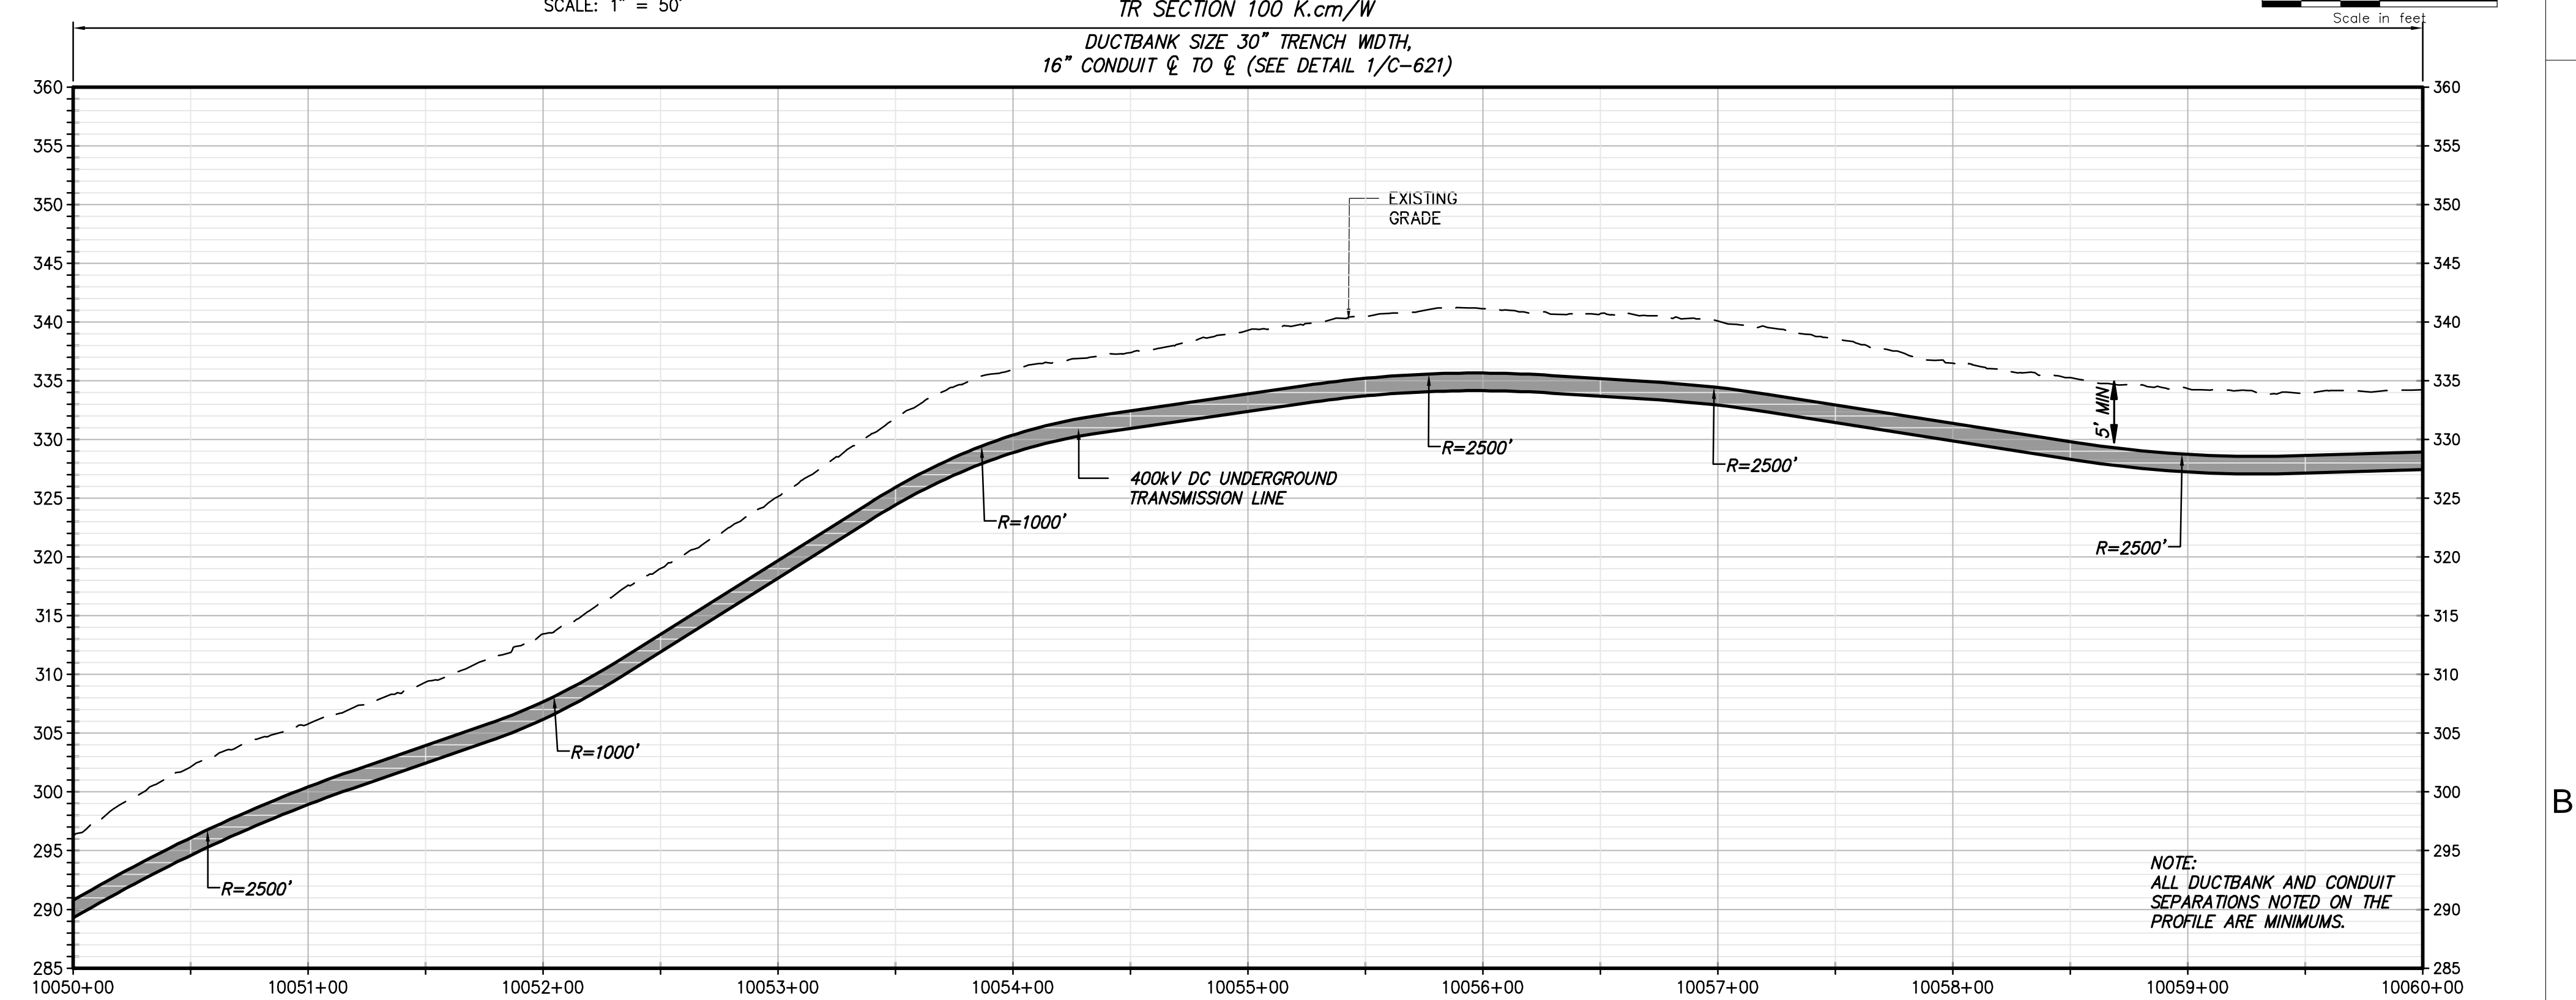


STA. 10050+00 TO STA. 10060+00 PROFILE VIEW


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
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09/18/2022


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**CHAMPLAIN HUDSON POWER EXPRESS
SEGMENT 1 (PACKAGE 1A) PUTNAM TO DRESDEN**
STA. 10045+00 TO STA. 10060+00



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						REV. NO.	X

KIEWIT PROJECT NO.	21162
CHA PROJECT NO.	066076
DRAWING NO.	C-104
DATE	09/21/2022
SH.NO.	XXX OF XXX





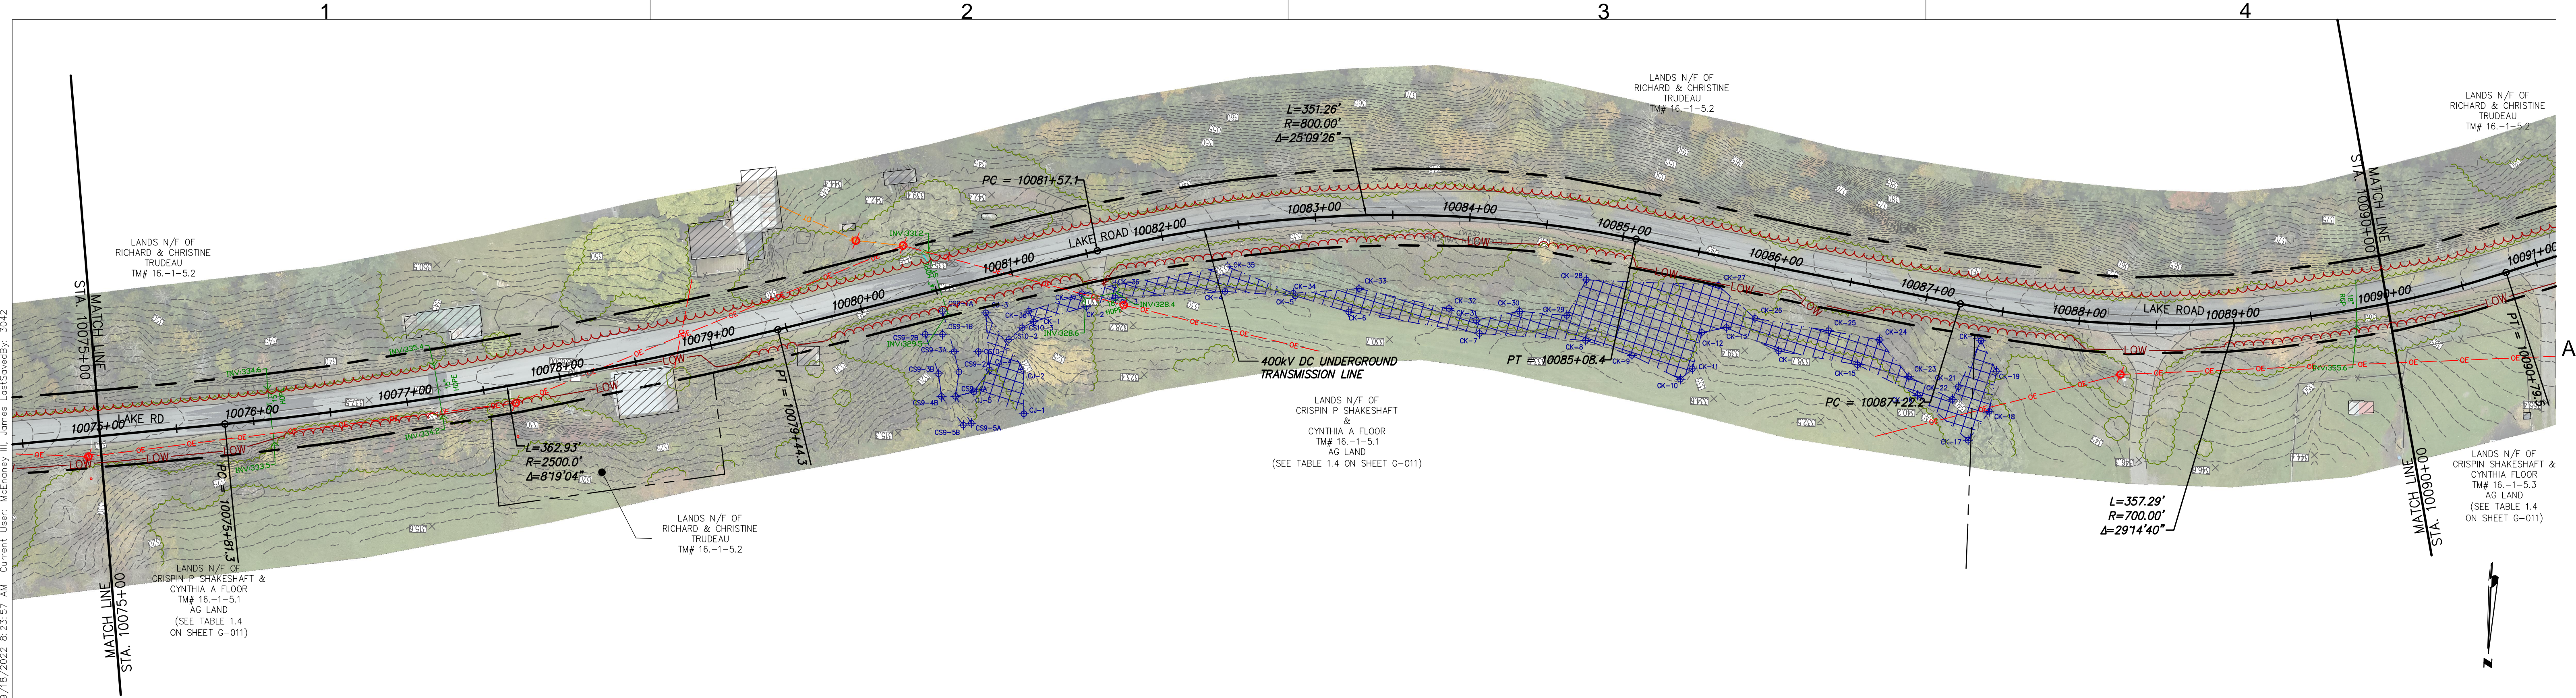

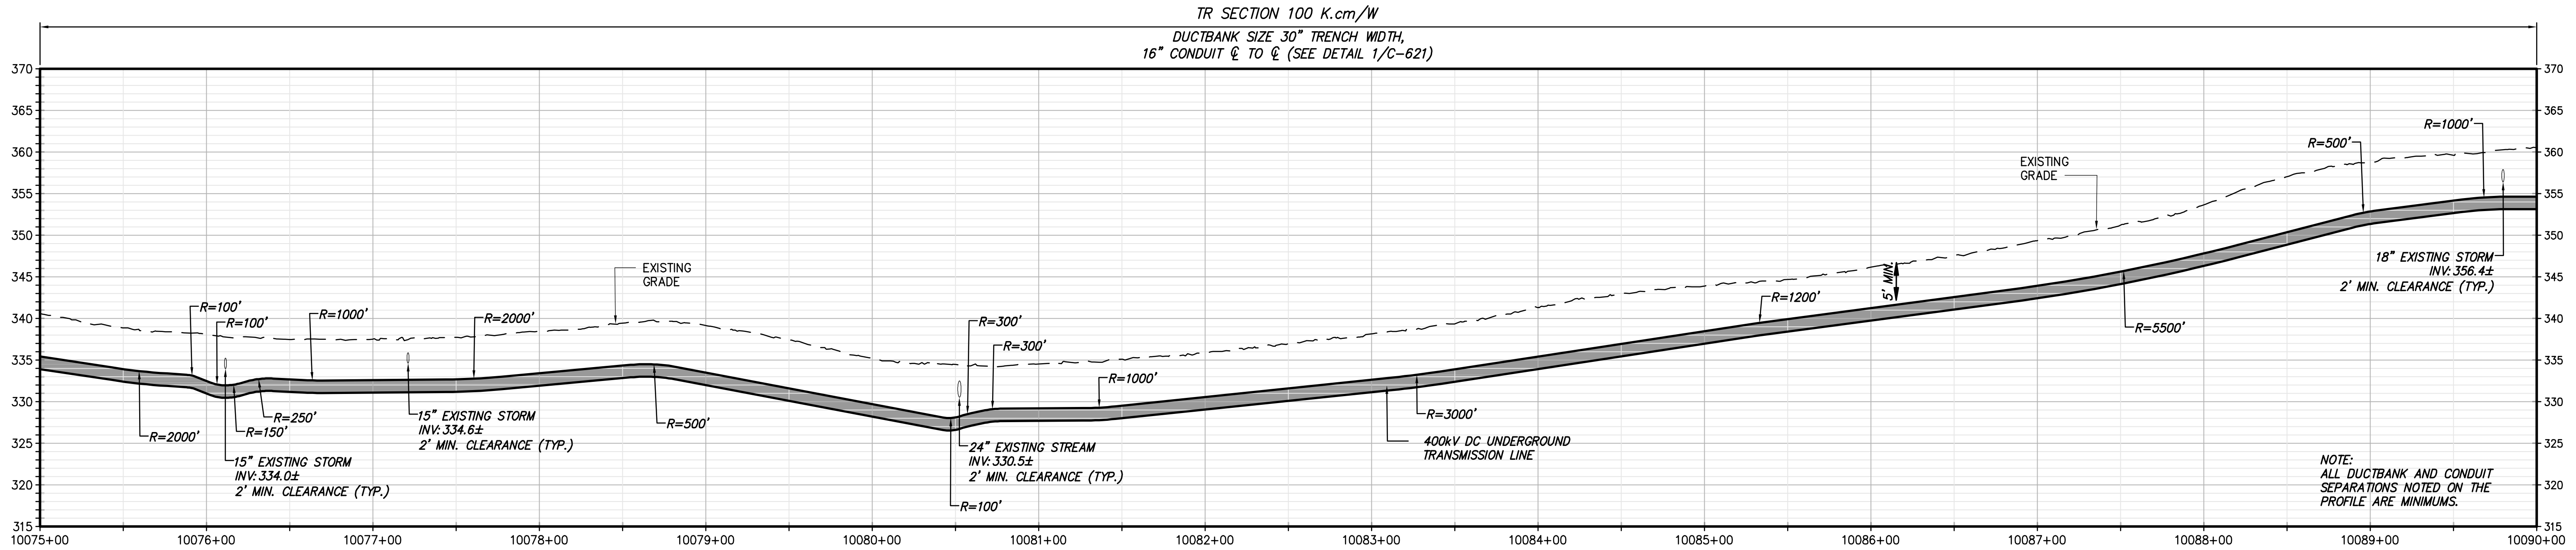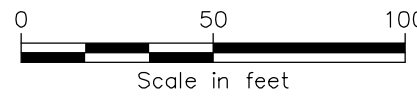STA. 10075+00 TO STA. 10090+00 PLAN VIEW
SCALE: 1" = 50'

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STA. 10075+00 TO STA. 10090+00 PROFILE VIEW
SCALE: H:1" = 50' V:1" = 10'



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CHAMPLAIN HUDSON POWER EXPRESS
SEGMENT 1 (PACKAGE 1A) PUTNAM TO DRESDEN
STA. 10075+00 TO STA. 10090+00

DRAWN BY: JTM


DESIGNED BY: JTM

APPROVED BY: JPR

SCALE: AS NOTED
REV. NO. X


KIEWIT PROJECT NO.
21162
CHA PROJECT NO.
066076
DRAWING NO.
C-106

DATE
09/21/2022
SH.NO.
XXX OF XXX

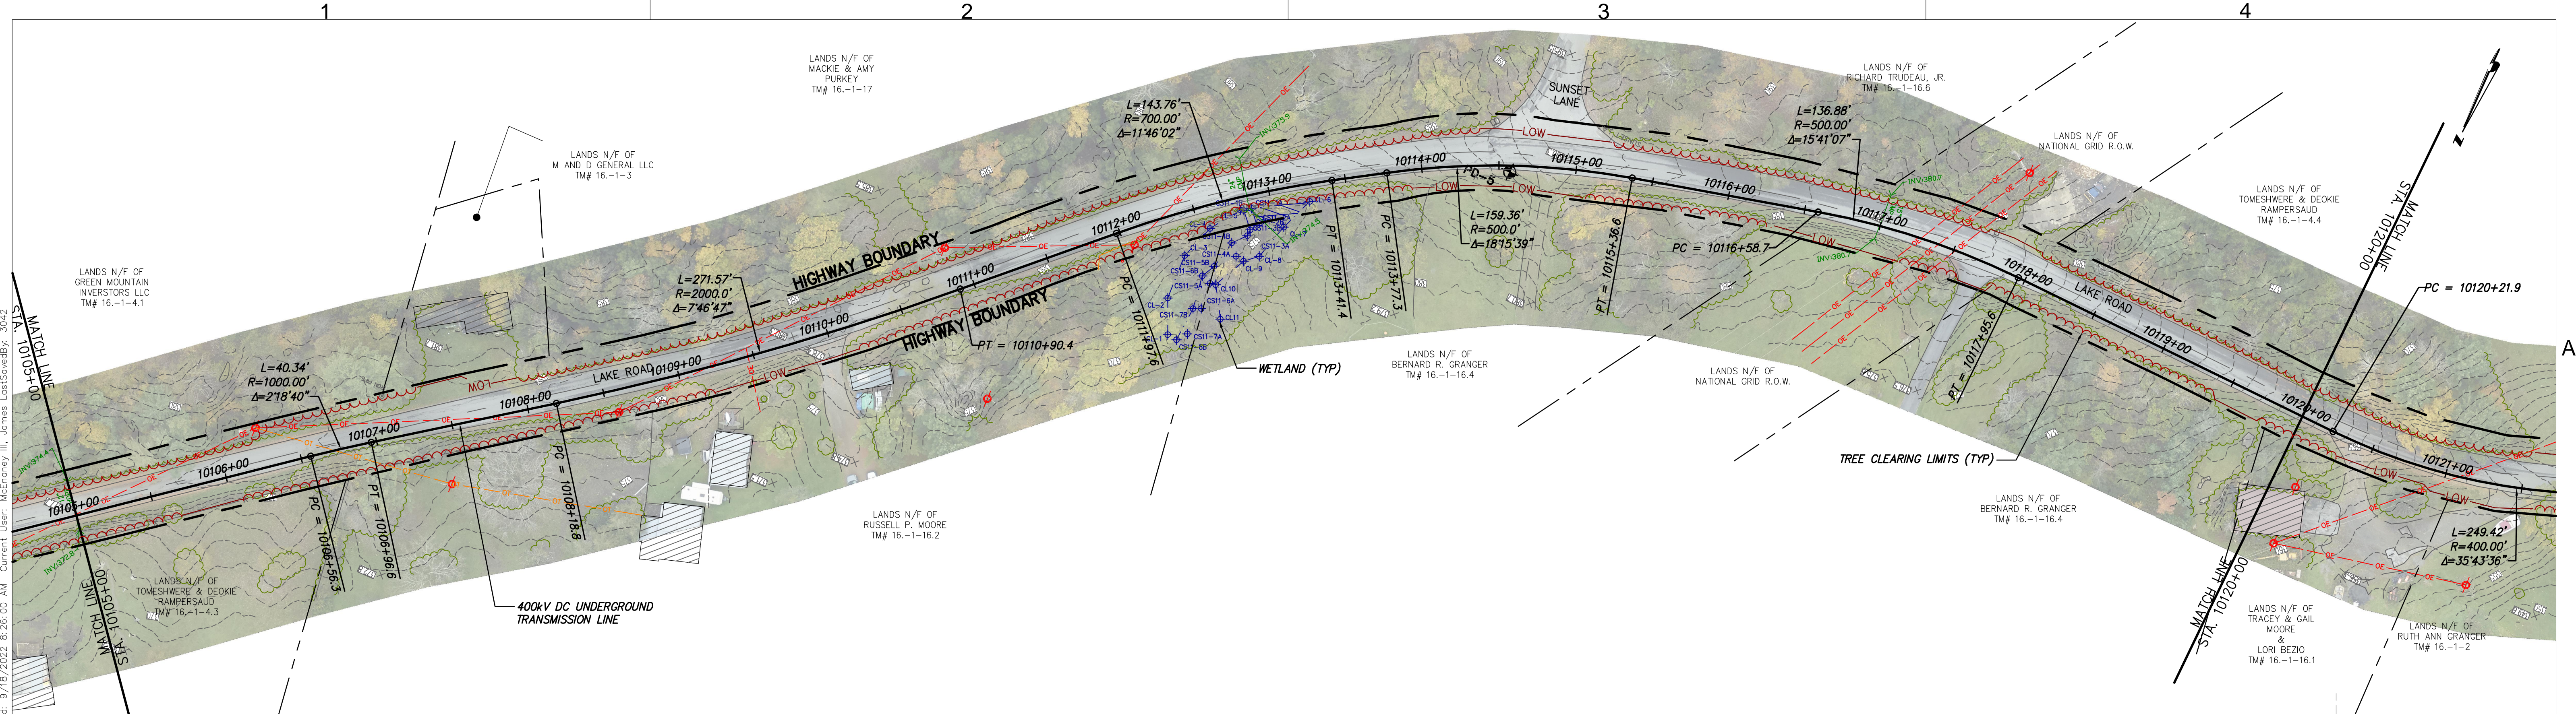


STA. 10105+00 TO STA. 10120+00 PLAN VIEW
SCALE: 1" = 50'


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
STA. 10105+00 TO STA. 10120+00 PROFILE VIEW
SCALE: H:1" = 50' V:1" = 10'

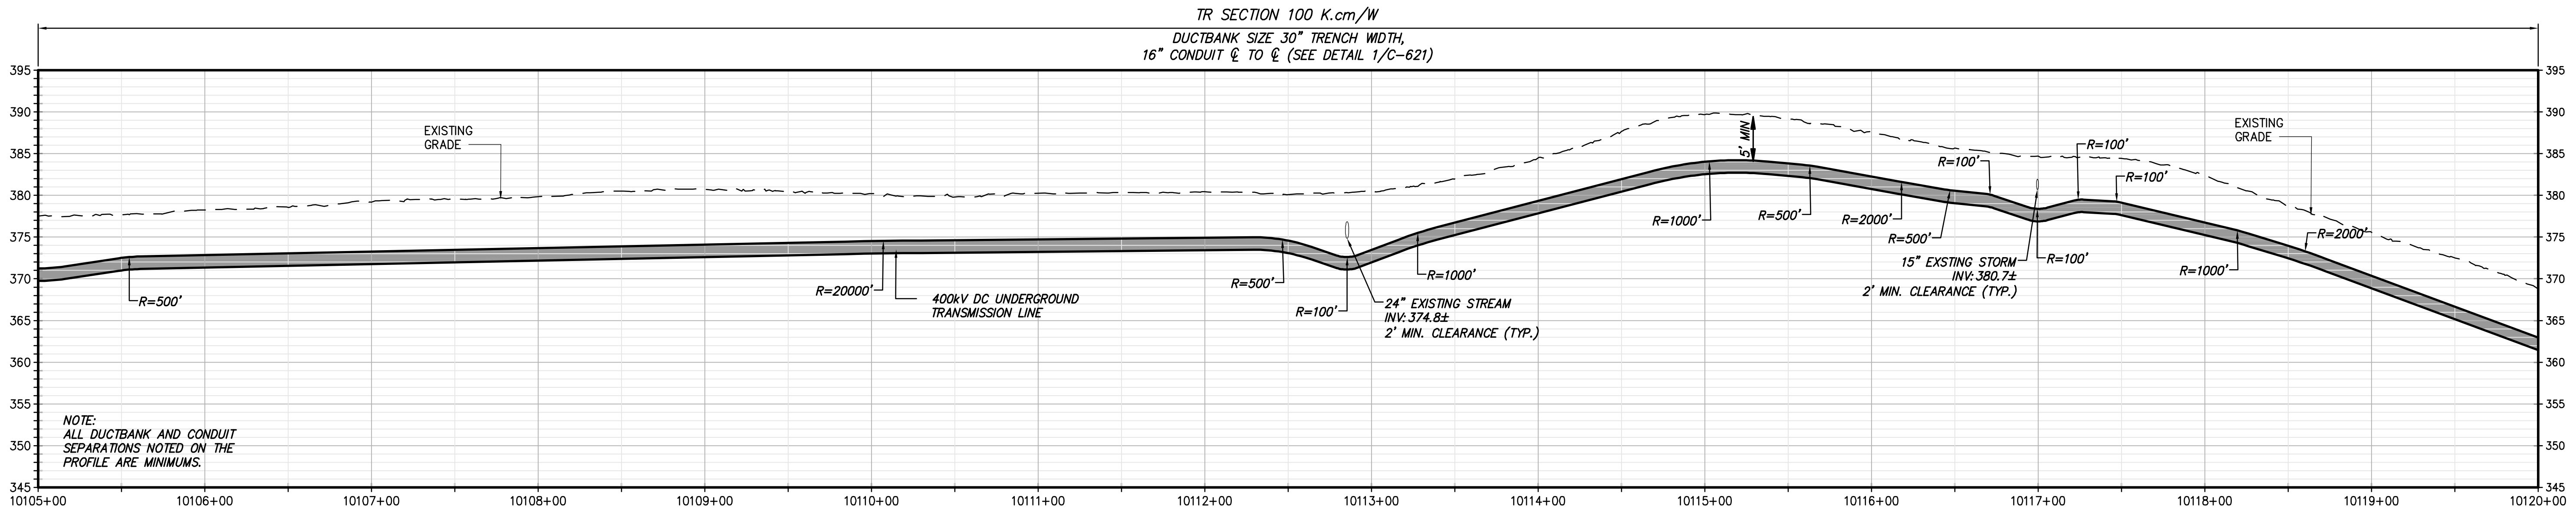


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CHAMPLAIN HUDSON POWER EXPRESS
SEGMENT 1 (PACKAGE 1A) PUTNAM TO DRESDEN
STA. 10105+00 TO STA. 10120+00

DRAWN BY:	DESIGNED BY:	APPROVED BY:	SCALE	AS NOTED
JTM	JTM	JPR	REV. NO.	X

KIEWIT PROJECT NO.	21162
CHA PROJECT NO.	066076
DRAWING NO.	C-108
DATE	09/21/2022
SH.NO.	XXX OF XXX

