

- 2. ALL TEMPORARY TRAFFIC CONTROL AND WORK AREA PROTECTION DEVICES SHALL BE FURNISHED AND INSTALLED BY THE CONTRACTOR UNLESS OTHERWISE NOTED ON THE CONTRACT DRAWINGS AND APPROVED BY THE ENGINEER PRIOR TO COMMENCING WORK.
- 3. ALL MAINTENANCE AND PROTECTIONS OF TRAFFIC WORK SHALL CONFORM TO THE CONTRACT DRAWINGS. MAINTENANCE AND PROTECTION OF TRAFFIC SCHEMES SHOWN ON THE CONTRACT DRAWINGS SHALL NOT BE CHANGED BY THE CONTRACTOR WITHOUT THE WRITTEN PERMISSION OF THE ENGINEER.
- 4. THE TEMPORARY MAINTENANCE OF TRAFFIC AND WORK AREA PROTECTION DEVICE LOCATIONS SHOWN ON THE CONTRACT DRAWINGS ARE SCHEMATIC EXCEPT AS NOTED. LOCATION OF TRAFFIC CONTROL DEVICES MAY BE MODIFIED TO MEET FIELD CONDITIONS AS APPROVED BY THE ENGINEER.
- 5. ALL CLOSURES SHALL BE COORDINATED WITH THE ENGINEER. A SCHEDULE OF WORK SHALL BE SUBMITTED AT LEAST TWO WEEKS IN ADVANCE FOR APPROVAL BY THE ENGINEER.
- 6. THERE MAY BE ONGOING CONSTRUCTION CONTRACTS WITHIN THE VICINITY OF THE WORK AREA. DO NOT MOVE, MODIFY, OR RELOCATE ANY ITEM ASSOCIATED WITH THESE CONTRACTS WITHOUT PROPER APPROVAL OF AND COORDINATION WITH THE ENGINEER.
- 7. PERFORM WORK IN SUCH A MANNER AND SEQUENCE AS TO INTERFERE AS LITTLE AS POSSIBLE WITH THE PASSAGE OF VEHICLES, PEDESTRIANS, AND OTHER KINDS OF PUBLIC TRAFFIC.
- 8. ALL TEMPORARY MAINTENANCE OF TRAFFIC AND WORK AREA PROTECTION SIGN SUPPORTS AND MOUNTING SHALL BE IN CONFORMANCE WITH NYSDOT STANDARD SHEETS AND STANDARD SPECIFICATIONS.
- 9. ALL CONSTRUCTION SIGNS SHALL BE COVERED WITH THICK PLASTIC WHEN THE WORK THEY ARE INTENDED FOR IS NOT IN PROGRESS.
- 10. ALL TRAFFIC CONTROL DEVICES SHALL BE INSTALLED PRIOR TO THE COMMENCEMENT OF THE WORK TO WHICH THEY APPLY, AND SHALL BE MAINTAINED BY THE CONTRACTOR THEREAFTER. THE DEVICES SHALL REMAIN IN PLACE AS LONG AS THEY ARE APPLICABLE.
- 11. TRAFFIC CONTROL DEVICES SHALL NOT BE PLACED AT ANY LOCATIONS WHERE THEY MAY OBSCURE OR INTERFERE WITH THE MOTORIST VIEW OF APPROACHING, MERGING, OR INTERSECTING TRAFFIC; OBSTRUCT OTHER TEMPORARY OR PERMANENT TRAFFIC CONTROL DEVICES WHICH ARE STILL APPLICABLE TO ROADWAY CONDITIONS: MISLEAD OR MISDIRECT MOTORISTS. OR ARE BLOCKED BY OTHER TEMPORARY OR PERMANENT OBJECTS.
- 12. ALL EXISTING ROADWAY ITEMS SUCH AS GUIDE RAILS, PAVEMENT MARKINGS, CURBS, SIGNALS AND SIGNS DAMAGED BY THE CONTRACTOR SHALL BE RESTORED BY THE CONTRACTOR TO THE SATISFACTION OF THE ENGINEER AT NO ADDITIONAL COST.
- 13. TRAFFIC LANES AND OTHER AREAS CLOSED BY THE CONTRACTOR DURING PERMITTED WORK HOURS SHALL BE CLEARED OF ALL MATERIAL, EQUIPMENT, AND DEBRIS, AND SAFELY REOPENED TO TRAFFIC BY THE END OF THE WORK PERIOD UNLESS OTHERWISE INDICATED ON THE CONTRACT DRAWINGS.
- 14. IF THE CONTRACTOR REQUIRES A LANE CLOSURE TO PERFORM OPERATIONS. THEY MAY DO SO WITH THE APPROVAL OF THE ENGINEER. ANY LANE CLOSURES WILL BE SHORT TERM AND IN ACCORDANCE WITH NYS STANDARD SHEETS UNLESS OTHERWISE SHOWN IN CONTRACT PLANS.
- 15. NO WORK ACTIVITY OR STORAGE OF EQUIPMENT, VEHICLES, OR MATERIAL SHOULD OCCUR WITHIN A BUFFER SPACE.
- 16. CHANNELIZING DEVICE SPACING (CENTER TO CENTER) SHALL NOT EXCEED 20' IN THE ACTIVE WORK SPACE.
- 17. WHEN THE DISTANCE BETWEEN THE ADVANCE WARNING SIGNS AND WORK IS 2 MILES TO 5 MILES, A SUPPLEMENTAL DISTANCE PLAQUE (W7-3a) SHOULD BE USED WITH THE SHOULDER WORK SIGN (W21-5).
- 18. THE ROAD WORK NEXT XX MILES SIGN (G20-1) MAY BE USED INSTEAD OF THE ROAD WORK AHEAD SIGN (W20-1) IF WORK LOCATIONS OCCUR OVER A DISTANCE OF MORE THAN 2 MILES.
- 19. ALL ADDITIONAL TEMPORARY SIGNAGE, NOT COVERED IN FHWA MUTCD, SHALL COMPLY WITH NYS SUPPLEMENT TO MANUAL OF UNIFORM TRAFFIC CONTROL DEVICES.

- 20. DURING NON-WORK HOURS, LEAVE DRUMS AND TCB IN PLACE, OR AS DIRECTED AT THE ENGINEER.
- 21. DURING WINTER MORATORIUM, COVER EXCAVATION WITH TEMPORARY ASPHALT AND OPEN ALL LANES TO TRAFFIC.
- 22. THE WZTC DETAILS CONTAINED IN THE CONTRACT PLANS SUPPLEMENT THE CURRENT NYSDOT STANDARD SHEETS. REFERENCE SHALL BE MADE TO THE APPLICABLE NYSDOT STANDARD SHEETS FOR ALL NOTES AND TABLES. THE LATEST REVISIONS OF THE STANDARD SHEETS MAINTAINED BY NYSDOT, WHICH ARE CURRENT ON THE DATE OF ADVERTISEMENT FOR BIDS. SHALL BE CONSIDERED TO BE IN EFFECT. ALL PAY ITEMS AND WORK CONTAINED IN THE CONTRACT AND ANY ADDITIONAL PAY ITEMS AND WORK ENCOUNTERED DURING THE COURSE OF THE CONTRACT SHALL BE SUBJECT TO THE APPLICABLE STANDARD SHEET(S) UNLESS OTHERWISE SPECIFIED IN THE CONTRACT DOCUMENTS.
- 23. MAINTAIN SAFE AND ADEQUATE ACCESS FOR INTERSECTING ROADWAYS, HOMES, AND BUSINESSES, AT ALL TIMES, TO THE SATISFACTION OF THE ENGINEER.
- 24. ACCESS TO RESIDENTIAL AND COMMERCIAL DRIVEWAYS SHALL BE MAINTAINED AT ALL TIMES. UNLESS OTHER AGREEMENTS SUITABLE TO THE PROPERTY OWNERS CAN BE MADE, PROPERTY OWNERS WHOSE DRIVEWAYS WILL BE MADE INACCESSIBLE SHALL BE NOTIFIED BY THE CONTRACTOR AT LEAST 24 HOURS PRIOR TO RESTRICTING USE OF THE DRIVEWAY. THE CONTRACTOR SHALL MAINTAIN ACCESS TO COMMERCIAL DRIVEWAYS AT ALL TIMES WHEN A FACILITY IS IN USE. FOR MULTIPLE ACCESS PROPERTIES, ONLY ONE DRIVEWAY MAY BE CLOSED AT ANY ONE TIME. ACCESS SHALL BE RESTORED TO ALL DRIVEWAYS AS SOON AS POSSIBLE, OR AS DIRECTED BY THE ENGINEER.
- 25. THE CONTRACTOR'S ATTENTION IS DIRECTED TO THE FACT THAT THE FOLLOWING HOLIDAY WORK RESTRICTIONS ARE APPLICABLE TO THIS PROJECT. DURING THESE HOLIDAY PERIODS, THE CONTRACTOR WILL NOT BE ALLOWED TO PERFORM ANY WORK THAT WILL BE DISRUPTIVE TO TRAFFIC, INCLUDING BUT NOT LIMITED TO LANE CLOSURES. LANE CLOSURES WILL NOT BE PERMITTED DURING THE FOLLOWING STATE RECOGNIZED HOLIDAYS:
 - 1) LABOR DAY 3) CHRISTMAS DAY - SUNDAY, DECEMBER 25, 2022
 - MONDAY, SEPTEMBER 5, 2022 2) THANKSGIVING DAY - THURSDAY, NOVEMBER 24, 2022
 - 4) NEW YEAR'S DAY 5) MEMORIAL DAY 7) LABOR DAY
 - SUNDAY, JANUARY 1, 2023 MONDAY, MAY 29, 2023 6) INDEPENDENCE DAY - TUESDAY, JULY 4, 2023 MONDAY, SEPTEMBER 4, 2023
 - 8) THANKSGIVING DAY THURSDAY, NOVEMBER 23, 2023 9) CHRISTMAS DAY - MONDAY, DECEMBER 25, 2023 10) NEW YEAR'S DAY - MONDAY, JANUARY 1, 2024 11) MEMORIAL DAY MONDAY, MAY 27, 2024
 - 12) INDEPENDENCE DAY THURSDAY, JULY 4, 2024 MONDAY, SEPTEMBER 2, 2024 13) LABOR DAY 14) THANKSGIVING DAY - THURSDAY, NOVEMBER 28, 2024 15) CHRISTMAS DAY - WEDNESDAY, DECEMBER 25, 2024
 - 16) NEW YEAR'S DAY WEDNESDAY, JANUARY 1, 2025
 - MONDAY, MAY 26, 2025 17) MEMORIAL DAY 18) INDEPENDENCE DAY - FRIDAY, JULY 4, 2025 19) LABOR DAY MONDAY, SEPTEMBER 1, 2025 20) THANKSGIVING DAY - THURSDAY, NOVEMBER 27, 2025

21) CHRISTMAS DAY - THURSDAY, DECEMBER 25, 2025

- 26. LANE CLOSURES SHALL BE SUSPENDED AS FOLLOWS:
 - BEGINNING 6AM, FRIDAY SEPTEMBER 2, 2022 AND ENDING 6AM, TUESDAY SEPTEMBER 6, 2022 - BEGINNING 6AM, WEDNESDAY NOVEMBER 23, 2022 AND ENDING 6AM, MONDAY NOVEMBER 28, 2022 - BEGINNING 6AM, FRIDAY DECEMBER 23, 2022 AND ENDING 6AM, TUESDAY DECEMBER 27, 2022
 - BEGINNING 6AM, FRIDAY DECEMBER 30, 2022 AND ENDING 6AM, TUESDAY JANUARY 3, 2023
 - BEGINNING 6AM, FRIDAY MAY 26, 2023 AND ENDING 6AM. TUESDAY MAY 30. 2023 - BEGINNING 6AM, SATURDAY JULY 1, 2023 AND ENDING 6AM, WEDNESDAY JULY 5, 2023
 - BEGINNING 6AM, FRIDAY SEPTEMBER 1, 2023 AND ENDING 6AM, TUESDAY SEPTEMBER 5, 2023 - BEGINNING 6AM, WEDNESDAY NOVEMBER 22, 2023 AND ENDING 6AM, MONDAY NOVEMBER 27, 2023 - BEGINNING 6AM, FRIDAY DECEMBER 22, 2023 AND ENDING 6AM, TUESDAY DECEMBER 26, 2023
 - BEGINNING 6AM, SUNDAY DECEMBER 30, 2023 AND ENDING 6AM, WEDNESDAY JANUARY 3, 2024 - BEGINNING 6AM, FRIDAY MAY 24, 2024 AND ENDING 6AM, TUESDAY MAY 28, 2024
 - BEGINNING 6AM, MONDAY JULY 1, 2024 AND ENDING 6AM, FRIDAY JULY 5, 2024
 - BEGINNING 6AM, FRIDAY AUGUST 30, 2024 AND ENDING 6AM, TUESDAY SEPTEMBER 3, 2024 - BEGINNING 6AM, WEDNESDAY NOVEMBER 27, 2024 AND ENDING 6AM, MONDAY DECEMBER 2, 2024 - BEGINNING 6AM, FRIDAY DECEMBER 20, 2024 AND ENDING 6AM, THURSDAY DECEMBER 26, 2024
 - BEGINNING 6AM, TUESDAY DECEMBER 30, 2024 AND ENDING 6AM, FRIDAY JANUARY 3, 2025 - BEGINNING 6AM, FRIDAY MAY 23, 2025 AND ENDING 6AM, TUESDAY MAY 27, 2025
 - BEGINNING 6AM, THURSDAY JULY 3, 2025 AND ENDING 6AM, MONDAY JULY 7, 2025 - BEGINNING 6AM, FRIDAY AUGUST 29, 2025 AND ENDING 6AM, TUESDAY SEPTEMBER 2, 2025 - BEGINNING 6AM, WEDNESDAY NOVEMBER 26, 2025 AND ENDING 6AM, MONDAY DECEMBER 1, 2025

- BEGINNING 6AM, WEDNESDAY DECEMBER 24, 2025 AND ENDING 6AM, MONDAY DECEMBER 29, 2025

- 27. DURING WINTER STORM EVENTS. NO WORK WITHIN THE ROAD RIGHT-OF-WAY IS PERMITTED TO ALLOW FOR SNOW REMOVAL. PLOWING ACTIVITIES.
- 28. ANY EARTHWORK DONE BETWEEN NOVEMBER 1ST AND APRIL 1ST MUST CONFORM TO NYSDOT STANDARD SPECIFICATION SECTION 203-1.01 P.
- 29. ALL OPEN TRENCH EXCAVATIONS SHALL BE BACKFILLED OR COVERED BY A STEEL PLATE (HS-20 LOAD RATED) AT THE END OF EACH WORK DAY, OR AS DIRECTED BY THE ENGINEER.

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LEGEND

TEMPORARY SIGN



TEMPORARY TRAFFIC SIGNAL UNIT



WORK ZONE

TEMPORARY CONCRETE BARRIER (TCB) FLAGGER

FLAG TREE

WORK VEHICLE WITH TRUCK MOUNTED ATTENUATOR

FLASH UNIT (LEFT ARROW)

FLASH UNIT (CAUTION MODE)

TYPE III BARRICADE TRAILER UNIT

WARNING LIGHT ON SIGN

ABBREVIATIONS

AVERAGE ANNUAL DAILY TRAFFIC

COUNTY ROUTE

DIRECTIONAL HOURLY VOLUME FLASHING ARROW SIGN UNIT

FEDERAL HIGHWAY ADMINISTRATION

MAXIMUM MINIMUM

MILES PER HOUR

MILE POST

MANUAL ON UNIFORM TRAFFIC CONTROL DEVICES NYS NEW YORK STATE

NEW YORK STATE DEPARTMENT OF TRANSPORTATION RTE ROUTE

TEMPORARY CONCRETE BARRIER

FINAL EM&CP SUBMISSION

SUBMITTAL / REVISION DESCRIPTION

STA. STATION

TEMPORARY TRAFFIC FLOW ARROW

09/21/2022

CHAMPLAIN HUDSON POWER EXPRESS SEGMENT 2 - ROUTE 22: DRESDEN - WHITEHALL

> WORK ZONE TRAFFIC CONTROL NOTES LEGEND AND ABBREVIATIONS

21162 CHA PROJECT NO. 066076 DRAWING NO.


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09/21/2022 OF XXX

Champlain Hudson Power Express





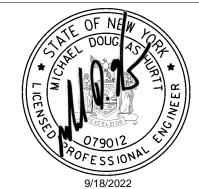

IT IS A VIOLATION OF LAW FOR ANY PERSON, UNLESS THEY ARE ACTING UNDER THE DIRECTION OF A LICENSED OR LAND SURVEYOR TO ALTER AN ITEM IN ANY WAY. IF AN ALTERED THE ALTERING ENGINEER ARCHITECT LANDSCAPE ARCHITECT OR LAND SURVEYOR SHALL STAMP THE DOCUMENT AND INCLUDE THE NOTATION "ALTERED BY" FOLLOWED BY THFIR SIGNATURE. THE DATE OF SUCH ALTERATION, AND A SPECIFIC DESCRIPTION OF THE ALTERATION.

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KIEWIT PROJECT NO.

C-501

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OR LAND SURVEYOR TO ALTER AN ITEM IN ANY WAY. IF AN	
TEM BEARING THE STAMP OF A LICENSED PROFESSIONAL IS	
ALTERED, THE ALTERING ENGINEER, ARCHITECT, LANDSCAPE	
RCHITECT OR LAND SURVEYOR SHALL STAMP THE DOCUMENT	
AND INCLUDE THE NOTATION "ALTERED BY" FOLLOWED BY	
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CHAMPLAIN HUDSON POWER EXPRESS SEGMENT 2 - ROUTE 22: DRESDEN - WHITEHALL


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WORK ZONE TRAFFIC CONTROL

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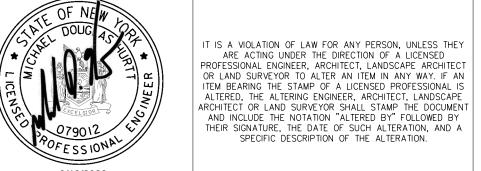


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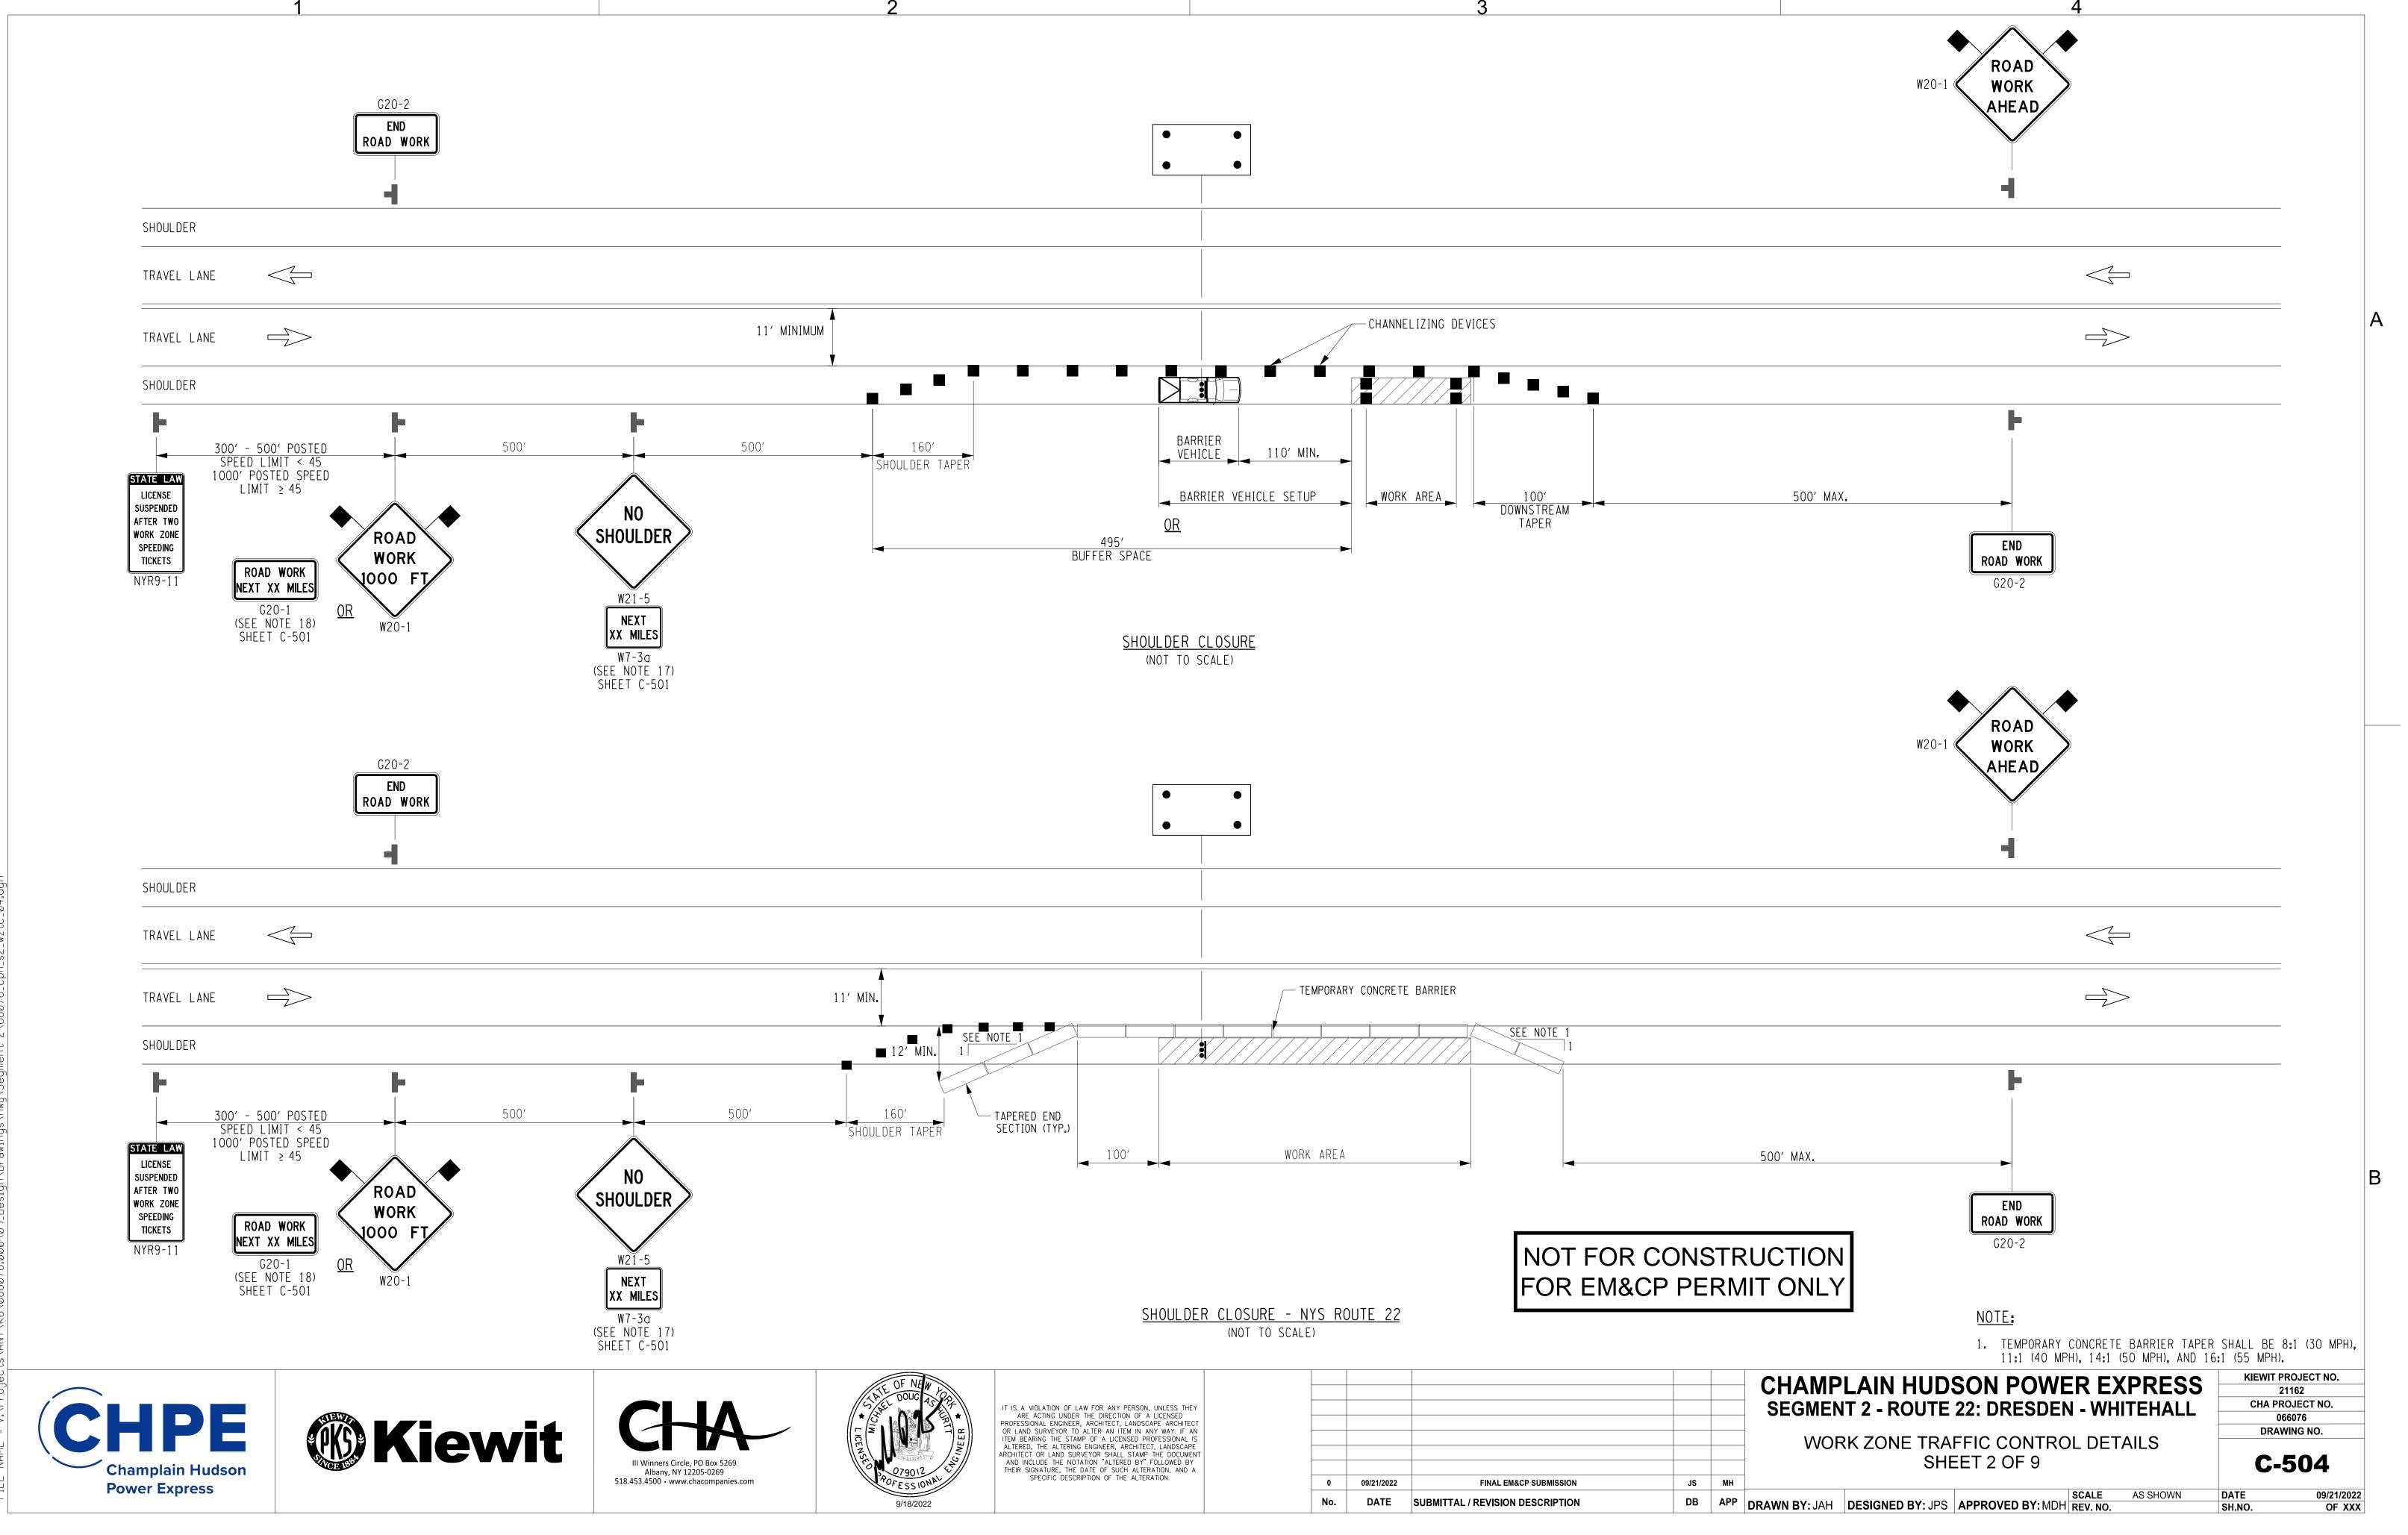
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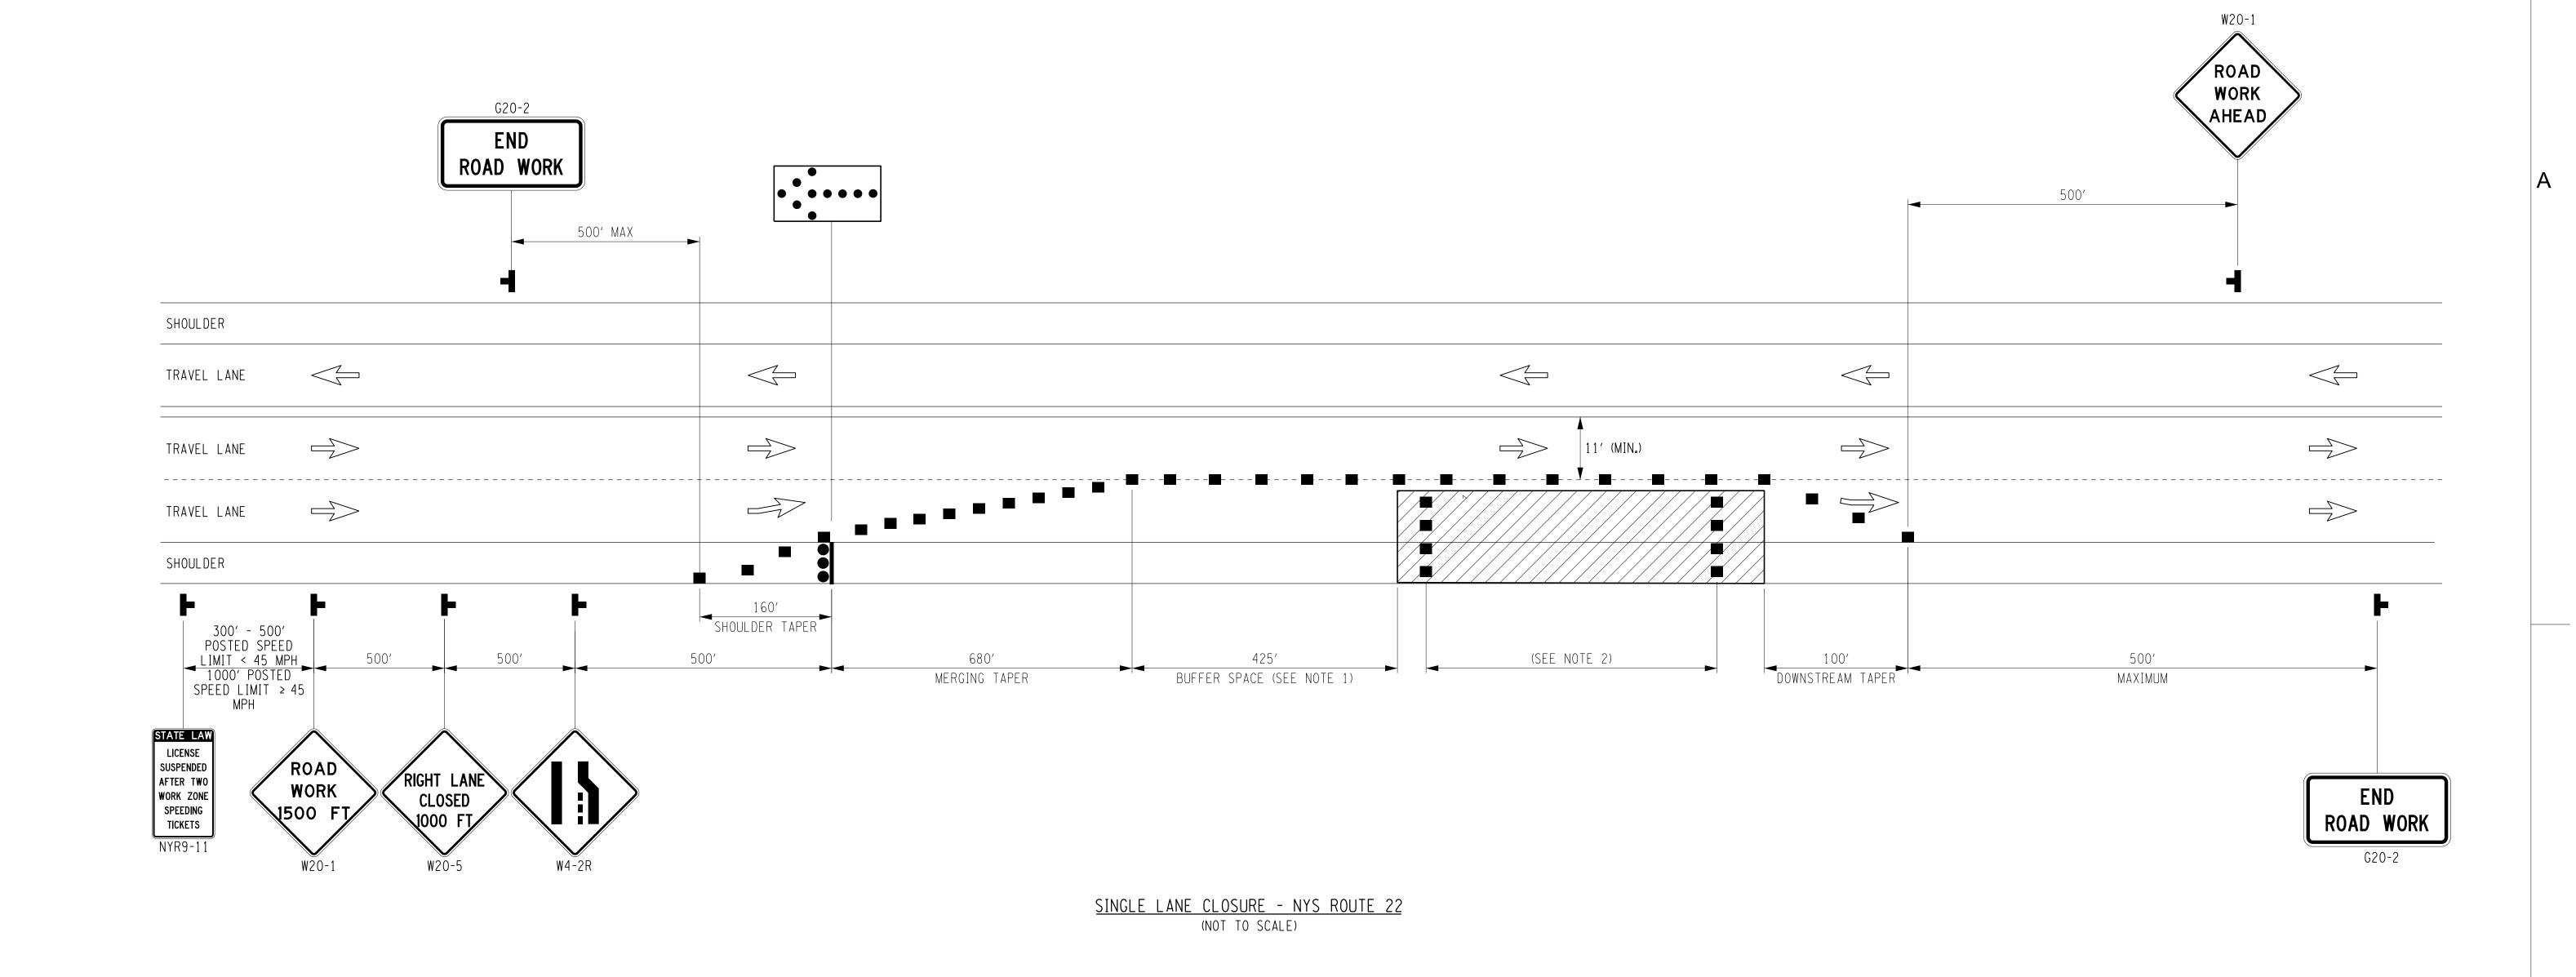
CHAMPLAIN HUDSON POWER EXPRESS **SEGMENT 2 - ROUTE 22: DRESDEN - WHITEHALL**

WORK ZONE TRAFFIC CONTROL DETAILS SHEET 1 OF 9

KIEWIT PROJECT NO.
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DRAWING NO.

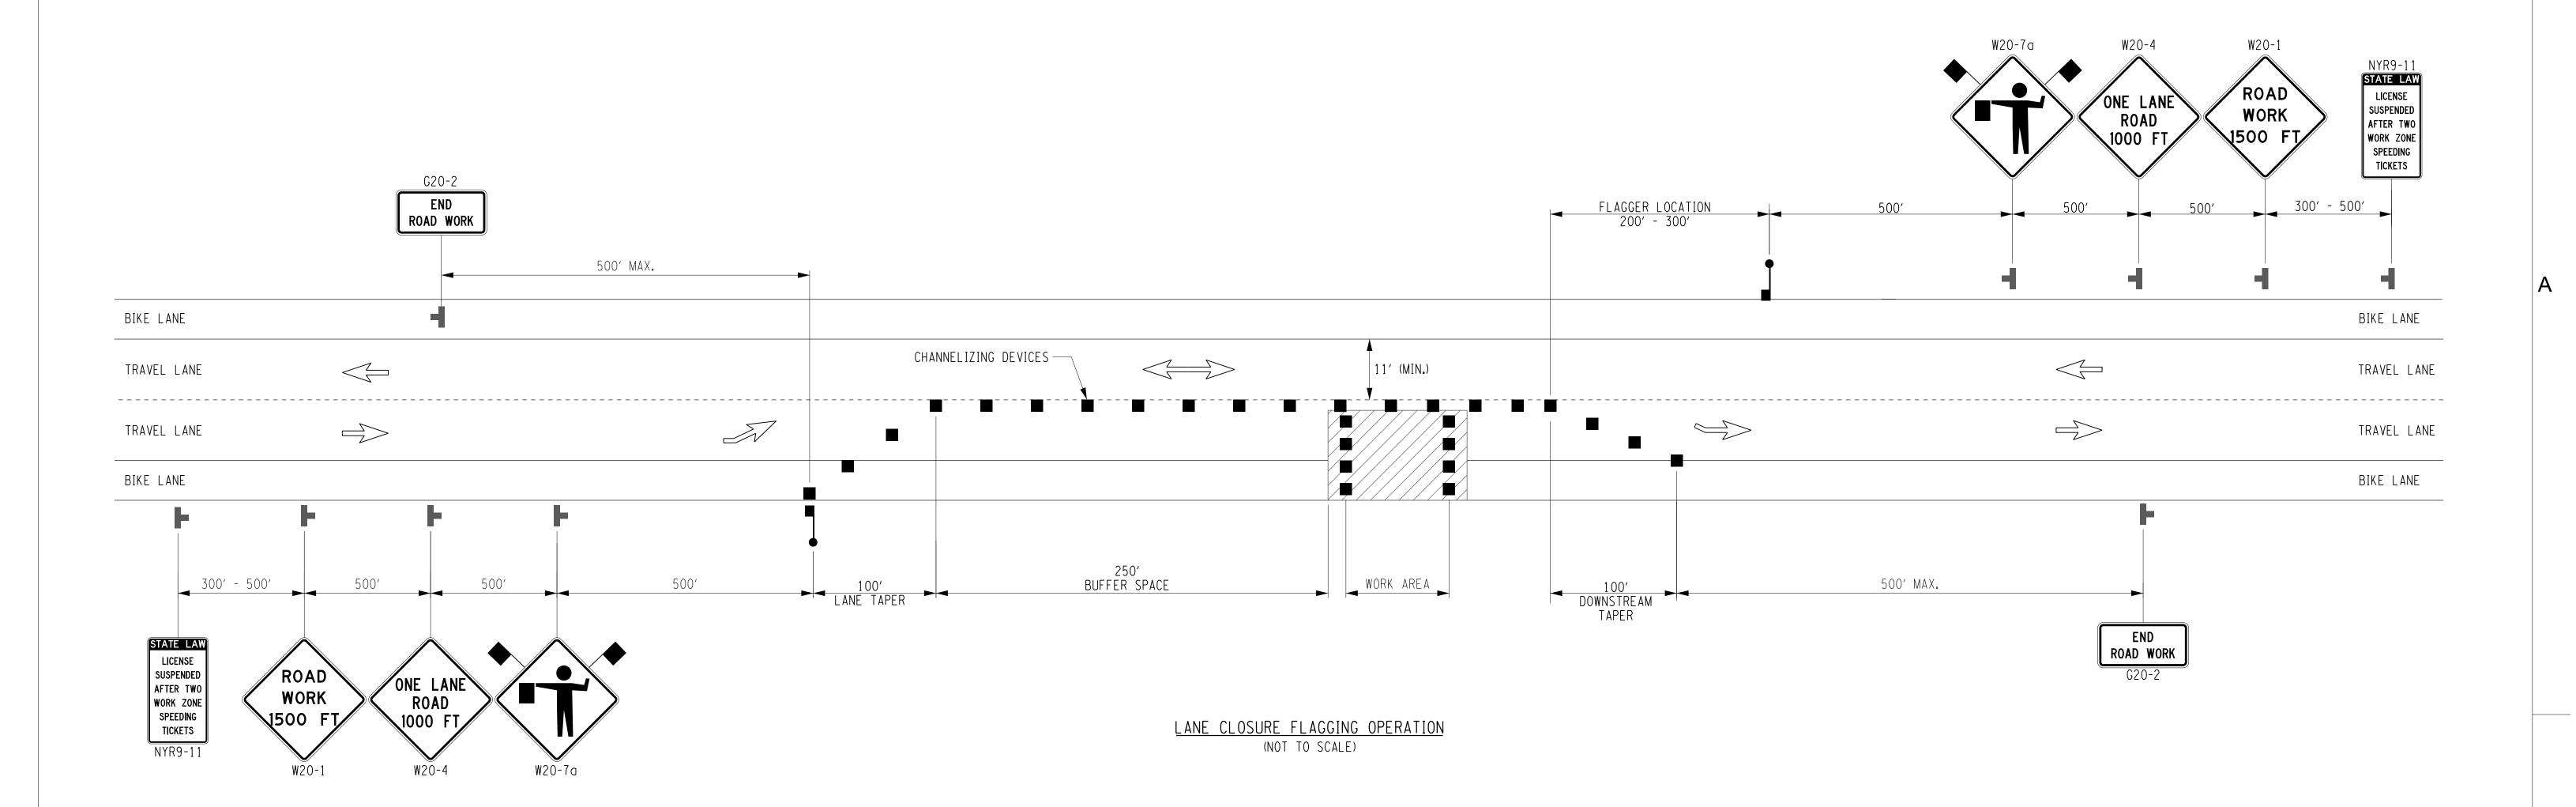C-503





NOTES:

- 1. NO WORK ACTIVITY, EQUIPMENT OR STORAGE OF VEHICLES, OR MATERIAL SHALL OCCUR WITHIN THE BUFFER SPACÉ AT ANY TIME.
- 2. TRANSVERSE DEVICES SHALL BE REQUIRED (AS PER 619 STANDARD SPECIFICATIONS) WHEN A PAVED SHOULDER HAVING A WIDTH OF 8' OR GREATER IS CLOSED FOR A DISTANCE GREATER THAN 1500'.


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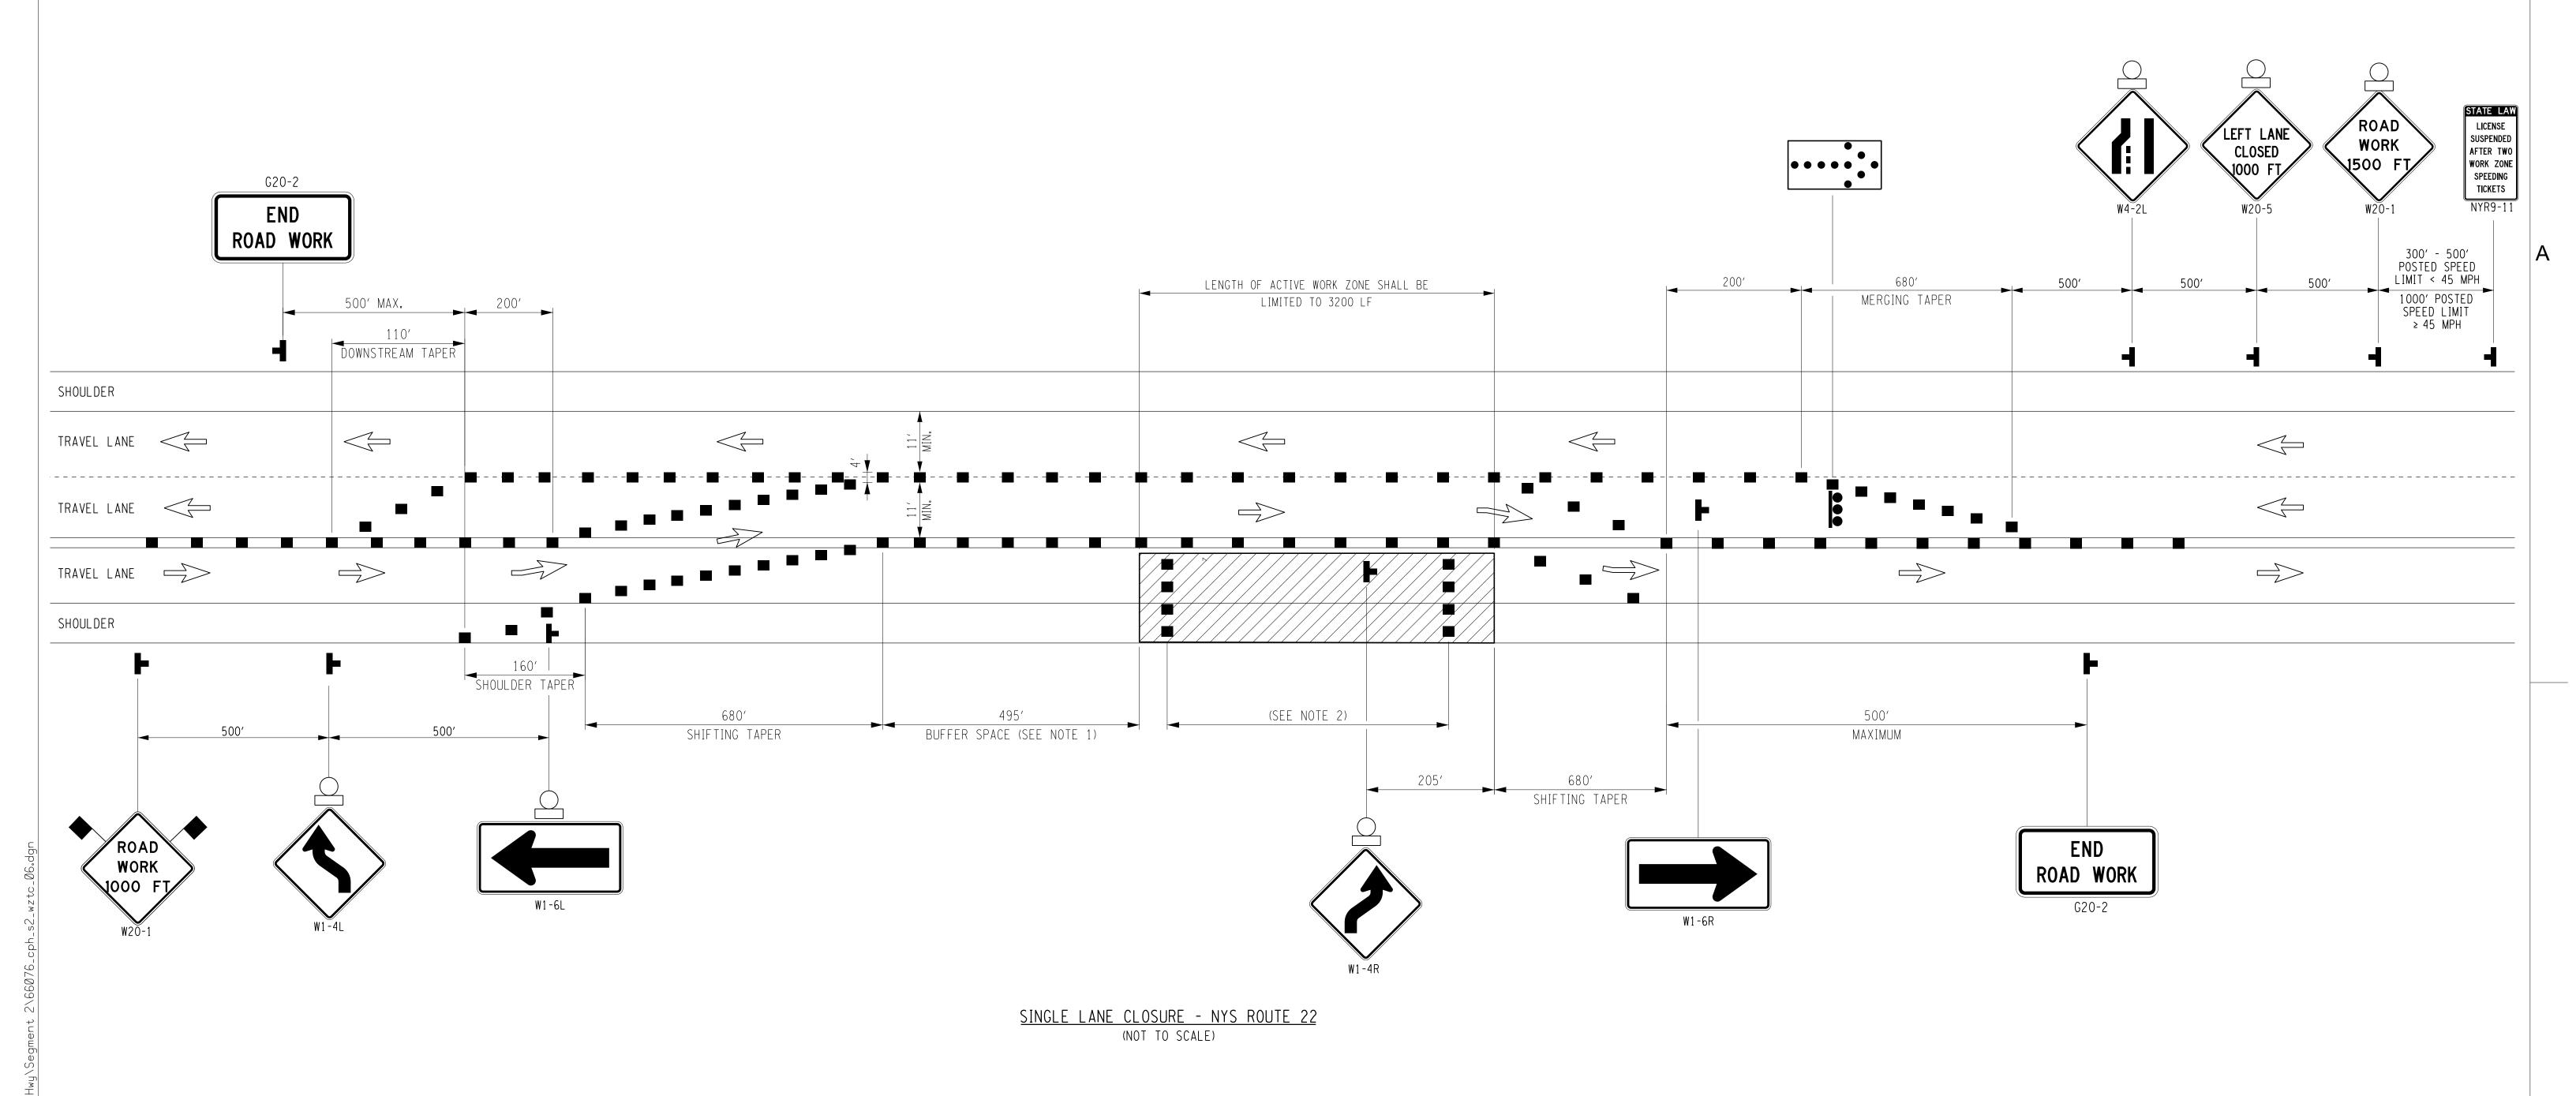
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CHAMPLAIN HUDSON POWER EXPRESS **SEGMENT 2 - ROUTE 22: DRESDEN - WHITEHALL**

WORK ZONE TRAFFIC CONTROL DETAILS SHEET 3 OF 9

KIEWIT PROJECT NO. 21162 CHA PROJECT NO. 066076 DRAWING NO. **C-505**

SH.NO. OF XXX

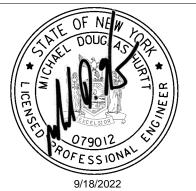

NOTES:

- 1. NO WORK ACTIVITY, EQUIPMENT OR STORAGE OF VEHICLES, OR MATERIAL SHALL OCCUR WITHIN THE BUFFER SPACE AT ANY TIME.
- 2. TRANSVERSE DEVICES SHALL BE REQUIRED (AS PER 619 STANDARD SPECIFICATIONS) WHEN A PAVED SHOULDER HAVING A WIDTH OF 8' OR GREATER IS CLOSED FOR A DISTANCE GREATER


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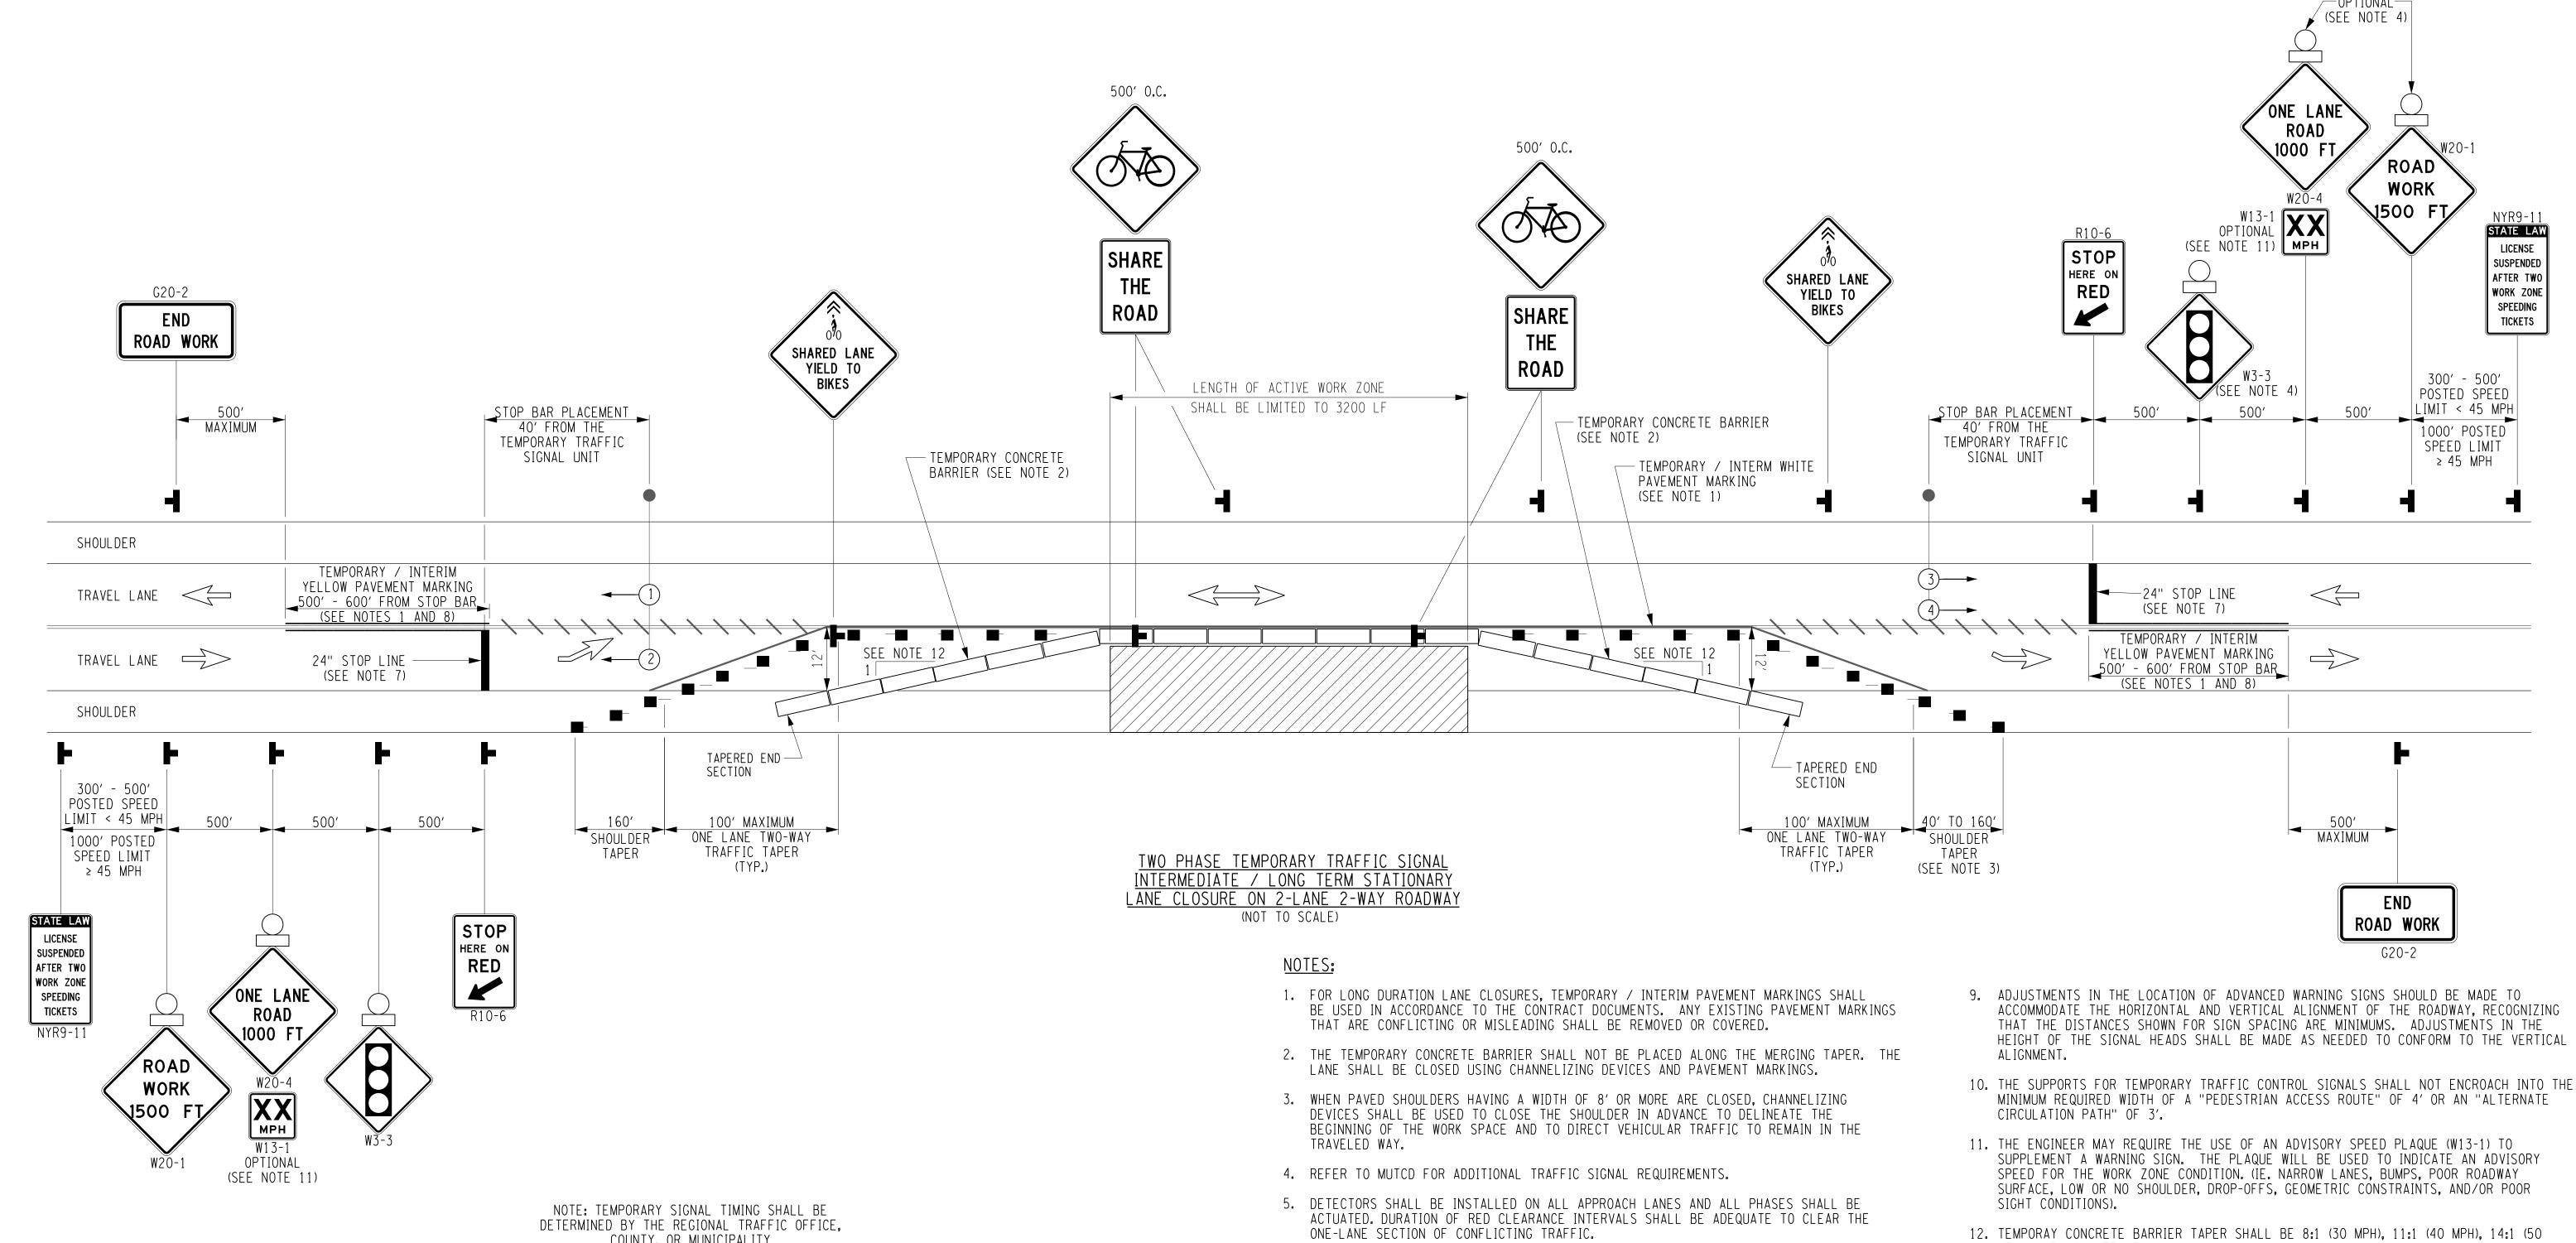
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CHAMPLAIN HUDSON POWER EXPRESS **SEGMENT 2 - ROUTE 22: DRESDEN - WHITEHALL**

WORK ZONE TRAFFIC CONTROL DETAILS SHEET 4 OF 9

KIEWIT PROJECT NO. 21162 CHA PROJECT NO. 066076 DRAWING NO. **C-506**



COUNTY, OR MUNICIPALITY

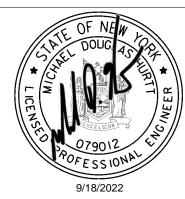OPERATIONAL SCHEDULE FOR TEMPORARY TRAFFIC SIGNALS						
PHASE FACE	1	2	3	4		
1	G	G	R	R		
CLEARANCE	Υ	Y	R	R		
ALL RED	R	R	R	R		
2	R	R	G	G		
CLEARANCE	R	R	Y	Y		
ALL RED	R	R	R	R		
EMERGENCY FLASH	FR	FR	FR	FR		

MPH), AND 16:1 (55 MPH).

13. LIMITS OF LONG-TERM LANE CLOSURE WITH TEMPORARY CONCRETE BARRIER SHALL BE ESTABLISHED BETWEEN EXISTING DRIVEWAYS AND SIDEROADS; UNLESS TEMPORARY SIGNALIZATION OF EXISTING DRIVEWAYS AND/OR SIDE ROADS CAN BE PROVIDED AND COORDINATED WITH THE MAINLINE TEMPORARY SIGNALS, AS DIRECTED BY THE ENGINEER.

14. LONG-TERM LANE CLOSURES ARE ANTICIPATED TO BE IN PLACE AT ANY ONE LOCATION FOR APPROXIMATELY ONE WEEK (7 DAYS).


15. WORK SPACE LIMITS SHALL BE ESTABLISHED TO ALLOW FOR STANDARD DEFLECTION OF TEMPORARY CONCRETE BARRIER AS DEFINED IN SECTION 619 OF THE NYSDOT STANDARD SPECIFICATIONS.

Champlain Hudson

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	ARE CONFLICTING (OR MIS	LEADING SI	HALL BE REMOVED OR COVERED.			

6. THE TRAFFIC SIGNAL CYCLE SHALL REST IN RED. WHEN THE SIGNAL IS CHANGED TO THE FLASHING MODE, EITHER MANUALLY OR AUTOMATICALLY, RED SIGNAL INDICATIONS SHALL

7. STOP LINES SHALL BE INSTALLED WITH TEMPORARY TRAFFIC SIGNALS FOR INTERMEDIATE AND LONG-TERM CLOSURES. EXISTING, CONFLICTING PAVEMENT MARKINGS AND RAISED PAVEMENT MARKINGS, BETWEEN THE ACTIVITY AREA AND THE STOP LINE, SHALL BE

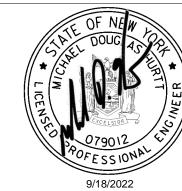8. WHERE NO-PASSING LINES ARE NOT ALREADY IN PLACE, THEY SHALL BE ADDED FOR A

DISTANCE OF 500'-600' FROM THE STOP BAR. ANY EXISTING PAVEMENT MARKINGS THAT

REMOVED. AFTER THE TEMPORARY TRAFFIC SIGNAL IS REMOVED, THE STOP LINES AND ALL

TEMPORARY PAVEMENT MARKINGS SHALL BE REMOVED AND PERMANENT PAVEMENT MARKINGS

BE FLASHED TO ALL APPROACHES.

RESTORED.

CHAMPLAIN HUDSON POWER EXPRESS **SEGMENT 2 - ROUTE 22: DRESDEN - WHITEHALL**

21162 CHA PROJECT NO. 066076 DRAWING NO. WORK ZONE TRAFFIC CONTROL DETAILS

SHEET 5 OF 9


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SCALE AS SHOWN DRAWN BY: JAH DESIGNED BY: JPS APPROVED BY: MDH REV. NO.

KIEWIT PROJECT NO.

09/21/2022 SH.NO. OF XXX

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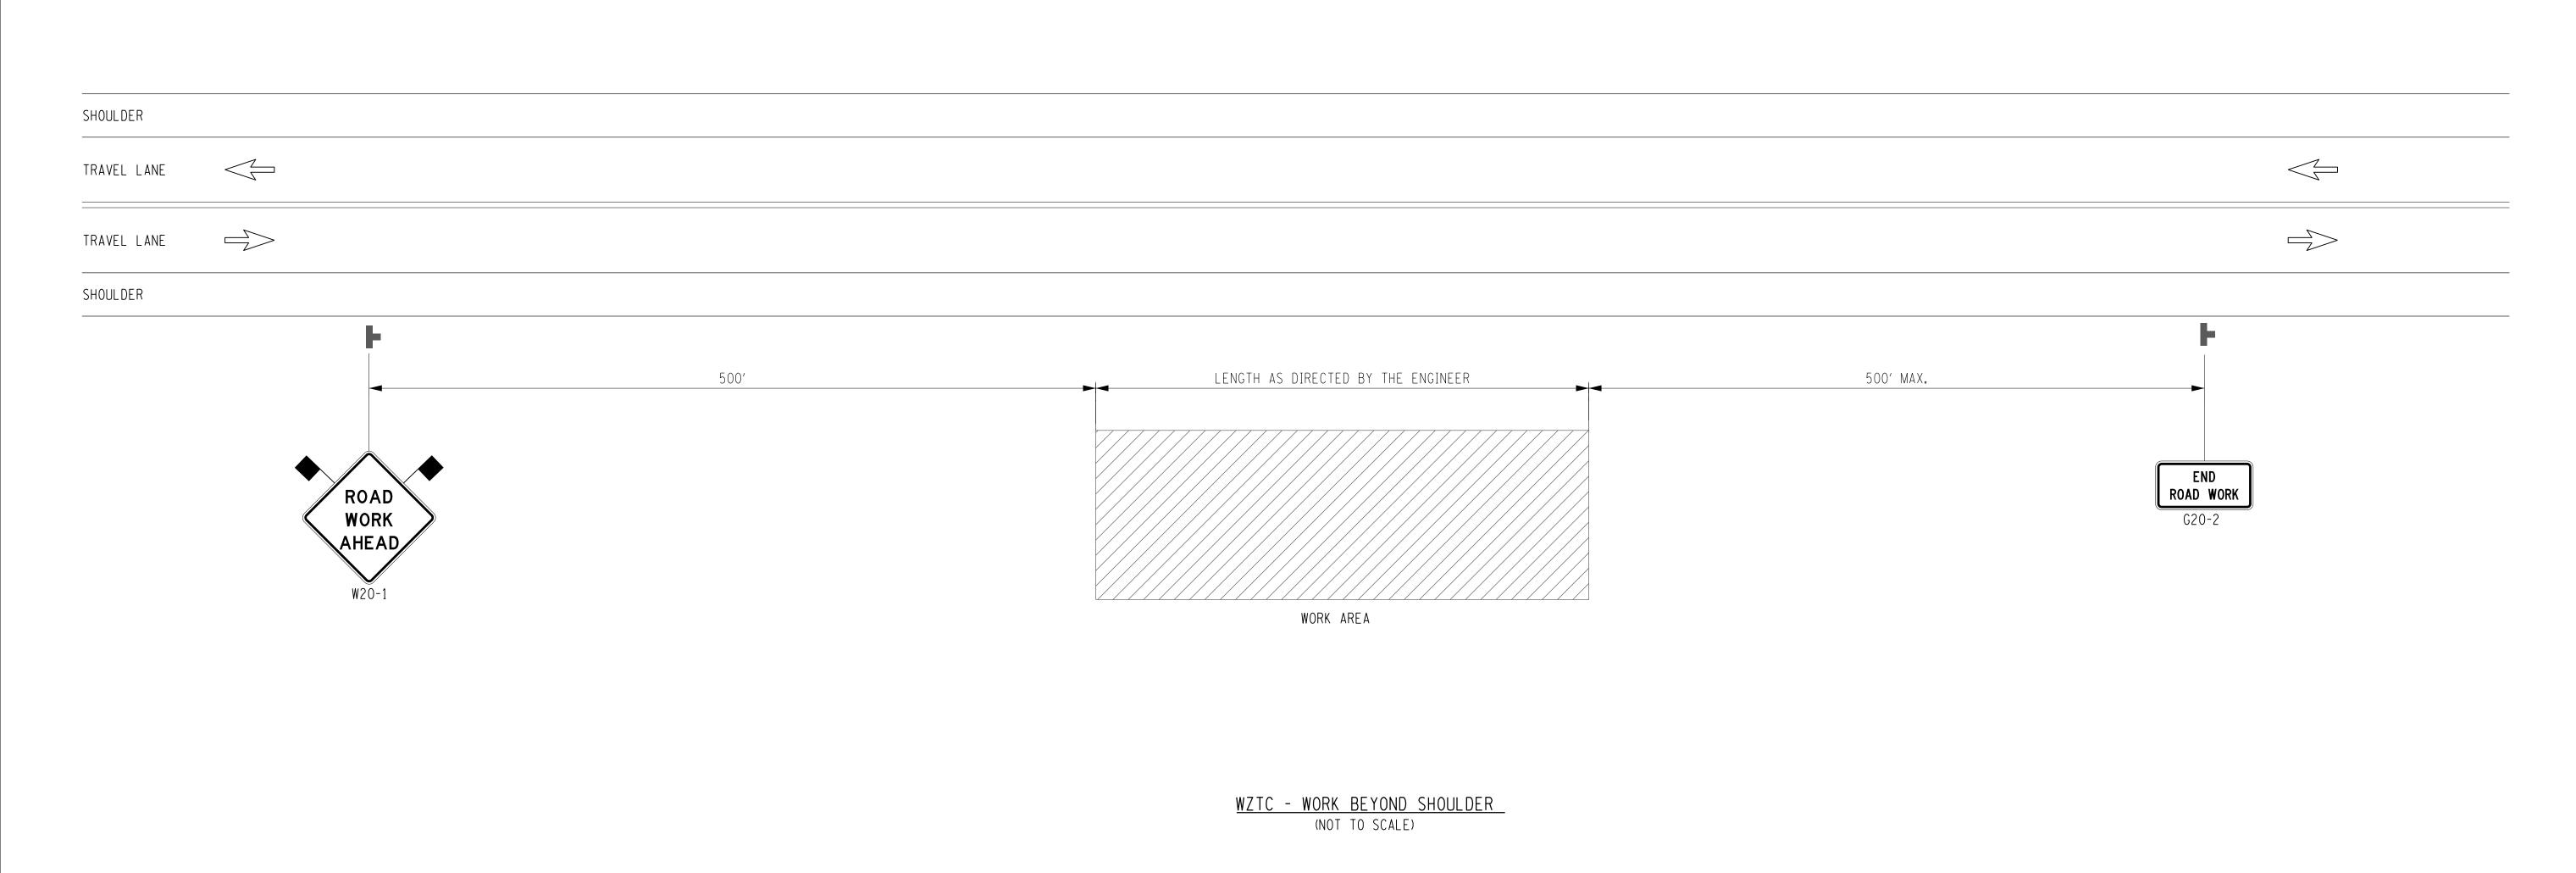
SUBMITTAL / REVISION DESCRIPTION

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DRAWING NO.
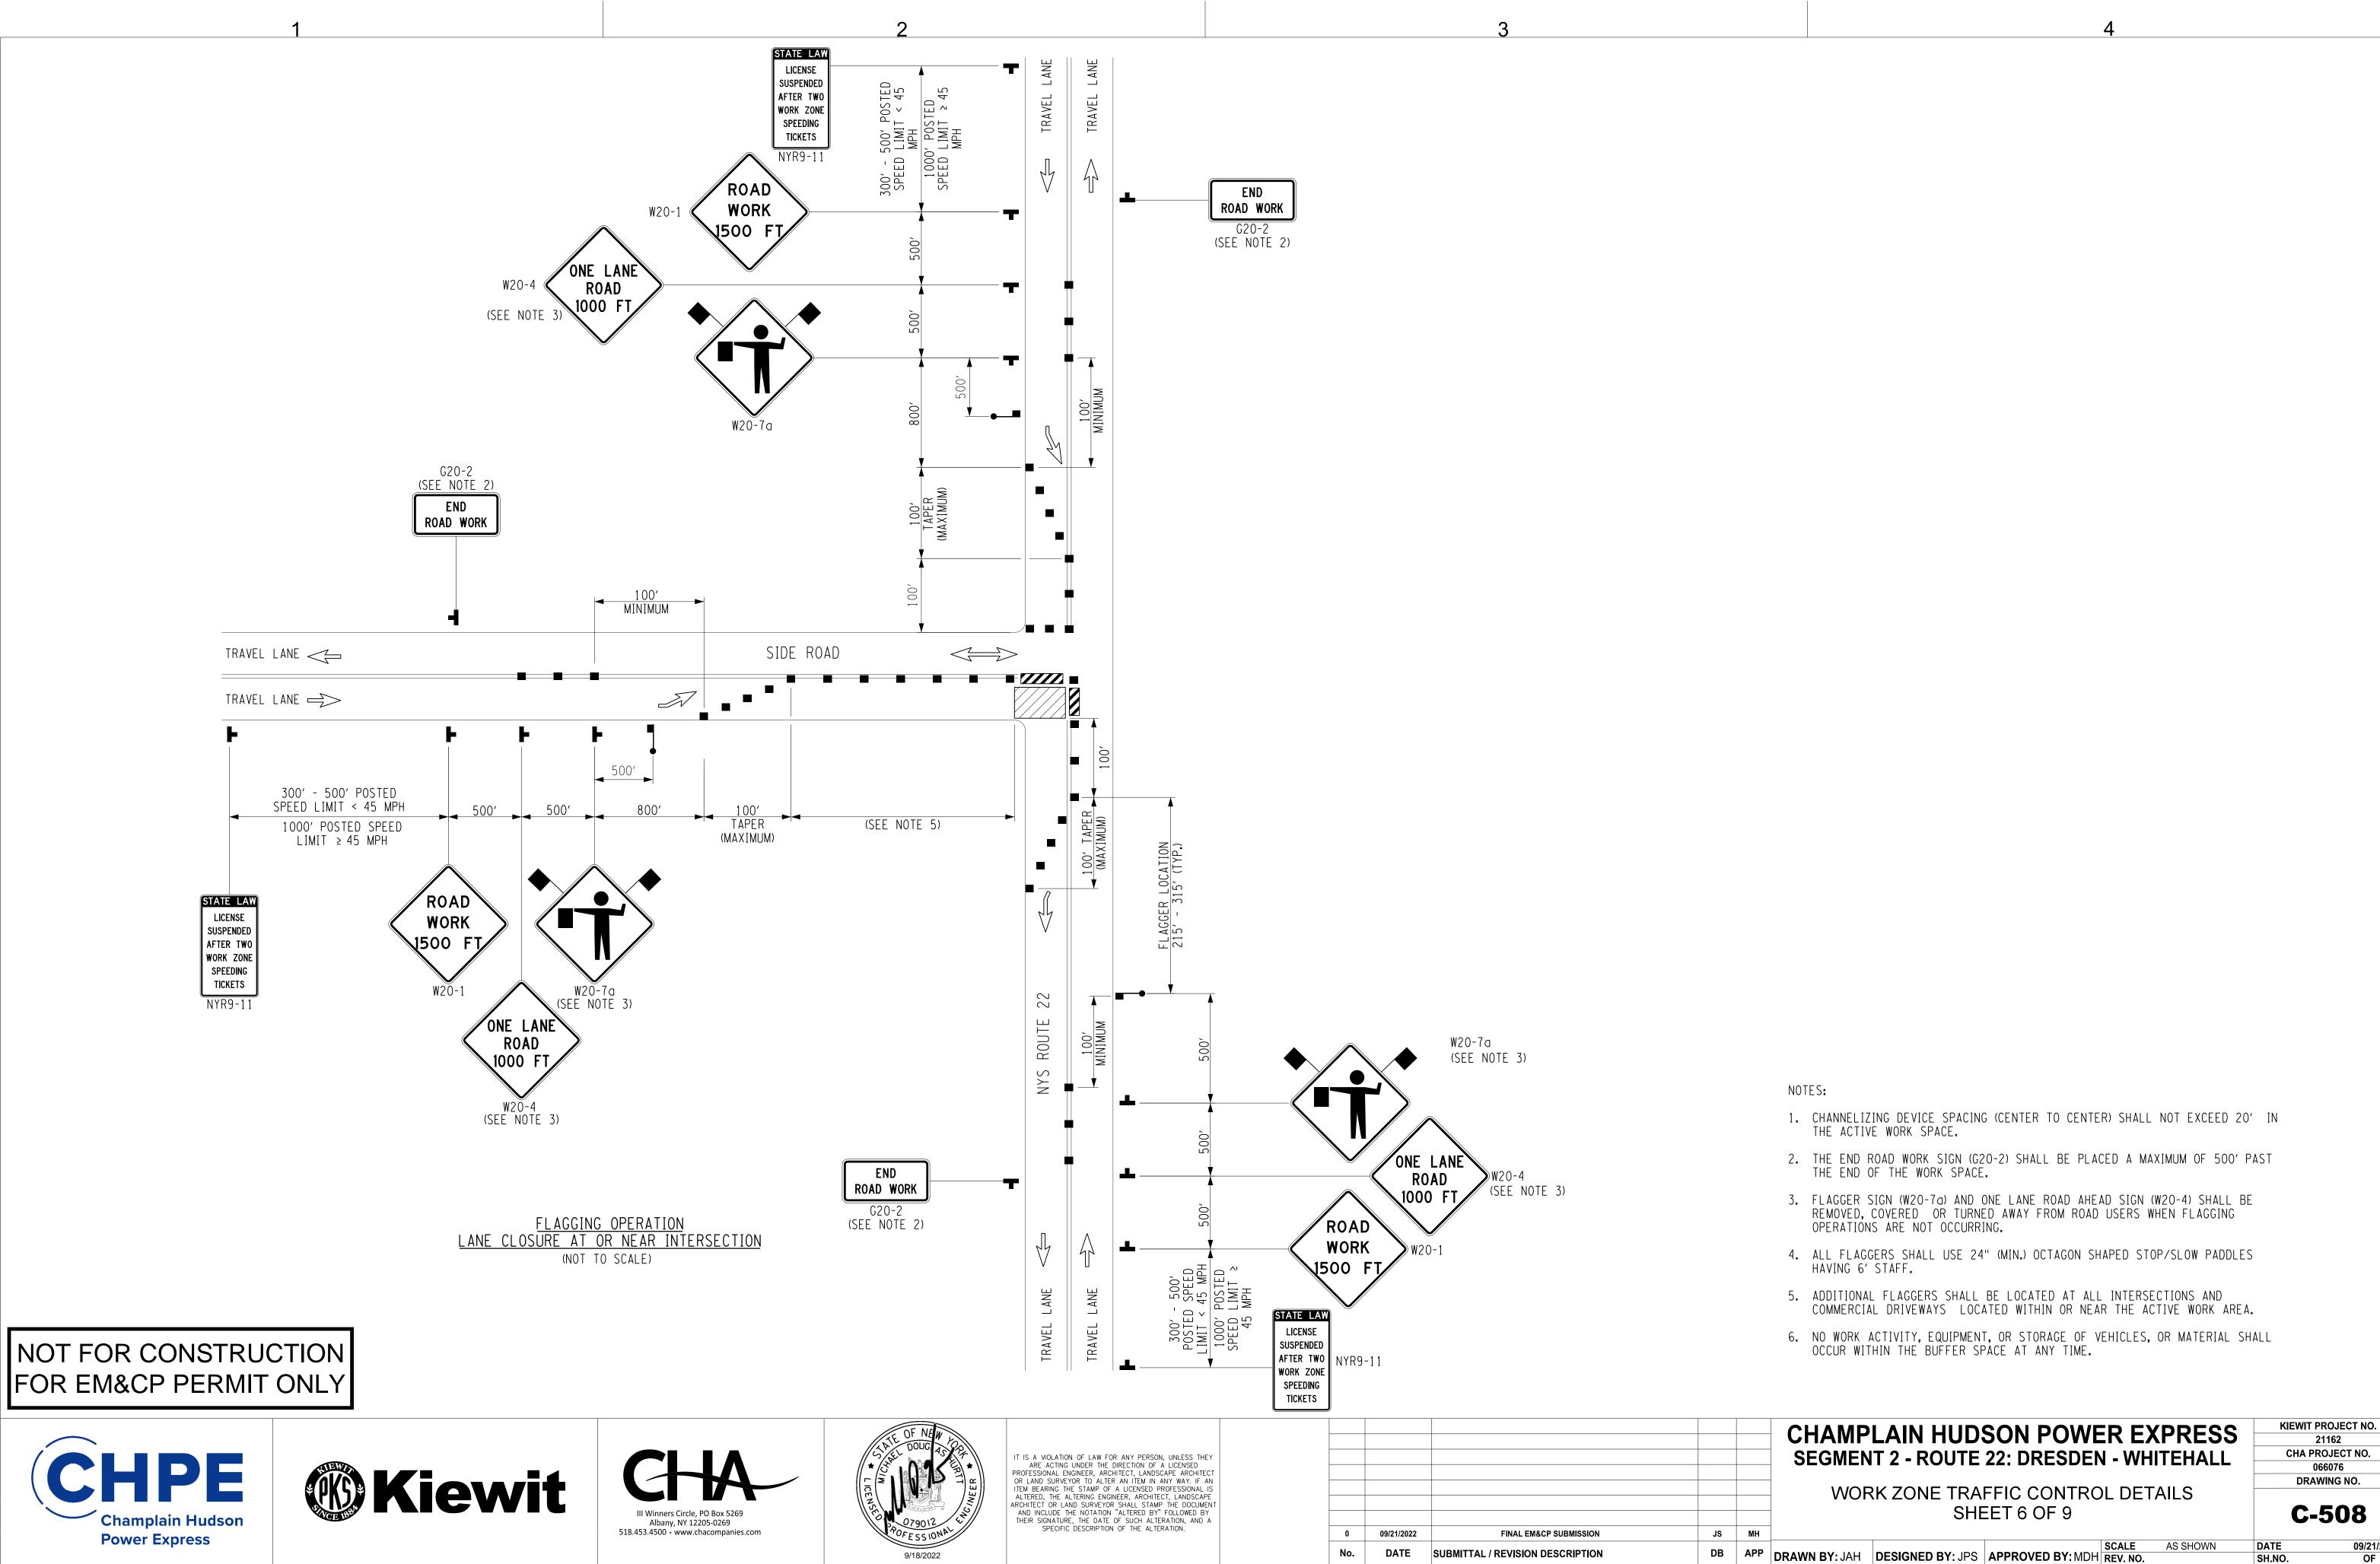
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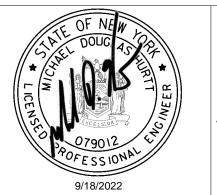
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IT IS A VIOLATION OF LAW FOR ANY PERSON, UNLESS THEY ARE ACTING UNDER THE DIRECTION OF A LICENSED PROFESSIONAL ENGINEER, ARCHITECT, LANDSCAPE ARCHITECT OR LAND SURVEYOR TO ALTER AN ITEM IN ANY WAY. IF AN ITEM BEARING THE STAMP OF A LICENSED PROFESSIONAL IS ALTERED, THE ALTERING ENGINEER, ARCHITECT, LANDSCAPE ARCHITECT OR LAND SURVEYOR SHALL STAMP THE DOCUMENT AND INCLUDE THE NOTATION "ALTERED BY" FOLLOWED BY THEIR SIGNATURE, THE DATE OF SUCH ALTERATION, AND A SPECIFIC DESCRIPTION OF THE ALTERATION.

No.	DATE	SUBMITTAL / REVISION DESCRIPTION	DB	APP	
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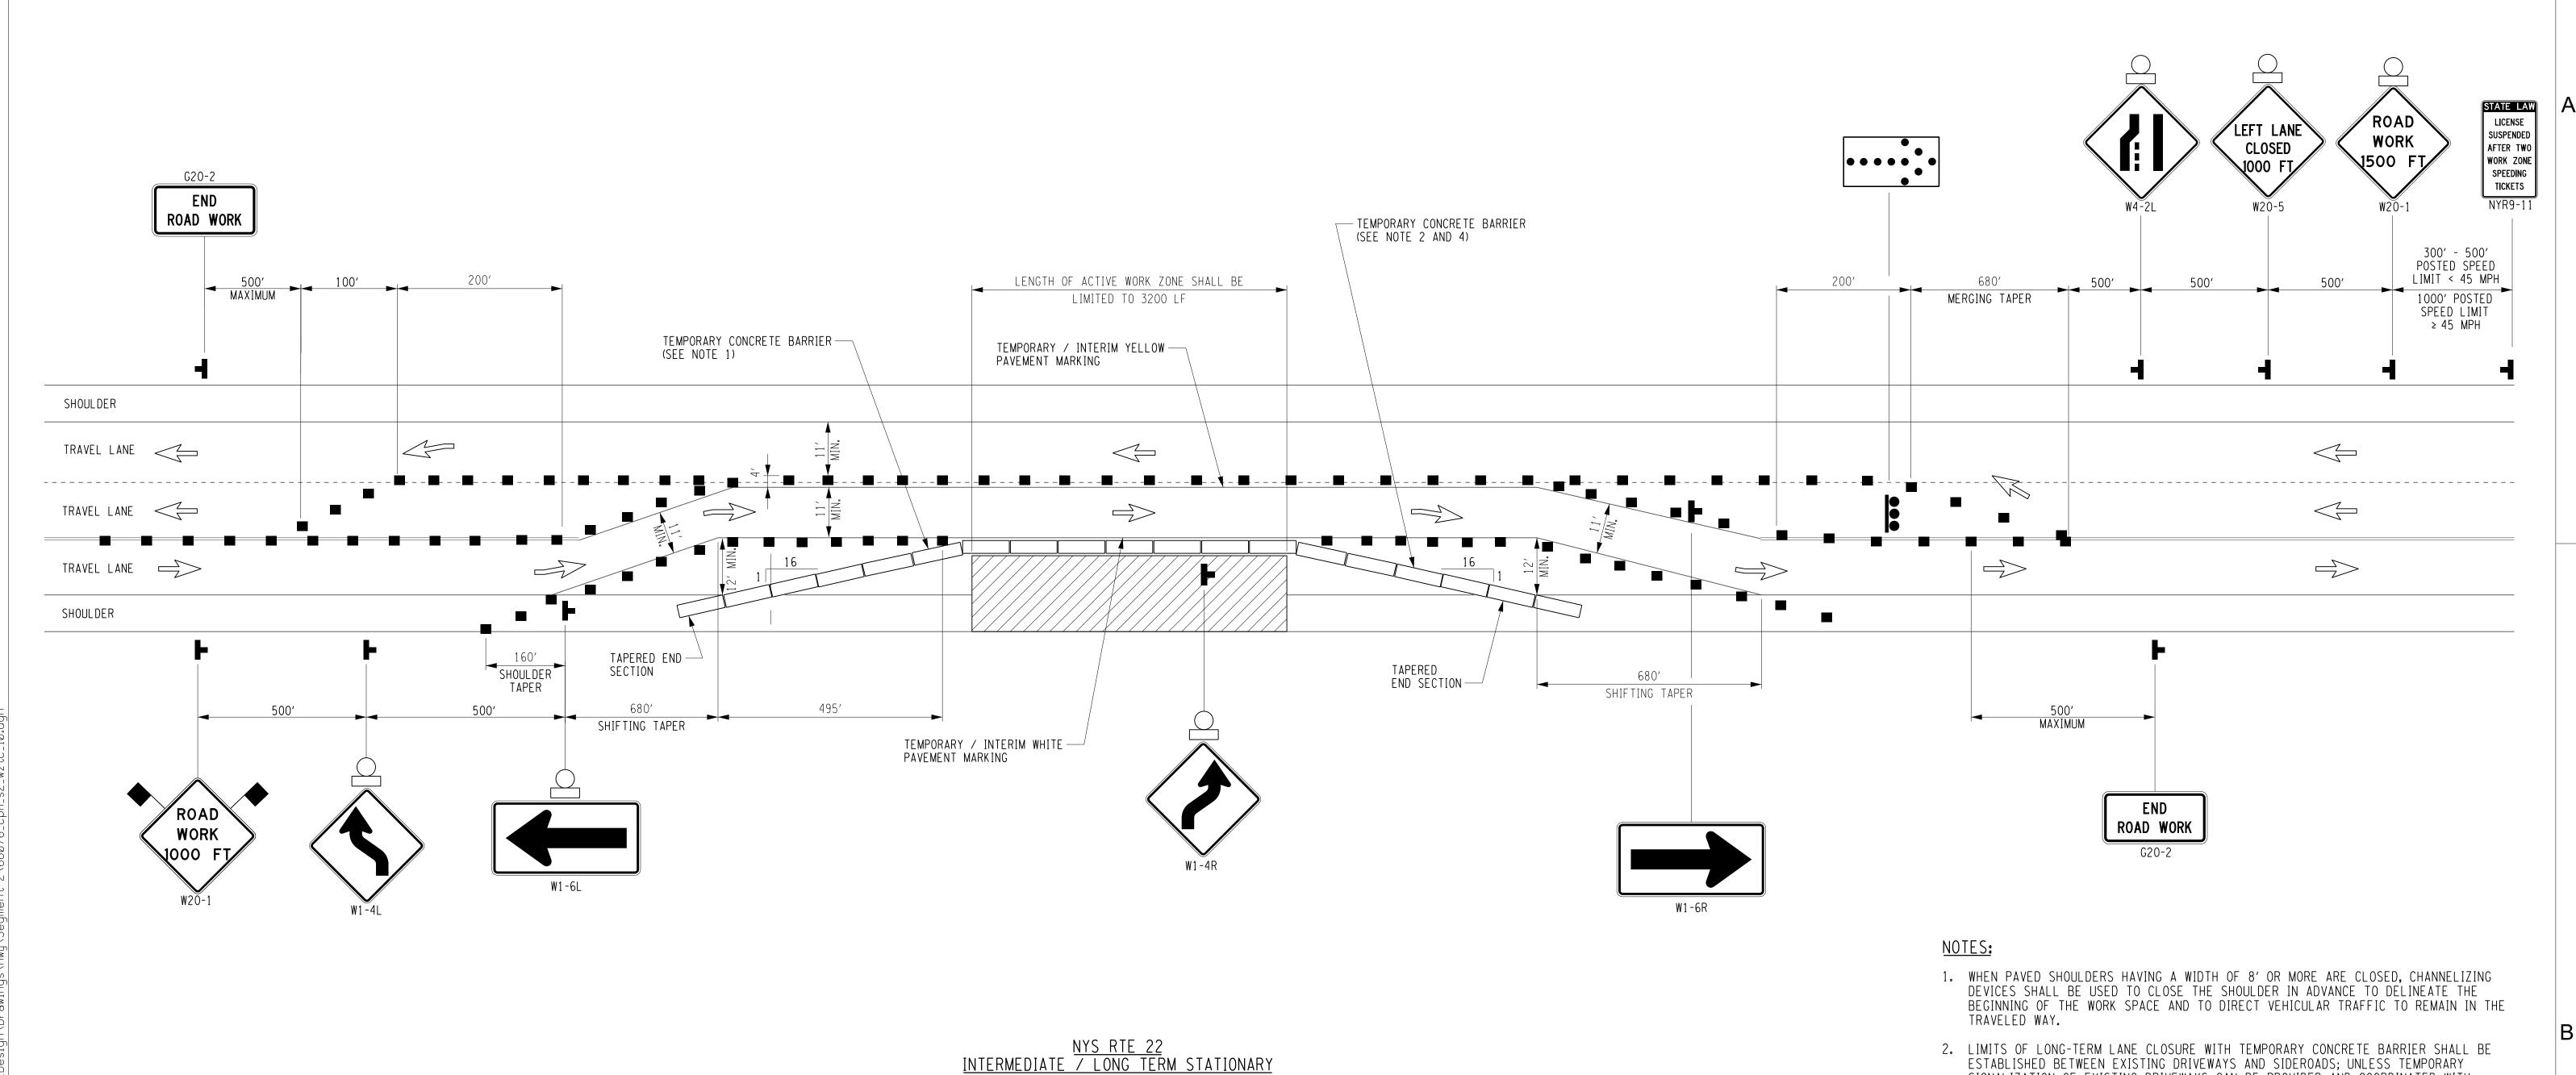
CHAMPLAIN HUDSON POWER EXPRESS SEGMENT 2 - ROUTE 22: DRESDEN - WHITEHALL

WORK ZONE TRAFFIC CONTROL DETAILS SHEET 7 OF 9

KIEWIT PROJECT NO.
21162
CHA PROJECT NO.
066076
DRAWING NO.

C-509

DRAWN BY: JAHDESIGNED BY: JPSAPPROVED BY: MDHSCALEAS SHOWNDATE09/21/2REV. NO.SH.NO.OF 2



LANE CLOSURE ON 3-LANE 2-WAY ROADWAY (NOT TO SCALE)

IT IS A VIOLATION OF LAW FOR ANY PERSON, UNLESS THEY ARE ACTING UNDER THE DIRECTION OF A LICENSED PROFESSIONAL ENGINEER, ARCHITECT, LANDSCAPE ARCHITECT OR LAND SURVEYOR TO ALTER AN ITEM IN ANY WAY. IF AN ITEM BEARING THE STAMP OF A LICENSED PROFESSIONAL IS ALTERED, THE ALTERING ENGINEER, ARCHITECT, LANDSCAPE

ARCHITECT, IHE ALTERING ENGINEER, ARCHITECT, LANDSCAPE ARCHITECT OR LAND SURVEYOR SHALL STAMP THE DOCUMENT AND INCLUDE THE NOTATION "ALTERED BY" FOLLOWED BY THEIR SIGNATURE, THE DATE OF SUCH ALTERATION, AND A SPECIFIC DESCRIPTION OF THE ALTERATION.

09/21/2022

FINAL EM&CP SUBMISSION

SUBMITTAL / REVISION DESCRIPTION

SIGNALIZATION OF EXISTING DRIVEWAYS CAN BE PROVIDED AND COORDINATED WITH THE MAINLINE TEMPORARY SIGNALS, AS DIRECTED BY THE ENGINEER.

3. LONG-TERM LAND CLOSURES ARE ANTICIPATED TO BE IN PLACE AT ANY ONE LOCATION

4. WORK SPACE LIMITS SHALL BE ESTABLISHED TO ALLOW FOR STANDARD DEFLECTION OF

TEMPORARY CONCRETE BARRIER AS DEFINED IN SECTION 619 OF THE NYSDOT STANDARD

AS SHOWN

KIEWIT PROJECT NO.

21162

CHA PROJECT NO.

DRAWING NO.

C-510

SH.NO.

FOR APPROXIMATELY ONE WEEK (7 DAYS).

CHAMPLAIN HUDSON POWER EXPRESS

SEGMENT 2 - ROUTE 22: DRESDEN - WHITEHALL

WORK ZONE TRAFFIC CONTROL DETAILS

SHEET 8 OF 9

SPECIFICATIONS.


DB APP DRAWN BY: JAH DESIGNED BY: JPS APPROVED BY: MDH REV. NO.

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Power Express

Kiewit

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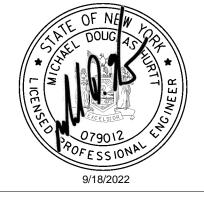


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No.	DATE	SUBMITTAL / REVISION DESCRIPTION	DB	APP	
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CHAMPLAIN HUDSON POWER EXPRESS **SEGMENT 2 - ROUTE 22: DRESDEN - WHITEHALL**

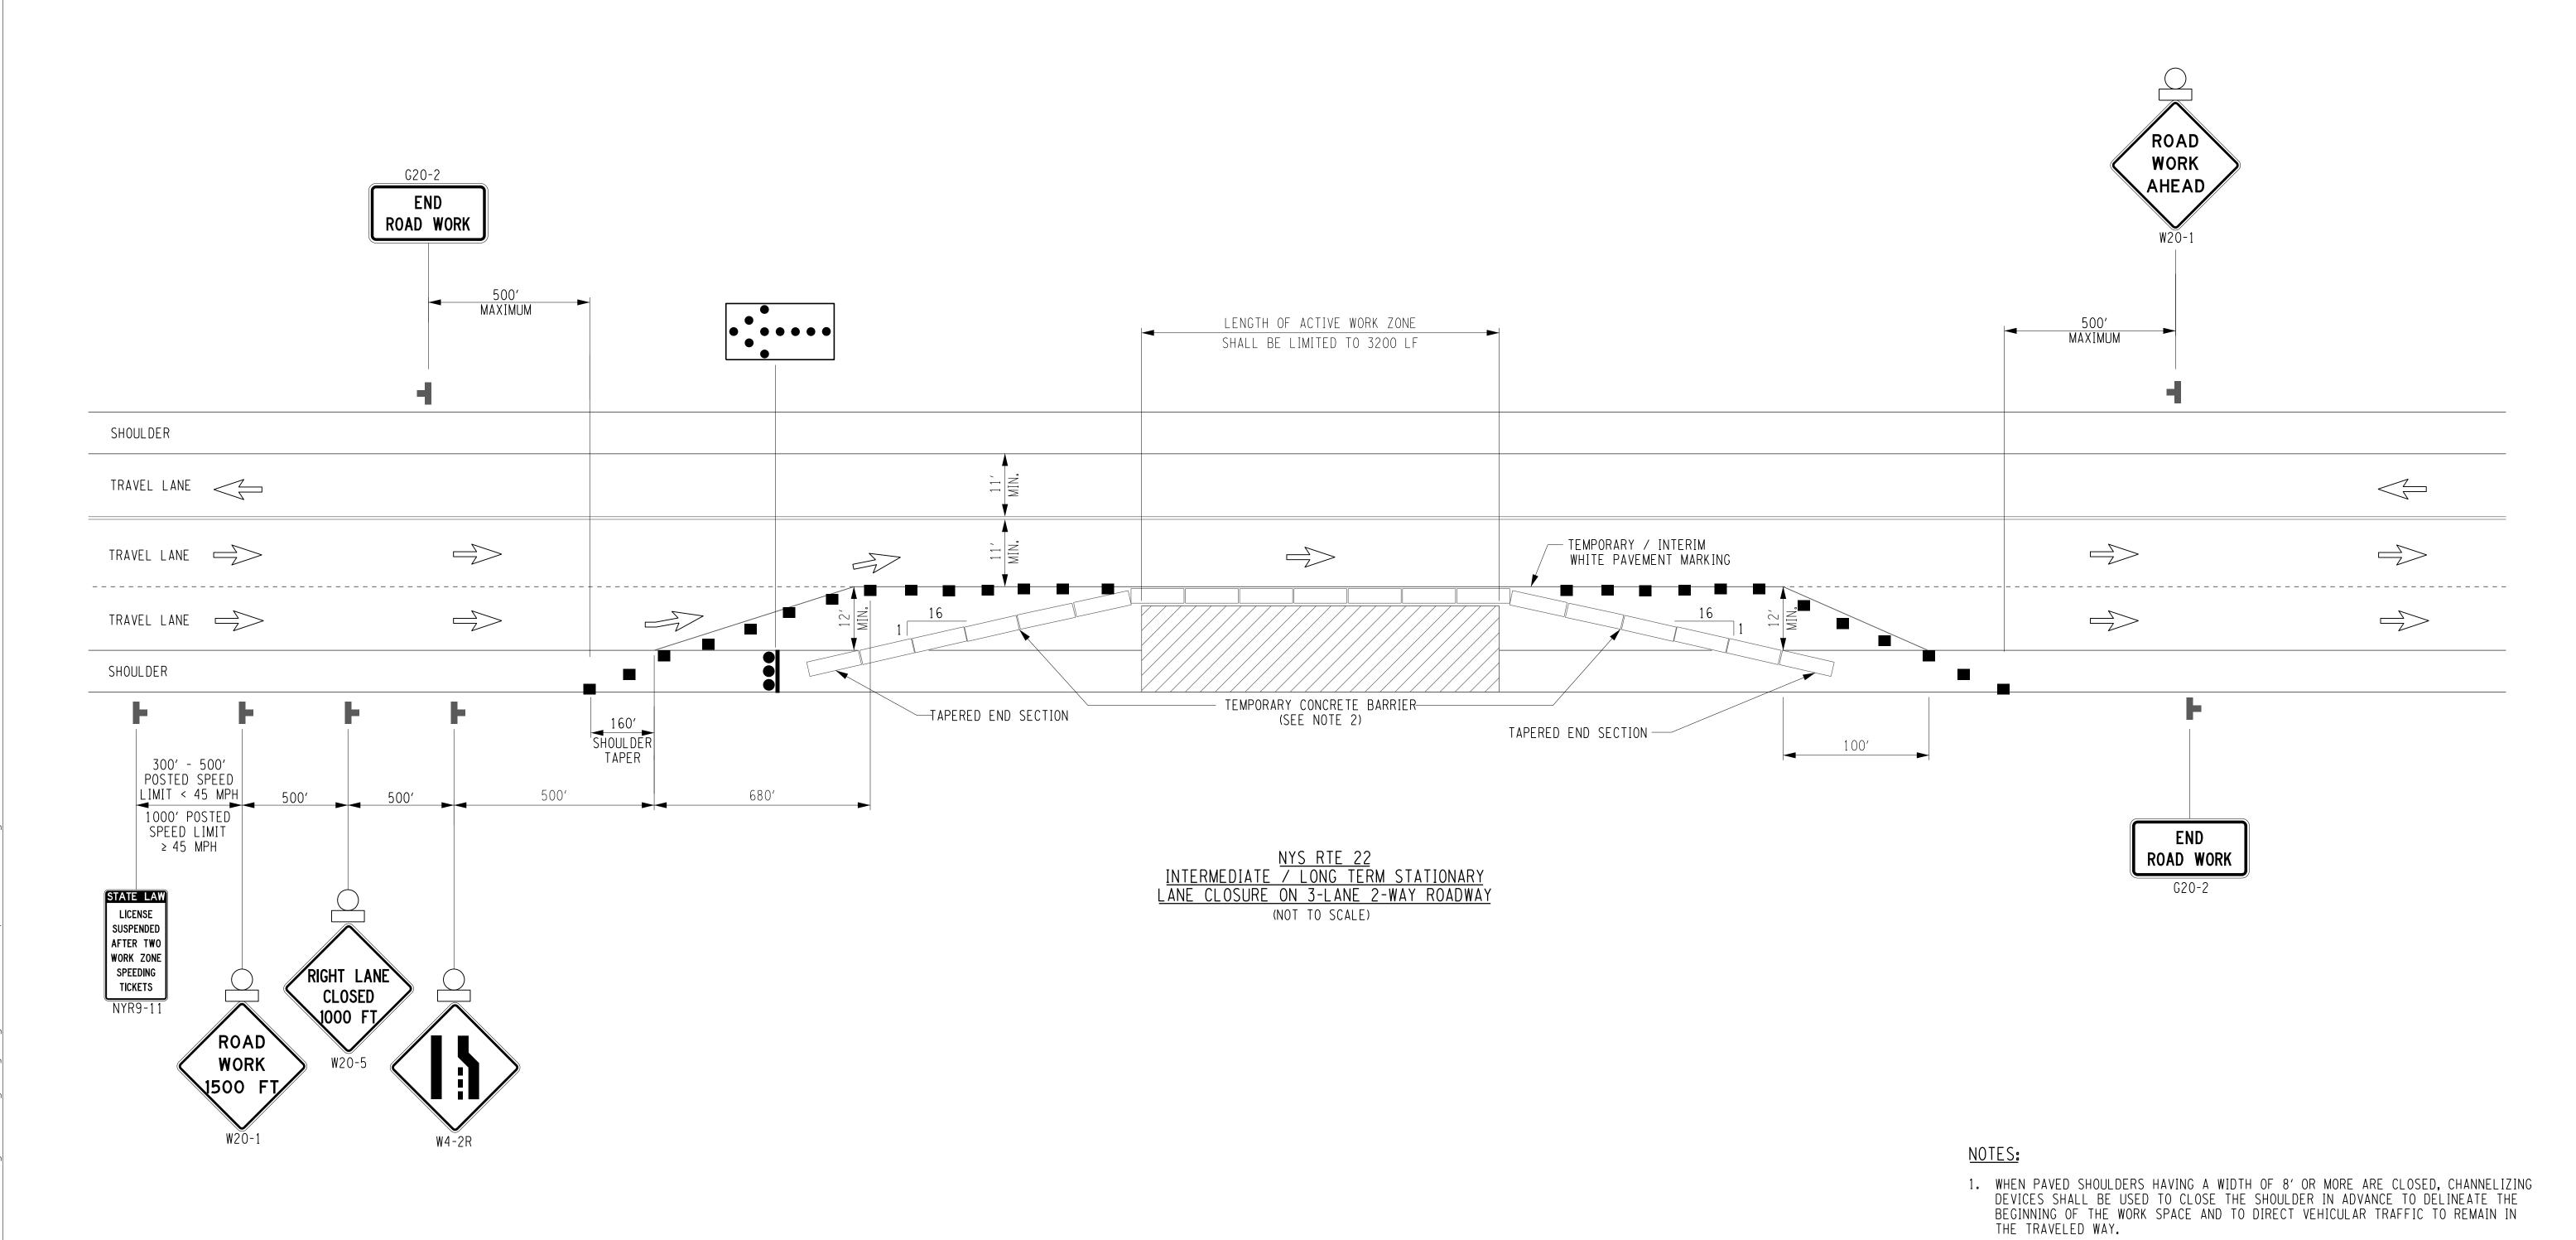STANDARD SPECIFICATIONS.

21162 CHA PROJECT NO. DRAWING NO. WORK ZONE TRAFFIC CONTROL DETAILS


SHEET 9 OF 9


2. WORK SPACE LIMITS SHALL BE ESTABLISHED TO ALLOW FOR STANDARD DEFLECTION OF TEMPORARY CONCRETE BARRIER AS DEFINED IN SECTION 619 OF THE NYSDOT

C-511

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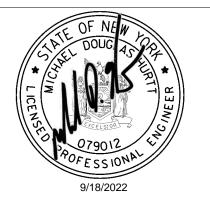




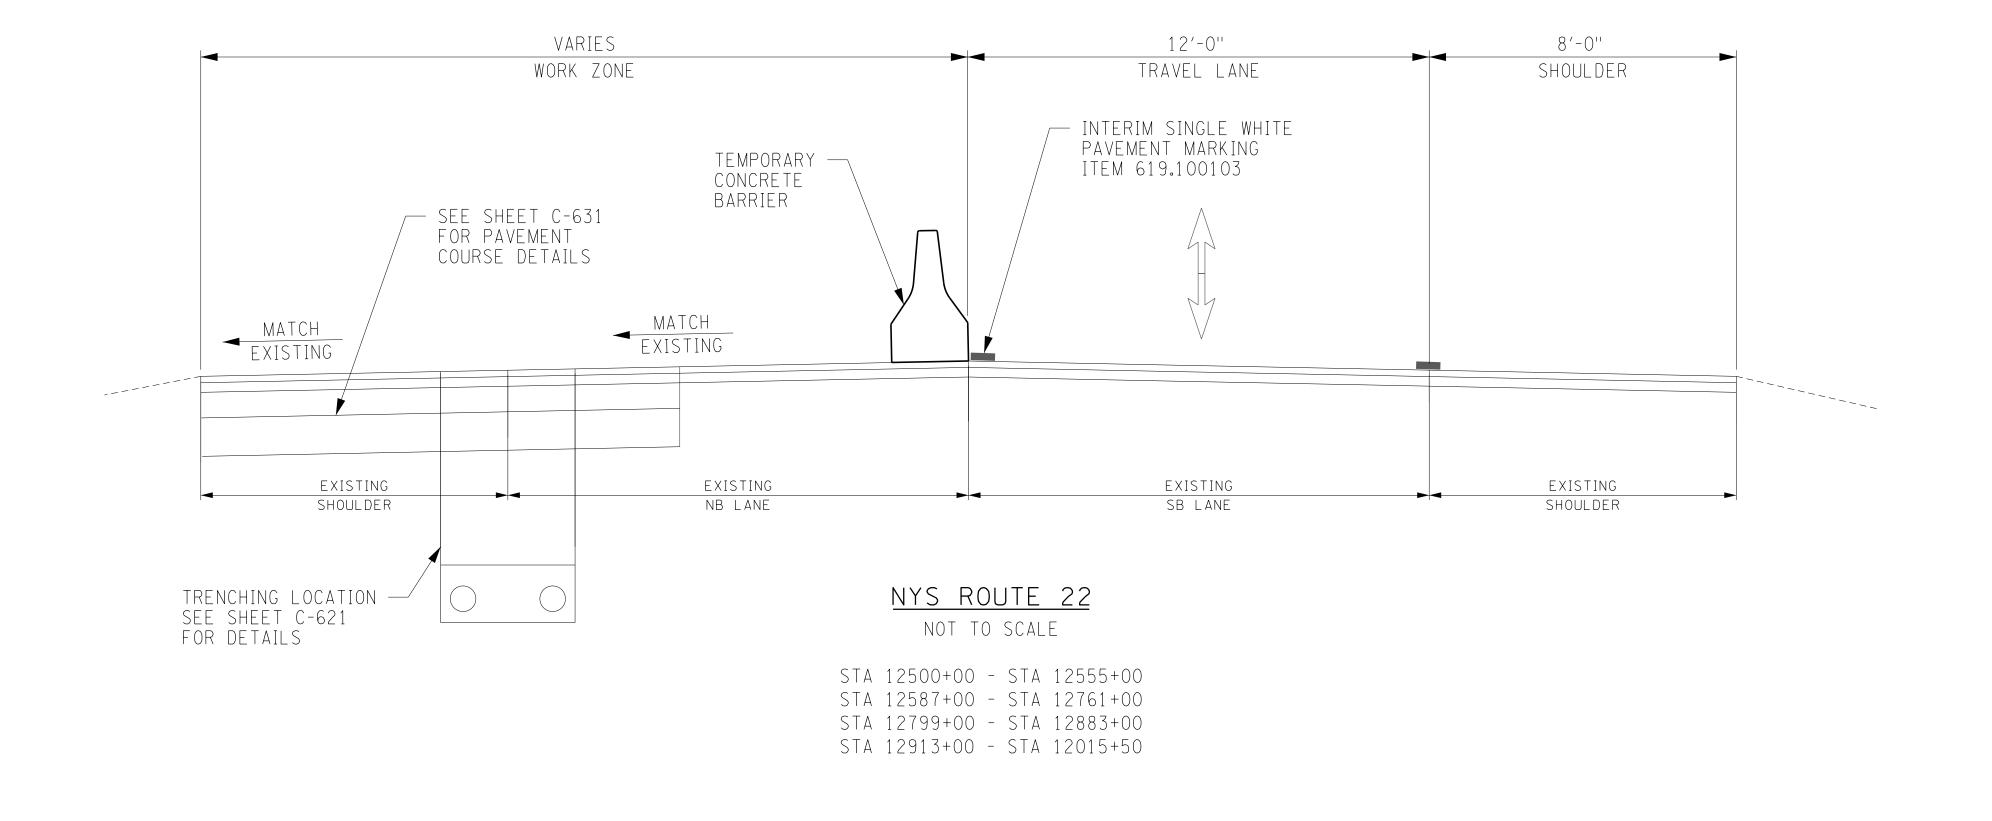

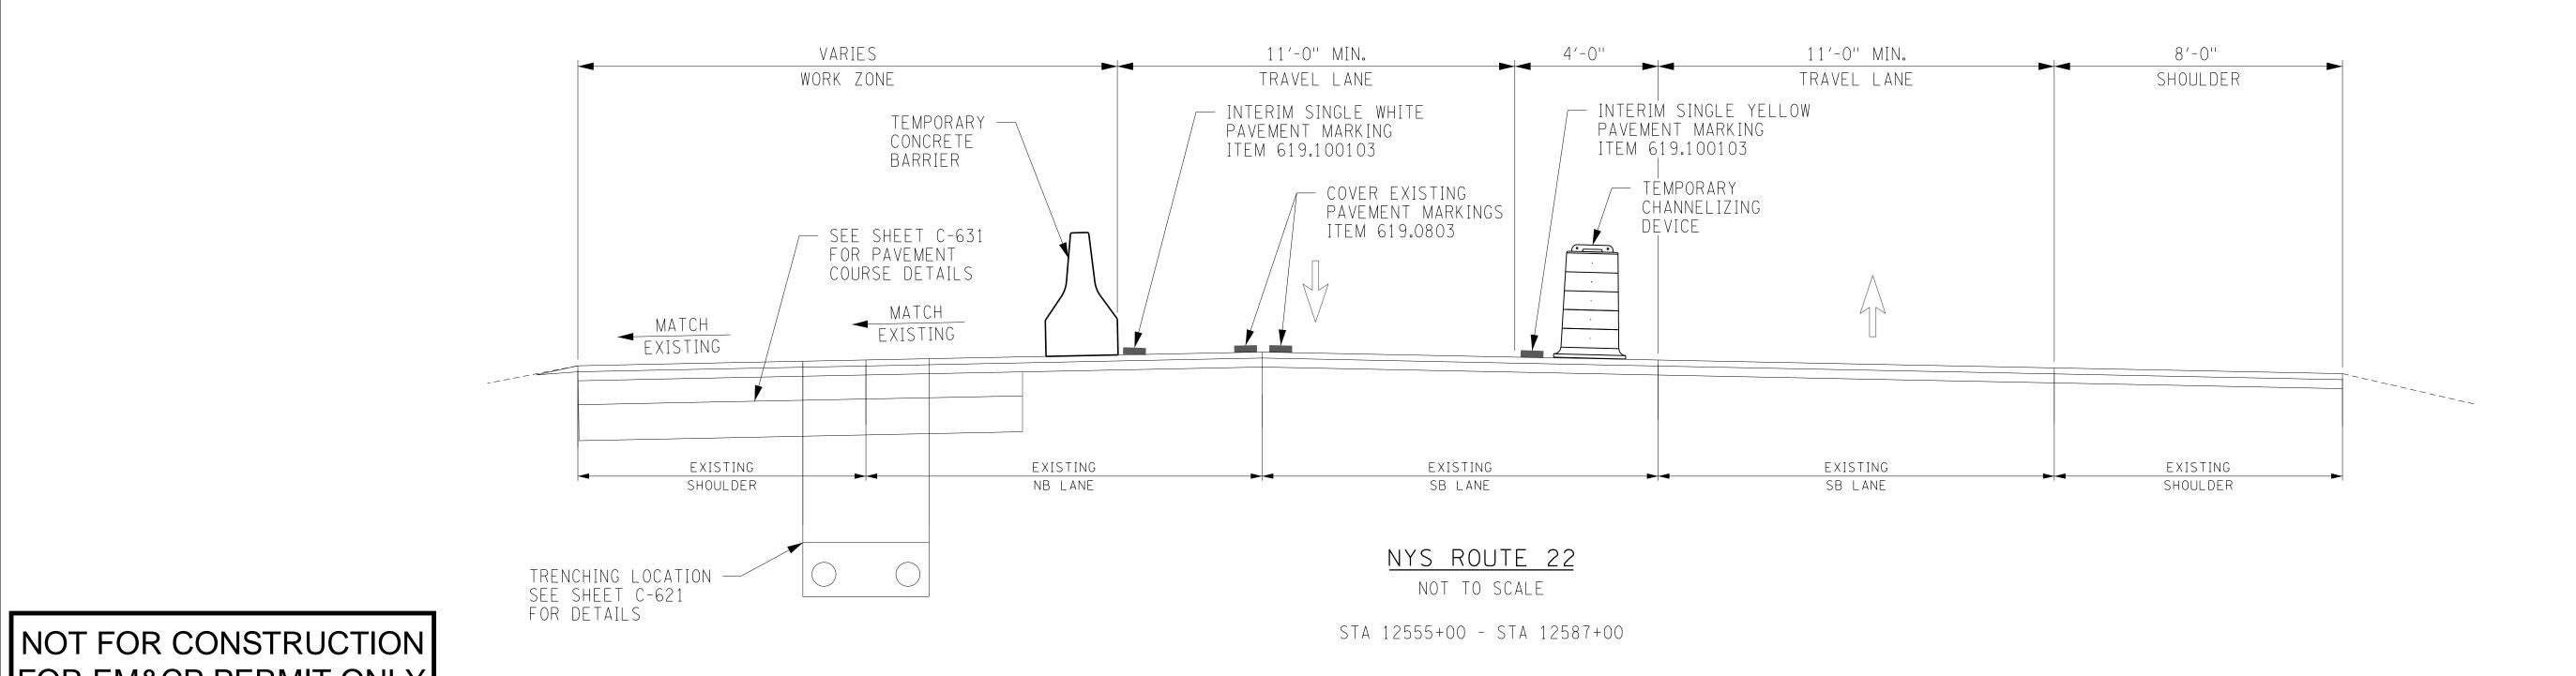





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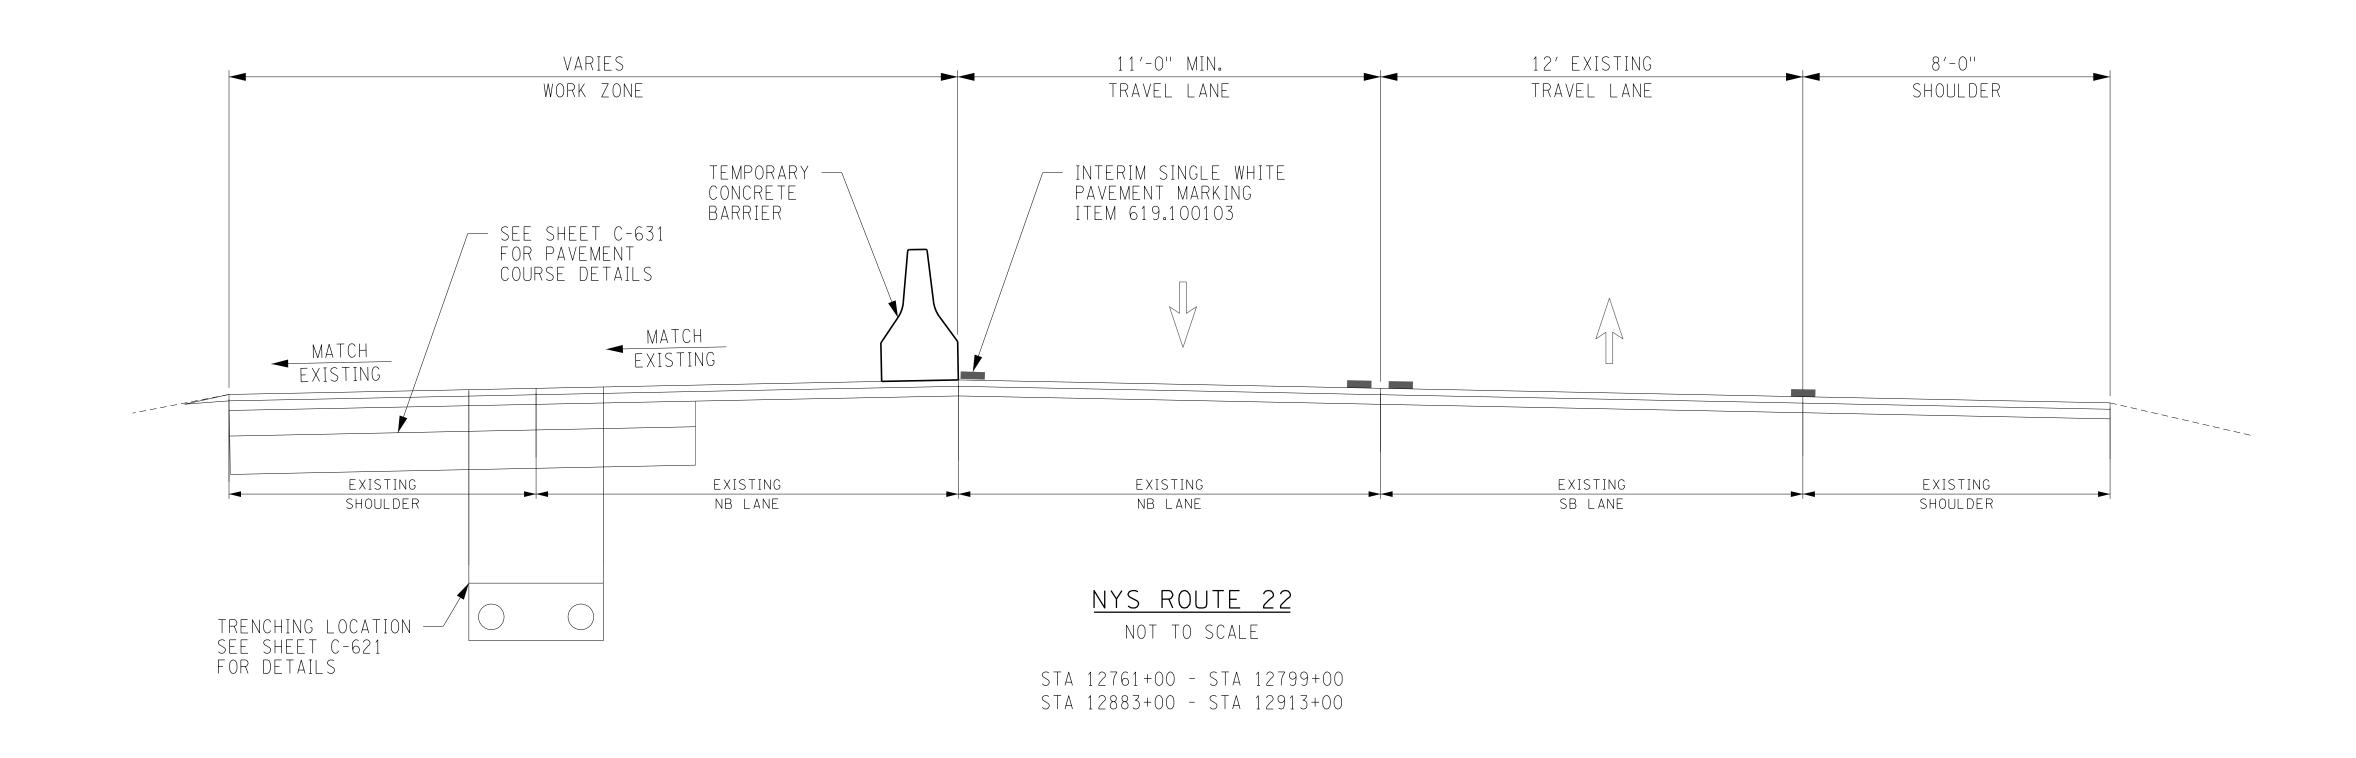
CHAMPLAIN HUDSON POWER EXPRESS
SEGMENT 2 - ROUTE 22: DRESDEN - WHITEHALL
WORK ZONE TRAFFIC CONTROL
TYPICAL SECTIONS
SHEET 1 OF 2

KIEWIT PROJECT NO.
21162
CHA PROJECT NO.
066076
DRAWING NO.

C-512

DRAWN BY: JAH DESIGNED BY: JPS APPROVED BY: MDH REV. NO. DATE 09/21/2

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No.	DATE	SUBMITTAL / REVISION DESCRIPTION	DB	APP	DRAWN BY: JAH	DESIGNED BY: JPS	APPROVED BY: MDH	SCALE REV. NO.	AS SHOWN			

CHAMPLAIN HUDSON POWER EXPRESS	
SEGMENT 2 - ROUTE 22: DRESDEN - WHITEHALL	
WORK ZONE TRAFFIC CONTROL	
TYPICAL SECTIONS	
SHEET 2 OF 2	

CHA PROJECT NO. DRAWING NO.

KIEWIT PROJECT NO.

C-513

SH.NO.

12545+00.00 12525+00.00 TEMPORARY CONCRETE — BARRIER TEMPORARY -CONCRETE BARRIER EXISTING SHOULDER INTERIM SINGLE WHITE
PAVEMENT MARKING
ITEM 619.100103 TRENCHING LOCATION—/
SEE SHEET C-621
FOR DETAILS [12531+50.00]1. SEE SHEET C-507 FOR WZTC DETAILS. NOT FOR CONSTRUCTION FOR EM&CP PERMIT ONLY 12510+00.00 WORK ZONE TEMPORARY CONCRETE — BARRIER CRANE PAD TEMPORARY CONCRETE —— BARRIER EXISTING SHOULDER EXISTING NB LANE EXISTING SHOULDER INTERIM SINGLE WHITE
PAVEMENT MARKING
ITEM 619.100103 ── INTERIM SINGLE WHITE PAVEMENT MARKING ITEM 619.100103 SPLICE VAULT LOCATION — └─ TEMPORARY SHORING 1. SEE SHEET C-507 FOR WZTC DETAILS. HORIZONTAL SCALE **KIEWIT PROJECT NO.** CHAMPLAIN HUDSON POWER EXPRESS 21162 IT IS A VIOLATION OF LAW FOR ANY PERSON, UNLESS THEY ARE ACTING UNDER THE DIRECTION OF A LICENSED PROFESSIONAL ENGINEER, ARCHITECT, LANDSCAPE ARCHITECT OR LAND SURVEYOR TO ALTER AN ITEM IN ANY WAY. IF AN ITEM BEARING THE STAMP OF A LICENSED PROFESSIONAL IS ALTERED, THE ALTERING ENGINEER, ARCHITECT, LANDSCAPE ARCHITECT OR LAND SURVEYOR SHALL STAMP THE DOCUMENT AND INCLUDE THE NOTATION "ALTERED BY" FOLLOWED BY THEIR SIGNATURE, THE DATE OF SUCH ALTERATION, AND A SPECIFIC DESCRIPTION OF THE ALTERATION. **SEGMENT 2 - ROUTE 22: DRESDEN - WHITEHALL** CHA PROJECT NO. Kiewit 066076 WORK ZONE TRAFFIC CONTROL CROSS SECTIONS DRAWING NO. C-514 SHEET 1 OF 9 Albany, NY 12205-0269 518.453.4500 • www.chacompanies.com 09/21/2022 FINAL EM&CP SUBMISSION **Power Express**

SUBMITTAL / REVISION DESCRIPTION

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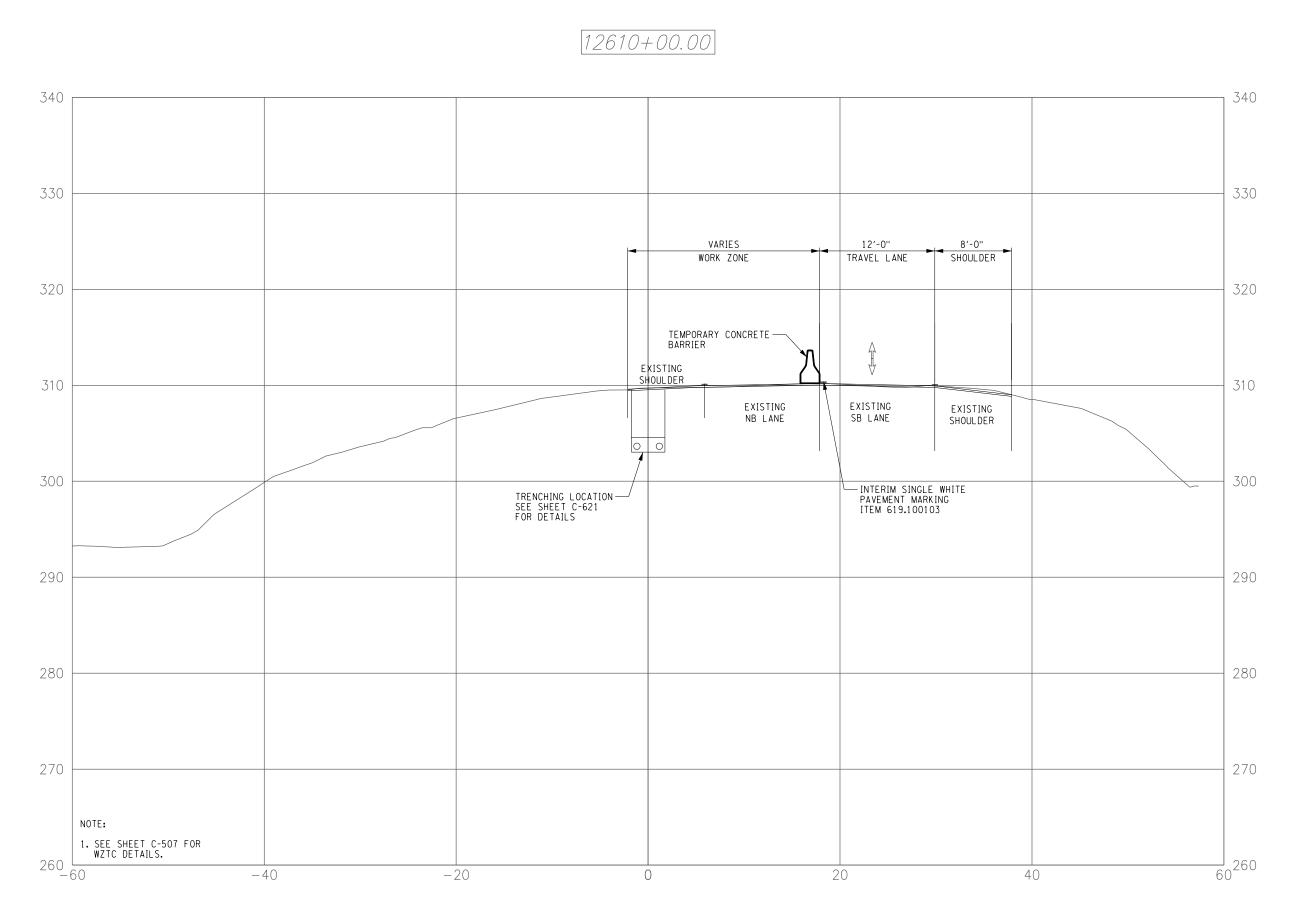
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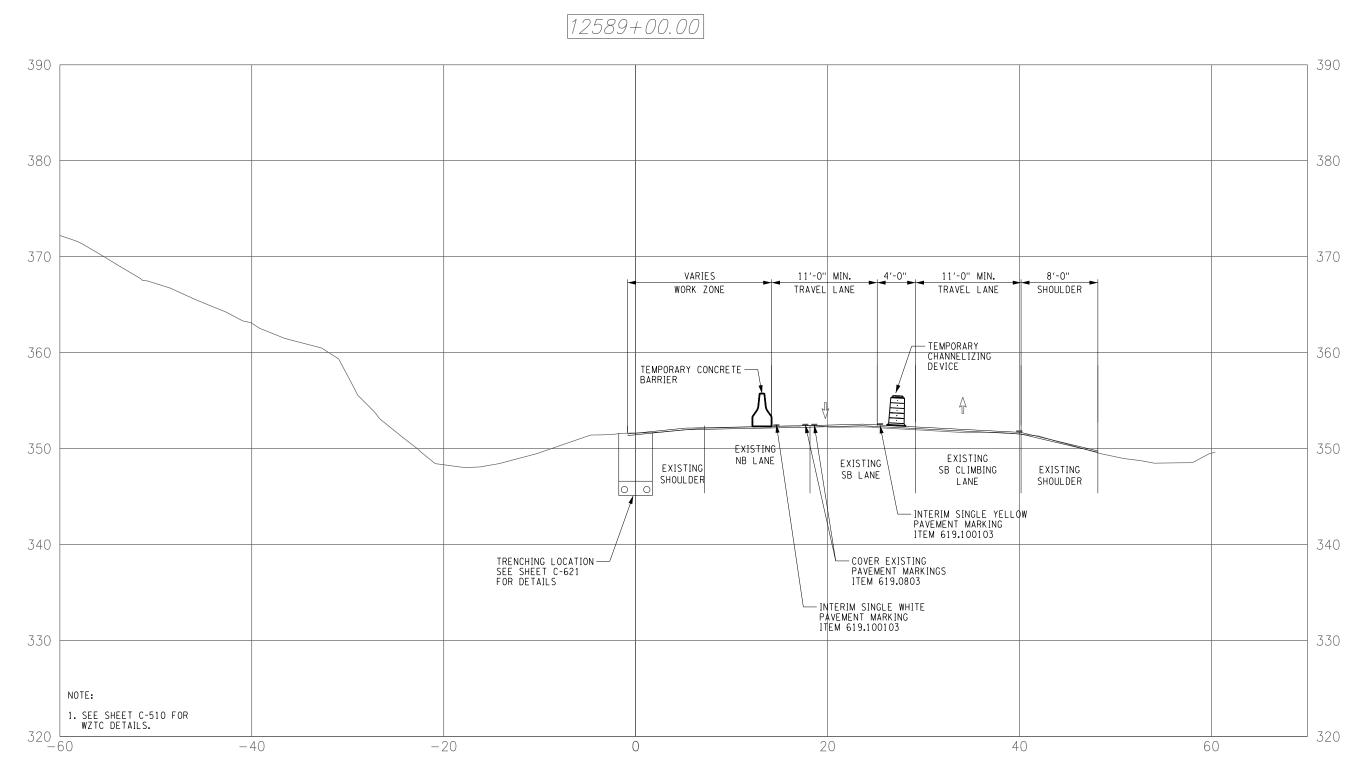
DB APP DRAWN BY: JAH DESIGNED BY: JPS APPROVED BY: MDH REV. NO.

12580+00.00 — TEMPORARY CHANNELIZING DEVICE TEMPORARY CONCRETE — BARRIER EXISTING SHOULDER EXISTING \
SB LANE EXISTING
SB CLIMBING
LANE EXISTING SHOULDER INTERIM SINGLE YELLOW
PAVEMENT MARKING
ITEM 619.100103 COVER EXISTING
PAVEMENT MARKINGS
ITEM 619.0803 — INTERIM SINGLE WHITE PAVEMENT MARKING ITEM 619.100103 NOT FOR CONSTRUCTION FOR EM&CP PERMIT ONLY 12570+00.00

VARIES 11'-0" MIN. 4'-0" 11'-0" MIN. 8'-0"

WORK ZONE TRAVEL LANE SHOULDER — TEMPORARY CHANNELIZING DEVICE TEMPORARY CONCRETE — BARRIER EXISTING SHOULDER SB CLIMBING LANE EXISTING SB LANE --- INTERIM SINGLE YELLOW PAVEMENT MARKING ITEM 619.100103 TRENCHING LOCATION——/
SEE SHEET C-621
FOR DETAILS COVER EXISTING
PAVEMENT MARKINGS
ITEM 619.0803 INTERIM SINGLE WHITE PAVEMENT MARKING ITEM 619.100103












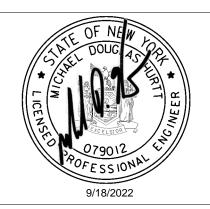

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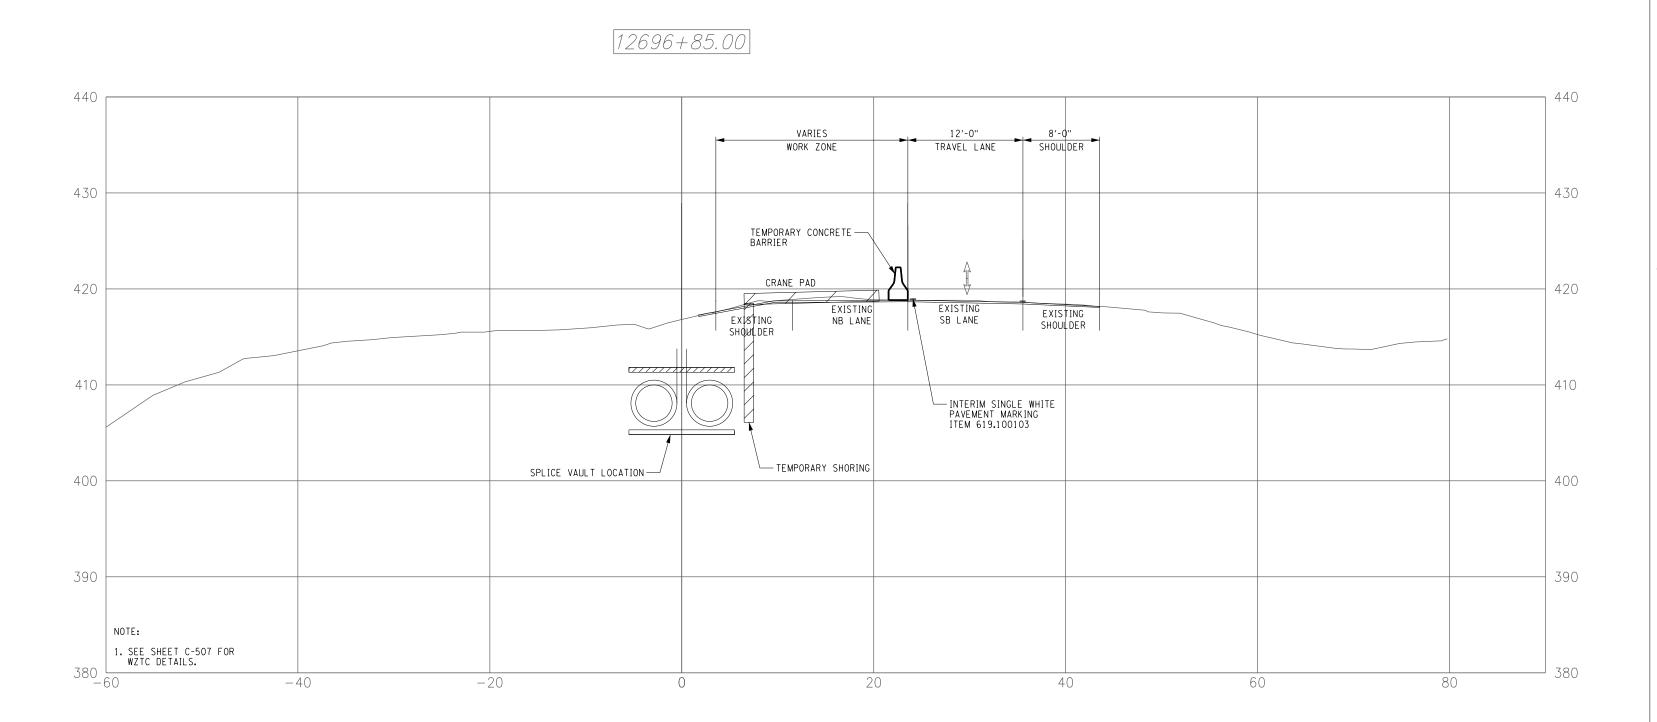
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SEGMENT 2 - ROUTE 22: DRESDEN - WHITEHALL	_
WORK ZONE TRAFFIC CONTROL	_
CROSS SECTIONS	
SHEET 2 OF 9	


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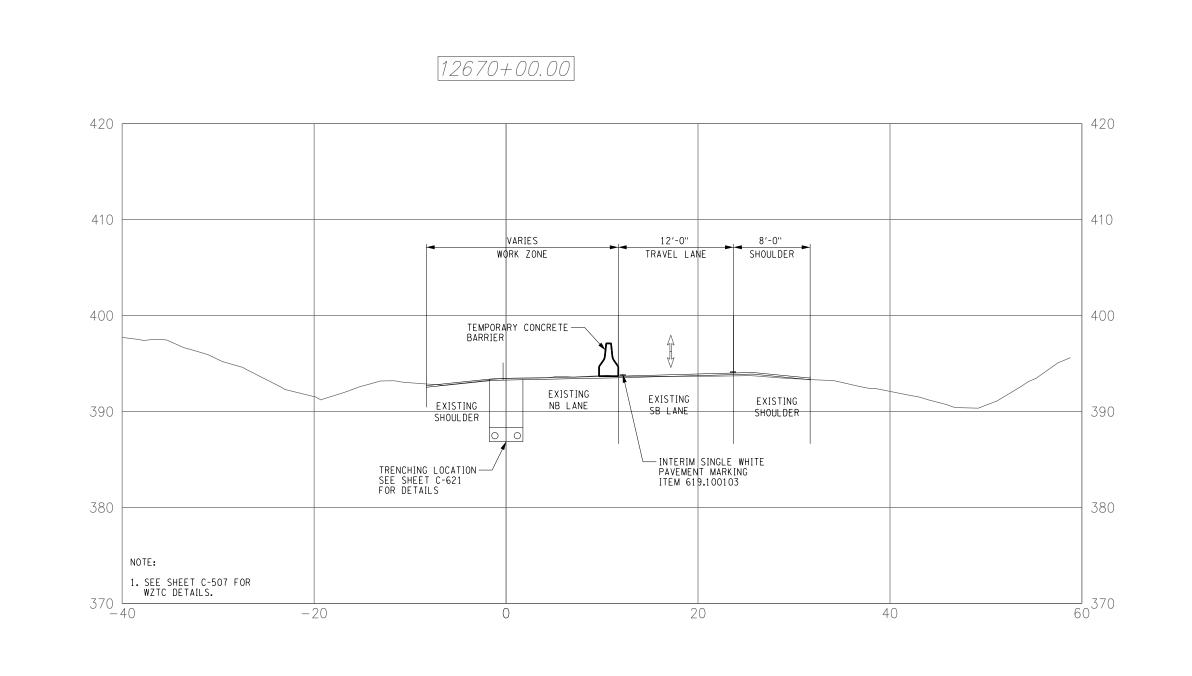
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1. SEE SHEET C-510 FOR WZTC DETAILS.

12651+00.00 EXISTING SHOULDER SHOULDER SPLICE VAULT LOCATION — TEMPORARY SHORING








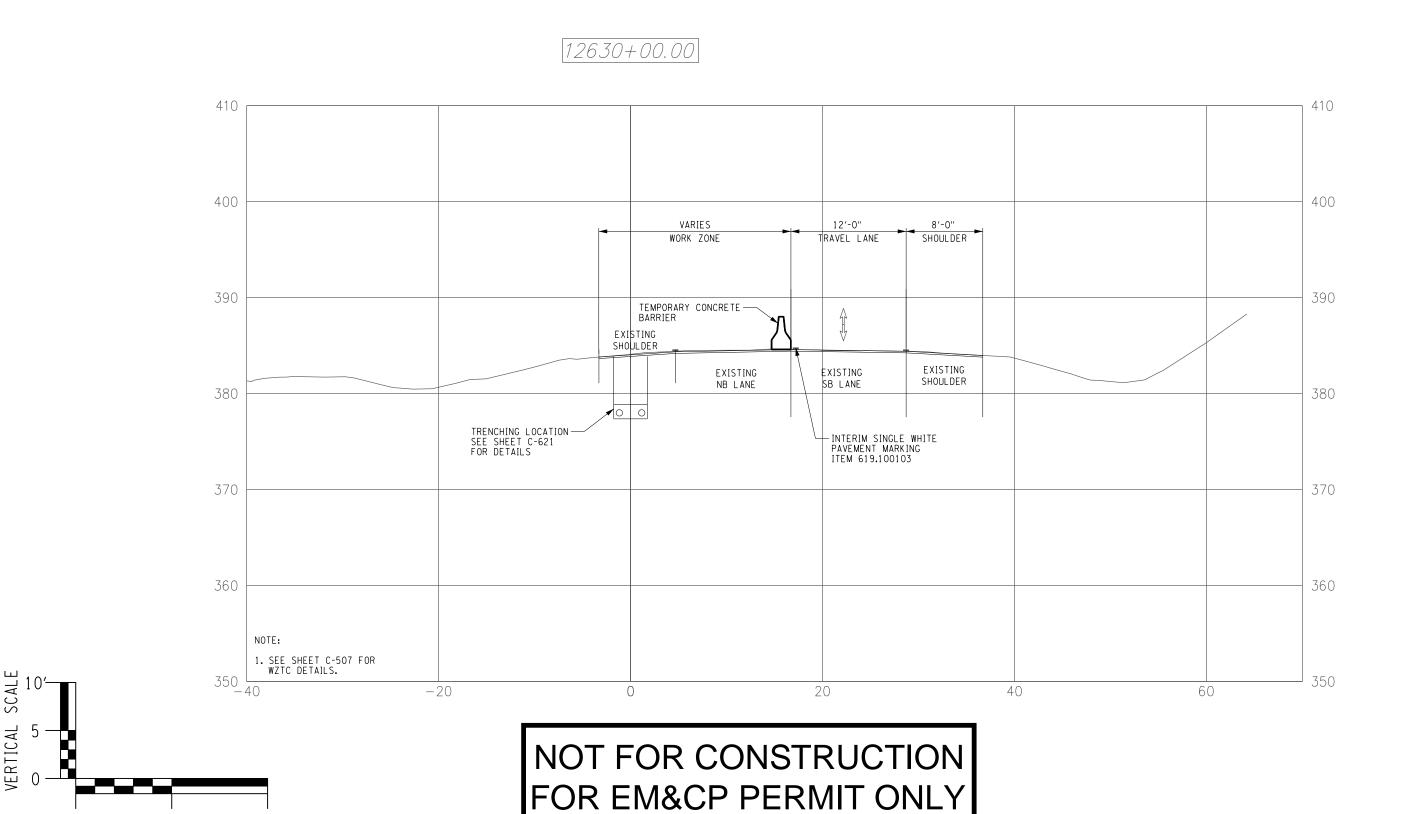





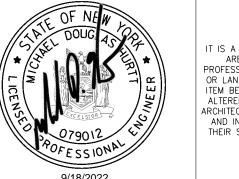

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No.	DATE	SUBMITTAL / REVISION DESCRIPTION	DB	APP	DRAWN BY: JAH	DESIGNED BY: JPS	APPROVED BY: MDH REV. NO.

CHAMPLAIN HUDSON POWER EXPRESS **SEGMENT 2 - ROUTE 22: DRESDEN - WHITEHALL** WORK ZONE TRAFFIC CONTROL **CROSS SECTIONS** SHEET 3 OF 9


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21162
CHA PROJECT NO.
066076
DRAWING NO.
C-516


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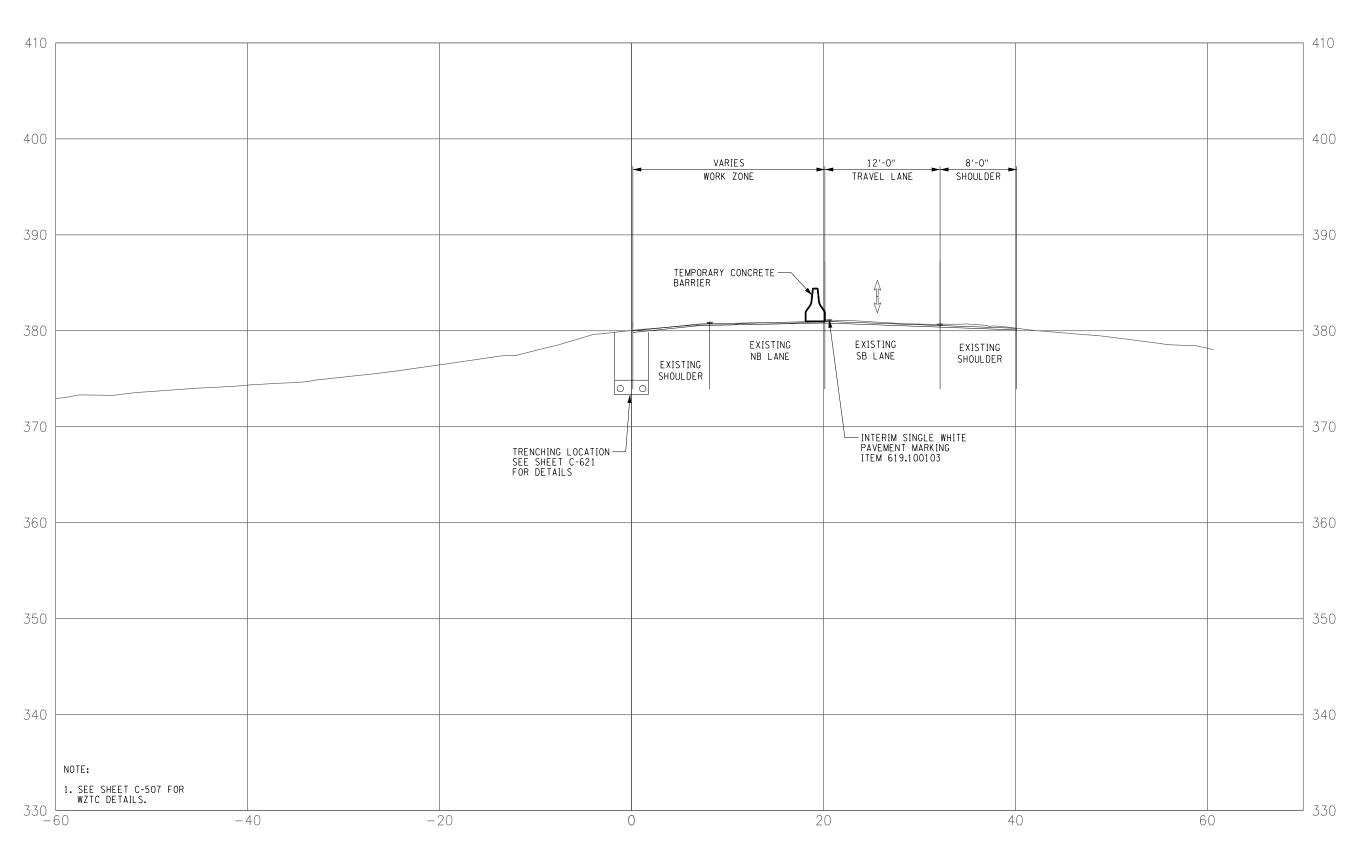
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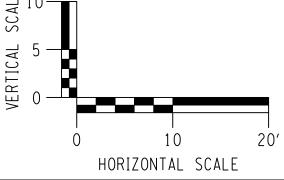


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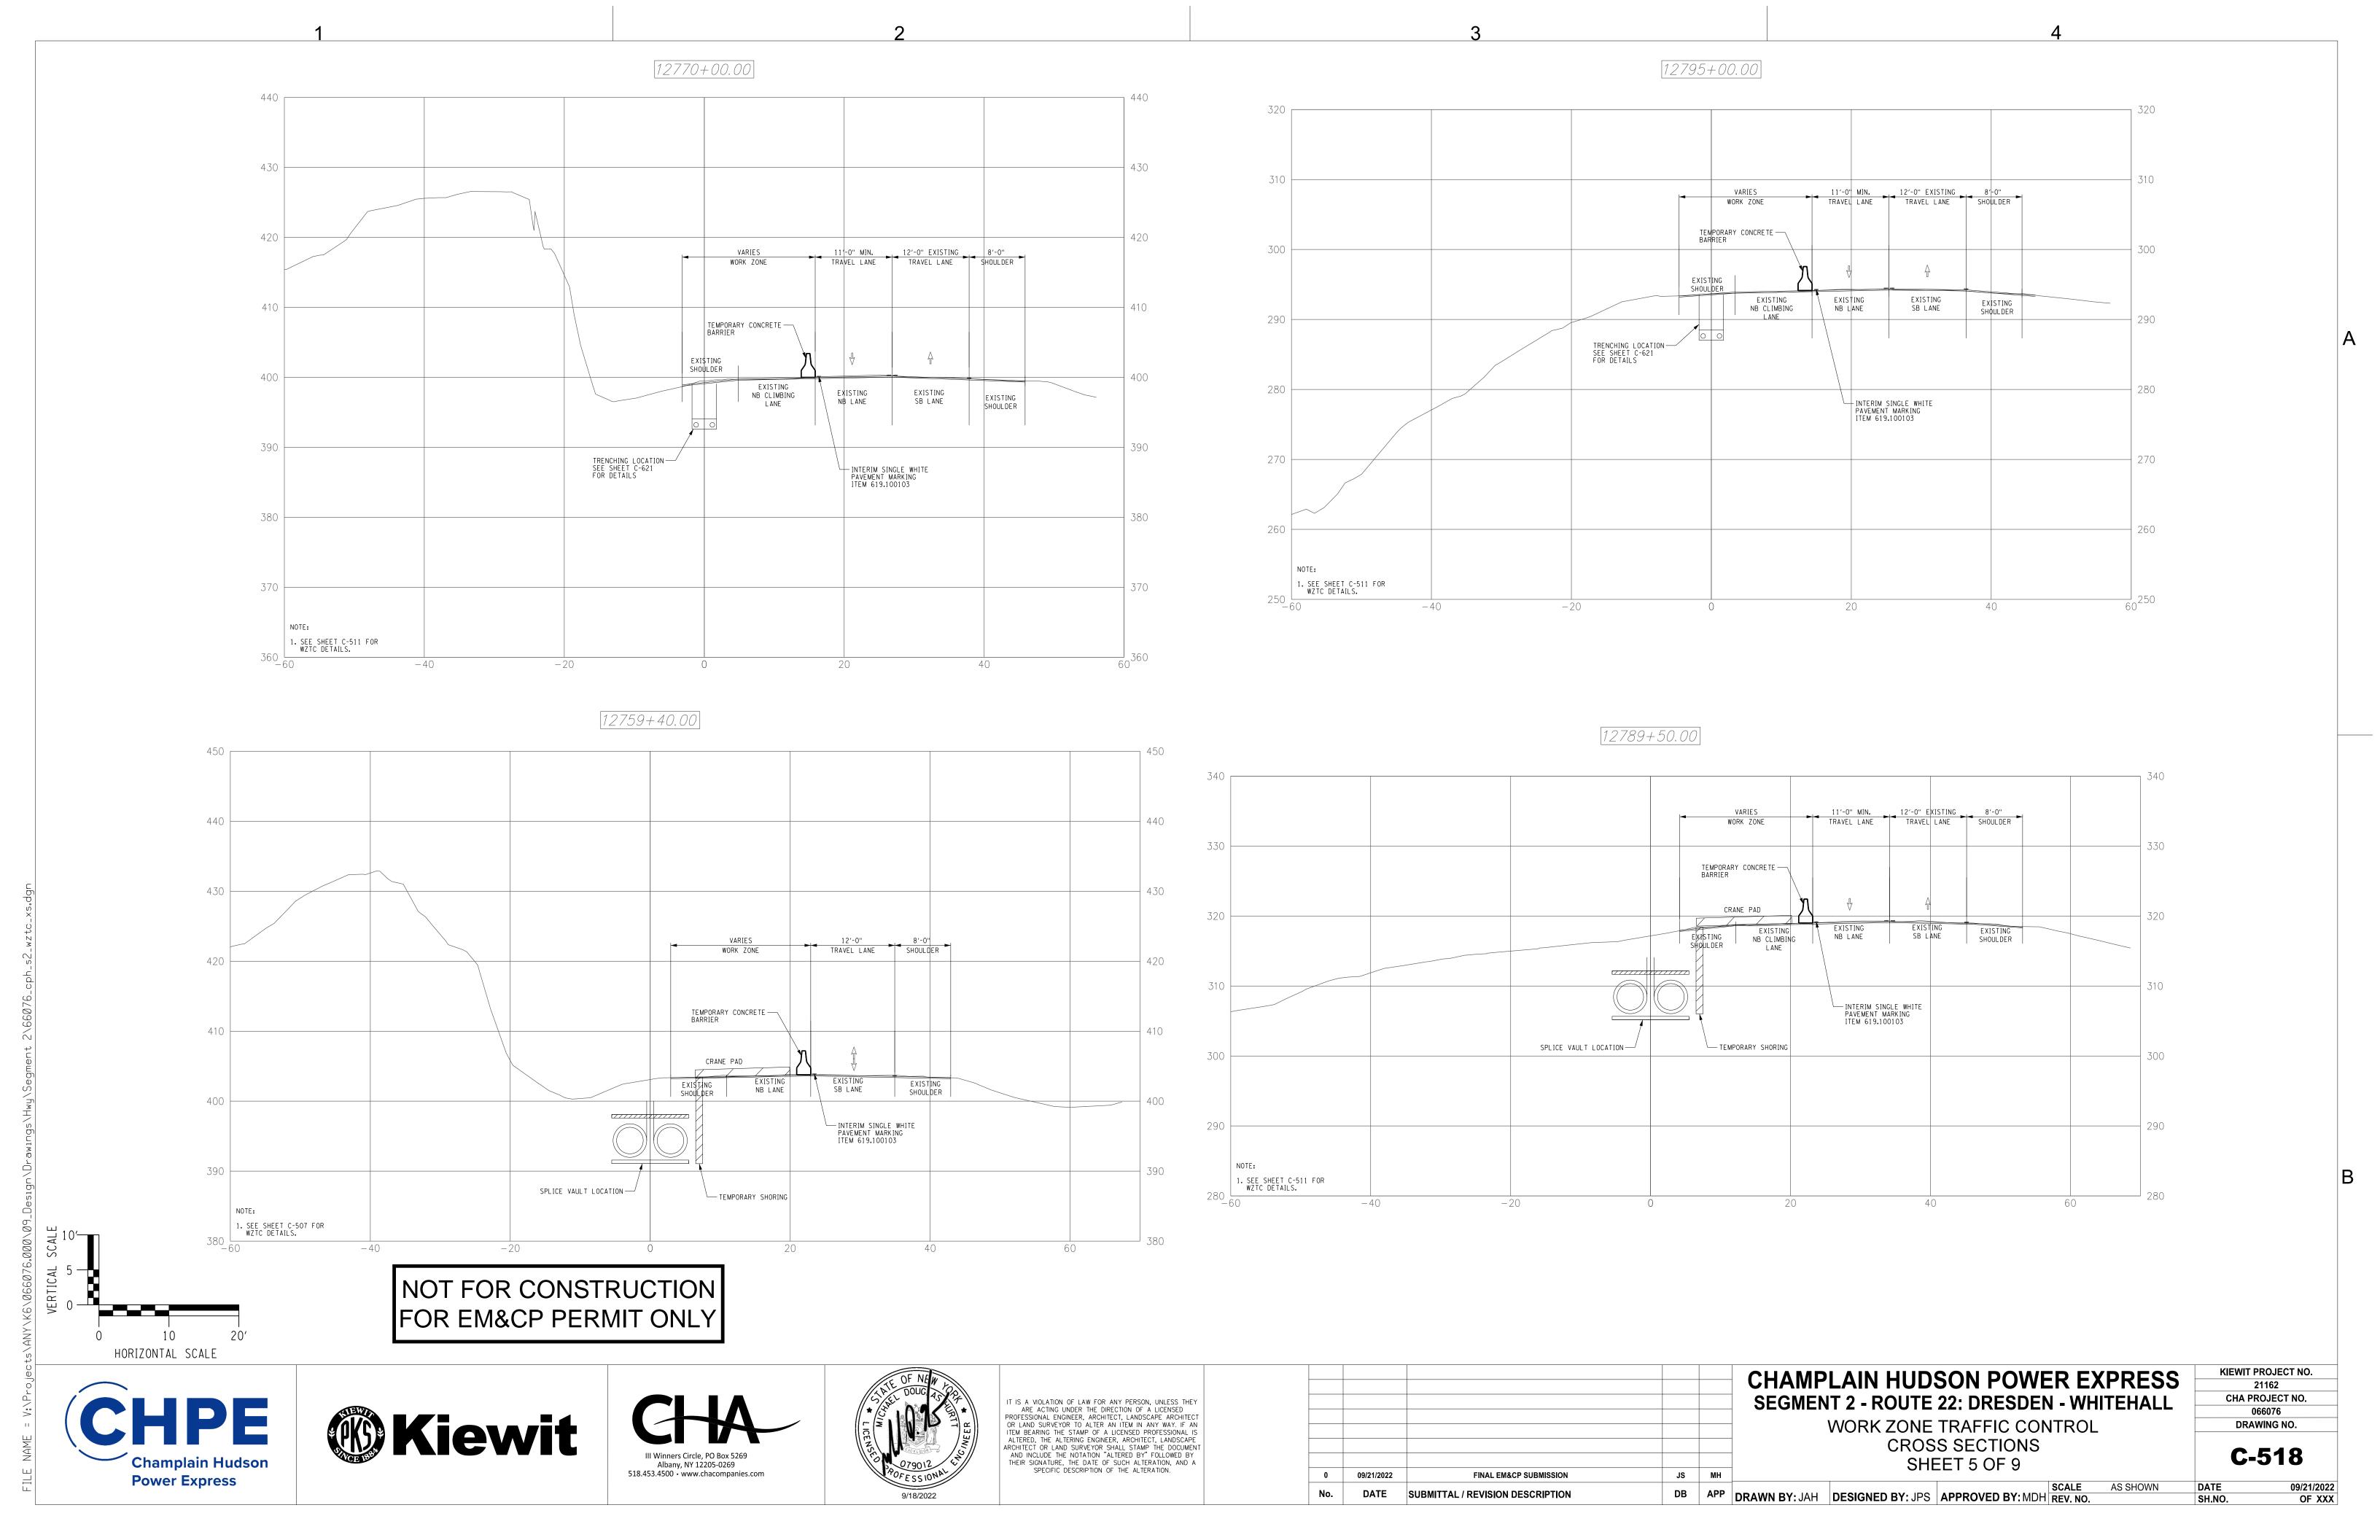
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CHAMPLAIN HUDSON POWER EXPRESS
SEGMENT 2 - ROUTE 22: DRESDEN - WHITEHALL
WORK ZONE TRAFFIC CONTROL
CROSS SECTIONS
SHEET 4 OF 9


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DRAWING NO.


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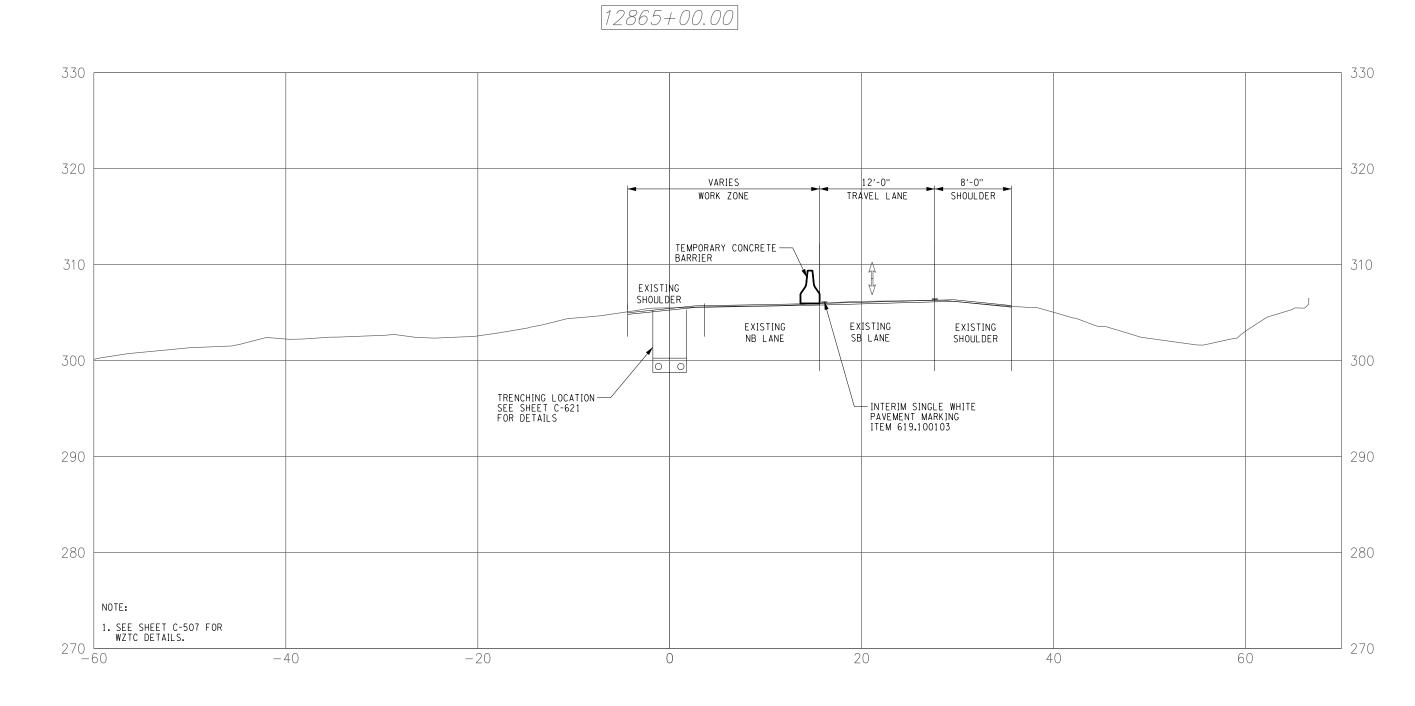


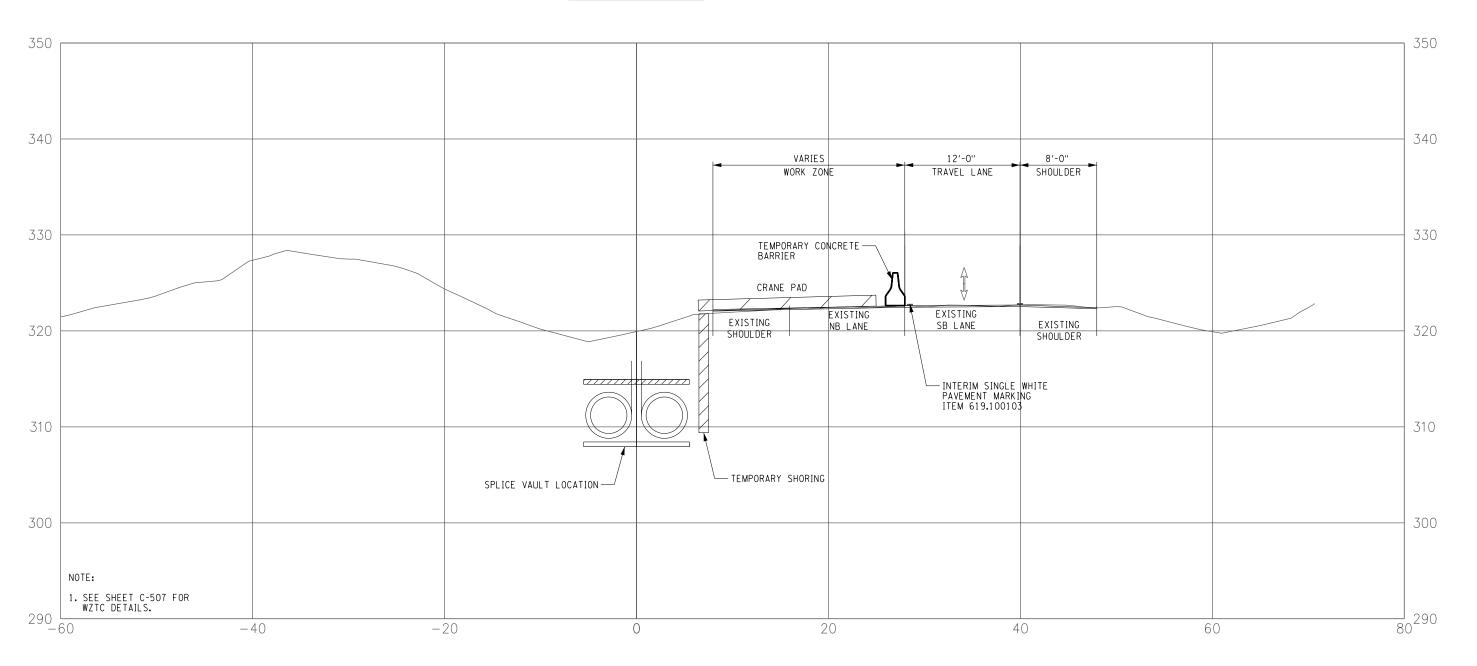

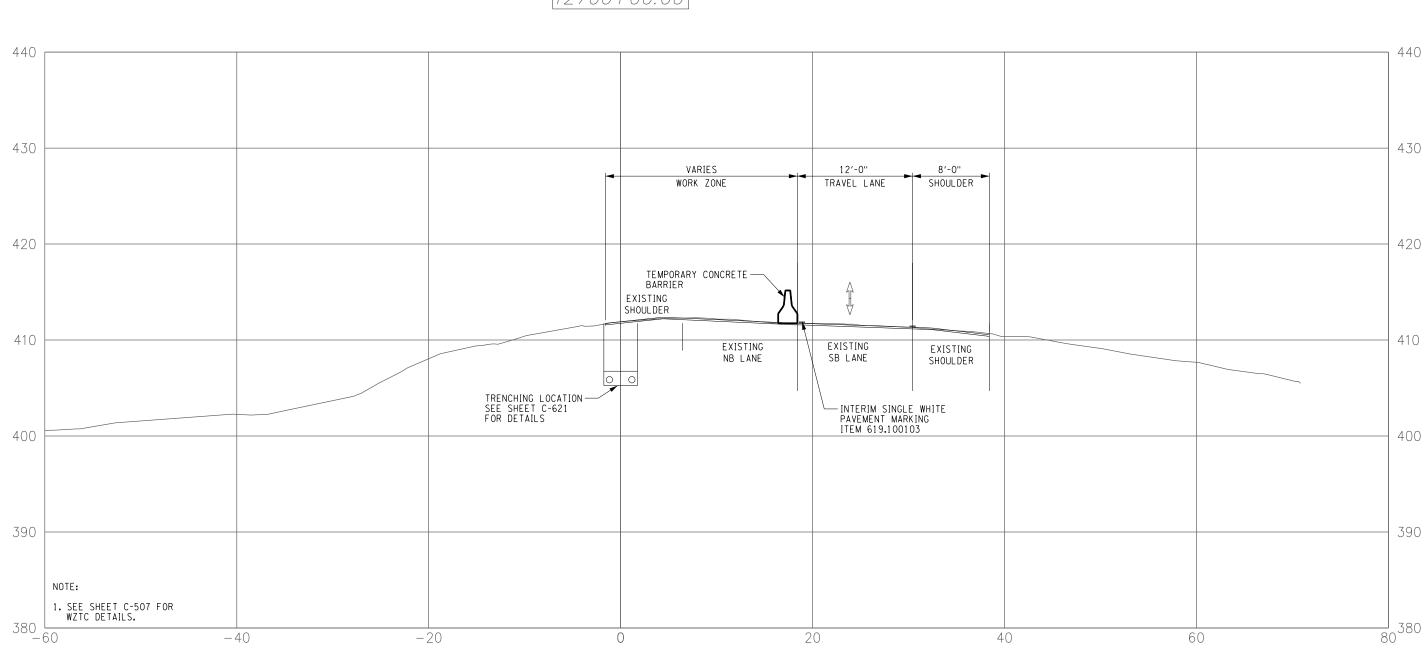
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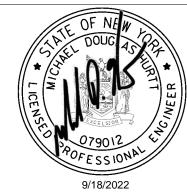


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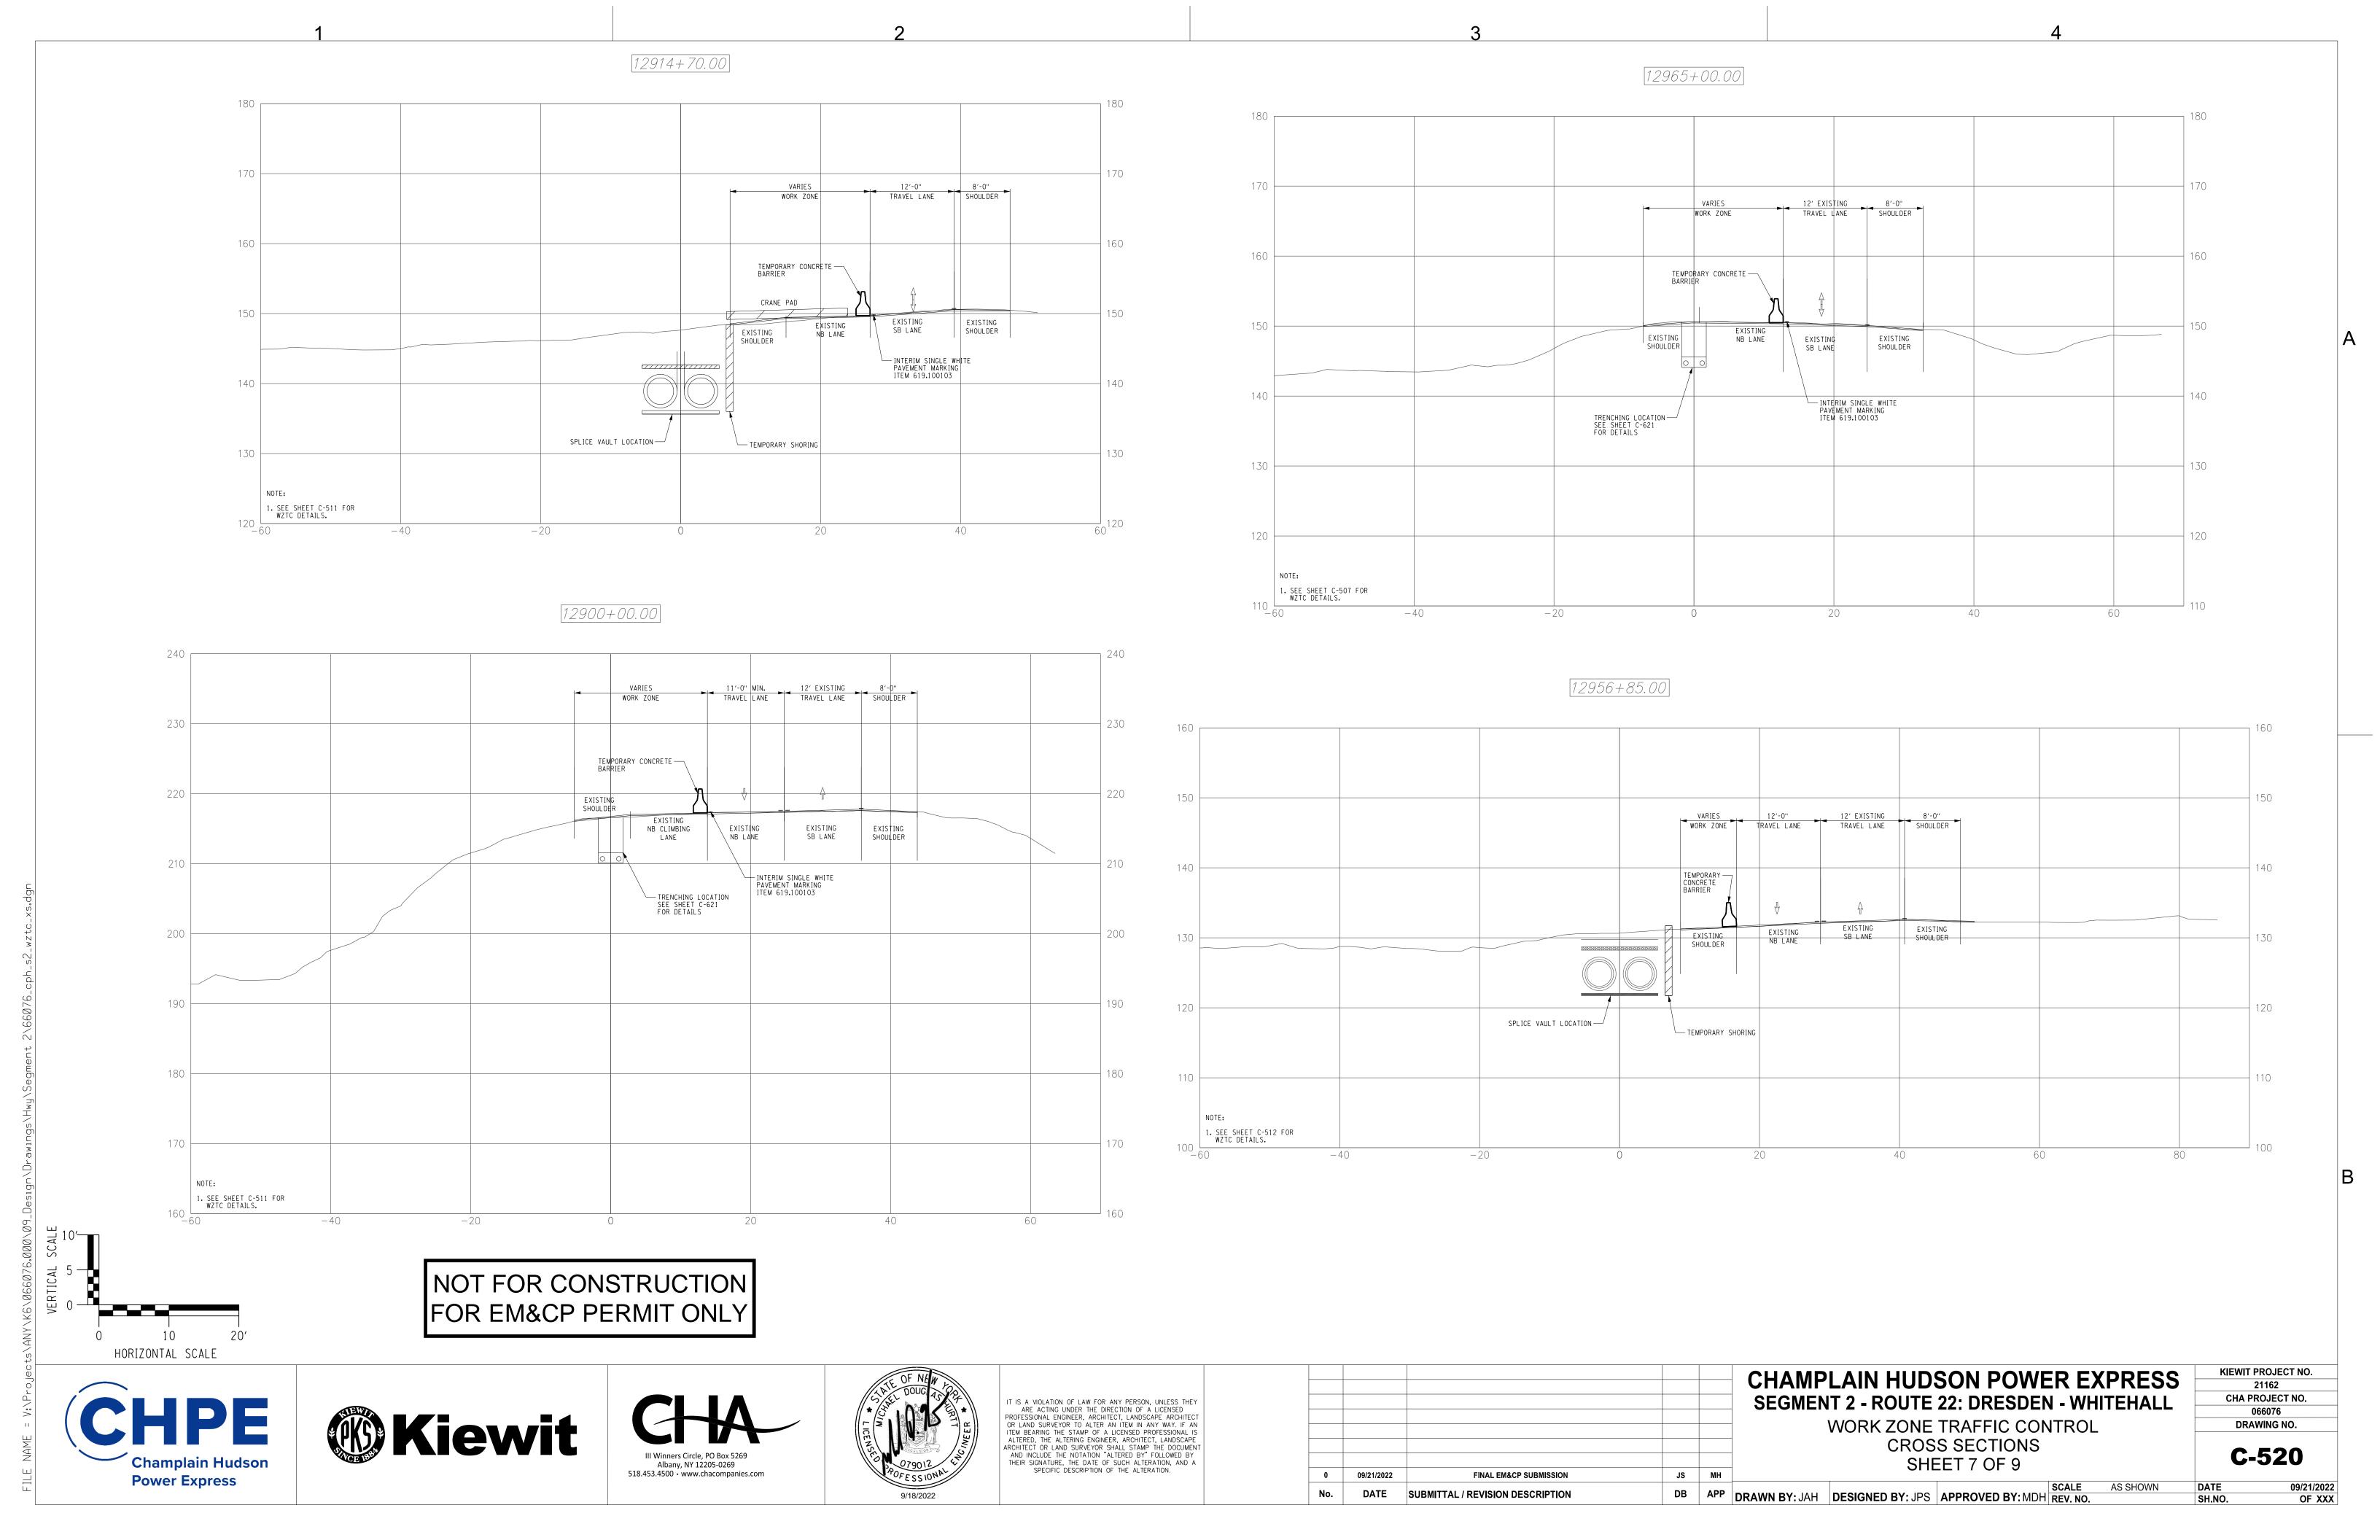


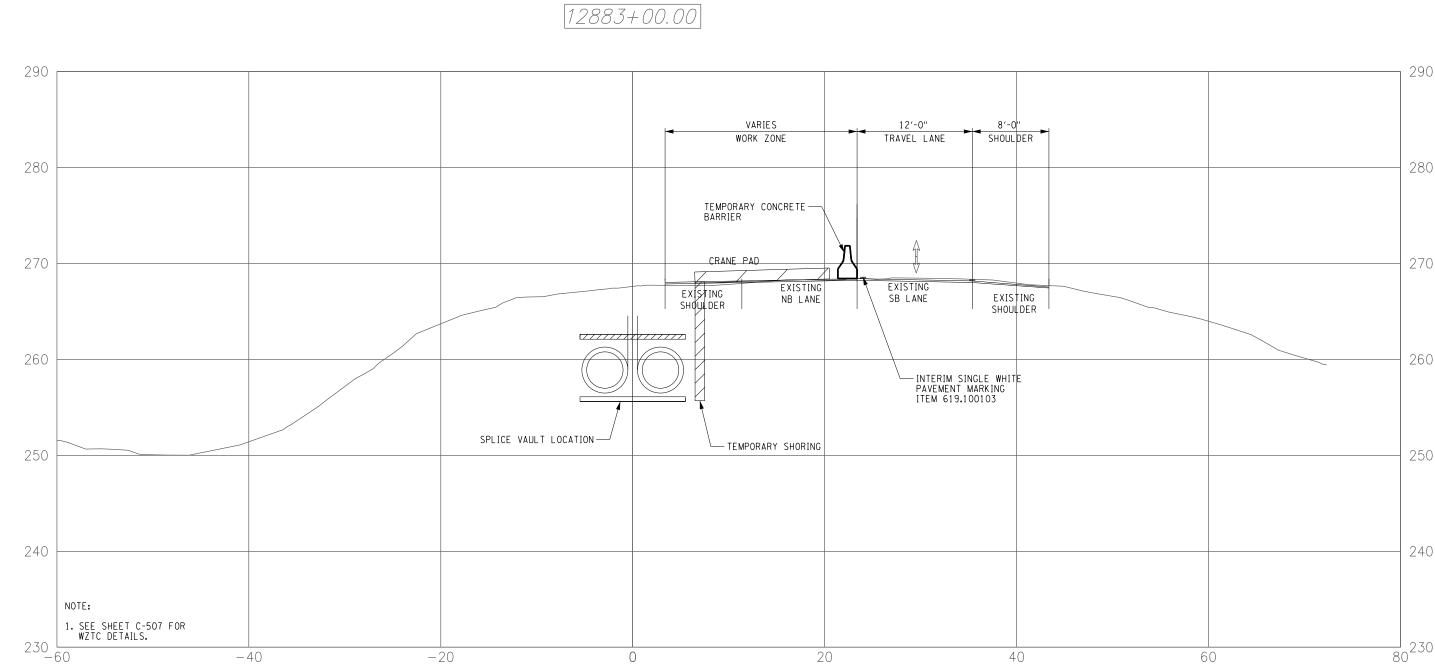
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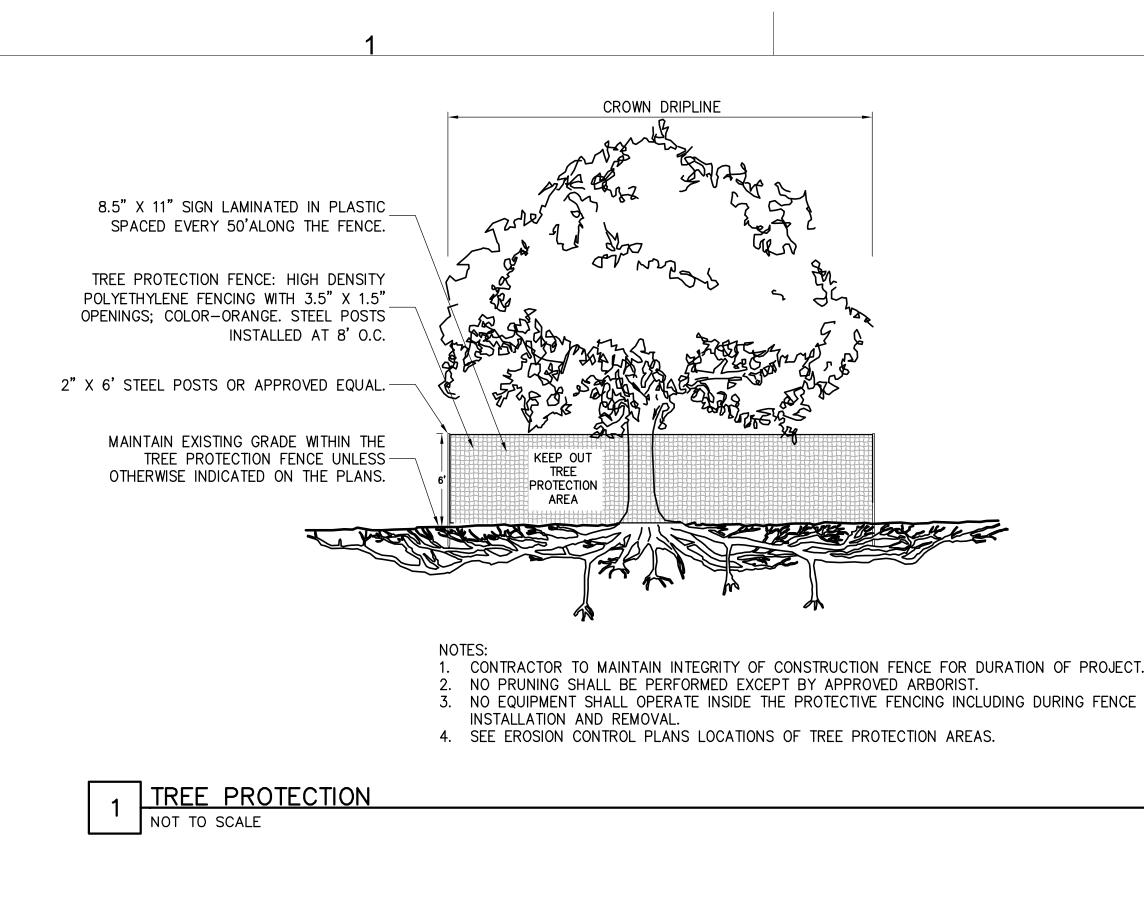
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SHEET 6 OF 9	
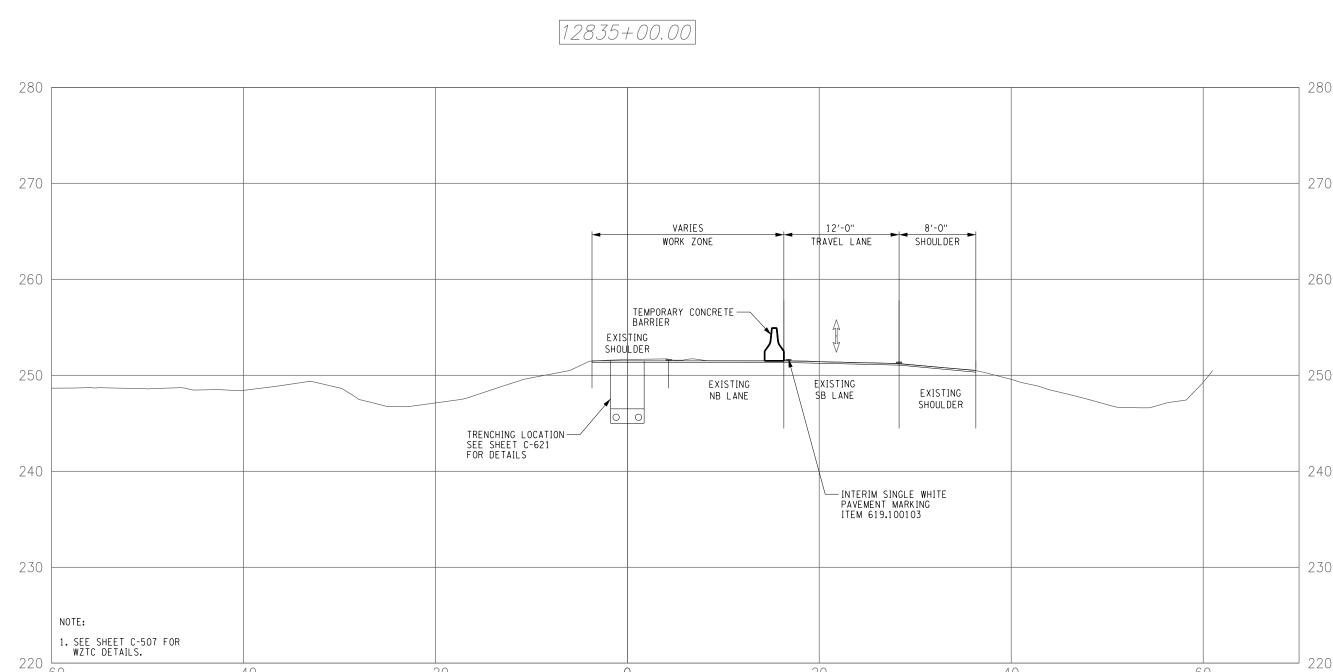
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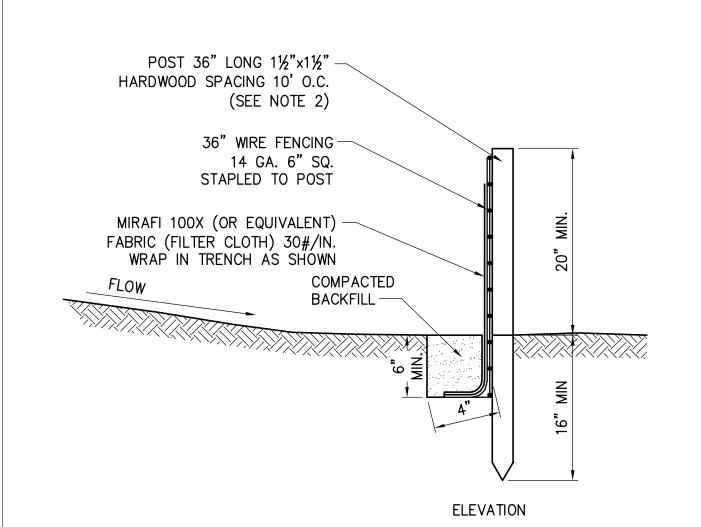


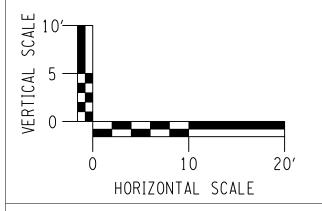

13032+00.00 TEMPORARY CONCRETE — BARRIER EXISTING SHOULDER EXISTING SHOULDER TRENCHING LOCATION
SEE SHEET C-621
FOR DETAILS 1. SEE SHEET C-507 FOR WZTC DETAILS. NOT FOR CONSTRUCTION FOR EM&CP PERMIT ONLY 13026+00.00 13034+55.00 WORK ZONE TEMPORARY CONCRETE ——
BARRIER TEMPORARY CONCRETE — BARRIER CRANE PAD EXISTING SHOULDER EXISTING SB LANE EXISTING SHOULDER EXISTING NB LANE EXISTING SB LANE EXISTING SHOULDER INTERIM SINGLE WHITE PAVEMENT MARKING ITEM 619.100103 - INTERIM SINGLE WHITE PAVEMENT MARKING ITEM 619.100103 TRENCHING LOCATION
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FOR DETAILS SPLICE VAULT LOCATION — TEMPORARY SHORING 1. SEE SHEET C-507 FOR WZTC DETAILS. HORIZONTAL SCALE KIEWIT PROJECT NO. CHAMPLAIN HUDSON POWER EXPRESS 21162 IT IS A VIOLATION OF LAW FOR ANY PERSON, UNLESS THEY ARE ACTING UNDER THE DIRECTION OF A LICENSED PROFESSIONAL ENGINEER, ARCHITECT, LANDSCAPE ARCHITECT OR LAND SURVEYOR TO ALTER AN ITEM IN ANY WAY. IF AN ITEM BEARING THE STAMP OF A LICENSED PROFESSIONAL IS ALTERED, THE ALTERING ENGINEER, ARCHITECT, LANDSCAPE ARCHITECT OR LAND SURVEYOR SHALL STAMP THE DOCUMENT AND INCLUDE THE NOTATION "ALTERED BY" FOLLOWED BY THEIR SIGNATURE, THE DATE OF SUCH ALTERATION, AND A SPECIFIC DESCRIPTION OF THE ALTERATION. **SEGMENT 2 - ROUTE 22: DRESDEN - WHITEHALL** CHA PROJECT NO. Kiewit WORK ZONE TRAFFIC CONTROL CROSS SECTIONS DRAWING NO. **C-522** SHEET 9 OF 9 Albany, NY 12205-0269 518.453.4500 • www.chacompanies.com 09/21/2022 FINAL EM&CP SUBMISSION **Power Express** AS SHOWN DB APP DRAWN BY: JAH DESIGNED BY: JPS APPROVED BY: MDH REV. NO. SUBMITTAL / REVISION DESCRIPTION 9/18/2022

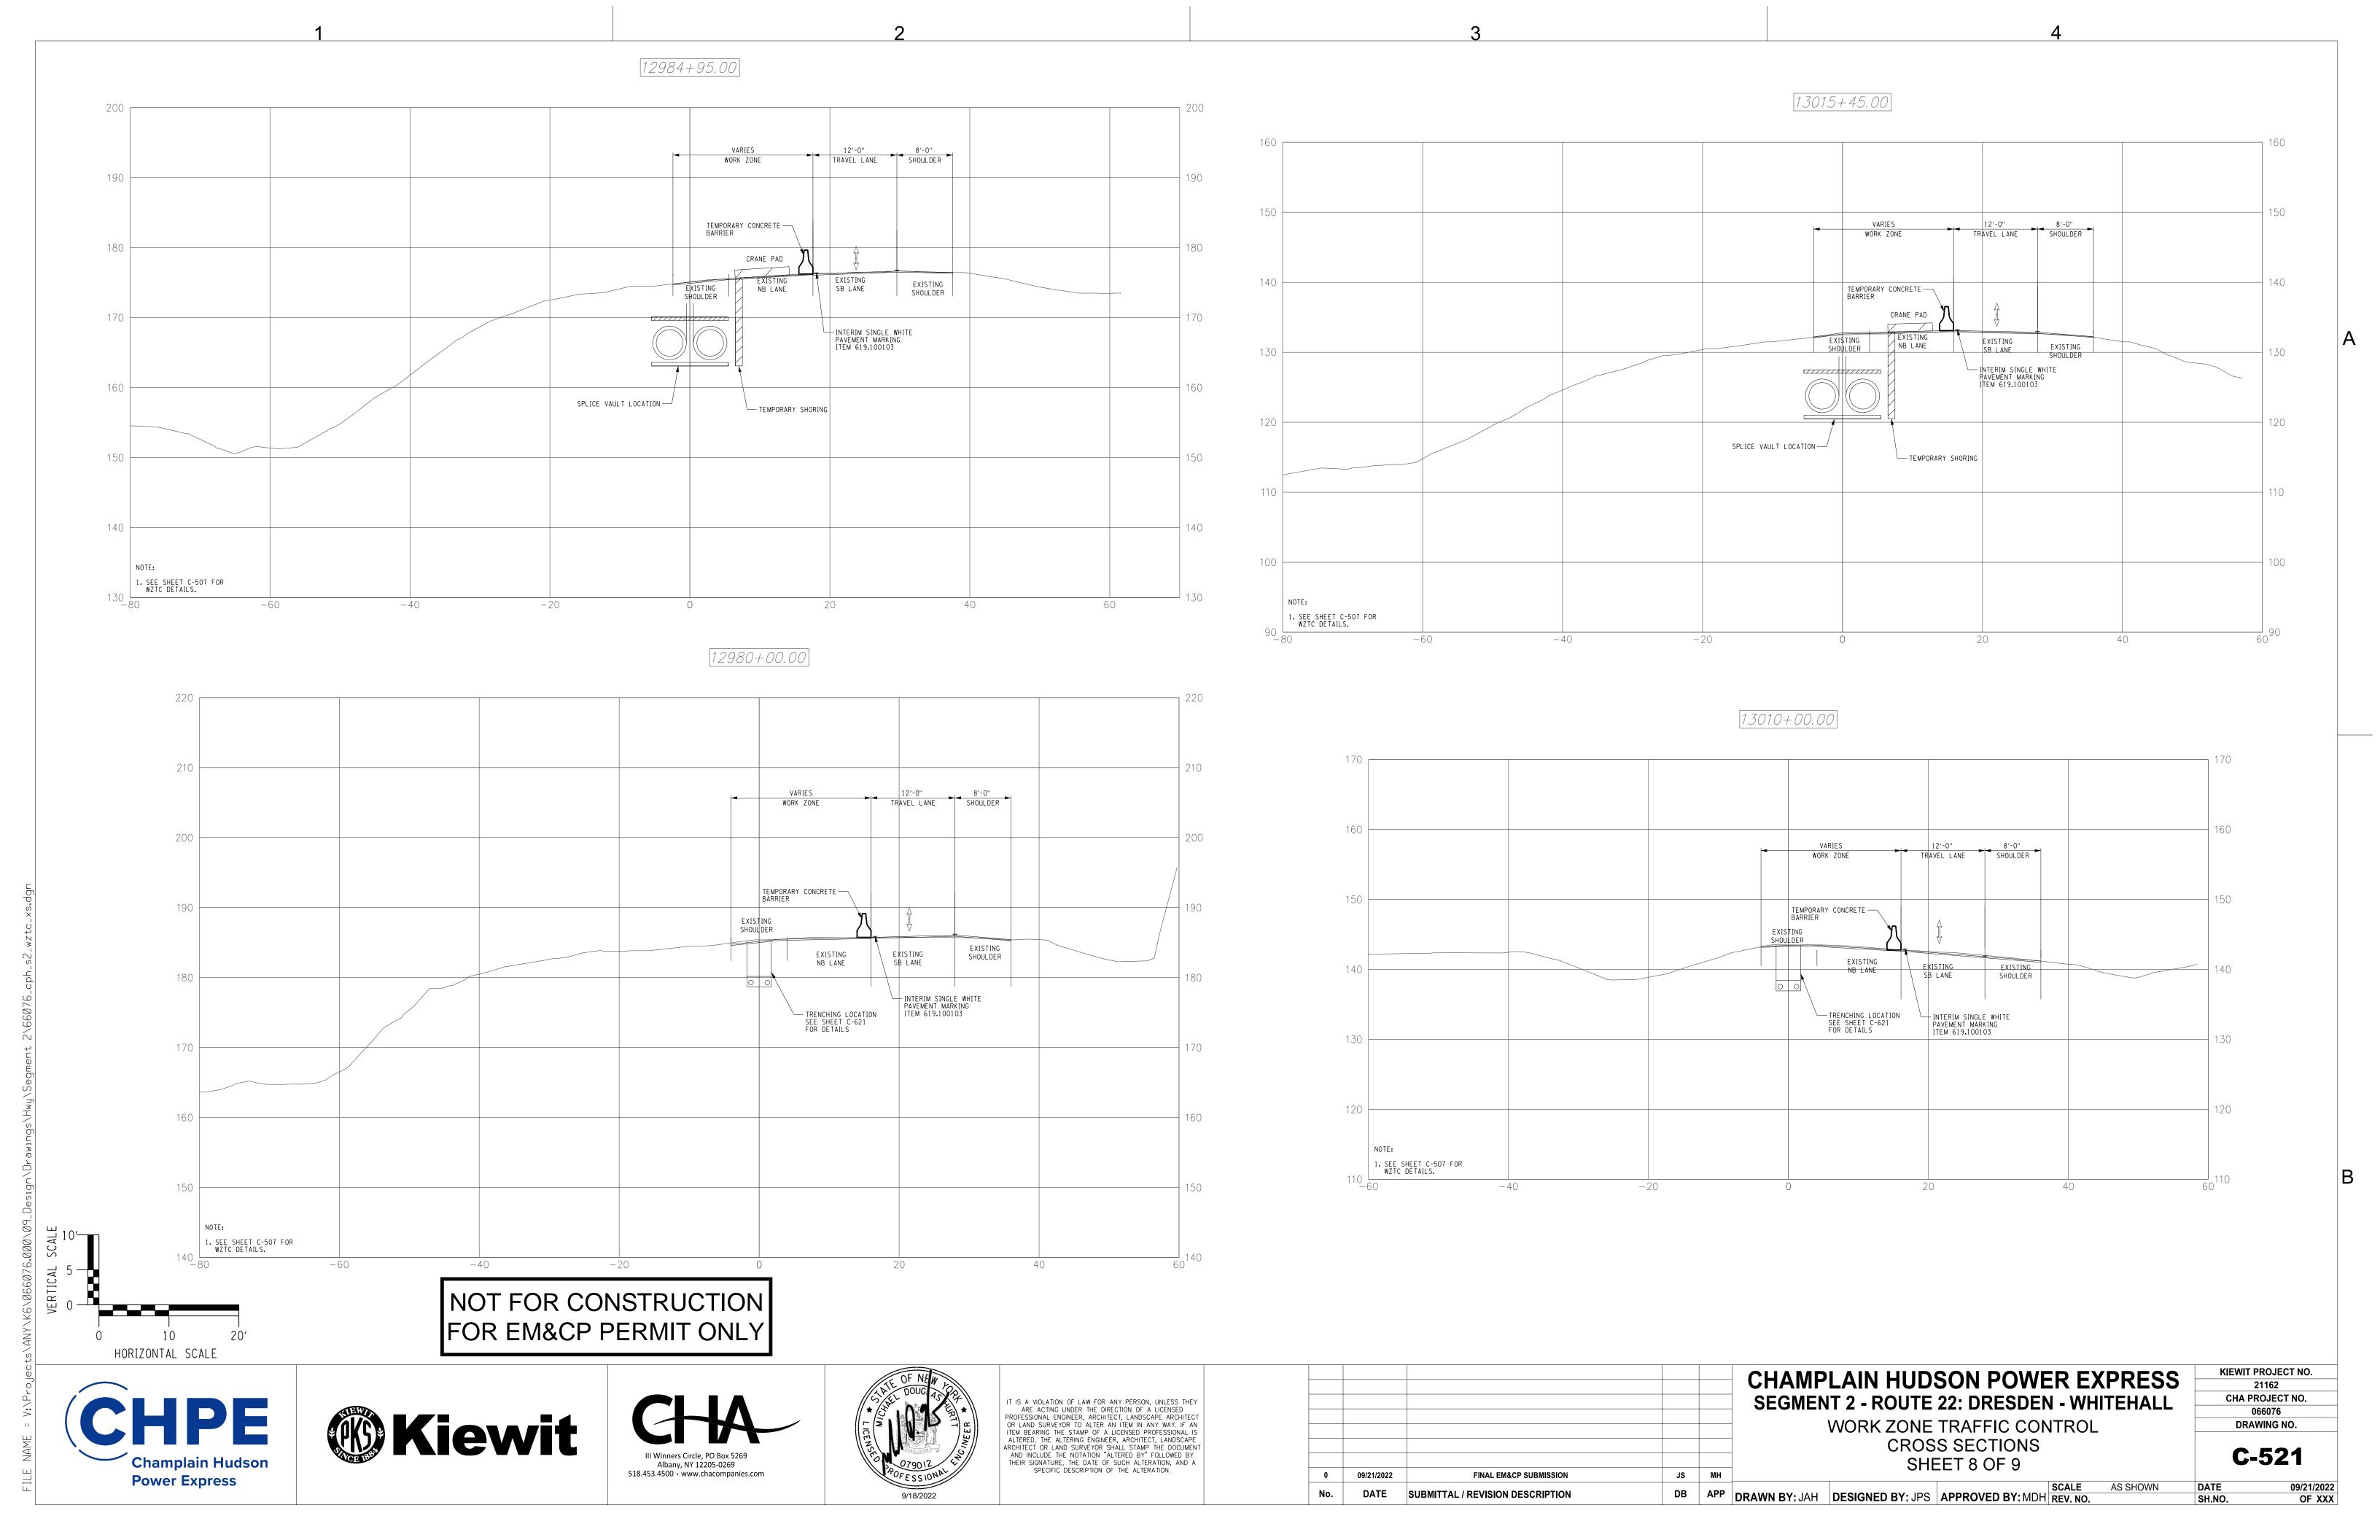

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- TIE FABRIC TO WIRE FENCE IN ACCORDANCE WITH MANUFACTURERS RECOMMENDATIONS.
- 2. IF EXTRA STRENGTH FABRIC (GREATER THAN 50#/INCH) IS USED, WIRE CAN BE DELETED IF POST SPACING IS REDUCED TO 6' O.C.
- 3. AT THE ENDS OF THE FENCING THE FIRST 20' SHALL BE TURNED UP THE SLOPE 2'.
- POSTS SHOULD BE INCLINED TOWARD THE DIRECTION FLOW CAME
- OVERLAP FABRIC A MINIMUM OF 6" AND FOLDED AT JOINTS. ATTACH FILTER FABRIS TO STAKES ALLOWING EXTENSION INTO TRENCH AS SHOWN; SECURE TO STAKES AS NOTED.
- THE MAXIMUM AREA OF RUNOFF PER 100LF. OF FENCE SHALL NOT EXCEED 0.25 ACRES.
- MAINTENANCE SHALL BE PERFORMED AS NECESSARY. THE FENCING SHALL BE CHECKED AFTER EVERY STORM TO ENSURE THEIR PROPER FUNCTIONING.
- WHEN FENCE IS NO LONGER NEEDED, THE ACCUMULATED SILT, THE POSTS AND FABRIC SHALL BE REMOVED AND TRENCH BACK FILLED WITH TOPSOIL AND SEEDED.
- 9. FENCING SHOULD BE PLACED AS SHOWN ON THE DRAWING OR IF NOT SHOWN, 10' BEYOND THE TOE OF THE OF THE SLOPE AND AT A SPACING IN ACCORDANCE WITH THE TABLE.
- 10. EXCAVATE TRENCH AS PER DETAIL AND SET POSTS AT 10' O.C.
- 11. BACKFILL WITH COMPACTED, EXCAVATED SOIL FROM TRENCH.

-NORTH AMERICAN GREEN S75 OR APPROVED EQUAL ON SUBGRADE, TEMP. SEED MIXTURE FILTER SOCK, SIZED TO SUIT HARDWOOD POST CONDITIONS. 10' O.C. WATER FLOW INLET SIDE FILTER COMPOST MATERIAL AS PER SPECIFICATIONS. NOTES:

- 1. ALL MATERIAL TO MEET MANUFACTURER SPECIFICATIONS.
- 2. ALL FILTER SOCKS SHALL BE 12" DIAMETER OR LARGER. 3. THE CONTRACTOR SHALL MAINTAIN THE COMPOST FILTER BERM
- IN A FUNCTIONAL CONDITION AT ALL TIMES AND IT SHALL BE ROUTINELY INSPECTED. 4. WHERE THE BERM REQUIRES REPAIR, IT WILL BE ROUTINELY
- 5. THE CONTRACTOR SHALL REMOVE SEDIMENTS COLLECTED AT THE BASE OF THE BERM WHEN THEY REACH 1/3 OF THE EXPOSED HEIGHT OF THE BERM, OR AS DIRECTED BY THE
- 6. THE COMPOST FILTER BERM WILL BE REMOVED ON SITE WHEN NO LONGER REQUIRED, AS DETERMINED BY THE OWNERS.
- 7. INSTALL PERPENDICULAR TO FLOW.

MAINTENANCE NOTES:

TOP OF CHANNEL/BANK

THE CHANNEL

FILTER

SOCK

CHANNEL PLACEMENT

FILTER

SOCK


FILTER

SOCK

- 1. TRAFFIC SHALL NOT BE PERMITTED TO CROSS FILTER
- 2. ACCUMULATED SEDIMENT SHALL BE REMOVED WHEN IT REACHES \(\frac{1}{3}\) OF THE EXPOSED HEIGHT OF THE PRACTICE AND DISPOSED OF IN ACCORDANCE WITH THE SWPPP.
- 3. SOCKS SHALL BE INSPECTED WEEKLY AND AFTER EACH RUNOFF EVENT. DAMAGED SOCKS SHALL BE REPAIRED IN THE MANNER REQUIRED BY THE MANUFACTURER OR REPLACED WITHIN 24 HOURS OF FILTER SOCK SHALL BE PLACED PERPENDICULAR TO THE FLOW ACROSS THE ENTIRE WIDTH OF INSPECTION NOTIFICATION.
 - BIODEGRADABLE FILTER SOCKS SHALL BE REPLACED AFTER 6 MONTHS; PHOTO-DEGRADABLE FILTER SOCKS AFTER 1 YEAR. POLY-PROPYLENE SOCKS SHALL BE REPLACED ACCORDING TO THE

MANUFACTURER'S RECOMMENDATIONS.

5. UPON STABILIZATION OF THE AREA CONTRIBUTORY TO THE SOCK, STAKES SHALL BE REMOVED. THE SOCK SHALL BE REMOVED. FOR REMOVAL THE MESH CAN BE CUT AND COMPOST SPREAD AS AN ADDITIONAL MULCH TO ACT AS A SOIL SUPPLEMENT.

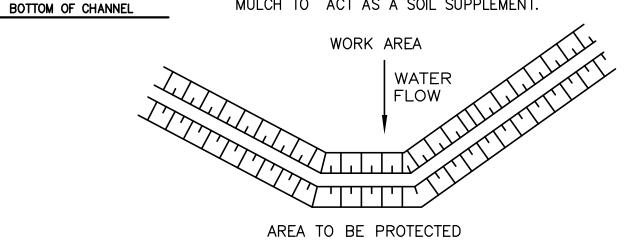

AT GRADE PLACEMENT


EXISTING OR


PROPOSED FINISHED GRADE

4"-TOPSOIL. SEED SIDE

SLOPES AND BOTTOM

COMPOST FILTER SOCK DETAIL

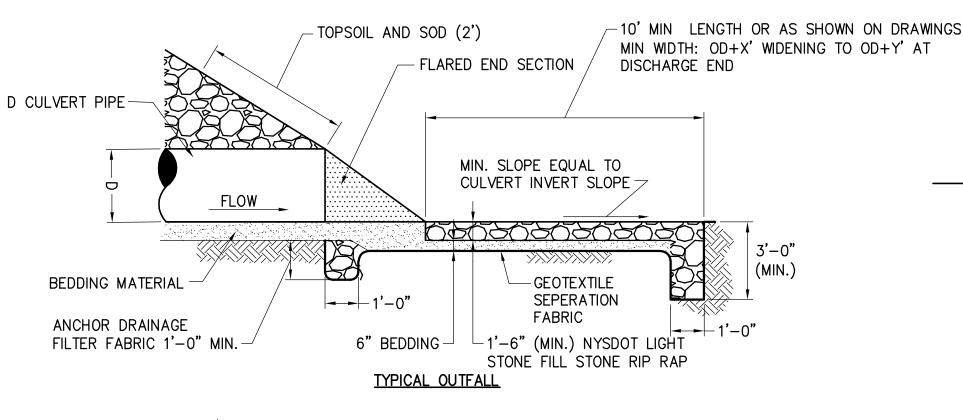

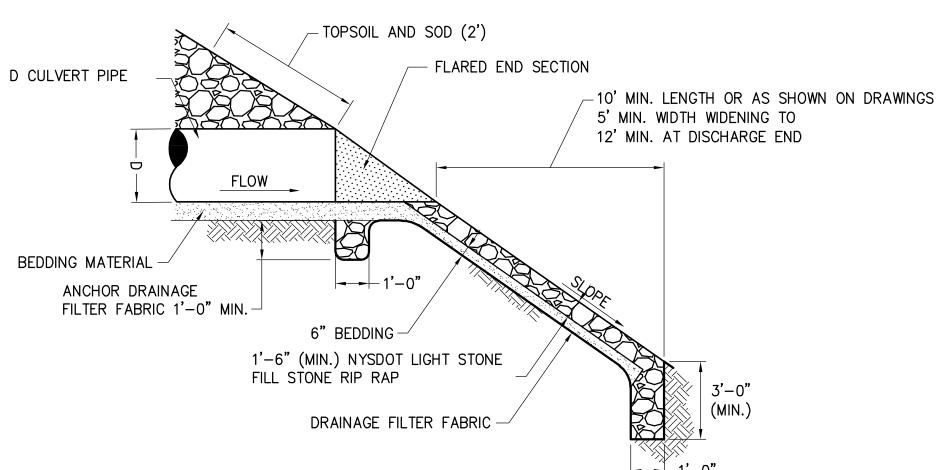

TYPICAL GRASS DRAINAGE SWALE

-1'-0" MIN.

-EXISTING GRADE (TYP.) BLEND FINISHED GRADES TO EXISTING (TYP.) - EROSION CONTROL BLANKET (TYP.) SEED AND MULCH ALL DISTRURBED AREAS SIDE SLOPES AS SHOWN ON GRADING PLANS (TYP.) NYSDOT LIGHT STONE FILL GEOTEXTILE SEPARATION FABRIC UNDISTURBED SUBGRADE OR SUBGRADE COMPACTED AS SHOWN ON PLAN TO 95% PROCTOR

TYPICAL CULVERT OUTFALL RIP RAP

TYPICAL OUTFALL ON SLOPE

LIGHT STONE-LINED DRAINAGE CHANNEL SCALE: N.T.S.

> CHAMPLAIN HUDSON POWER EXPRESS **SEGMENT 2 - ROUTE 22: DRESDEN - WHITEHALL EROSION AND SEDIMENT CONTROL DETAILS**

KIEWIT PROJECT NO. 21162 CHA PROJECT NO. DRAWING NO.

C-601

Champlain Hudson

Power Express

SILT FENCE

SCALE: N.T.S.







IT IS A VIOLATION OF LAW FOR ANY PERSON, UNLESS THEY ARE ACTING UNDER THE DIRECTION OF A LICENSED PROFESSIONAL ENGINEER, ARCHITECT, LANDSCAPE ARCHITECT OR LAND SURVEYOR TO ALTER AN ITEM IN ANY WAY. IF AN ALTERED. THE ALTERING ENGINEER ARCHITECT LANDSCAPE ACHIERED, THE ALTERING ENGINEER, ARCHITECT, LANDSCAPE
ARCHITECT OR LAND SURVEYOR SHALL STAMP THE DOCUMENT
AND INCLUDE THE NOTATION "ALTERED BY" FOLLOWED BY
THEIR SIGNATURE, THE DATE OF SUCH ALTERATION, AND A
SPECIFIC DESCRIPTION OF THE ALTERATION.


JM JR 09/21/2022 FINAL EM&CP SUBMISSION

DATE SUBMITTAL / REVISION DESCRIPTION

DB APP DRAWN BY: SKB DESIGNED BY: SKB APPROVED BY: JPR REV. NO.


AS NOTED DATE X SH.NO.

XXX OF XXX

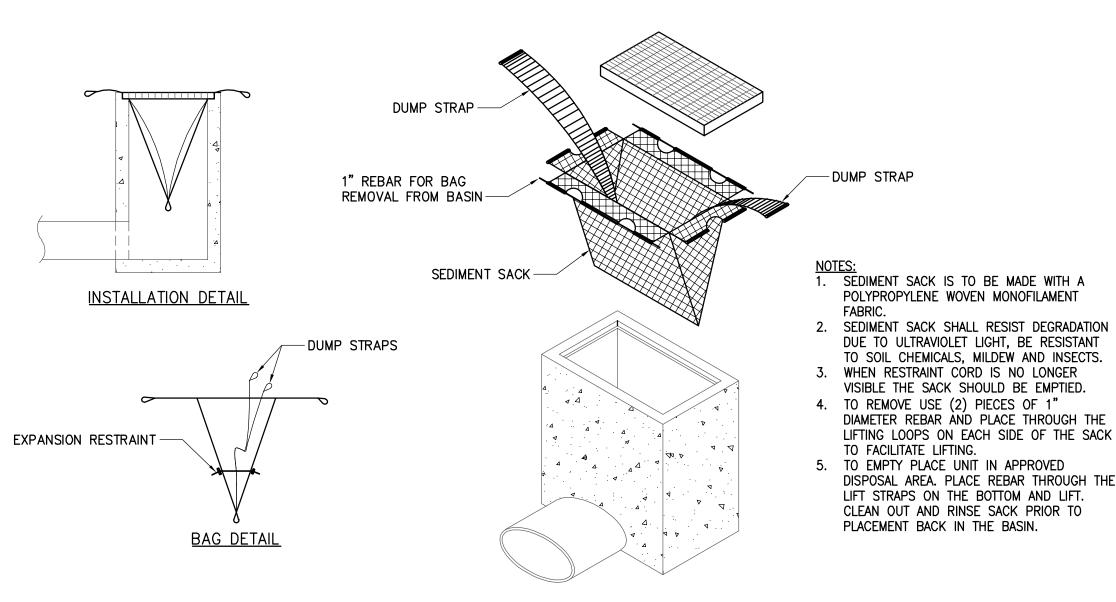

6' LONG 13 GAUGE RUST PROOF —STEEL FENCE POST WITH STABILIZING ANCHOR PLATES -CONSTRUCTION FLAT ORIENTED OR DIAMOND MESH BARRIER FENCE 8' O.C. MAX. -WARNING SIGN (SEE ADJACENT DETAIL) (SIGNS SPACED AT 48' ON CENTER±) EXISTING GRADE **ELEVATION**

- 2. THE CONTRACTOR SHALL INSTALL AT THE BEGINNING OF THE CONTRACT, AND MAINTAIN THROUGHOUT ITS DURATION.
- 3. SET BOTTOM OF CONSTRUCTION BARRIER FENCE FLUSH WITH EXISTING
- 4. CONSTRUCTION BARRIER FENCE SHALL HAVE A MINIMUM TENSILE STRENGTH OF 2000 PSI.

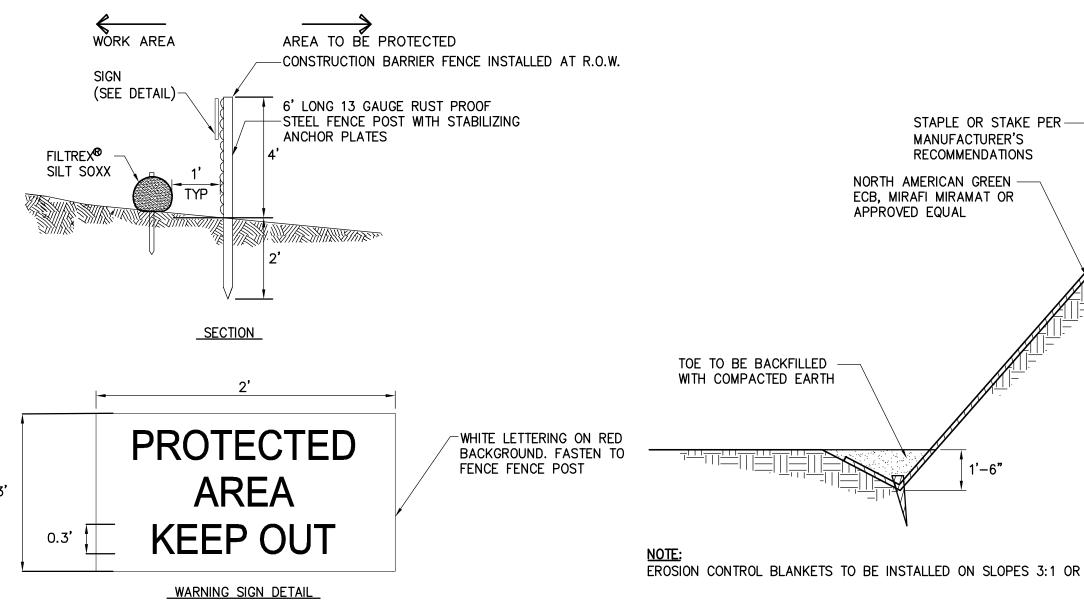


STAPLE OR STAKE PER — EROSION CONTROL BLANKETS TO BE INSTALLED ON SLOPES 3:1 OR GREATER (TYP.)

EROSION CONTROL BANK STABILIZATION DETAIL

INLET PROTECTION

50' MINIMUM FROM WETLANDS/WATERBODIES

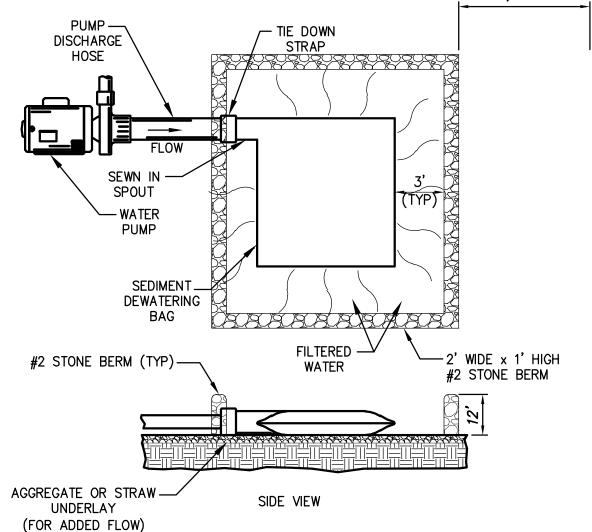

NOTE: THE SEDIMENT DEWATERING BAG WILL BE MANUFACTURED IN THE U.S.A. FROM A NONWOVEN POLYPROPYLENE FABRIC THAT MEETS OR EXCEEDS THE FOLLOWING SPECIFICATIONS:


SEDIMENT DEWATERING BAG SPECIFICATIONS

Mechanical Properties	Test Method	Units	MARV
·			
Grab Tensile Strength	ASTM D 4632	kN (lbs)	0.9 (205) x 0.9 (205)
Grab Tensile Elongation	ASTM D 4632	%	50 × 50
Puncture Strength	ASTM D 4833	kN (lbs)	0.58 (130)
Mullen Burst Strength	ASTM D 3786	kPa (psi)	2618 (380)
Trapezoid Tear Strength	ASTM D 4533	kN (lbs)	0.36 (80) X 0.36 (80)
UV Resistence	ASTM D 4355	%	70
Apparent Opening Size	ASTM D 4751	Mm (US Std Sieve)	0.180 (80)
Flow Rate	ASTM D 4491	1/min/m² (gal/min/ft²)	3866 (95)
Permittivity	ASTM D 4491	Sec ⁻¹	1.2


SEDIMENT DEWATERING BAG SCALE: N.T.S.

NOT FOR CONSTRUCTION

FOR EM&CP PERMIT ONLY

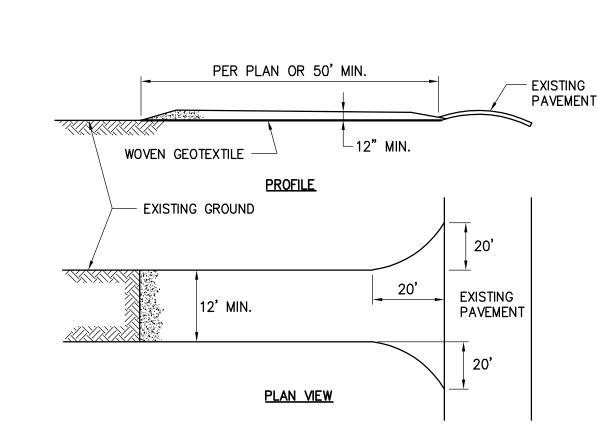

- 1. STONE SIZE-USE AASHTO M43 SIZE 3 COARSE AGGREGATE, OR RECLAIMED OR RECYCLED CONCRETE EQUIVALENT.
- 2. LENGTH NOT LESS THAN 50 FEET (EXCEPT ON A SINGLE RESIDENCE LOT WHERE A 30 FOOT MINIMUM LENGTH WOULD APPLY).
- 3. THICKNESS NOT LESS THAN 12".
- 4. WIDTH TWELVE (12) FOOT MINIMUM, BUT NOT LESS THAN THE FULL WIDTH AT POINTS WHERE INGRESS OR EGRESS OCCURS. TWENTY-FOUR (24) FOOT IF SINGLE ACCESS TO SITE.
- 5. WOVEN GEOTEXTILE FABRIC WILL BE PLACED OVER THE ENTIRE AREA PRIOR TO PLACING OF STONE.
- 6. EXISTING ROAD SIDE DRAINAGE SHALL BE MAINTAINED.
- 7. SURFACE WATER ALL SURFACE WATER FLOWING OR DIVERTED TOWARD CONSTRUCTION ENTRANCES SHALL BE PIPED BENEATH THE ENTRANCE, IF PIPING IS IMPRACTICAL, A MOUNTABLE BERM WITH 5:1 SLOPES WILL BE PERMITTED.
- 8. MAINTENANCE-THE ACCESS SHALL BE MAINTAINED IN A CONDITION WHICH WILL PREVENT TRACKING OR FLOWING OF SEDIMENT ONTO PUBLIC RIGHTS-OF-WAY. THIS MAY REQUIRE PERIODIC TOP DRESSING WITH ADDITIONAL STONE AS CONDITIONS DEMAND AND REPAIR AND/OR CLEANOUT OF ANY MEASURES USED TO TRAP SEDIMENT. ALL SEDIMENT OR STONE SPILLED. DROPPED, WASHED, OR TRACKED ONTO PUBLIC RIGHTS-OF-WAY MUST BE REMOVED IMMEDIATELY.
- 9. WHEN WASHING IS REQUIRED, IT SHALL BE DONE ON A AREA STABILIZED WITH STONE AND WHICH DRAINS INTO AN APPROVED SEDIMENT TRAPPING DEVICE.
- 10. PERIODIC INSPECTION AND NEEDED MAINTENANCE SHALL BE PROVIDED AFTER EACH RAIN.

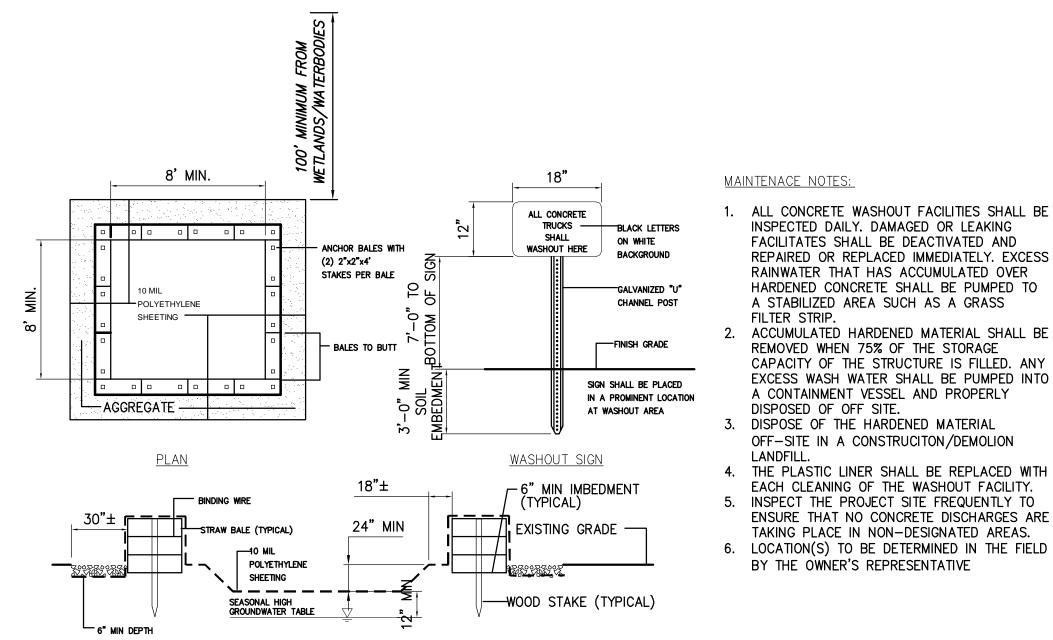

AGGREGATE ALL AROUND TYPICAL SECTION CONCRETE WASHOUT AREA

SCALE: N.T.S.

A CONTAINMENT VESSEL AND PROPERLY DISPOSED OF OFF SITE. DISPOSE OF THE HARDENED MATERIAL OFF-SITE IN A CONSTRUCITON/DEMOLION

FILTER STRIP.

4. THE PLASTIC LINER SHALL BE REPLACED WITH EACH CLEANING OF THE WASHOUT FACILITY.

INSPECT THE PROJECT SITE FREQUENTLY TO ENSURE THAT NO CONCRETE DISCHARGES ARE

INSPECTED DAILY. DAMAGED OR LEAKING

FACILITATES SHALL BE DEACTIVATED AND

A STABILIZED AREA SUCH AS A GRASS

REMOVED WHEN 75% OF THE STORAGE

REPAIRED OR REPLACED IMMEDIATELY. EXCESS

RAINWATER THAT HAS ACCUMULATED OVER

HARDENED CONCRETE SHALL BE PUMPED TO

ACCUMULATED HARDENED MATERIAL SHALL BE

CAPACITY OF THE STRUCTURE IS FILLED. ANY

EXCESS WASH WATER SHALL BE PUMPED INTO

TAKING PLACE IN NON-DESIGNATED AREAS. 6. LOCATION(S) TO BE DETERMINED IN THE FIELD

BY THE OWNER'S REPRESENTATIVE

5 | STABILIZED CONSTRUCTION ACCESS SCALE: N.T.S.


Champlain Hudson Power Express







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CHAMPLAIN HUDSON POWER EXPRESS **SEGMENT 2 - ROUTE 22: DRESDEN - WHITEHALL EROSION AND SEDIMENT CONTROL DETAILS**

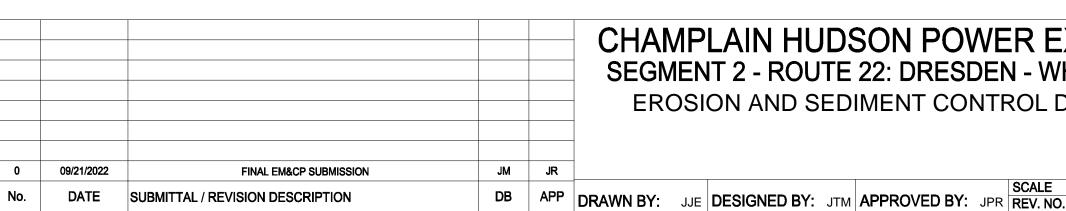KIEWIT PROJECT NO. 21162 CHA PROJECT NO. 066076 DRAWING NO.

C-602

AS NOTED DATE

XXX OF XXX

X SH.NO.

1. SEDIMENT SACK IS TO BE MADE WITH A POLYPROPYLENE WOVEN MONOFILAMENT 2. SEDIMENT SACK SHALL RESIST DEGRADATION DUE TO ULTRAVIOLET LIGHT, BE RESISTANT

TO SOIL CHEMICALS, MILDEW AND INSECTS WHEN RESTRAINT CORD IS NO LONGER VISIBLE THE SACK SHOULD BE EMPTIED. 4. TO REMOVE USE (2) PIECES OF 1" DIAMETER REBAR AND PLACE THROUGH THE

TO FACILITATE LIFTING. TO EMPTY PLACE UNIT IN APPROVED DISPOSAL AREA. PLACE REBAR THROUGH THE LIFT STRAPS ON THE BOTTOM AND LIFT. CLEAN OUT AND RINSE SACK PRIOR TO PLACEMENT BACK IN THE BASIN.

CONSTRUCTION FENCE BY RESINET OR EQUAL CONSTRUCTION BARRIER FENCE SHALL BE INSTALLED IN THE LOCATIONS SHOWN ON THE PLANS PRIOR TO BEGINNING ANY WORK ADJACENT TO THESE AREAS.

1.3'


WETLAND PROTECTION FENCE

1. TIMBER MATS SHOULD BE INSTALLED IN WETLANDS AND OTHER AREAS IF NECESSARY TO PREVENT RUTTING.

- 2. BASED ON ACTUAL SITE CONDITIONS, MULTIPLE LAYERS OF TIMBER MATS MAY BE REQUIRED. 3. TIMBER MAT SURFACE SHOULD BE LEVEL TO PREVENT EQUIPMENT AND VEHICLES FROM
- SLIDING OFF DURING MUDDY OR ICING CONDITIONS, AND PREVENT TIMBERS FROM BREAKING. 4. SEDIMENT TRACKED ONTO TIMBER MATTING SHOULD BE REMOVED AS NECESSARY TO PREVENT SEDIMENT FROM ENTERING WETLAND DURING RAIN EVENTS. SEDIMENT SHOULD BE
- REMOVED TO A STABILIZED SOIL STOCKPILE OR OTHER APPROVED LOCATION. 5. PERIMETER EROSION AND SEDIMENT CONTROL ARE REQUIRED TO BE INSTALLED PRIOR TO PLACING TIMBER MATTING.
- 6. UNLESS PERMITTED FROM REMOVAL, STUMPS WITHIN THE WETLAND SHOULD REMAIN. THIS MAY REQUIRE ADDITIONAL TIMBERS TO BRIDGE ABOVE.
- 7. UPON REMOVAL OF TIMBER MATTING ALL SPLINTERED WOOD SHOULD BE REMOVED. IF EXPOSED SOILS ARE PRESENT STRAW MULCH SHOULD BE APPLIED.

NOTE: GEOTEXTILE FABRIC TO BE INSTALLED UNDER MATTING (TYP)



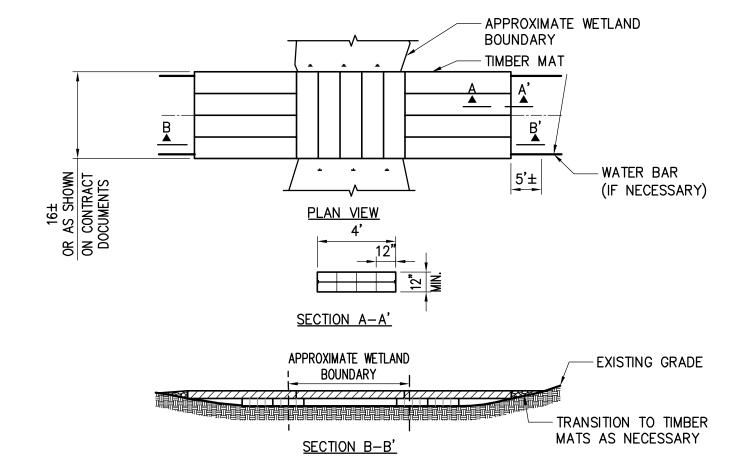



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- EXPOSED SOILS ARE PRESENT STRAW MULCH SHOULD BE APPLIED.

NOTE: GEOTEXTILE FABRIC TO BE INSTALLED UNDER MATTING (TYP)

NOT TO SCALE



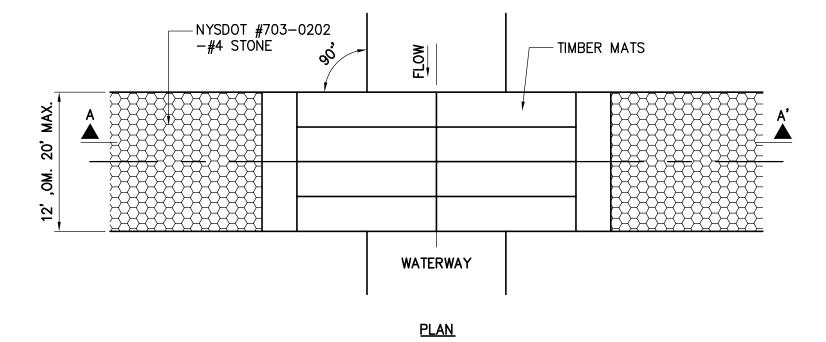

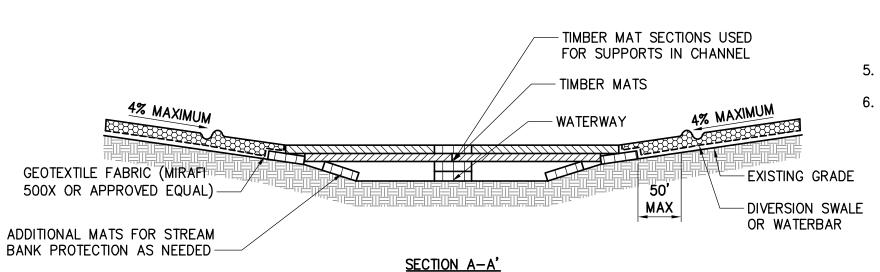NOTES:

- 1. IN-STREAM EXCAVATION SHOULD BE COMPLETED IN ACCORDANCE WITH "TEMPORARY ACCESS WATERWAY CROSSING" ON PAGE 2.32 OF THE 2016 NYSDEC STANDARDS AND SPECIFICATIONS FOR EROSION AND SEDIMENT CONTROL (OR NEWEST VERSION) AND THE CERTIFICATE.
- THE CONSTRUCTION OF ANY CROSSING SHOULD NOT CAUSE A SIGNIFICANT WATER LEVEL DIFFERENCE BETWEEN THE UPSTREAM AND DOWNSTREAM WATER SURFACE ELEVATIONS. IN-STREAM WORK WILL BE PROHIBITED WITHIN COLD WATER TROUT FISHERIES FROM OCTOBER 1 TO MAY 31.
- 3. ALL FILL MATERIALS ASSOCIATED WITH THE ROADWAY APPROACH SHOULD BE LIMITED TO A MAXIMUM HEIGHT OF 2 FEET ABOVE THE EXISTING FLOOD PLAIN ELEVATION.
- 4. A WATER DIVERTING STRUCTURE SUCH AS A SWALE OR WARE BAR SHOULD BE CONSTRUCTED (ACROSS THE ROADWAY ON BOTH ROADWAY APPROACHES) 50 FEET (MAXIMUM) ON EITHER SIDE OF THE WATERWAY CROSSING. THIS WILL PREVENT ROADWAY SURFACE RUNOFF FROM DIRECTLY ENTERING THE WATERWAY. THE 50 FEET MEASURED IS MEASURED FROM THE TOP OF THE WATERWAY BANK. IF THE ROADWAY APPROACH IS CONSTRUCTED WITH A REVERSE GRADE AWAY FROM THE WATERWAY, A SEPARATE DIVERTING STRUCTURE IS NOT REQUIRED.
- ALL CROSSINGS SHOULD HAVE ONE TRAFFIC LANE. THE MINIMUM WIDTH SHOULD BE 12 FEET WITH A MAXIMUM WIDTH OF 20 FEET. ANCHORS: TIMBER MATS SHOULD BE SECURELY ANCHORED AT ONLY ONE END, USING STEEL CABLE OR CHAIN. ANCHORING AT ONLY ONE END WILL PREVENT CHANNEL OBSTRUCTION IN THE EVENT THAT FLOODWATERS FLOAT THE BRIDGE. ACCEPTABLE ANCHORS ARE LARGE TREES, LARGE BOULDERS, OR DRIVEN STEEL ANCHORS. ANCHORING SHOULD BE SUFFICIENT TO PREVENT THE TIMBER MATS FORM FLOATING DOWNSTREAM AND POSSIBLY CAUSING AN OBSTRUCTION TO THE FLOW.

TO SCALE

TIMBER MATTING SCALE: N.T.S.









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ARCHITECT OR LAND SURVEYOR SHALL STAMP THE DOCUMENT
AND INCLUDE THE NOTATION "ALTERED BY" FOLLOWED BY
THEIR SIGNATURE, THE DATE OF SUCH ALTERATION, AND A
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0 09/21/2022	FINAL EM&CP SUBMISSION	JM	JR


CHAMPLAIN HUDSON POWER EXPRESS **SEGMENT 2 - ROUTE 22: DRESDEN - WHITEHALL** WETLAND CROSSING DETAILS

DRAWN BY: JJE DESIGNED BY: JTM APPROVED BY: JPR REV. NO.

KIEWIT PROJECT NO. 21162 CHA PROJECT NO. 066076 DRAWING NO.

C-611

AS NOTED DATE 09/21/2022 X SH.NO. XXX OF XXX

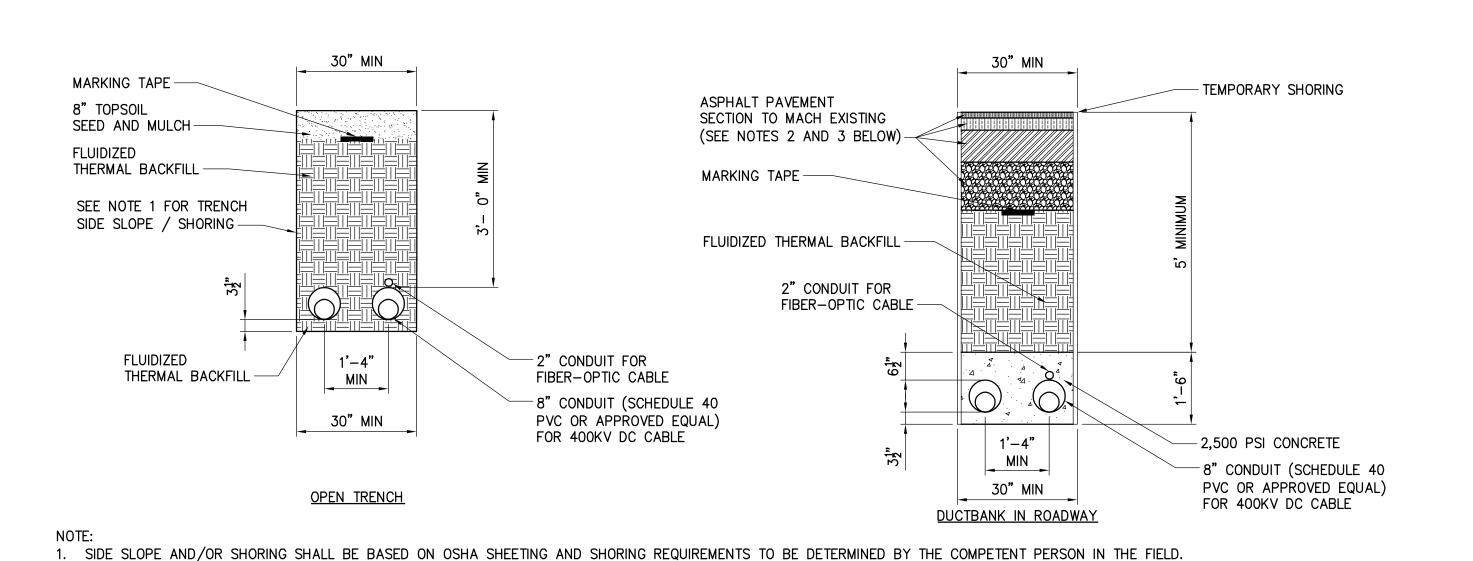

30" MIN MARKING TAPE -TEMPORARY SHORING ASPHALT PAVEMENT 8" TOPSOIL SECTION TO MACH EXISTING SEED AND MULCH (SEE NOTES 2 AND 3 BELOW) -FLUIDIZED THERMAL BACKFILL -MARKING TAPE — SEE NOTE 1 FOR TRENCH SIDE SLOPE / SHORING — FLUIDIZED THERMAL BACKFILL -2" CONDUIT FOR FIBER-OPTIC CABLE -FLUIDIZED 1'-10" 2" CONDUIT FOR THERMAL BACKFILL FIBER-OPTIC CABLE MIN -8" CONDUIT (SCHEDULE 40 36" MIN PVC OR APPROVED EQUAL) FOR 400KV DC CABLE 1'-10" -2,500 PSI CONCRETE MIN -8" CONDUIT (SCHEDULE 40 PVC OR APPROVED EQUAL) FOR 400KV DC CABLE OPEN TRENCH DUCTBANK IN ROADWAY

1. SLOPE SHALL BE BASED ON OSHA SHEETING AND SHORING REQUIREMENTS TO BE DETERMINED BY THE COMPETENT PERSON IN THE FIELD. 2. SEE DETAIL 4 ON DETAIL SHEET C-631 FOR PAVEMENT TRANSITION DETAIL.

2 36" WIDTH. 22" CENTER TO CENTER SPACING
NOT TO SCALE

3. SEE SHEET C-631 FOR SURFACE RESTORATION DETAILS.

DIRECTION OF CABLE PULL CABLE REEL PULLING WINCH DIRECTION OF CABLE PULL

SEE DETAIL 4 ON DETAIL SHEET C-631 FOR PAVEMENT TRANSITION DETAIL.

3. SEE SHEET C-631 FOR SURFACE RESTORATION DETAILS.

1 30" WDTH. 16" CENTER TO CENTER SPACING NOT TO SCALE

3 TYPICAL COUPLING DIRECTION OF PULL DETAIL
NOT TO SCALE

SPIGOT -

LONG BELL COUPLING -

304 STAINLESS -BUTT FUSION WELD STEEL OUTER RING DE-BEAD INNER RING 8" SCH 40 CONDUIT 10" IPS DR9 HDPE 8" SCH 40 DISTANCE LTR CONDUIT -BEVELED EDGE THIS TRANSITION COUPLING COMES ASSEMBLED AS A UNIT. POLY-CAM, ISCO INDUSTRIES P/N: 737-1008PVC40PVI09 TRANSITION COUPLING SHALL ARRIVE FROM VENDOR WITH NO ROUGH EDGES OR PROTRUSIONS ON INTERIOR. INTEGRITY OF COUPLING TO BE FIELD-VERIFIED PRIOR TO INSTALLATION. IF UNSATISFACTORY, CONTRACTOR TO SHAPE OR SAND PVC COMPRESSION SLEEVE MINOR IRREGULARITIES PRIOR TO INSTALLATION. 10" IPS DR9 HDPE

4 8"-10" PVC/HDPE TRANSITION COUPLING
NOT TO SCALE

NOT FOR CONSTRUCTION FOR EM&CP PERMIT ONLY









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0	09/21/2022	FINAL EM&CP SUBMISSION	JM	JR	SEGMENT 2 - ROUTE 22: DRESDEN - WH TRENCHING DETAILS
NI.	DATE		55		SCALE
No.	DATE	SUBMITTAL / REVISION DESCRIPTION	DB	APP	DRAWN BY: JJE DESIGNED BY: JTM APPROVED BY: JPR REV. NO.

CHAMPLAIN HUDSON POWER EXPRESS **SEGMENT 2 - ROUTE 22: DRESDEN - WHITEHALL** TRENCHING DETAILS

KIEWIT PROJECT NO. 21162 CHA PROJECT NO. 066076 DRAWING NO.

C-621

AS NOTED DATE XXX OF XXX X SH.NO.

- COMPACTED SUBGRADE 1. ABOVE SECTION IS THE MINIMUM FOR INSTALLATION. MATCH EXISTING SECTION IF EXISTING THICKNESS IS GREATER

ASPHALT CONCRETE PAVEMENT DETAIL

2. ALL MATERIALS TO MEET NYSDOT STANDARD SPECIFICATIONS

(PRIVATE DRIVEWAY)

-8" ASPHALT CONCRETE BASE COURSE (NYSDOT ITEM NO. 402.378904) -12" SUBBASE MATERIAL, MATCH EXISTING THICKNESS NYSDOT TYPE 2 (ITEM NO. 304.12)

ASPHALT CONCRETE PAVEMENT

(WITHIN NYSDOT ROADWAYS)

-1 1/2" ASPHALT CONCRETE TOP COURSE (NYSDOT TYPE 6, ITEM NO. 402.128204) -3" ASPHALT CONCRETE BINDER COURSE (NYSDOT TYPE 3, ITEM NO. 402.258904) - COMPACTED SUBGRADE 1. ABOVE SECTION IS THE MINIMUM FOR INSTALLATION. MATCH EXISTING SECTION IF EXISTING THICKNESS IS GREATER 2. ALL MATERIALS TO MEET NYSDOT STANDARD SPECIFICATIONS

> ASPHALT CONCRETE PAVEMENT 3 (WITHIN COUNTY OR TOWN ROADWAYS)


2. ALL MATERIALS TO MEET NYSDOT STANDARD SPECIFICATIONS

IF EXISTING THICKNESS IS GREATER

COLD MILL EXISTING PAVEMENT TOP COURSE, TACK -SAW CUT FULL DEPTH COAT AND INSTALL NEW TOP COURSE: TOP COURSE PER - EXISTING PAVEMENT PAVEMENT DETAIL -SUBBASE COLD MILL EXISTING PAVEMENT 24" MIN. BEYOND THE TRENCH WALL

1. ALL MATERIALS TO MEET NYSDOT STANDARD SPECIFICATIONS

4 PAVEMENT TRANSITION DETAIL

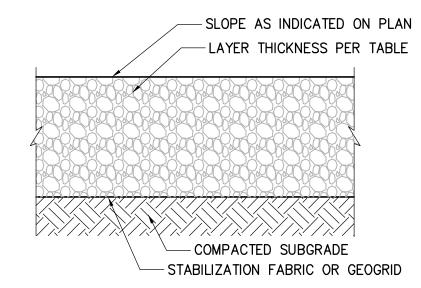


TEMPORARY ACCESS ROAD SECTION BX1200 CBR 180N GEOTEXTILE RD580I GEOTEXTILE GEOGRID² 24 INCH RIP RAP + 4 INCH 0.5 24 INCH RIP RAP³ AGGREGATE + 6 INCH AGGREGATE 1.0 20 INCH AGGREGATE 12 INCH AGGREGATE 9 INCH AGGREGATE 1.5 15 INCH AGGREGATE 9 INCH AGGREGATE 2.0 12 INCH AGGREGATE 6 INCH AGGREGATE 3.0+ 9 INCH AGGREGATE 6 INCH AGGREGATE

1 ESTIMATE CBR IN THE FIELD USING A DYNAMIC CONE PENETROMETER. ² SEPARATOR GEOTEXTILE FABRIC SUCH AS MIRAFI 140N SHALL BE INCLUDED BENEATH GEOGRID LAYER ON COHESIVE SUBGRADE 3 RIP RAP TO BE NYSDOT LIGHT STONE FALL

 4 A LAYER OF #57 STONE MAY BE REQUIRED ON TOP OF GEOTEXTILE TO PREVENT DAMAGING OR PUNCHING OF THE FABRIC. ⁵ GEOGRID AND GEOTEXTILES SHALL BE INSTALLED PER MANUFACTURES SPECIFICATION INCLUDING OVERLAP AND EDGE DETAILS

ACCESS ROAD SECTIONS PER KIEWIT GEOTECHNICAL

TEMPORARY ACCESS ROAD

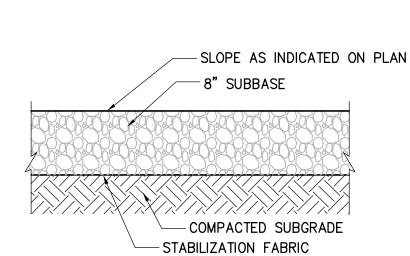

1. ABOVE SECTION IS THE MINIMUM FOR INSTALLATION. MATCH EXISTING SECTION

1 1/2" ASPHALT CONCRETE TOP COURSE

(NYSDOT TYPE 6, ITEM NO. 402.128204)

(NYSDOT TYPE 3, ITEM NO. 402.258904)

-3" ASPHALT CONCRETE BASE COURSE

(NYSDOT ITEM NO. 402.378904)


NYSDOT TYPE 2 (ITEM NO. 304.12)

-12" SUBBASE MATERIAL,

- COMPACTED SUBGRADE

MATCH EXISTING THICKNESS

-2-1/2" ASPHALT CONCRETE BINDER COURSE

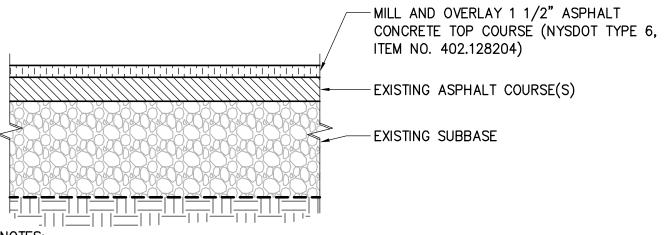

MILL AND OVERLAY ASPHALT CONCRETE PAVEMENT DETAIL

1. APPLY TACKCOAT TO MILLED SURFACE PRIOR TO PLACING ASPHALT

CONCRETE TOP COURSE. 2. ALL MATERIALS TO MEET NYSDOT STANDARD SPECIFICATIONS

SCALE: N.T.S.

0.D. + 3'-0" BACKFILL WITH SUITABLE MATERIAL (NYS DOT ITEM NO. 203.02) PIPE ZONE BACKFILL (NYS DOT SUBASE TYPE 4, ITEM NO. 304.14) ✓ SLOPE TRENCH 1/2 0.D. + 12" MIN. AS REQ'D PIPE ZONE BEDDING (NYS DOT NO. 2 STONE, ITEM NO. 703.02) ¹1/2 0.D. + 8"


UNDISTURBED MATERIAL-

1. WHERE IDENTIFIED ON PLANS, CULVERT REPLACEMENTS AND/OR REPAIR TO BE COMPLETED IN ACCORDANCE WITH NYSDOT STANDARD SHEETS (NYSDOT STANDARD SHEET GROUP 603 CULVERTS AND STORM DRAINS AND NYSDOT BRIDGE DETAIL SHEETS BD-CB1 THRU BD-CB13)

OPTIONAL EXTRA BEDDING AS


PIPE ORDERED BY THE ENGINEER

CULVERT REPLACEMENT

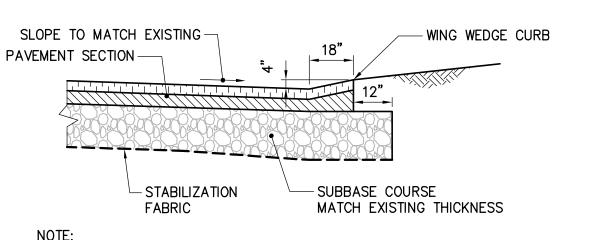

1. ALL MATERIALS TO MEET NYSDOT STANDARD SPECIFICATIONS

WING WEDGE CURB DETAIL

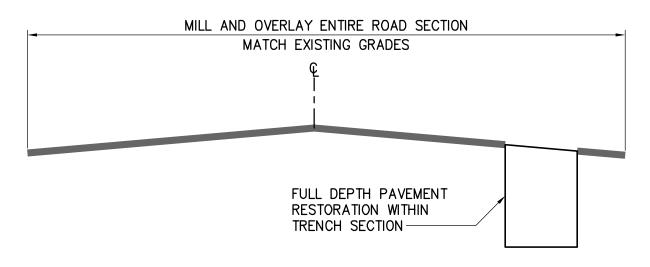

BELLAMY ST TYPICAL ROADWAY RESTORATION SCALE: N.T.S.

TYPICAL LIMIT OF WORK/LIMIT OF CLEARING SEE C-100 SERIES PLAN SHEETS FOR SPECIFIC LOCATIONS. ALL DISTURBED AREAS TO BE - GUIDERAIL REPLACEMENT IN RESTORED IN ACCORDANCE WITH NOTES ON G-020. -ACCORDANCE WITH NYSDOT STANDARD SHEET 606-01 (BOTH SIDES OF EXISTING GRADE/DRAINAGE TO BE ROADWAY WITHIN PROJECT LIMITS RESTORED TO EXISTING CONDITIONS — WHERE EXISTING) MILL AND OVERLAY ENTIRE ROAD SECTION MATCH EXISTING GRADES (SEE DETAIL 7 ON SHEET C-631) SAWCUT LIMIT OF TRENCH EXCAVATION — FULL DEPTH PAVEMENT RESTORATION WITHIN TRENCH SECTION AND ENTIRE SHOULDER SEE DETAIL 2 ON SHEET C-631-1. SEE APPLICABLE NOTES ON SHEETS G-003 AND G-020 REGARDING ROADWAY RESTORATION. 2. FOR TYPICAL SPLICE VAULT SEE S-700 DETAIL SHEET. NYSDOT ROUTE 22 TYPICAL ROADWAY RESTORATION

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No.	DATE	SUBMITTAL / REVISION DESCRIPTION	DB	APP	DRAWN BY: JJE	DESIGNED BY:	JTM	APPROVED I	3Y: JPF	SCALE REV. NO.

CHAMPLAIN HUDSON POWER EXPRESS **SEGMENT 2 - ROUTE 22: DRESDEN - WHITEHALL** SURFACE RESTORATION DETAILS

KIEWIT PROJECT NO. 21162 CHA PROJECT NO. DRAWING NO.

C-631

AS NOTED DATE X SH.NO. XXX OF XXX


CULVERT REPLACEMENT CONSTRUCTION SEQUENCING

- 1. INSTALL ALL EROSION AND SEDIMENT CONTROL MEASURES.
- 2. INSTALL MAINTENANCE AND PROTECTION OF TRAFFIC MEASURES. 3. INSTALL A SANDBAG COFFERDAM AT THE UPSTREAM END TO SUPPORT BY-PASS
- 4. INSTALL A RIPRAP APRON AT THE DOWNSTREAM END TO SUPPORT BY-PASS
- PUMPING. 5. INSTALL A TRENCH ACROSS THE ROAD TO RUN BY-PASS PUMPING PIPE AND BACKFILL OVERTOP OF THE PIPE WITH CRUSHED STONE TO MATCH THE GRADES OF THE EXISTING DRIVING SURFACE.
- 6. EXCAVATE THE DOWNSTREAM PORTION OF THE ROADWAY (FIRST HALF OF ROAD). 7. PREPARE SUBGRADE AND SUBBASE AND INSTALL HALF OF THE NEW CULVERT INLINE WITH THE EXISTING CULVERT. MATCH THE DOWNSTREAM INVERT TO THE TO THAT OF THE PREVIOUS DOWNSTREAM INVERT OF THE CULVERT REPLACED.
- (REMOVE A MINIMUM 100' OF PAVEMENT IN EACH DIRECTION FROM THE CULVERT) 8. INSTALL THE HEADWALL SECTION AND RIPRAP SECTION ALONG THE DOWNSTREAM
- SIDE (IF REQUIRED) 9. BACKFILL AND COMPACT IN LIFTS AROUND THE HALF SECTION OF NEWLY INSTALLED CULVERT AND INSTALL A COMPACTED CRUSHED STONE DRIVING
- SURFACE OVER TOP OF THE BACKFILLED AREA. 10. ADJUST MAINTENANCE AND PROTECTION OF TRAFFIC MEASURES AS NECESSARY TO
- INSTALL THE SECOND HALF OF THE CULVERT. 11. EXCAVATE THE UPSTREAM PORTION OF ROADWAY (SECOND HALF OF ROAD)
- 12. PREPARE SUBGRADE AND SUBBASE AND INSTALL HALF OF THE CULVERT INLINE WITH THE NEWLY INSTALLED DOWNSTREAM PORTION OF CULVERT. MATCH THE UPSTREAM INVERT TO THE TO THAT OF THE PREVIOUS UPSTREAM INVERT OF THE CULVERT REPLACED. (REMOVE A MINIMUM 100' OF PAVEMENT IN EACH DIRECTION FROM THE CULVERT)
- 13. INSTALL THE HEADWALL SECTION AND RIPRAP SECTION ALONG THE UPSTREAM SIDE (IF REQUIRED)
- 14. ALLOW FLOW THROUGH THE NEWLY INSTALLED CULVERT BY REMOVING THE
- SANDBAG COFFERDAM. 15. BACKFILL AND COMPACT IN LIFTS THE EXCAVATED AREAS AROUND THE NEW
- CULVERT SECTION AND INSTALL A CRUSHED STONE DRIVING SURFACE. 16. ROUGH GRADE THE EMBANKMENT BACKFILL AND COMPACT IN LIFTS.
- 17. FINE GRADE THE ROADWAY SUBBASE AND BASE COURSES TO MACH THE EXISTING
- 18. INSTALL THE PORTION OF ROADWAY SECTION ABOVE THE INSTALLED CULVERT TO MATCH EX. GRADE.
- 19. TOPSOIL SEED AND MULCH THE GRADED EMBANKMENT AREA.
- 20. REMOVE ALL TEMPORARY EROSION AND SEDIMENT CONTROL MEASURES AT THE SUBSTANTIAL COMPLETION OF THE CULVERT REPLACEMENT

BY-PASS PUMPING NOTE:

1. CONTRACTOR SHALL PROVIDE 24—HOUR BY—PASS PUMPING OF THE STREAM DURING THE REMOVAL OF EXISTING CULVERT THROUGH THE INSTALLATION OF

TYPICAL CULVERT REPLACEMENT SEQUENCING

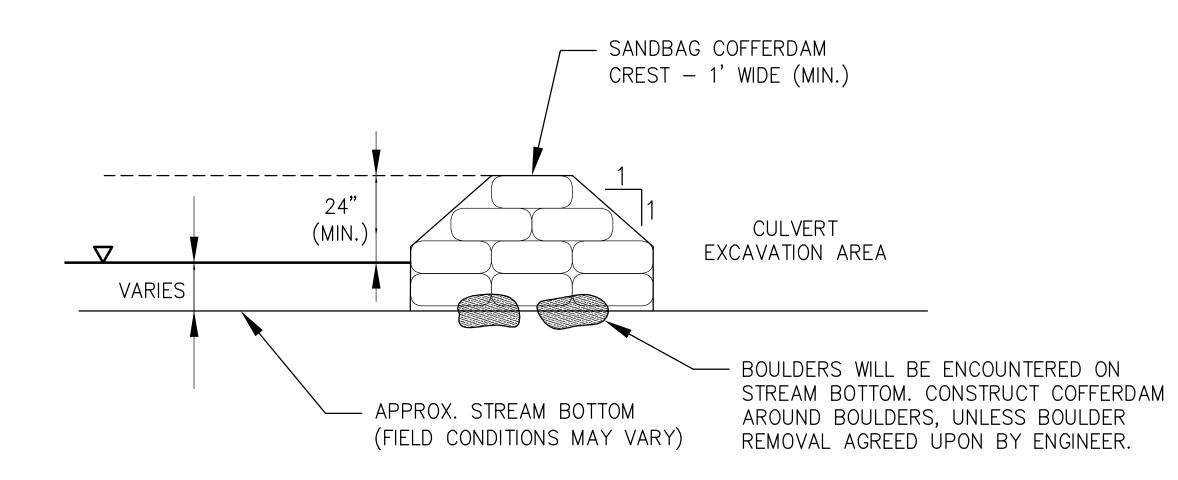

NOTE:

1. SAND BAGS SHALL BE FILTER FABRIC TYPE AND BE DOUBLE BAGGED.

2. PORTADAM, BY PORTADAM, INC. SHALL BE CONSIDERED ACCEPTABLE SUBSTITUTE TO SAND BAGS.

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SANDBAG COFFERDAM DETAIL

SCALE: N.T.S







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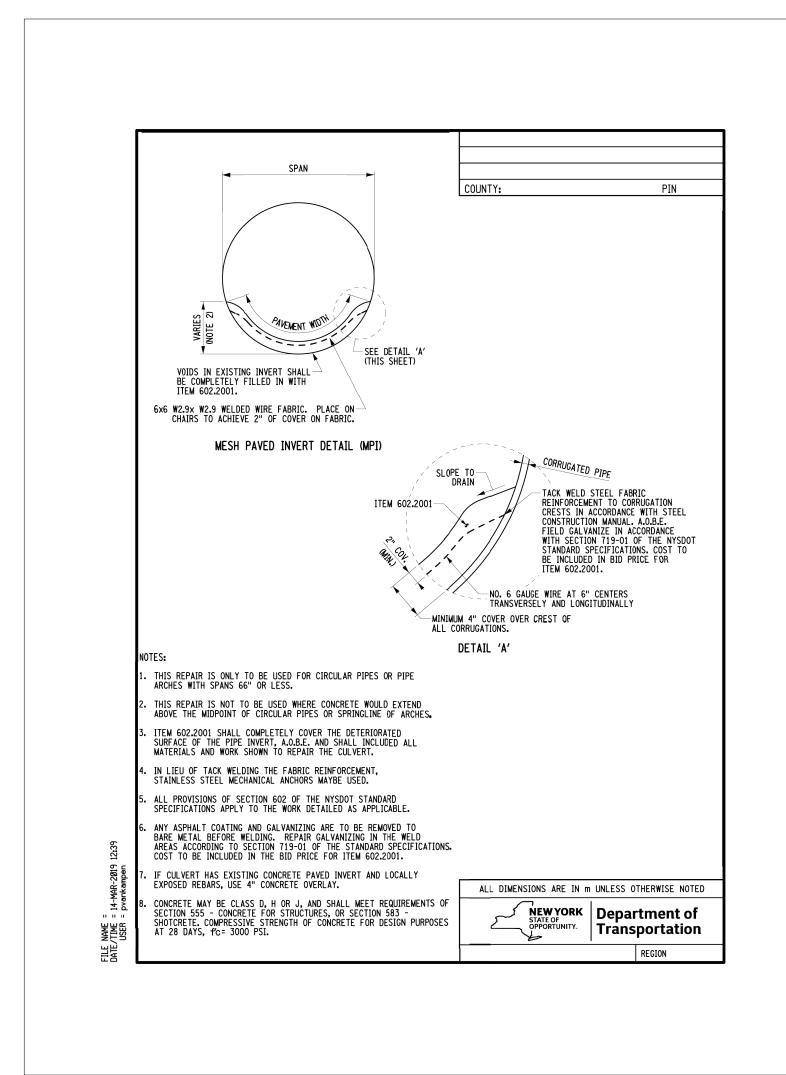
					SEGMENT 2 - ROUTE 22: DRESDEN - WH TYPICAL CULVERT REPLACMENT SEQUE DETAILS
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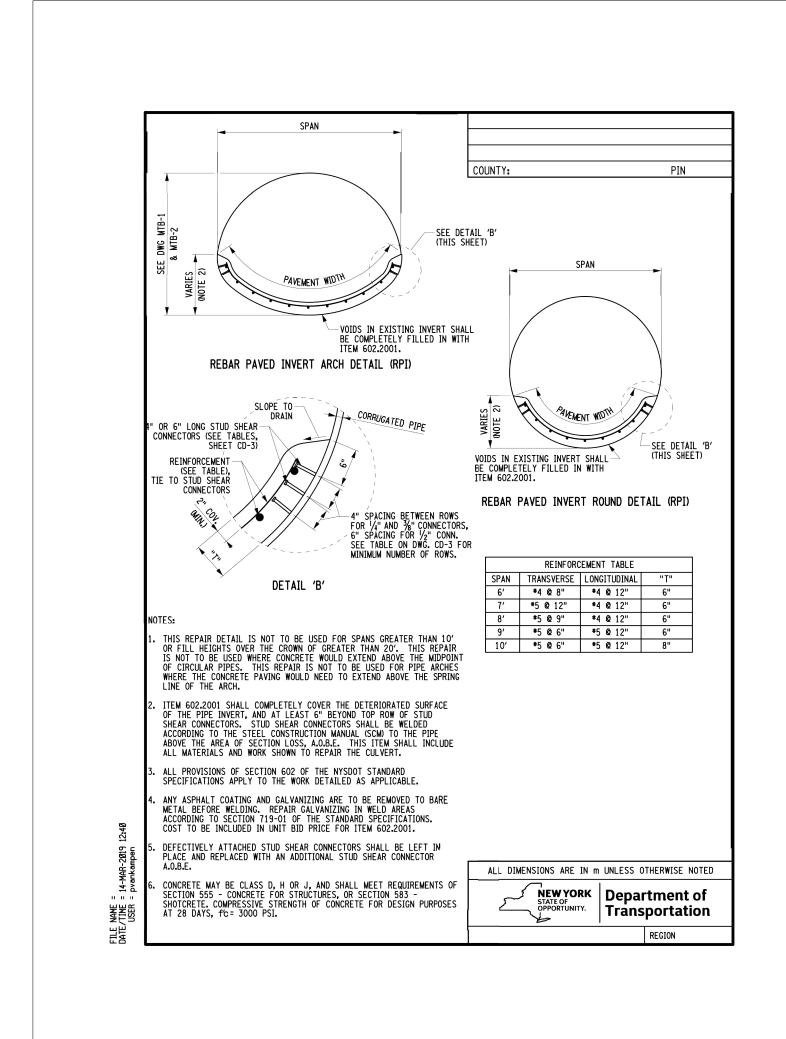
CHAMPLAIN HUDSON POWER EXPRESS **SEGMENT 2 - ROUTE 22: DRESDEN - WHITEHALL** TYPICAL CULVERT REPLACMENT SEQUENCING **DETAILS**


KIEWIT PROJECT NO. CHA PROJECT NO. DRAWING NO.

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AS NOTED DATE XXX OF XXX





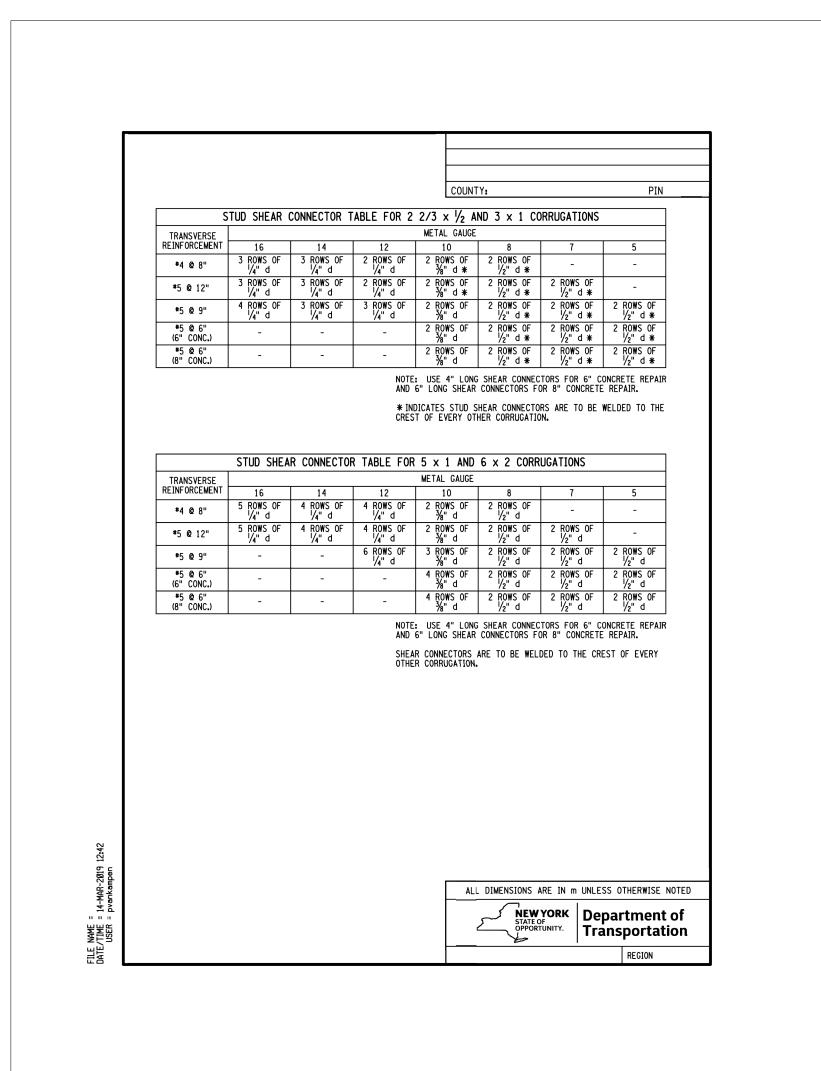


RELINING OF EXISTING ROADWAY CULVERTS SHALL BE IN ACCORDANCE WITH NYSDOT STANDARD SPECIFICATIONS - SECTION 706-09 CURED IN PLACE PIPE (CIPP) LINER

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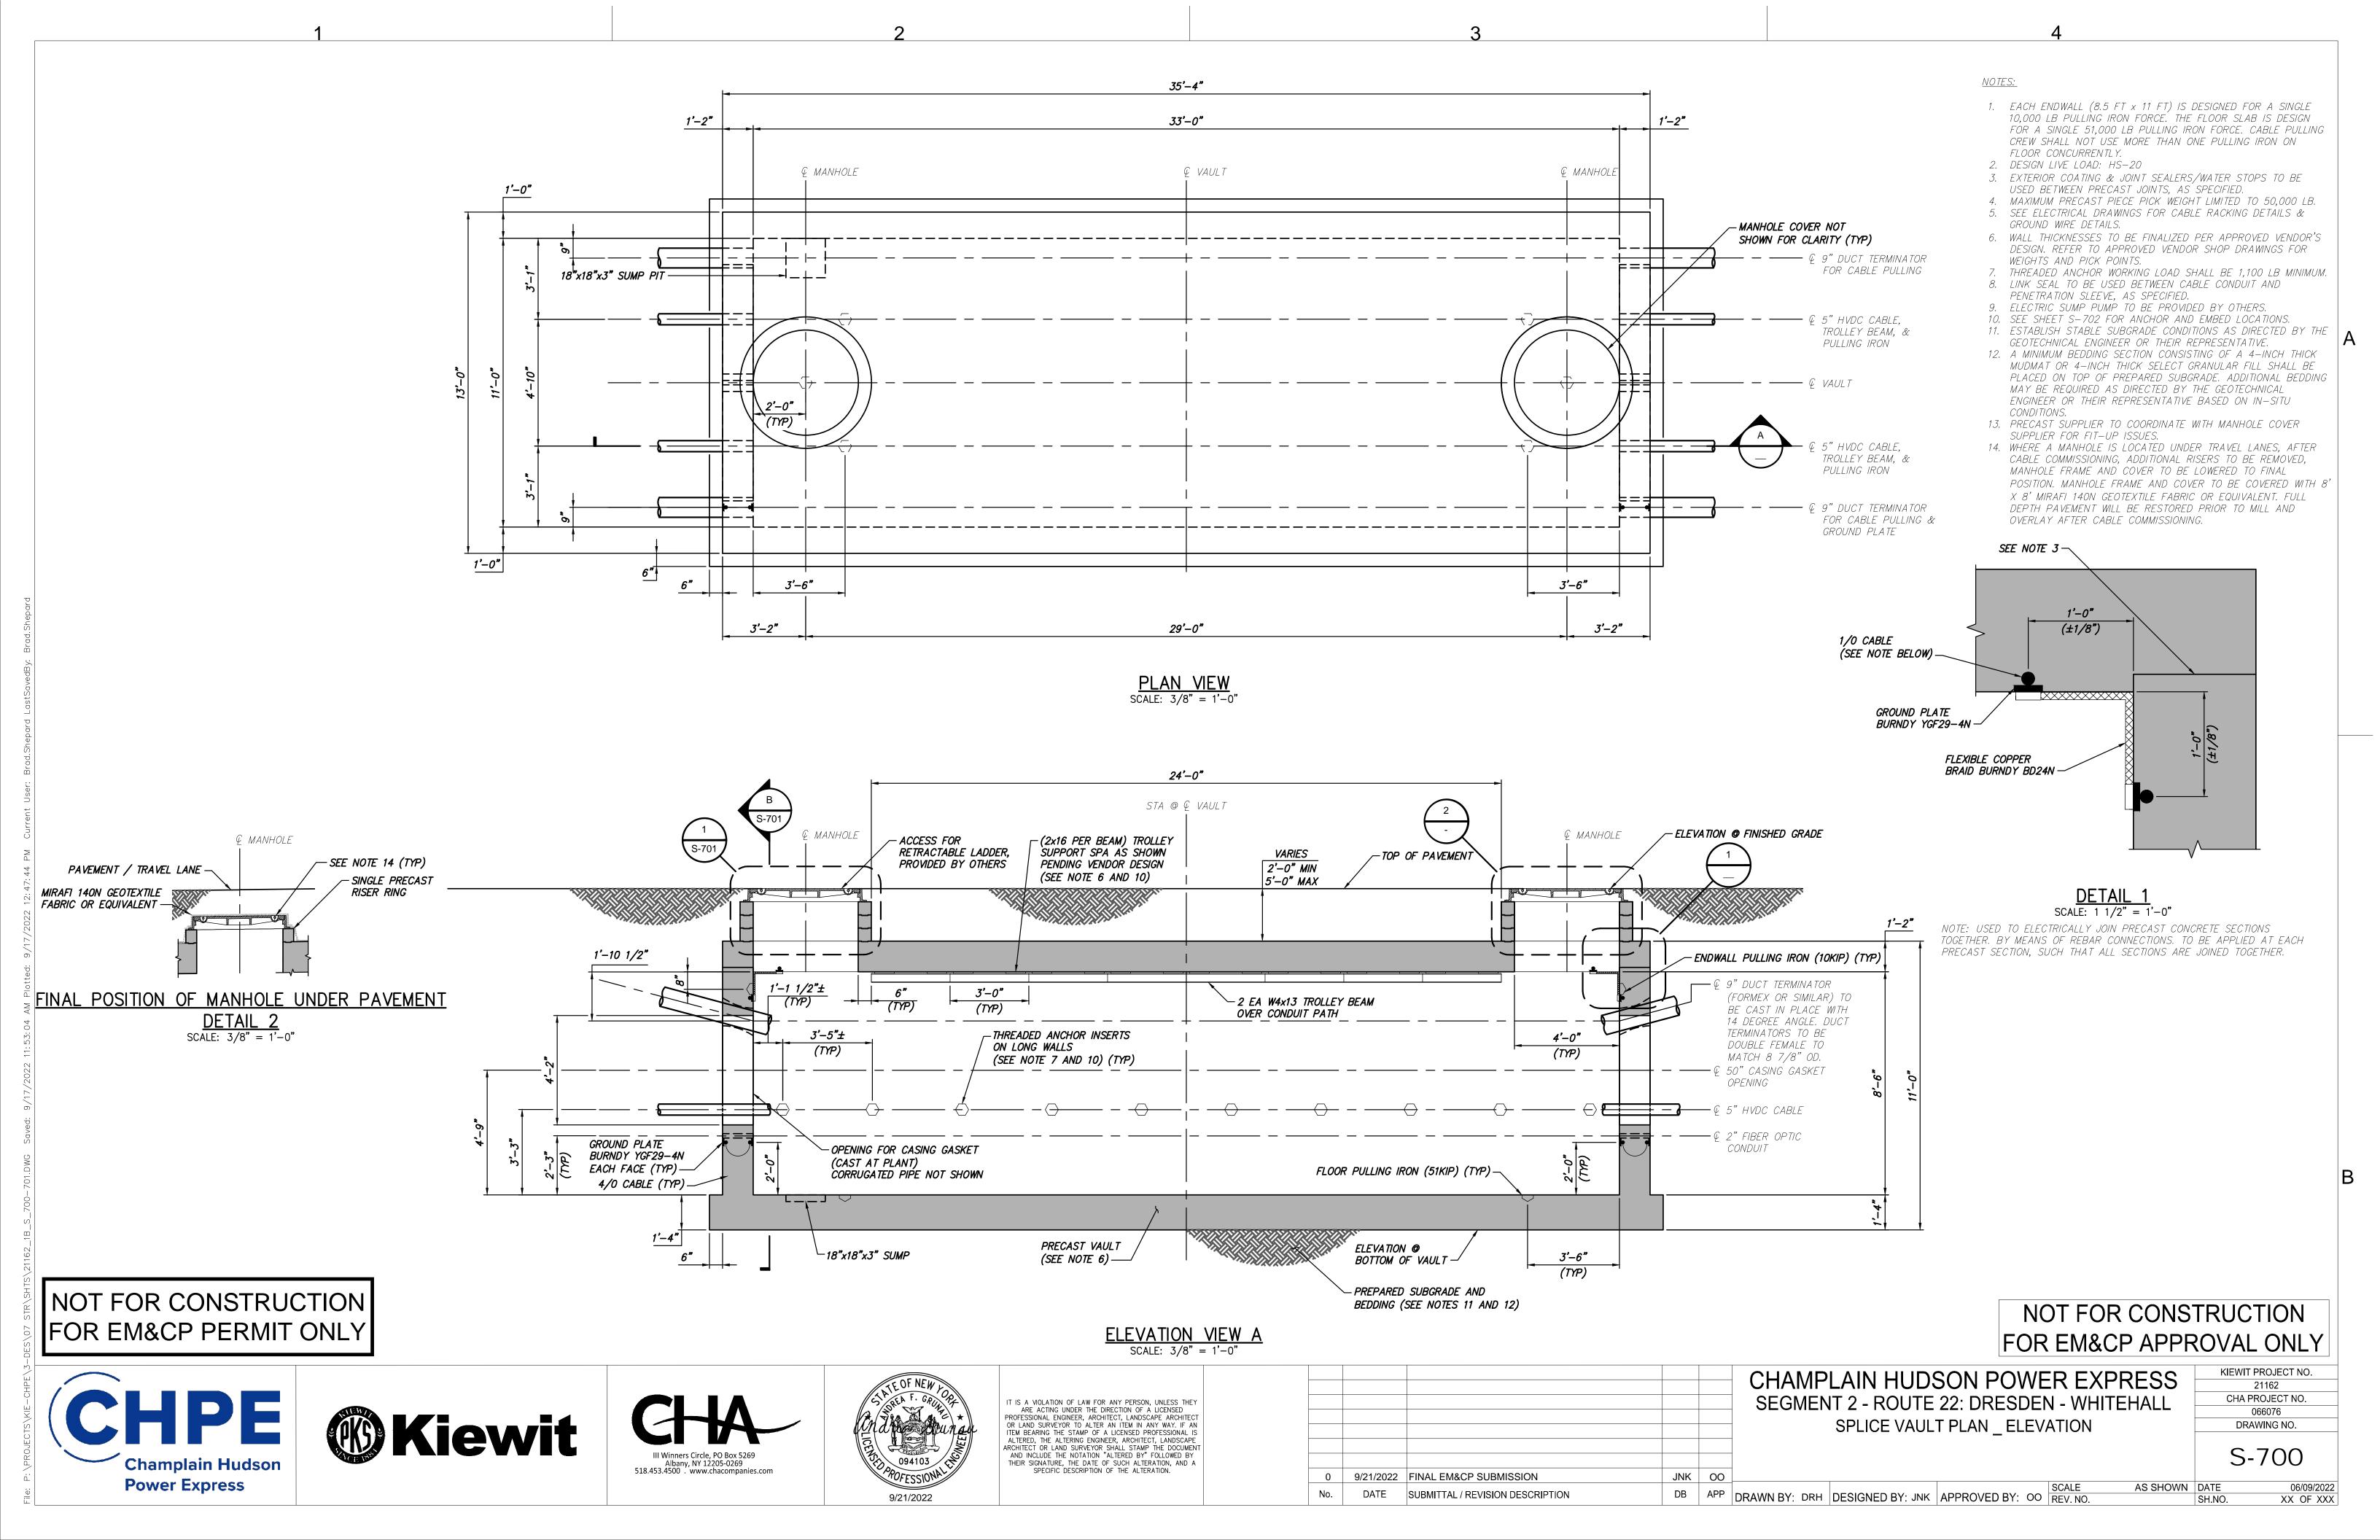
NYSDOT CULVERT REPAIR DETAILS


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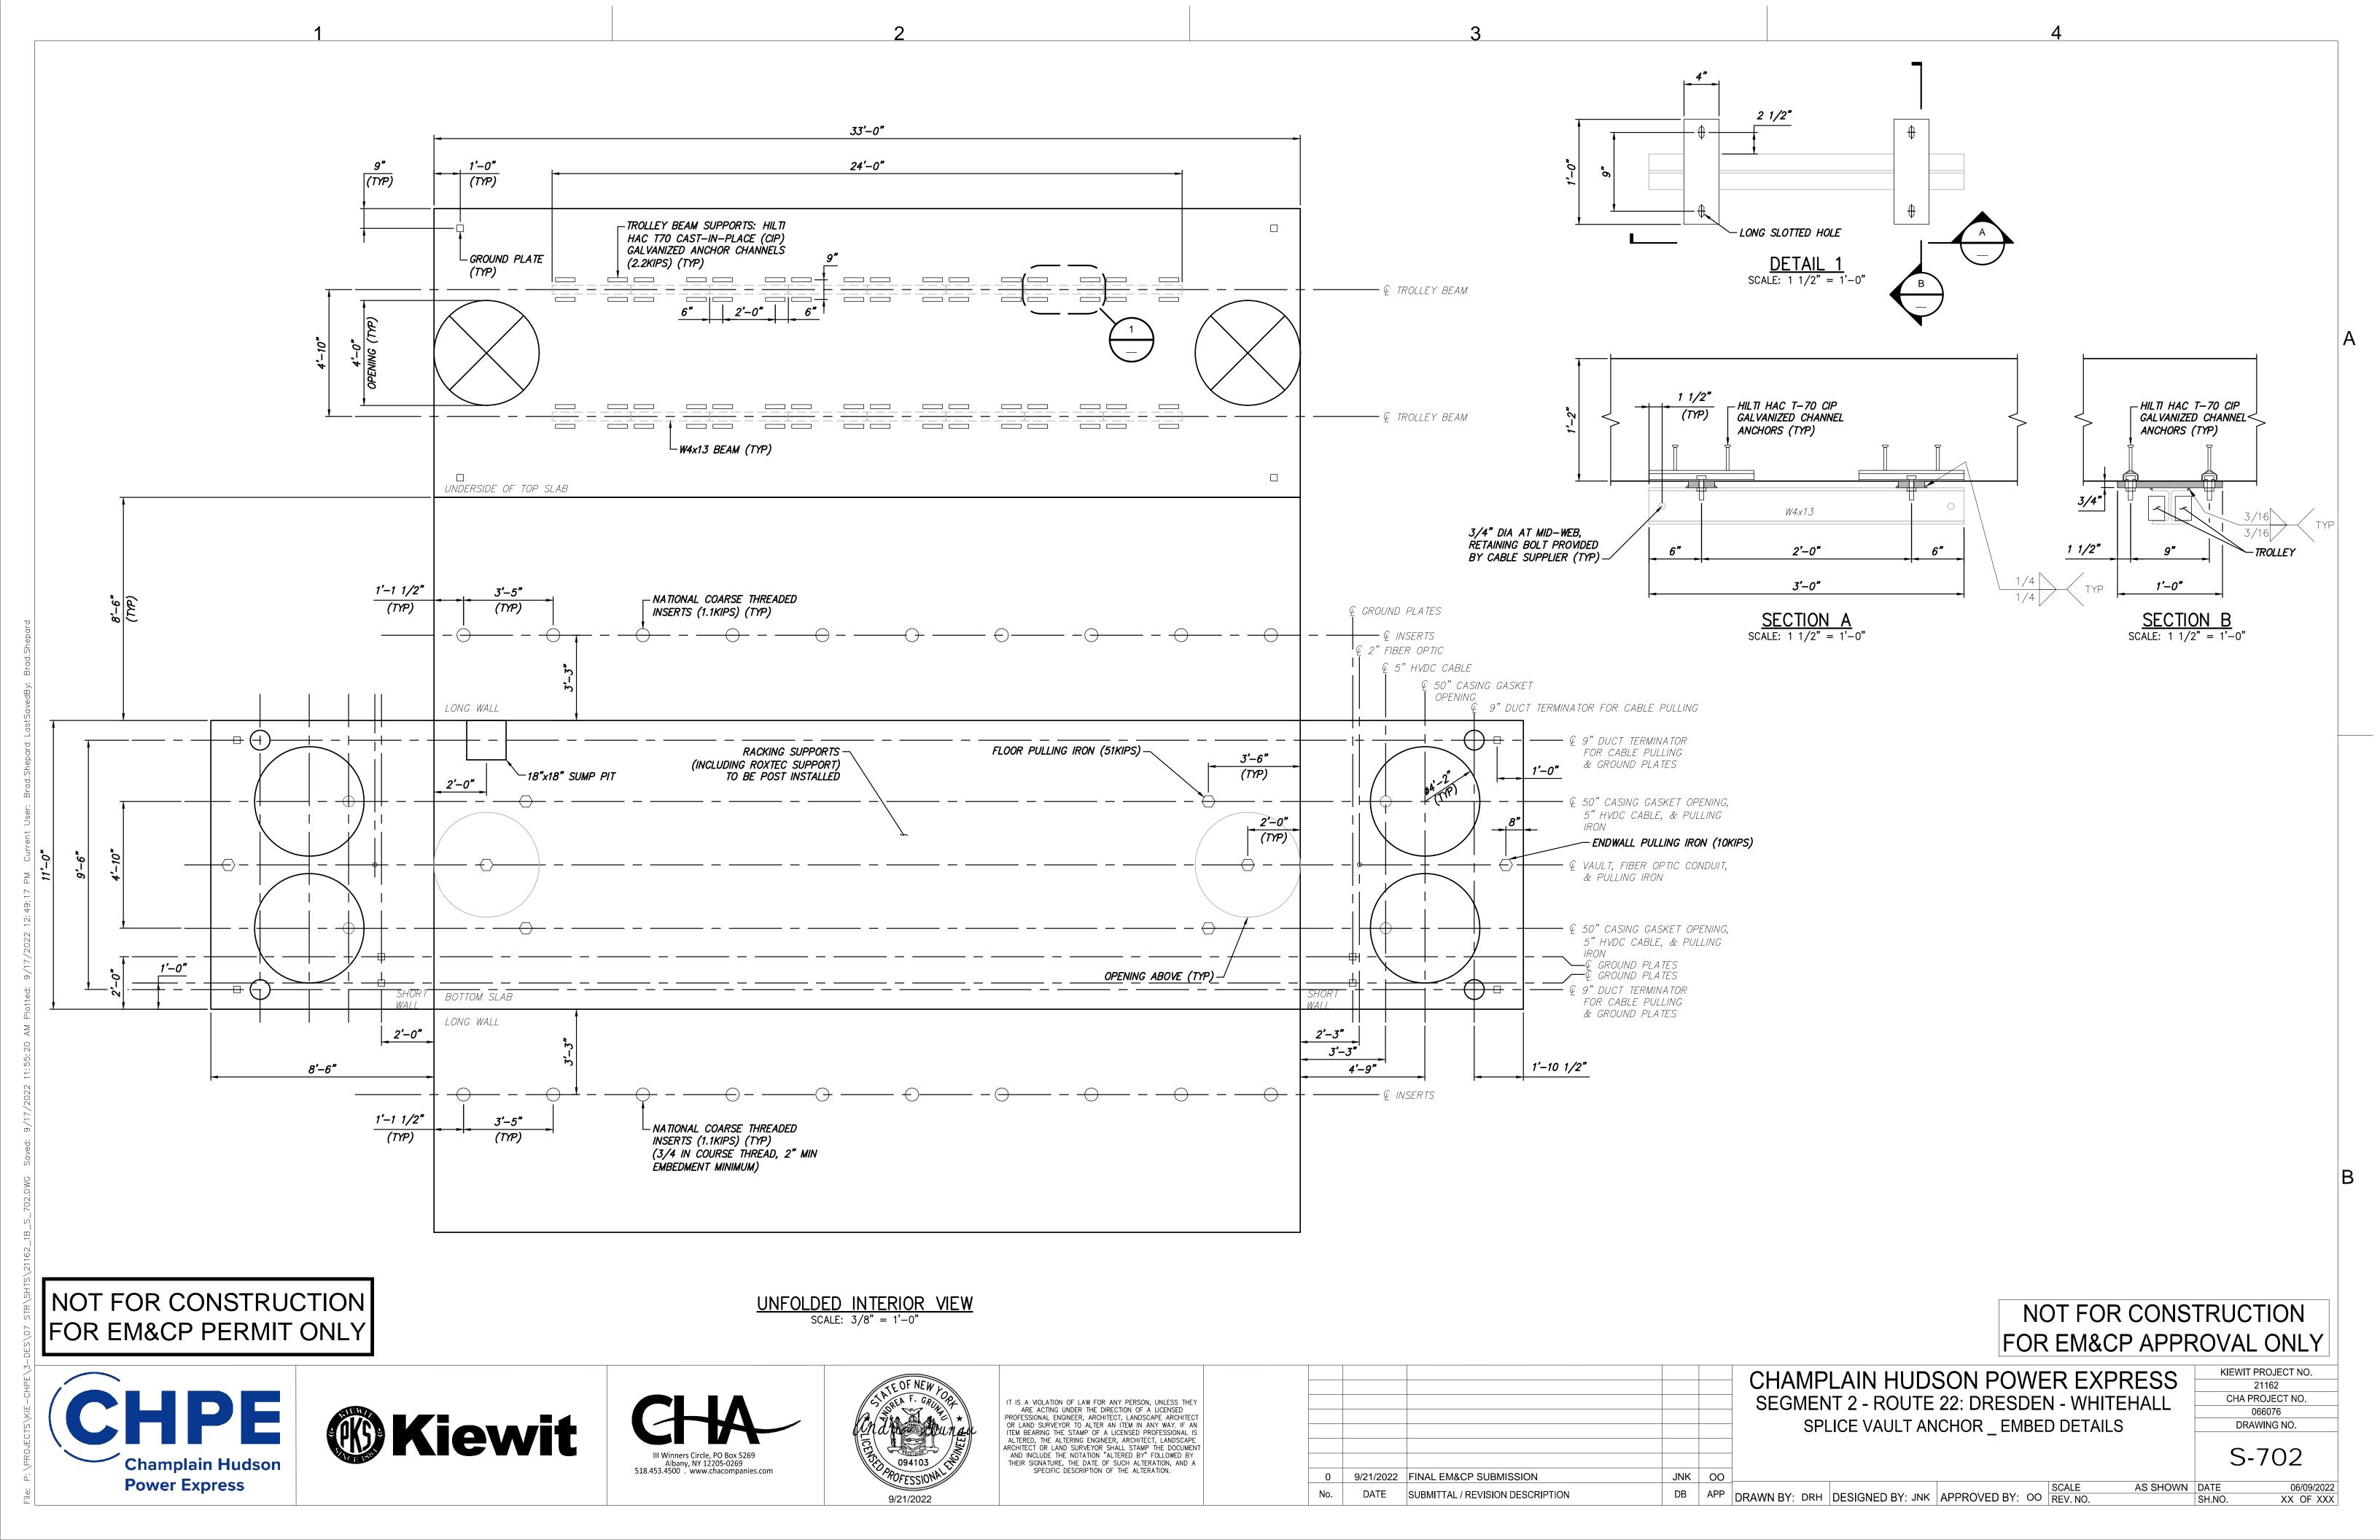
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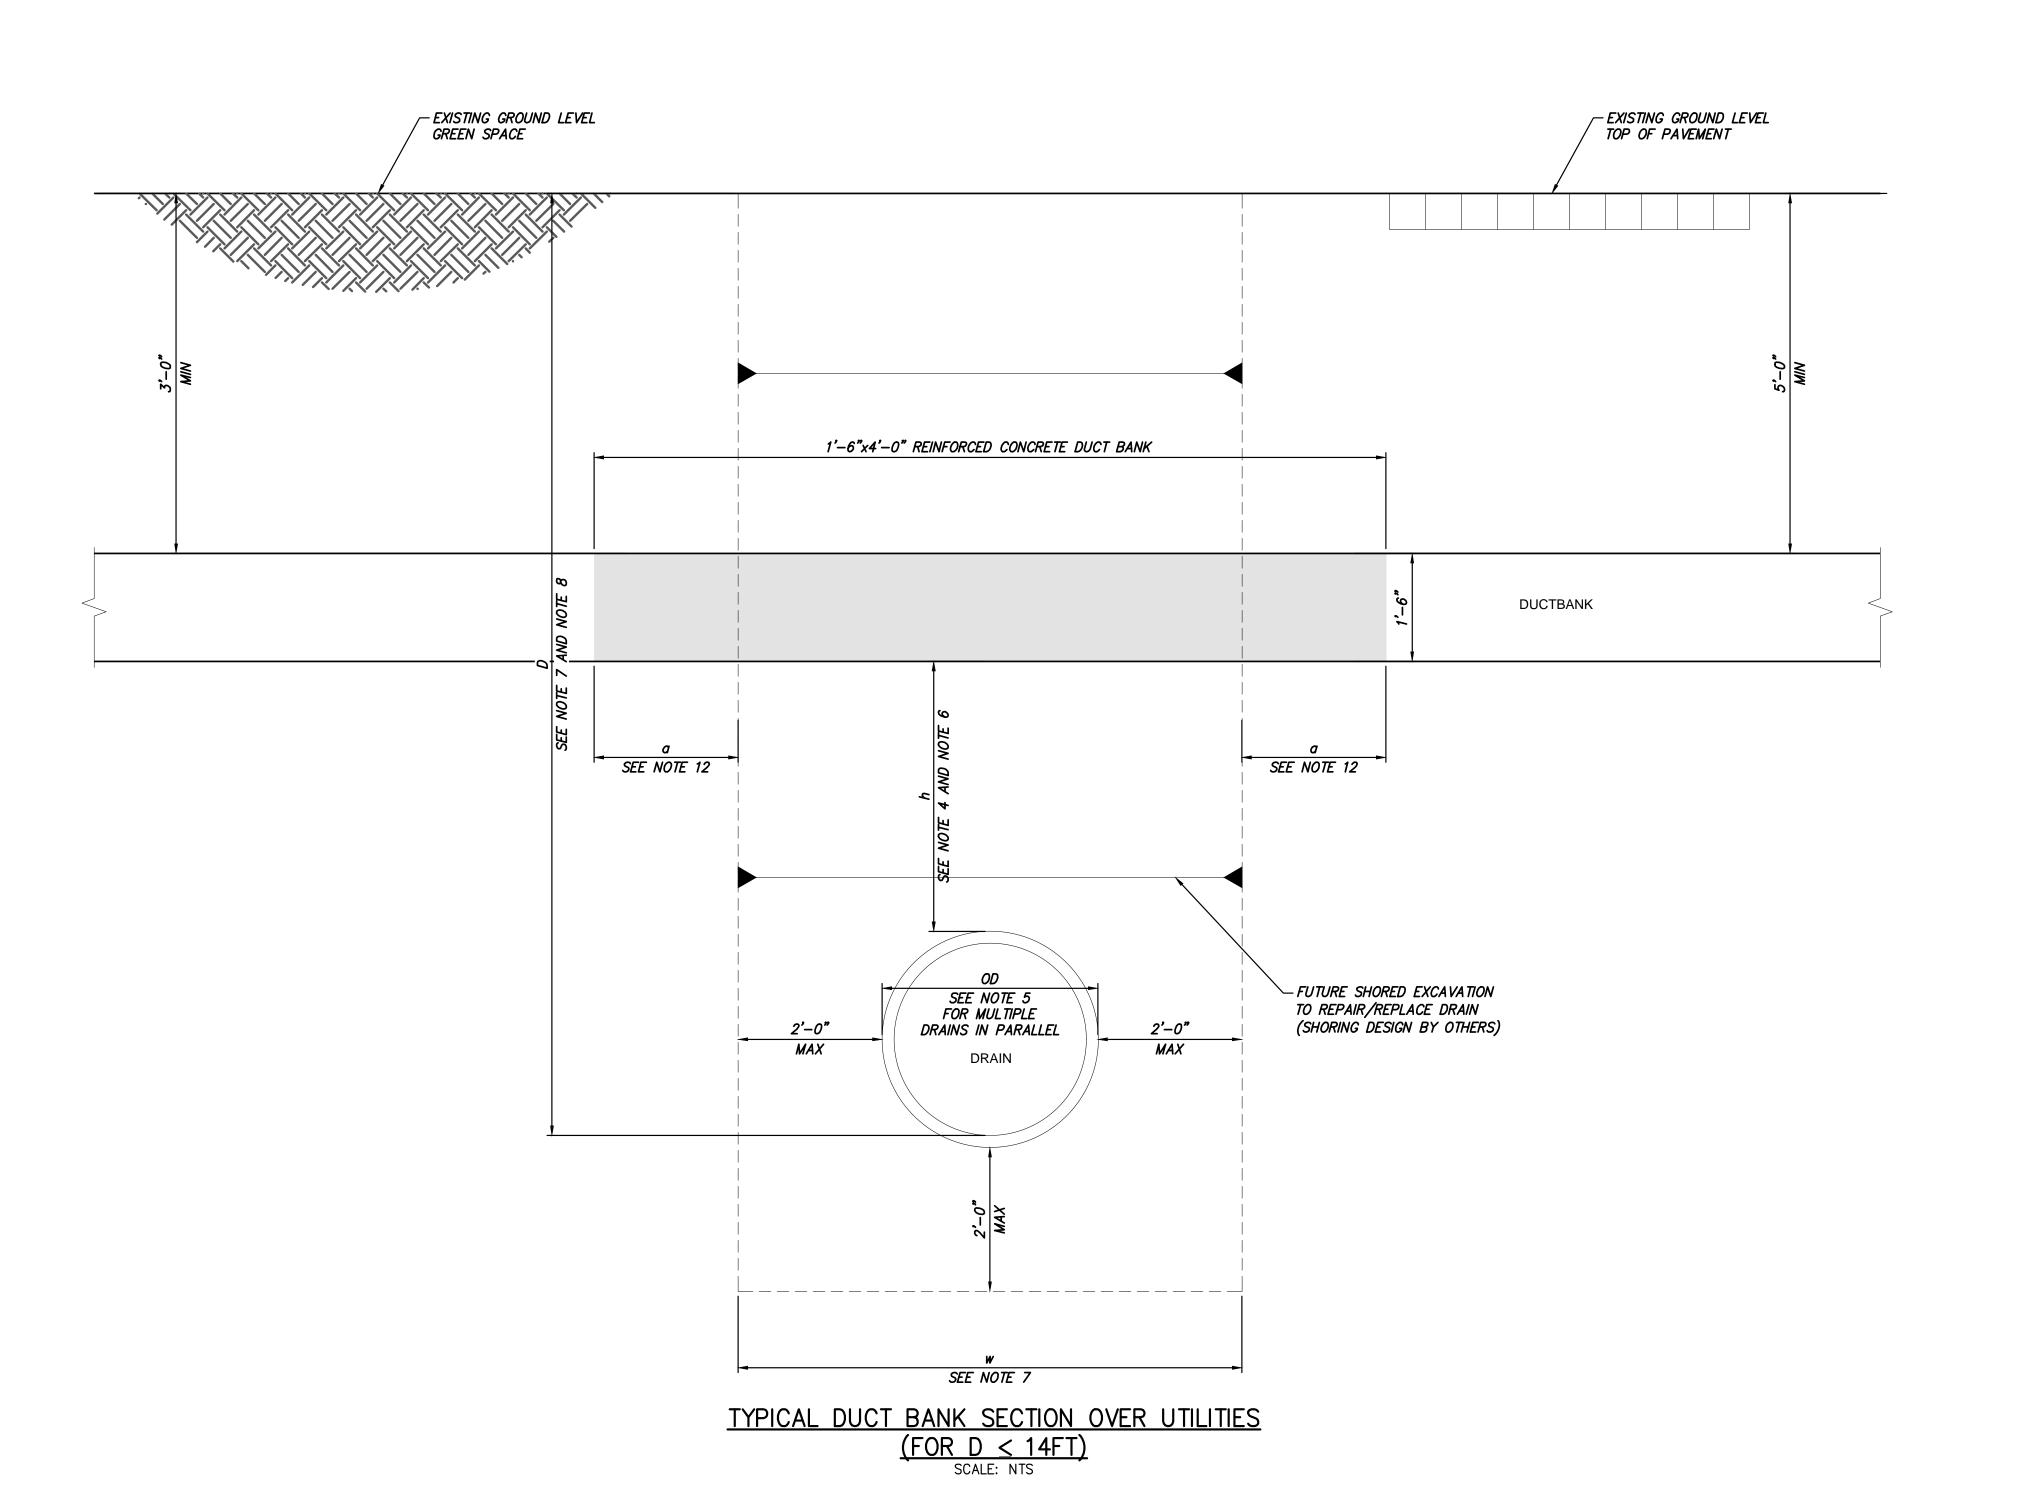
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CHAMPLAIN HUDSON POWER EXPRESS **SEGMENT 2 - ROUTE 22: DRESDEN - WHITEHALL**





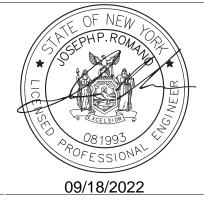

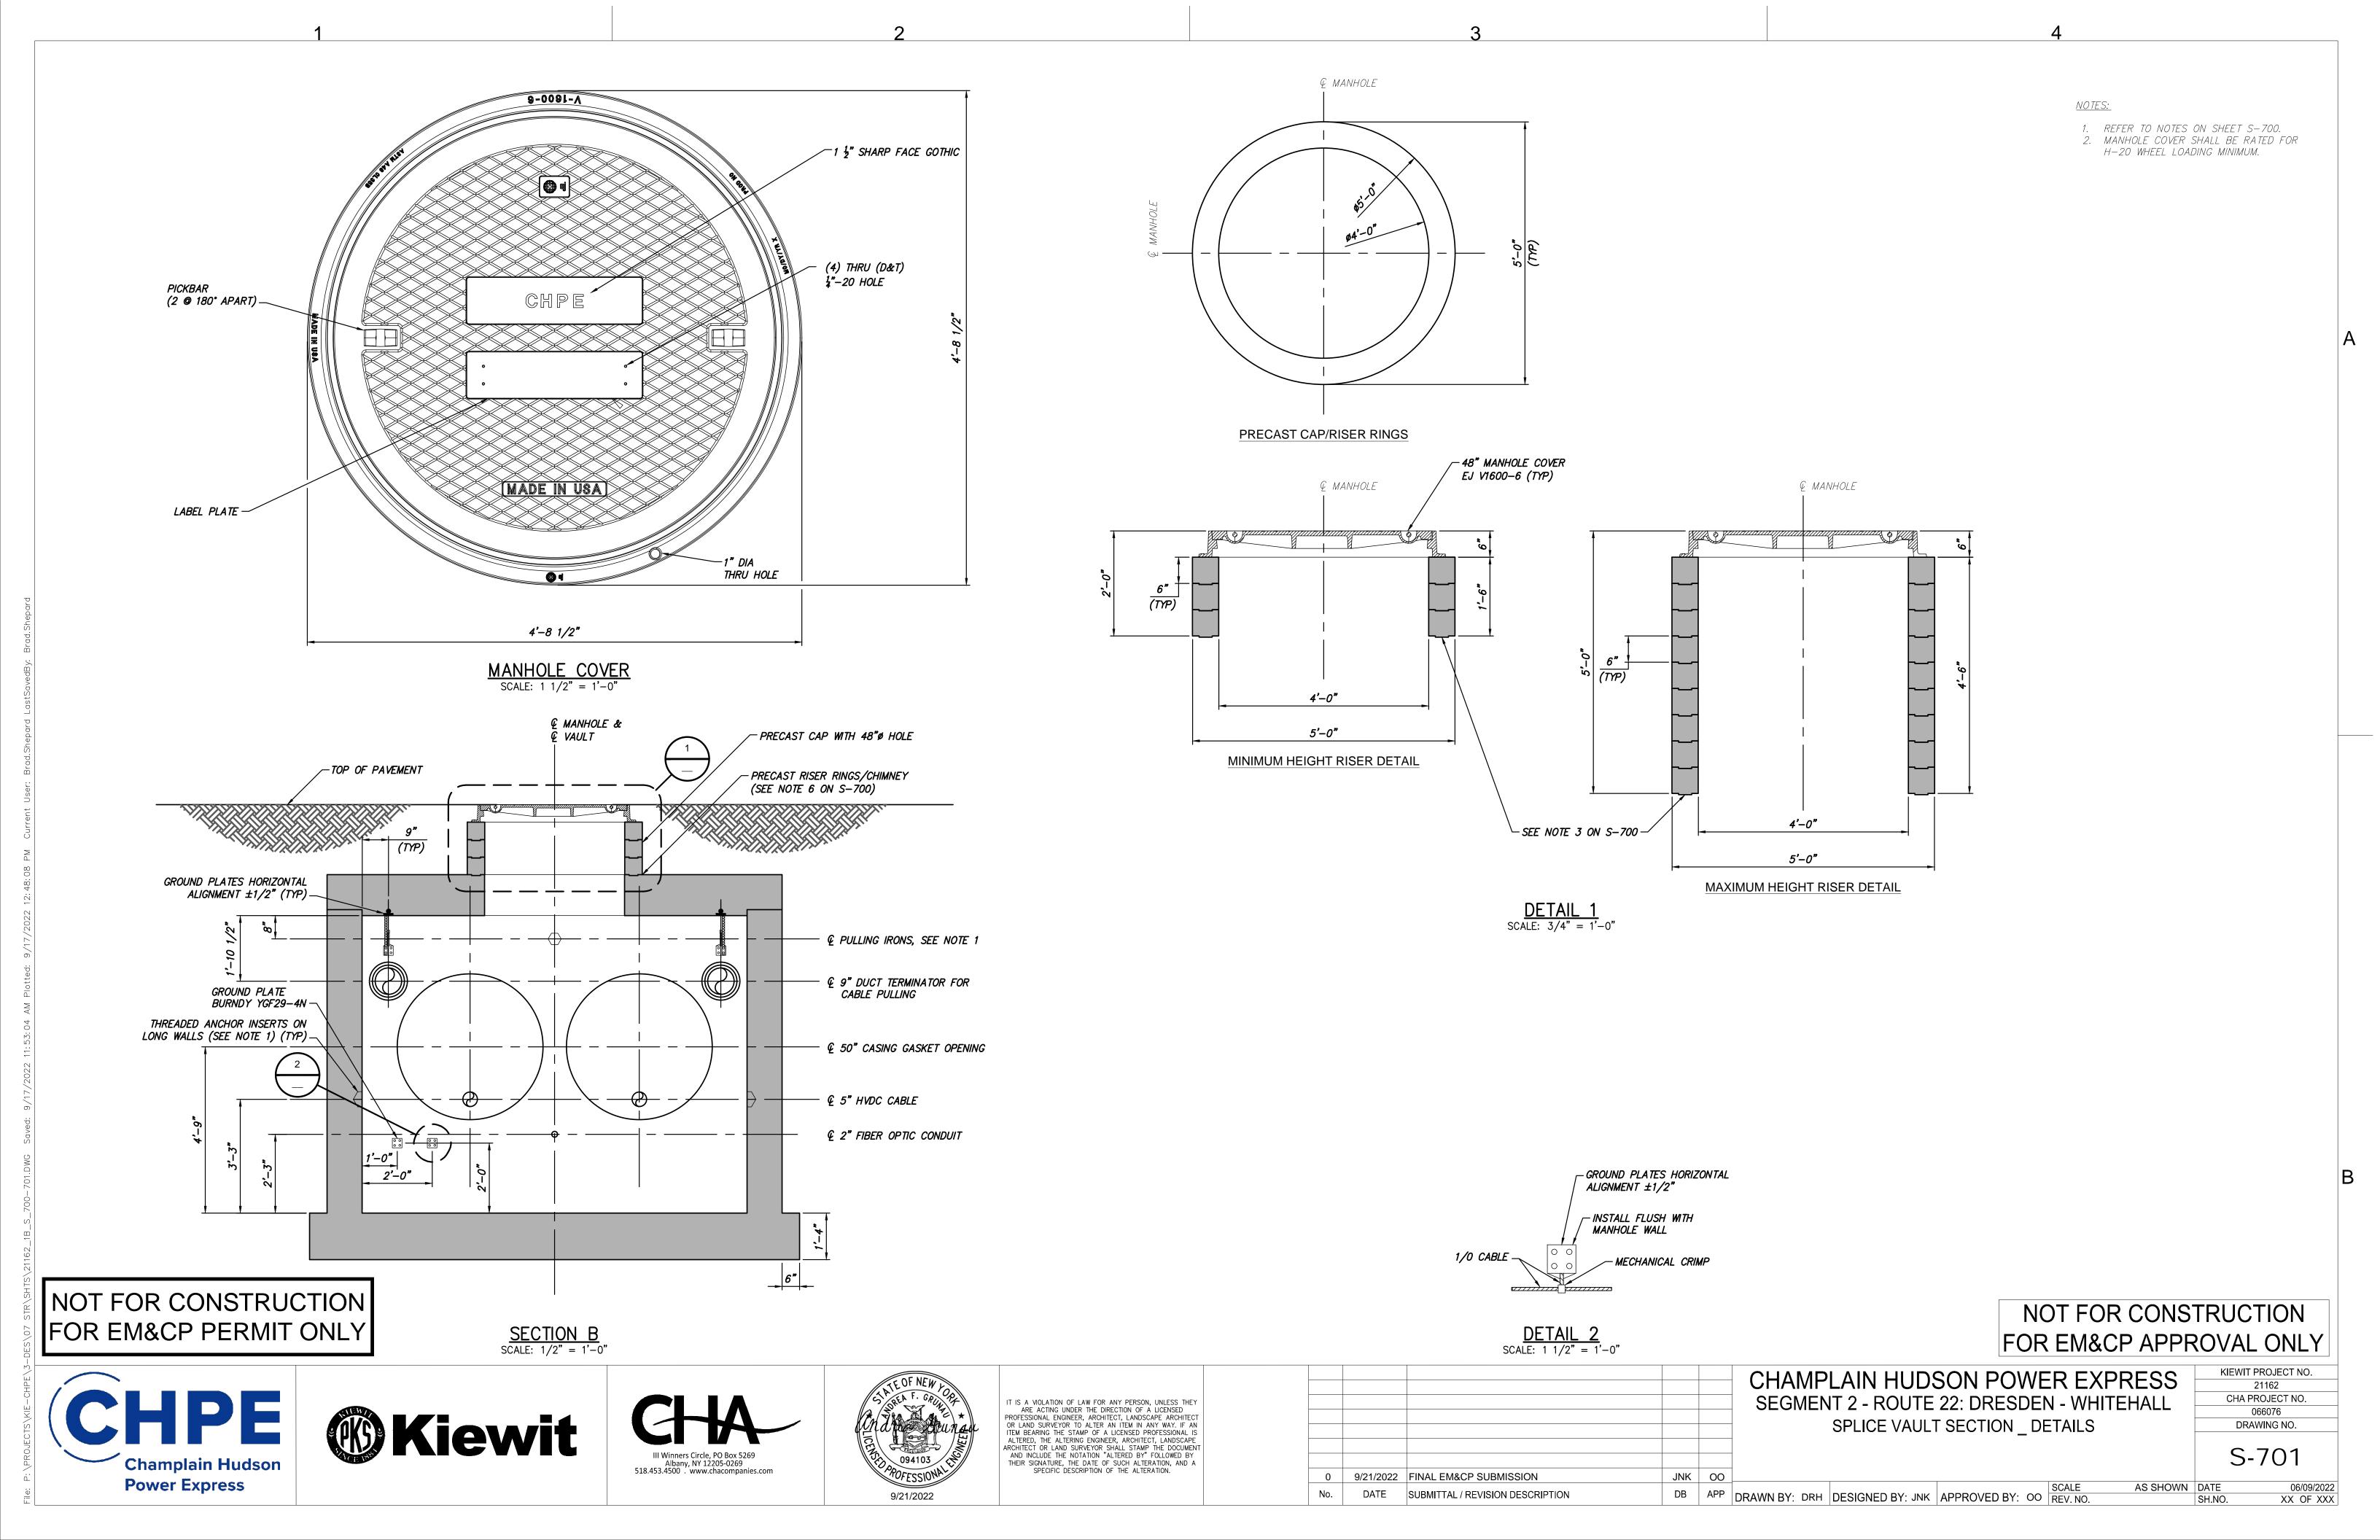

NOTES:

- 1. TYPICAL SECTION AND FOLLOWING NOTES PROVIDED PROPOSED DESIGN CRITERIA TO BE APPLIED FOR DRAINS LOCATED BELOW THE DUCT BANK WITHIN THE NYSDOT RIGHT OF WAY, PENDING APPROVAL.
- 2. EXCAVATION FOR / CONSTRUCTION OF FUTURE DRAIN REPAIRS/REPLACEMENTS,
- AND RELATED SHORING CALCULATIONS BY OTHERS. 3. D = DISTANCE FROM EXISTING GROUND LEVEL TO DRAIN INVERT.
- 4. h = DISTANCE FROM BOTTOM OF TRENCH PROTECTIVE CONCRETE/BOTTOM OF BRIDGING SUPPORT, TO TOP OF EXISTING DRAINAGE PIPE.
- 5. FOR SINGLE PIPE, OD = OUTSIDE DIAMETER OF PIPE; FOR MULTIPLE PIPES IN PARALLEL, OD = DISTANCE BETWEEN OUTSIDE EDGES OF EXTERIOR PIPES.
- 6. h IS ASSUMED TO BE 2FT MINIMUM.
- 7. FOR D<14FT, ALL FUTURE EXCAVATIONS TO REPAIR/REPLACE EXISTING DRAINAGE PIPES WILL BE SHORED EXCAVATION, WITH MAXIMUM EXCAVATION WIDTH OF w=2FT+OD+2FT (DESIGN/CONSTRUCTION BY OTHERS).
- 8. FOR D>14FT, TRENCH-LESS METHOD WILL BE USED TO REPAIR/REPLACE EXISTING DRAINAGE PIPES (DESIGN/CONSTRUCTION BY OTHERS).
- 9. BRIDGING SUPPORT IS PROVIDED OVER LENGTH "w+2a".
- 10. BRIDGING SUPPORT IS NOT PROVIDED WHEN D>14FT.
- 11. BRIDGING SUPPORT IS DESIGNED TO CARRY DUCT BANK WEIGHT, ONLY. SOIL ABOVE THE DUCT BANK IS REMOVED BEFORE EXCAVATING UNDER THE DUCT BANK.
- 12. "a" DIMENSION IS 2'-0" MINIMUM.

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CHAMPLAIN HUDSON POWER EXPRESS SEGMENT 2 - ROUTE 22: DRESDEN - WHITEHALL SELF-SUPPORTING STRUCTURE OVER UTILITIES

KIEWIT PROJECT NO. 21162 CHA PROJECT NO. 066076 DRAWING NO.

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AS SHOWN DATE XX OF XXX