


NORTH ABUTMENT ELEVATION SCALE: 1/4" = 1'-0"

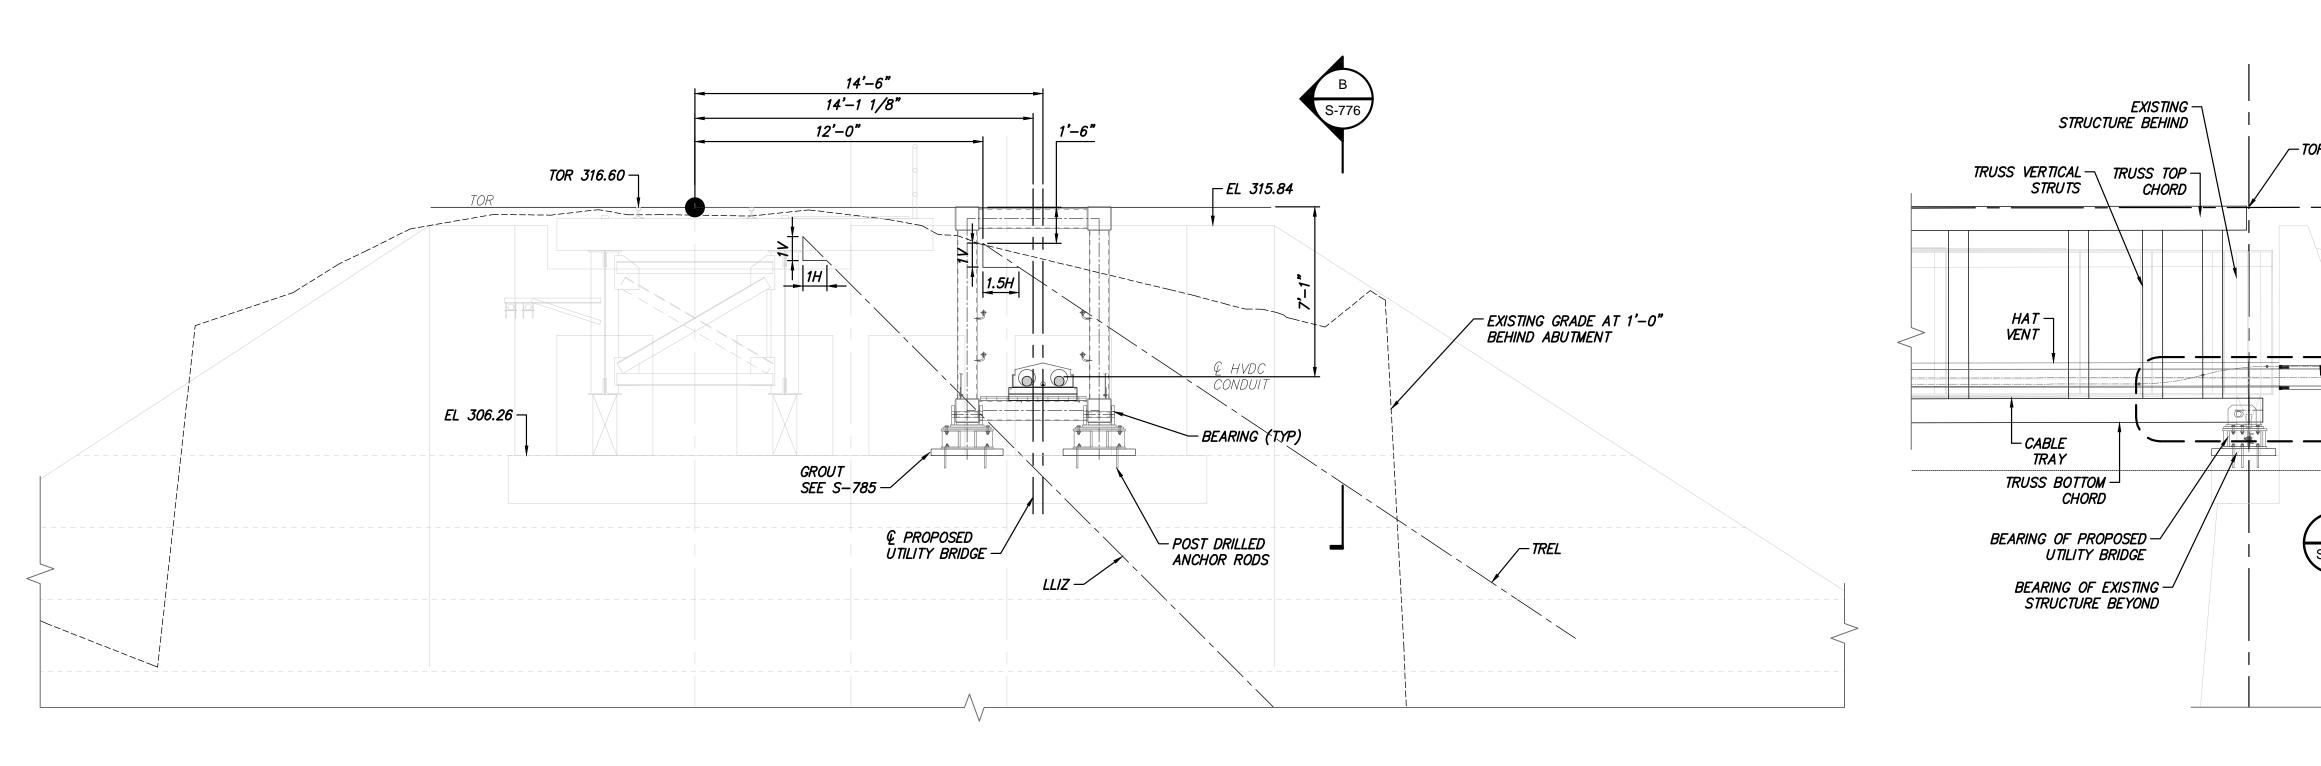

SOUTH ABUTMENT ELEVATION SCALE: 1/4" = 1'-0"









SECTION A SCALE: 1/4" = 1'-0'

SCALE: 1/4" = 1'-0"

	IT IS A VIOLATION OF LAW FOR ANY PERSON, UNLESS THEY ARE ACTING UNDER THE DIRECTION OF A LICENSED PROFESSIONAL ENGINEER, ARCHITECT, LANDSCAPE ARCHITECT OR LAND SURVEYOR TO ALTER AN ITEM IN ANY WAY. IF AN ITEM BEARING THE STAMP OF A LICENSED PROFESSIONAL IS ALTERED, THE ALTERING ENGINEER, ARCHITECT, LANDSCAPE ARCHITECT OR LAND SURVEYOR SHALL STAMP THE DOCUMENT AND INCLUDE THE NOTATION "ALTERED BY" FOLLOWED BY THEIR SIGNATURE, THE DATE OF SUCH ALTERATION, AND A SPECIFIC DESCRIPTION OF THE ALTERATION.		12/16/2022	FINAL SUBMISSION	JNK JNK JNK	00 00 00	-
Do in in		A	11/11/2022	DRAFT FINAL SUBMISSION	JNK	00	
POFESSIONAL		No.	DATE	SUBMITTAL / REVISION DESCRIPTION	DB	400	DR



## BRIDGE NO. 8

### <u>NOTES:</u>

- 1. UTILITY TRUSS BRIDGE DESIGN PER AREMA. 2. WEIGHT OF CABLE TRAY + HAT VENT = 20.57 PLF
- WEIGHT OF CABLE + CONDUITS (2xDC+1xFO) = 47.53PLF WEIGHT OF CABLE TRAY WITH CABLES & CONDUITS =
- 68.1 PLF 3. ENVIRONMENTAL LOADS PER AREMA \$15 -1.3.8 : TRANSVERSE WIND = 50 PSF LONGITUDINAL WIND = 50% x 50 PSF = 25 PSF

ENVIRONMENTAL LOADS PER ASCE 7–16 §7: SNOW LOAD = 45 PSF

LIVE LOAD DURING CONSTRUCTION / INSPECTION = 60PSF

CABLE PULL LOADS TO BE CONSIDERED PENDING ALIGNMENT FINALIZATION.

4. CABLE TRAY ACCOMODATES EXPANSION/CONTRACTION OVER UNISTRUTS WITH HOLD DOWN CLAMP & EXPANSION GUIDE.

FOR SW FIBERGLASS CONDUITS (RTRC, REINFORCED THERMOSET RESIN CONDUIT), PROVIDE: - NO EXPANSION JOINT, FOR CONDUIT LENGTH LESS THAN 50FT,


- ONE EXPANSION JOINT MIDWAY, FOR CONDUIT LENGTH BETWEEN 50FT & 200FT. - ONE EXPANSION JOINT EVERY 200FT APART, FOR CONDUIT LENGTH OVER 200FT, ANCHORING BETWEEN 0—RINGS.

TEMPERATURE CHANGE OF 120°F ON 100FT LONG SW FIBERGLASS (RTRC) CONDUIT RESULTS IN  $\pm 1.8$ IN EXPANSION/CONTRACTION. O-RING EXPANSION JOINT PROVIDES ±6IN OF FREE TRAVEL IN EACH DIRECTION AT SET POSITION.


- 6. DRILL ABUTMENT BACKWALL WITH 2 x 12IN DIA + 1 x 4IN DIA CORE DRILLS, AT EACH ABUTMENT. USE RUBBER LINK SEAL (GARLOCK OR SIMILAR) BETWEEN THE RTRC CONDUIT & DRILLED SURFACE TO PROVIDE WATERTIGHNESS. LINK SEALS INSTALLED AT 1.5IN MIN RECESS. COVER LINK SEAL SURFACE WITH GROUT.
- 7. UTILITY TRUSS BRIDGE TO BE SUPPORTED ON EXISTING PIERS OVER NEW BEARINGS.
- 8. DIMENSIONS TO BE VERIFIED WITH FIELD SURVEY.
- 9. SEE SHEETS C-124 & C-125 FOR PLAN & PROFILE. 10. FOR DUCTBANK TO BRIDGE TRANSITION, SEE S-778. 11. SEE TEMPORARY WORKS DRAWINGS FOR SHORING
- CONSTRUCTION DETAILS.
- 12. TREL: THEORETICAL RAILROAD EMBANKMENT LINE (1.5H:1.0V STARTING AT 1'-6" BELOW AND 12'-0" AWAY FROM TOP OF RAIL CENTERLINE)
- 13. LLIZ: RAILROAD LIVE LOAD INFLUENCE ZONE (1.0H: 1.0V STARTING AT BOTTOM EDGE OF RAIL TIE)
- 14. FOR DUCTBANKS WITH LESS THAN 2'-6" COVER TO TOP OF DUCTBANK, EXCAVATE TRENCH AT MINIMUM 4'-0" (FROST DEPTH) FROM GROUND LEVEL, BACKFILL TRENCH BELOW DUCTBANK WITH NON-FROST-SUSCEPTIBLE FILL OR FLOWABLE FILL MATERIAL.
- 15. STRUCTURAL STEEL PLATES & SHAPES SHALL BE ASTM A709, GRADE 50W (A588) (FY=50KSI). 16. NO FIELD WELDING SHALL BE PERMITTED.
- 17. TRUSS MEMBER SIZES ARE AS FOLLOWING:

SPAN	CHORDS	STRUTS
30FT	HSS 12x12x3/8	HSS 10x10x3/8
50FT	HSS 12x12x3/8	HSS 10x10x3/8
60FT	HSS 12x12x5/8	HSS 10x10x5/8
90FT	HSS 12x12x5/8	HSS 10x10x5/8

CHAMPLAIN HUDSON POWER EXPRESS	KIEWIT PROJECT NO. 21162
	21102
BRIDGE NO. 8 - UTILITY TRUSS BRIDGE	DRAWING NO.
ABUTMENT ELEVATIONS AND SECTIONS	S-776

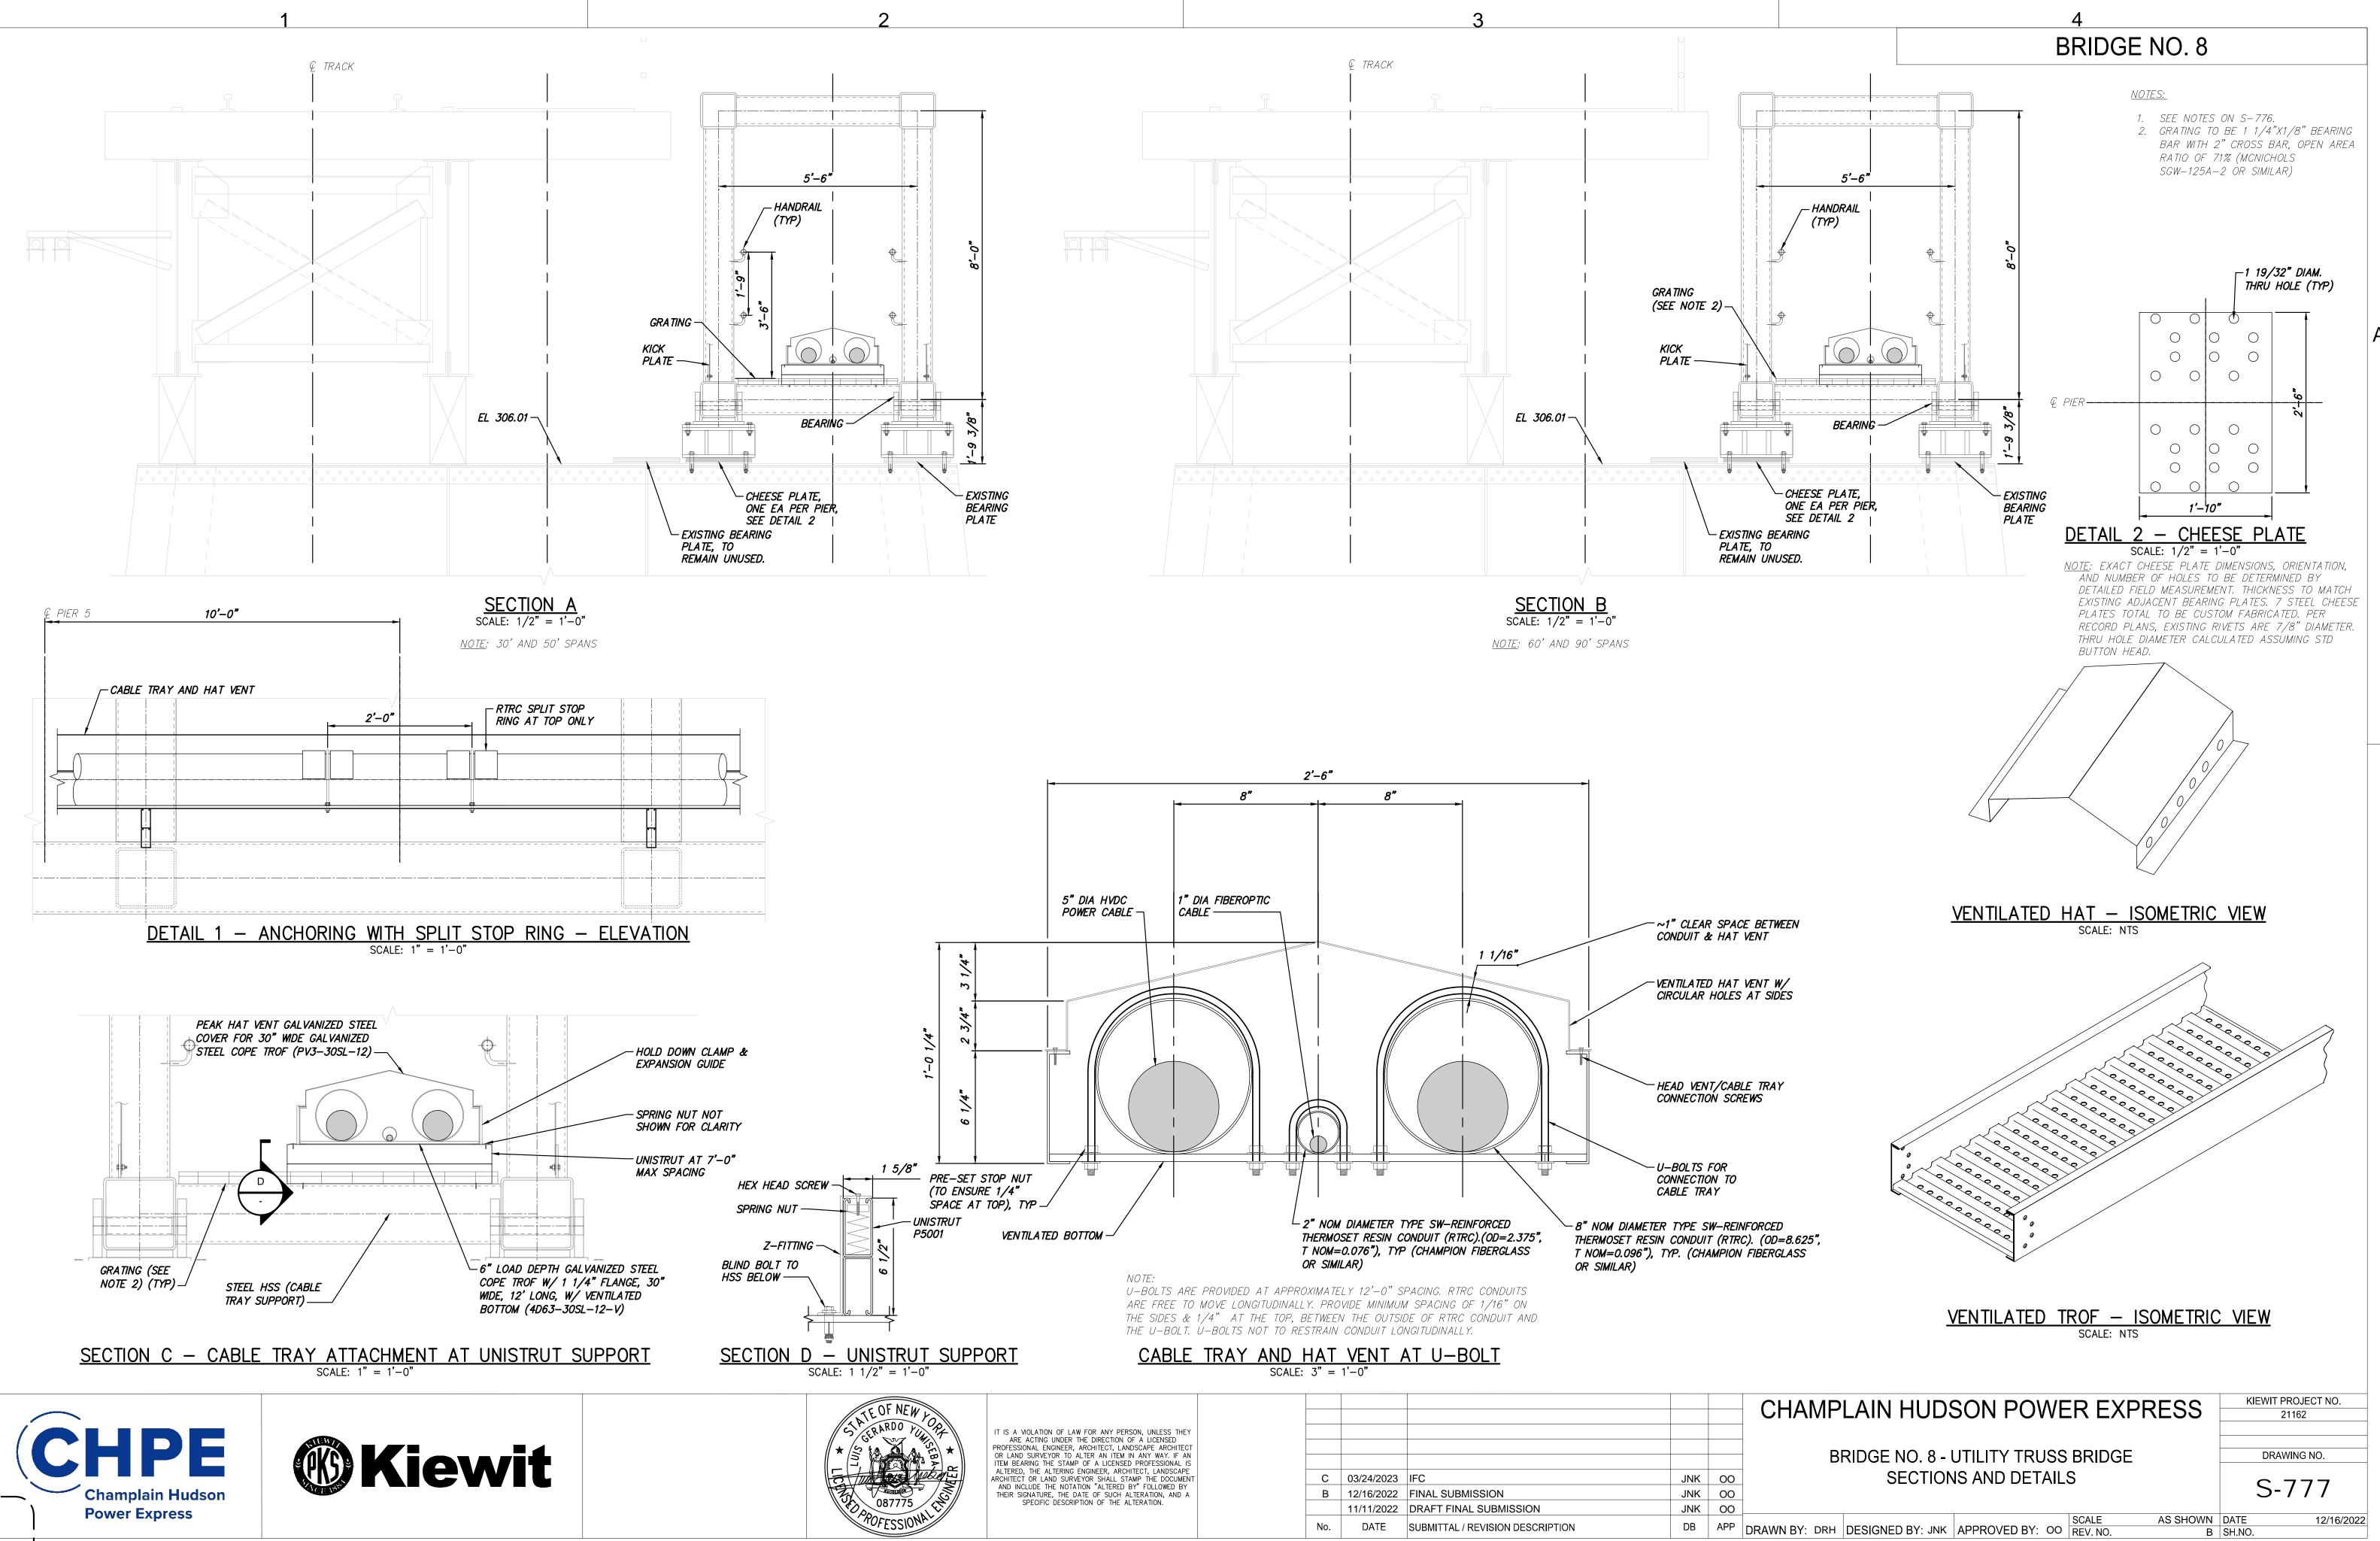


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	ARE ACTING UNDER THE DIRECTION OF A LICENSED PROFESSIONAL ENGINEER, ARCHITECT, LANDSCAPE ARCHITECT OR LAND SURVEYOR TO ALTER AN ITEM IN ANY WAY. IF AN						
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	AND INCLUDE THE NOTATION "ALTERED BY" FOLLOWED BY THEIR SIGNATURE, THE DATE OF SUCH ALTERATION, AND A	В	12/16/2022	FINAL SUBMISSION	JNK	00	-
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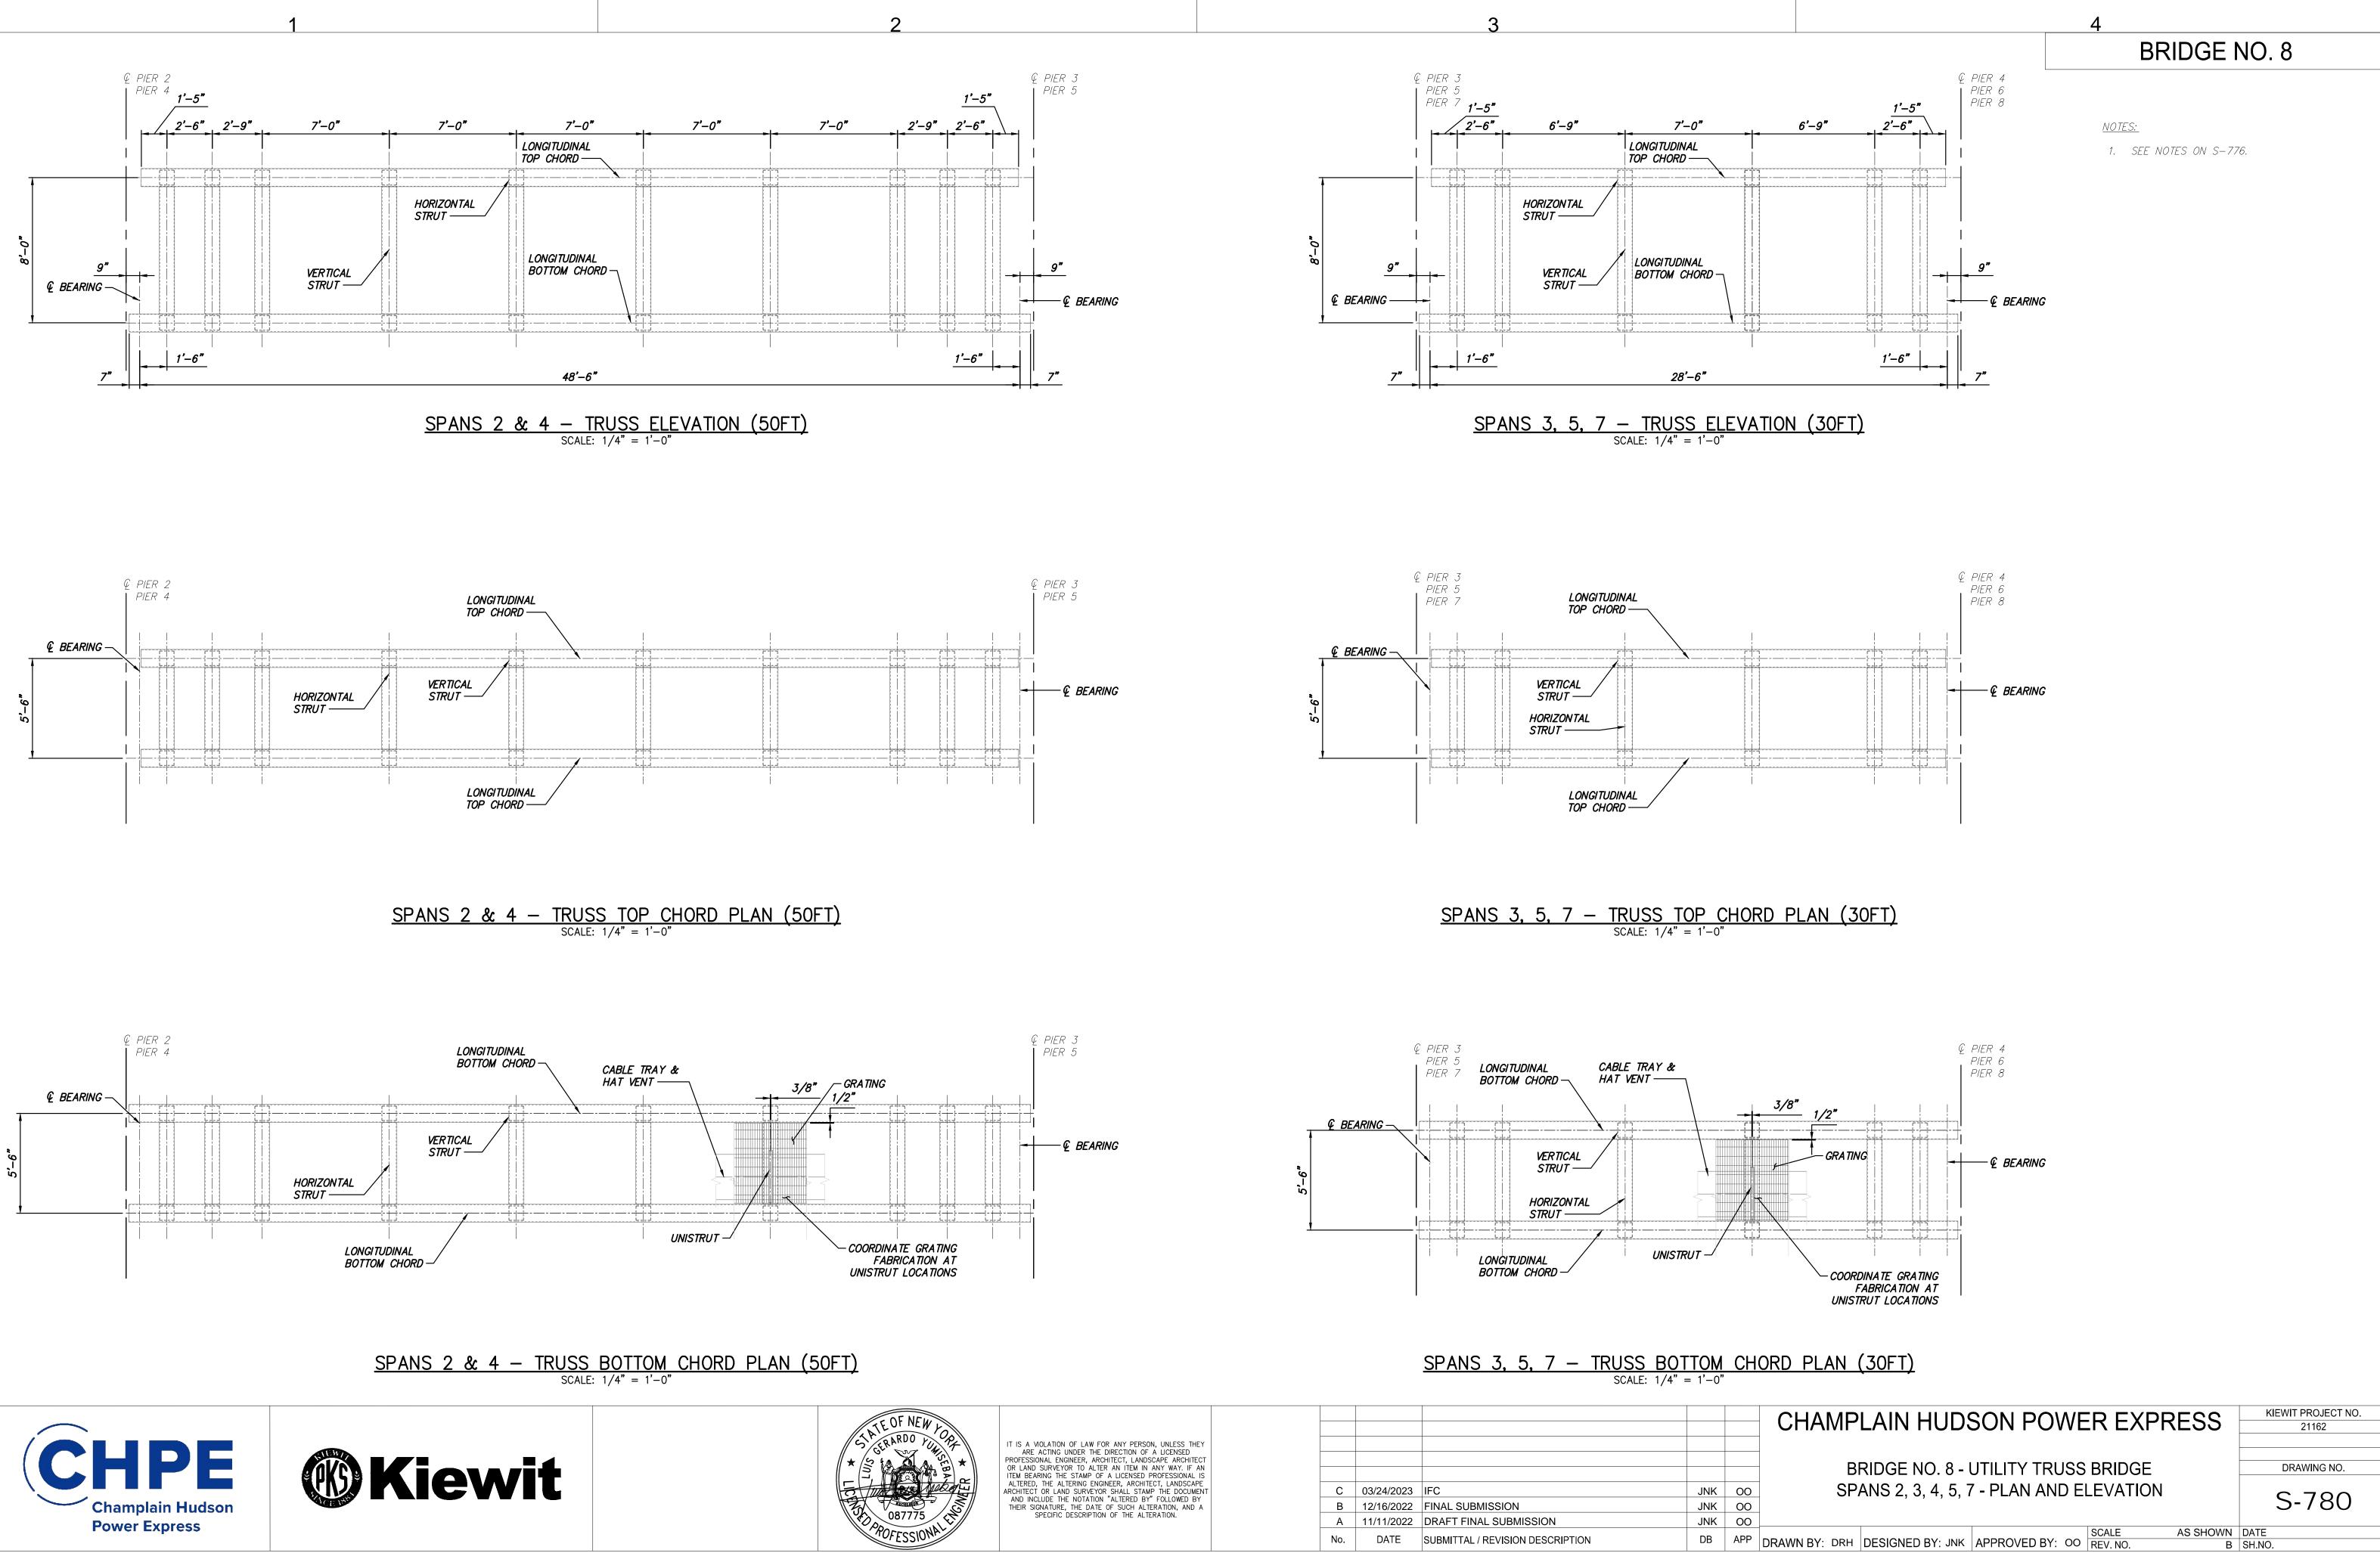
-@ 2" NOM DIA T REINFORCED THE RESIN CONDUIT ( SEE S−786 (TYP	RMOSET (RTRC). /	/- CABLE TRAY AND HAT VENT	
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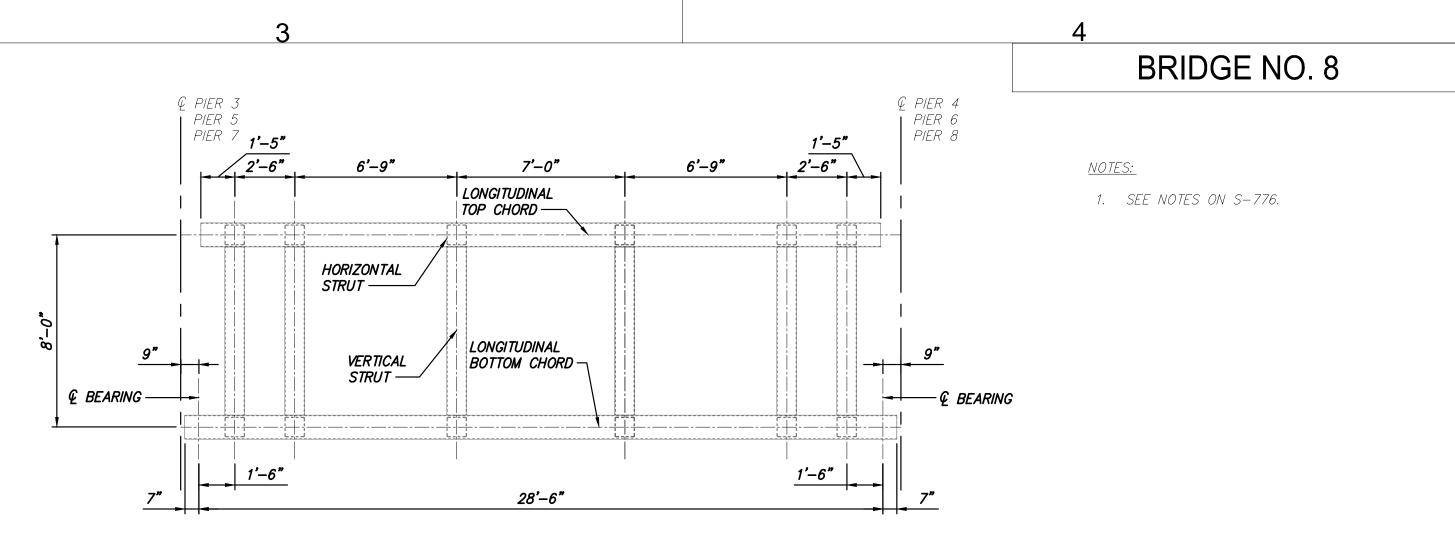


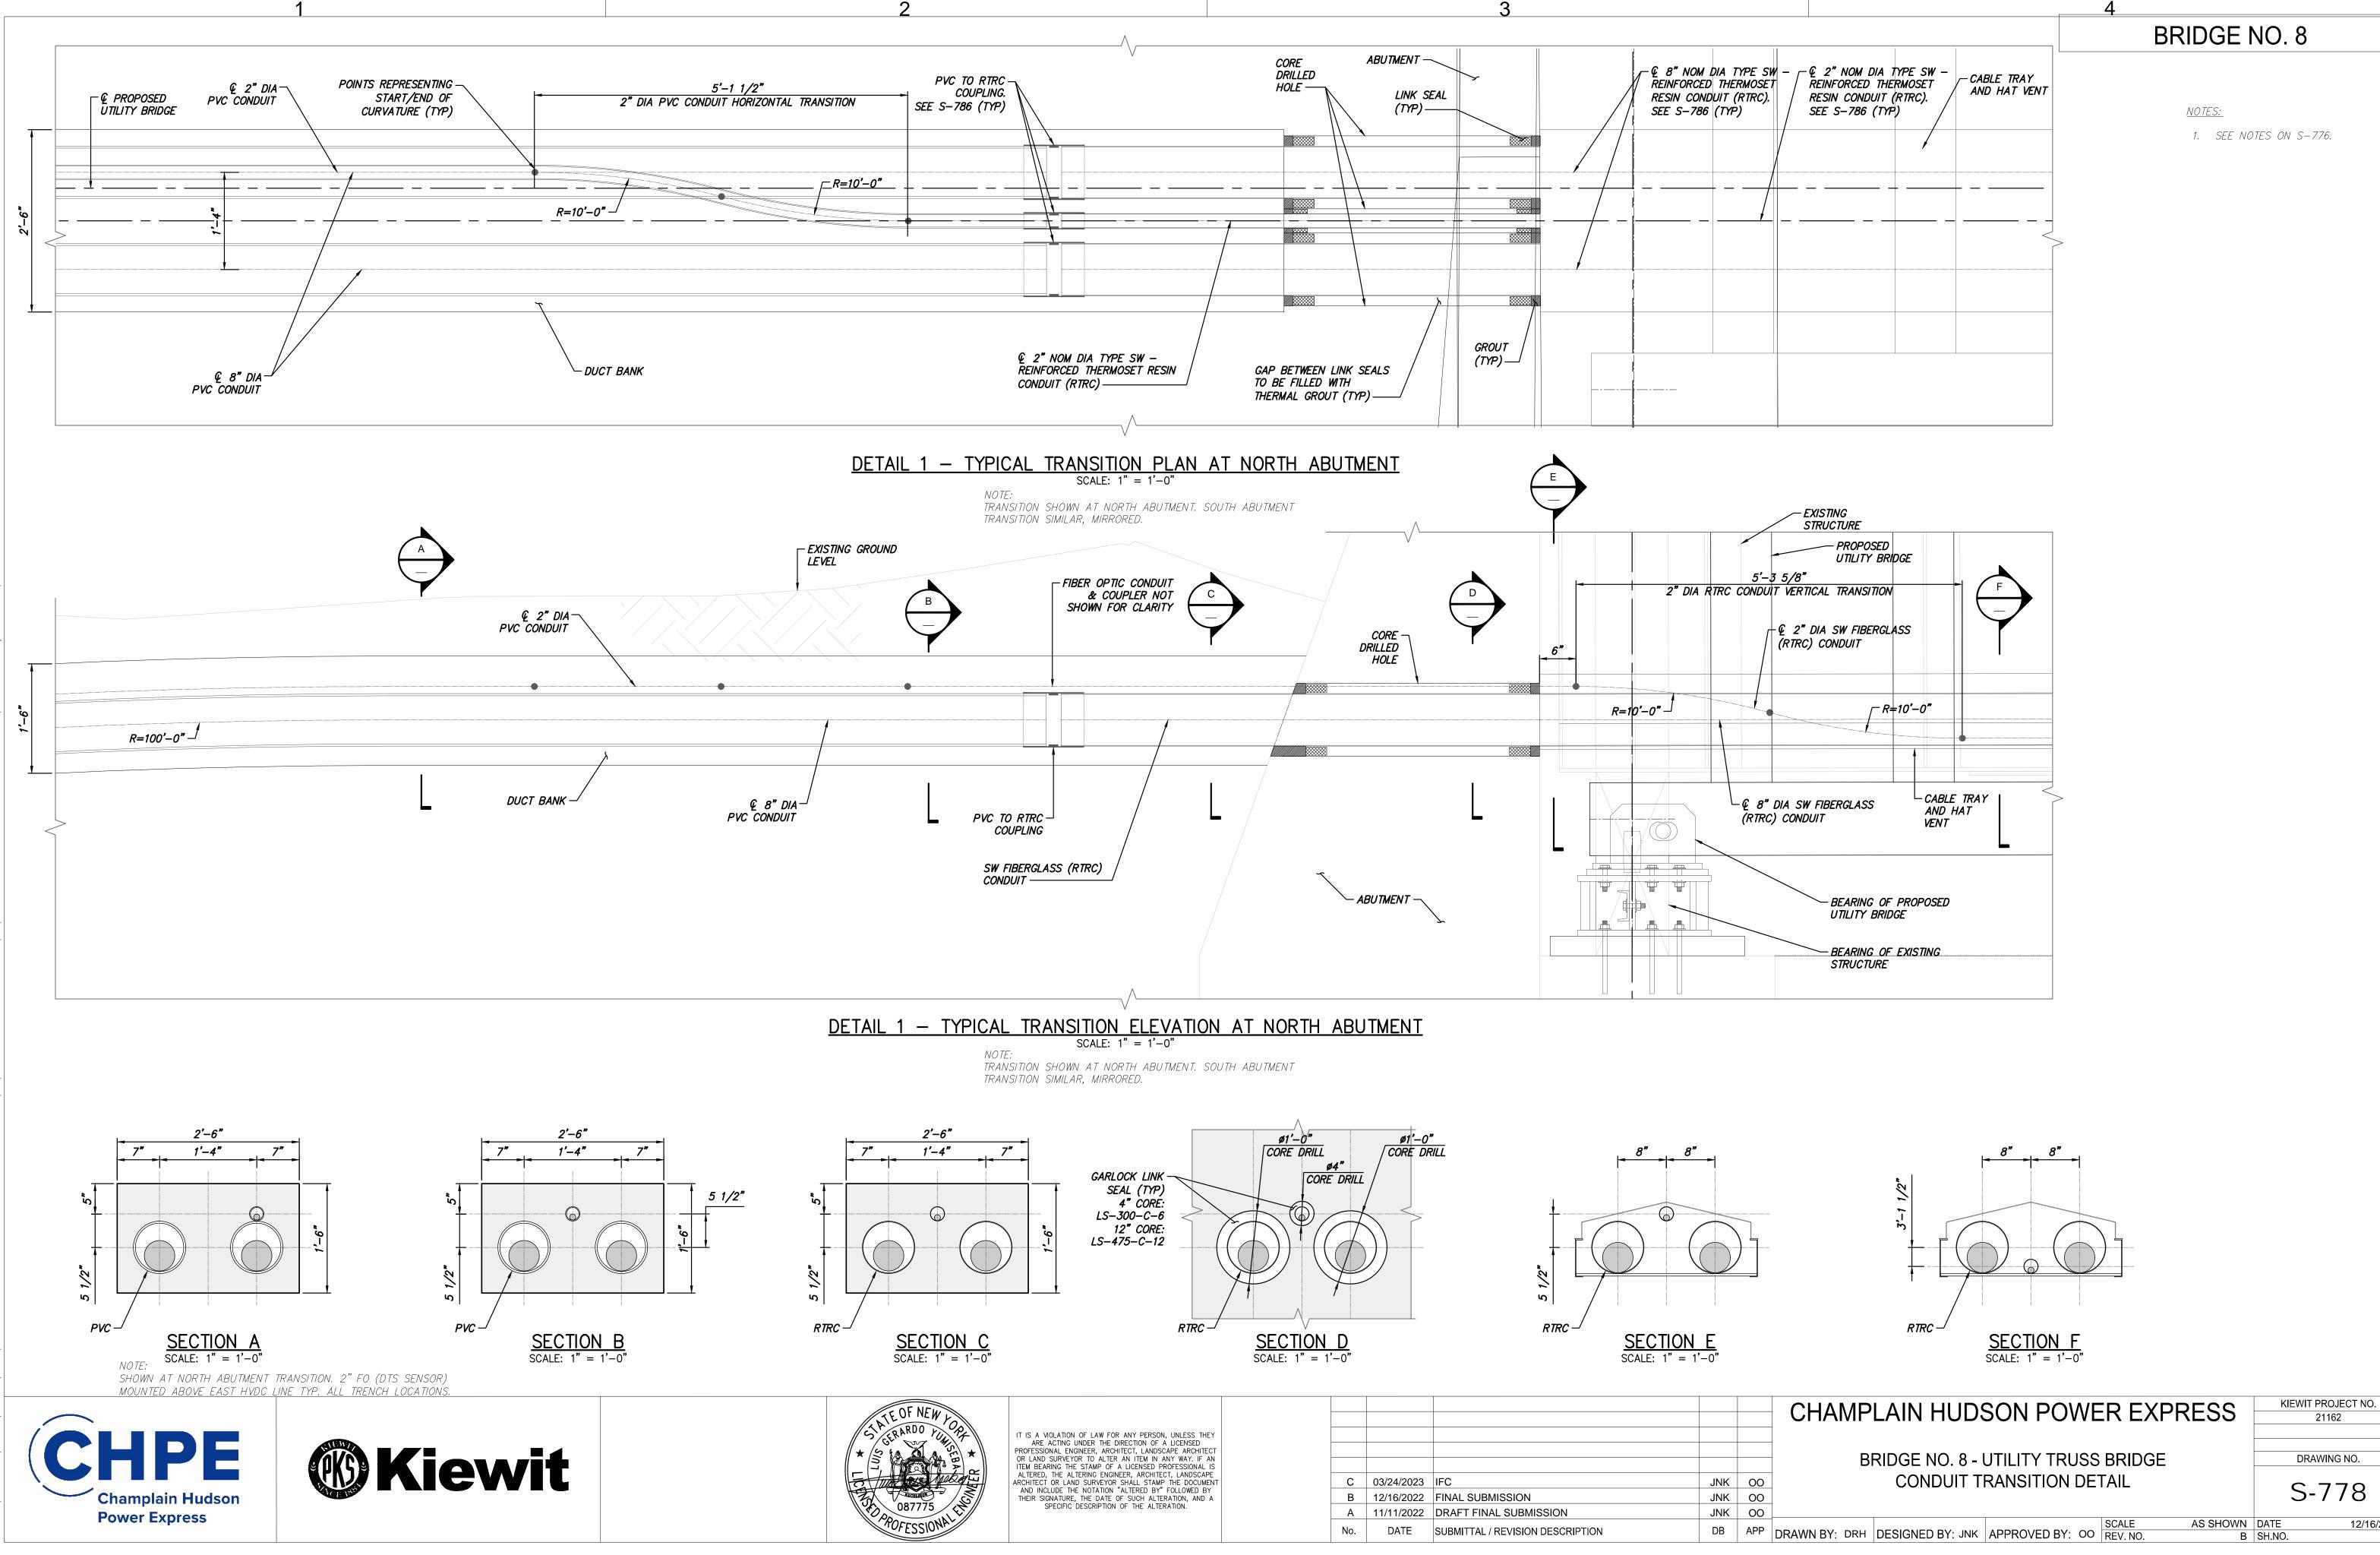


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	PROFESSIONAL ENGINEER, ARCHITECT, LANDSCAPE ARCHITECT OR LAND SURVEYOR TO ALTER AN ITEM IN ANY WAY. IF AN						-
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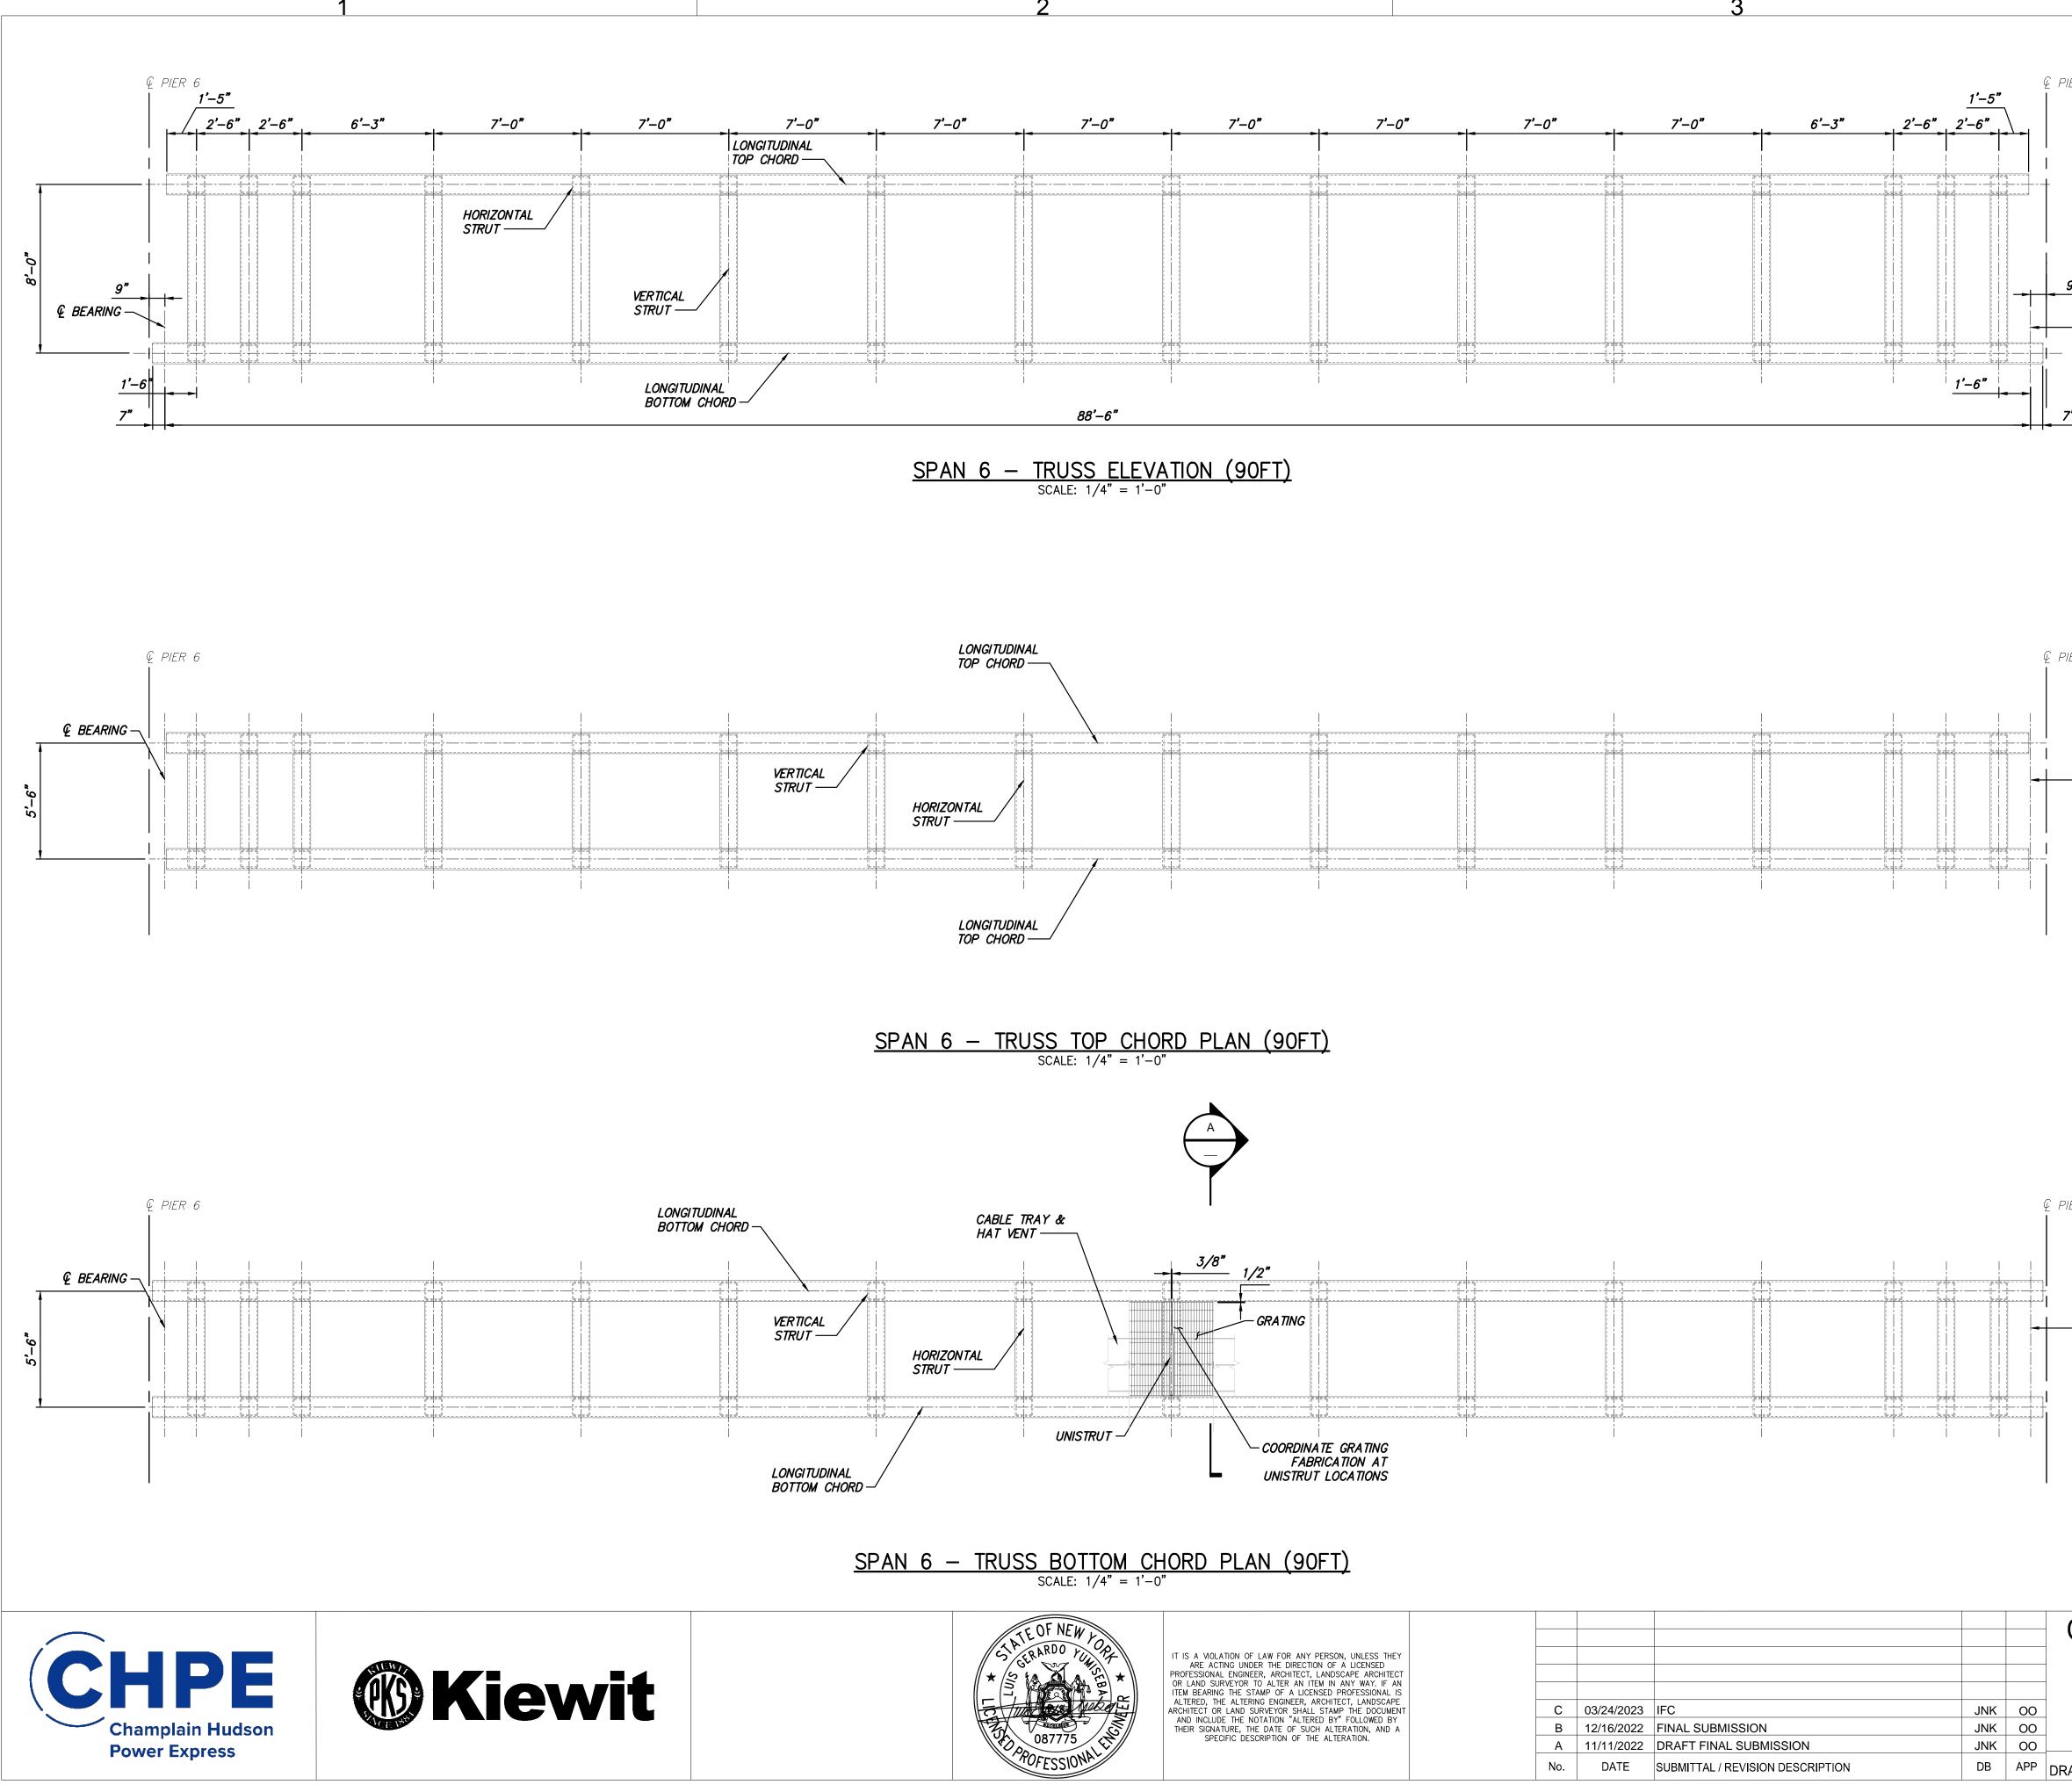




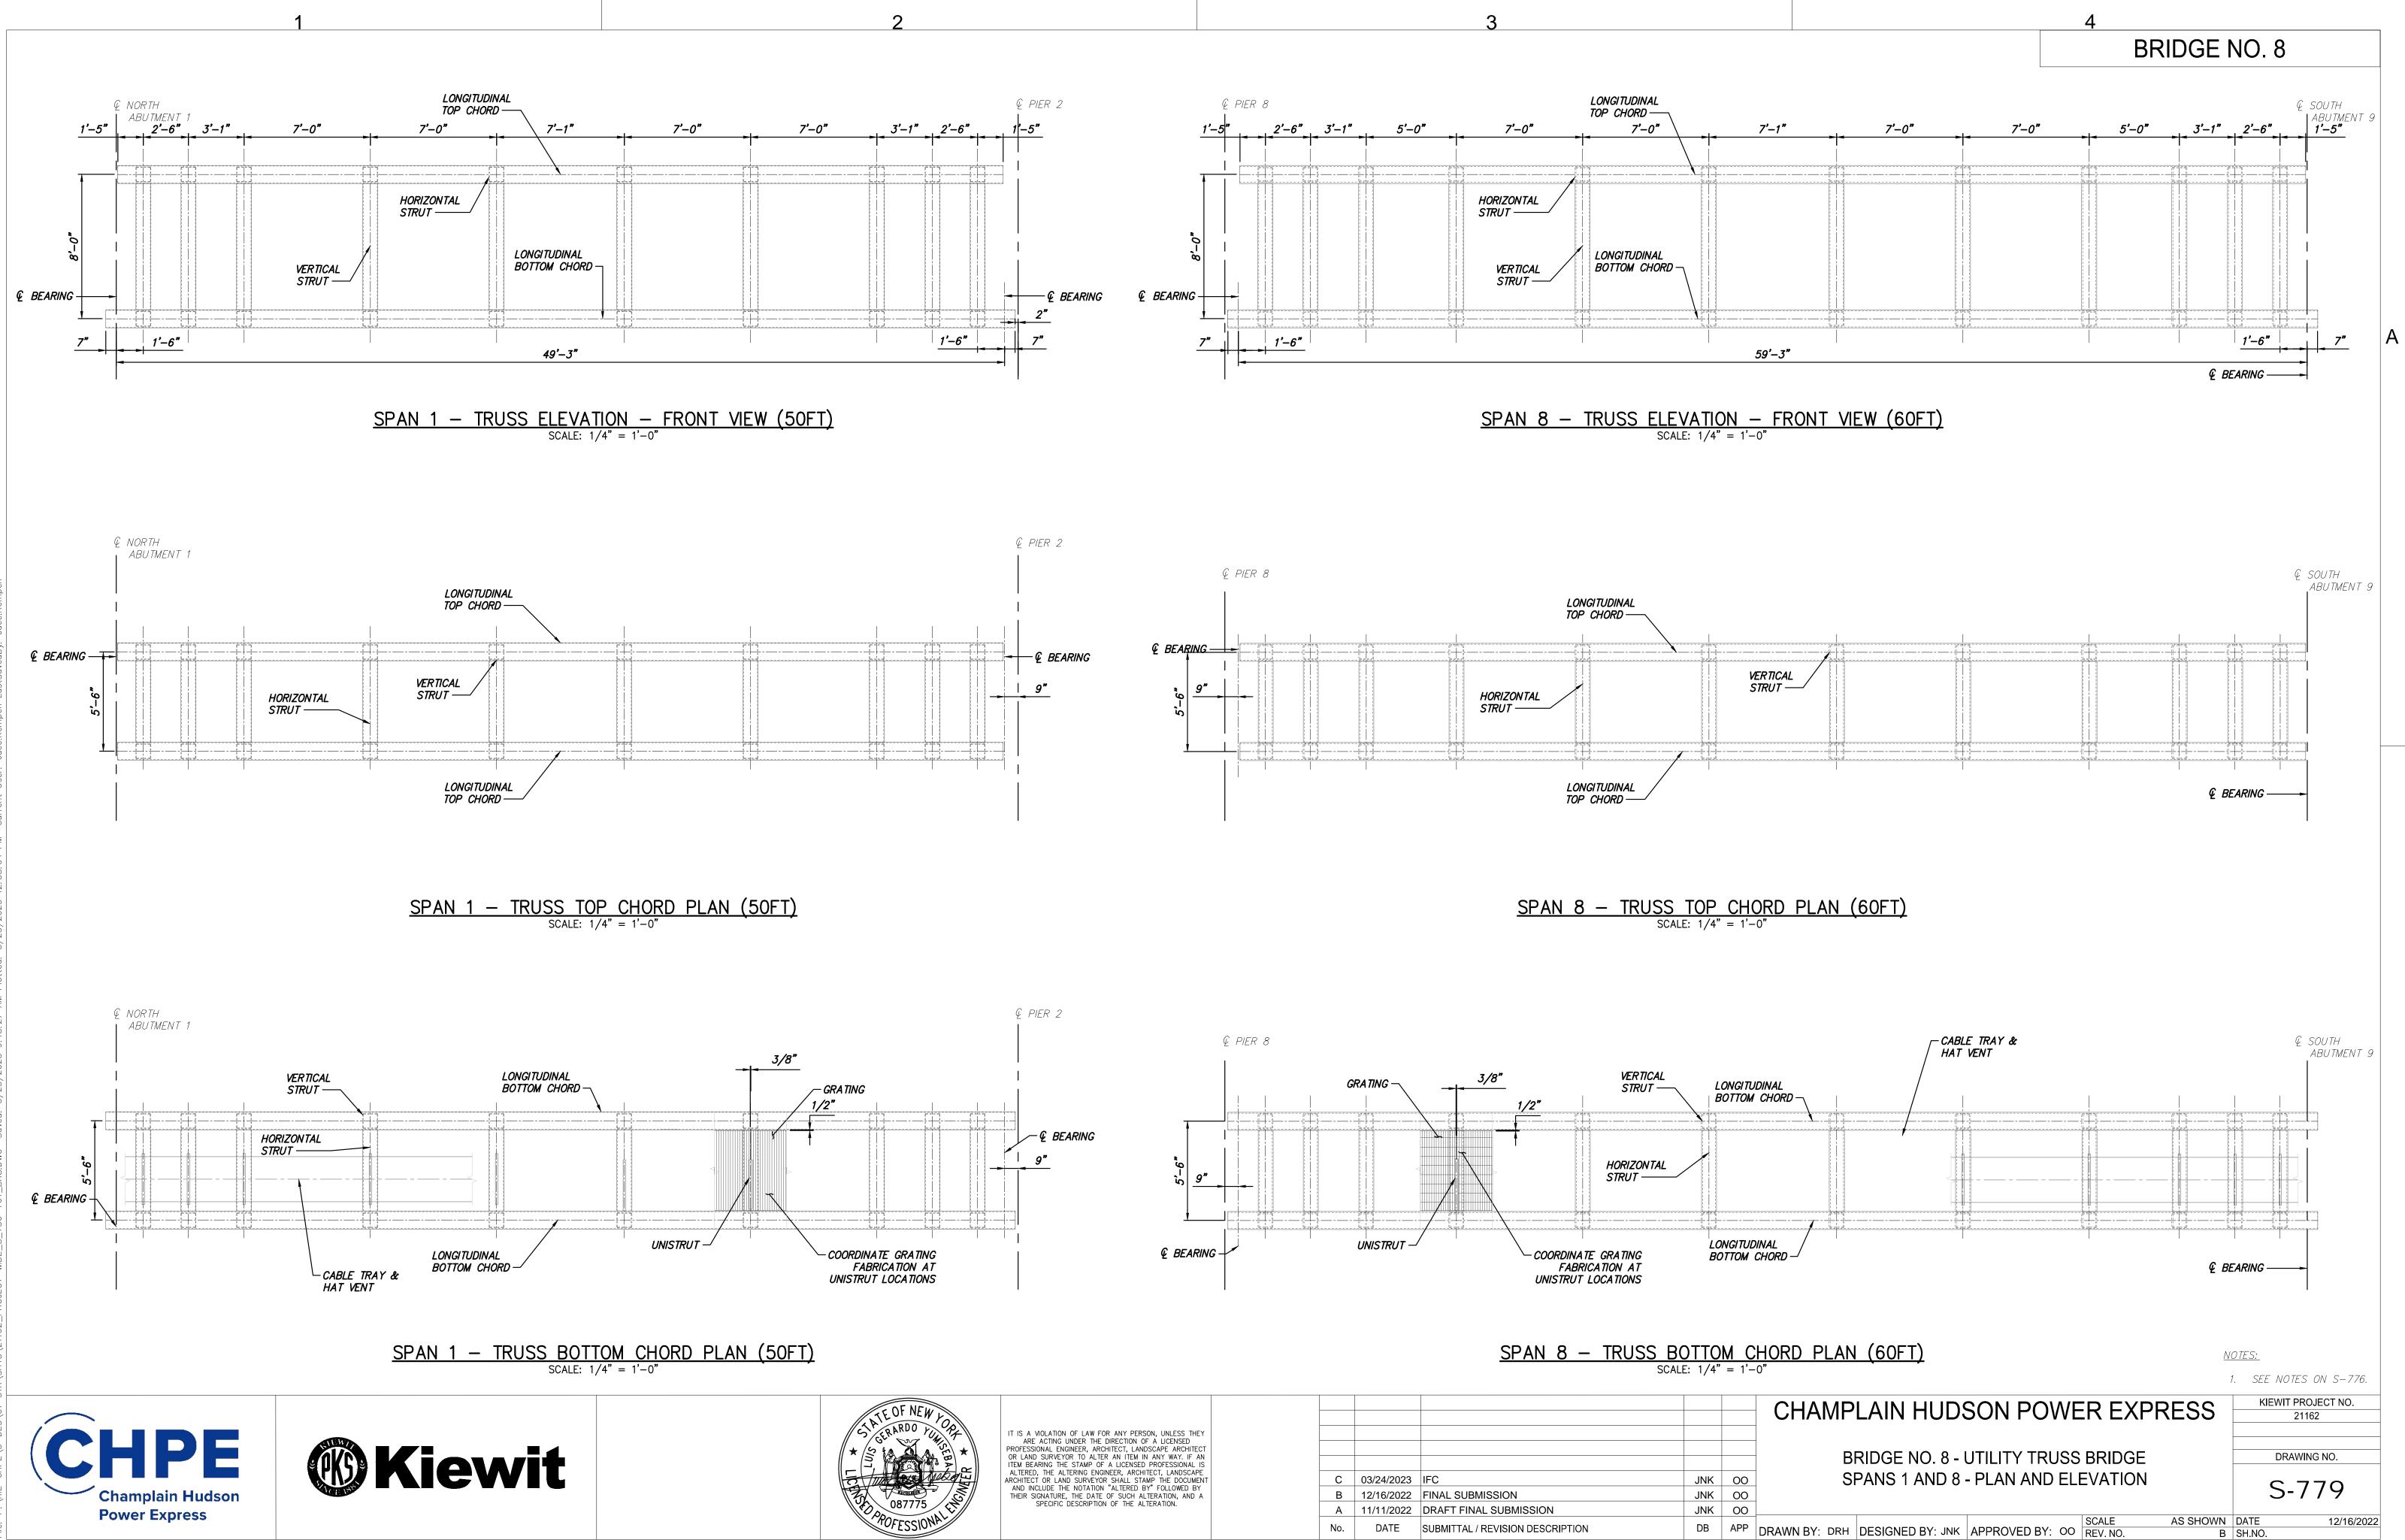

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	ARE ACTING UNDER THE DIRECTION OF A LICENSED PROFESSIONAL ENGINEER, ARCHITECT, LANDSCAPE ARCHITECT						-
	OR LAND SURVEYOR TO ALTER AN ITEM IN ANY WAY. IF AN						-
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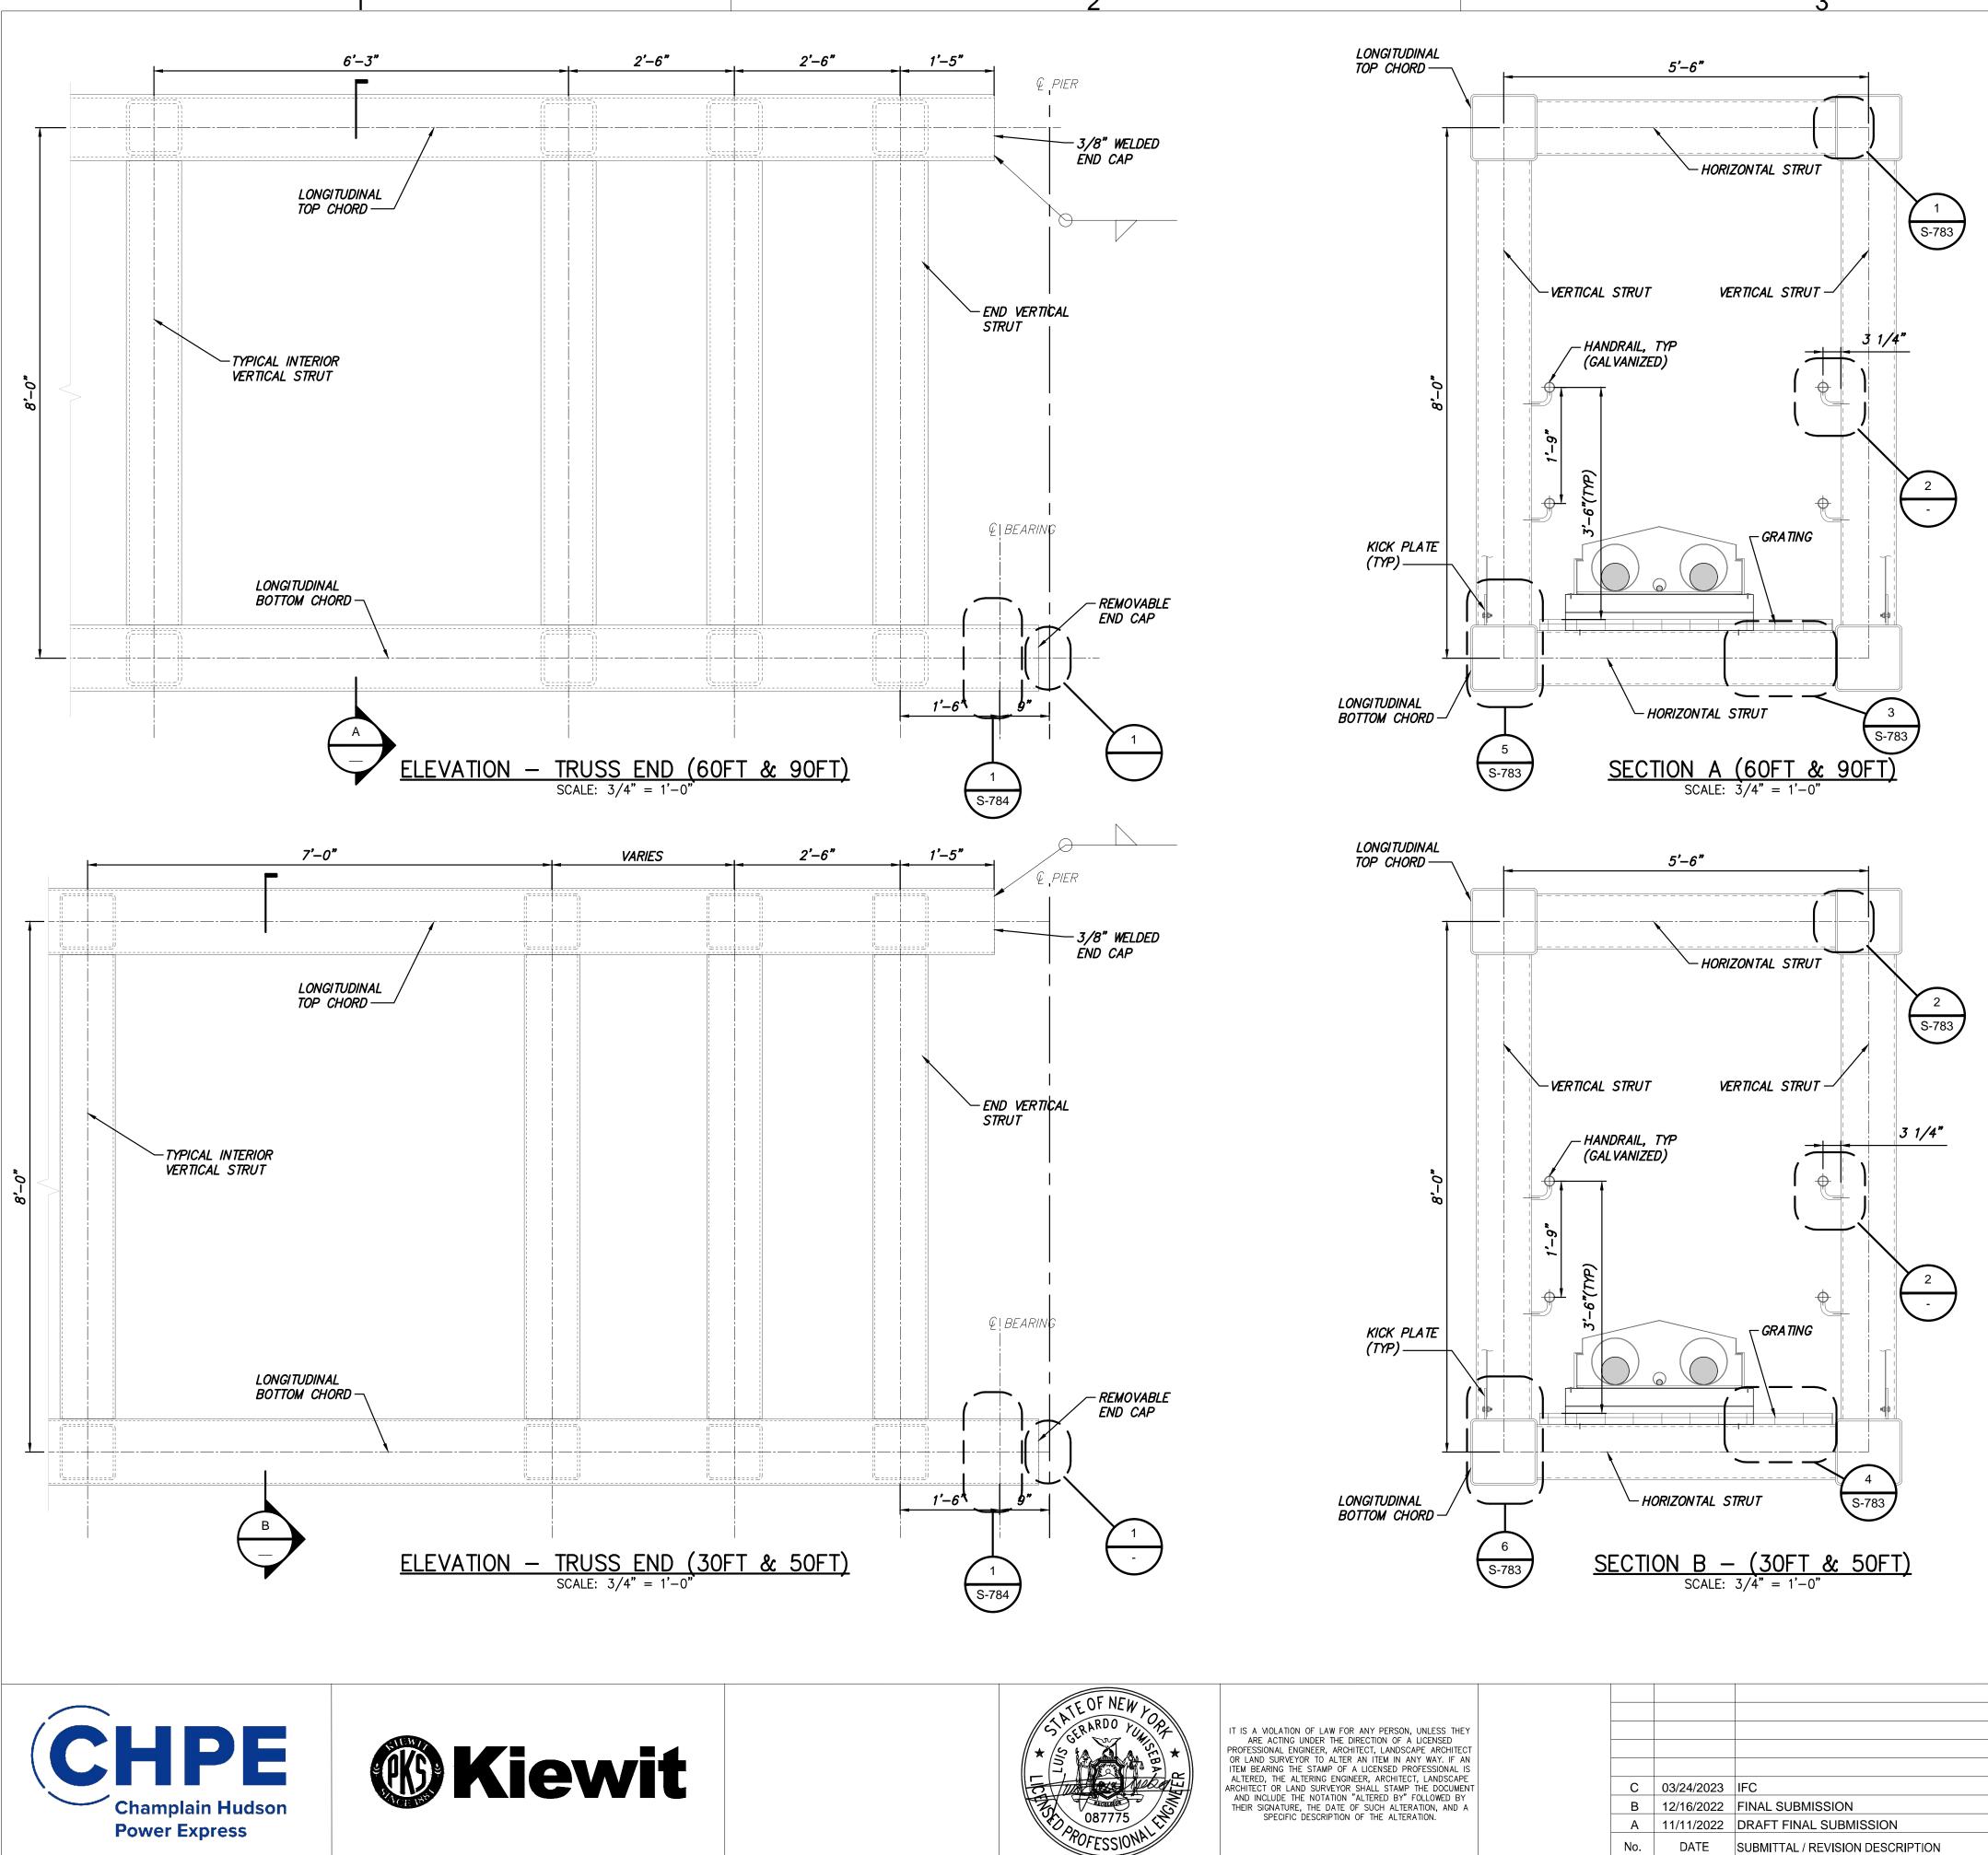
D PLAN (30FT)							
CHAMP	KIEWIT PROJECT NO. 21162						
Bł SP/	DRAWING NO.						
AWN BY: DRH	DESIGNED BY: JNK	APPROVED BY: 00	SCALE REV. NO.	AS SHOWN B	DATE SH.NO.		

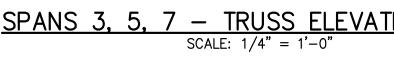



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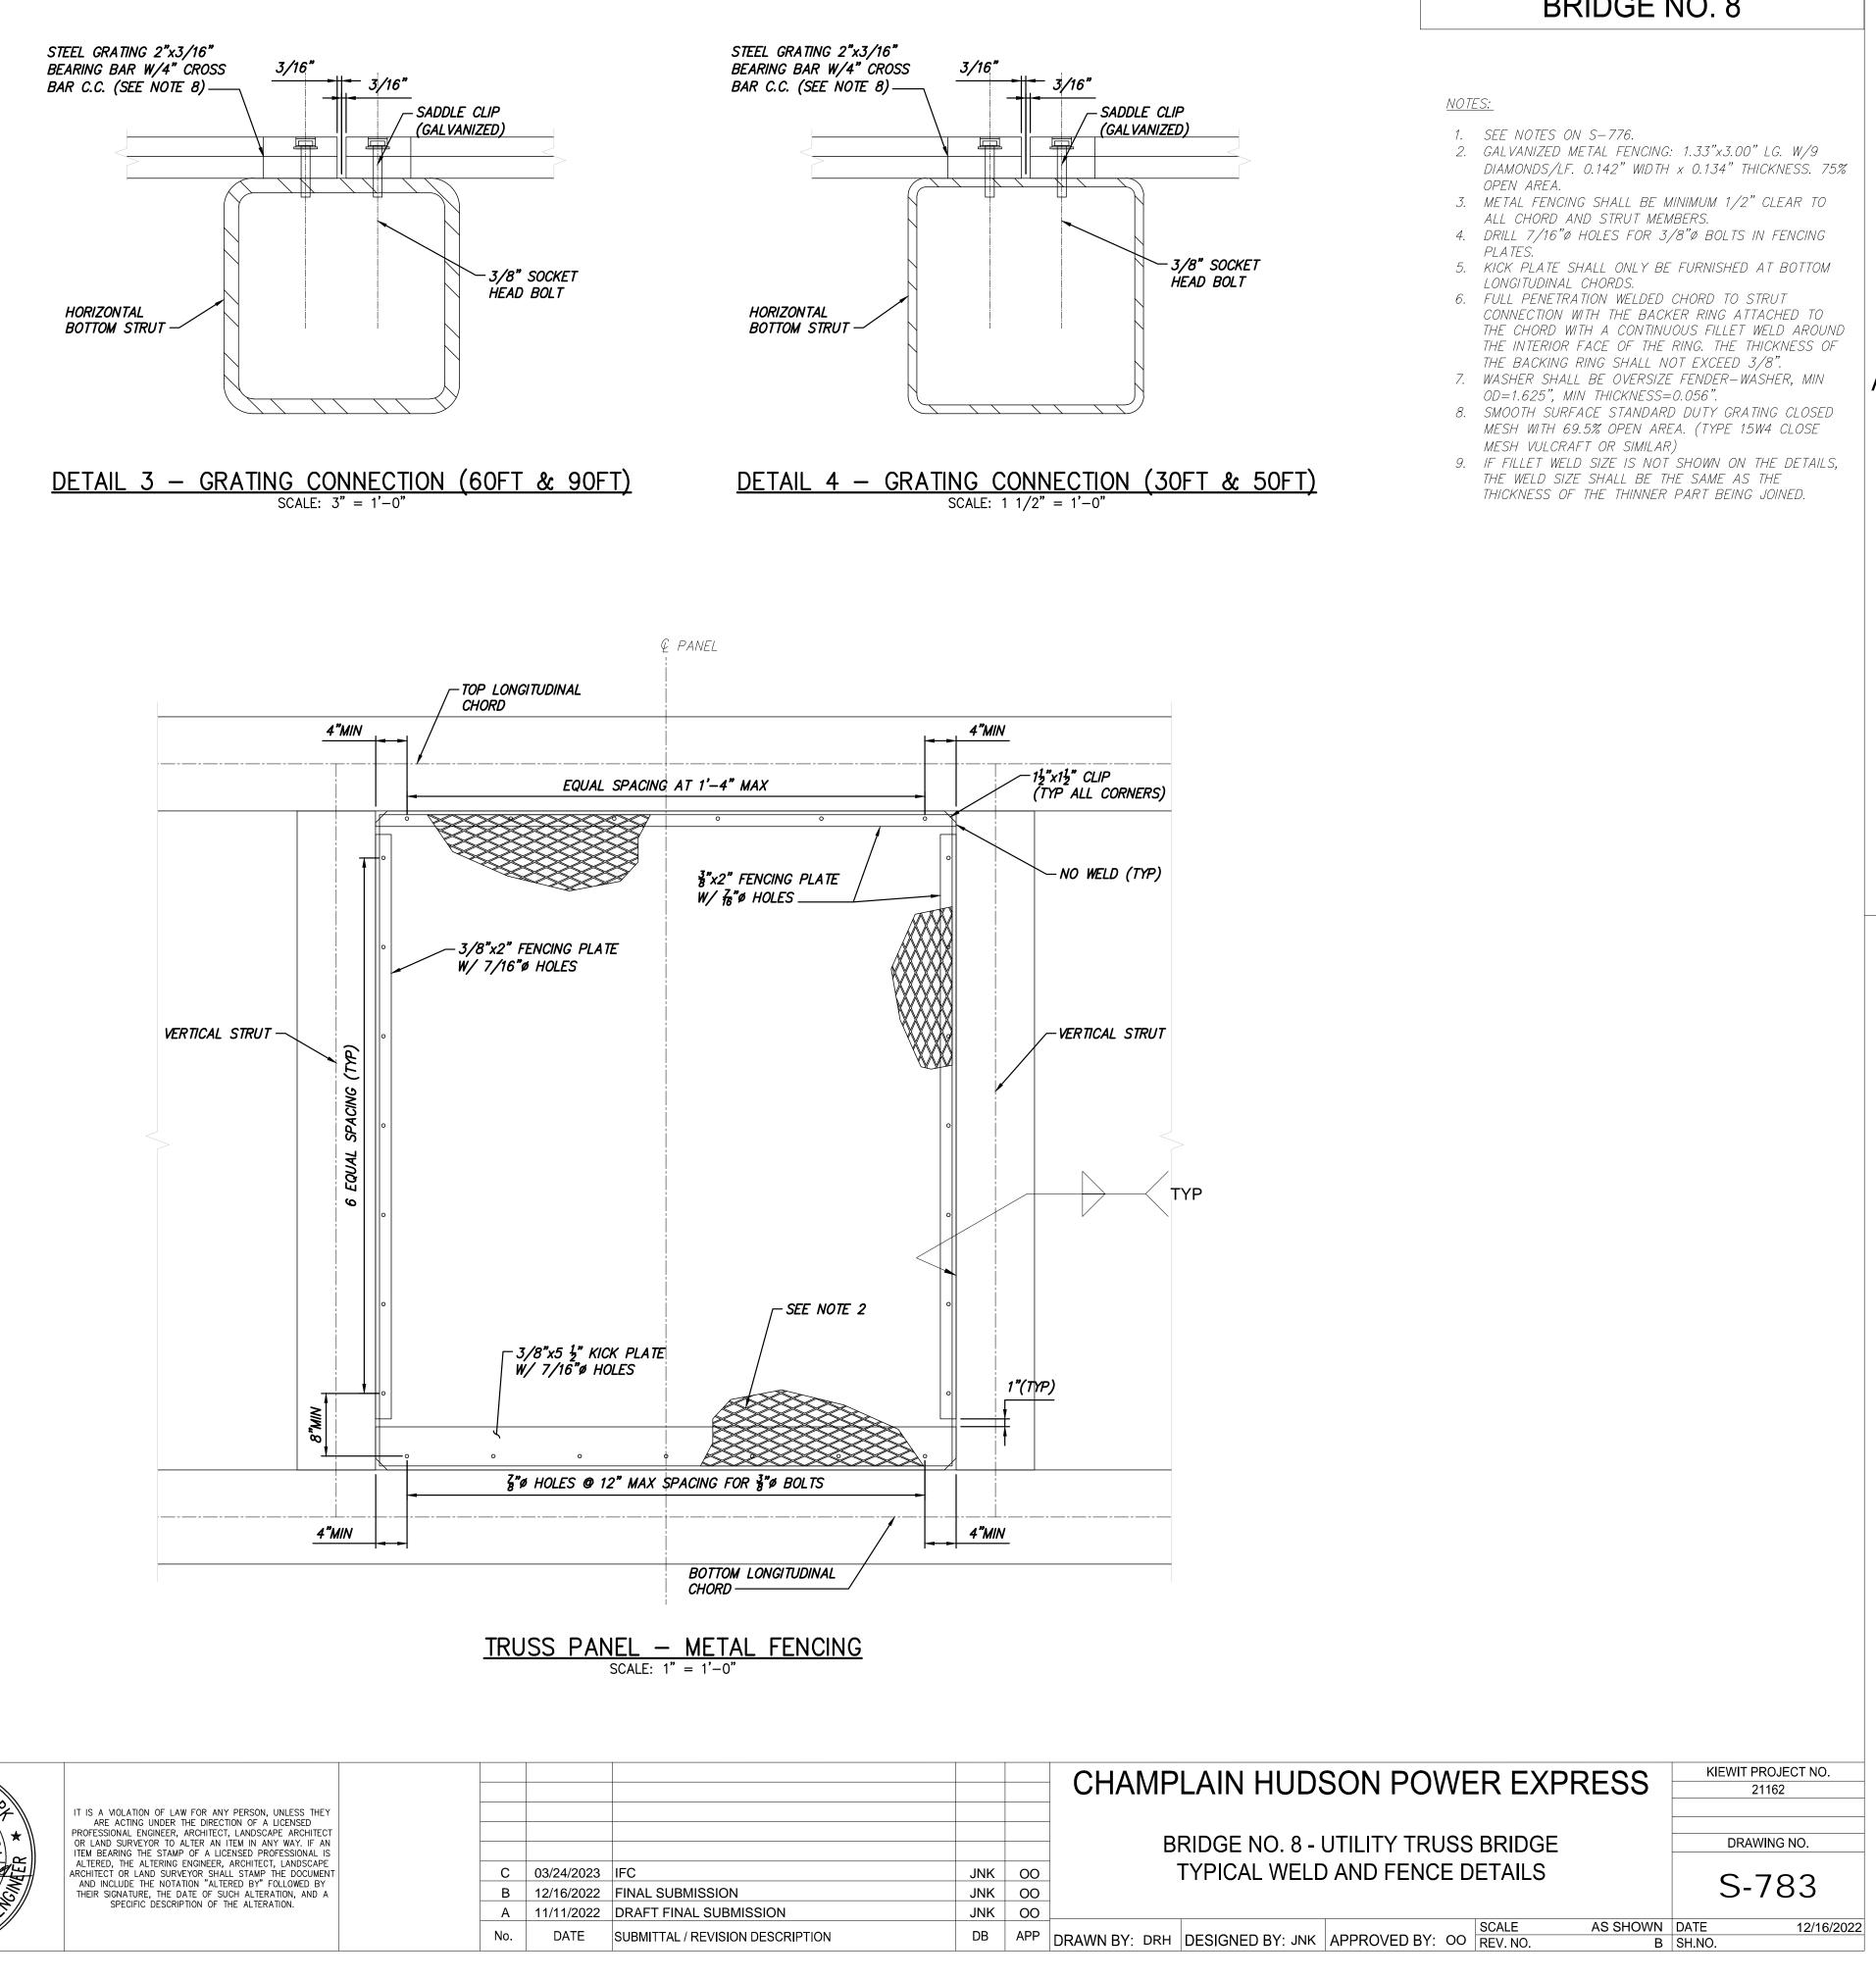
	BRIDGE	NO. 8	
NER 7			
	<u>NOTES:</u> 1. SEE NOTES ON S-77	6.	
<i>9"</i>			
— ¢ BEARING			
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<b>7</b> ″			
PIER 7			
— ∉ BEARING			
- LONGITUL	DINAL		
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FENCING PLATE			
(TYP)/			
FENCING (TYP)			
— HANDRAIL, (GAL VANIZ			
PIER 7	<b></b>		
÷	<b>.</b>		
— ♀ BEARING 9 1/8"			
	GRATING		
KICK PLATE (TYP) ACCESS :	4 1/2"		
FOR U-B	LONGITUDINAL		
	BOTTOM CHORD/		
<u>SECTION</u>	A – ACCESS FOR U- SCALE: 3/4" = 1'-0"	-BOFIZ	
CHAMPLAIN HUDSON PC	OWER EXPRESS	KIEWIT PROJECT NO. 21162	
BRIDGE NO. 8 - UTILITY TF	RUSS BRIDGE	DRAWING NO.	
SPAN 6 - PLAN AND EI	EVATION	S-781	

12/16/2022






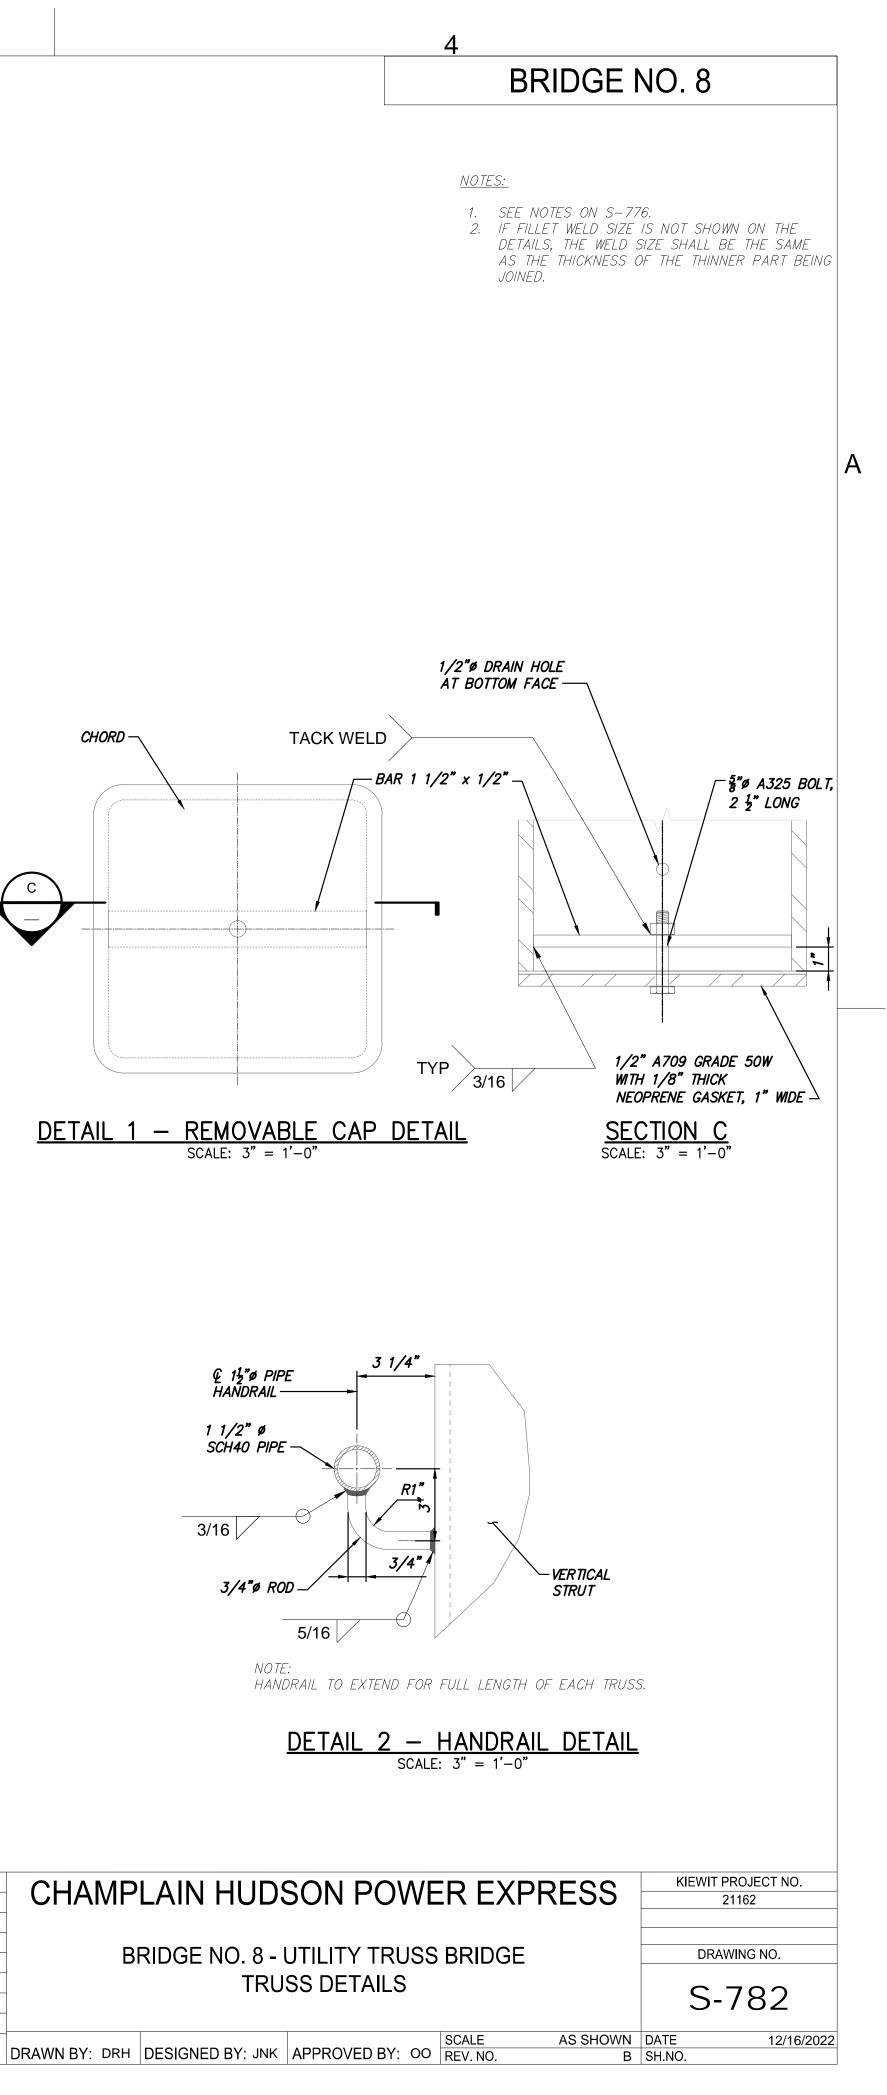


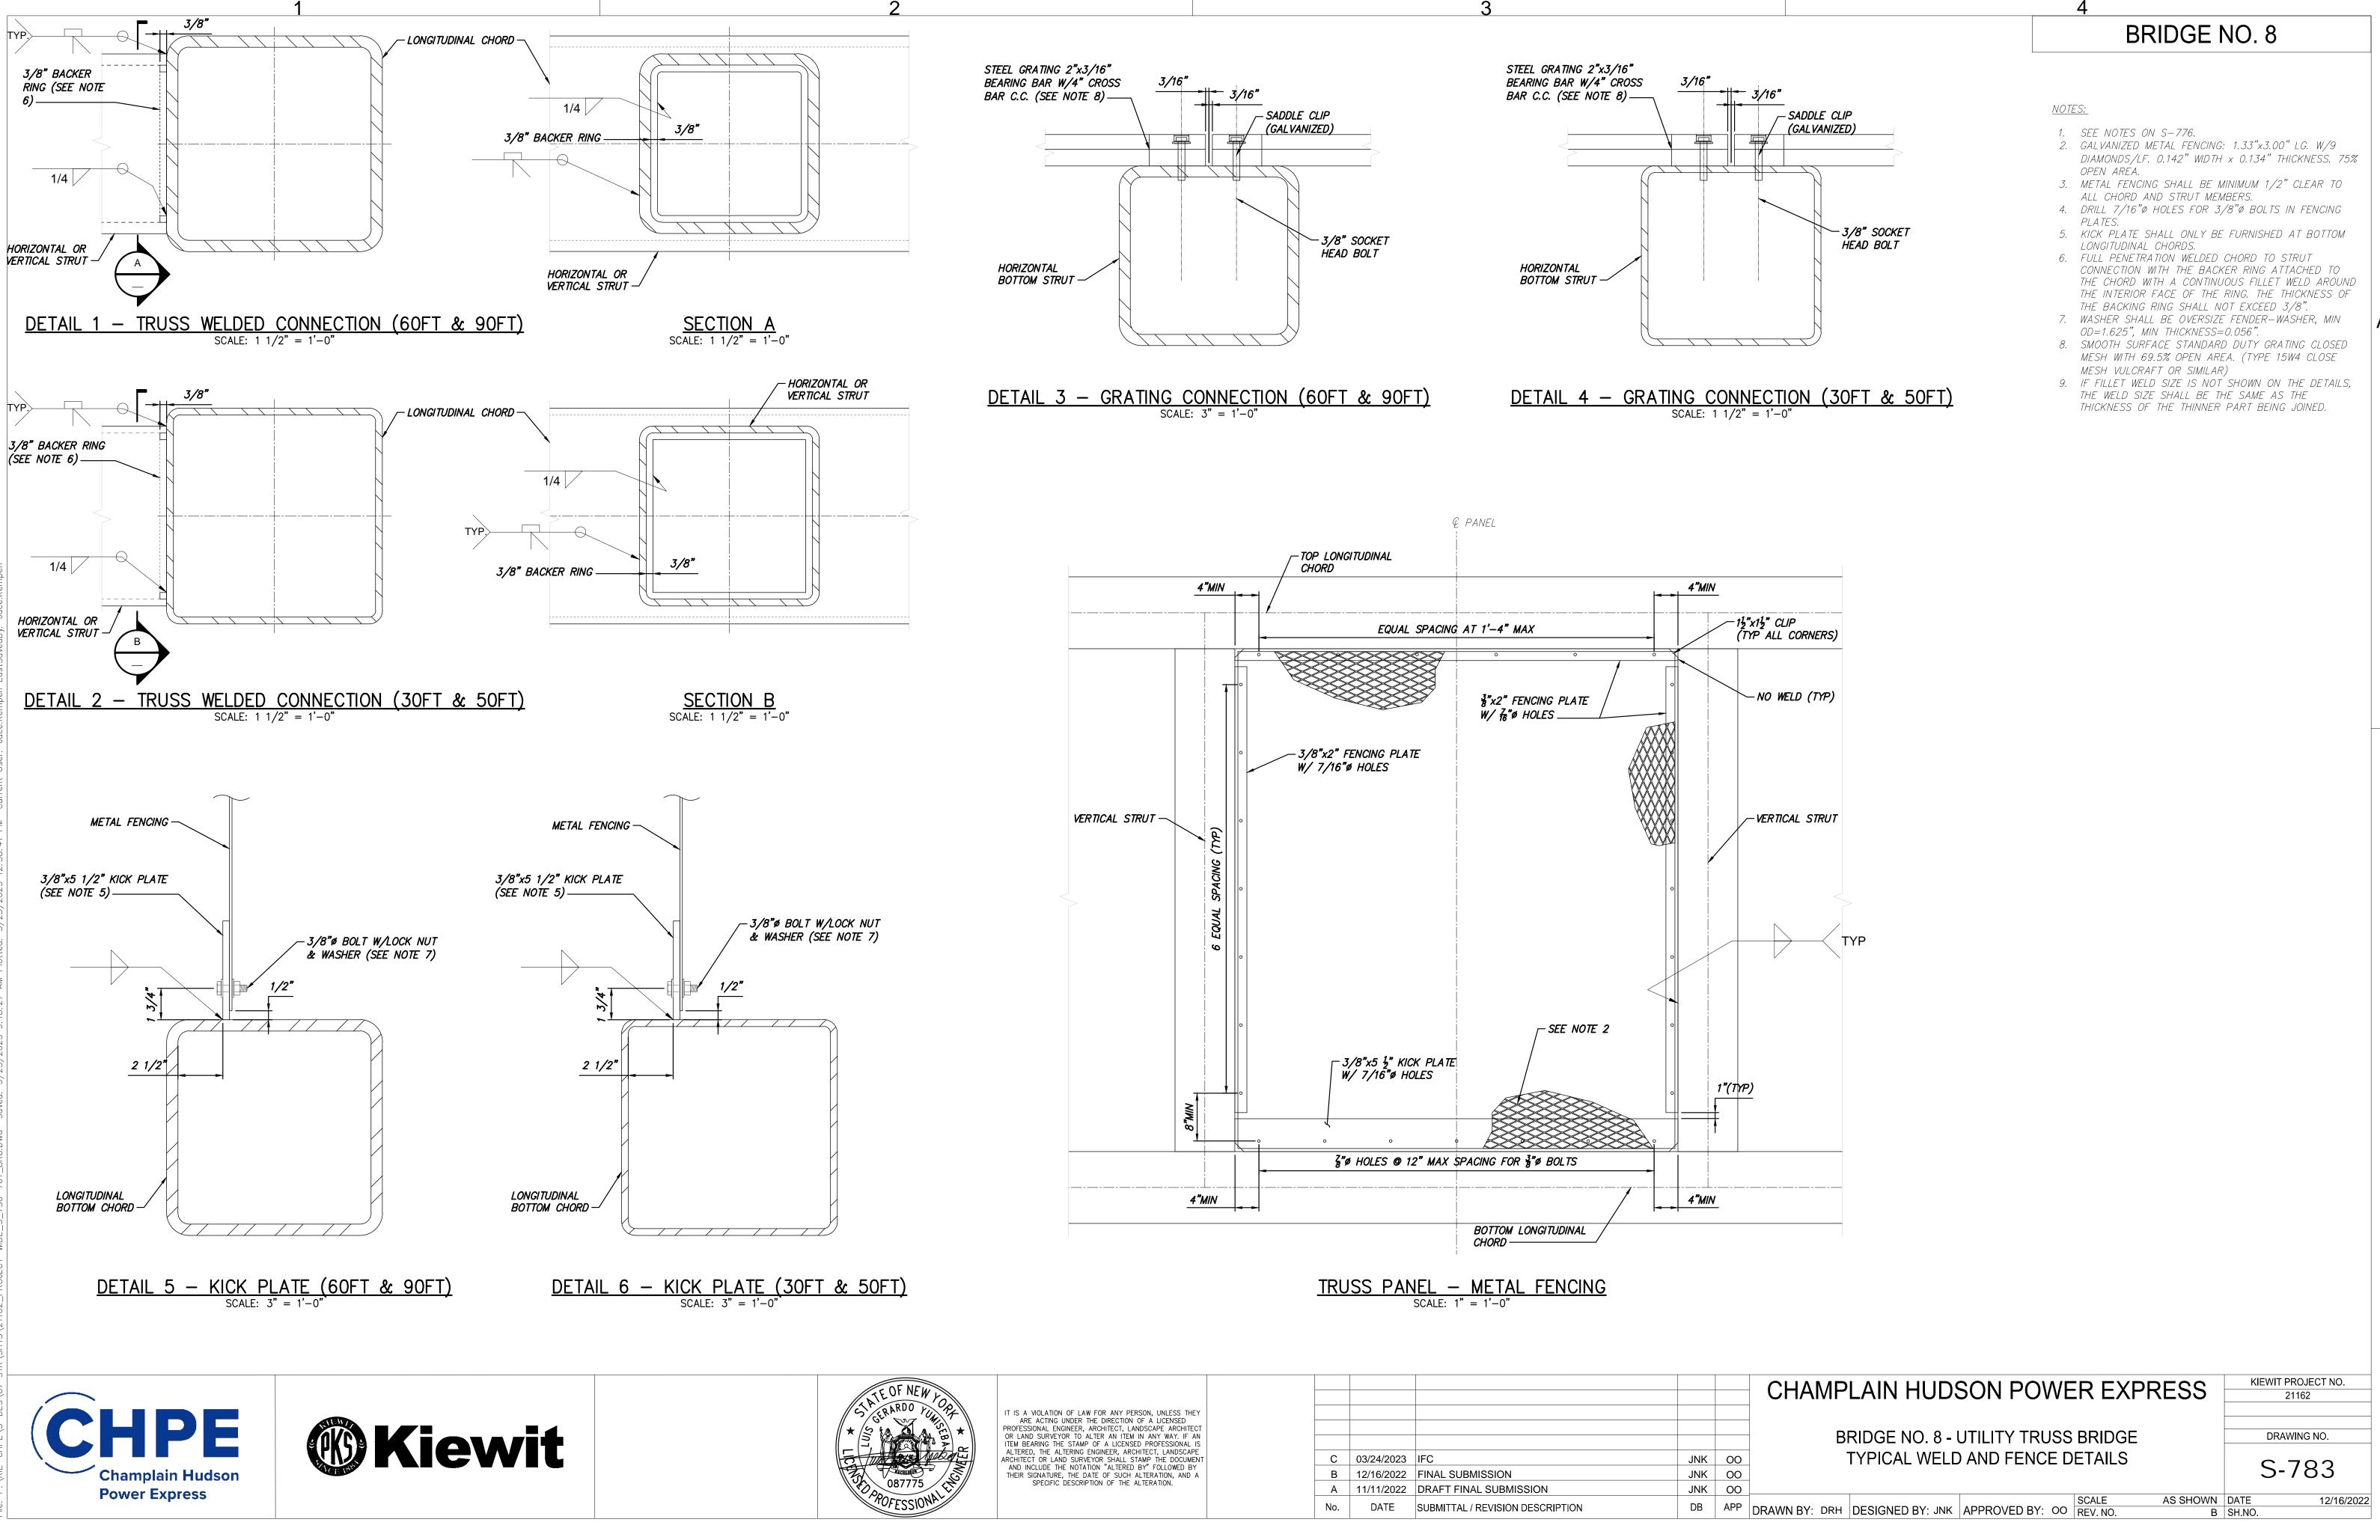




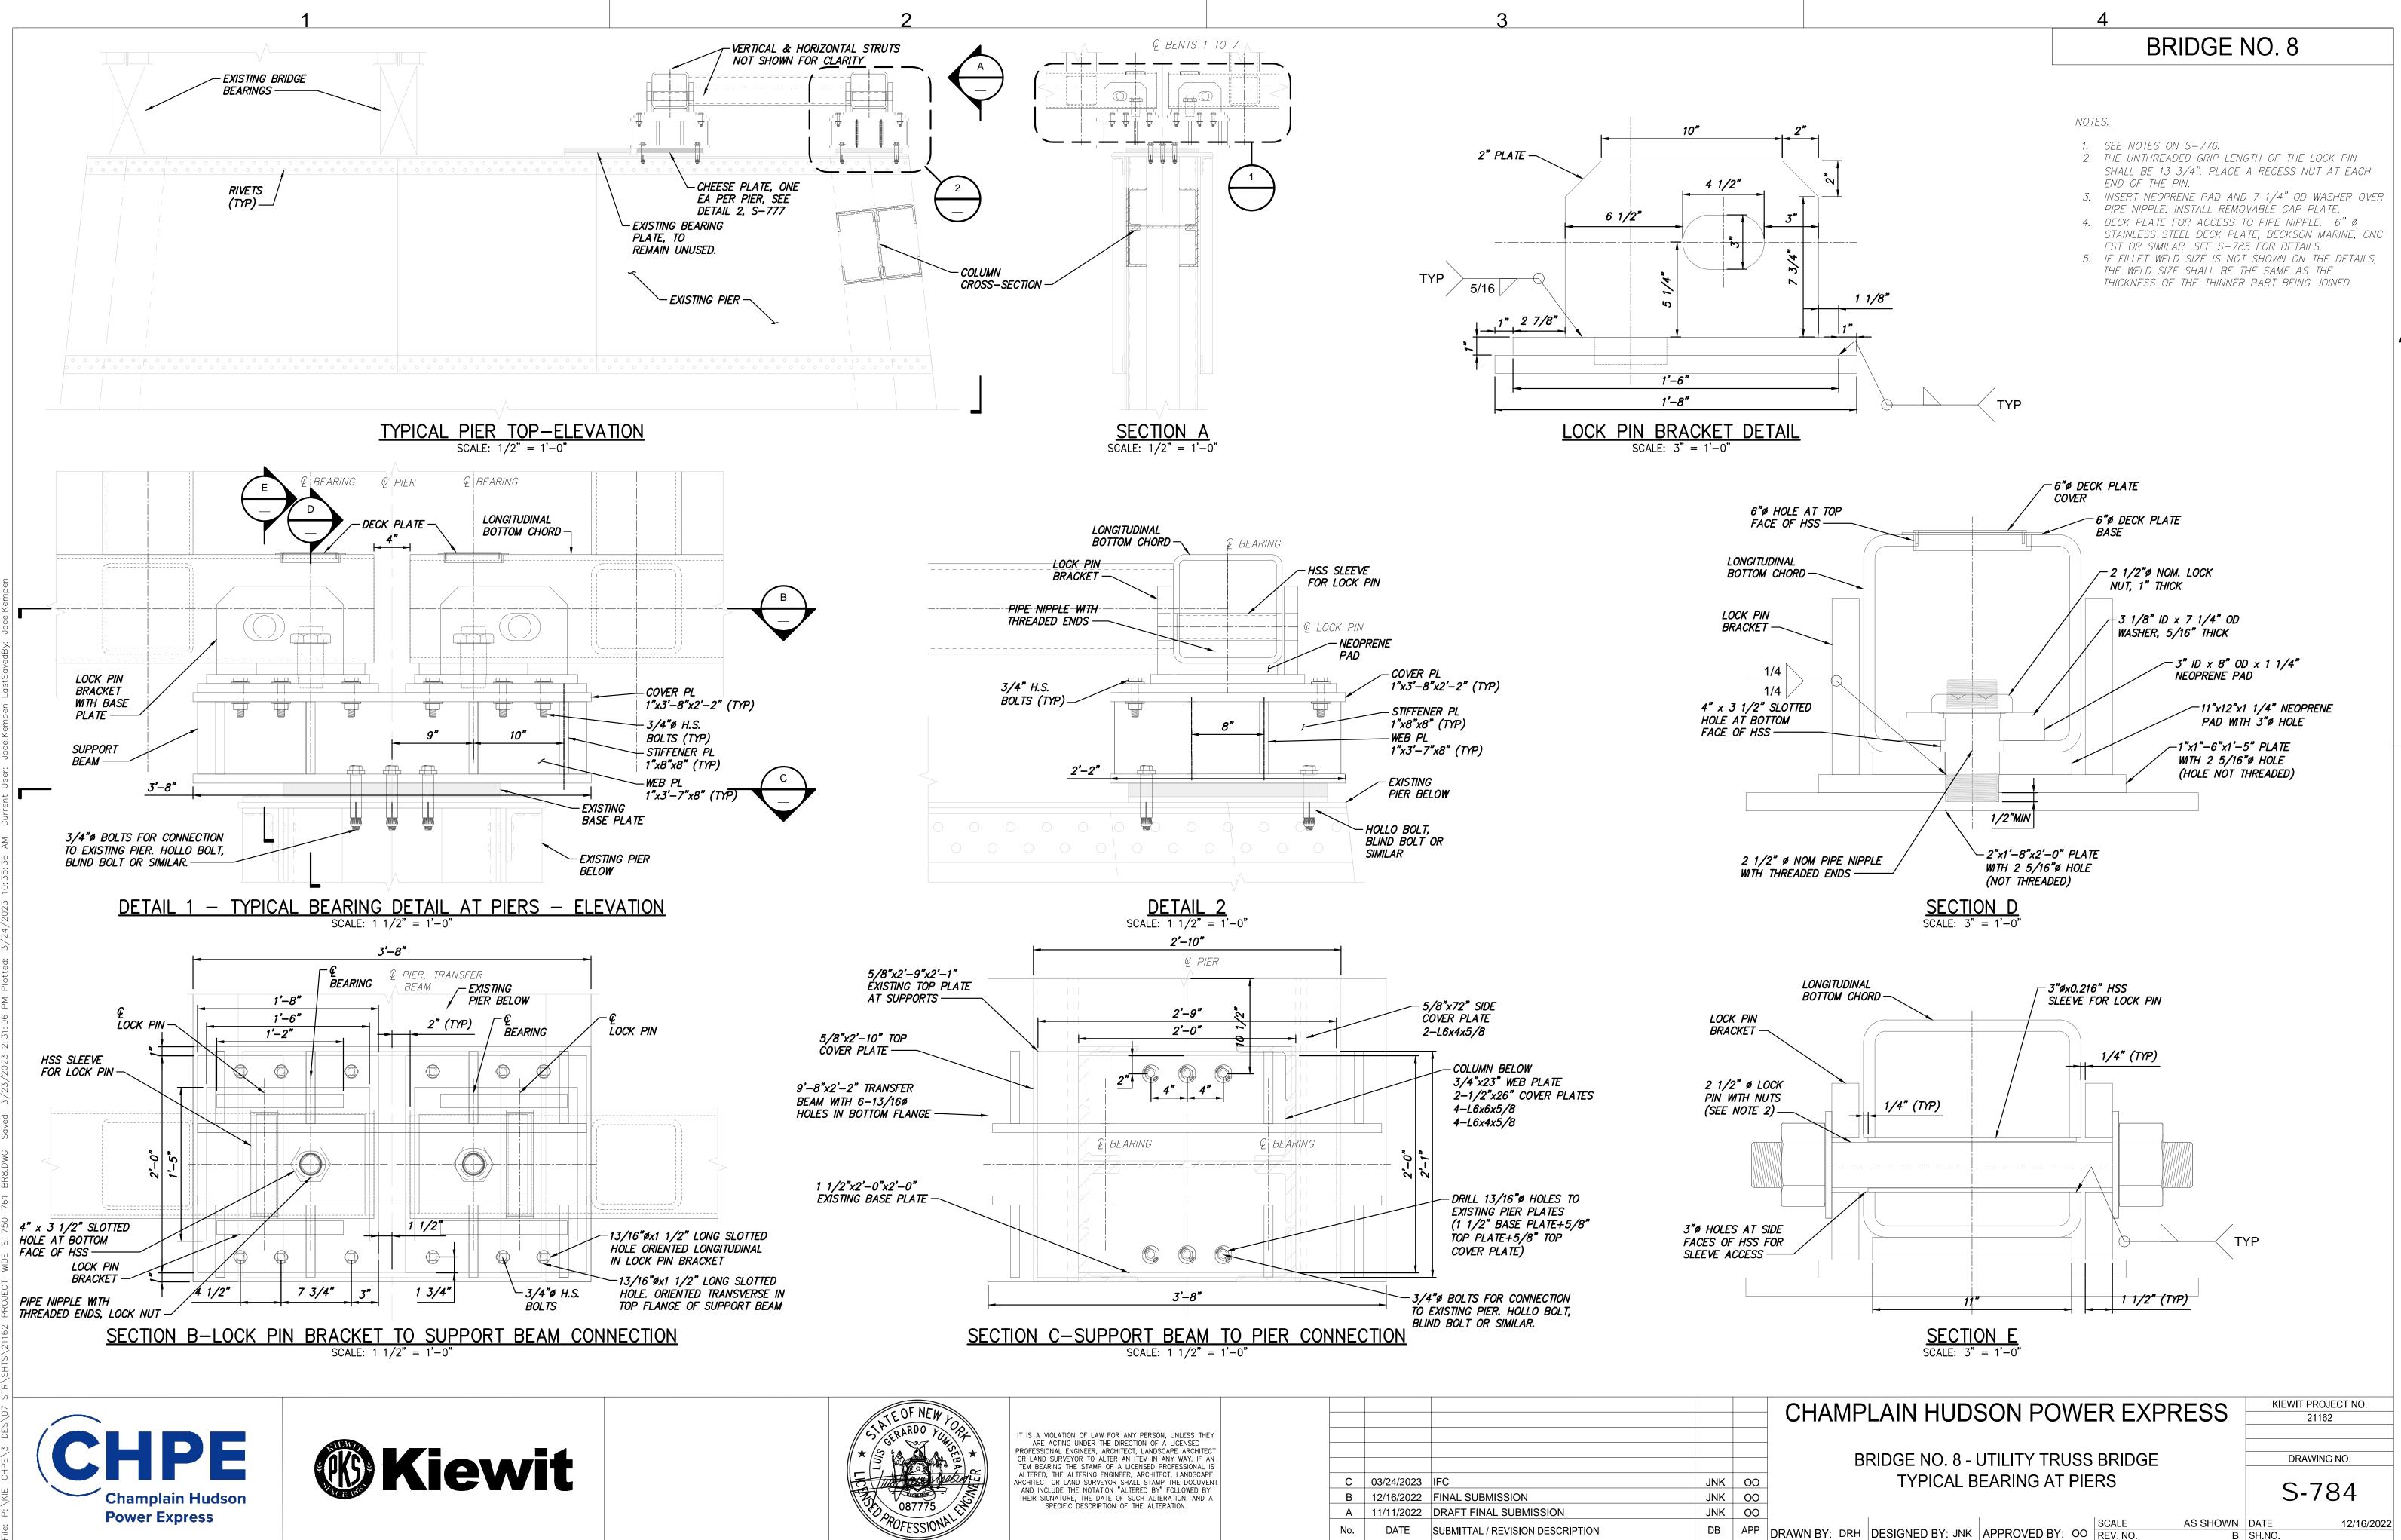

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No.	DATE	SUBMITTAL / REVISION DESCRIPTION	DB	APP	DRA

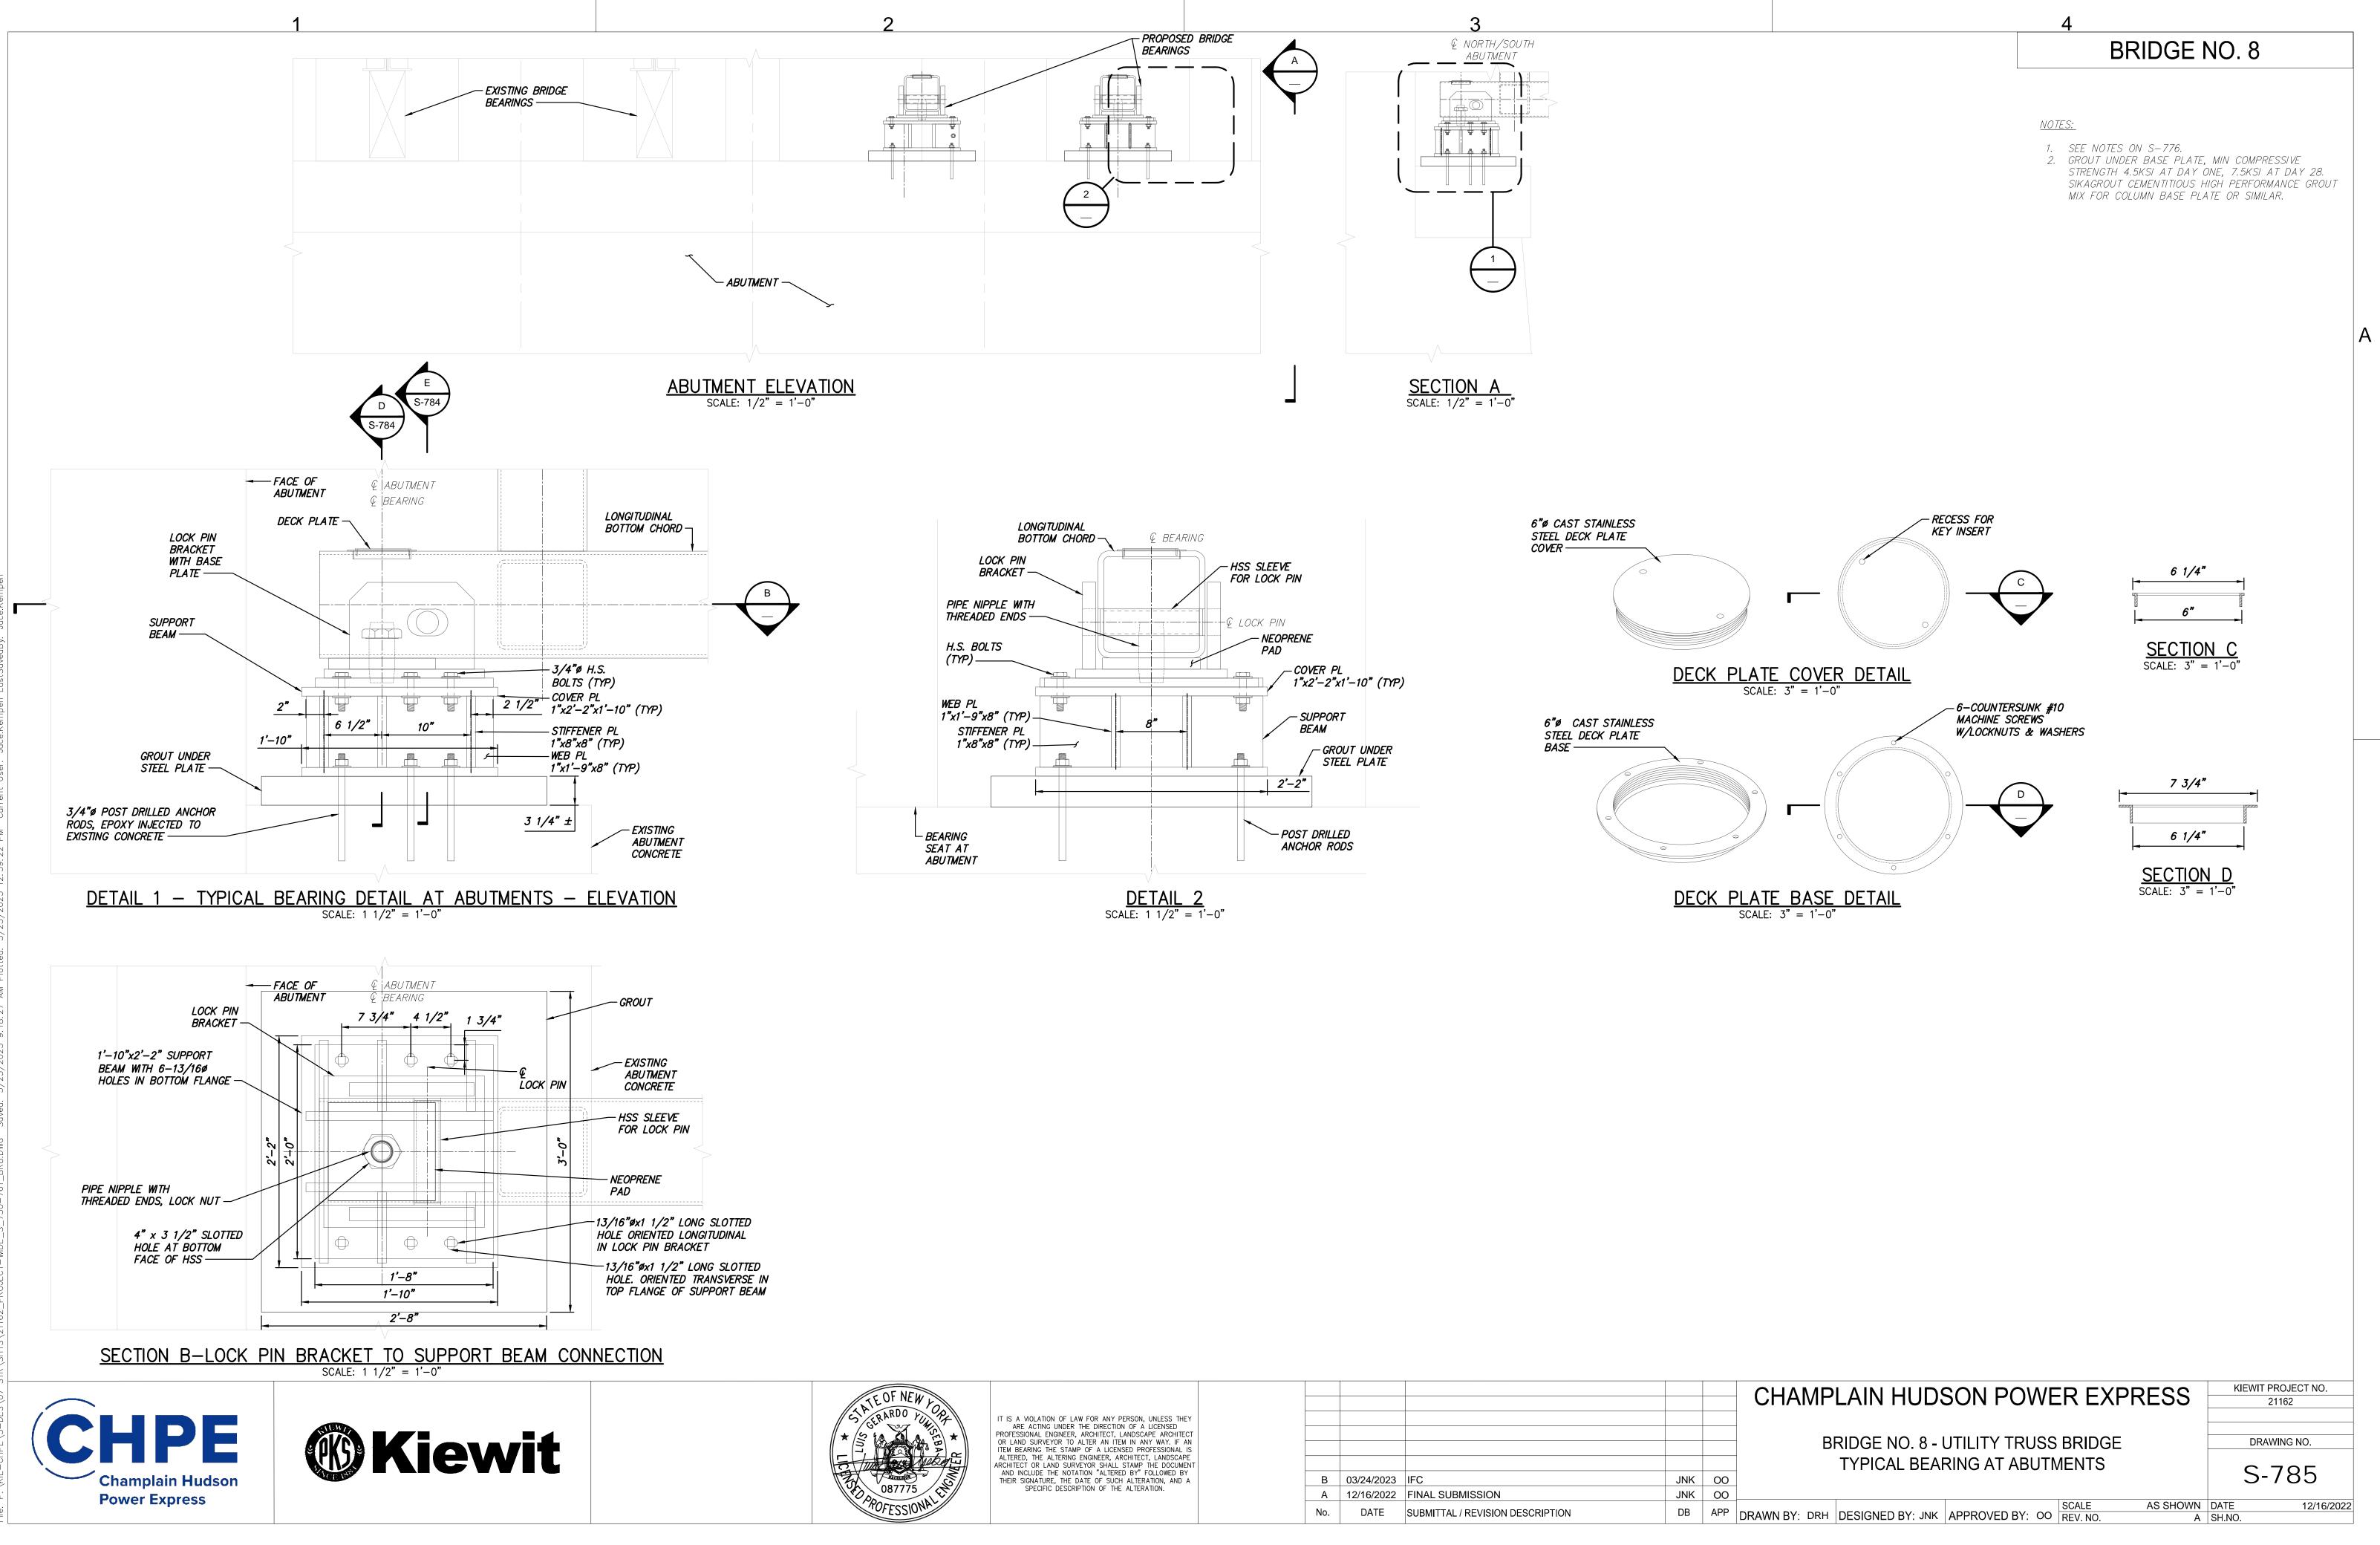

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## PROPOSED BRIDGE-BEARING LAYOUT SCALE: NTS

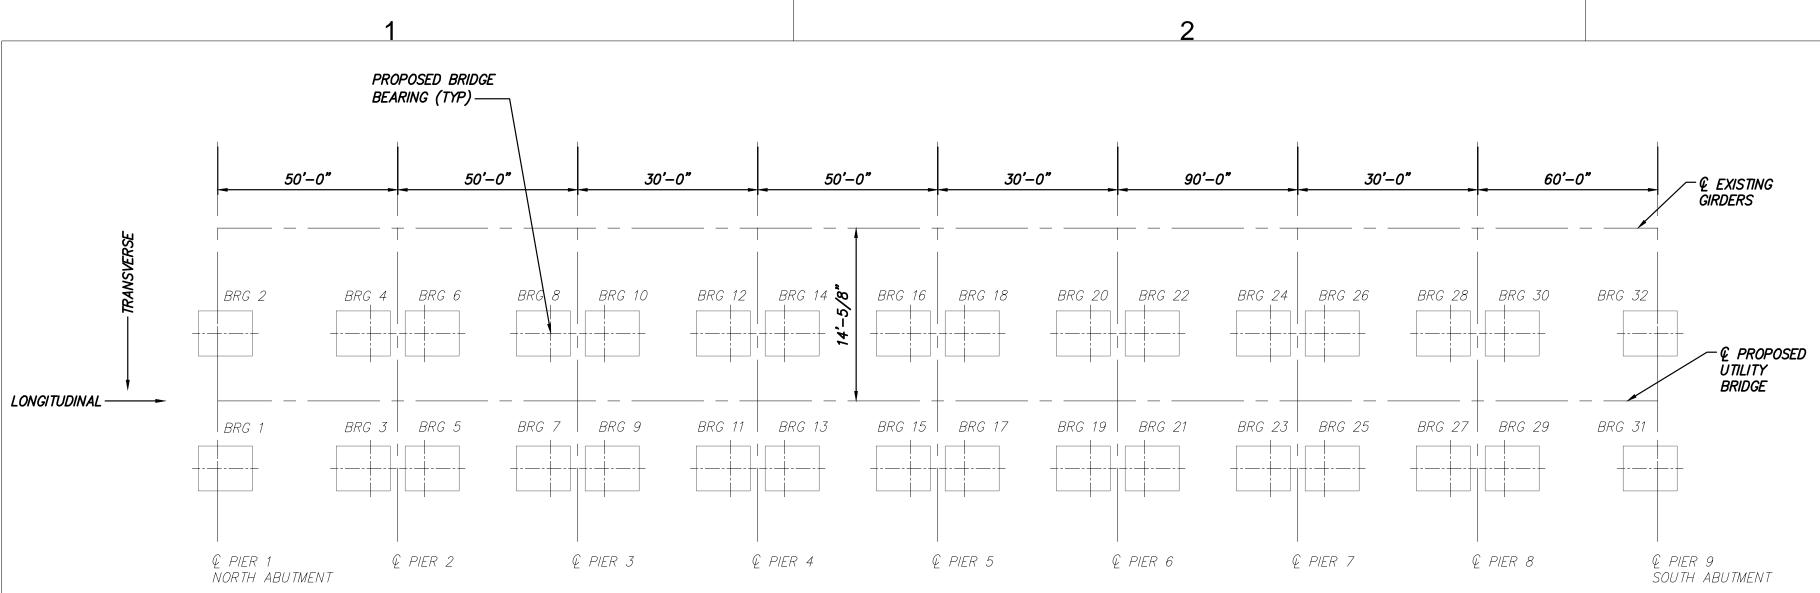SPAN	BEARING LABEL	DEAD LOAD VERTICAL (KIP)	LIVE LOAD VERTICAL (KIP)	SNOW LOAD VERTICAL (KIP)	LONG. WIND VERTICAL (KIP)	LONG. WIND LONGITUDINAL (KIP)	TRAN. WIND VERTICAL (KIP)	TRAN. WIND TRANSVERSE (KIP)
1	1,2,3,4	13.4	4.2	3.5	±0.4	-2.2	±9.3	5.7
2,4	5,6,7,8 13,14,15,16	13.3	4.1	3.4	±0.4	-2.2	±9.1	5.6
3,5,7	9,10,11,12 17,18,19,20 25,26,27,28	7.8	2.4	2.0	±0.4	-1.3	±5.5	3.3
6	21,22,23,24	29.8	7.4	6.2	±0.4	-3.9	±16.5	10.1
8	29,30,31,32	20.8	5.0	4.2	±0.4	-2.6	±11.1	6.8

NOTE:

REACTIONS REPORTED AT PROPOSED BRIDGE BEARING ELEVATION. (NOT AT PIER ELEVATION)

## PROPOSED BRIDGE-BEARING REACTIONS SCALE: NTS

PIER	EXISTING BEARING PLATE THICKNESS
2	2.28"
3	1.68"
4	2.40"
5	1.20"
6	1.20"
7	2.16"
8	1.44"

## EXISTING BRIDGE - BEARING PLATE THICKNESSES

SCALE: NTS


NOTE: EXISTING BEARING PLATE THICKNESSES ESTIMATED BASED ON SURVEY DATA. SHIM PLATES TO BE PROVIDED WHERE NECESSARY TO BRING TRUSS TO GRADE.











SPAN	C-C SUPPORT	BOTTOM CHORD LENGTH	NO OF S
1	49'-3"	50'-5"	4x10
2,4	48'-6"	49'-8"	4x10
3,5,7	28'-6"	29'-8"	4x6
6	88'-6"	89'-8"	4x16
8	59'– <i>3</i> "	60'-5"	4x12

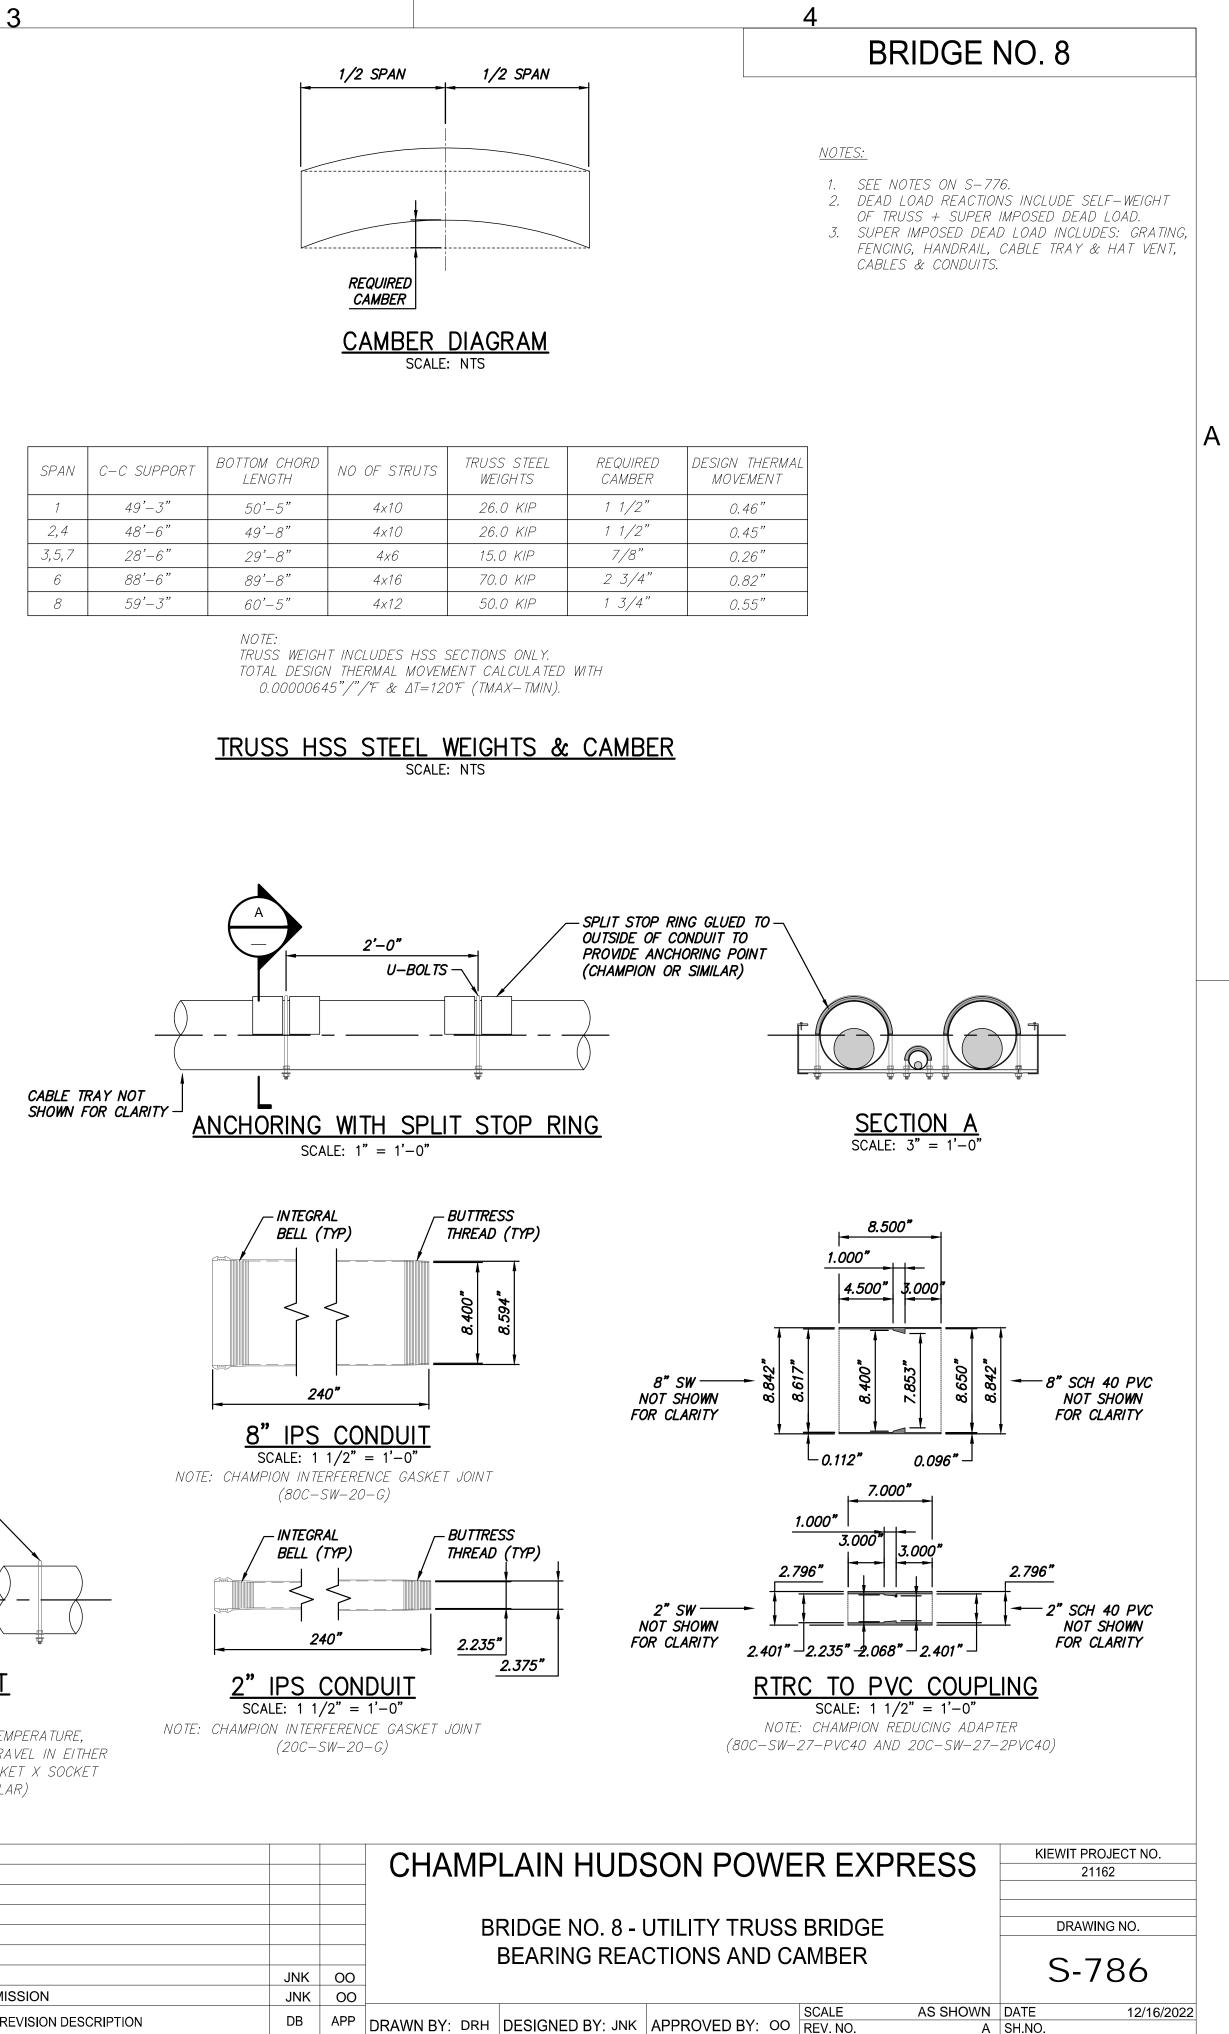

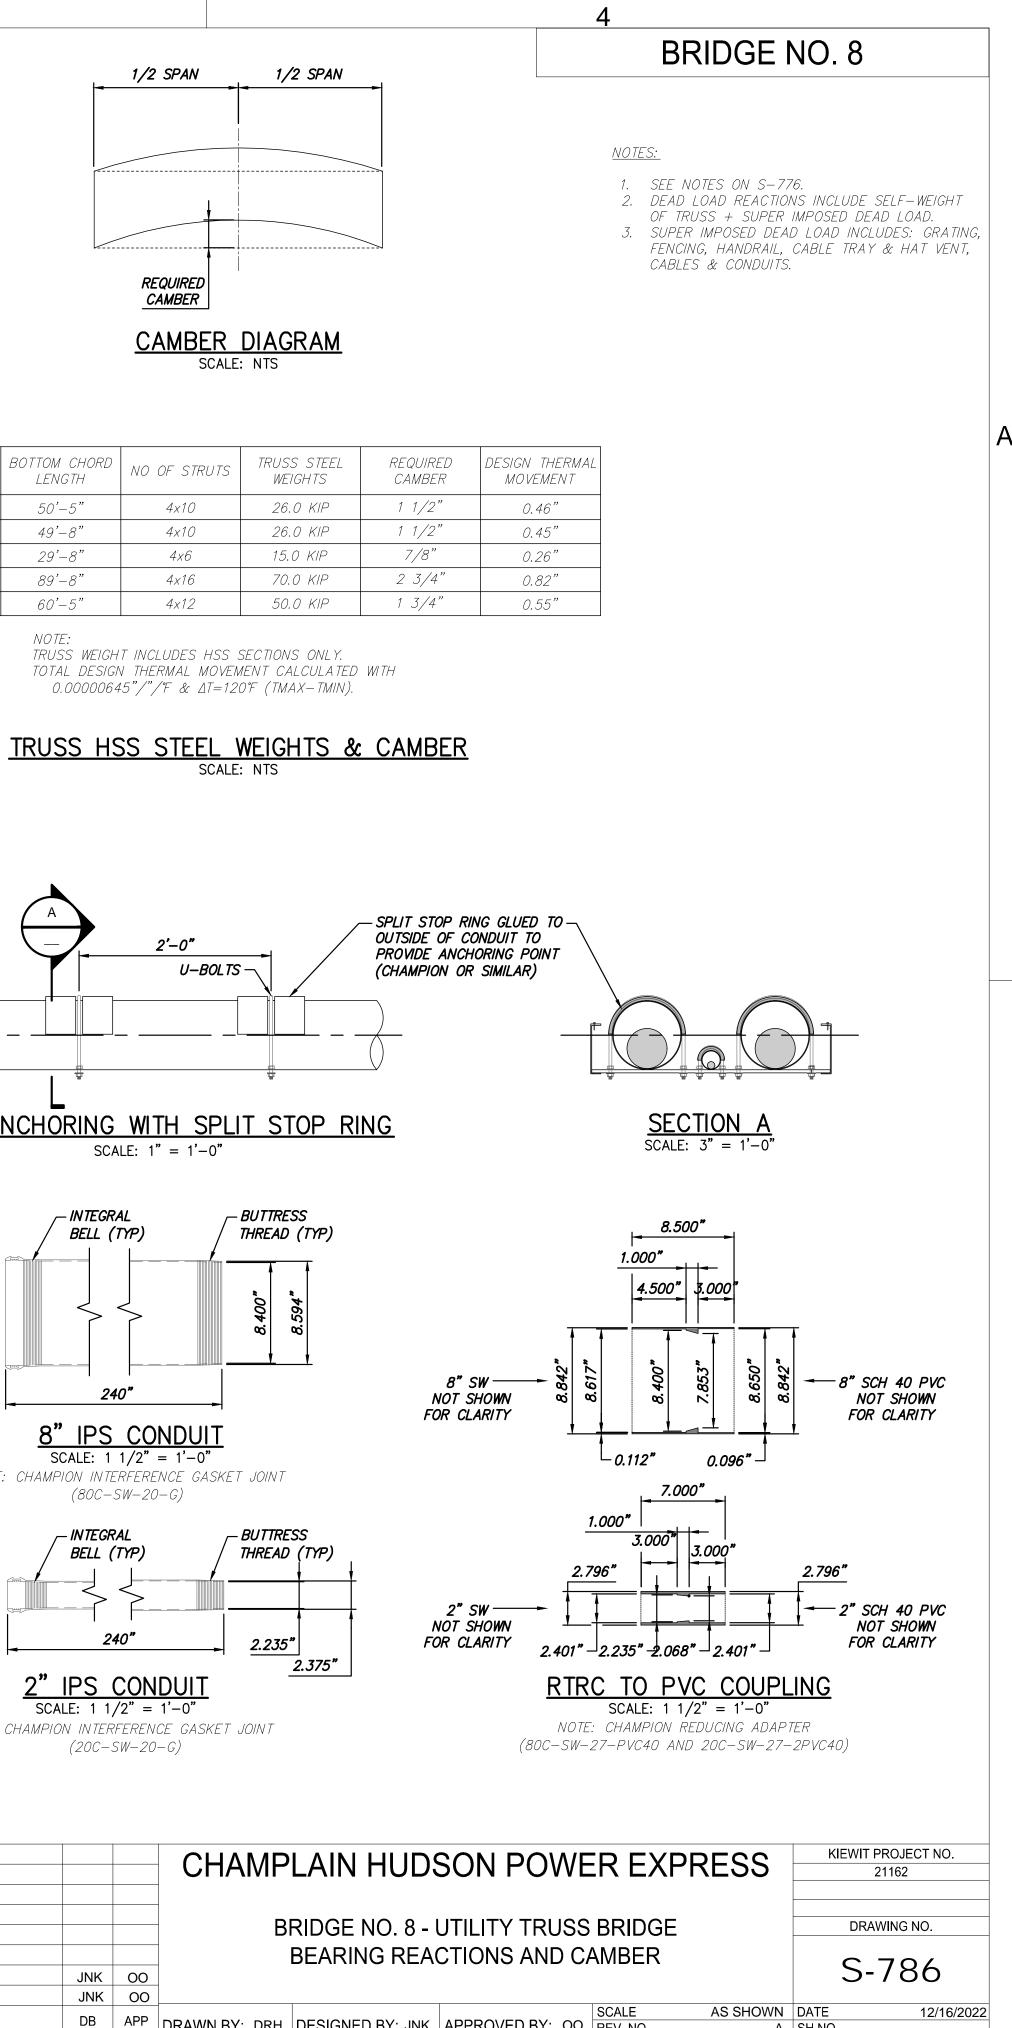

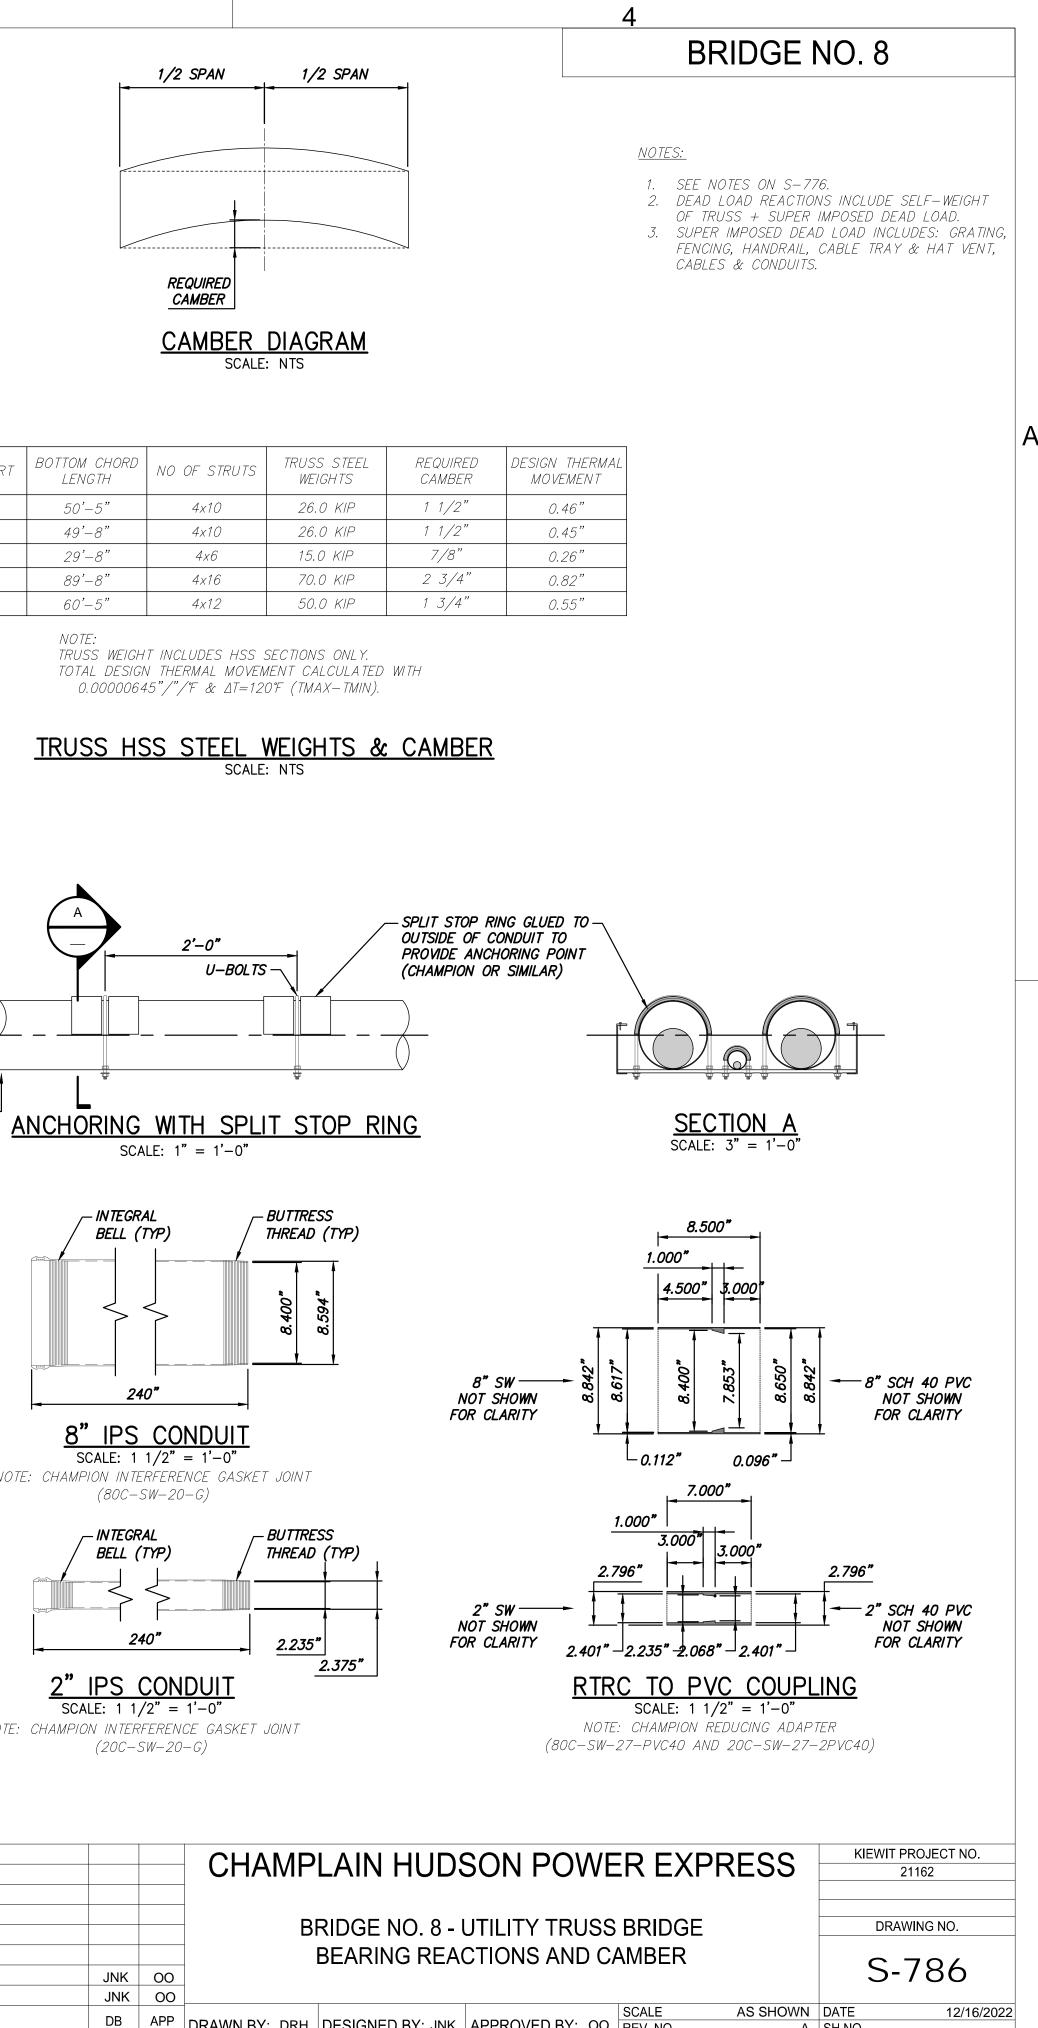

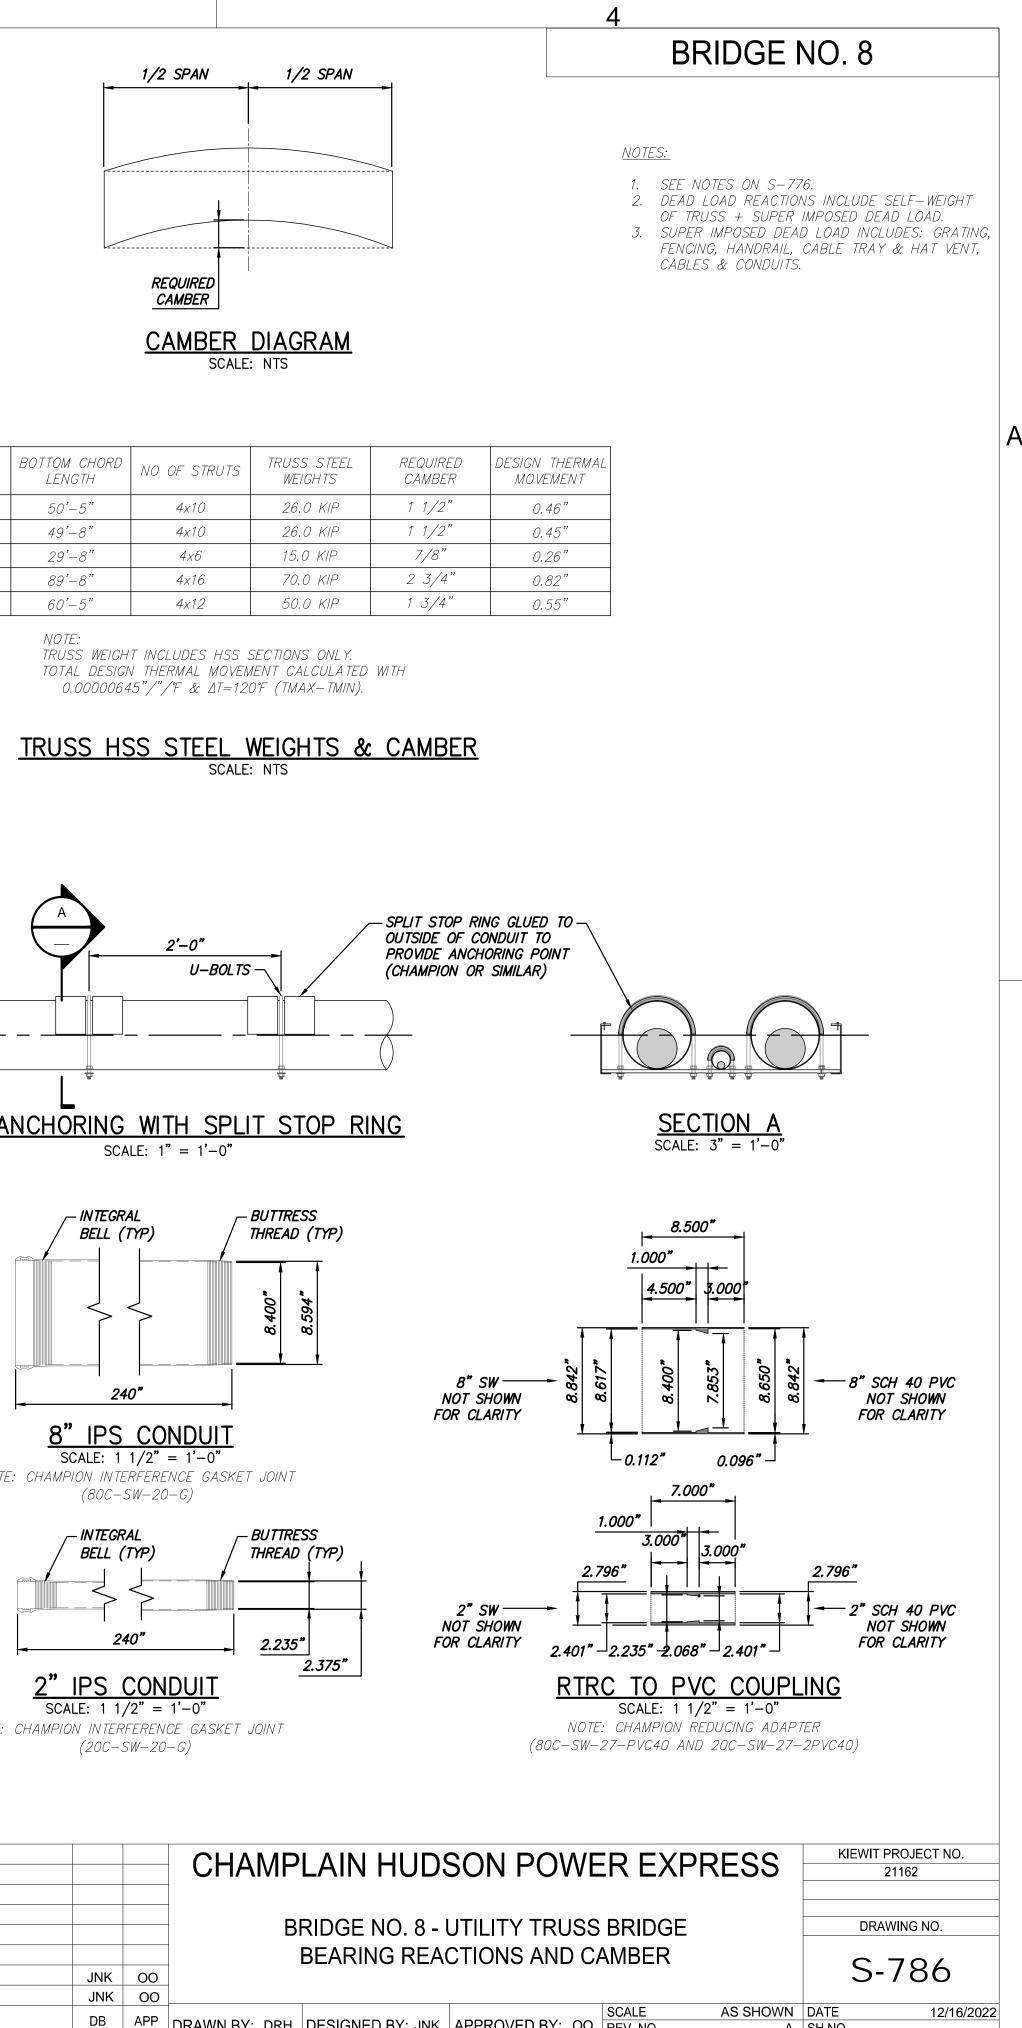

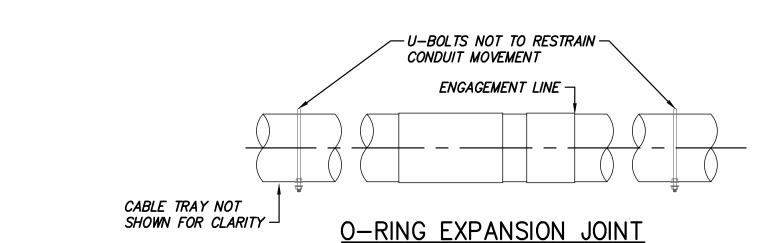



## SCALE: 1'' = 1' - 0''


NOTE: WHEN SET AT ENGAGEMENT LINE POSITION AT SET TEMPERATURE, O-RING EXPANSION JOINT PROVIDES  $6"\pm$  OF FREE TRAVEL IN EITHER DIRECTION. (CHAMPION SINGLE EXPANSION JOINT SOCKET X SOCKET WITH O-RING : 80C-SW-37 & 20C-SW-37, OR SIMILAR)

WHER *	IT IS A VIOLATION OF LAW FOR ANY PERSON, UNLESS THEY ARE ACTING UNDER THE DIRECTION OF A LICENSED PROFESSIONAL ENGINEER, ARCHITECT, LANDSCAPE ARCHITECT OR LAND SURVEYOR TO ALTER AN ITEM IN ANY WAY. IF AN ITEM BEARING THE STAMP OF A LICENSED PROFESSIONAL IS ALTERED, THE ALTERING ENGINEER, ARCHITECT, LANDSCAPE ARCHITECT OR LAND SURVEYOR SHALL STAMP THE DOCUMENT AND INCLUDE THE NOTATION "ALTERED BY" FOLLOWED BY THEIR SIGNATURE, THE DATE OF SUCH ALTERATION, AND A SPECIFIC DESCRIPTION OF THE ALTERATION.	
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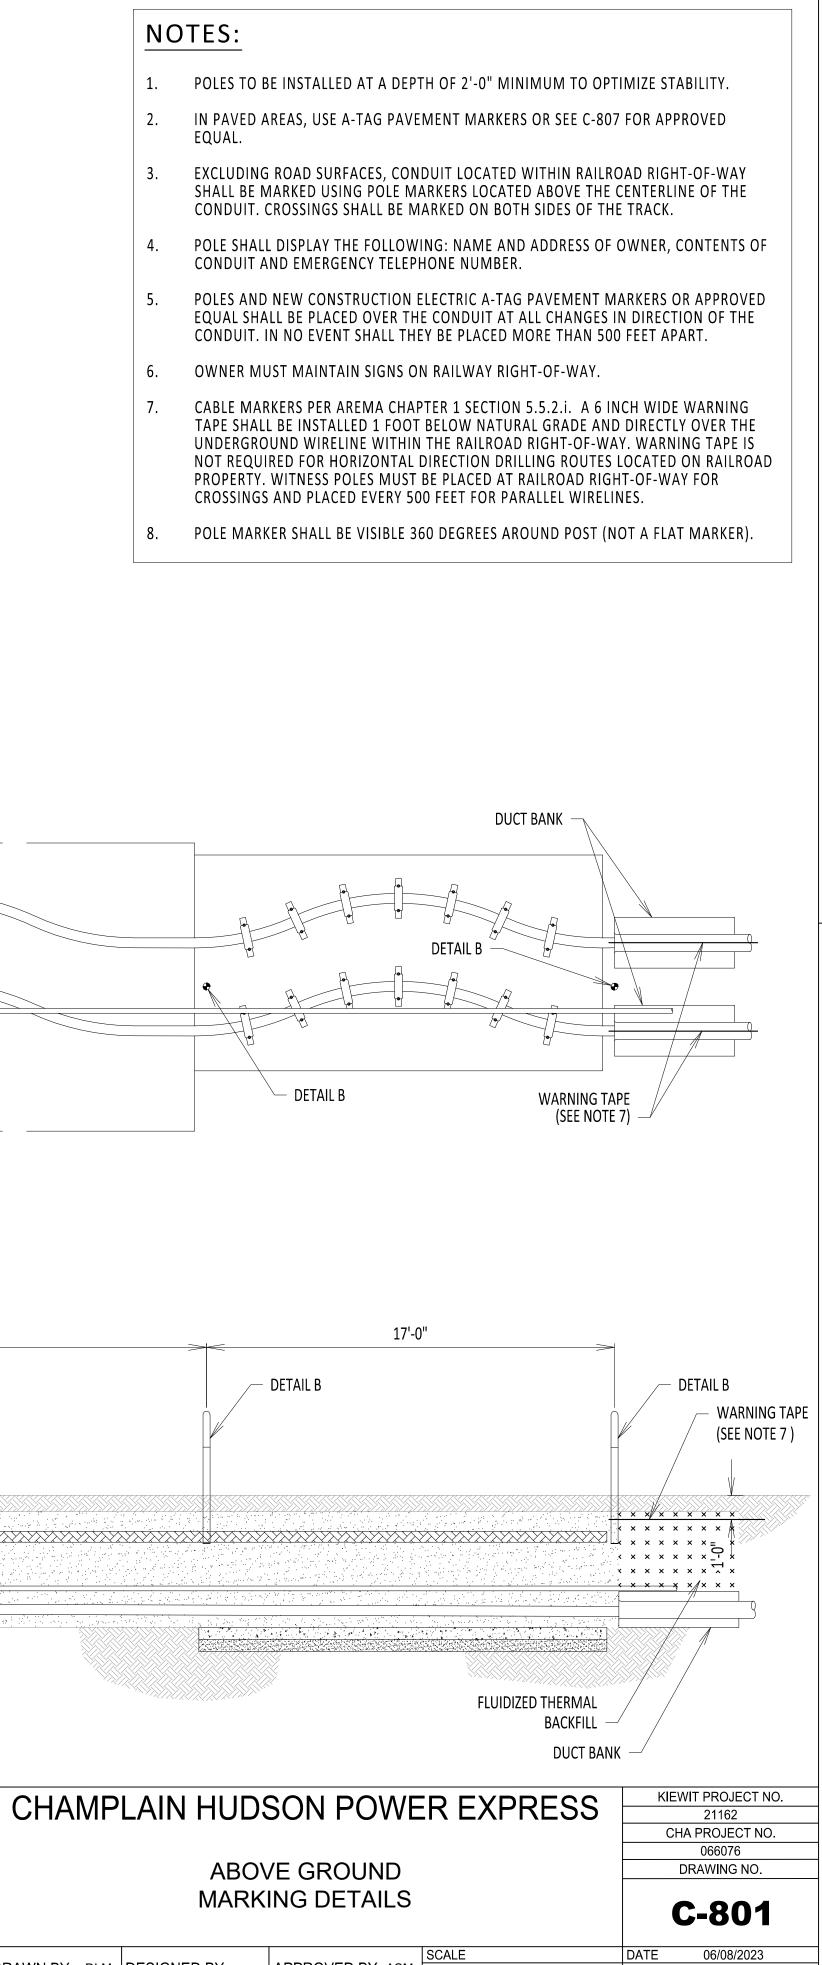
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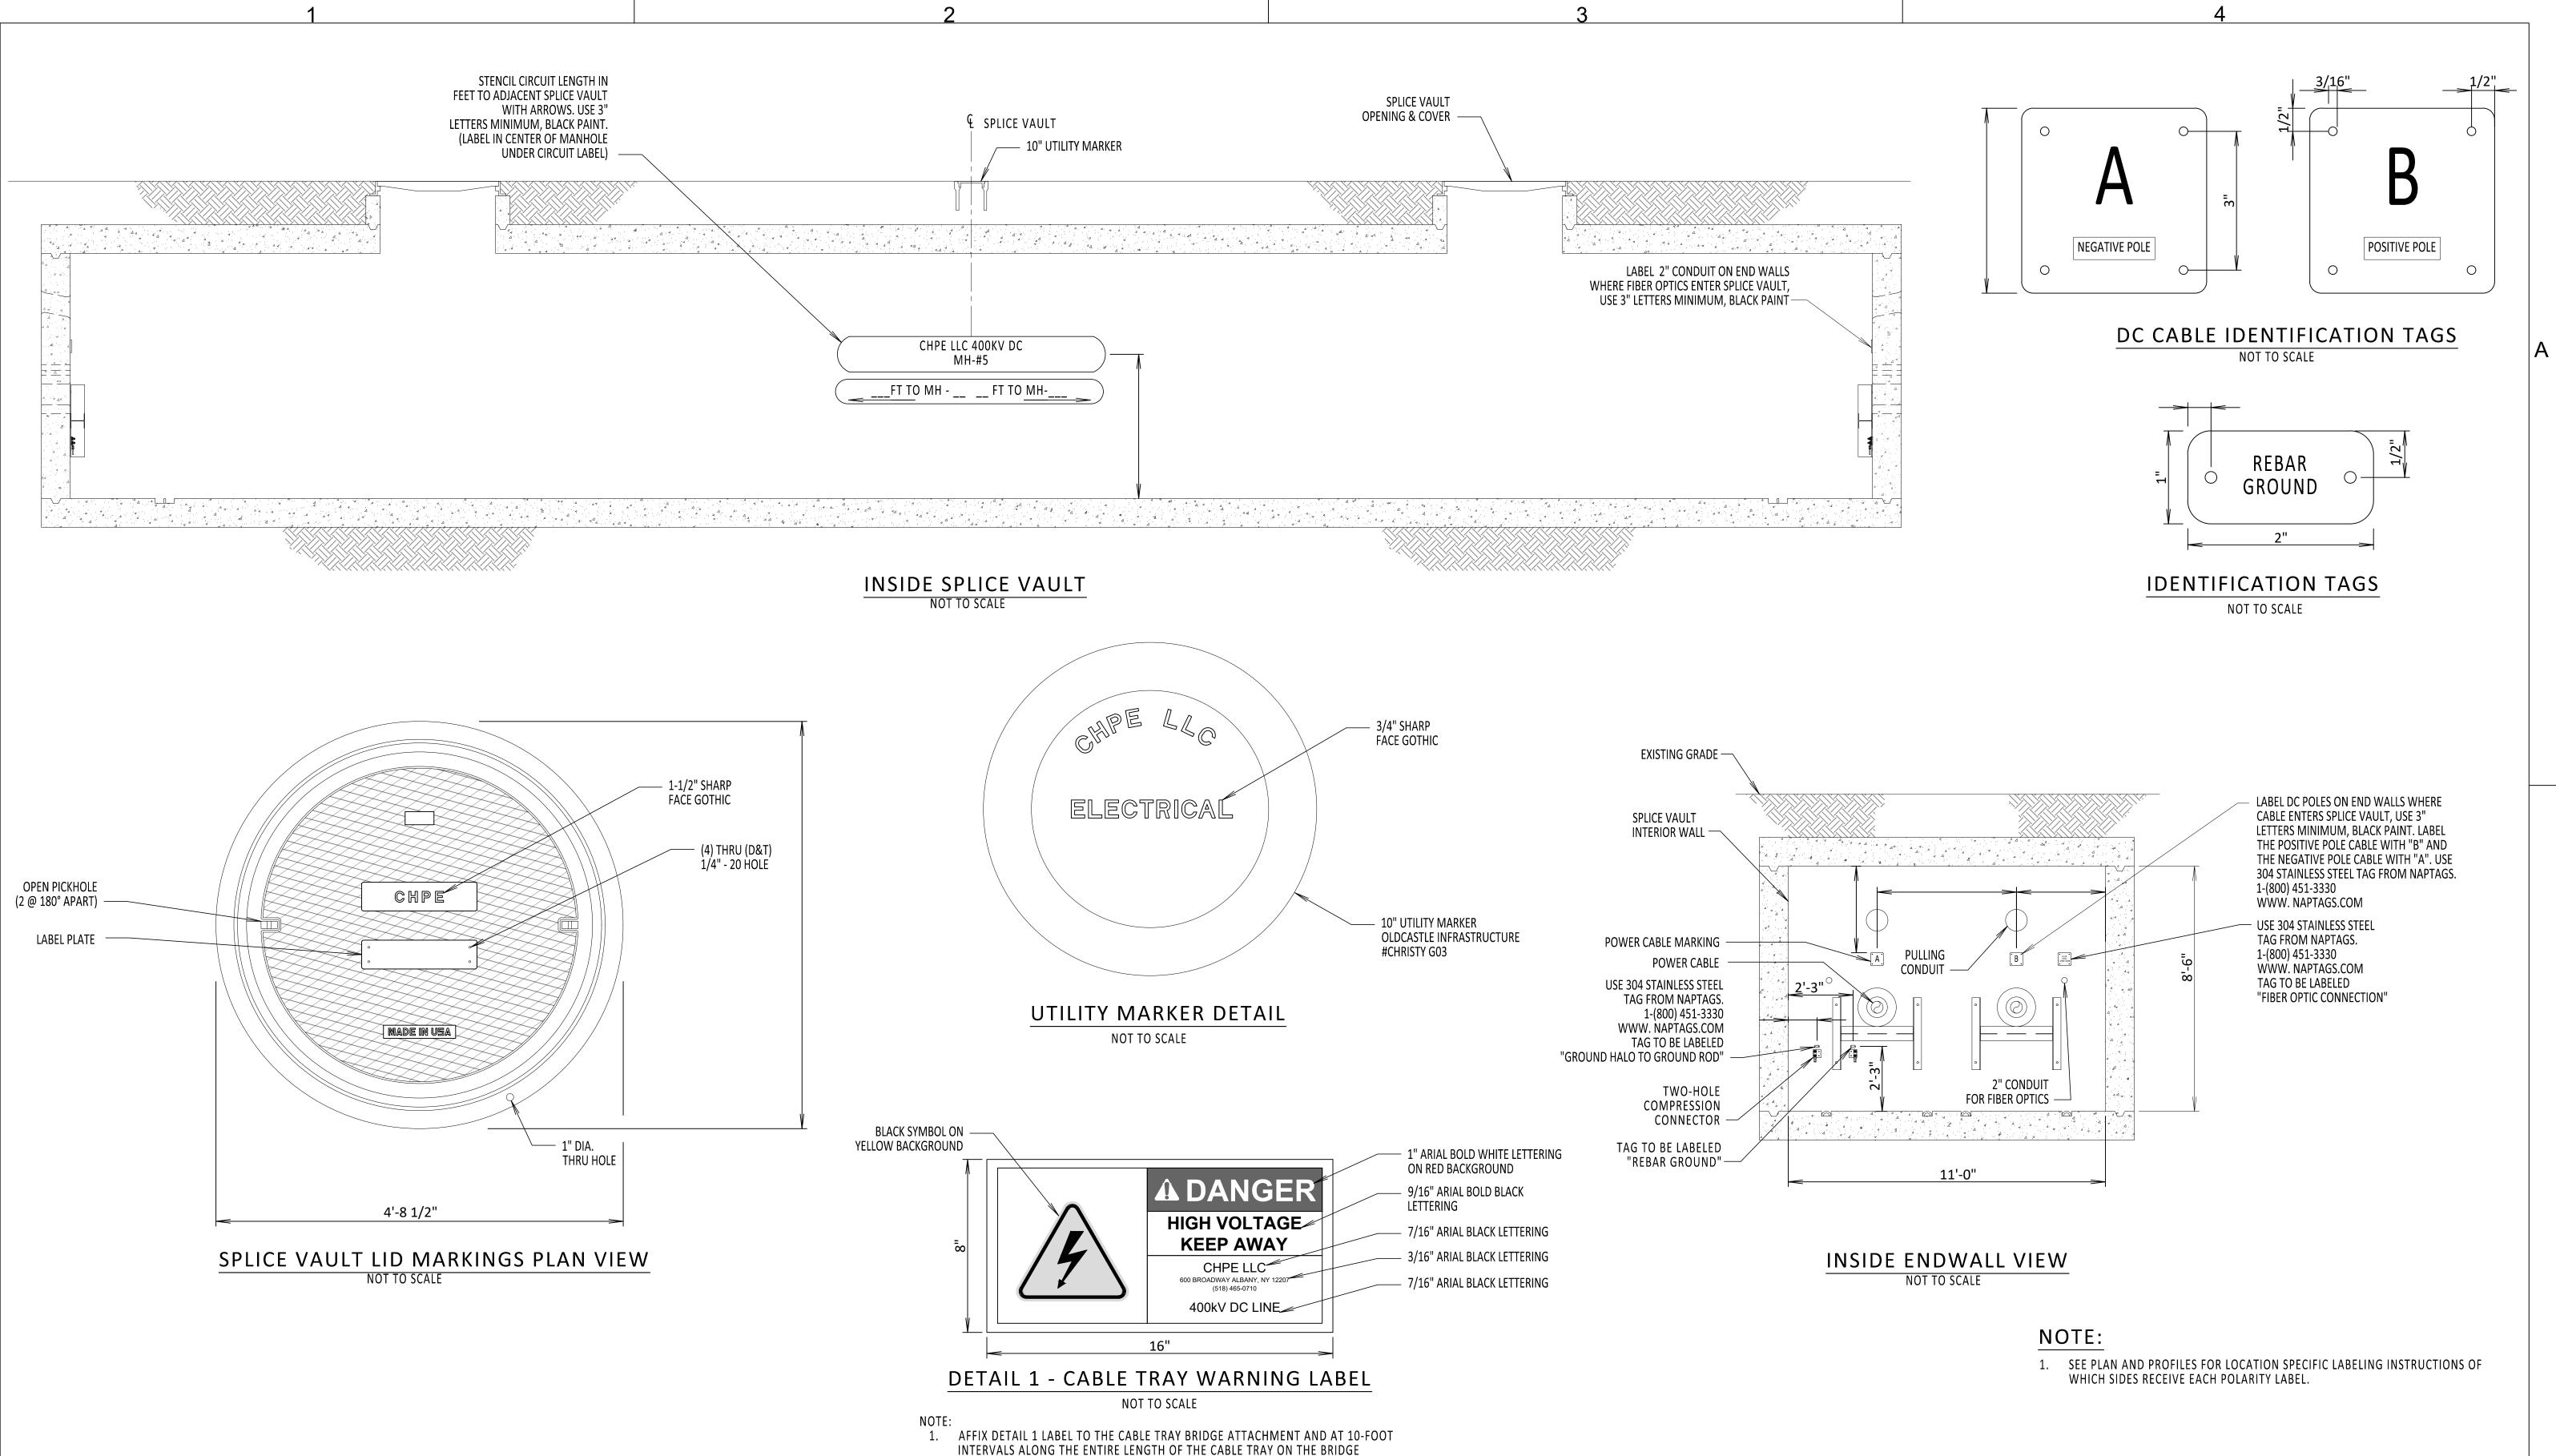


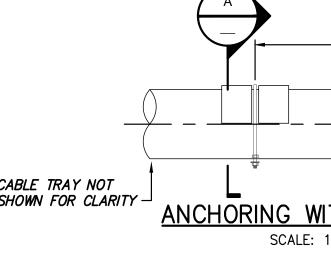

### APPROVED BY: ASM REV. NO. DB APP DRAWN BY: DLM DESIGNED BY:

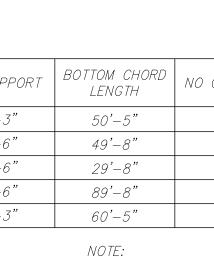OF

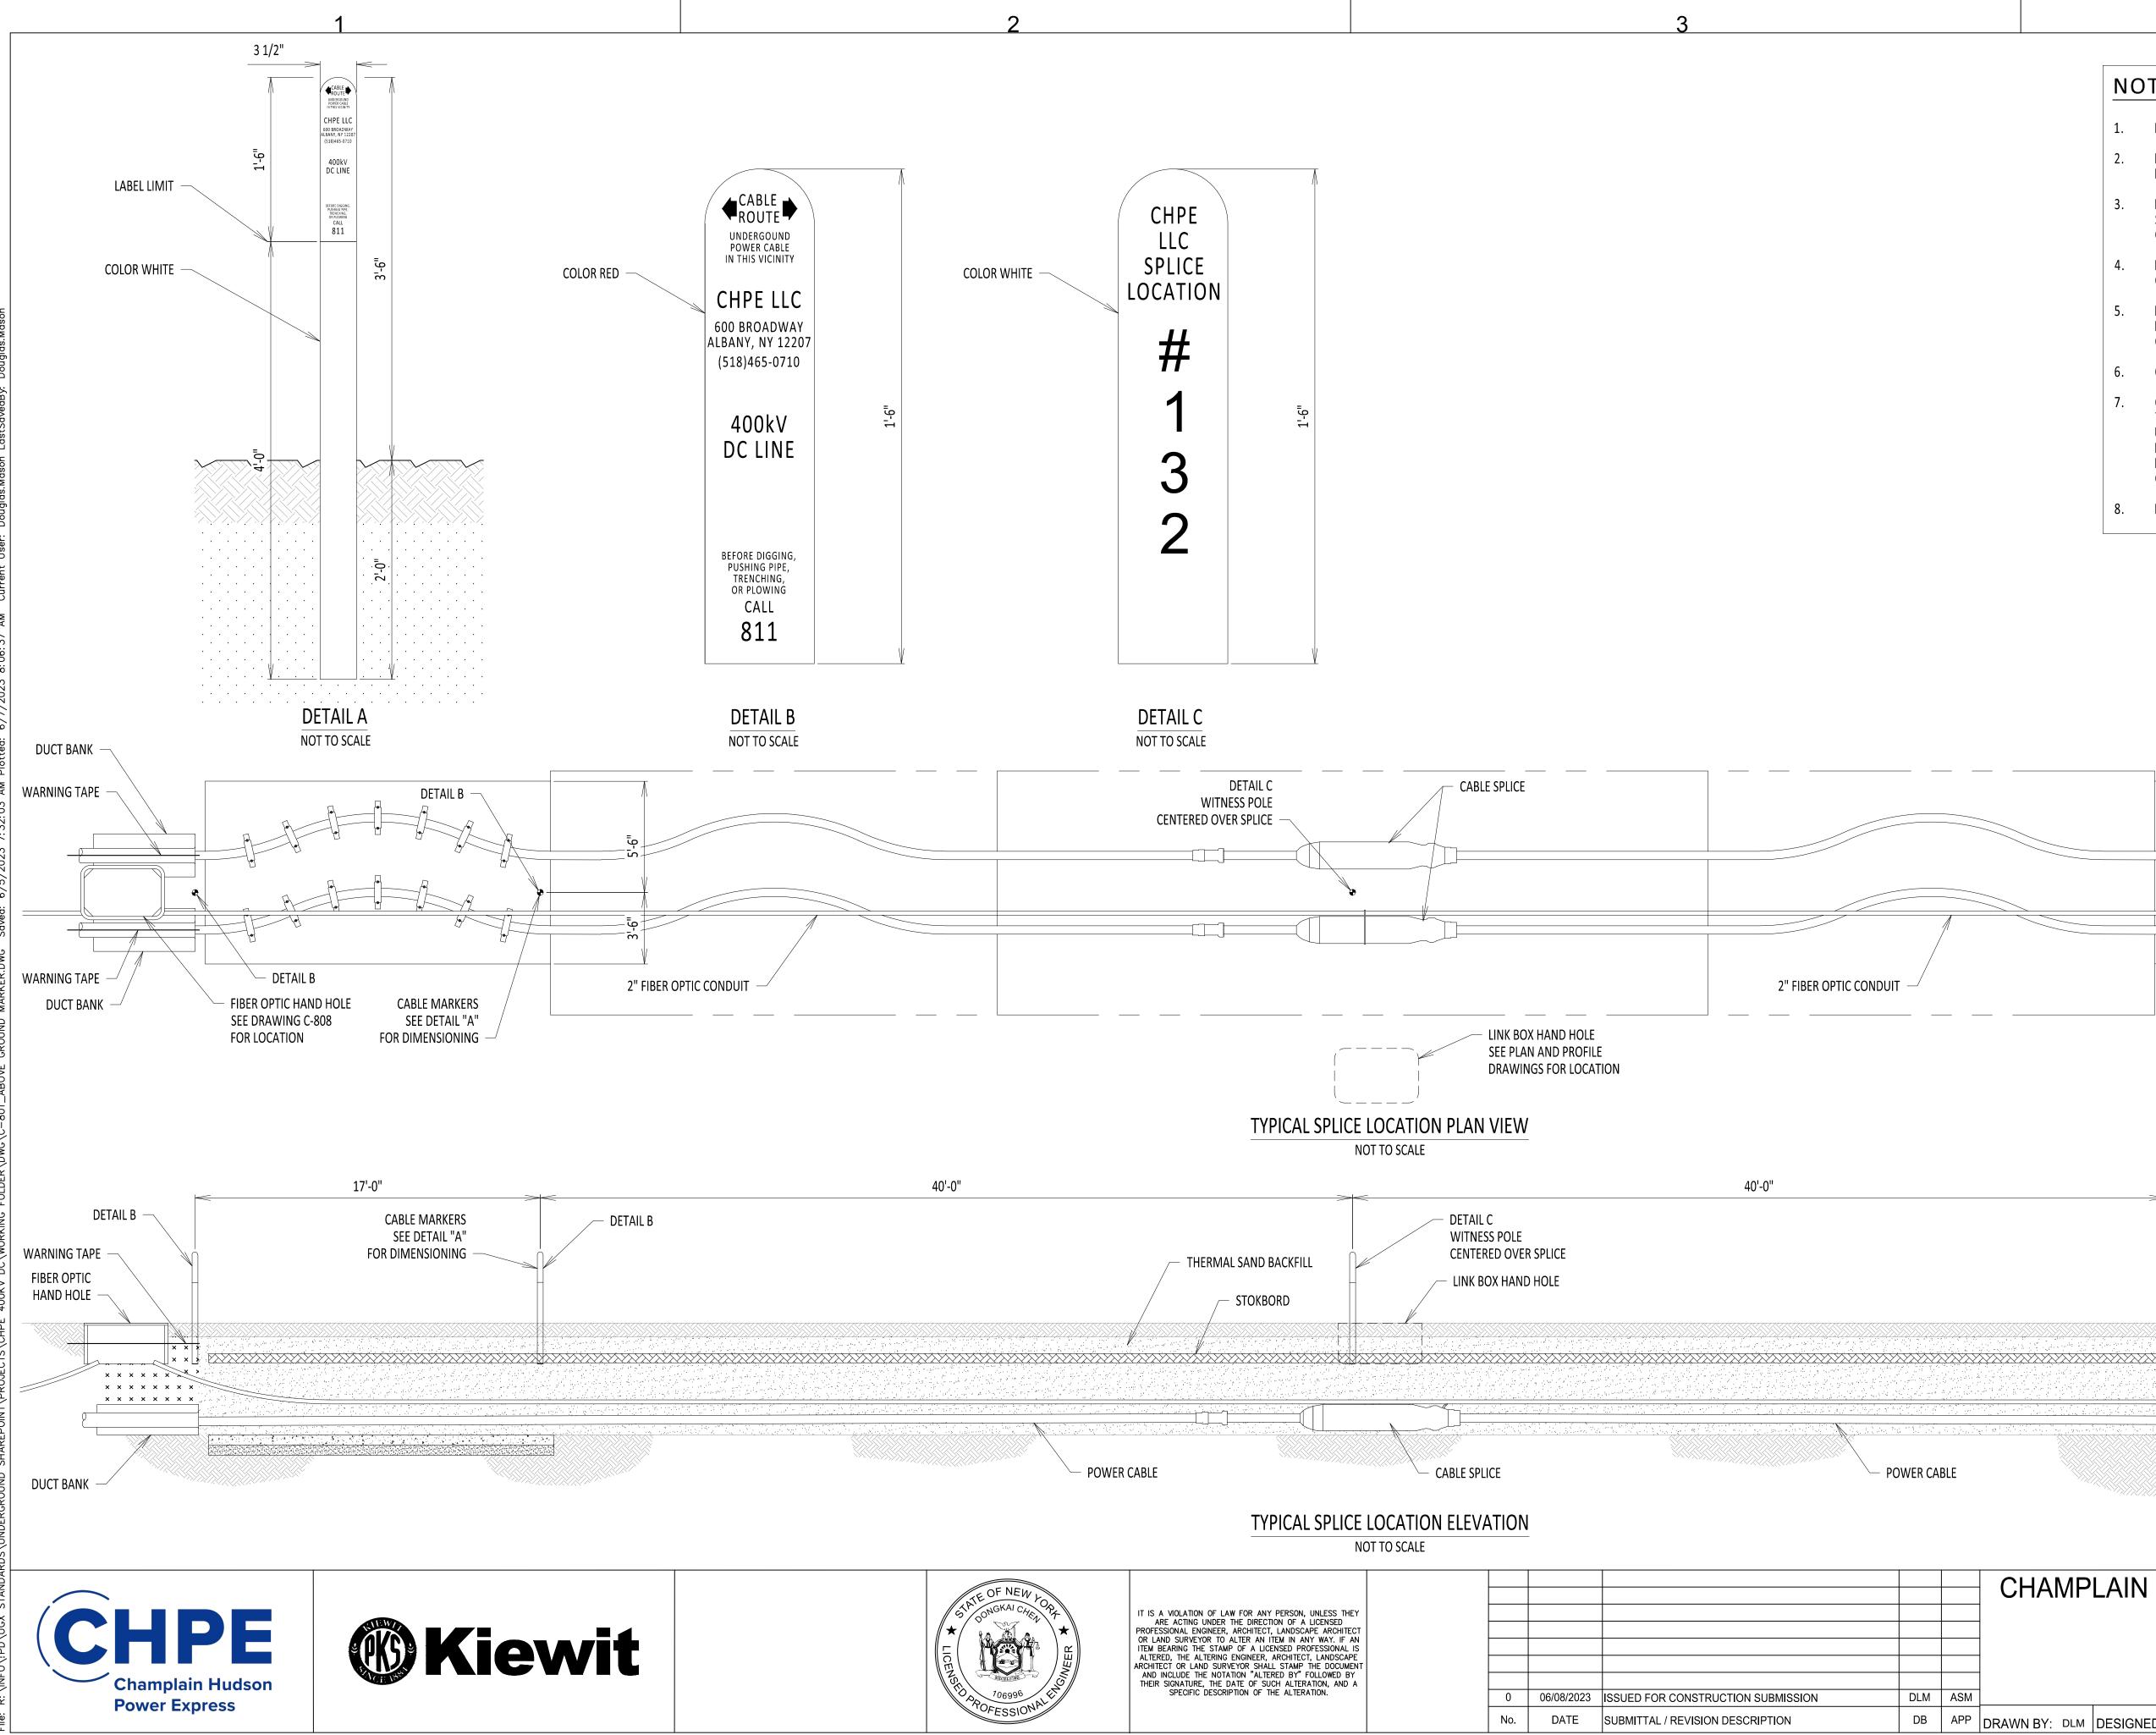0 SH.NO.






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RECEIPTION CONTRACTOR	AND INCLUDE THE NOTATION "ALTERED BY" FOLLOWED BY							
106096	THEIR SIGNATURE, THE DATE OF SUCH ALTERATION, AND A SPECIFIC DESCRIPTION OF THE ALTERATION.		0	06/08/2023	ISSUED FOR CONSTRUCTION SUBMISSION	DLM	ASM	
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						•	KIEW	T PROJECT NO.	
	CHAMPLAIN HUDSON POWER EXPRESS						21162		
							CHA	PROJECT NO.	
								066076	
SPLICE VAULT AND CABLE MARKING DETAILS						DRAWING NO.			
							С	-807	
					SCALE		DATE	06/08/2023	
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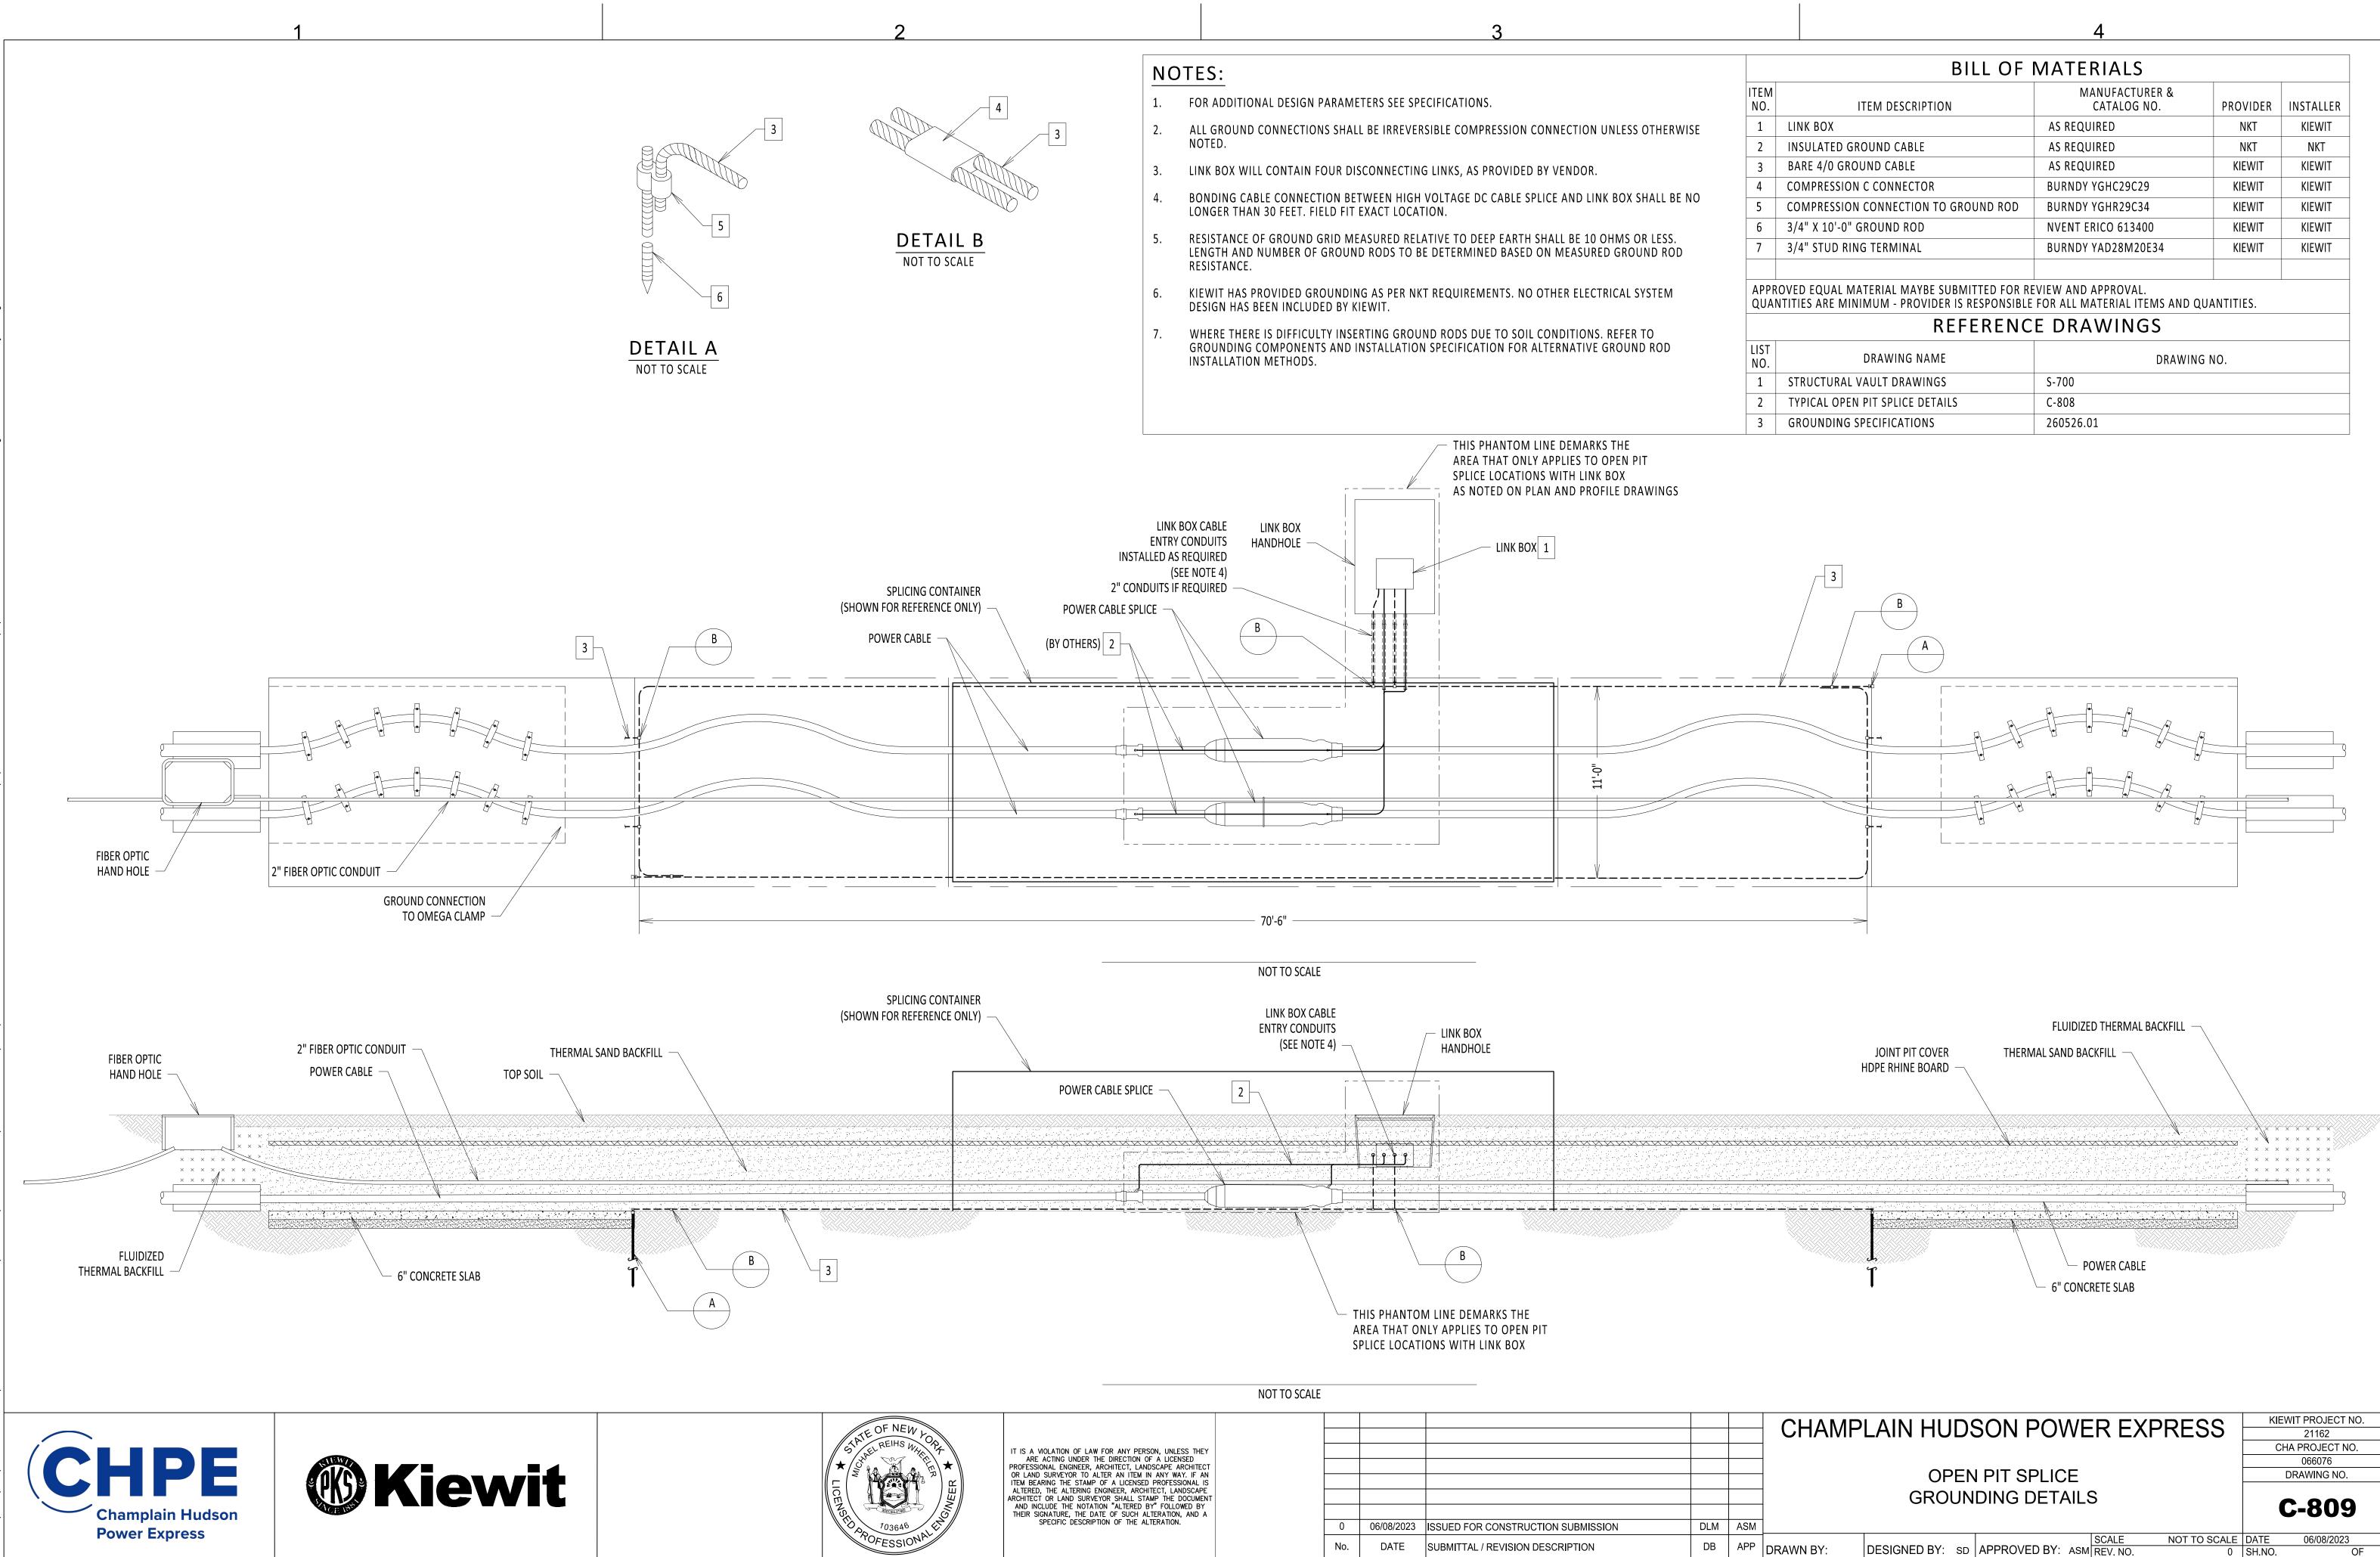


No. DATE SUBMITTAL / REVISION DESCRIPTION

	REFERENCE DUCUMENTS						
LIST NO.	DOCUMENT NAME	DOCUMENT NO.					
1	TYPICAL OPEN PIT GROUNDING DETAILS	C-809					
2	OPEN VAULT HAND HOLE	C-853					
3	FIBER OPTIC HAND HOLE DETAILS	C-854					
4	FIBER OPTIC SPLICE DETAILS	C-855					
5	TRENCHING AND BACKFILLING SPEC.	312333					

0 SH.NO.

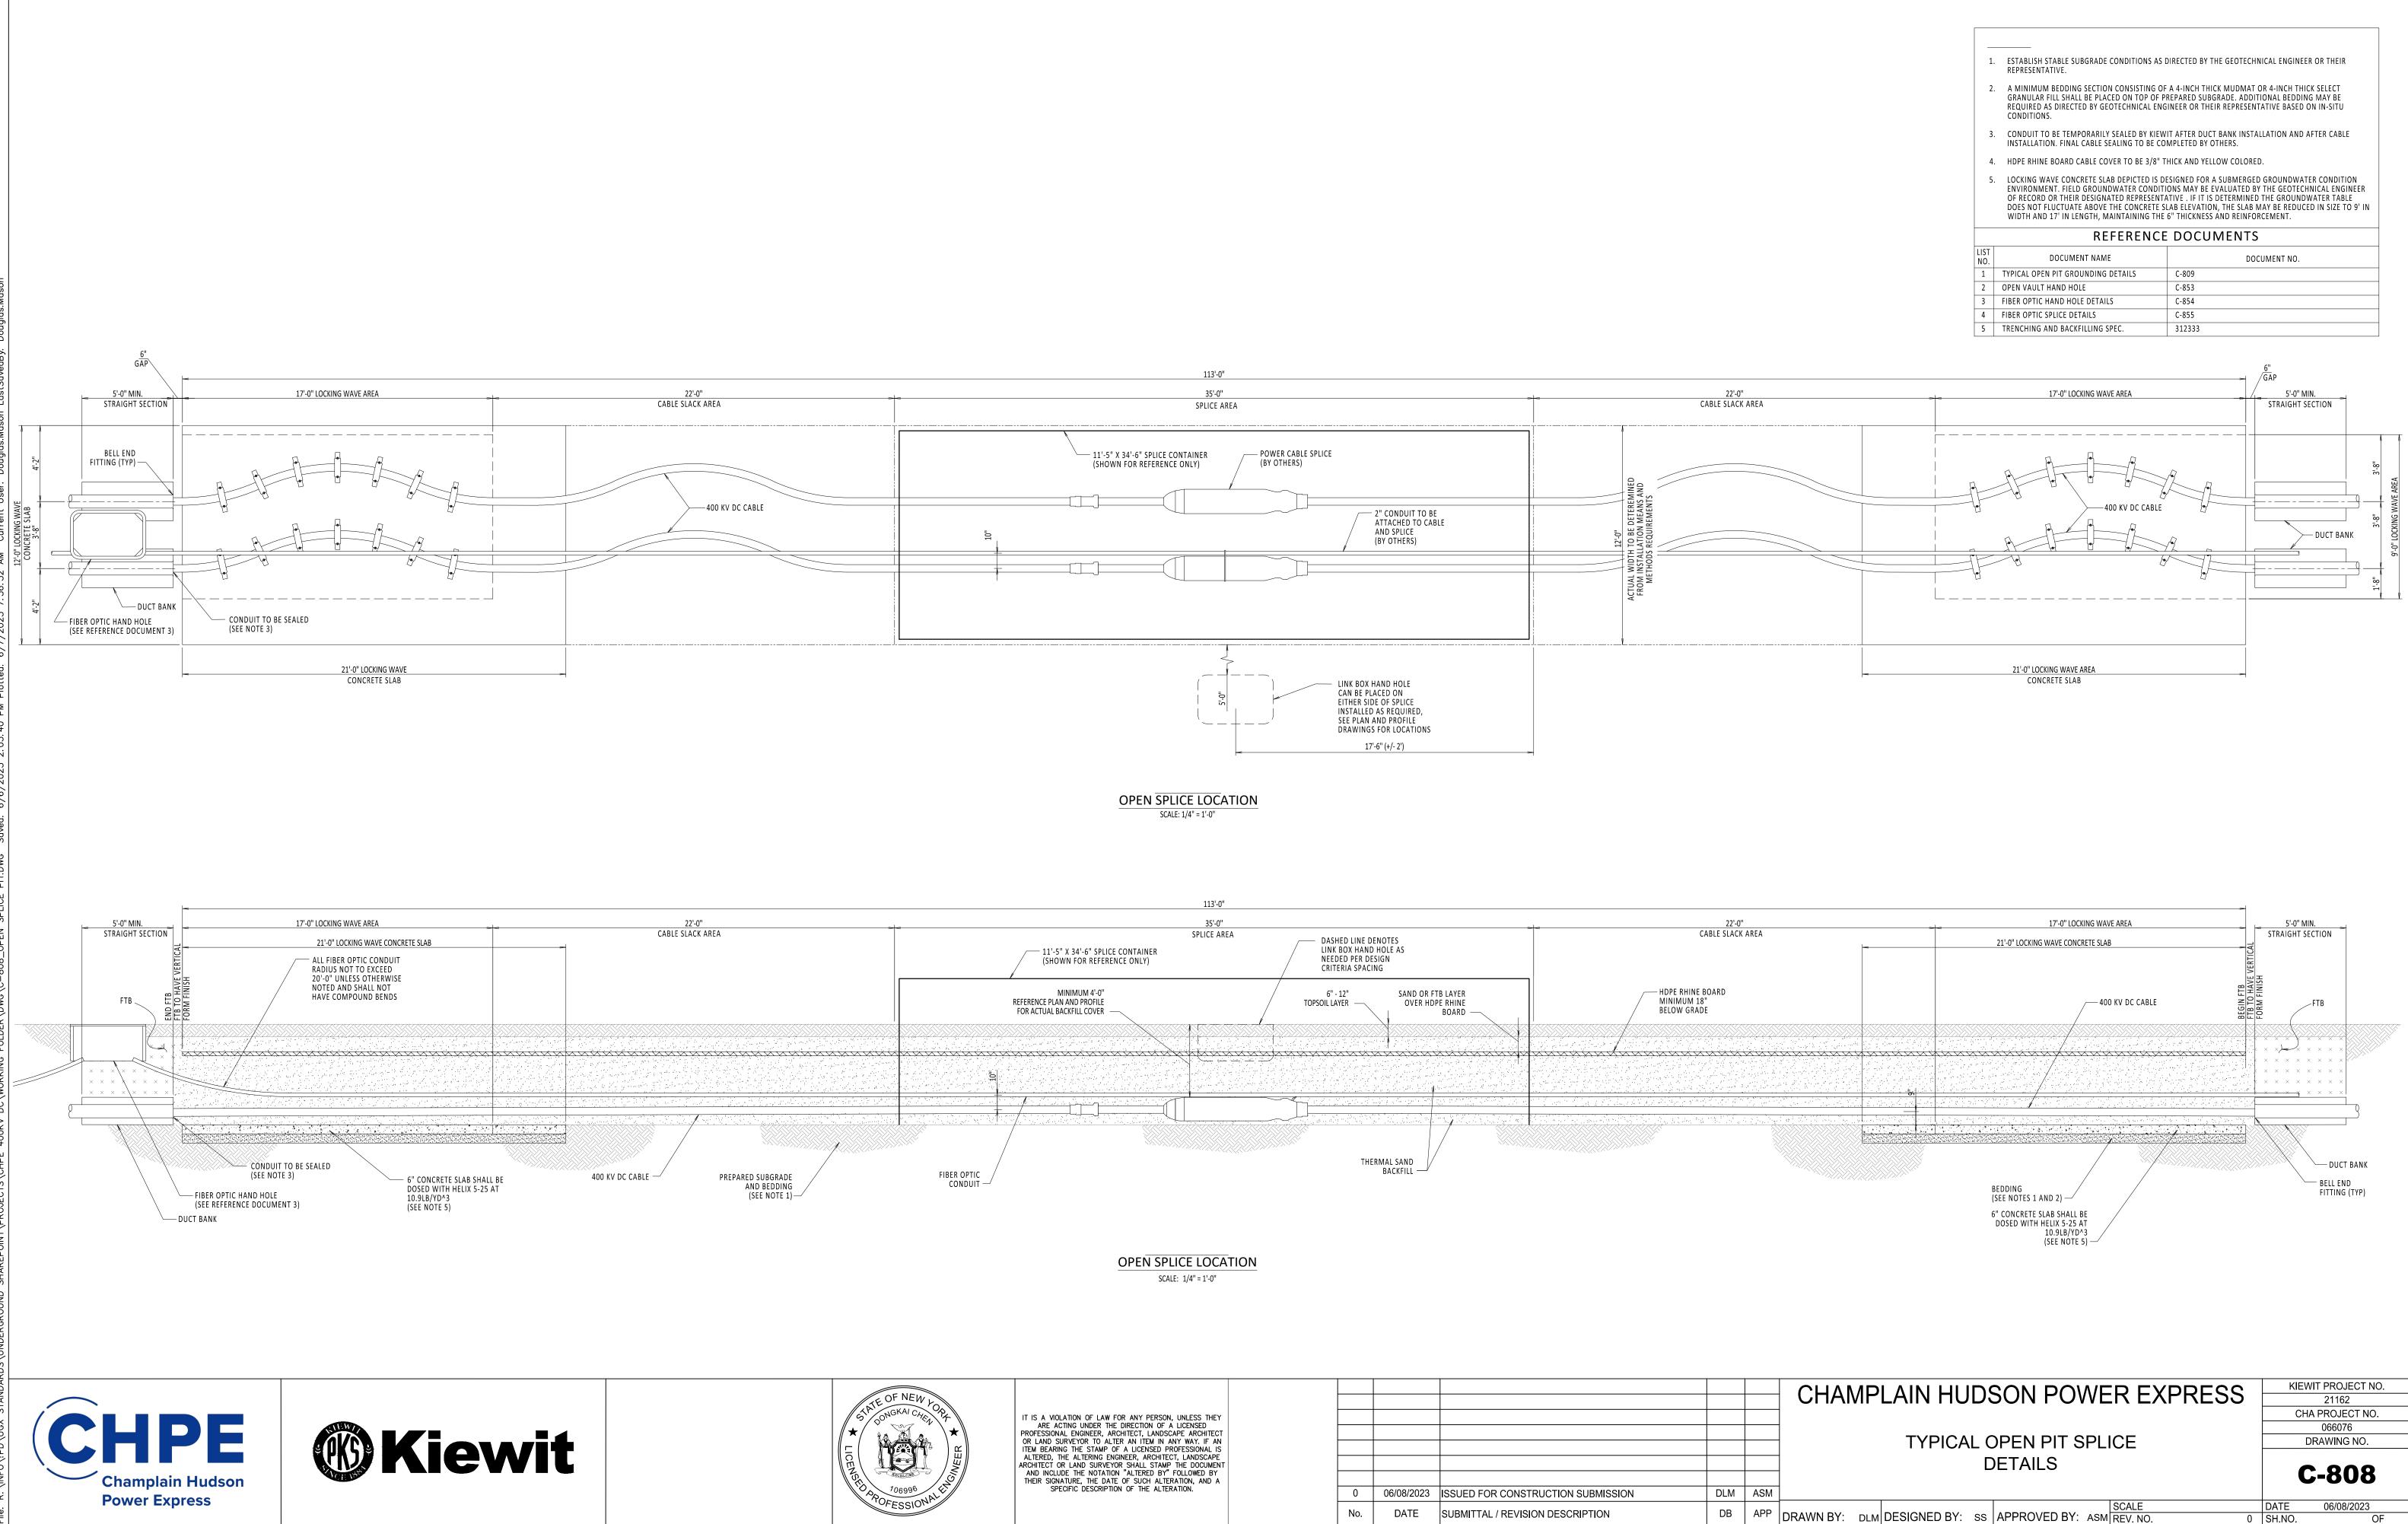OF




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Ś	AND INCLUDE THE NOTATION "ALTERED BY" FOLLOWED BY THEIR SIGNATURE, THE DATE OF SUCH ALTERATION, AND A			
\$//	SPECIFIC DESCRIPTION OF THE ALTERATION.	0	06/08/2023	ISSUED FOR CONSTRUCTION

DB APP DRAWN BY:

BILL OF MATERIALS					
ITEM DESCRIPTION	MANUFACTURER & CATALOG NO.	PROVIDER	INSTALLER		
LINK BOX	AS REQUIRED	NKT	KIEWIT		
INSULATED GROUND CABLE	AS REQUIRED	NKT	NKT		
BARE 4/0 GROUND CABLE	AS REQUIRED	KIEWIT	KIEWIT		
COMPRESSION C CONNECTOR	BURNDY YGHC29C29	KIEWIT	KIEWIT		
COMPRESSION CONNECTION TO GROUND ROD	BURNDY YGHR29C34	KIEWIT	KIEWIT		
3/4" X 10'-0" GROUND ROD	NVENT ERICO 613400	KIEWIT	KIEWIT		
3/4" STUD RING TERMINAL	BURNDY YAD28M20E34	KIEWIT	KIEWIT		

DRAWING NAME	DRAWING NO.
STRUCTURAL VAULT DRAWINGS	S-700
TYPICAL OPEN PIT SPLICE DETAILS	C-808
GROUNDING SPECIFICATIONS	260526.01

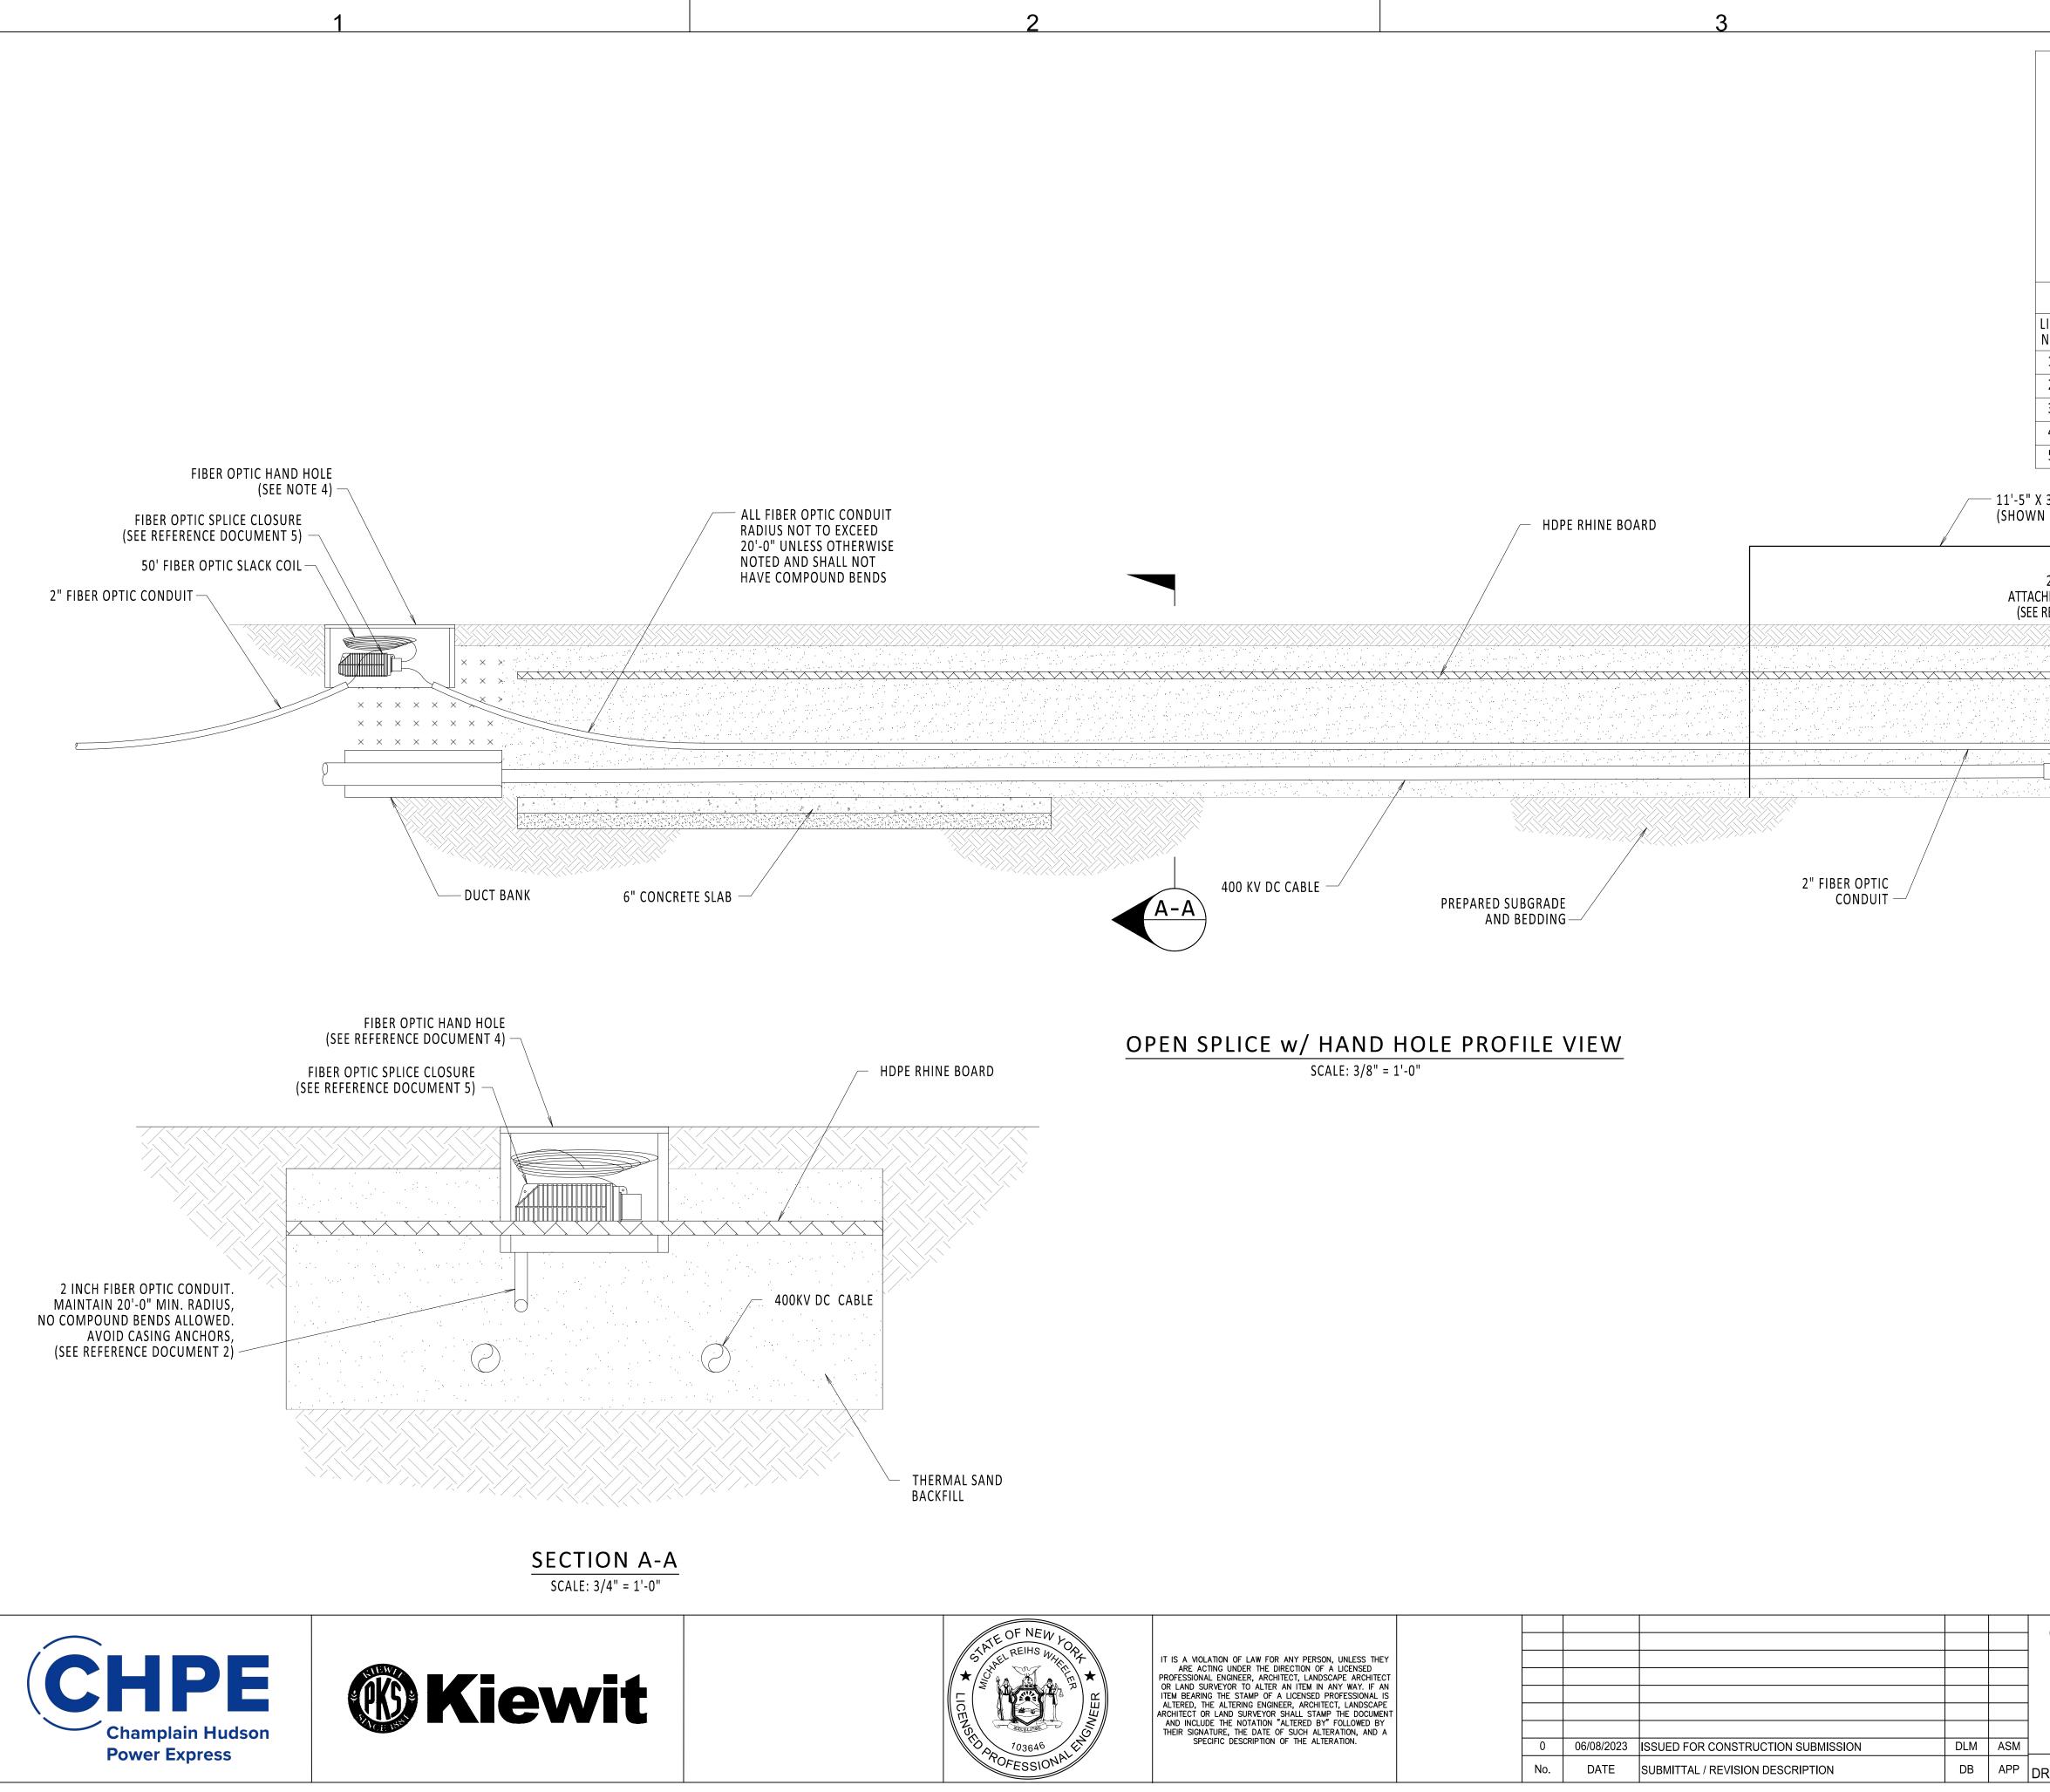

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103646	SPECIFIC DESCRIPTION OF THE ALTERATION.	0	06/08/2023	ISSUED FOR CONSTRUCTION SUBMISSION	DLM	ASM	
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- 1. ADD HAND HOLE TO ALL OPEN SPLICE LOCATIONS.
- 2. FIBER OPTIC SPLICE CLOSURE ONLY AT SPECIFIC LOCATIONS. SEE PLAN AND PROFILE FOR DETAILS.
- 3. SEE REFERENCE DOCUMENTS 2 FOR HAND HOLE LOCATION DETAILS.
- 4. SEE REFERENCE DOCUMENT 4 FOR FIBER OPTIC HAND HOLE DETAILS.
- 5. MAINTAIN A MINIMUM FIBER OPTIC CABLE BEND RADIUS OF 8" UNLESS OTHERWISE STATED (WHEN BENDING THE CABLE).

## REFERENCE DOCUMENTS

LIST NO.	DOCUMENT NAME	DOCUMENT NO.	
1	FRP FIBER COMMUNICATION HAND HOLE	S-771	
2	TYPICAL OPEN PIT SPLICE DETAILS	C-808	
3	DTS HUT CONNECTION FIBER OPTIC SPLICE AND HAND HOLE	C-851	
4	FIBER OPTIC HAND HOLE DETAILS	C-854	
5	FIBER OPTIC SPLICE DETAILS	C-855	


11'-5" X 34'-6" SPLICE CONTAINER (SHOWN FOR REFERENCE ONLY)

2" FIBER OPTIC CONDUIT IED TO CABLE AND SPLICE REFERENCE DOCUMENT 2)
POWER CABLE SPLICE —

CHAMPLAIN HUDSO			KIEWI	T PROJECT NO.
		R EAFRESS		21162
			CHA	PROJECT NO.
				066076
OPEN SPLICE	DF	RAWING NO.		
	DHOLE		С	-853
		SCALE	DATE	06/08/2023
RAWN BY' TIMO DESIGNED BY' MK   AF	PPROVED BY · XX			OF

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## **ISOMETRIC VIEW** NOT TO SCALE


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ALL REINS MARKER	IT IS A VIOLATION OF LAW FOR ANY PERSON, UNLESS THEY ARE ACTING UNDER THE DIRECTION OF A LICENSED PROFESSIONAL ENGINEER, ARCHITECT, LANDSCAPE ARCHITECT OR LAND SURVEYOR TO ALTER AN ITEM IN ANY WAY. IF AN						
	ITEM BEARING THE STAMP OF A LICENSED PROFESSIONAL IS ALTERED, THE ALTERING ENGINEER, ARCHITECT, LANDSCAPE ARCHITECT OR LAND SURVEYOR SHALL STAMP THE DOCUMENT						
703646 E	AND INCLUDE THE NOTATION "ALTERED BY" FOLLOWED BY THEIR SIGNATURE, THE DATE OF SUCH ALTERATION, AND A SPECIFIC DESCRIPTION OF THE ALTERATION.	0	06/08/2023	ISSUED FOR CONSTRUCTION SUBMISSION	DLM	ASM	_
POFESSIONAL		No.	DATE	SUBMITTAL / REVISION DESCRIPTION	DB	APP	DRA

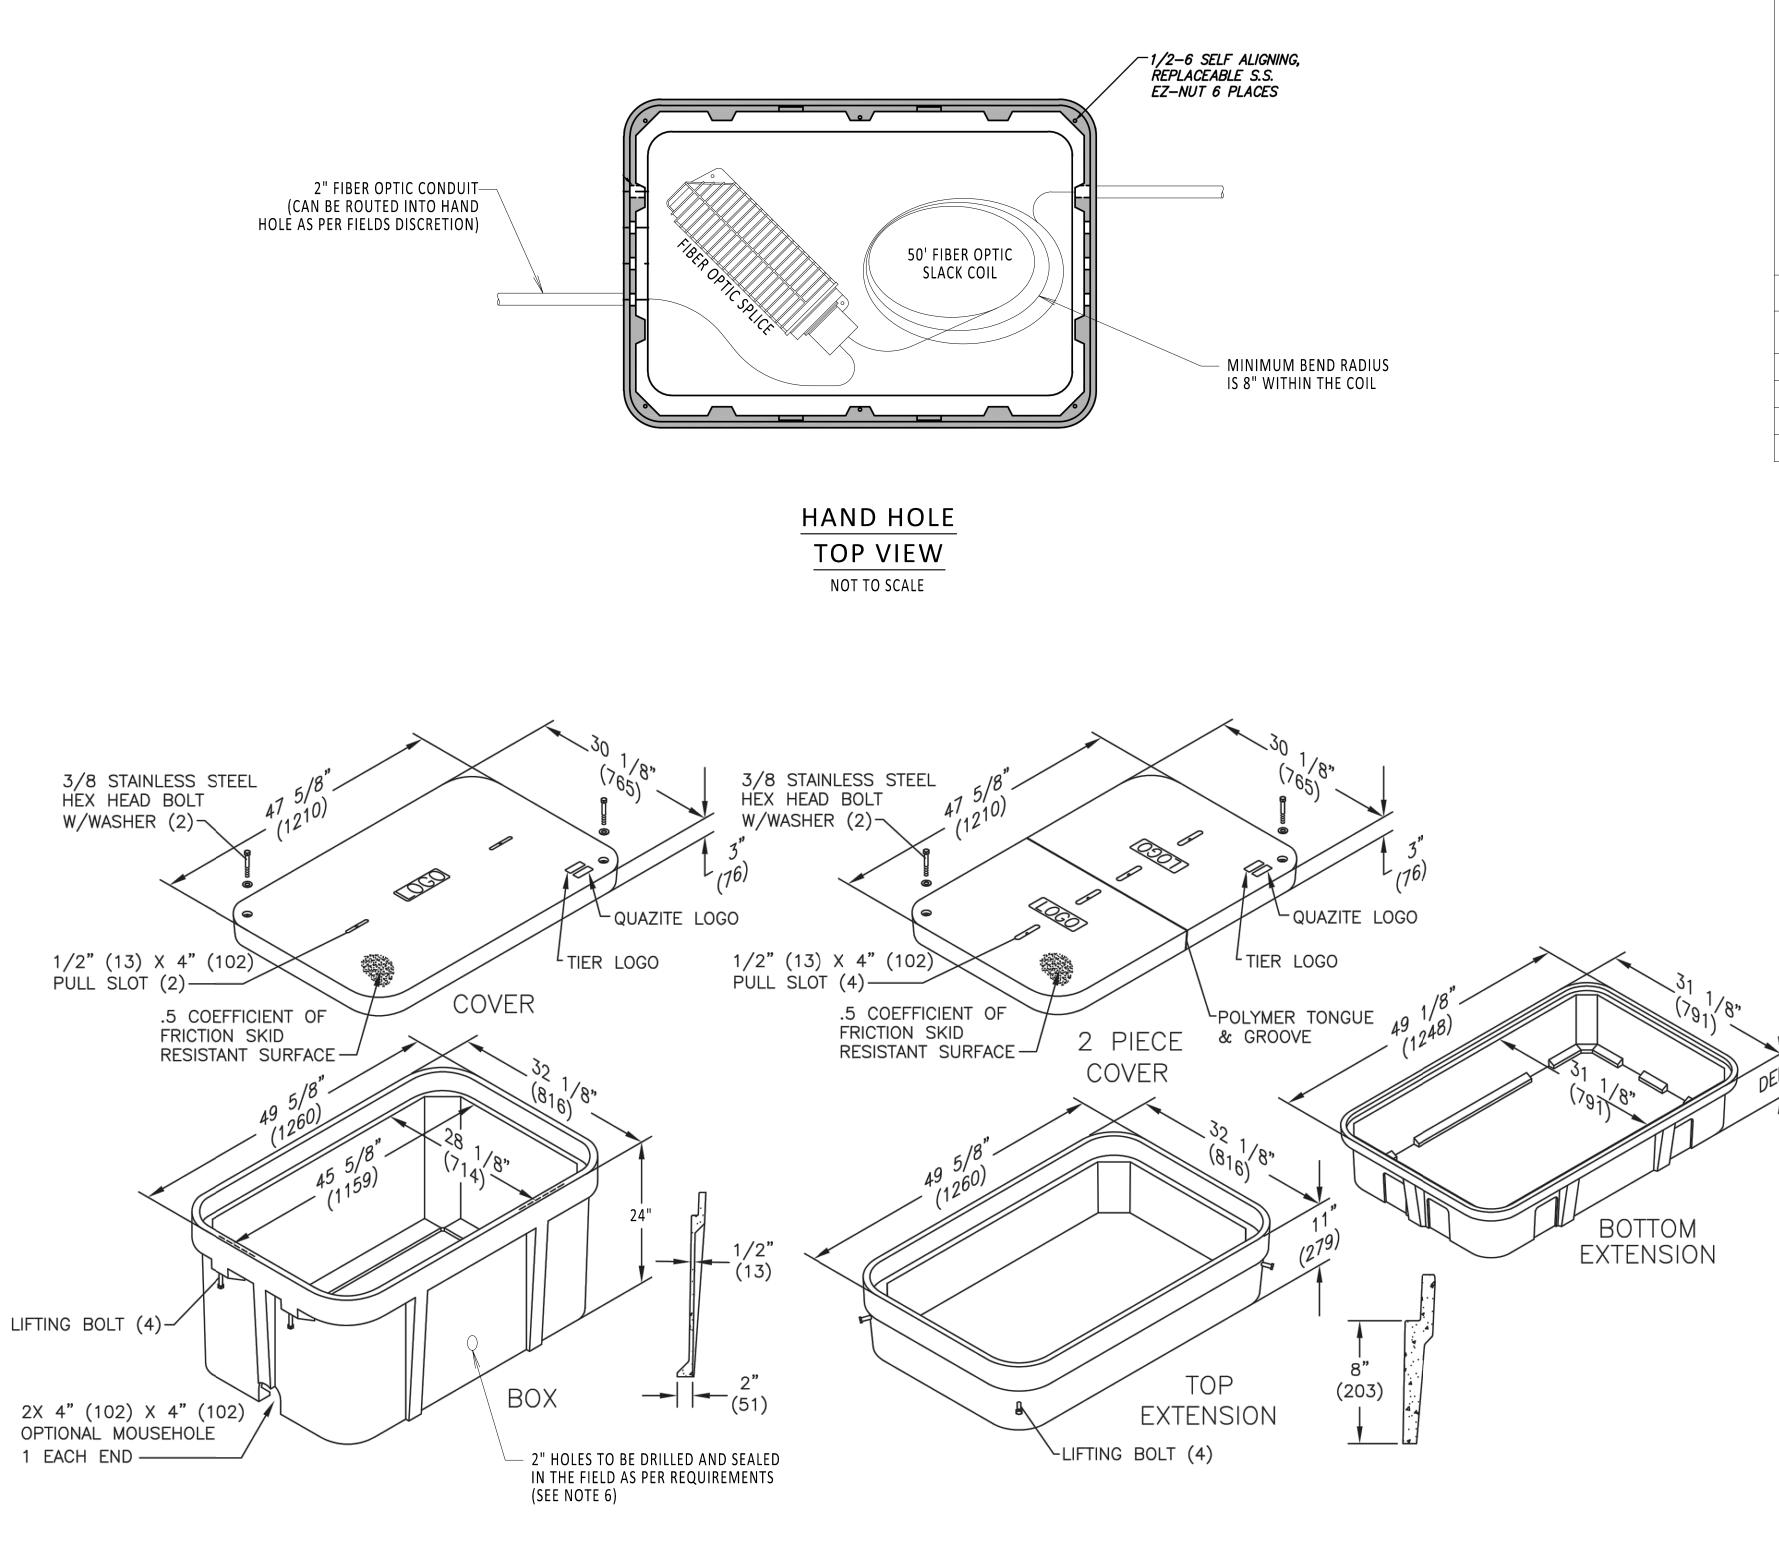
- 1. FIBER OPTIC COIL TO BE PLACED IN BOTTOM OF HAND HOLE. OBSERVE MINIMUM BEND RADIUS.
- 2. SPLICE ALL FIBERS STRAIGHT THROUGH.
- 3. FIBER OPTIC SPLICE CLOSURE ONLY AT SPECIFIC LOCATIONS. SEE PLAN AND PROFILE FOR DETAILS.
- 4. GROUNDING REQUIREMENTS TO BE DETERMINED.
- 5. HAND HOLE AT ALL OPEN SPLICE LOCATIONS. SEE REFERENCE DOCUMENTS 1 AND 2 FOR DETAILS ON HAND HOLE PLACEMENT IN OPEN PIT.
- 6. DRILLED HOLES ARE INTENDED TO ROUTE FIBER OPTIC CONDUIT AND CAN BE DRILLED AND SEALED ON ANY SIDE OF HAND HOLE AS REQUIRED BY THE FIELD.

REFERENCE	DOCUMENTS
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LIST NO.	DOCUMENT NAME	DOCUMENT NO.
1	TYPICAL OPEN PIT SPLICE DETAILS	C-808
2	OPEN VAULT w/FIBER OPTIC HAND HOLE	C-853
3	FIBER OPTIC SPLICE DETAILS	C-855
4	HUBBELL QUAZITE (HAND HOLE)	MODEL NO. PG3048BA24


3/8" (10) 



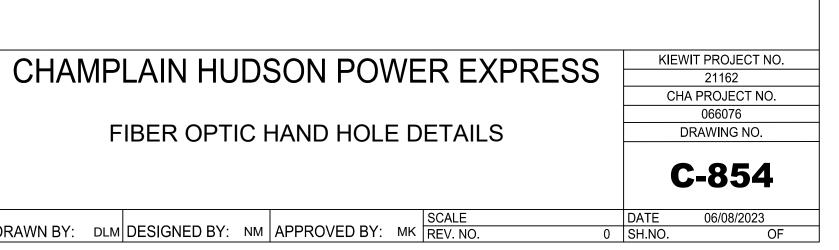

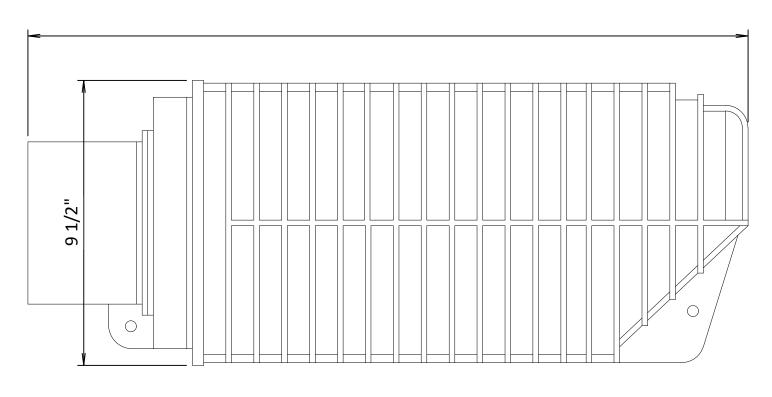
## FIBER OPTIC SPLICE CLOSURE

NOT TO SCALE

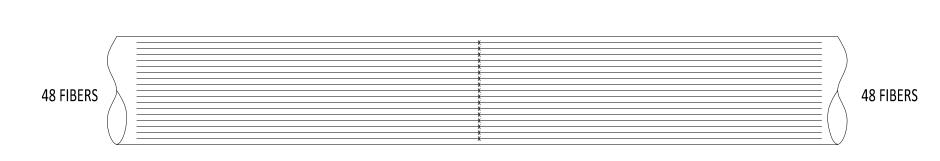

## FIBER OPTIC CABLE SPLICE

NOT TO SCALE

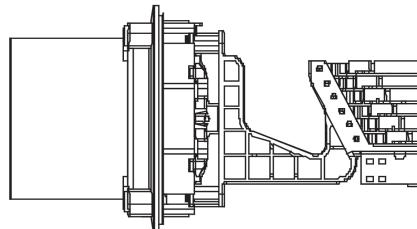


FIBER OPTIC SPLICE CLOSURE INSIDE DIAGRAM NOT TO SCALE








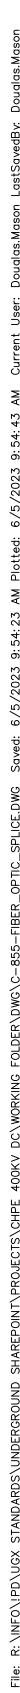


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3 4 5

# DIAGRAM TYPICAL

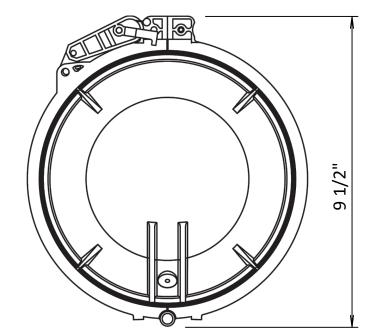

FIBER OPTIC SPLICE CLOSURE NOT TO SCALE

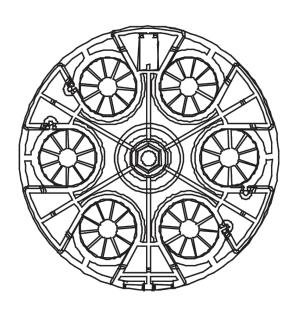

## FIBER OPTIC SPLICE CLOSURE GEL-BLOCK PROFILE NOT TO SCALE

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EOFINEN							
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	ARE ACTING UNDER THE DIRECTION OF A LICENSED PROFESSIONAL ENGINEER, ARCHITECT, LANDSCAPE ARCHITECT						
	OR LAND SURVEYOR TO ALTER AN ITEM IN ANY WAY. IF AN ITEM BEARING THE STAMP OF A LICENSED PROFESSIONAL IS						
	ALTERED, THE ALTERING ENGINEER, ARCHITECT, LANDSCAPE ARCHITECT OR LAND SURVEYOR SHALL STAMP THE DOCUMENT						
	AND INCLUDE THE NOTATION "ALTERED BY" FOLLOWED BY THEIR SIGNATURE, THE DATE OF SUCH ALTERATION, AND A						
703646	SPECIFIC DESCRIPTION OF THE ALTERATION.	0	06/08/2023	ISSUED FOR CONSTRUCTION SUBMISSION	DLM	ASM	
OFESSIONAL		No.	DATE	SUBMITTAL / REVISION DESCRIPTION	DB	APP	DRA
				I	I		<u></u>

1. MAINTAIN 18" SWEEPS ON ALL CONDUITS.

2. DTS HUT FIBERS WILL SPLICE TO BLUE TUBE FIBER COLORS BLUE, ORANGE, GREEN AND BROWN.

3. SEE REFERENCE DOCUMENTS 2, 3, 4 AND 5 FOR PLACEMENT DETAILS.

4. FIBER OPTIC SPLICE CLOSURE ONLY IN SPECIFIC LOCATIONS. SEE PLAN AND PROFILES FOR DETAILS.

## REFERENCE DOCUMENTS

DOCUMENT NAME	DOCUMENT NO.
FIBER OPTIC SPLICE CLOSURE	COMMSCOPE: MODEL NO. FOSC450-B6-6-24-1-B3V
TRANSITION VAULT FIBER OPTIC DETAIL	C-850
DTS HUT CONNECTION FIBER OPTIC SPLICE AND HANDHOLE	C-851
ENCLOSED VAULT w/FIBER OPTICS	C-852
OPEN VAULT w/FIBER OPTICS HAND HOLE	C-853

	KIEWIT PROJECT NO.	
CHAMPLAIN HUDSON POWER EXPRESS	21162	
	CHA PROJECT NO.	
	066076	
FIBER OPTIC SPLICE DETAILS	DRAWING NO.	
	<b>C-855</b>	
SCALE	DATE 06/08/2023	
RAWN BY: DLM DESIGNED BY: NM APPROVED BY: MK REV. NO. 0	SH.NO. OF	








32.34"

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## FIBER OPTIC H-FRAME BRACKET

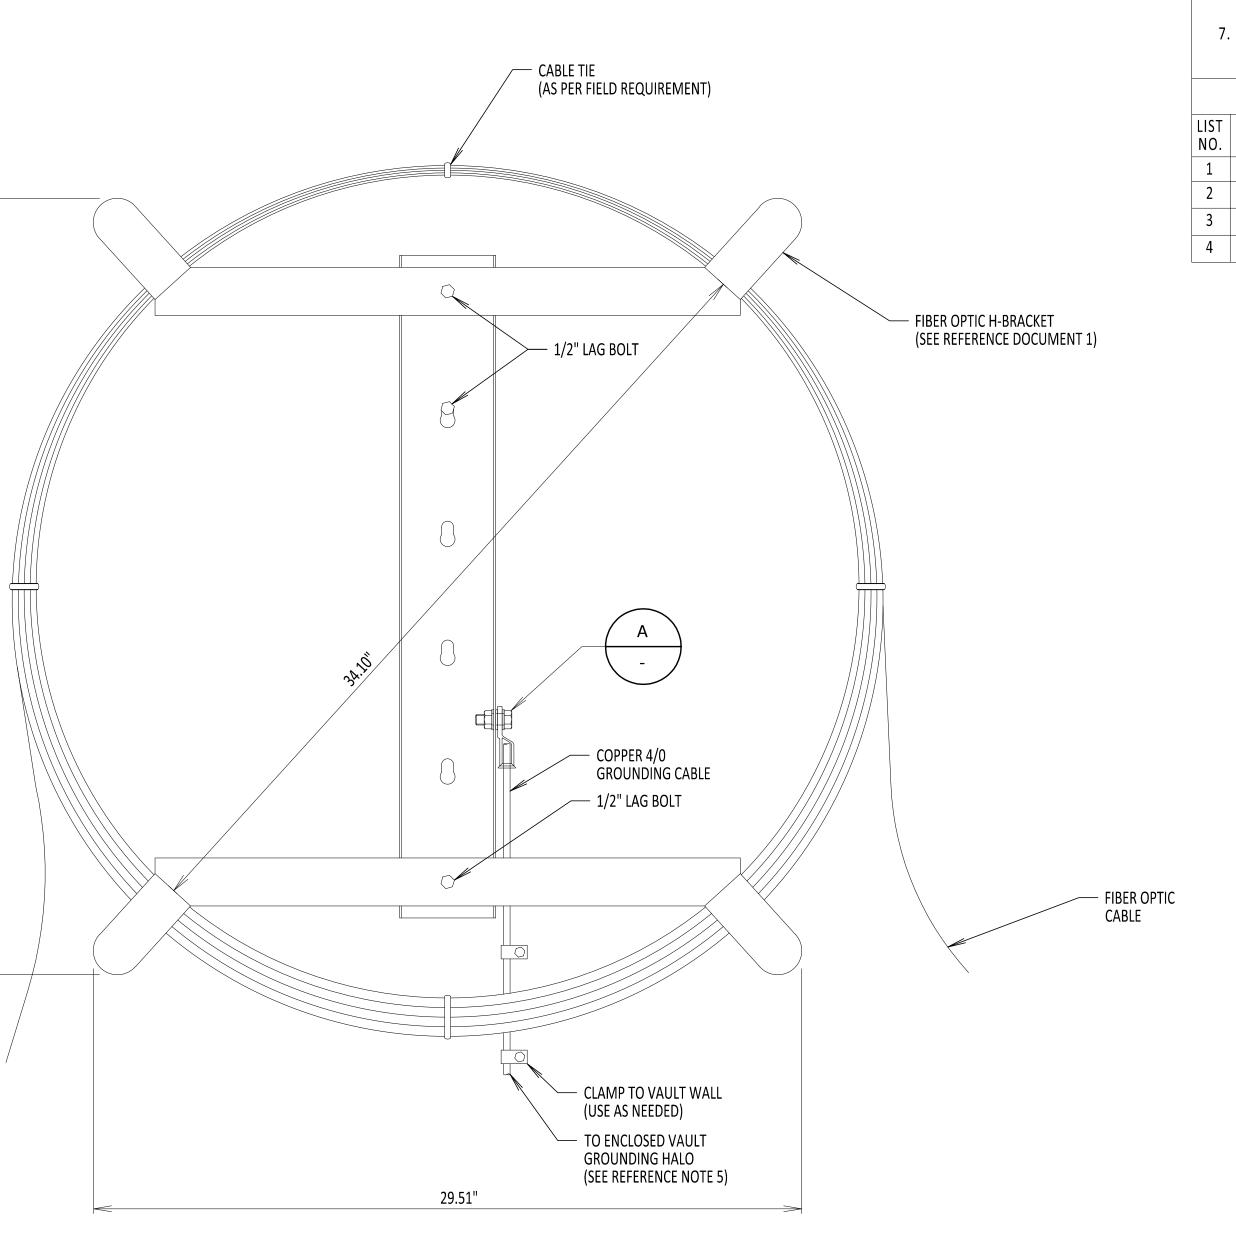NOT TO SCALE

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IT IS A VIOLATION OF LAW FOR ANY PERSON, UNLESS THEY							
	ARE ACTING UNDER THE DIRECTION OF A LICENSED PROFESSIONAL ENGINEER, ARCHITECT, LANDSCAPE ARCHITECT OR LAND SURVEYOR TO ALTER AN ITEM IN ANY WAY. IF AN						-
	ITEM BEARING THE STAMP OF A LICENSED PROFESSIONAL IS ALTERED, THE ALTERING ENGINEER, ARCHITECT, LANDSCAPE ARCHITECT OR LAND SURVEYOR SHALL STAMP THE DOCUMENT					<u> </u>	-
- Carcelone	AND INCLUDE THE NOTATION "ALTERED BY" FOLLOWED BY THEIR SIGNATURE, THE DATE OF SUCH ALTERATION, AND A SPECIFIC DESCRIPTION OF THE ALTERATION.		0.0100.100.00				
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1. DO NOT KINK OR TWIST FIBER OPTIC CABLE.

2. IN VAULT PULL FROM DISTANT MANHOLE THEN COIL AND PLACE ON H-FRAME BRACKET.

3. H-FRAME IS ONLY USED IN ENCLOSED VAULTS. SEE REFERENCE DOCUMENTS 2 AND 3 FOR PLACEMENT DETAILS.

4. H-FRAME BRACKET DEPTH IS 4.50".

5. H-FRAME BRACKET TO BE GROUNDED TO THE GROUNDING HALO WITHIN AN ENCLOSED VAULT. SEE DRAWING C-803 FOR ENCLOSED VAULT GROUNDING DETAILS.

6. H-FRAME BRACKET IS MADE OF 12GA GALVANIZED STEEL.


7. 1/2" LAG BOLT DOES NOT COME WITH H-BRACKET ASSEMBLY AND NEEDS TO BE PROCURED AS NEEDED. BOLT TO BE INSTALLED INTO VAULT WALL BY FIELD PERSONNEL.

## REFERENCE DOCUMENTS


DOCUMENT NAME	DOCUMENT NO.
AMERICAN PRODUCT	H-FRAME POLE BRACKET MODEL NO: AM-3432-FSF-G-B x2
TYPICAL VAULT GROUNDING DETAILS	C-803
TRANSITION VAULT FIBER OPTIC DETAILS	C-850
ENCLOSED VAULT w/FIBER OPTICS	C-852

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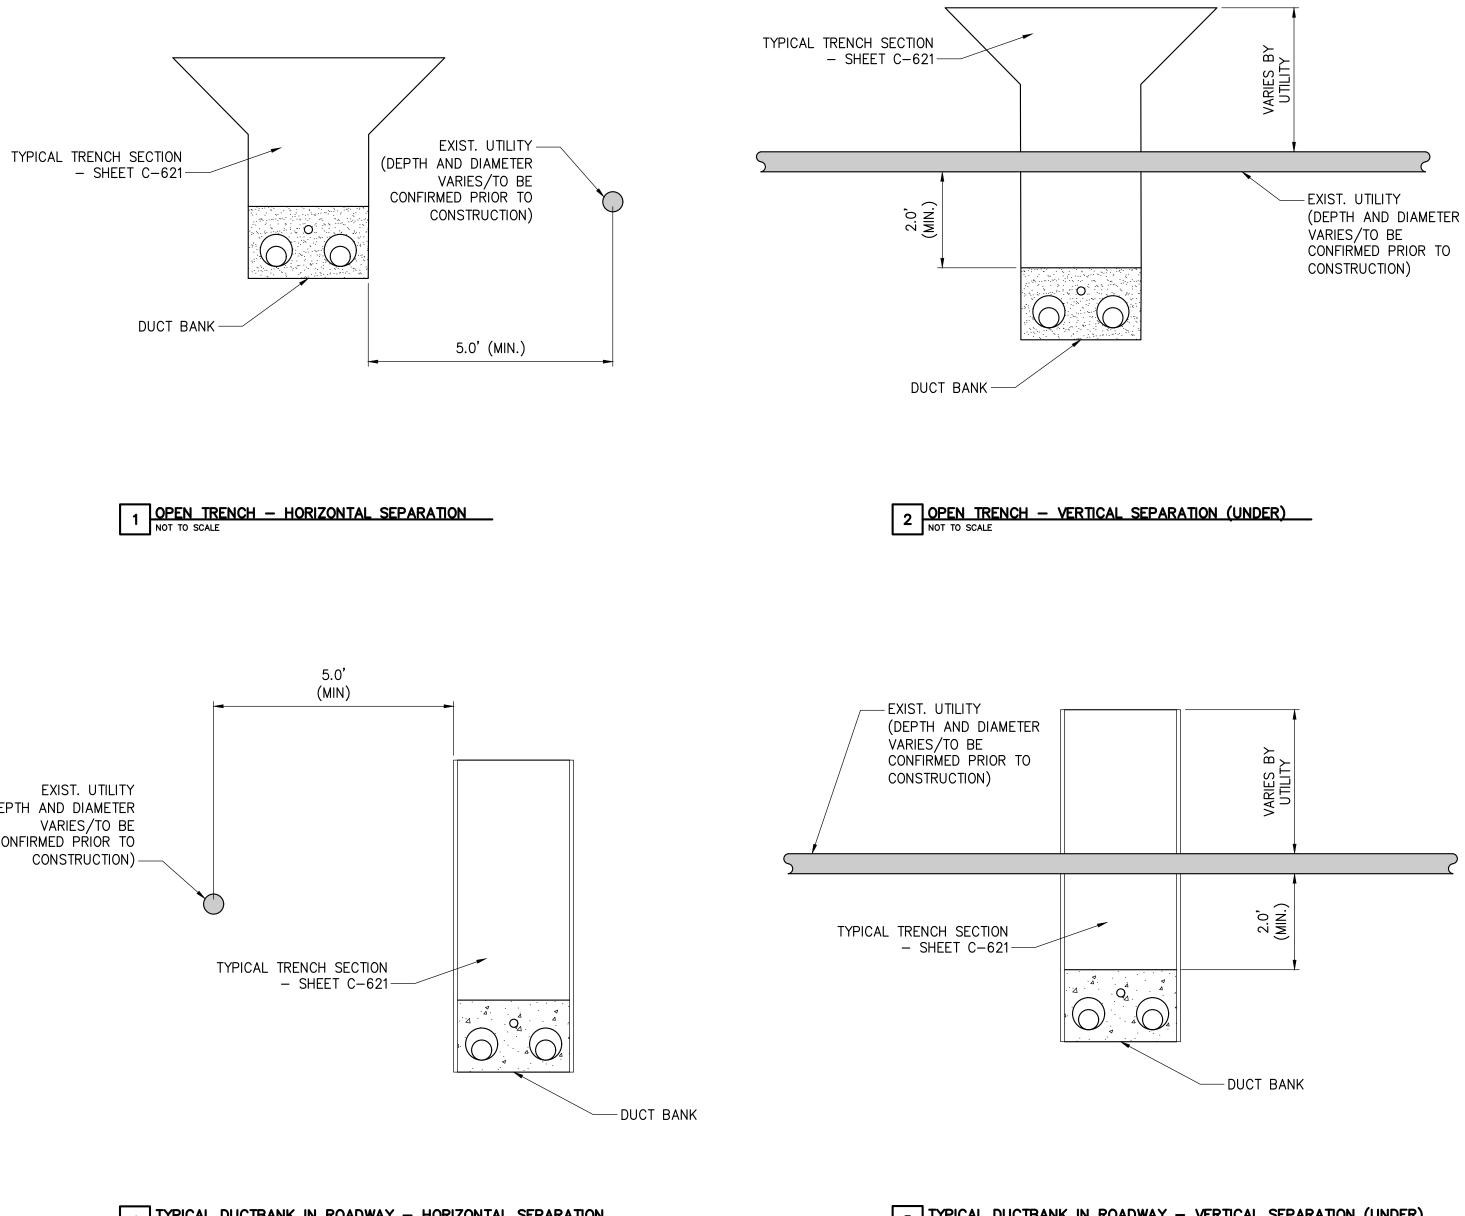
DETAIL A

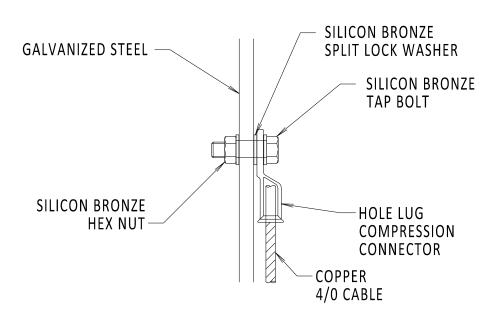

4

## NATIONAL GRID NOTES

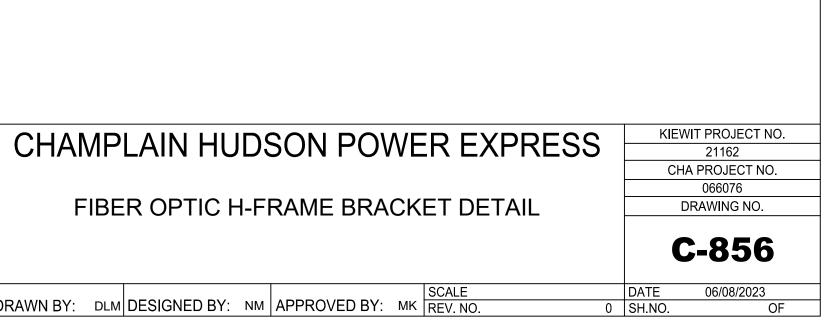- 1. THE CONTRACTOR SHALL OBSERVE AND ABIDE BY THE APPLICABLE POWER LINE SAFETY REGULATIONS 29 C.F.R. § 1926.1406 1926.1411.
- 2. THE CONTRACTOR SHALL TRAIN EMPLOYEES WORKING AS DEDICATED SPOTTERS IN ACCORDANCE WITH 29 C.F.R. § 1926.1408(G)(2).
- 3. CONSTRUCTION UNDER TRANSMISSION LINES REQUIRES A DEDICATED SPOTTER, AS APPLICABLE.
- 4. THE CONTRACTOR SHALL SUBMIT QUALIFIED INDIVIDUALS' RESUMES TO NATIONAL GRID.





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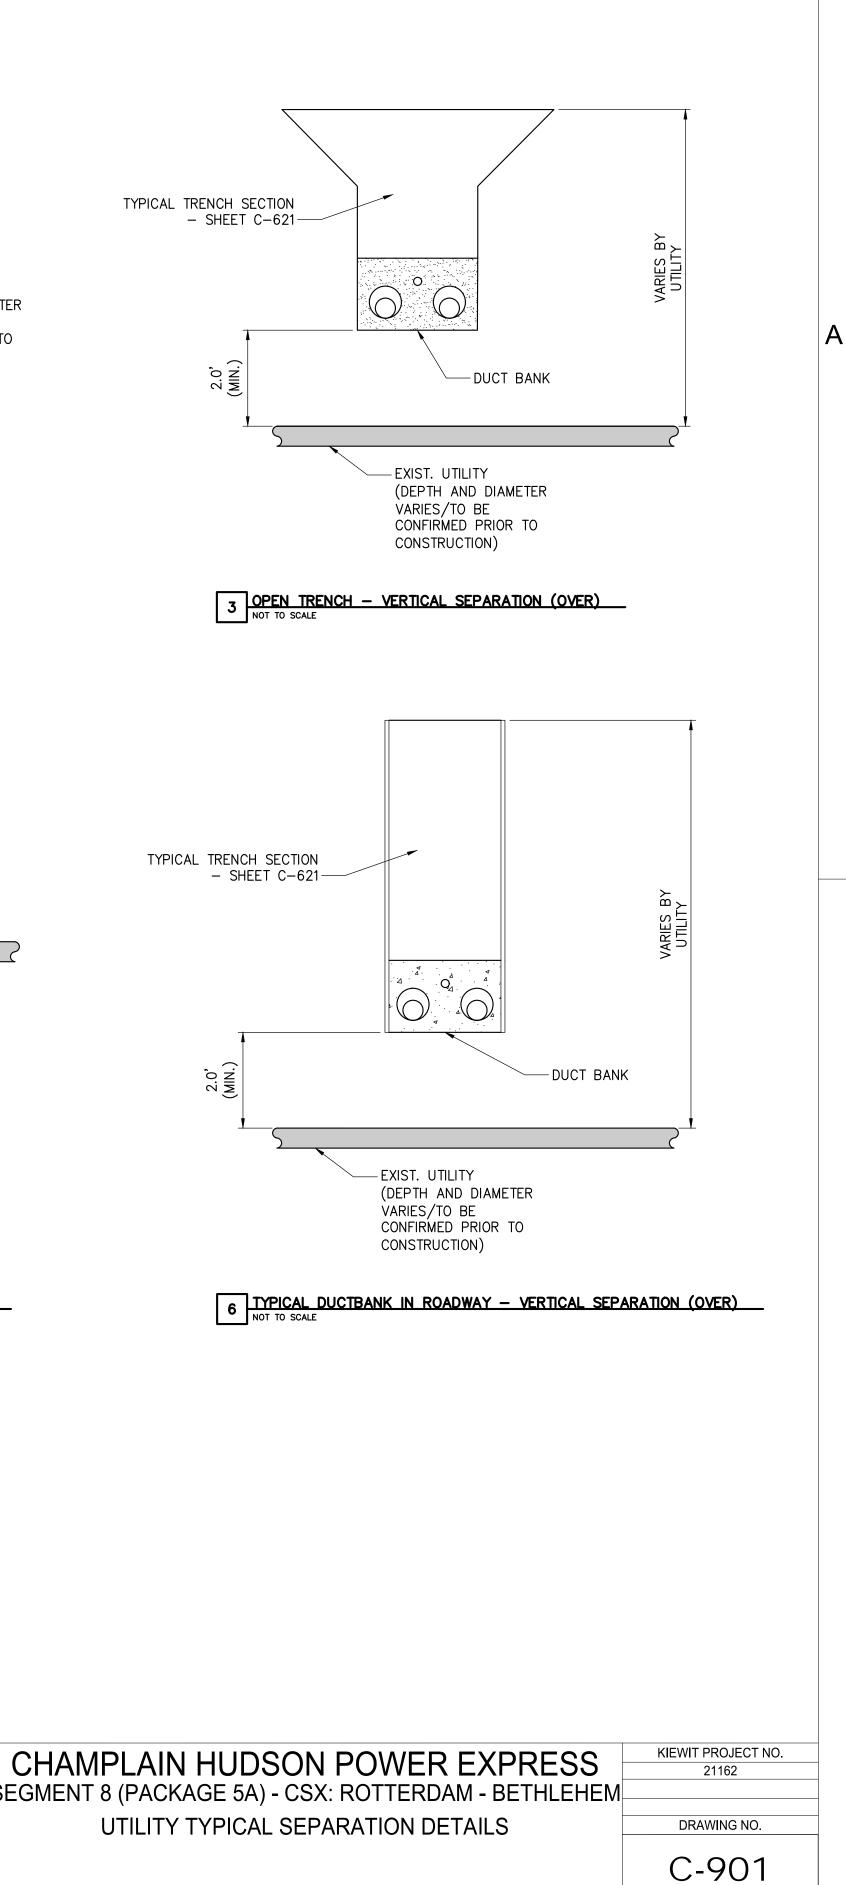


4 TYPICAL DUCTBANK IN ROADWAY - HORIZONTAL SEPARATION

5 TYPICAL DUCTBANK IN ROADWAY - VERTICAL SEPARATION (UNDER)

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EL REIHS WAR PY	IT IS A VIOLATION OF LAW FOR ANY PERSON, UNLESS THEY ARE ACTING UNDER THE DIRECTION OF A LICENSED PROFESSIONAL ENGINEER, ARCHITECT, LANDSCAPE ARCHITECT							SEC
	OR LAND SURVEYOR TO ALTER AN ITEM IN ANY WAY. IF AN ITEM BEARING THE STAMP OF A LICENSED PROFESSIONAL IS ALTERED, THE ALTERING ENGINEER, ARCHITECT, LANDSCAPE ARCHITECT OR LAND SURVEYOR SHALL STAMP THE DOCUMENT							
	ARCHITECT OR LAND SORVETOR SHALL STAMP THE DOCUMENT AND INCLUDE THE NOTATION "ALTERED BY" FOLLOWED BY THEIR SIGNATURE, THE DATE OF SUCH ALTERATION, AND A SPECIFIC DESCRIPTION OF THE ALTERATION.		0	06/00/2023	ISSUED FOR CONSTRUCTION SUBMISSION	BV	ТК	
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AS SHOWN DATE 0 SH.NO. SCALE REV. NO. 06/09/2023 OF APPROVED BY: DESIGNED BY: RAWN BY: