

## STA. 20165+00 TO STA. 20180+00 PROFILE VIEW SCALE: H: 1" = 50' V: 1" = 10'







IT IS A VIOLATION OF LAW FOR ANY PERSON, UNLESS THEY ARE ACTING UNDER THE DIRECTION OF A LICENSED PROFESSIONAL ENGINEER, ARCHITECT, LANDSCAPE ARCHITECT OR LAND SURVEYOR TO ALTER AN ITEM IN ANY WAY. IF AN ITEM BEARING THE STAMP OF A LICENSED PROFESSIONAL IS ALTERED, THE ALTERING ENGINEER, ARCHITECT, LANDSCAPE ARCHITECT OR LAND SURVEYOR SHALL STAMP THE DOCUMENT AND INCLUDE THE NOTATION "ALTERED BY" FOLLOWED BY THEIR SIGNATURE, THE DATE OF SUCH ALTERATION, AND A SPECIFIC DESCRIPTION
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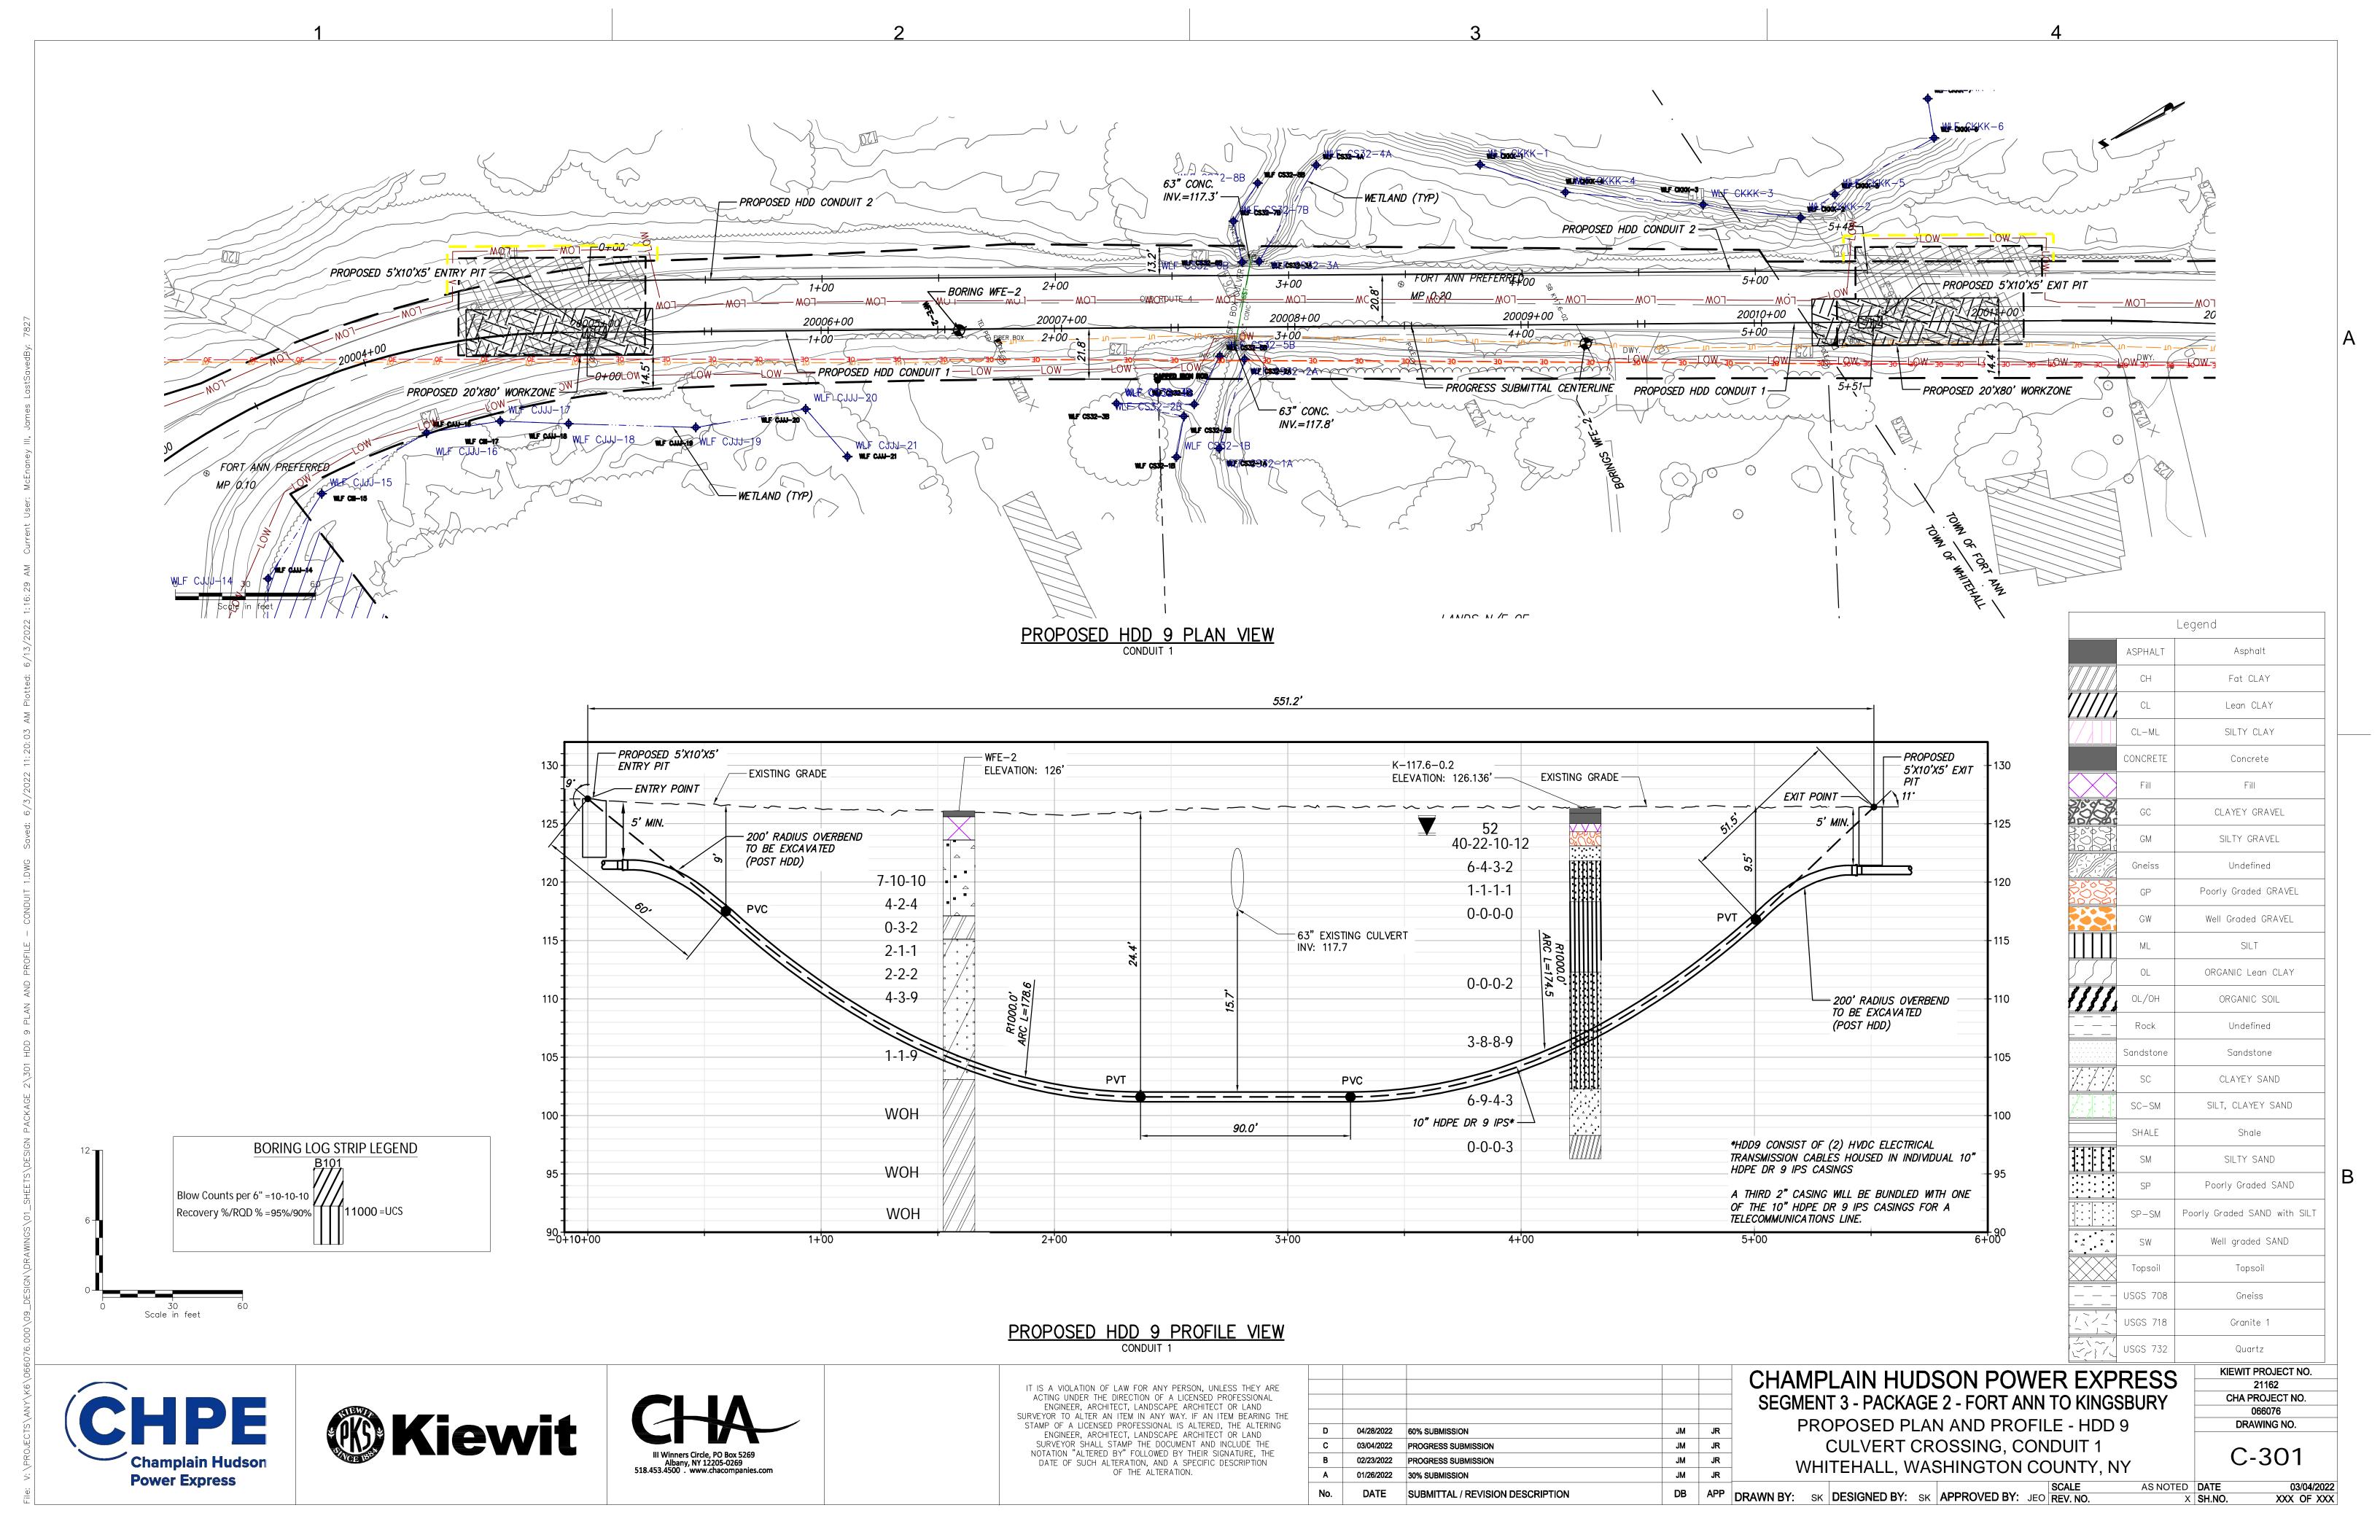
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D	04/28/2022	60% SUBMISSION	JM	JR	\ \
С	03/04/2022	PROGRESS SUBMISSION	JM	JR	
В	02/23/2022	PROGRESS SUBMISSION	JM	JR	
Α	01/26/2022	30% SUBMISSION	JM	JR	
No.	DATE	SUBMITTAL / REVISION DESCRIPTION	DB	APP	DR


#### CHAMPLAIN HUDSON POWER EXPRESS SEGMENT 3 - PACKAGE 2 - FORT ANN TO KINGSBURY STA. 20165+00 TO STA. 20180+00 PLAN AND PROFILE


KIEWIT PROJECT NO. 21162 CHA PROJECT NO. 066076 DRAWING NO.


C-112


DRAWN BY: XXX DESIGNED BY: XXX APPROVED BY: XXX REV. NO. AS NOTED DATE X SH.NO. XXX OF XXX




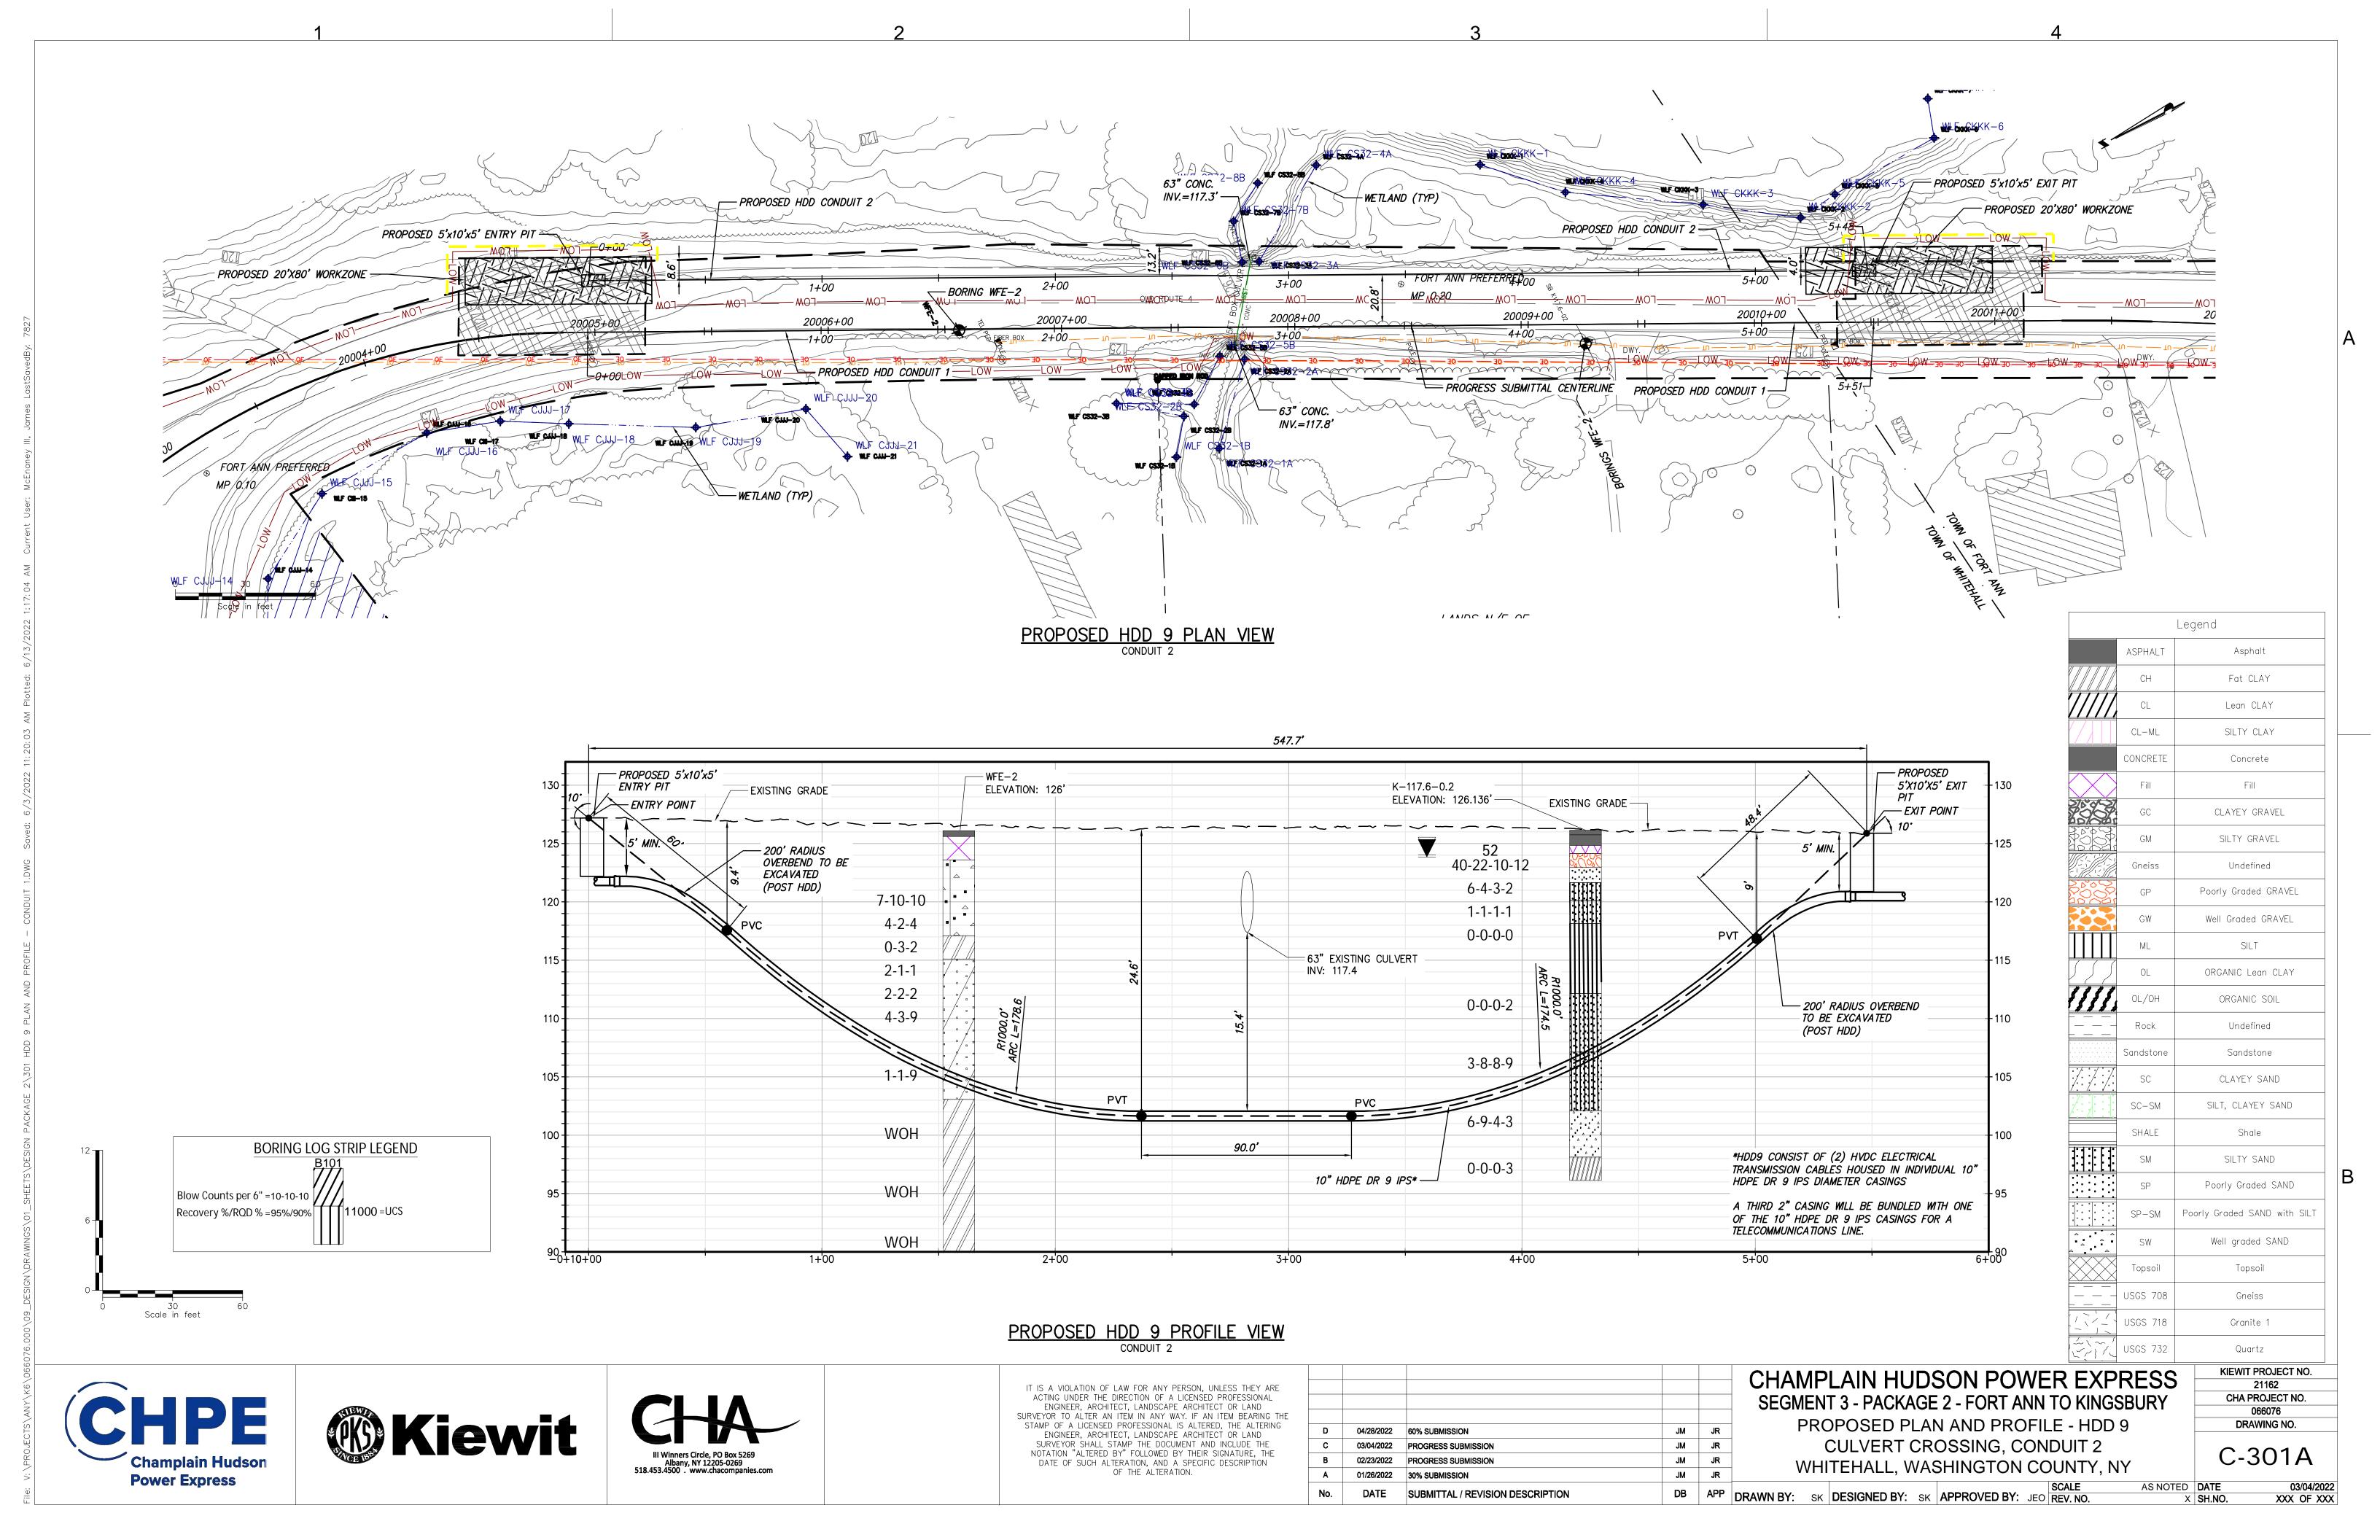


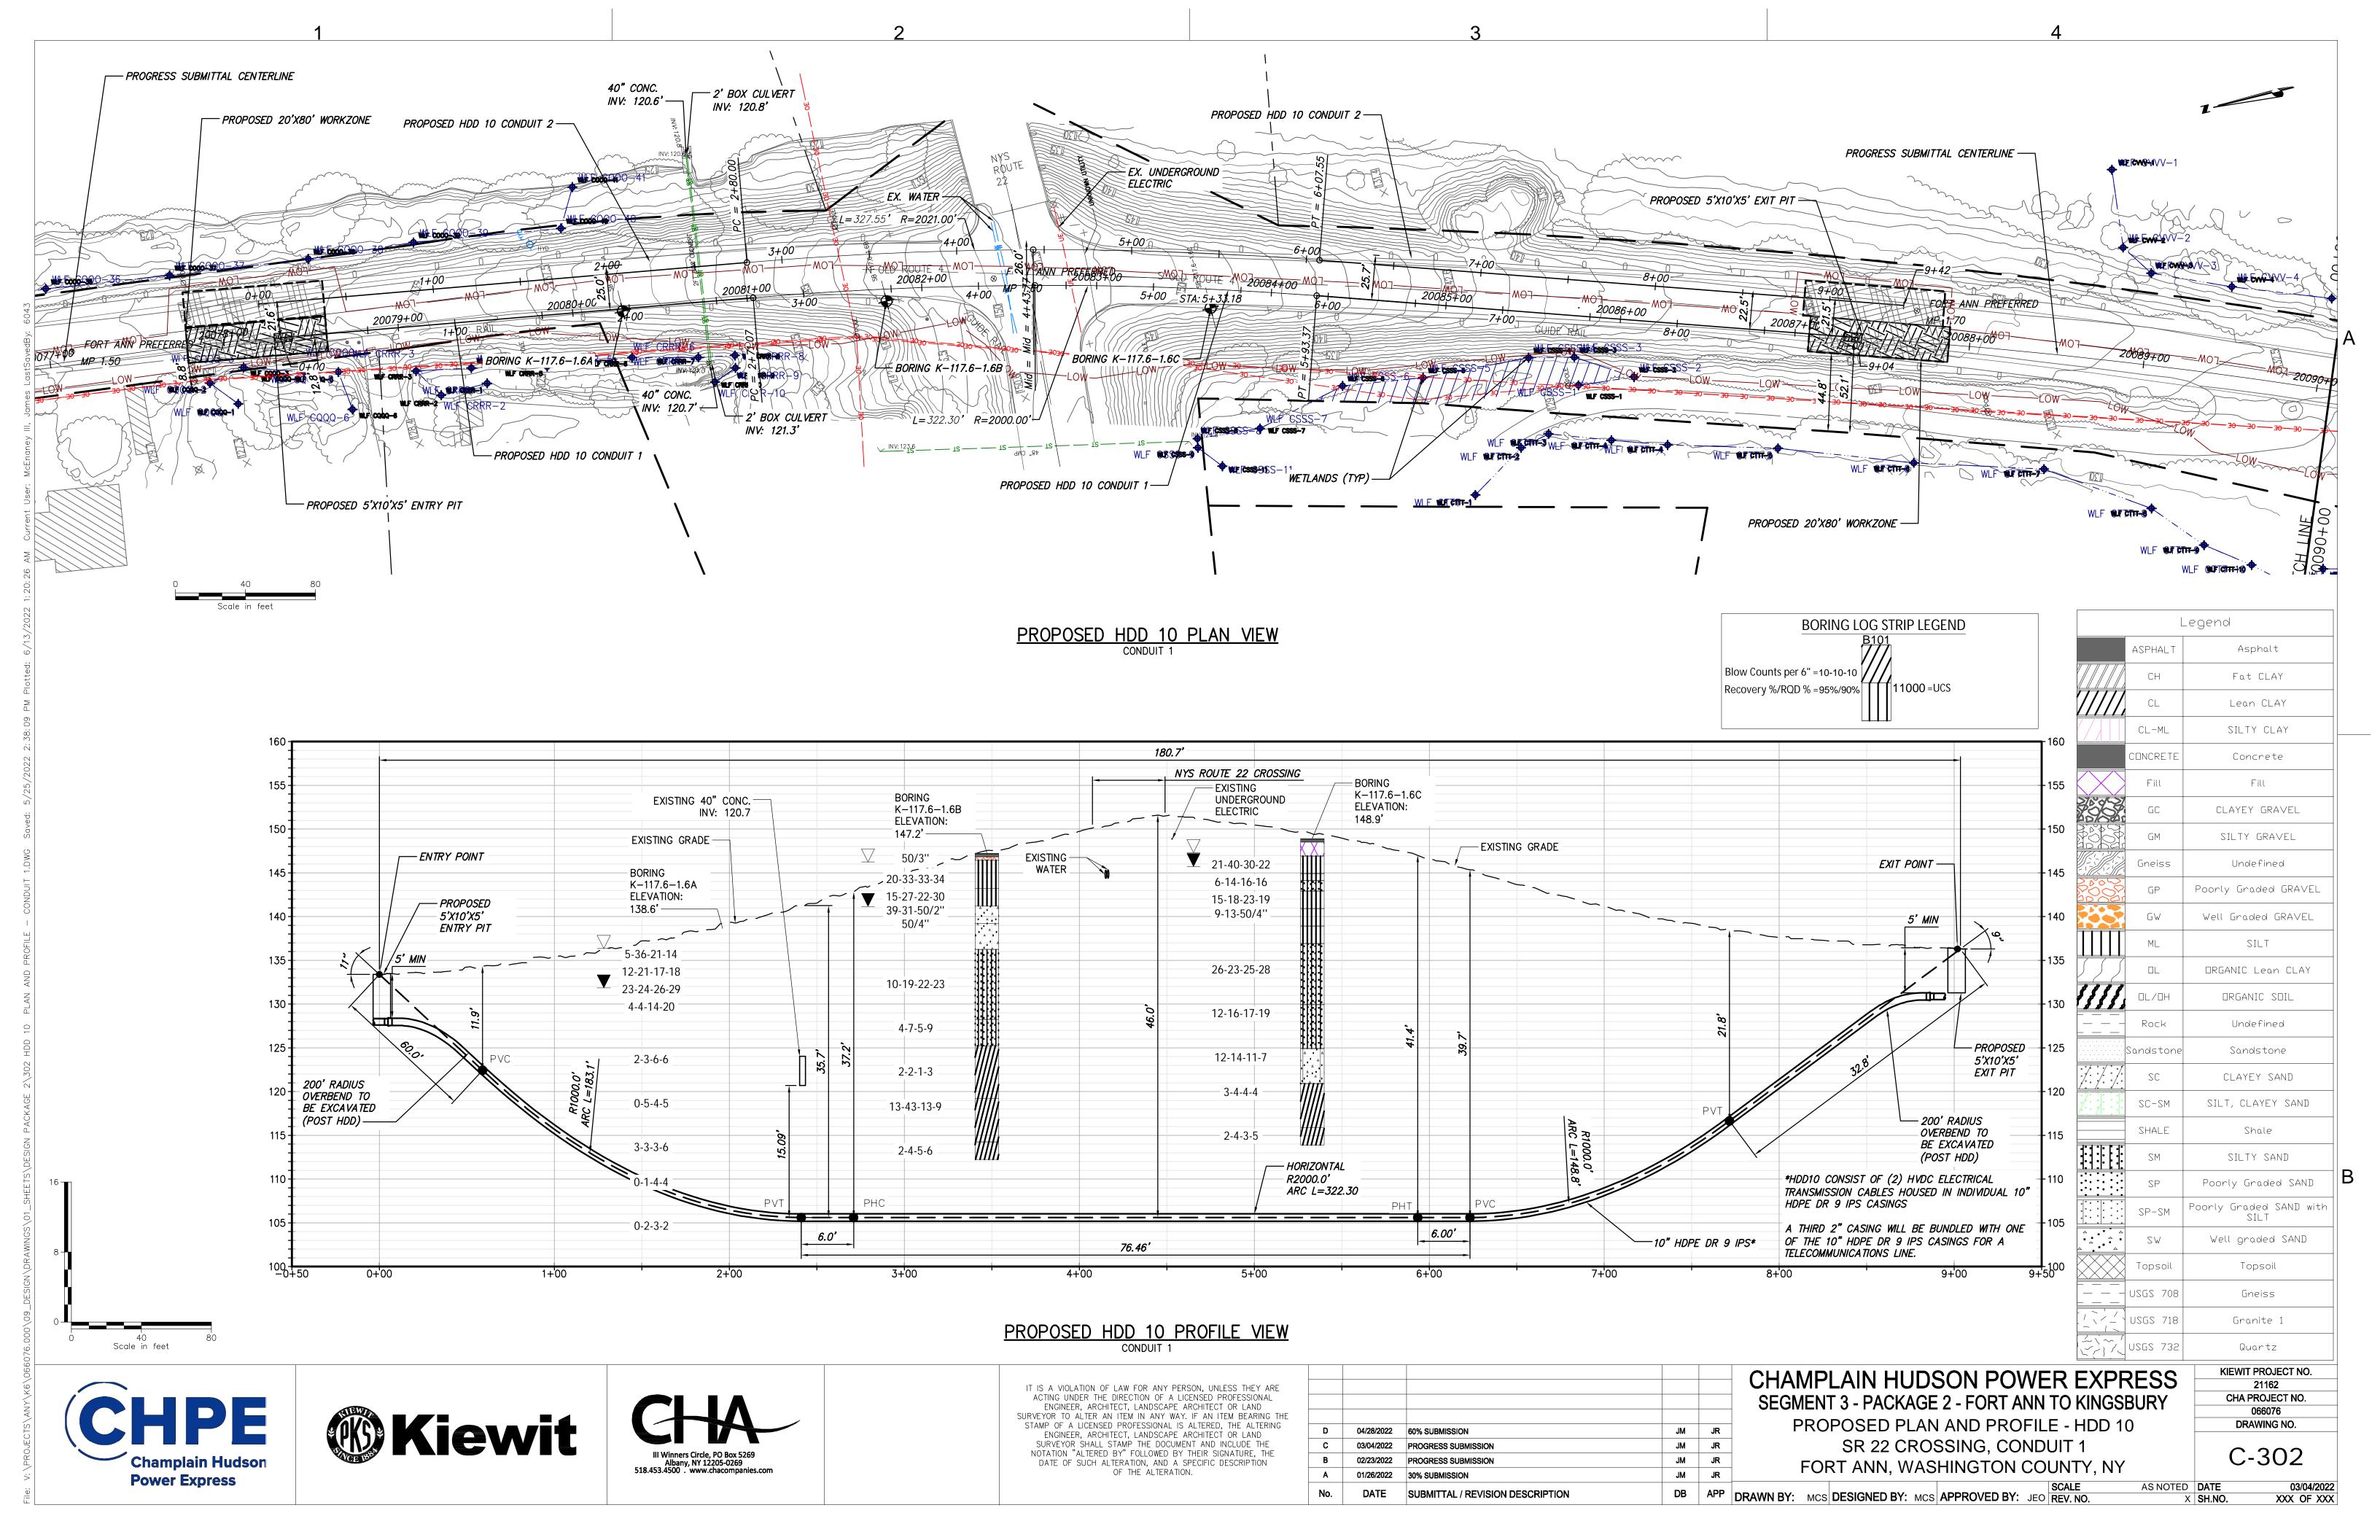


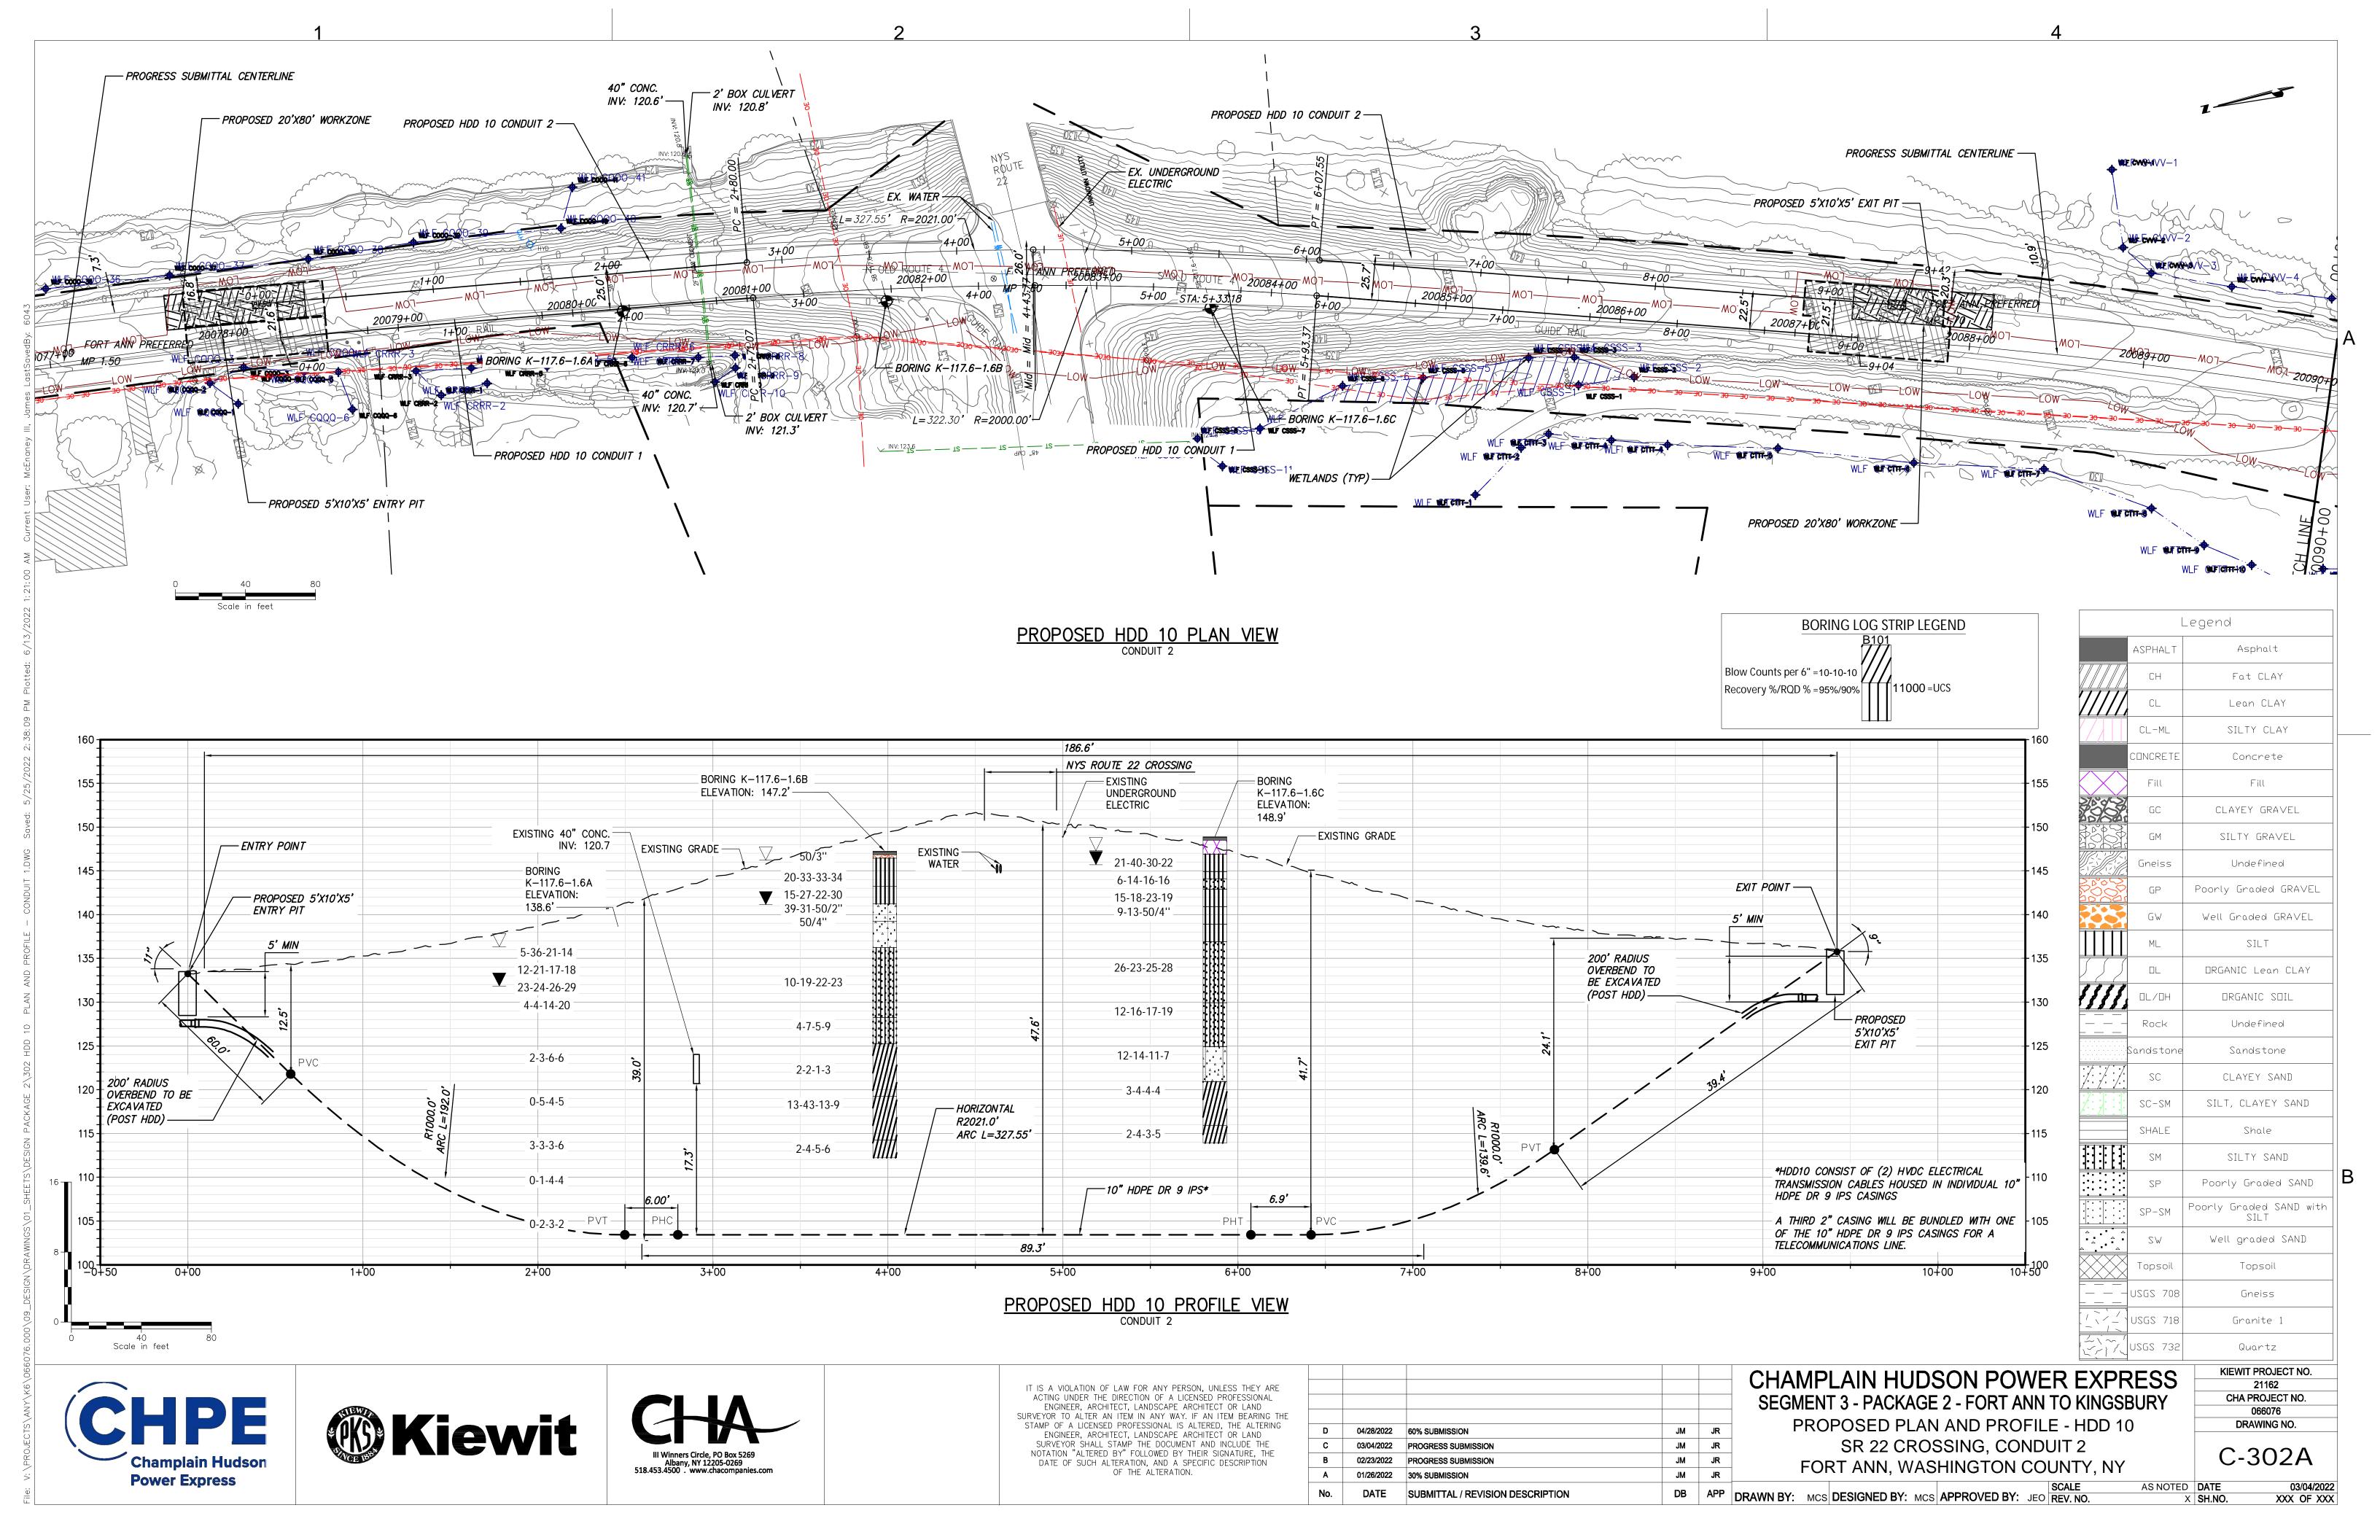

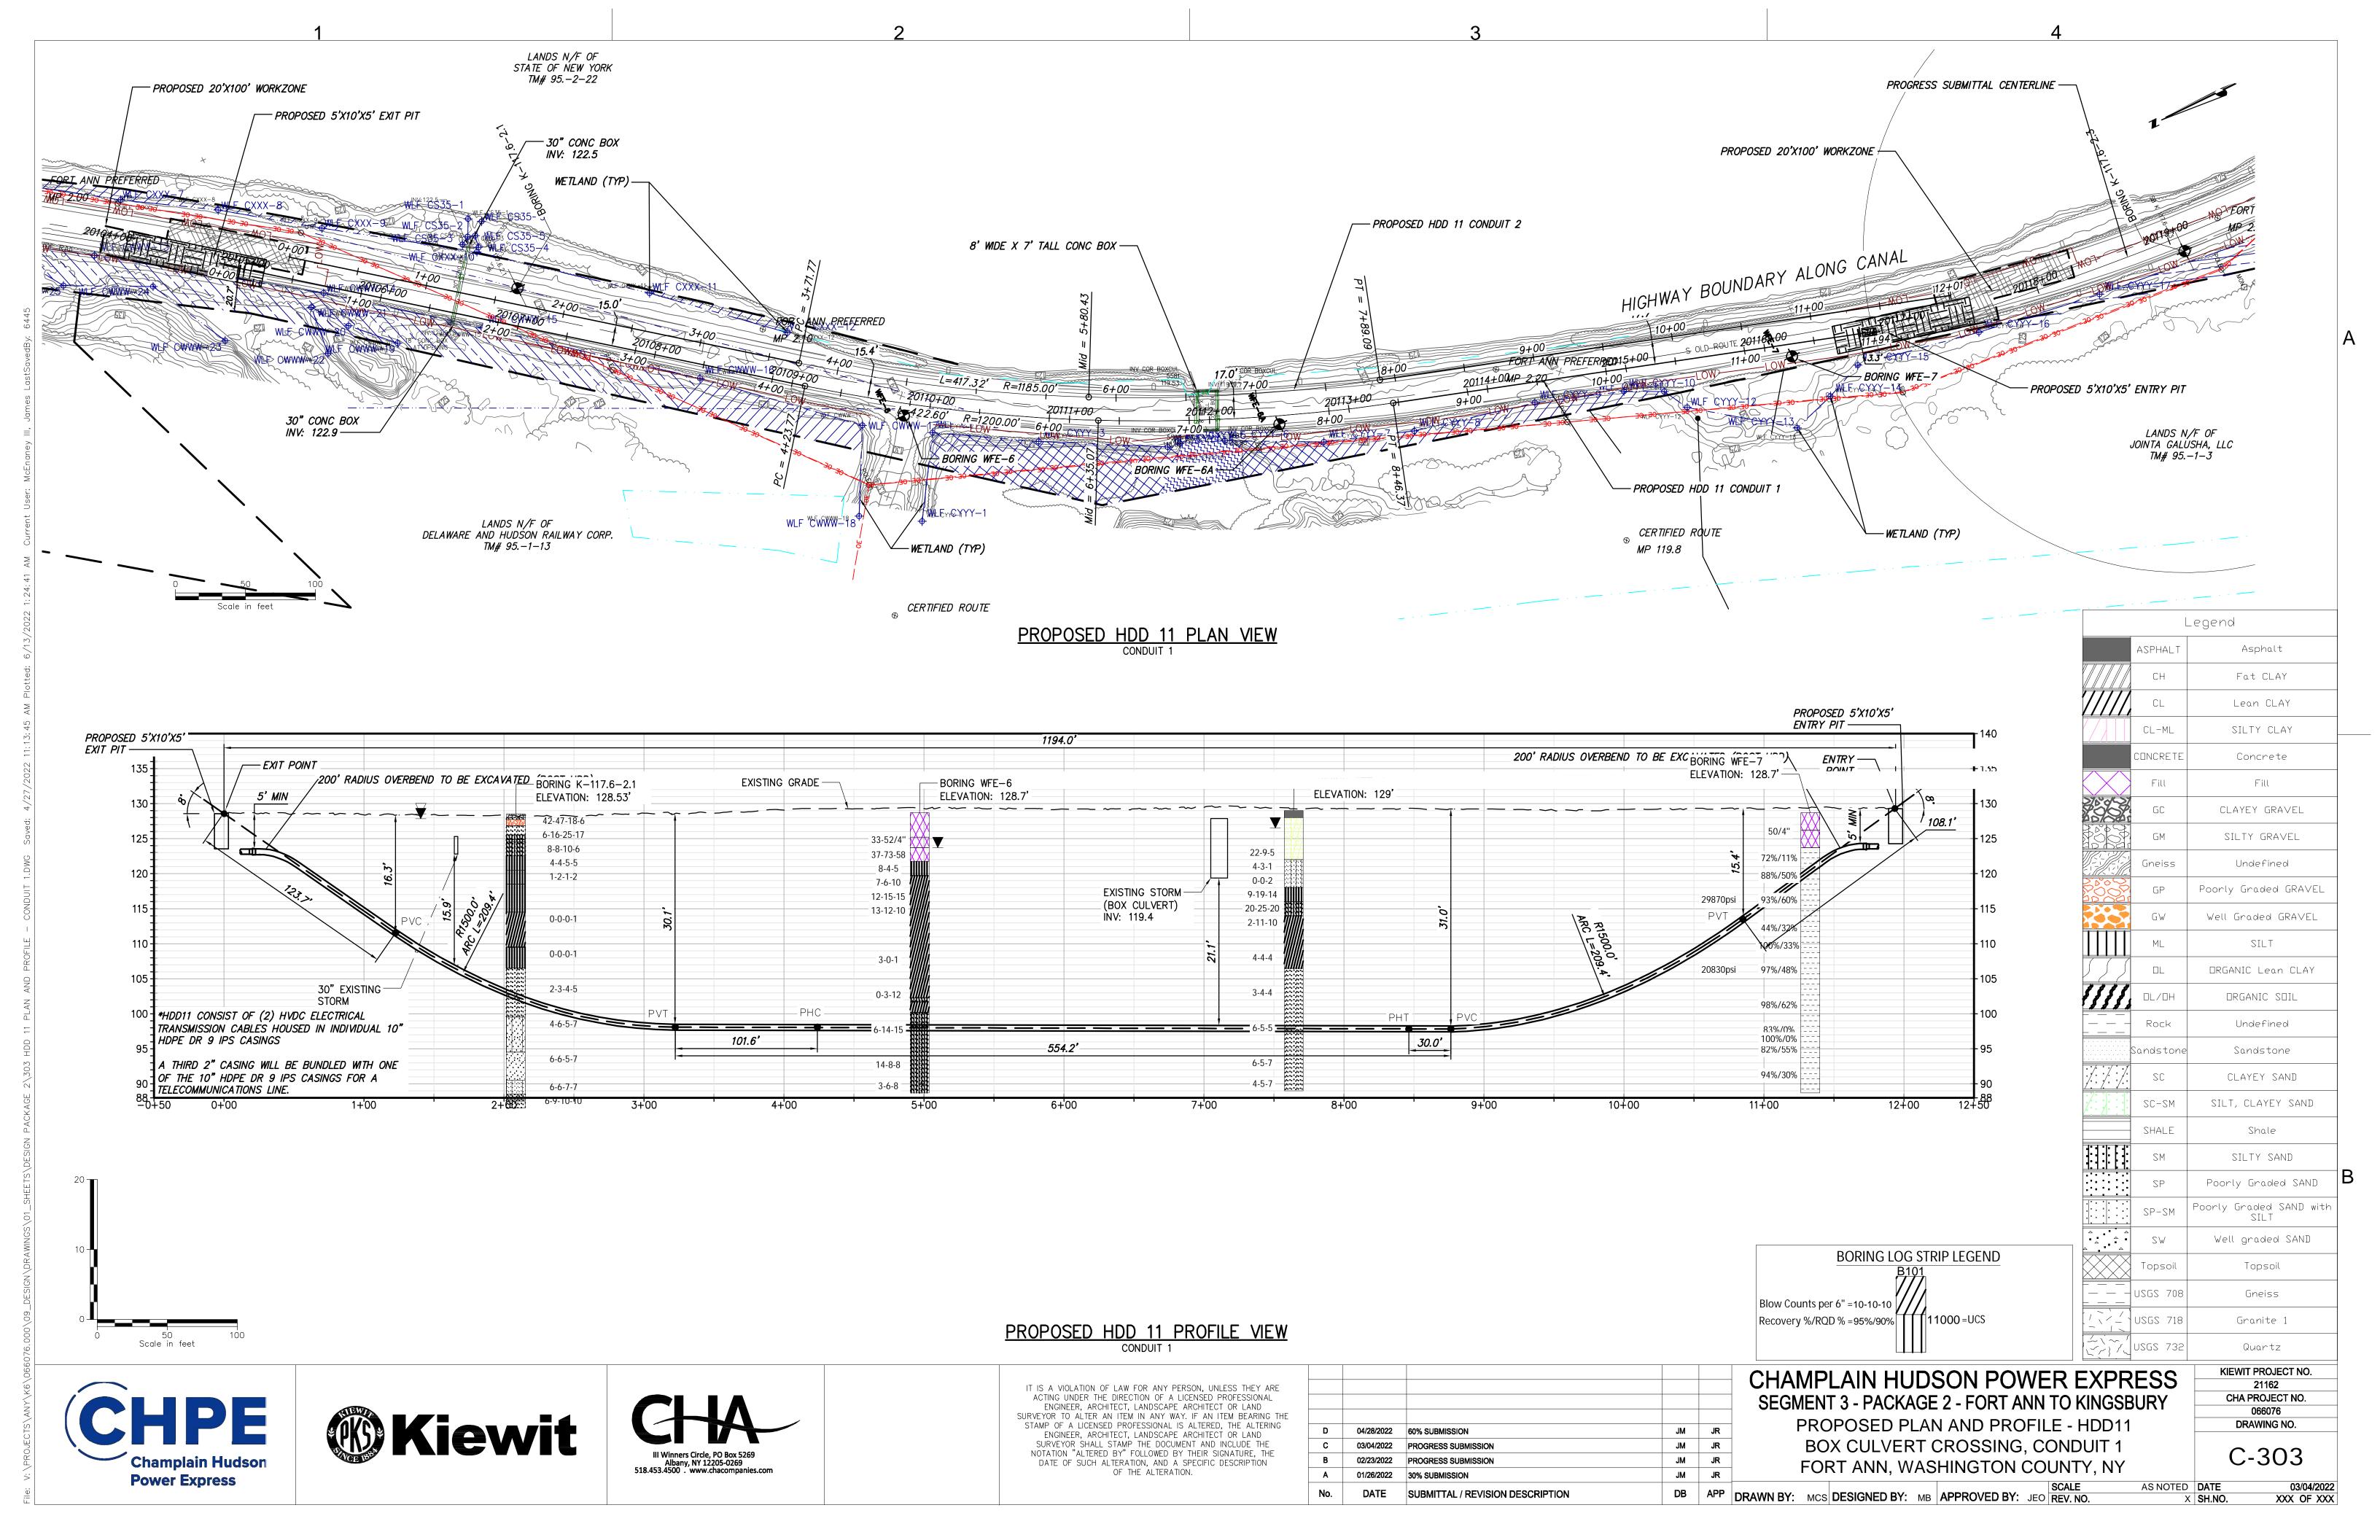

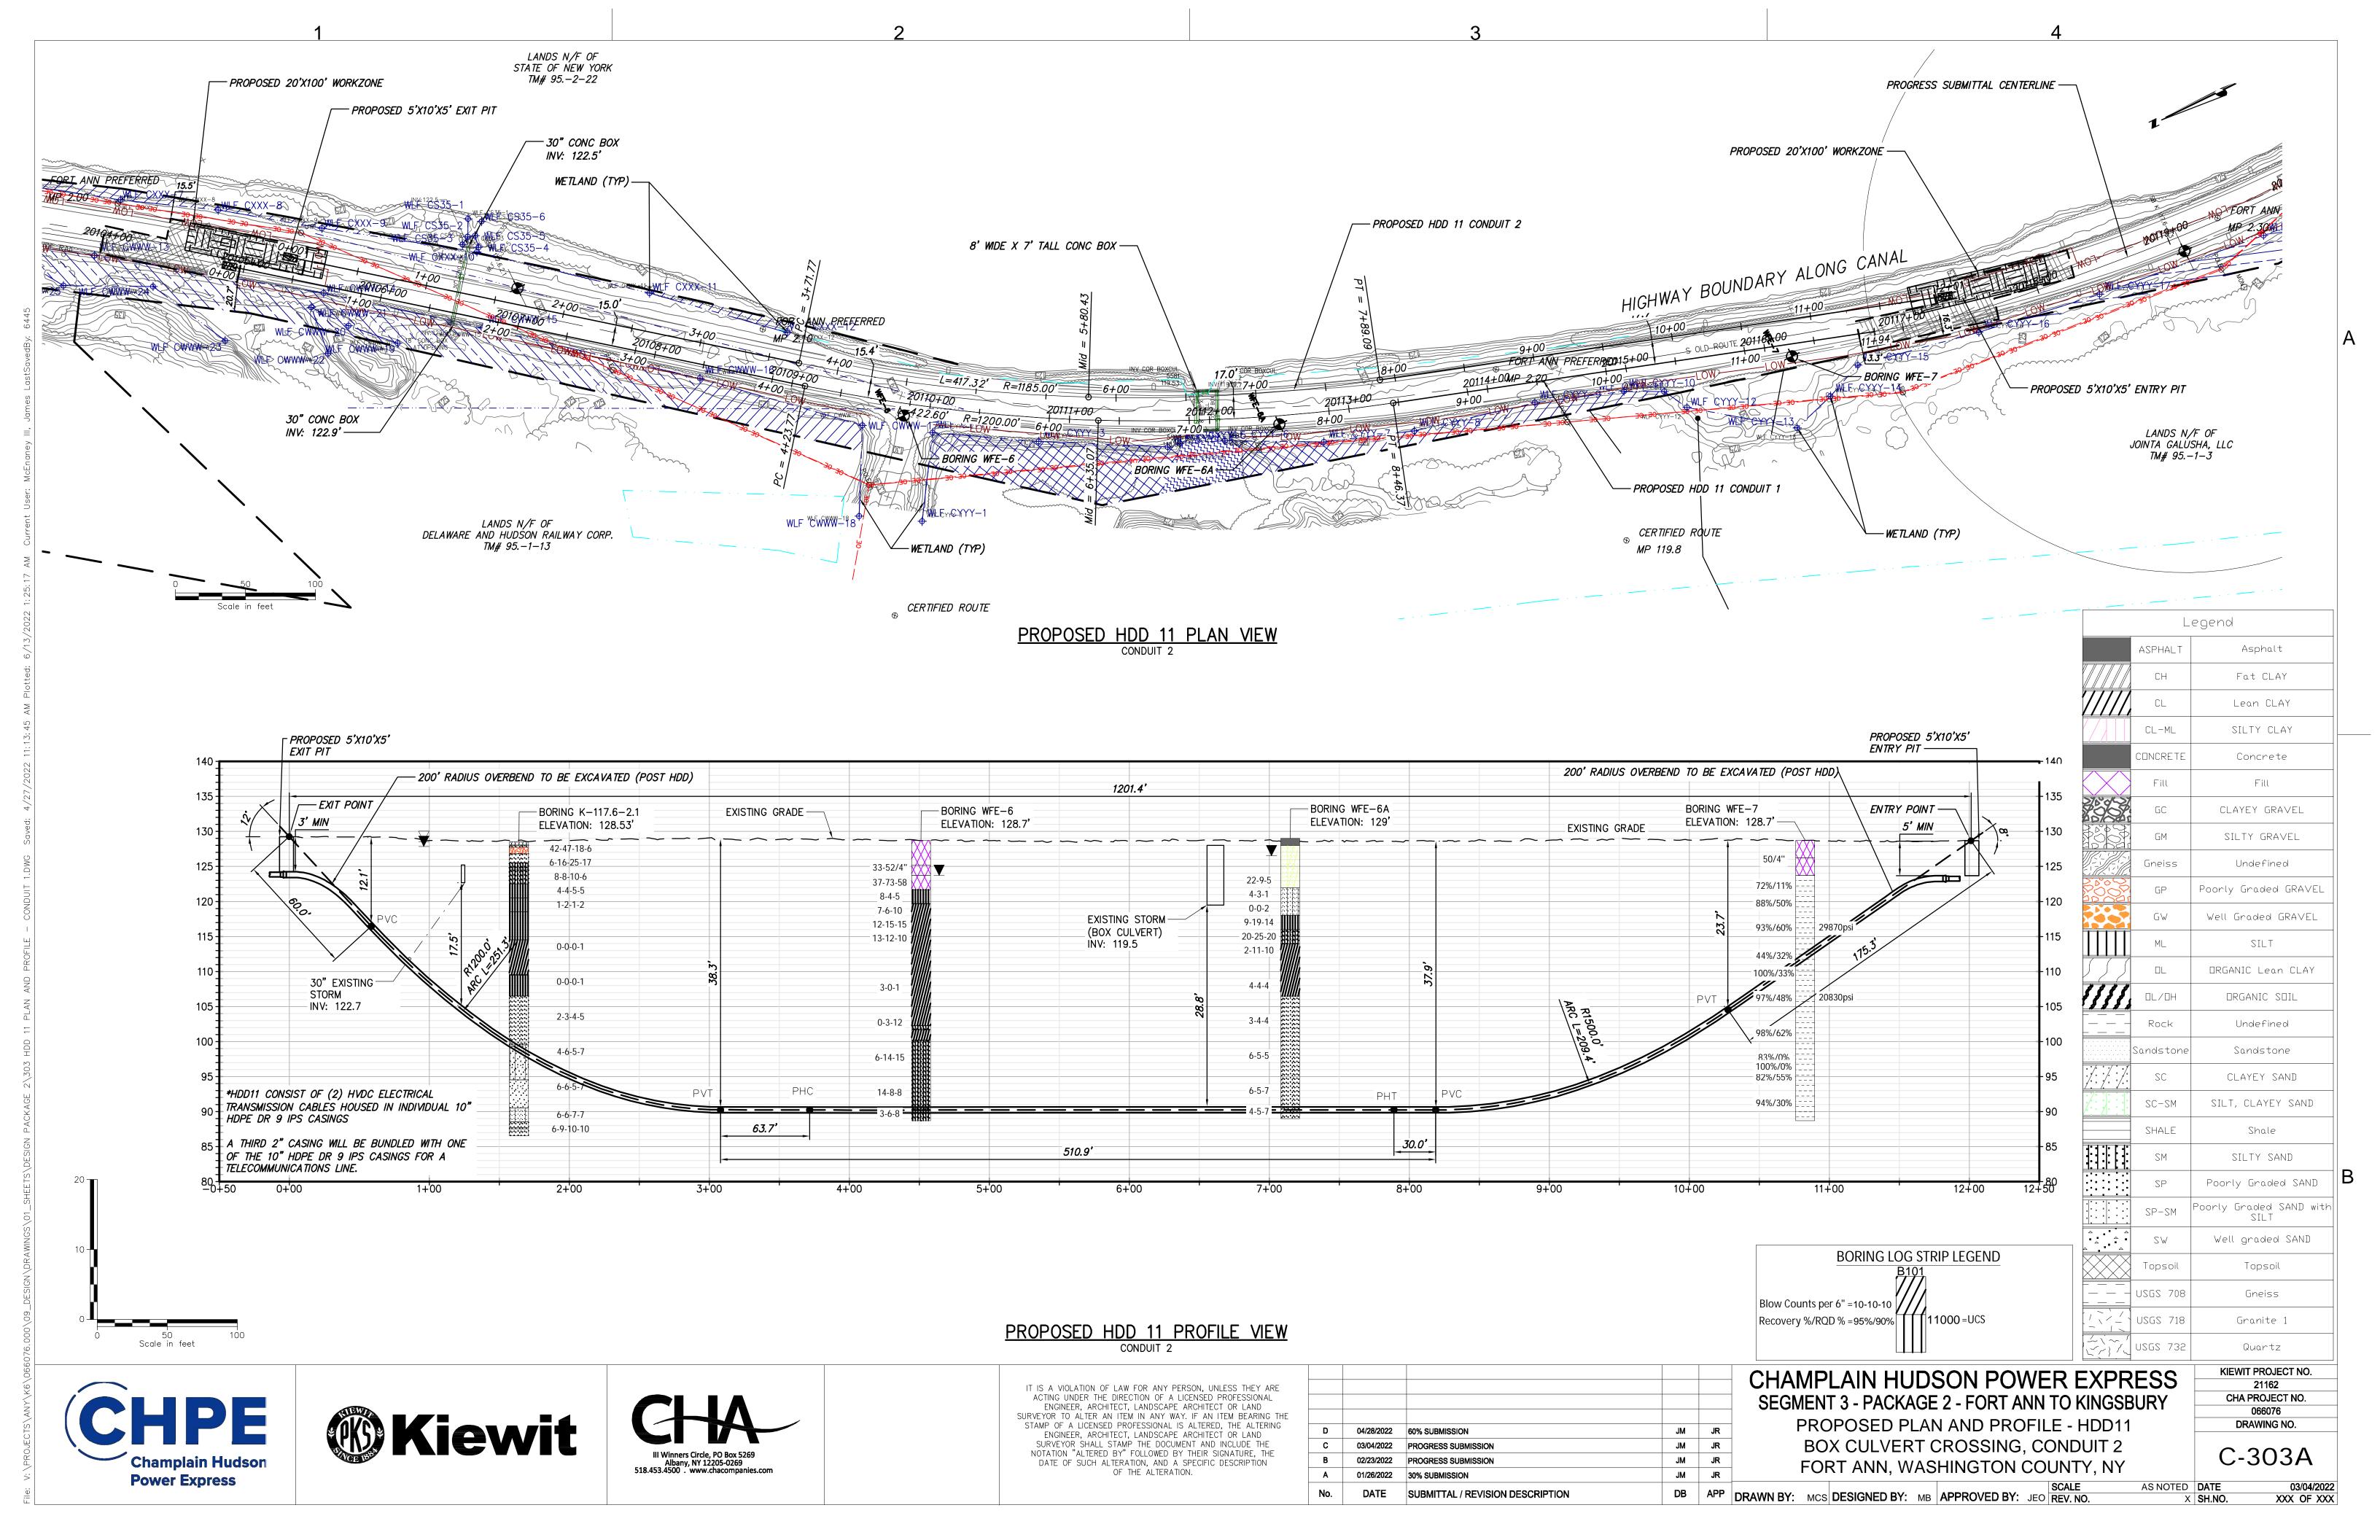


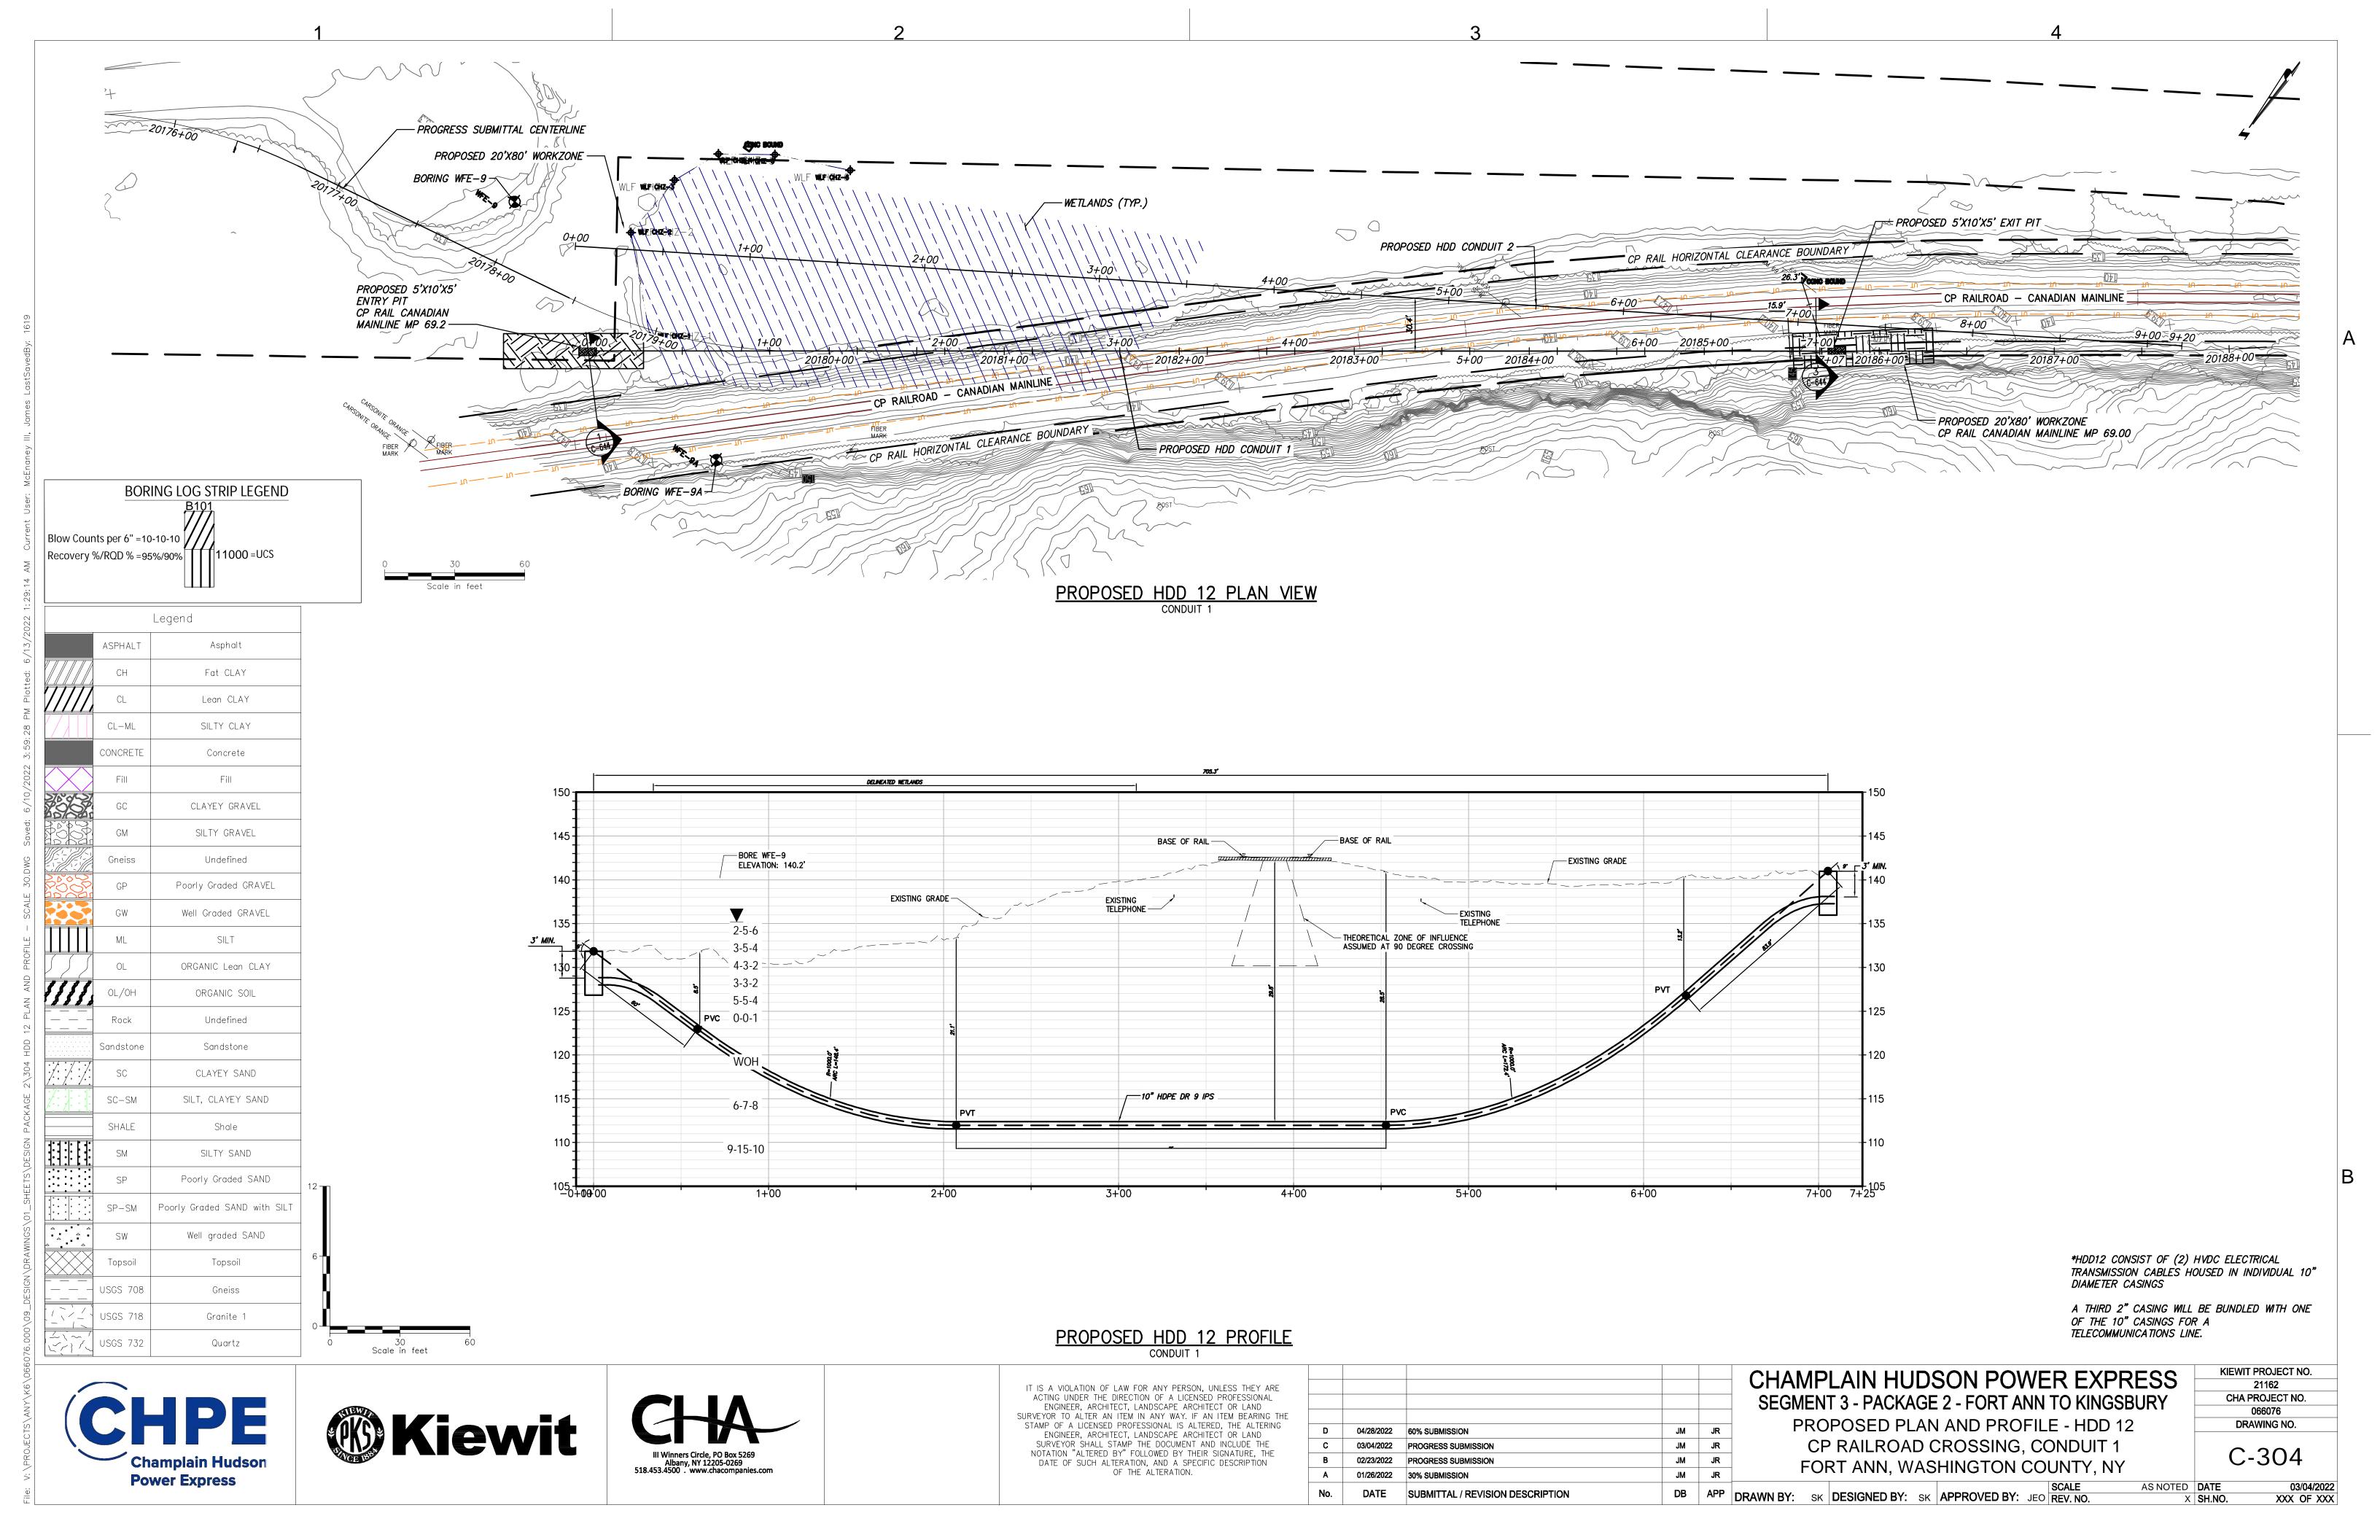


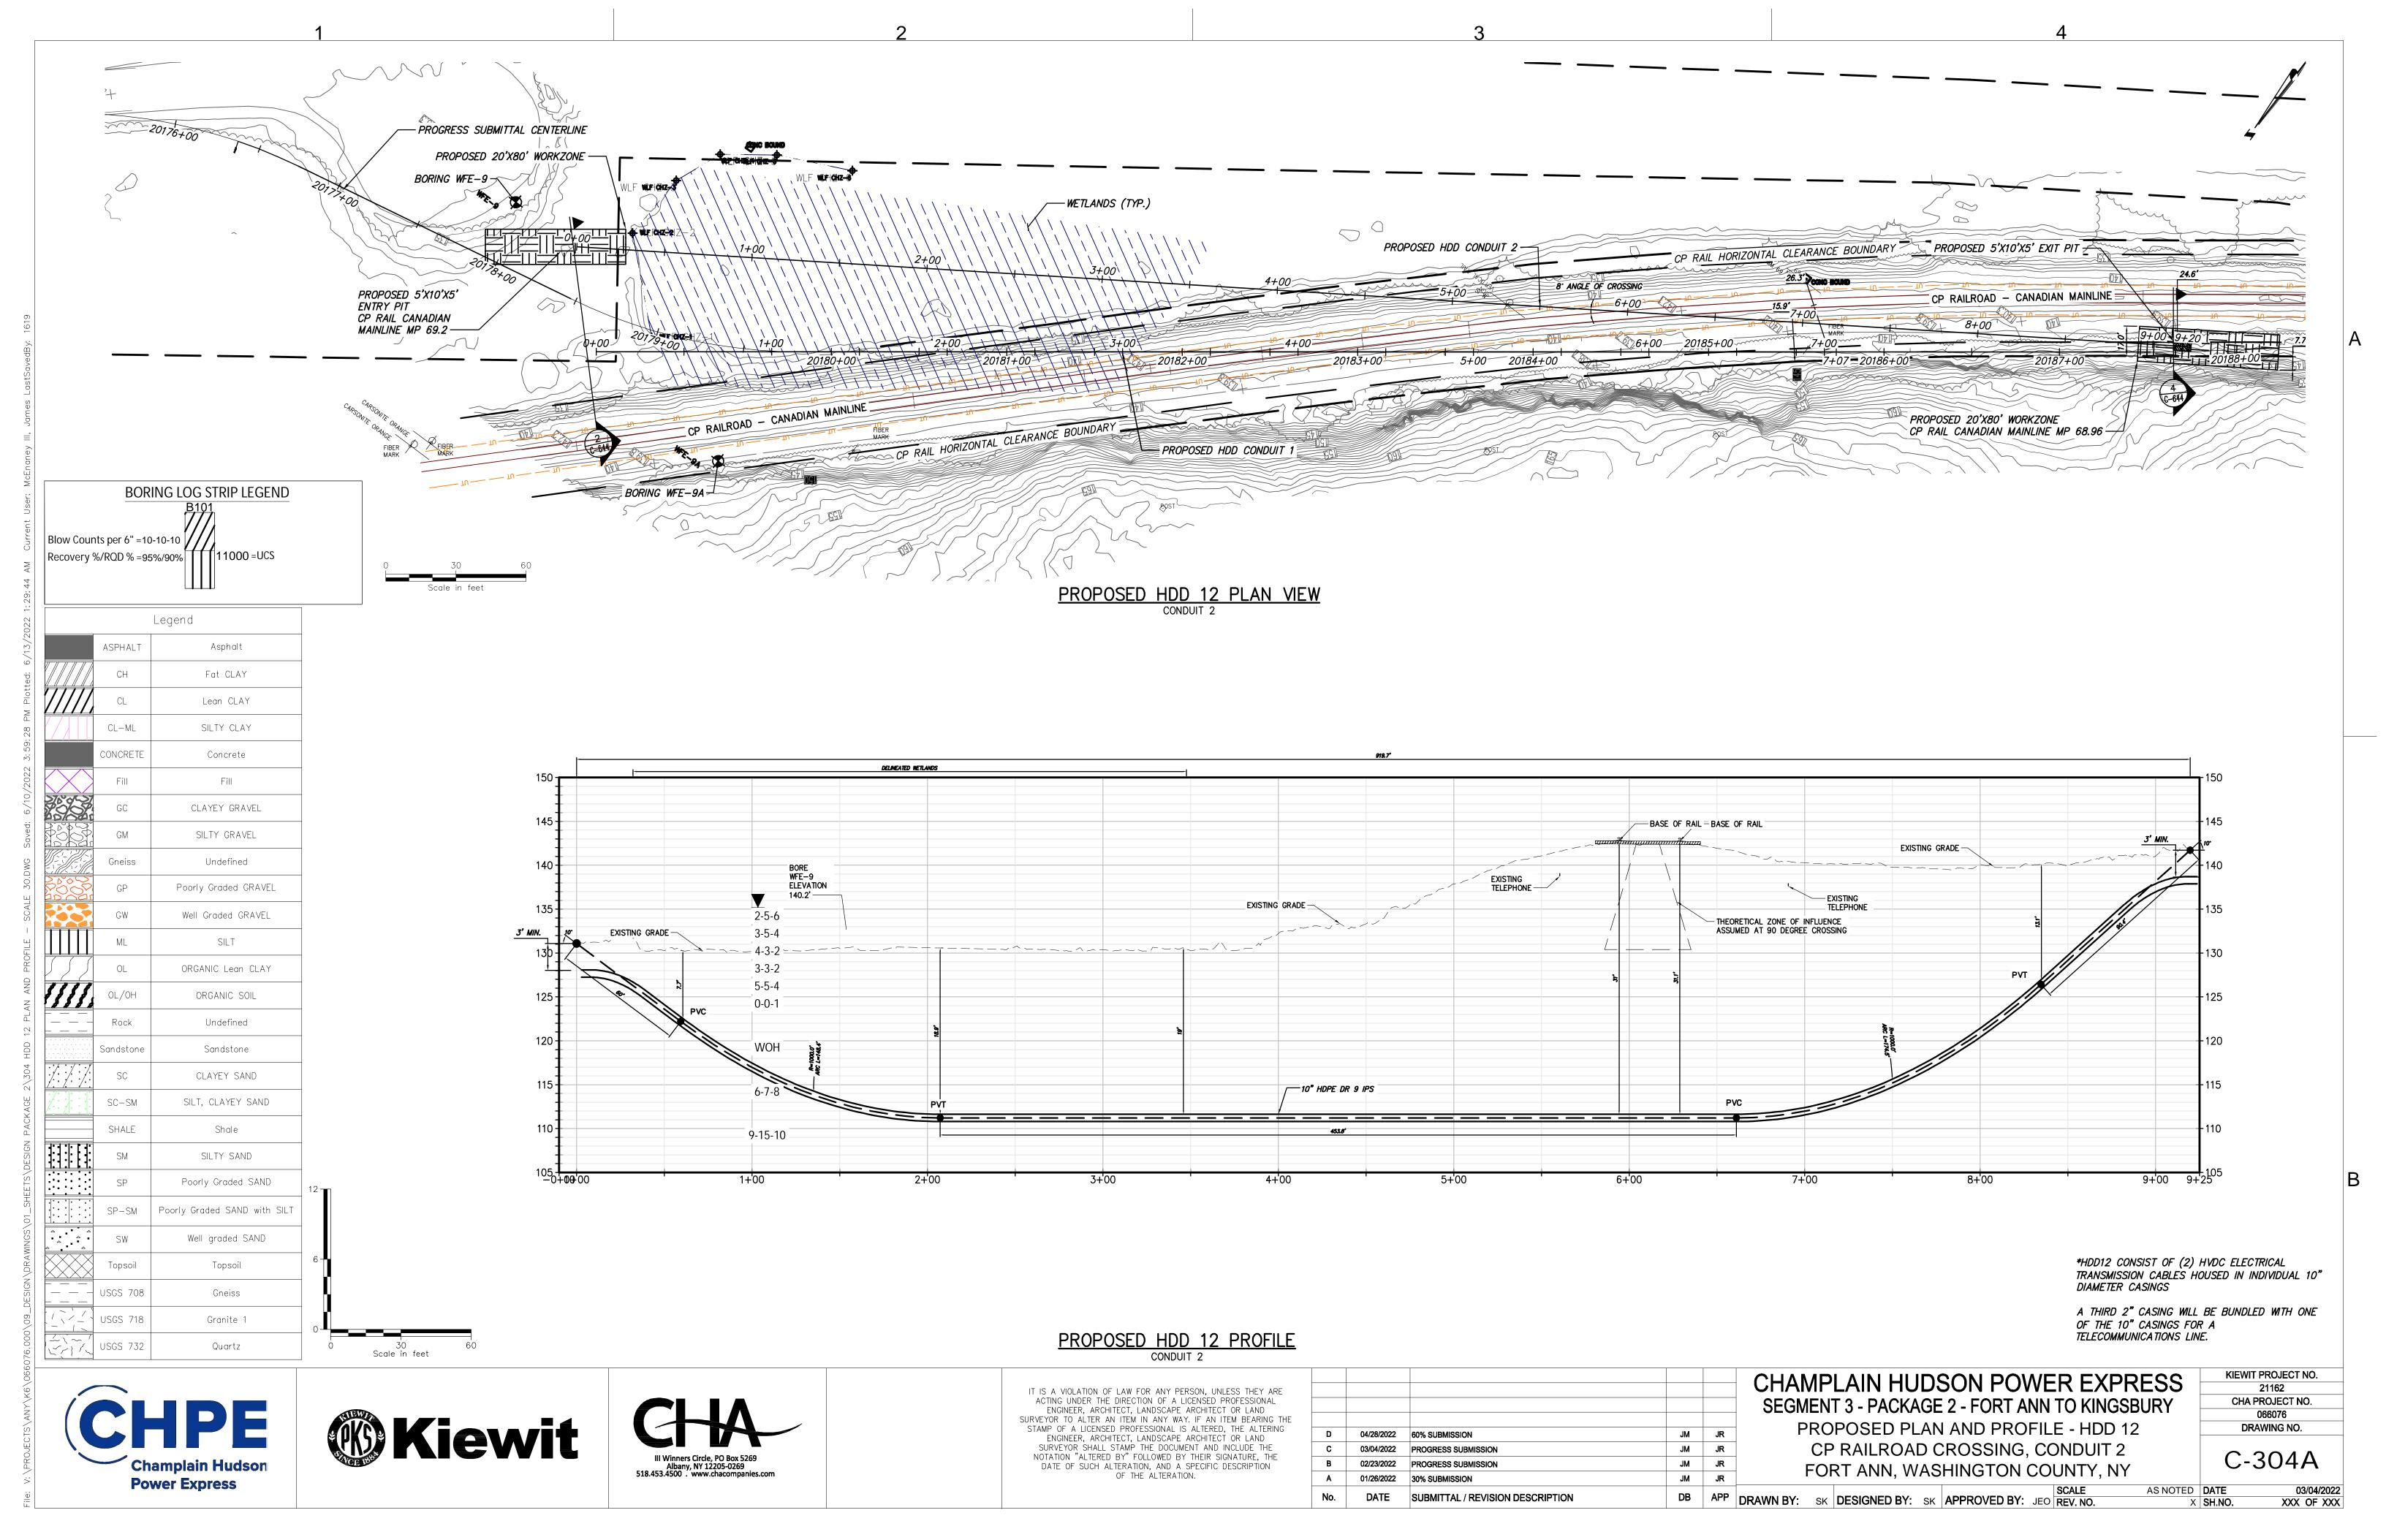


1. SLOPE SHALL BE BASED ON OSHA SHEETING AND SHORING REQUIREMENTS TO BE DETERMINED BY THE COMPETENT PERSON IN THE FIELD.

1 OPEN TRENCH (30" WIDTH, 16" CENTER TO CENTER SPACING)
NOT TO SCALE

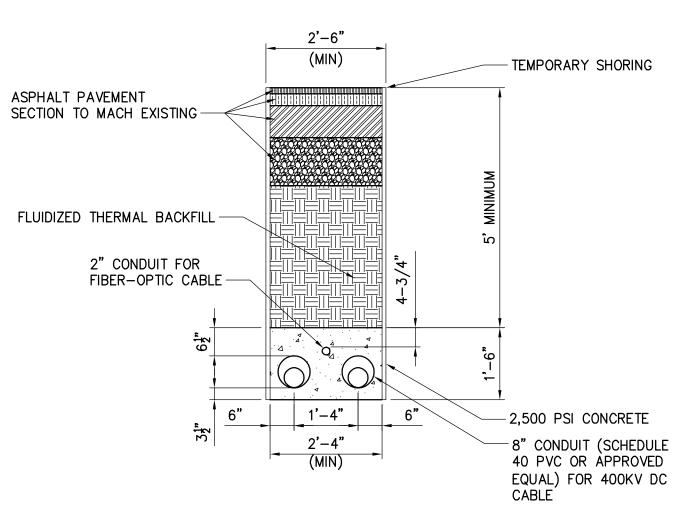


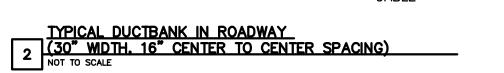

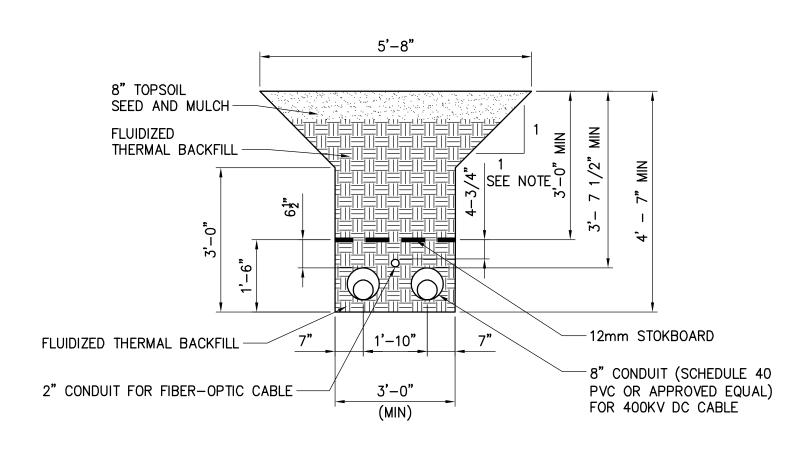


1. SLOPE SHALL BE BASED ON OSHA SHEETING AND SHORING REQUIREMENTS TO BE DETERMINED BY THE COMPETENT PERSON IN THE FIELD.

OPEN TRENCH (36" WIDTH. 22" CENTER TO CENTER SPACING)
NOT TO SCALE

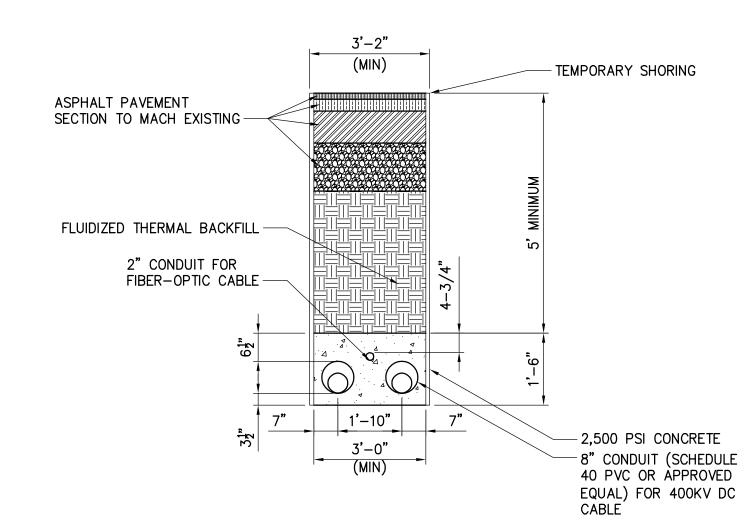


TYPICAL DUCTBANK IN ROADWAY

(36" WDTH. 22" CENTER TO CENTER SPACING)

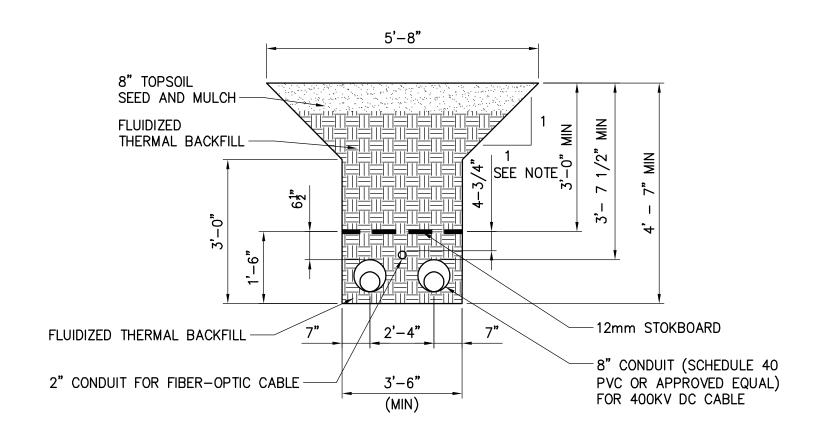

1. SLOPE SHALL BE BASED ON OSHA SHEETING AND SHORING REQUIREMENTS TO BE DETERMINED BY THE COMPETENT PERSON IN THE FIELD.

4 OPEN TRENCH (42" WIDTH. 28" CENTER TO CENTER SPACING)
NOT TO SCALE

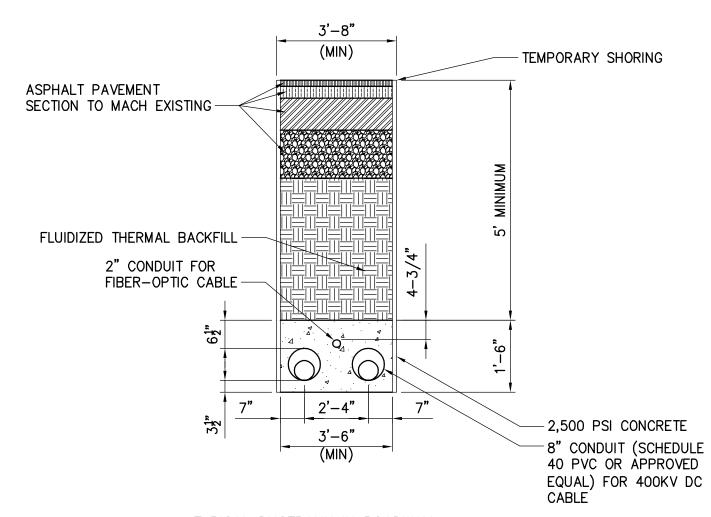

TYPICAL DUCTBANK IN ROADWAY

(42" WIDTH. 28" CENTER TO CENTER SPACING)

Champlain Hudson **Power Express** 





NOTATION "ALTERED BY" FOLLOWED BY THEIR SIGNATURE, THE  DATE OF SUCH ALTERATION, AND A SPECIFIC DESCRIPTION  OF THE ALTERATION.
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					SEGMENT 3 - PACKAGE 2 - FORT ANN TO KIN
D	04/28/2022	60% SUBMISSION	JM	JR	TRENCH CROSS SECTION DETAIL
С	03/04/2022	PROGRESS SUBMISSION	JM	JR	
В	02/23/2022	PROGRESS SUBMISSION	JM	JR	
Α	01/26/2022	30% SUBMISSION	JM	JR	
No.	DATE	SUBMITTAL / REVISION DESCRIPTION	DB	APP	DRAWN BY: XXX DESIGNED BY: XXX APPROVED BY: XXX REV. NO.

CHAMPLAIN HUDSON POWER EXPRESS
SEGMENT 3 - PACKAGE 2 - FORT ANN TO KINGSBURY
TRENCH CROSS SECTION DETAILS

KIEWIT PROJECT NO. 21162 CHA PROJECT NO. 066076 DRAWING NO.


C-621

AS NOTED DATE 03/04/2022


XXX OF XXX

X SH.NO.



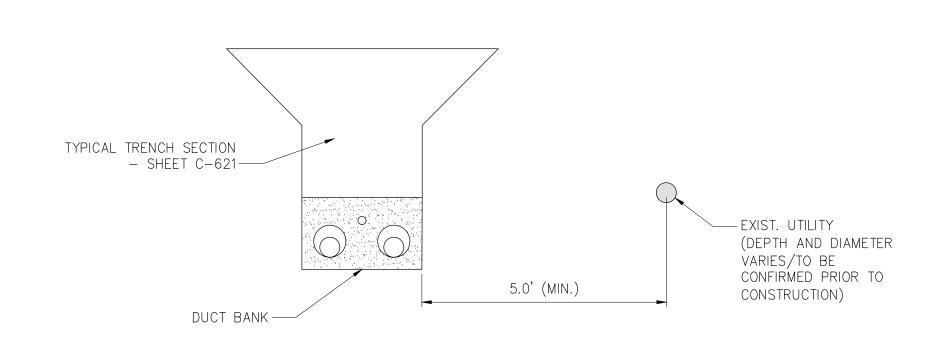


TYPICAL TRENCH SECTION
- SHEET C-621-EXIST. UTILITY 2.0' (MIN.) (DEPTH AND DIAMETER VARIES/TO BE CONFIRMED PRIOR TO CONSTRUCTION) DUCT BANK-

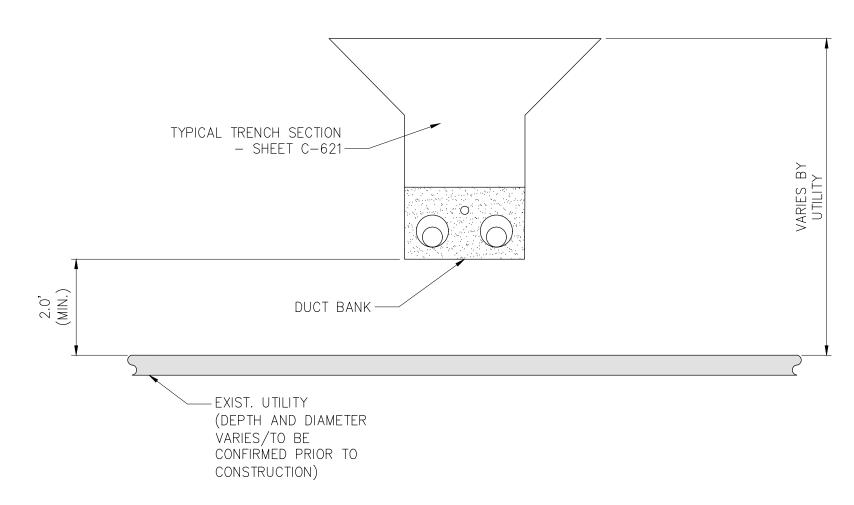

1 OPEN TRENCH - HORIZONTAL SEPARATION
NOT TO SCALE

3 OPEN TRENCH - VERTICAL SEPARATION (UNDER)
NOT TO SCALE

5 OPEN TRENCH - VERTICAL SEPARATION (OVER)
NOT TO SCALE

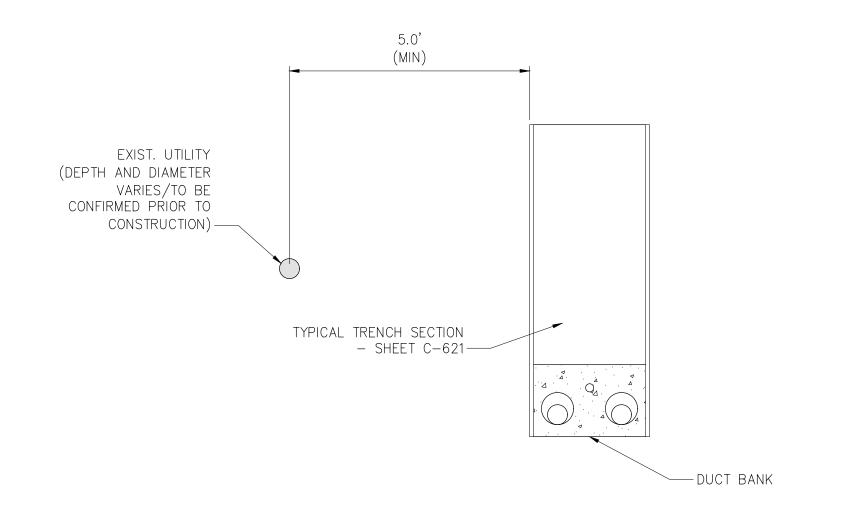

EXIST. UTILITY (DEPTH AND DIAMETER VARIES/TO BE CONFIRMED PRIOR TO CONSTRUCTION) — TYPICAL TRENCH SECTION
- SHEET C-621TYPICAL TRENCH SECTION
- SHEET C-621-- DUCT BANK - EXIST. UTILITY (DEPTH AND DIAMETER VARIES/TO BE CONFIRMED PRIOR TO CONSTRUCTION)

2 TYPICAL DUCTBANK IN ROADWAY - HORIZONTAL SEPARATION
NOT TO SCALE

4 TYPICAL DUCTBANK IN ROADWAY - VERTICAL SEPARATION (UNDER)
NOT TO SCALE

6 TYPICAL DUCTBANK IN ROADWAY - VERTICAL SEPARATION (OVER)







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OF THE ALTERATION.

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G	06/20/2022	PROGRESS SUBMISSION	JM	JR	_	LAIN HUD	
F	05/06/2022	PROGRESS SUBMISSION	JM	JR	SEGMEN <sup>*</sup>	T 3 - PACKAGE	: 2 - FORT AN
E	03/17/2022	PROGRESS SUBMISSION	JM	JR		UTUU	TV TVDIC AL
D	02/04/2022	PROGRESS SUBMISSION	JM	JR		UTILI	TY TYPICAL
С	01/28/2022	PROGRESS SUBMISSION	JM	JR		SEPARA	ATION DETA
В	12/21/2021	PROGRESS SUBMISSION	JM	JR			
Α	11/02/2021	30% SUBMISSION	JM	JR			
No.	DATE	SUBMITTAL / REVISION DESCRIPTION	DB	APP	DRAWN BY: wso	DESIGNED BY: wso	APPROVED BY:

CHAMPLAIN HUDSON POWER EXPRESS
SEGMENT 3 - PACKAGE 2 - FORT ANN TO KINGSBURY
UTILITY TYPICAL
SEPARATION DETAILS

KIEWIT PROJECT NO.	
21162	
CHA PROJECT NO.	
066076	
DRAWING NO.	
C-901	

XXX OF XXX

AS NOTED DATE

# CHAMPLAIN HUDSON POWER EXPRESS

SEGMENT 3 - PACKAGE 2 - FORT ANN TO KINGSBURY WASHINGTON COUNTY, NEW YORK CI OWNER SUBMISSION (July 14, 2022)


#### NOTES TO CO-LOCATED INFRASTRUCTURE REVIEWERS:

Please review the attached information regarding the CHPE alignment relating to your infrastructure and provide your concurrence of the Project's cables separation and alignment and any feedback to ben.cole@wsp.com. It is important to TDI that the construction and operation of the CHPE does not interfere with the continued operation of your infrastructure.

See applicable locations depicting crossing(s) and/or parallel interactions with assets owned by your organization. Specific details applicable to each crossing are currently being developed and will depend on depth of existing co-located infrastructure and other site conditions identified in the field. However, Utility Typical Separation Details are presented on Drawing No. C-901 for your review and discussion initiation.

The basis of design for this package as it relates to the proposed Horizontal and Vertical underground separations from all Co-Located Infrastructure is 5' (H) and 2' (V). These separation distances are to be maintained as a minimum at all times and any variances (i.e. closer) will be presented to your organization prior to implementation and called out specifically on the plans.

Note that there may be some gaps in the pages provided, this is intentional as some of the pages do not present assets owned by your organization. In addition, please see attached the Champlain Hudson Power Express "Upland Co-Located Utility Summation Matrix" for the location (by Station) of assets that may interact with the proposed project.

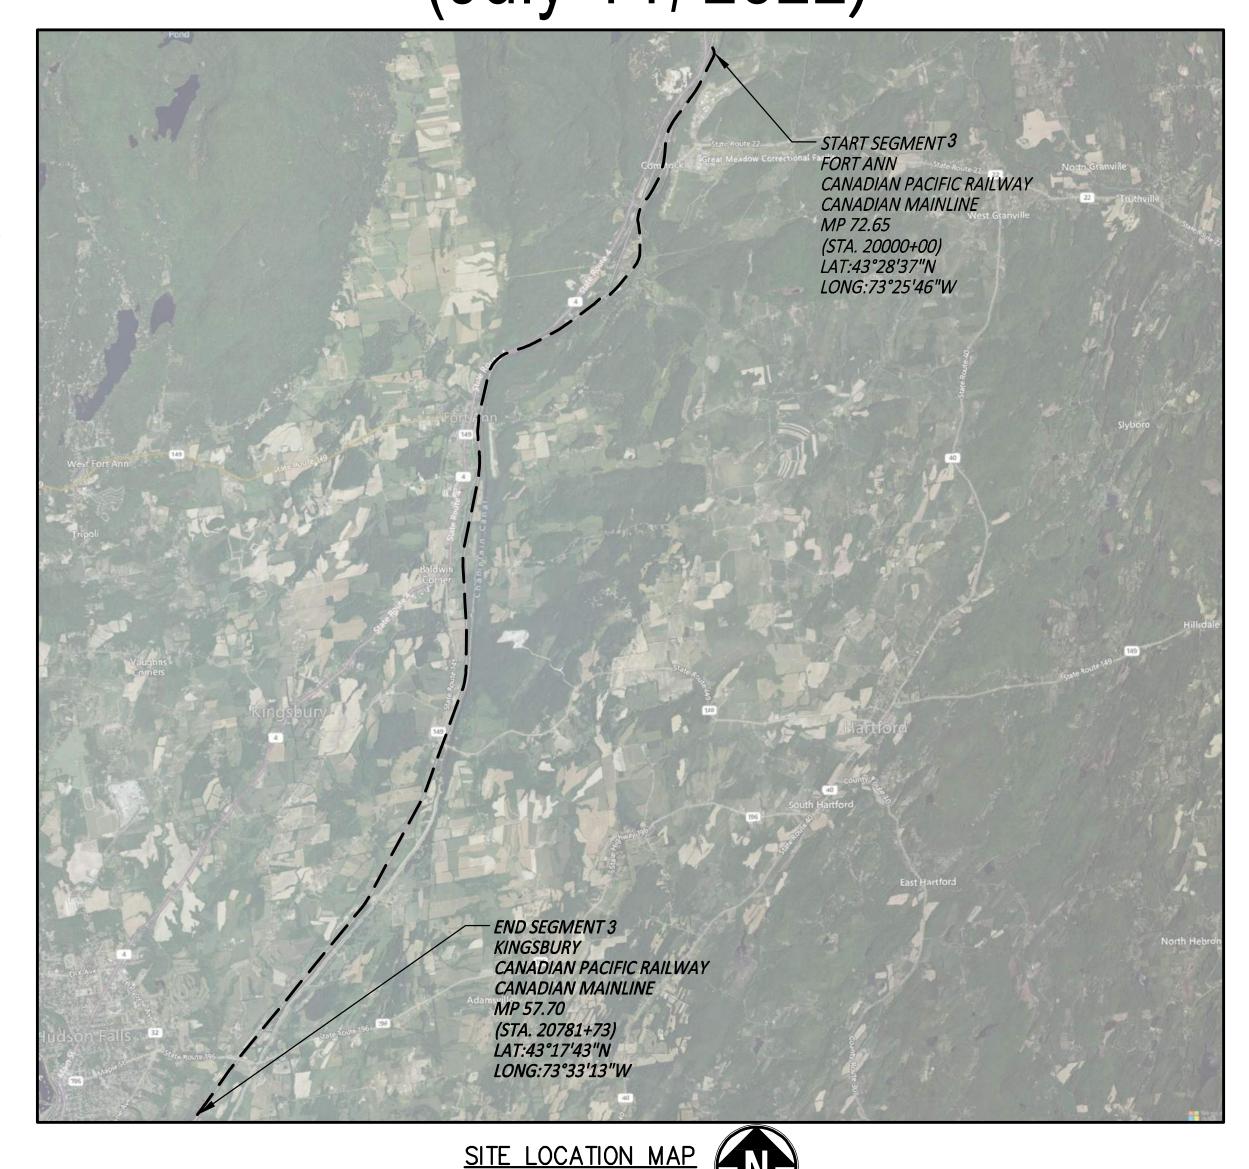

Note: This is a copy of the Plan and Profiles that were provided to Verizon

NOT FOR CONSTRUCTION

**Power Express** 





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Α	01/26/2022	30% SUBMISSION	JM	JR	
No.	DATE	SUBMITTAL / REVISION DESCRIPTION	DB	APP	D

CHAMPLAIN HUDSON POWER EXPRESS **SEGMENT 3 - PACKAGE 2 - FORT ANN TO KINGSBURY COVER SHEET** 

KIEWIT PROJECT NO. CHA PROJECT NO. DRAWING NO.

G-000

AS NOTED DATE

RAWN BY: JTM DESIGNED BY: JTM APPROVED BY: JPR REV. NO.





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No.	DATE	SUBMITTAL / REVISION DESCRIPTION	DB	APP

CHAMPLAIN HUDSON POWER EXPRESS SEGMENT 3 - PACKAGE 2 - FORT ANN TO KINGSBURY SHEET INDEX

KIEWIT PROJECT NO. 21162 CHA PROJECT NO. 066076 DRAWING NO.

G-001

DRAWN BY: JTM DESIGNED BY: JTM APPROVED BY: JPR REV. NO.

AS NOTED DATE X SH.NO.

- 2. THE GENERAL CONTRACTOR SHALL STRICTLY ADHERE TO THE STORM WATER POLLUTION PREVENTION PLAN (SWPPP) DURING CONSTRUCTION OPERATIONS.
- 3. NO LAND CLEARING OR GRADING SHALL BEGIN UNTIL ALL PERIMETER EROSION AND SEDIMENT CONTROL MEASURES HAVE BEEN INSTALLED. (WETLAND PROTECTION FENCE, SILT FENCE AND STABILIZED CONSTRUCTION ENTRANCE)
- 4. SITE DISTURBANCE SHALL NOT EXCEED FIVE (5) ACRES OF SOIL AT ANY ONE TIME WITHOUT PRIOR WRITTEN AUTHORIZATION FROM NYSDEC.
- 5. ALL EXPOSED AREAS SHALL BE SEEDED AND MULCHED AS SPECIFIED WITHIN 7 DAYS OF FINAL GRADING.
- 6. INACTIVE PORTIONS OF THE SITE ARE TO BE SEEDED AND MULCHED AS SPECIFIED WITHIN 7 DAYS.
- 7. SEDIMENT AND EROSION CONTROL MEASURES SHALL BE INSPECTED AT LEAST ONCE EVERY SEVEN (7) DAYS OR MORE FREQUENTLY IF REQUIRED. ALL MAINTENANCE REQUIRED BY INSPECTION SHALL COMMENCE WITHIN 24 HOURS AND BE COMPLETED WITHIN 48 HOURS OF REPORT.
- 8. THIS PLAN SHALL NOT BE CONSIDERED ALL INCLUSIVE AS THE GENERAL CONTRACTOR SHALL TAKE ALL NECESSARY PRECAUTIONS TO PREVENT SOIL SEDIMENT FROM LEAVING THE SITE.
- 9. GENERAL CONTRACTOR SHALL COMPLY WITH ALL STATE AND LOCAL ORDINANCES THAT APPLY.
- 10. ADDITIONAL EROSION AND SEDIMENT CONTROL MEASURES WILL BE INSTALLED IF DEEMED NECESSARY FOLLOWING SITE INSPECTION.
- 11. GENERAL CONTRACTOR SHALL BE RESPONSIBLE TO TAKE WHATEVER MEANS NECESSARY TO ESTABLISH PERMANENT SOIL STABILIZATION.
- 12. AT THE END OF EACH WORK DAY DISTURBED SOILS ARE TO BE REGRADED TO DRAIN INTO THE TEMPORARY DIVERSION SWALES AND DISCHARGES FROM DEWATERING ACTIVITIES ARE TO BE DIRECTED INTO CATCH BASINS OR SWALES.

#### **GENERAL NOTES:**

- 1. THE PLANS SHOW SUBSURFACE STRUCTURES, ABOVE GROUND STRUCTURES AND/OR UTILITIES FROM FIELD LOCATION AND RECORD MAPPING. EXACT LOCATION OF WHICH MAY VARY FROM THE LOCATIONS INDICATED. IN PARTICULAR, THE CONTRACTOR IS WARNED THAT THE EXACT OR EVEN APPROXIMATE LOCATION OF SUCH PIPELINES, SUBSURFACE STRUCTURES AND/OR UTILITIES IN THE AREA MAY BE DIFFERENT FROM THAT SHOWN OR MAY NOT BE SHOWN, AND IT SHALL BE HIS RESPONSIBILITY TO PROCEED WITH GREAT CARE IN EXECUTING ANY WORK. 48 HOURS BEFORE YOU DIG, DRILL, OR BLAST, CALL U.F.P.O. 1-(800)-962-7962 TOLL FREE.
- 2. THE ENGINEER SHALL BE NOTIFIED IN WRITING OF ANY CONDITIONS THAT VARY FROM THOSE SHOWN ON THE PLANS. THE CONTRACTOR'S WORK SHALL NOT VARY FROM THE PLANS WITHOUT THE EXPRESSED APPROVAL OF THE ENGINEER.
- 3. THE CONTRACTOR SHALL RESTORE LAWNS, DRIVEWAYS, CULVERTS, SIGNS AND OTHER PUBLIC OR PRIVATE PROPERTY DAMAGED OR REMOVED TO AT LEAST AS GOOD A CONDITION AS BEFORE BEING DISTURBED AS DETERMINED BY THE ENGINEER.
- 4. THE CONTRACTOR SHALL BE RESPONSIBLE FOR OBTAINING AND INCURRING THE COST OF ALL REQUIRED PERMITS, INSPECTIONS, CERTIFICATES, ETC. AND SHALL COMPLY WITH ALL REQUIRED PERMITS.
- 5. ALL WORK SHALL BE DONE IN STRICT COMPLIANCE WITH ALL APPLICABLE NATIONAL, STATE, AND LOCAL CODES, STANDARDS, ORDINANCES, RULES, AND REGULATIONS.
- 6. ALL PROPOSED UTILITIES AND APPURTENANCES TO BE CONSTRUCTED IN COMPLIANCE WITH THE LOCAL MUNICIPALITIES' CODES AND REGULATIONS GOVERNING THE INSTALLATION OF SUCH UTILITIES.
- 7. THE ENGINEER RESERVES THE RIGHT TO EXAMINE ANY WORK DONE ON THIS PROJECT AT ANY TIME TO DETERMINE THE CONFORMANCE WITH THE REQUIREMENTS OF THE CONTRACT DOCUMENTS OF THIS PROJECT.
- 8. THE CONTRACTOR SHALL PROTECT EXISTING PROPERTY LINE MONUMENTATION. ANY MONUMENTATION DISTURBED OR DESTROYED, AS JUDGED BY THE ENGINEER OR OWNER, SHALL BE REPLACED AT THE CONTRACTOR'S EXPENSE UNDER THE SUPERVISION OF A NEW YORK STATE LICENSED LAND SURVEYOR.
- 9. IT IS THE CONTRACTOR'S RESPONSIBILITY TO EXAMINE ALL PLAN SHEETS AND COORDINATE WORK WITH ALL OTHER CONTRACTS FOR THE SITE.
- 10. THE CONTRACTOR SHALL:
  - A. VERIFY ALL CONDITIONS IN THE FIELD PRIOR TO COMMENCEMENT OF
  - WORK AND NOTIFY THE ENGINEER OF ANY DISCREPANCIES. B. EXAMINE THE SITE AND INCLUDE IN HIS WORK THE EFFECT OF ALL EXISTING CONDITIONS ON THE WORK.
  - C. PROVIDE AND INSTALL ALL MATERIALS AND PERFORM ALL WORK IN ACCORDANCE WITH RECOGNIZED GOOD STANDARD PRACTICE.

- 11. ALL TRENCH EXCAVATION AND ANY REQUIRED SHEETING AND SHORING SHALL BE DONE IN ACCORDANCE WITH THE LATEST REVISIONS OF NEW YORK STATE INDUSTRIAL CODE RULE 23 AND OSHA REGULATIONS FOR CONSTRUCTION. SHEET PILING SHALL BE DESIGNED AND SEALED BY A NEW YORK STATE PROFESSIONAL ENGINEER.
- 12. CONTRACTOR SHALL BE RESPONSIBLE FOR DEWATERING AND THE MAINTENANCE OF SURFACE DRAINAGE DURING THE COURSE OF WORK AND SHALL SUBMIT A DEWATERING PLAN DESIGNED AND SEALED BY A NEW YORK STATE PROFESSIONAL ENGINEER. CONTRACTOR SHALL MAINTAIN EXISTING SITE DRAINAGE PATTERNS THROUGHOUT CONSTRUCTION UNLESS OTHERWISE SHOWN ON THE PLANS.
- 13. MAINTAIN FLOW FOR ALL EXISTING UTILITIES.
- 14. ALL FRAMES/COVERS WITHIN PAVED AREAS SHALL HAVE THE TOPS SET FLUSH WITH THE EXISTING PAVEMENT GRADE. IN LANDSCAPED AREAS, ALL FRAMES SHALL BE 0.1' ABOVE GRADE.
- 15. THE CONTRACTOR SHALL BE RESPONSIBLE FOR PROVIDING ALL FIELD LAYOUT. THE CONTRACTOR SHALL TAKE TIES TO ALL UTILITY CONNECTIONS AND PROVIDE MARKED-UP AS-BUILT PLANS FOR ALL UTILITIES SHOWING TIES TO CONNECTIONS, BENDS, VALVES, LENGTHS OF LINES, AND INVERTS. AS-BUILT PLANS SHOWING ALL UNDERGROUND UTILITIES INSTALLED OR ENCOUNTERED SHALL BE REVIEWED BY THE OWNER AND HIS REPRESENTATIVES. THE CONTRACTOR SHALL PROVIDE ANY CORRECTION OR ADMISSIONS TO THE SATISFACTION OF THE OWNER AND HIS REPRESENTATIVES BEFORE UTILITIES WILL BE ACCEPTED.
- 16. TEMPORARY PAVEMENT SHALL BE PLACED WITHIN 48 HOURS OF COMPLETION OF BACKFILL OPERATIONS WITHIN THE EXISTING PAVEMENT
- 17. CONTRACTOR SHALL MAINTAIN ALL TRAFFIC IN ALL AREAS IN ACCORDANCE WITH THE NYSDOT MANUAL OF UNIFORM TRAFFIC CONTROL DEVICES.
- 18. ALL EXCAVATIONS SHALL BE PROTECTED AT THE END OF EACH WORK DAY.
- 19. CONTRACTOR SHALL TAKE CARE TO PREVENT DAMAGE TO EXISTING UTILITIES. DAMAGED UTILITIES SHALL BE IMMEDIATELY REPAIRED BY CONTRACTOR AT THE CONTRACTOR'S EXPENSE.

Champlain Hudson **Power Express** 





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CHAMPLAIN HUDSON POWER EXPRESS **SEGMENT 3 - PACKAGE 2 - FORT ANN TO KINGSBURY GENERAL NOTES** 

KIEWIT PROJECT NO. 21162 CHA PROJECT NO. 066076 DRAWING NO.

G-002

AS NOTED DATE DRAWN BY: XXX DESIGNED BY: XXX APPROVED BY: XXX REV. NO. X SH.NO.

U CAPPED IRON ROD

(SYM.)

O IRON PIPE CONCRETE BOUNDARY ⊕POST

EXISTING REFLECTOR MARKER EXISTING SYMBOL

EXISTING POST

EXIST. TELE. PEDESTAL

EXIST. TELE. DOGHOUSE

EXIST. TELE. MARKER POST

EXIST. TELE. JUNCTION BOX

EXIST. TRAFFIC SIGNAL BOX

EXISTING MANHOLE UNKNOWN

EXISTING CAPPED IRON ROD

**EXISTING CONCRETE MONUMENT** 

EXISTING UTILITY BOX UNKNOWN

EXIST. CELL TOWER

EXIST. CABLE BOX

EXISTING ANTENNA

EXISTING IRON PIPE

EXISTING SIGN

EXIST. STRUCTURE POST EXIST. STRUCTURE MAILBOX

EXIST. OVERHEAD ELEC.

EXIST. SANITARY SEWER

EXIST. RAILROAD TRACK

EXIST. CONTOUR, INDEX

EXIST. SPOT ELEVATION

EXIST. CULTURAL PILE

EXIST. HYDROGRAPHIC

EXIST. INUNDATED AREA

EXIST. NATURAL BOULDER

EXIST. NATURAL SHRUB LINE

EXIST. STRUCTURAL BUILDING

EXIST. PAVED DRIVE

EXIST. PAVED ROAD

EXIST. GUARDRAIL

EXIST. RAILROAD

EXIST. TRAIL

EXIST. FENCE

EXIST. WALL

EXIST. PAVED SHOULDER

EXIST. PAVED SIDEWALK

EXIST. RETAINING WALL

EXIST. NATURAL SINGLE TREE/BUSH

EXIST. NATURAL TREE LINE

EXIST. CULVERT

EXIST. RIP-RAP

EXIST. STREAM

EXIST. SWAMP

WATER LEVEL

EXIST. CULTURAL DEBRIS

EXIST. CULTURAL FIELD LINE

EXIST. CULTURAL LANDSCAPE AREA

EXIST. CULTURAL STORAGE AREA

EXIST. WETLANDS

EXIST. POTABLE WATER LINE

CERTIFIED ROUTE PROVIDED BY CHPE KMZ

EXIST. CONTOUR, DEPRESSION INTERMEDIATE

EXIST. CONTOUR, DEPRESSION INDEX

EXIST. CONTOUR, INTERMEDIATE

EXIST. STORM SEWER

EXIST. CULVERT

EXIST. WETLAND FLAG EXIST. GAS LINE \_\_\_\_ G \_\_\_ G \_\_\_

EXIST. UNDERGROUND TELE. — — UT — — UT — EXIST. FIBER OPTIC

EXIST. OVERHEAD TELE. — — ot — — ot — EXIST. UNDERGROUND ELEC. — — UE — — UE —

— OE — OE — — — ST — — ST — — ss — ss —

— st — st —

⊗ CERTIFIED ROUTE MP XX 

 $\times 139.7$ 

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EXIST. RIGHT-OF-WAY EXIST. ABUTTER 

LEGEND & ABBRIVIATIONS

1...<del>\*</del>...\*...\* .<u>. . . . .</u> 2:2:2:2 ——FS—— ----\_\_\_\_  $rac{-}{-}$ \_ \_ \_ \_

PROP. GIS — WETLAND PROP. JD BOUNDARY PROP. WETLAND PROTECTION FENCE PROP. COMPOST FILTER SOCK (OR SILT SOCK) PROP. LIMITS OF WORK/DISTURBANCE PROP. LIMITS OF CLEARING/LIMITS OF WORK IN CLEARING AREAS PROP. CONCRETE WASHOUT PROP. ACCESS ROAD ROUTE (EXISTING ROAD OR SURFACE)

PEM - PALUSTRINE EMERGENT

PFO - PALUSTRINE FORESTED

L1 - LACUSTRINE LIMNETIC

L2 - LACUSTRINE LITTORAL

PSS - PALUSTRINE SCRUB-SHRUB

PUB - PALUSTRINE UNCONSOLIDATED BOTTOM

PROP. NYSDEC FWW 100-FOOT ADJACENT AREA

PROP. REFURBISHED ACCESS ROAD PROP. ACCESS ROAD OR OFF SITE ACCESS ROAD PROP. TIMBER MATTING ACCESS ROAD

PROP. SPLICE LOCATION

PROP. SPLICE VAULT PROP. LINK BOX HANDHOLE PROP. FIBER SPLICE HANDHOLE PROP. BORING LOCATION

PROP. ALIGNMENT STATIONING PROP. RIGHT-OF-WAY PROP. ABUTTER

PROP. ALIGNMENT CENTERLINE **ZZZ** PROP. LAYDOWN YARDS, PARKING, STORAGE & MUSTER AREA 

PROP. WORK AREAS PROP. PERMANENT EASEMENT \_ \_ \_ PROP. TEMPORARY EASEMENT

7' FOUL ZONE: NO VEHICLES, MATERIALS, DISTURBANCE, PERSONNEL, OR WORK SHALL ENCROACH THE ZONE WITHIN 7FT OF THE NEAREST RAIL WITHOUT CSX COORDINATION AND APPROVAL

**SURVEY NOTES:** 

1. A ROW, UTILITY & WETLAND SURVEY PREPARED IN THE FIELD BY CONTROL POINT ASSOCIATES, INC., AND OTHER REFERENCE MATERIAL AS LISTED HEREON.

2. ELEVATIONS REFER TO THE NORTH AMERICAN VERTICAL DATUM OF 1988 (NAVD88). BASED ON GPS OBSERVATIONS TAKEN AT THE TIME OF THE

NORTH ORIENTATION SHOWN REFERS TO THE NAD83 STATE PLANE COORDINATE SYSTEM - NEW YORK EAST ZONE BASED ON GPS OBSERVATIONS TAKEN AT THE TIME OF THE FIELD SURVEY.

LOCATION OF UNDERGROUND UTILITIES ARE APPROXIMATE. LOCATIONS AND SIZES ARE BASED ON UTILITY MARK-OUTS, ABOVE GROUND STRUCTURES THAT WERE VISIBLE & ACCESSIBLE IN THE FIELD, AND THE MAPS AS LISTED IN THE REFERENCES AVAILABLE AT THE TIME OF THE SURVEY. AVAILABLE ASBUILT PLANS AND UTILITY MARKOUT DOES NOT ENSURE MAPPING OF ALL UNDERGROUND UTILITIES AND STRUCTURES. BEFORE ANY EXCAVATION IS TO BEGIN, ALL UNDERGROUND UTILITIES SHOULD BE VERIFIED AS TO THEIR LOCATION, SIZE AND TYPE BY THE PROPER UTILITY COMPANIES. CONTROL POINT ASSOCIATES, INC. DOES NOT GUARANTEE THE UTILITIES SHOWN COMPRISE ALL SUCH UTILITIES IN THE AREA EITHER IN SERVICE OR ABANDONED.

SUBSURFACE UTILITY ENGINEERING NOTES:

A QUALITY LEVEL SYSTEM IS UTILIZED TO IDENTIFY THE SOURCE OF THE UNDERGROUND UTILITY INFORMATION. THE METHOD OF DETERMINATION IS BASED ON CONTRACTUAL AGREEMENT WITH THE CLIENT AND IS DEPICTED ON THE SURVEY BY THE LINE TYPES SHOWN IN THE DRAWING LEGEND. FOR REFERENCE, THE QUALITY LEVELS ARE AS FOLLOWS:

QUALITY LEVEL B - UTILITY LOCATION DATA IS COLLECTED THROUGH GEOPHYSICAL SENSING TECHNOLOGY TO SUPPLEMENT SURFACE FEATURES AND OR REFERENCE MAPPING. INCLUDES MARKOUT BY CONTROL POINT ASSOCIATES, INC.

Champlain Hudson **Power Express** 





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					CHAMPLAIN HUDSON POWER EX SEGMENT 3 - PACKAGE 2 - FORT ANN TO KIN
D	04/28/2022	60% SUBMISSION	JM	JR	SURVEY LEGEND
С	03/04/2022	PROGRESS SUBMISSION	JM	JR	-
В	02/23/2022	PROGRESS SUBMISSION	JM	JR	
Α	01/26/2022	30% SUBMISSION	JM	JR	
No.	DATE	SUBMITTAL / REVISION DESCRIPTION	DB	APP	DRAWN BY: JTM DESIGNED BY: JTM APPROVED BY: JPR REV. NO.

CHAMPLAIN HUDSON POWER EXPRESS **SEGMENT 3 - PACKAGE 2 - FORT ANN TO KINGSBURY** SURVEY LEGEND

**APPROVED** 

CENTERLINE

CONCRETE

DEGREES

DRIVE

**EASTING** 

**ELEVATION** 

GAS PIPE

**HORIZONTAL** 

INVERT ELEVATION

LIMITS OF WORK

FEET

LEFT

MAXIMUM

MINIMUM

**NORTHING** 

NUMBER

RADIUS

ROAD

RIGHT

ROUTE

SHEET

**STREET** 

STATION

**TEMPORARY** 

**TYPICAL** 

**VERTICAL** 

WATERLINE

REVISION

RIGHT-OF-WAY

SANITARY SEWER PIPE

STORM DRAIN PIPE

THERMAL RESISTIVITY

TELECOMMUNICATIONS CABLE

**NEW YORK** 

PACKAGE #

POLYVINYL CHLORIDE

POINT OF VERTICAL INTERSECTION

REINFORCED CONCRETE PIPE

DESIGNED BY

DEVIATION ZONE

ELECTRIC CABLE

FIBER OPTIC CABLE

HORIZONTAL DIRECTIONAL DRILLING

HIGH-VOLTAGE DIRECT CURRENT TRANSMISSION LINE

CONC

DB

DEC

DEG

DR

DΖ

**ELECTRIC** 

**ELEV** 

**FIBER** 

FΤ

GAS

HDD

HVDC

INV

LOW

MAX

PVC

PVI

REV

ROW

**SEWER** 

STA

STORM

TELECOM

**TEMP** 

TR

WATER

CORRUGATED METAL PIPE

NEW YORK STATE DEPARTMENT OF ENVIRONMENTAL CONSERVATION

KIEWIT PROJECT NO. 21162 CHA PROJECT NO. 066076 DRAWING NO.


AS NOTED DATE

XXX OF XXX

G-003

X SH.NO.



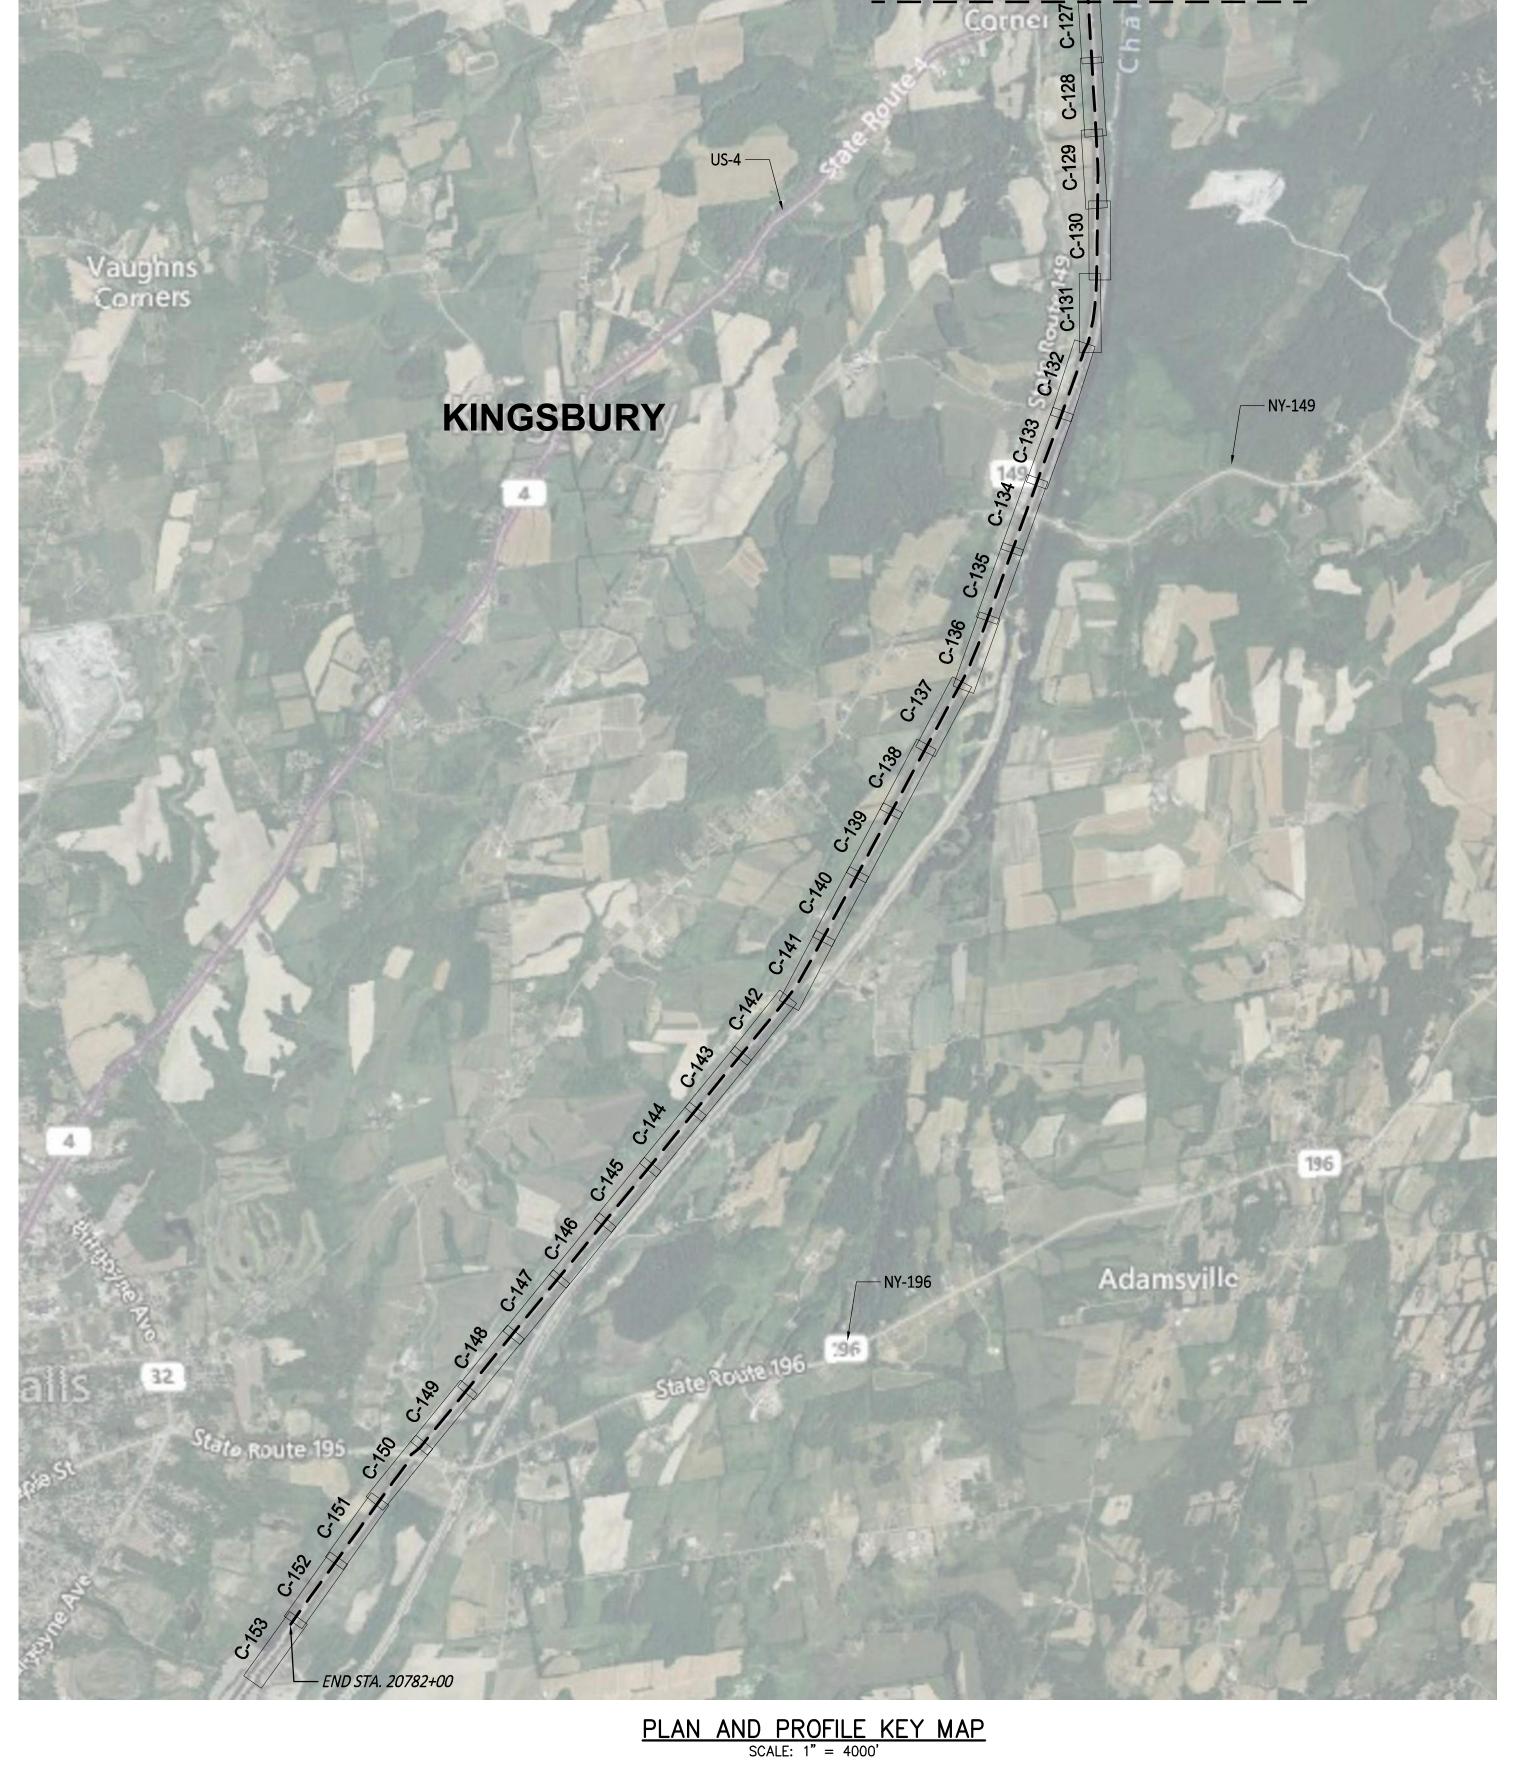








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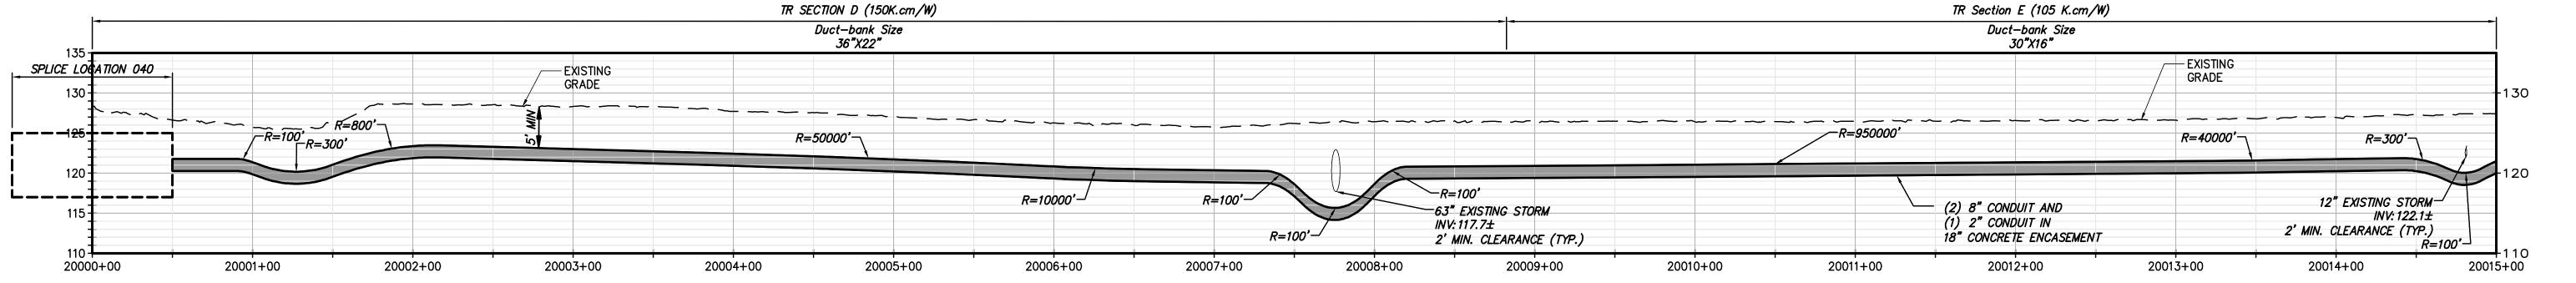
					SEGMENT 3 - PACKAGE 2 - FORT ANN TO KIN
_					KEYPLAN
D	04/28/2022	60% SUBMISSION	JM	JR	
С	03/04/2022	PROGRESS SUBMISSION	JM	JR	
В	02/23/2022	PROGRESS SUBMISSION	JM	JR	
Α	01/26/2022	30% SUBMISSION	JM	JR	
No.	DATE	SUBMITTAL / REVISION DESCRIPTION	DB	APP	SCALE SCALE
110.	DAIL	SUBMITTAL / REVISION DESCRIPTION	DB	AFF	P DRAWN BY: JTM DESIGNED BY: JTM APPROVED BY: JPR REV. NO.

CHAMPLAIN HUDSON POWER EXPRESS SEGMENT 3 - PACKAGE 2 - FORT ANN TO KINGSBURY KEYPLAN

KIEWIT PROJECT NO. 21162 CHA PROJECT NO. 066076 DRAWING NO.

G-004 AS NOTED DATE



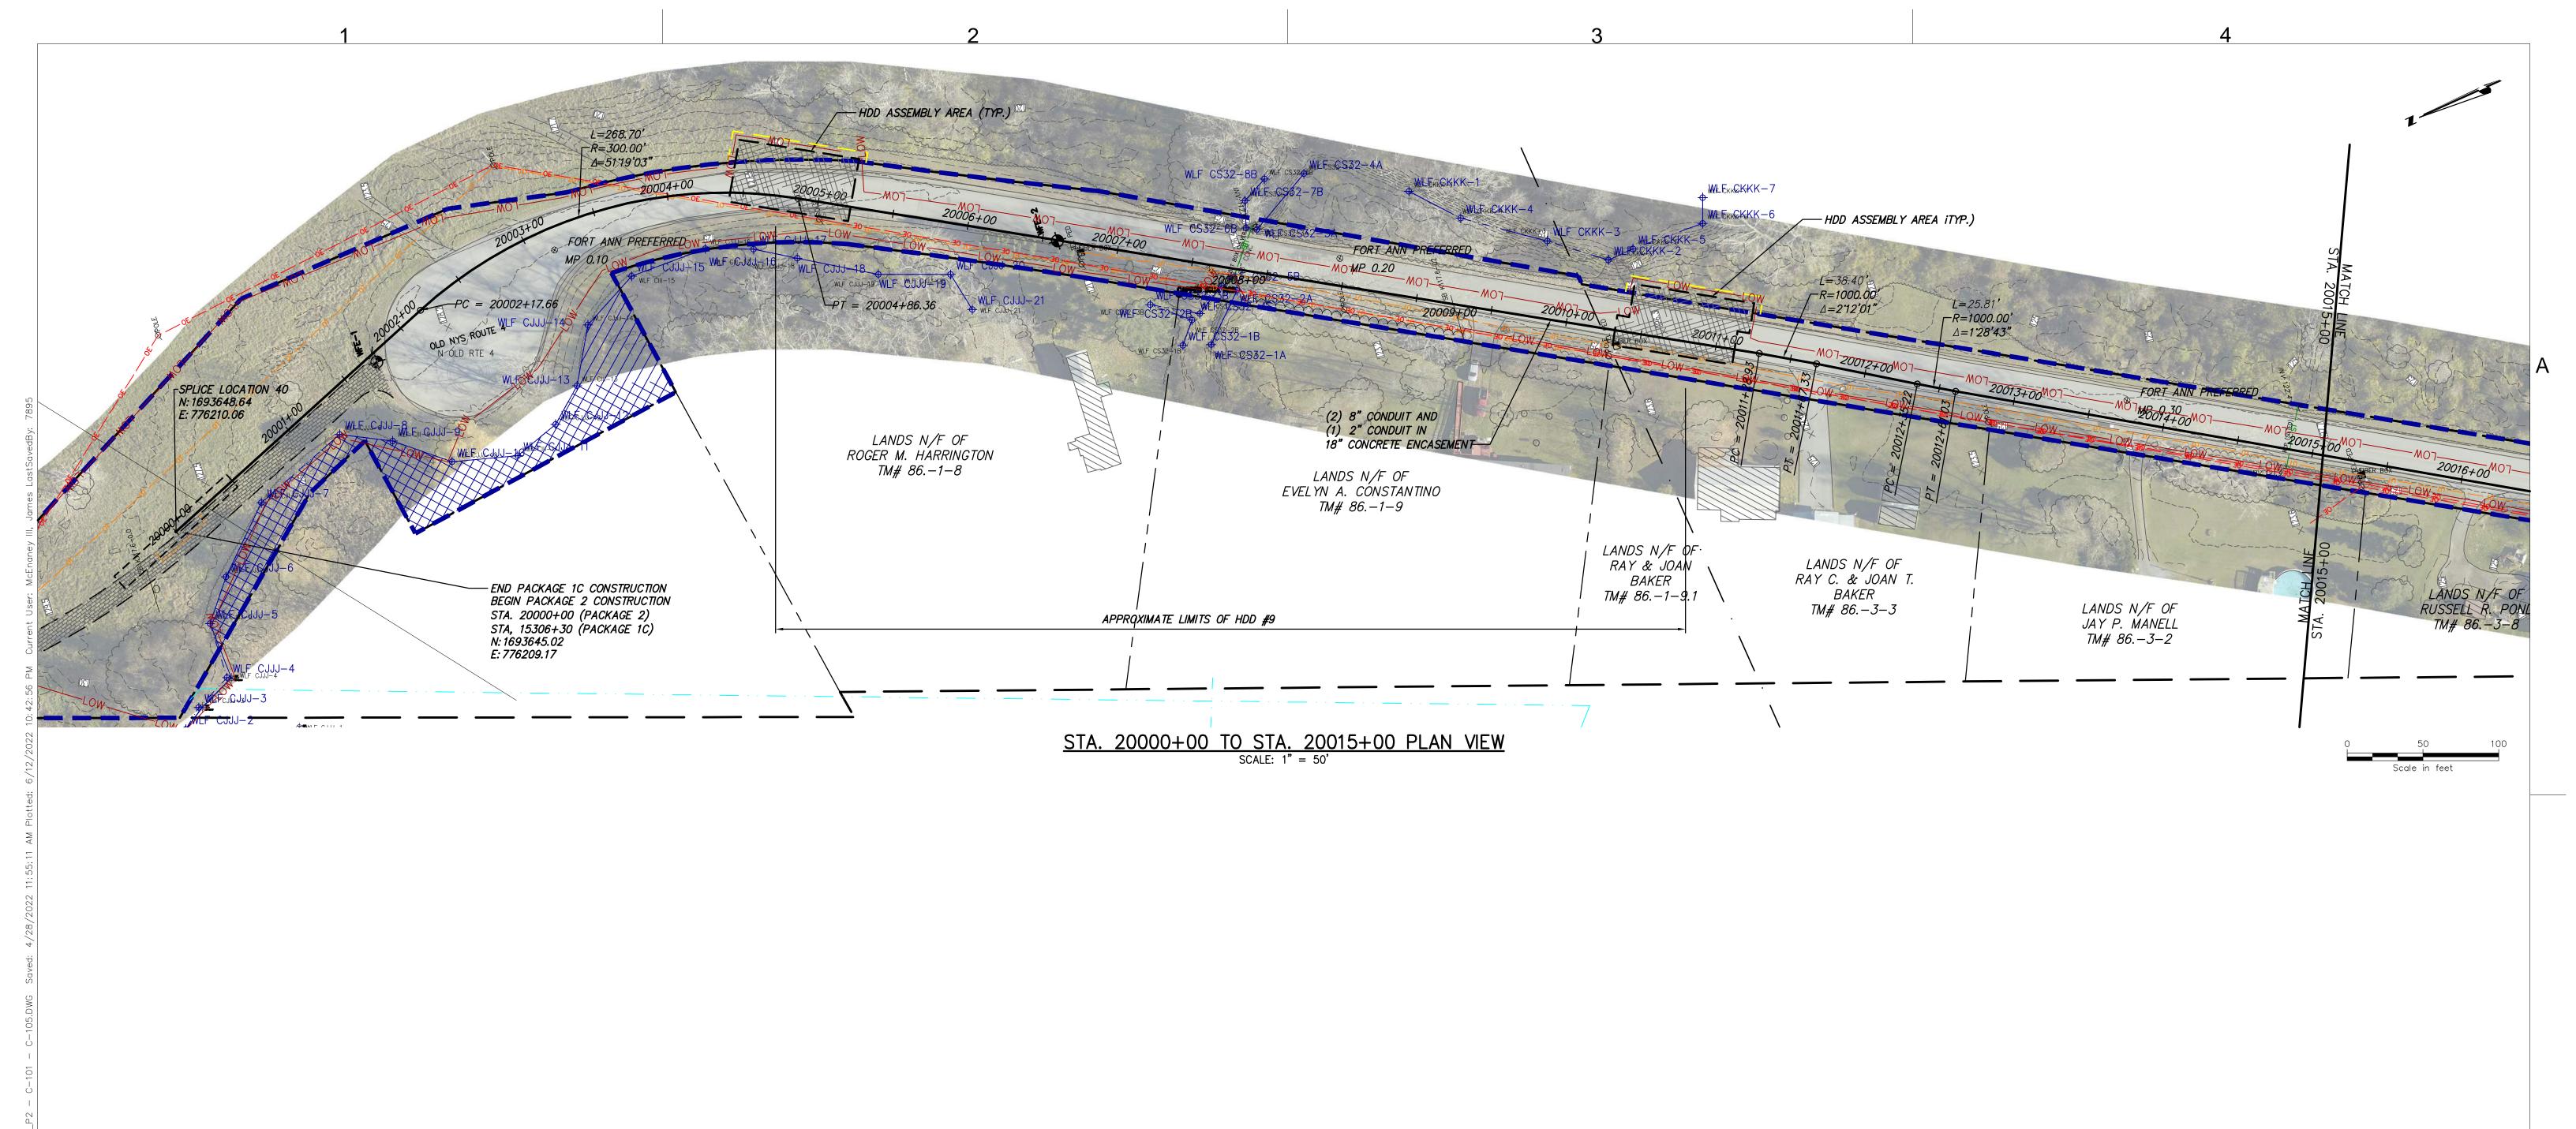

## STA. 20000+00 TO STA. 20015+00 PROFILE VIEW SCALE: H: 1" = 50' V: 1" = 10'







IT IS A VIOLATION OF LAW FOR ANY PERSON, UNLESS THEY ARE
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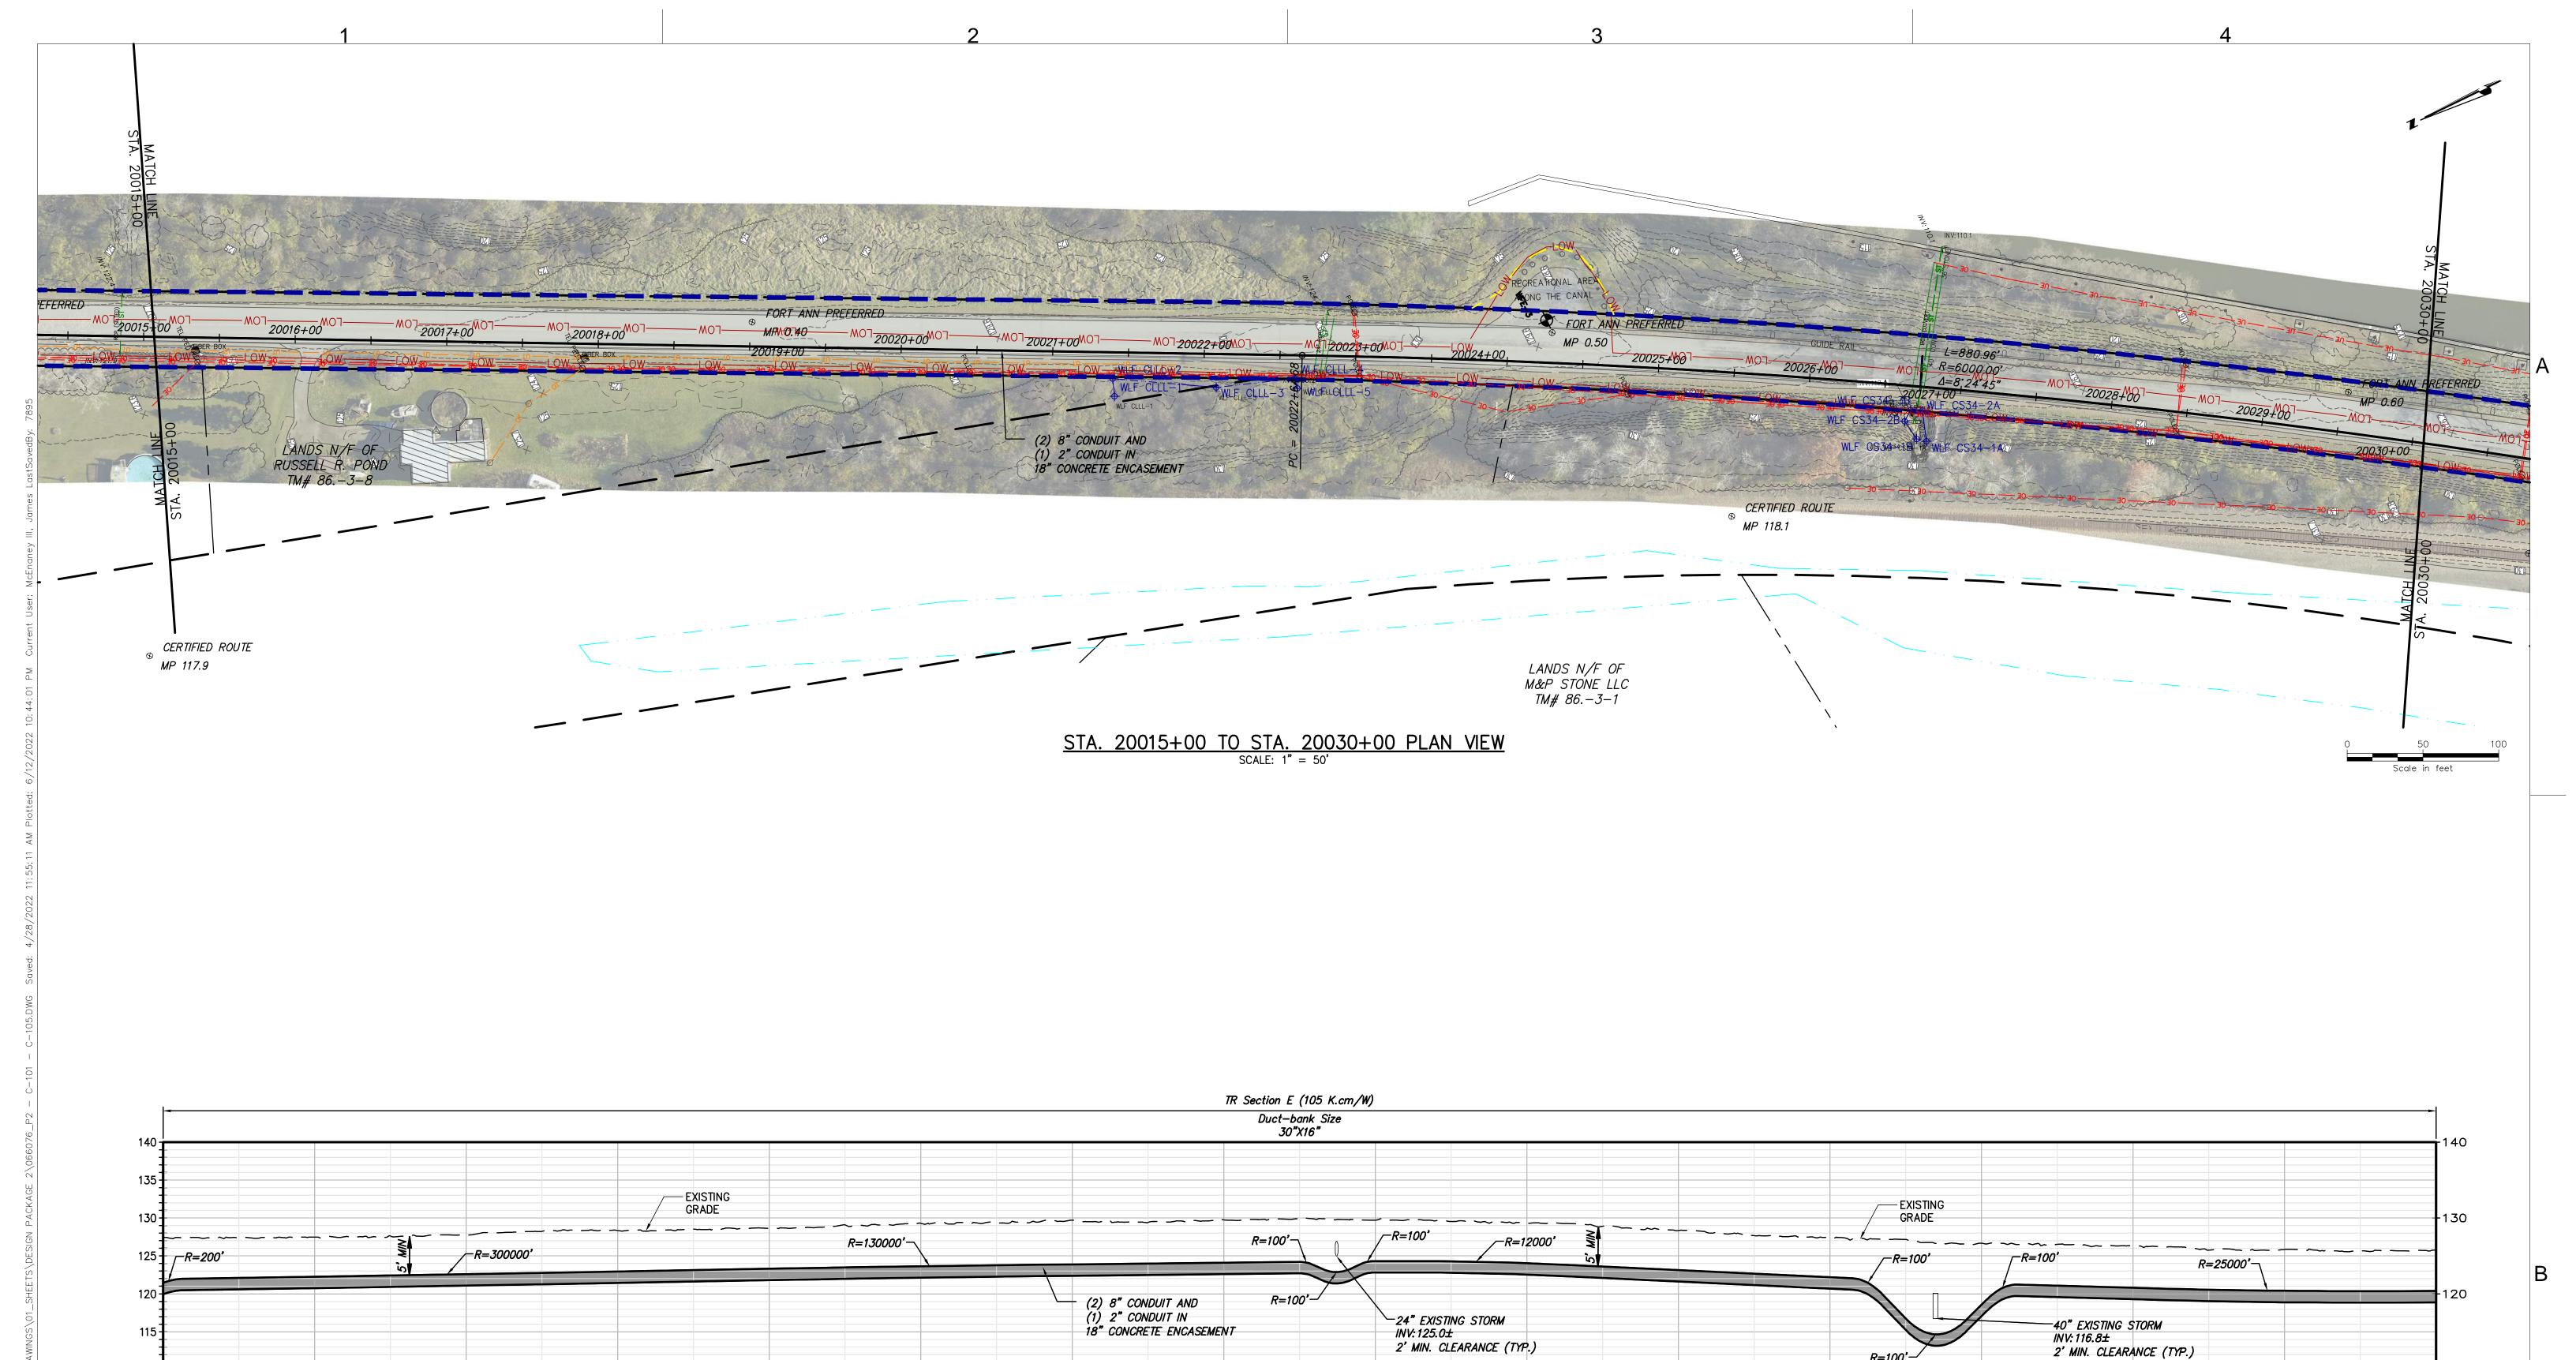
-						CHAMPLAIN HUDSON POWER EX SEGMENT 3 - PACKAGE 2 - FORT ANN TO KIN
	D	04/28/2022	60% SUBMISSION	JM	JR	STA. 20000+00 TO STA. 20015+00 PLAN AND
	С	03/04/2022	PROGRESS SUBMISSION	JM	JR	
	В	02/23/2022	PROGRESS SUBMISSION	JM	JR	
	Α	01/26/2022	30% SUBMISSION	JM	JR	
	No.	DATE	SUBMITTAL / REVISION DESCRIPTION	DB	APP	DRAWN BY: XXX DESIGNED BY: XXX APPROVED BY: XXX REV. NO.

#### CHAMPLAIN HUDSON POWER EXPRESS **SEGMENT 3 - PACKAGE 2 - FORT ANN TO KINGSBURY** STA. 20000+00 TO STA. 20015+00 PLAN AND PROFILE

KIEWIT PROJECT NO. 21162 CHA PROJECT NO. DRAWING NO.

C-101

AS NOTED DATE X SH.NO. XXX OF XXX



STA. 20015+00 TO STA. 20030+00 PROFILE VIEW

SCALE: H: 1" = 50' V: 1" = 10'

20023+00

20024+00



20015+00

20016+00



20017+00

20018+00



20019+00

20020+00

20021+00

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20022+00

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D	04/28/2022	60% SUBMISSION	JM	JR	S
С	03/04/2022	PROGRESS SUBMISSION	JM	JR	
В	02/23/2022	PROGRESS SUBMISSION	JM	JR	
Α	01/26/2022	30% SUBMISSION	JM	JR	
No.	DATE	SUBMITTAL / REVISION DESCRIPTION	DB	APP	DRA

CHAMPLAIN HUDSON POWER EXPRESS SEGMENT 3 - PACKAGE 2 - FORT ANN TO KINGSBURY STA. 20015+00 TO STA. 20030+00 PLAN AND PROFILE

20028+00

20029+00

KIEWIT PROJECT NO. 21162 CHA PROJECT NO. 066076 DRAWING NO.

20030+00

C-102

AS NOTED DATE

XXX OF XXX


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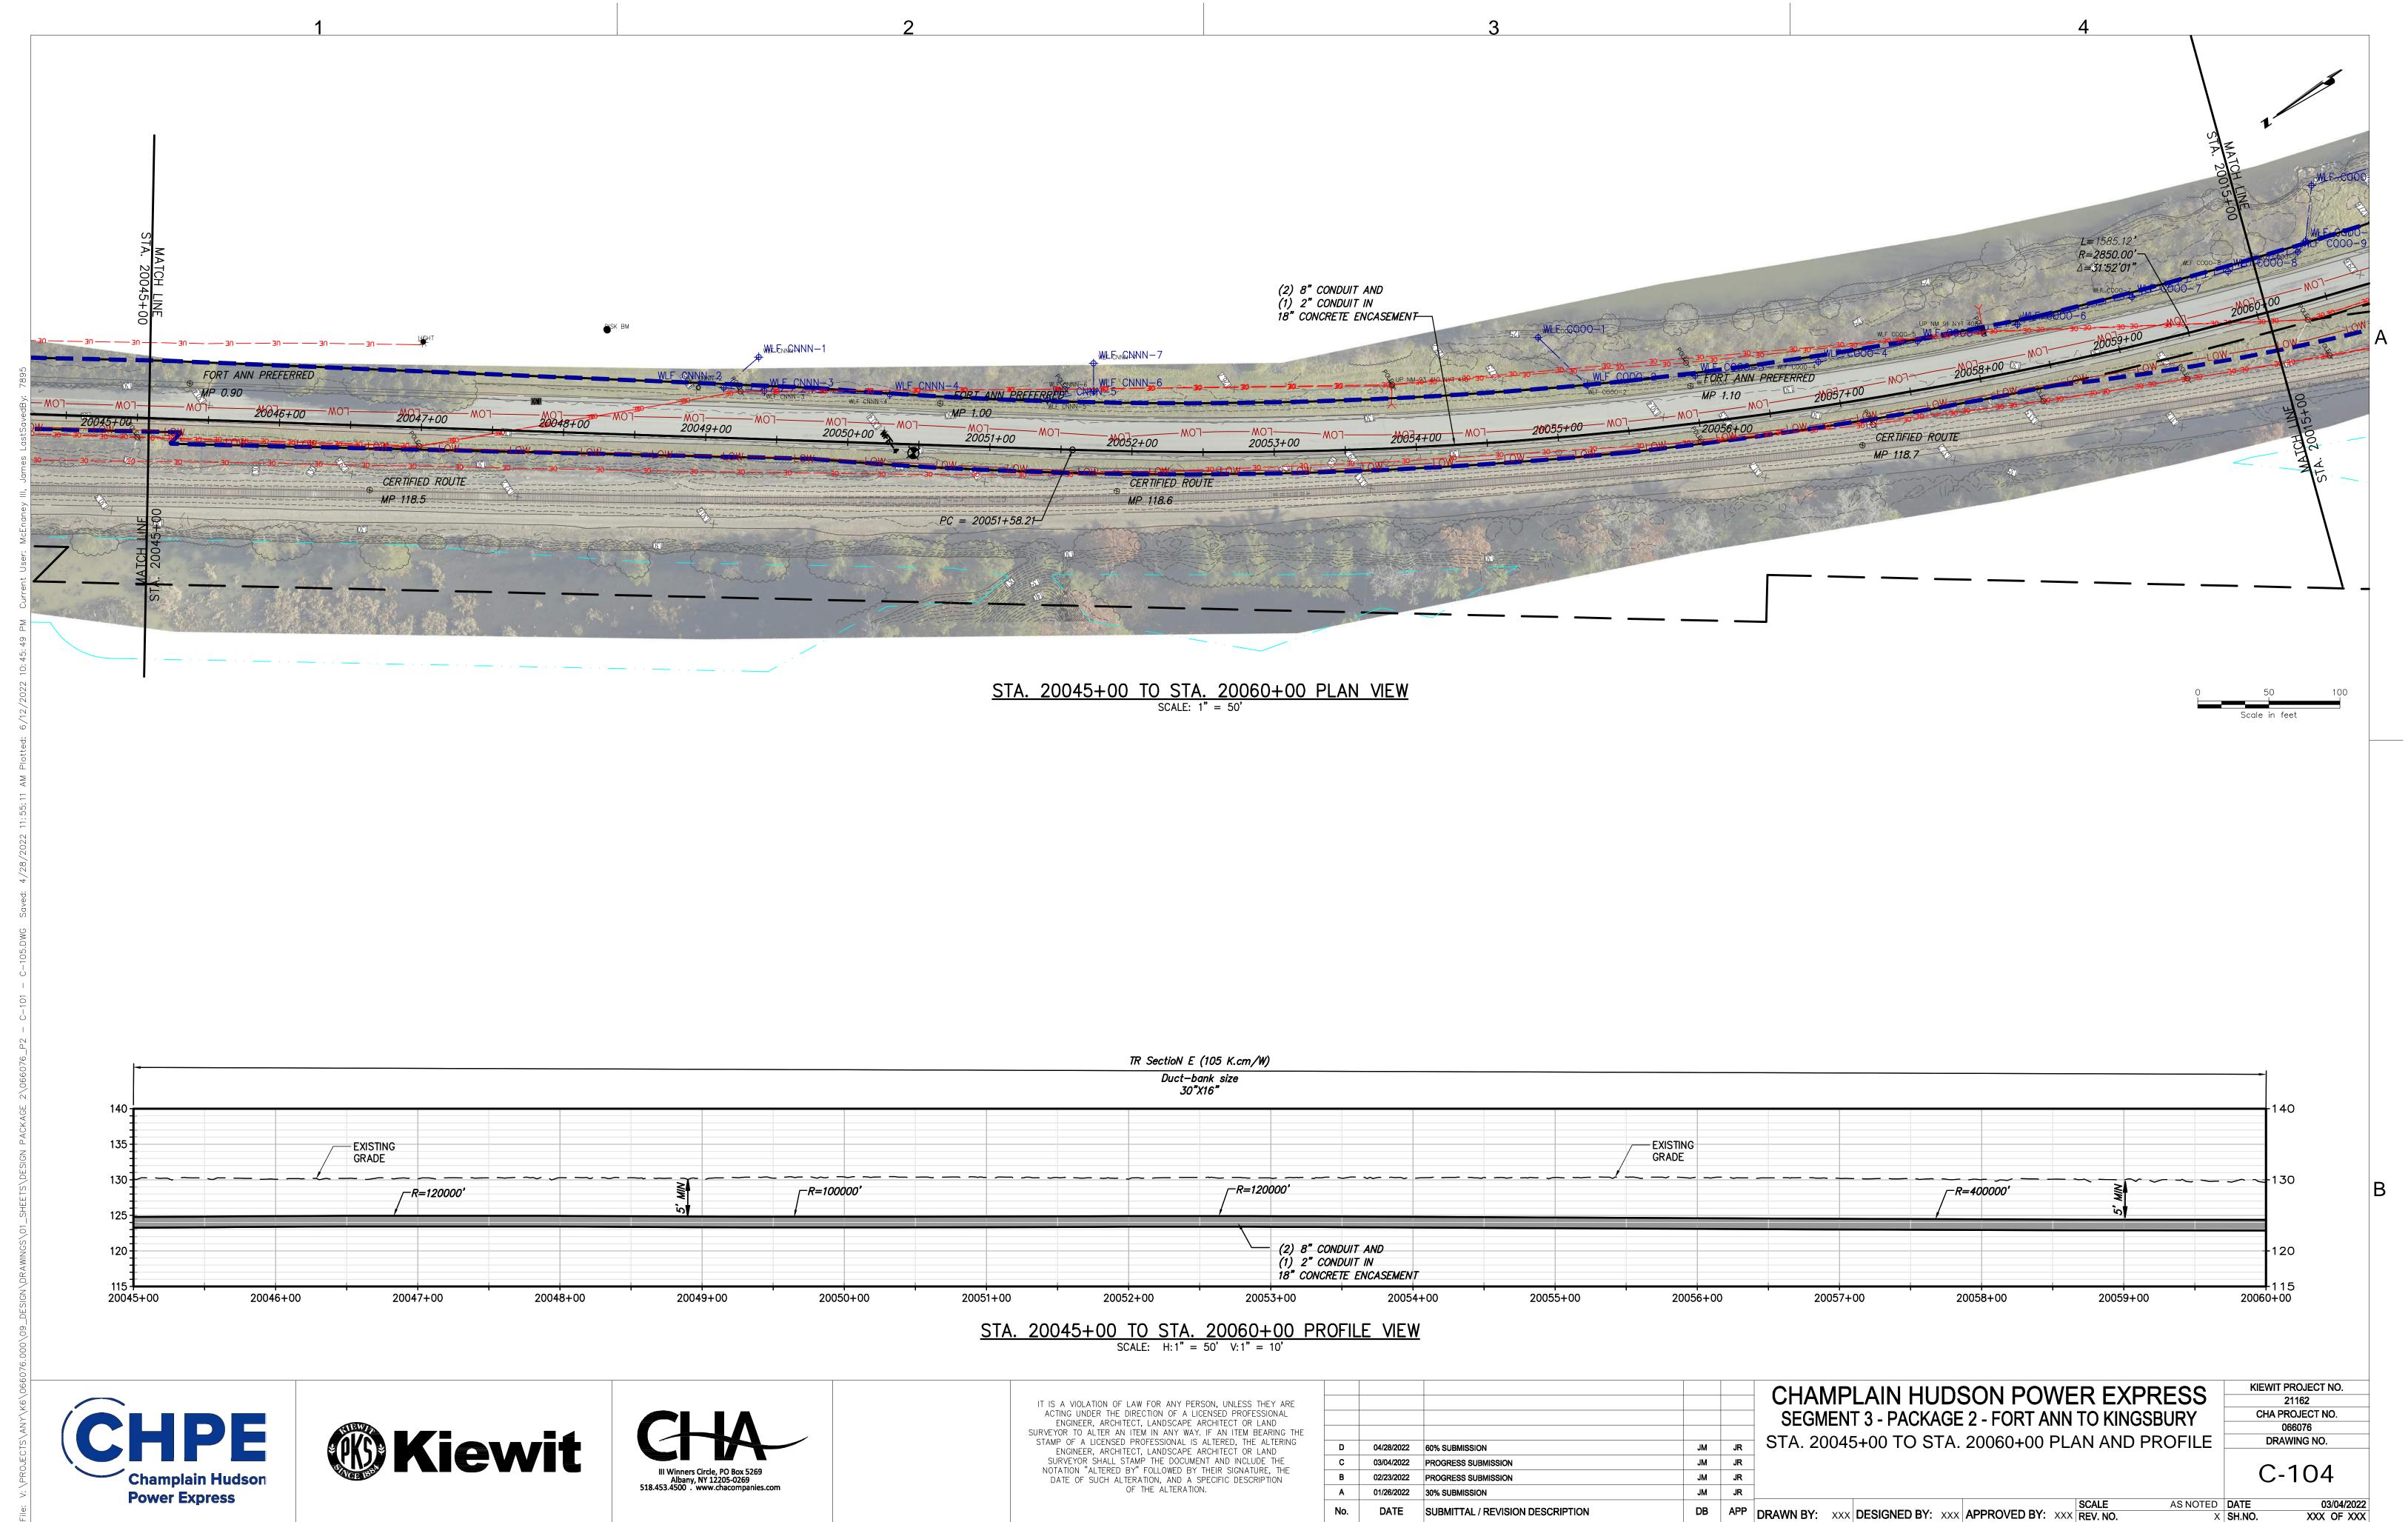
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20025+00

20026+00


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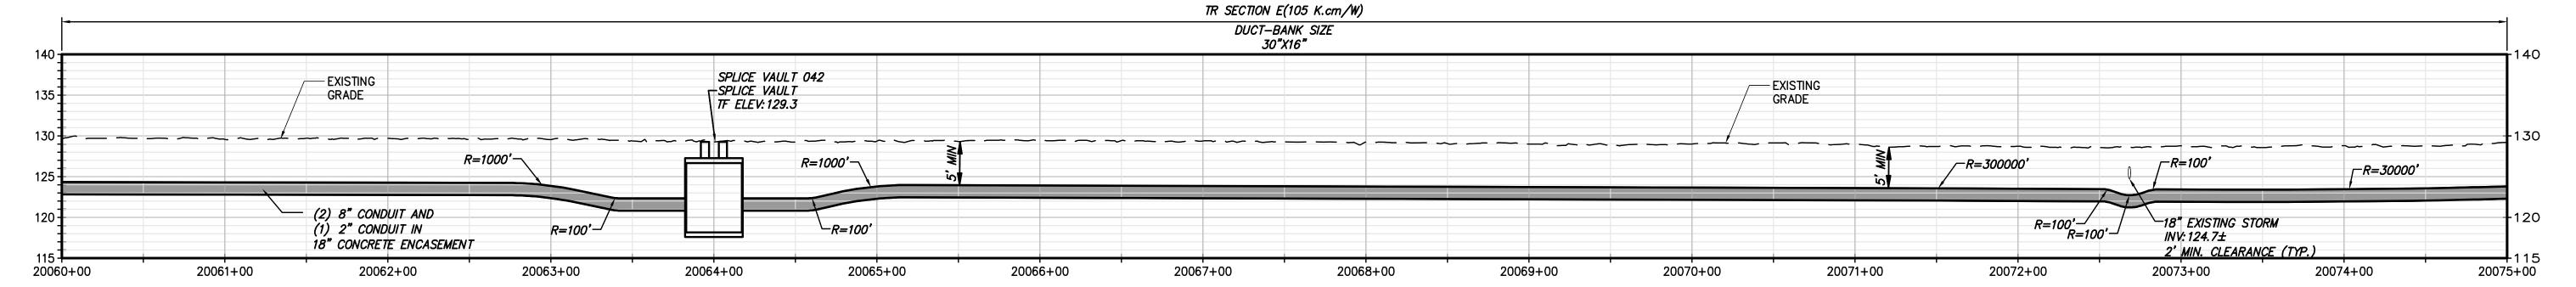




DATE SUBMITTAL / REVISION DESCRIPTION

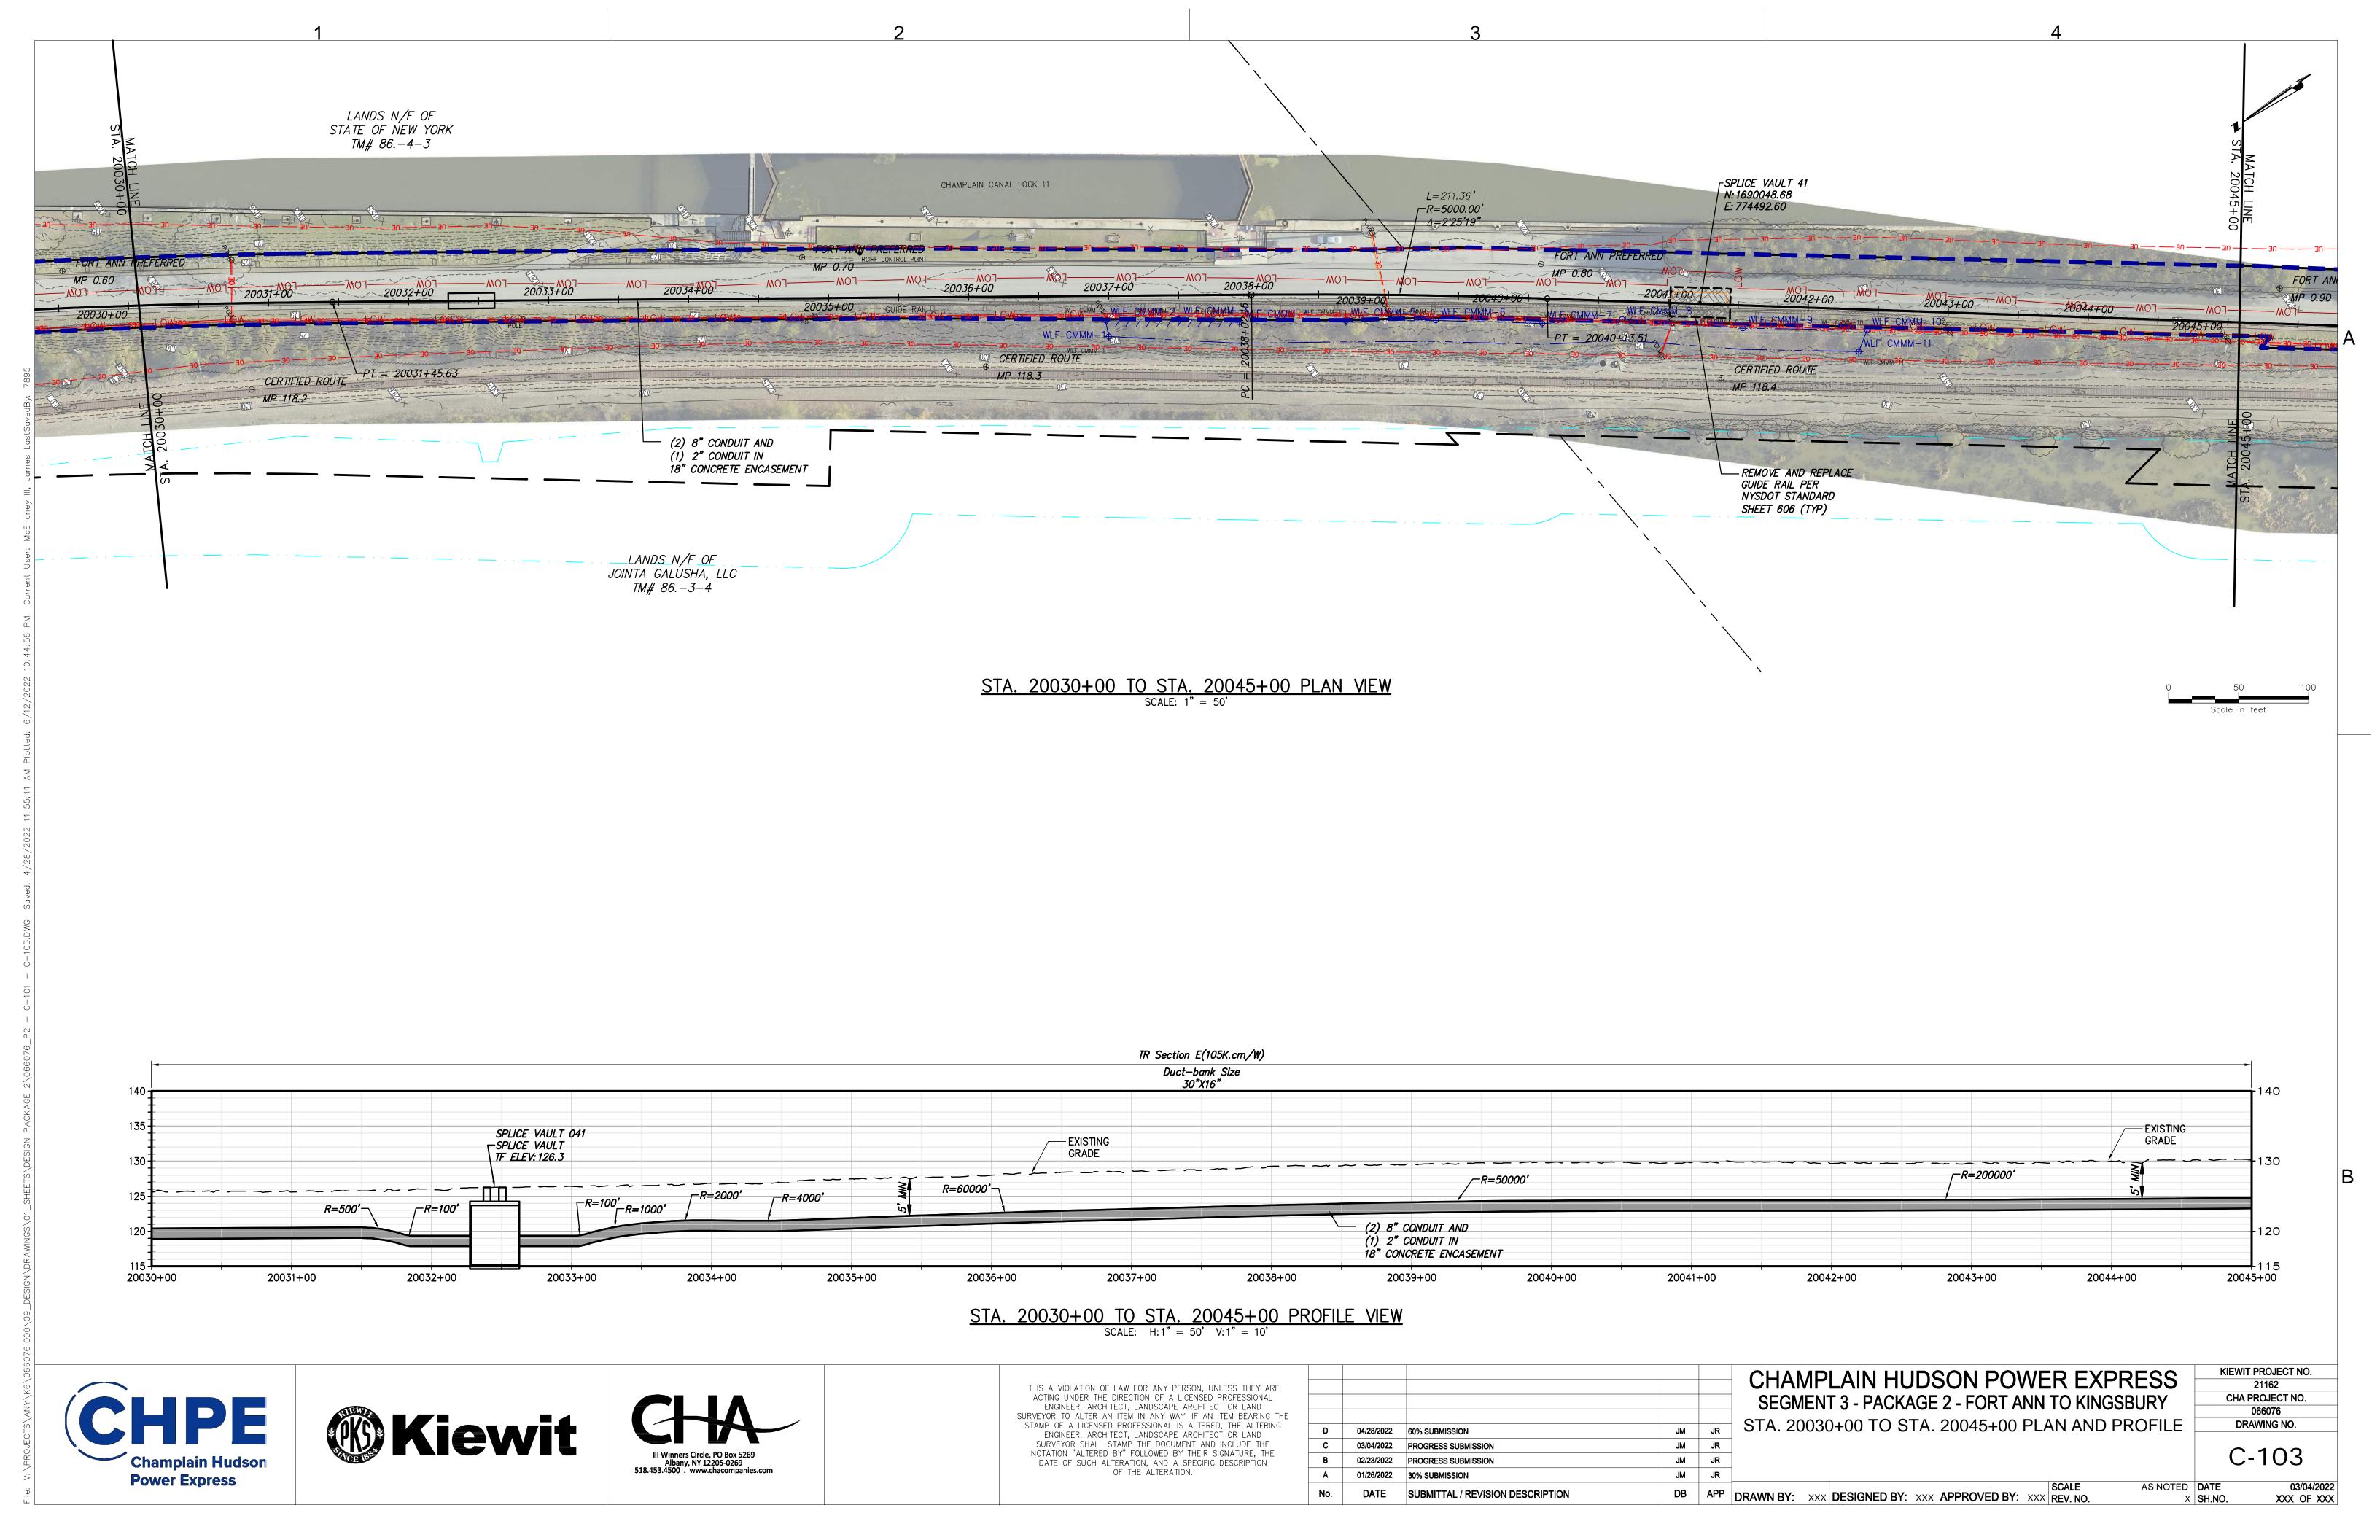X SH.NO.



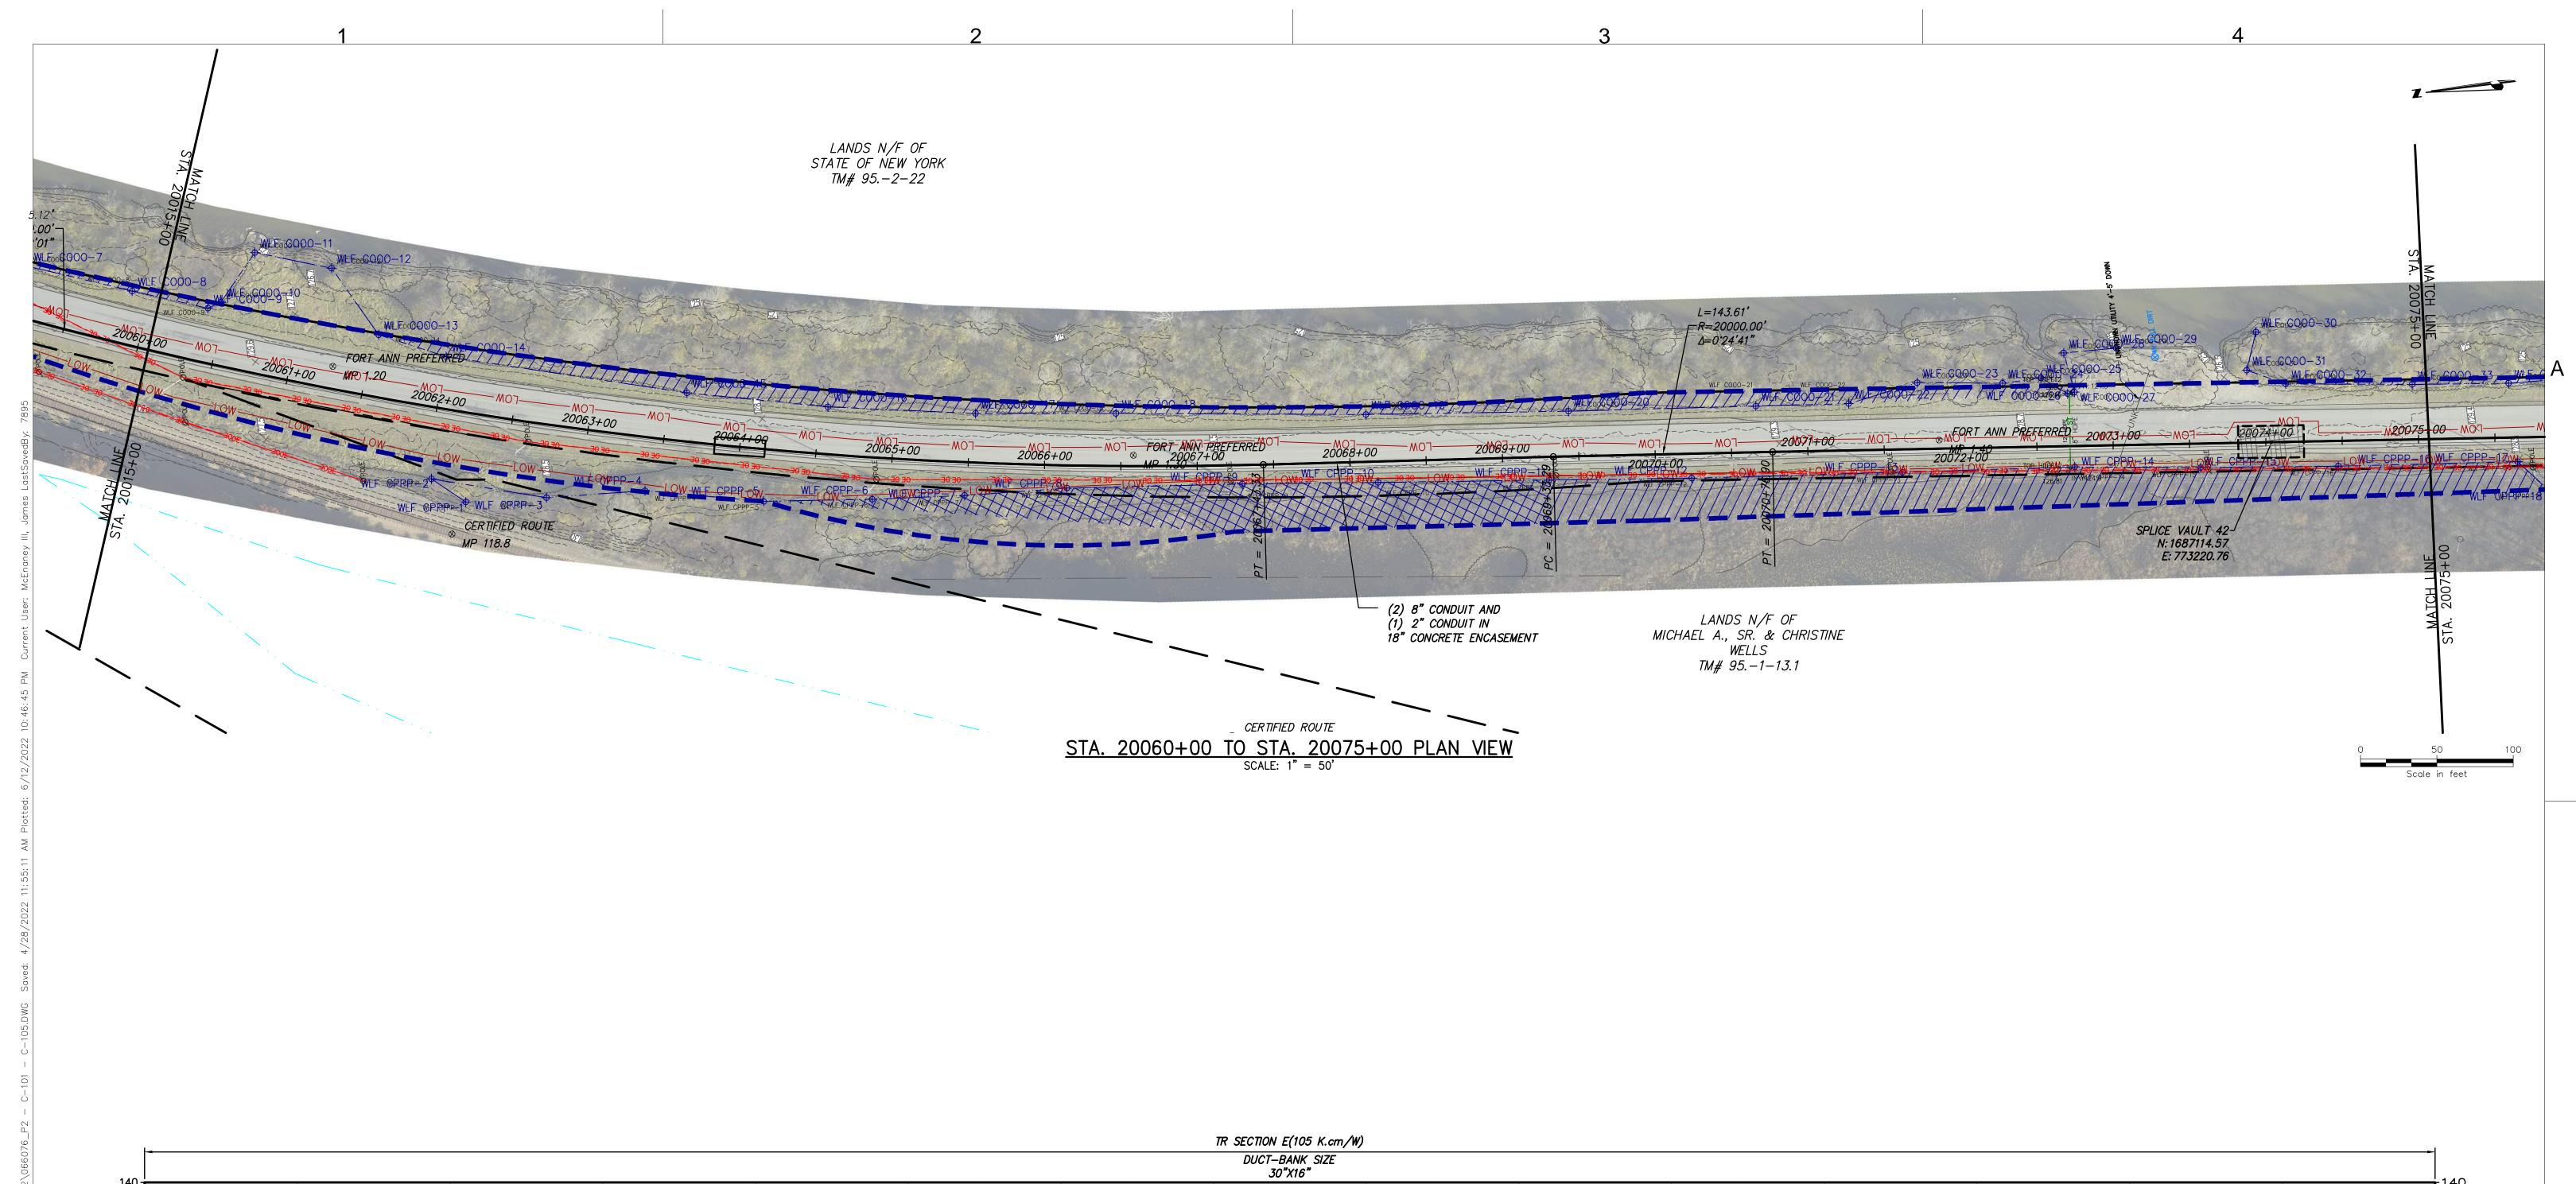

## STA. 20060+00 TO STA. 20075+00 PROFILE VIEW SCALE: H: 1" = 50' V: 1" = 10'







IT IS A VIOLATION OF LAW FOR ANY PERSON, UNLESS THEY ARE
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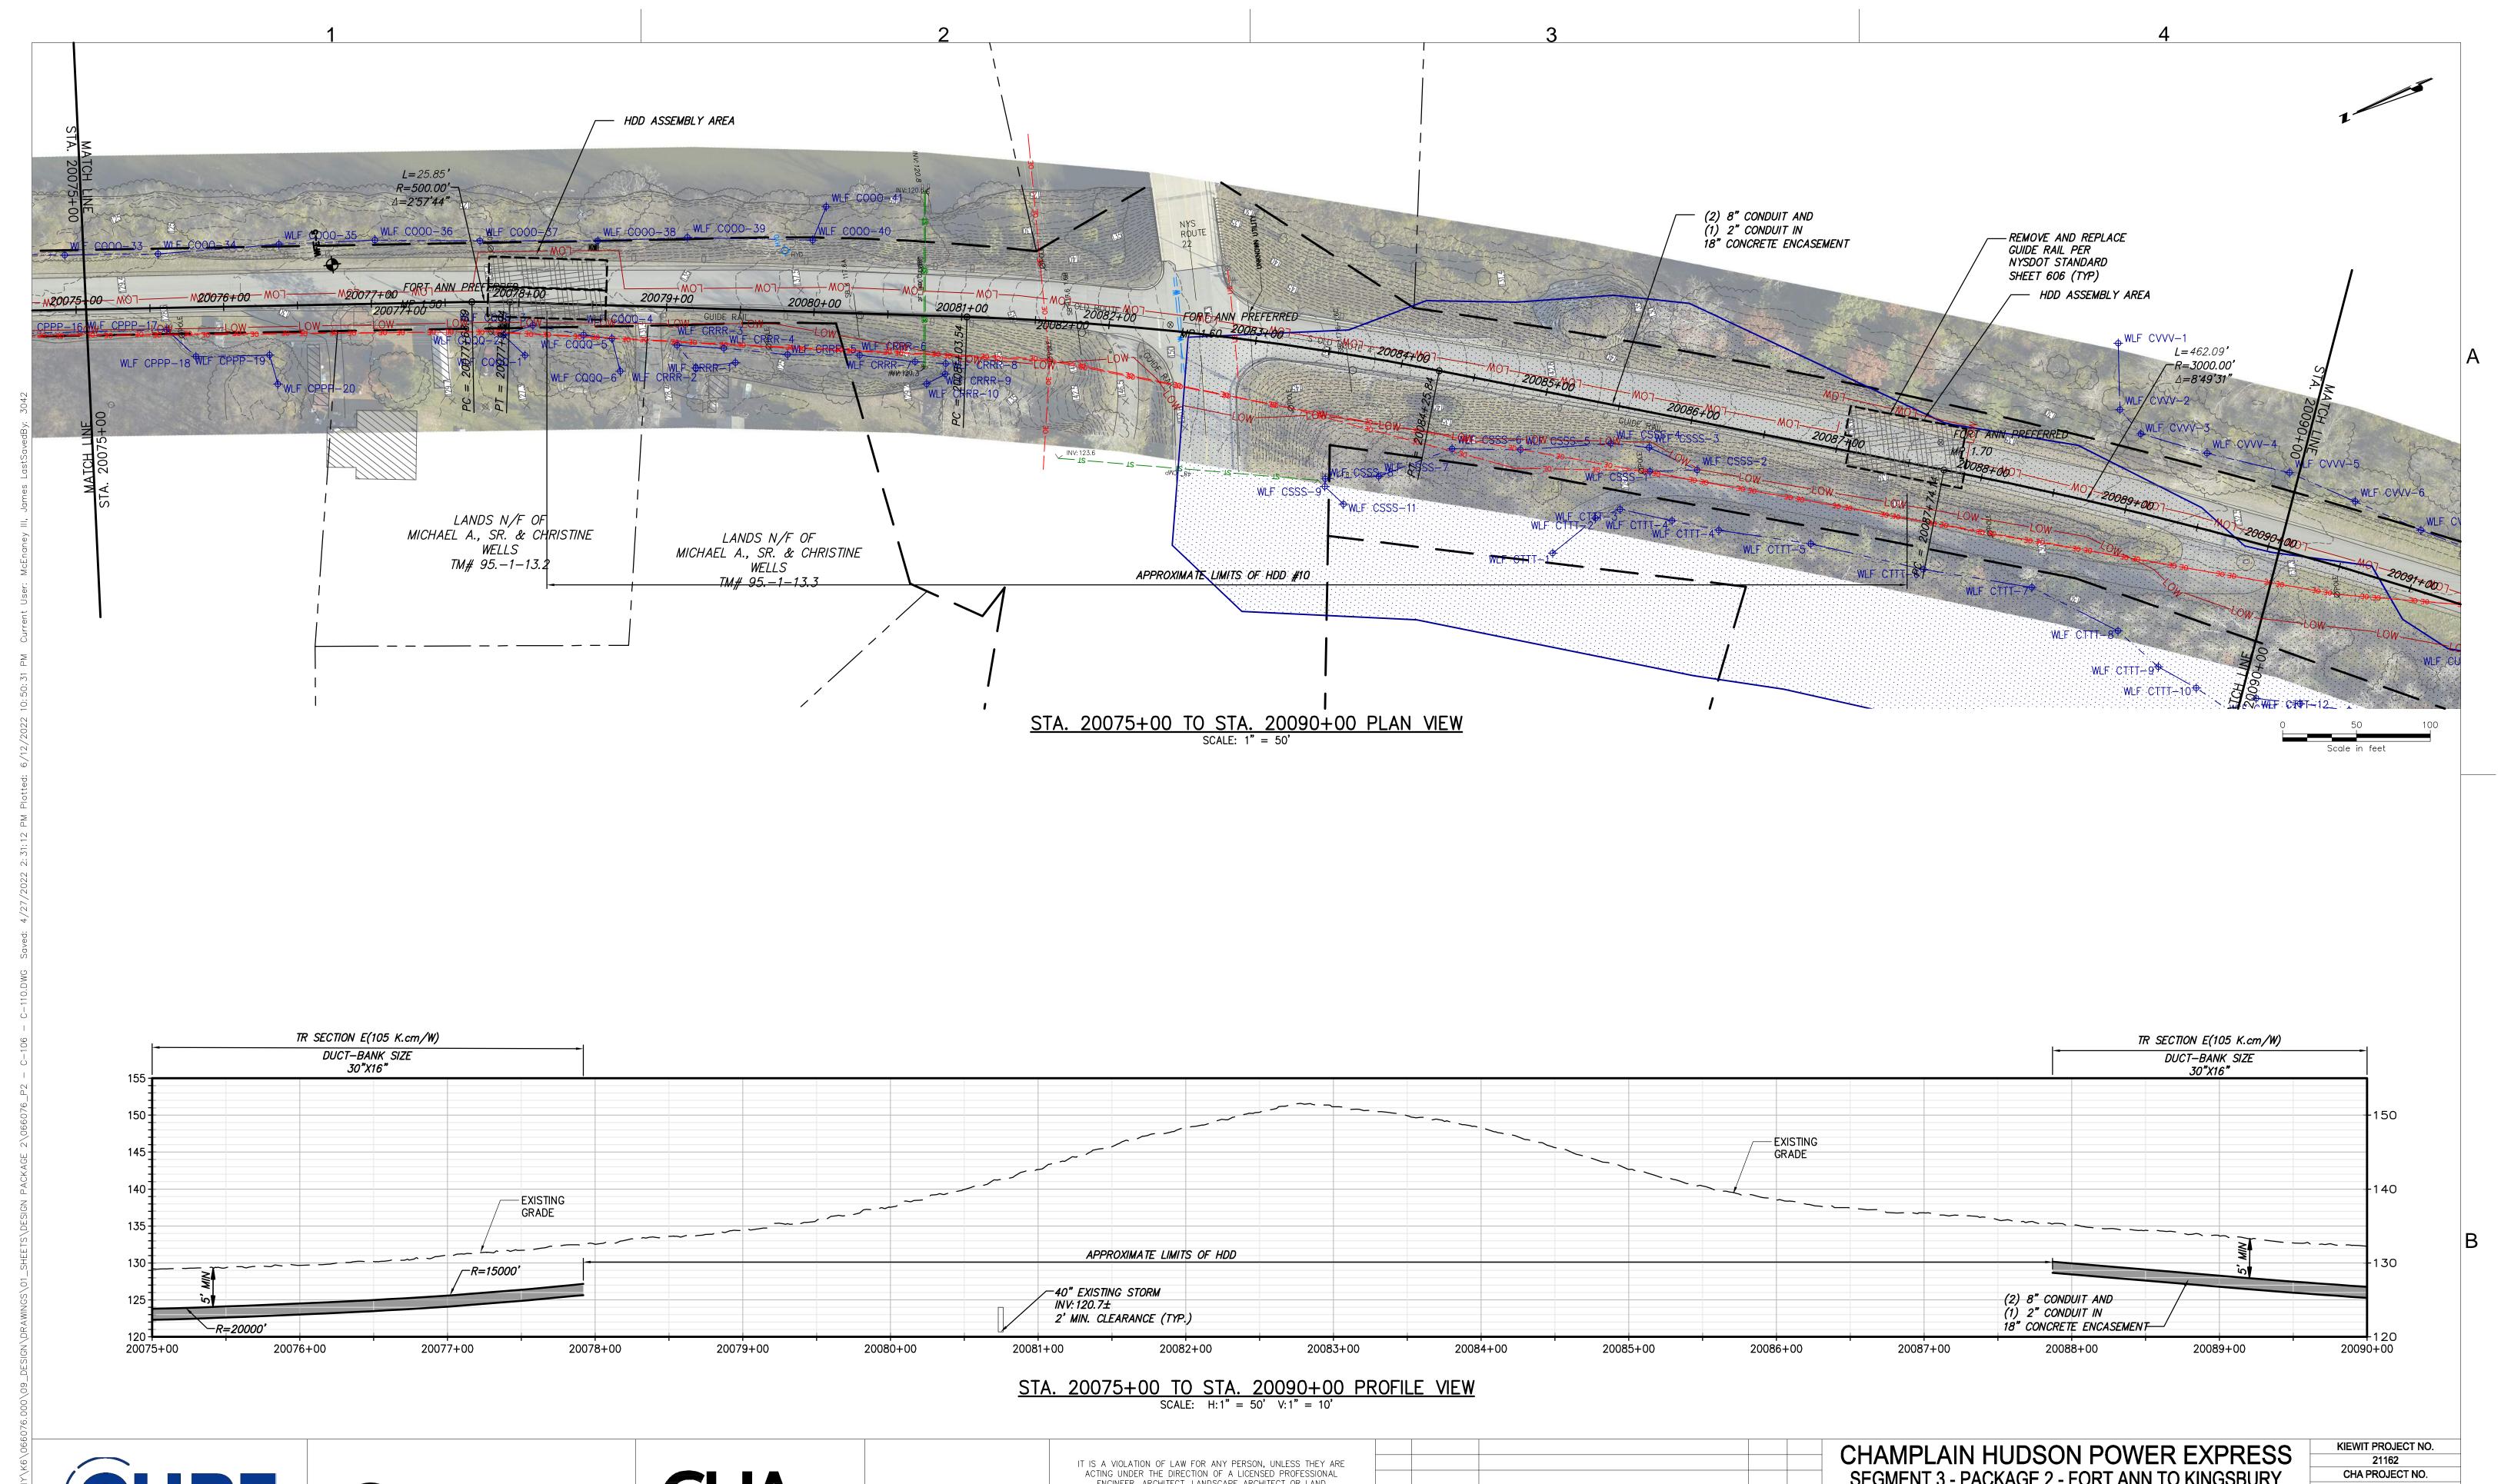
					CHAMPLAIN HUDSON POWER EX
					SEGMENT 3 - PACKAGE 2 - FORT ANN TO KIN
D	04/28/2022	60% SUBMISSION	JM	JR	STA. 20060+00 TO STA. 20075+00 PLAN AND
С	03/04/2022	PROGRESS SUBMISSION	JM	JR	
В	02/23/2022	PROGRESS SUBMISSION	JM	JR	
Α	01/26/2022	30% SUBMISSION	JM	JR	
No.	DATE	SUBMITTAL / REVISION DESCRIPTION	DB	APP	DRAWN BY: XXX DESIGNED BY: XXX APPROVED BY: XXX REV. NO.

CHAMPLAIN HUDSON POWER EXPRESS
SEGMENT 3 - PACKAGE 2 - FORT ANN TO KINGSBURY
STA. 20060+00 TO STA. 20075+00 PLAN AND PROFILE

KIEWIT PROJECT NO.
21162
CHA PROJECT NO.
066076
DRAWING NO.

C-105

AS NOTED DATE 03/04/2022 XXX OF XXX









ENGINEER, ARCHITECT, LANDSCAPE ARCHITECT OR LAND SURVEYOR TO ALTER AN ITEM IN ANY WAY. IF AN ITEM BEARING THE STAMP OF A LICENSED PROFESSIONAL IS ALTERED, THE ALTERING ENGINEER, ARCHITECT, LANDSCAPE ARCHITECT OR LAND SURVEYOR SHALL STAMP THE DOCUMENT AND INCLUDE THE NOTATION "ALTERED BY" FOLLOWED BY THEIR SIGNATURE, THE DATE OF SUCH ALTERATION, AND A SPECIFIC DESCRIPTION
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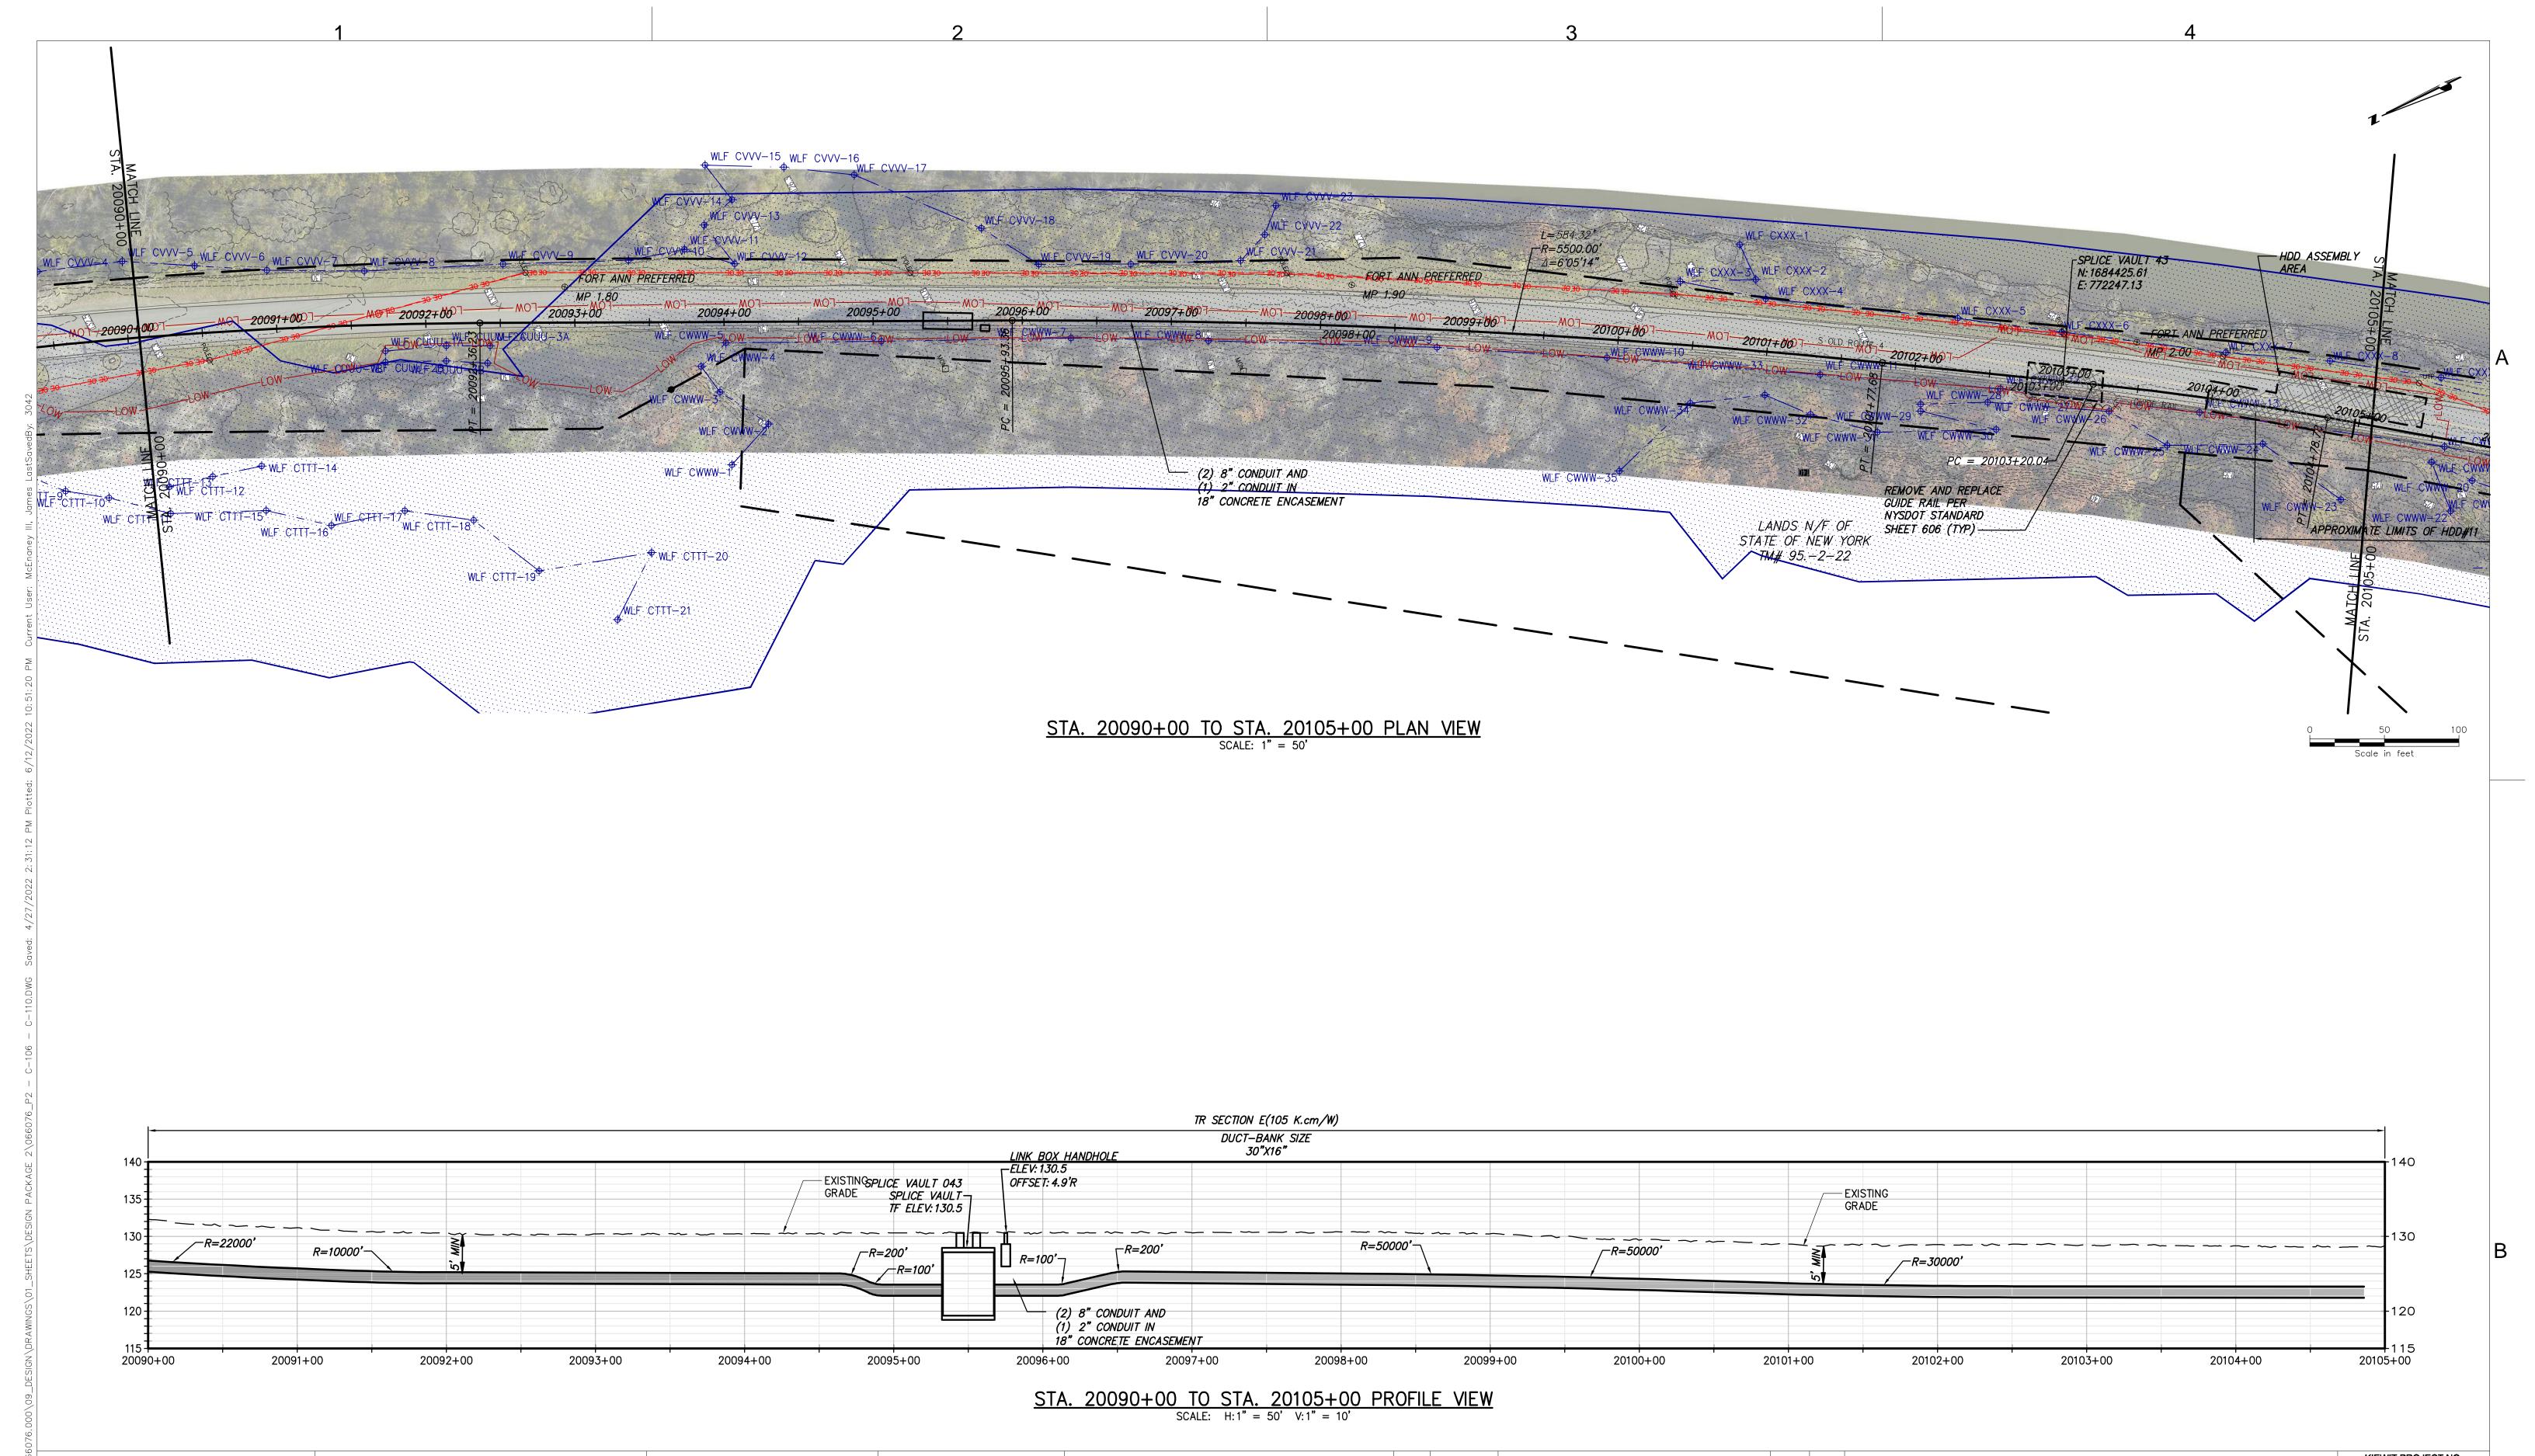
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	D	04/28/2022	60% SUBMISSION	JM	JR	STA. 20075+00 TO STA. 20090+00 PLAN AND
	С	03/04/2022	PROGRESS SUBMISSION	JM	JR	
	В	02/23/2022	PROGRESS SUBMISSION	JM	JR	
	Α	01/26/2022	30% SUBMISSION	JM	JR	
	No.	DATE	SUBMITTAL / REVISION DESCRIPTION	DB	APP	DRAWN BY: XXX DESIGNED BY: XXX APPROVED BY: XXX REV. NO.
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SEGMENT 3 - PACKAGE 2 - FORT ANN TO KINGSBURY STA. 20075+00 TO STA. 20090+00 PLAN AND PROFILE

066076 DRAWING NO.

C-106

AS NOTED DATE









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D	04/28/2022	60% SUBMISSION	JM	JR	5
С	03/04/2022	PROGRESS SUBMISSION	JM	JR	
В	02/23/2022	PROGRESS SUBMISSION	JM	JR	
Α	01/26/2022	30% SUBMISSION	JM	JR	
No.	DATE	SUBMITTAL / REVISION DESCRIPTION	DB	APP	DR

CHAMPLAIN HUDSON POWER EXPRESS SEGMENT 3 - PACKAGE 2 - FORT ANN TO KINGSBURY STA. 20090+00 TO STA. 20105+00 PLAN AND PROFILE

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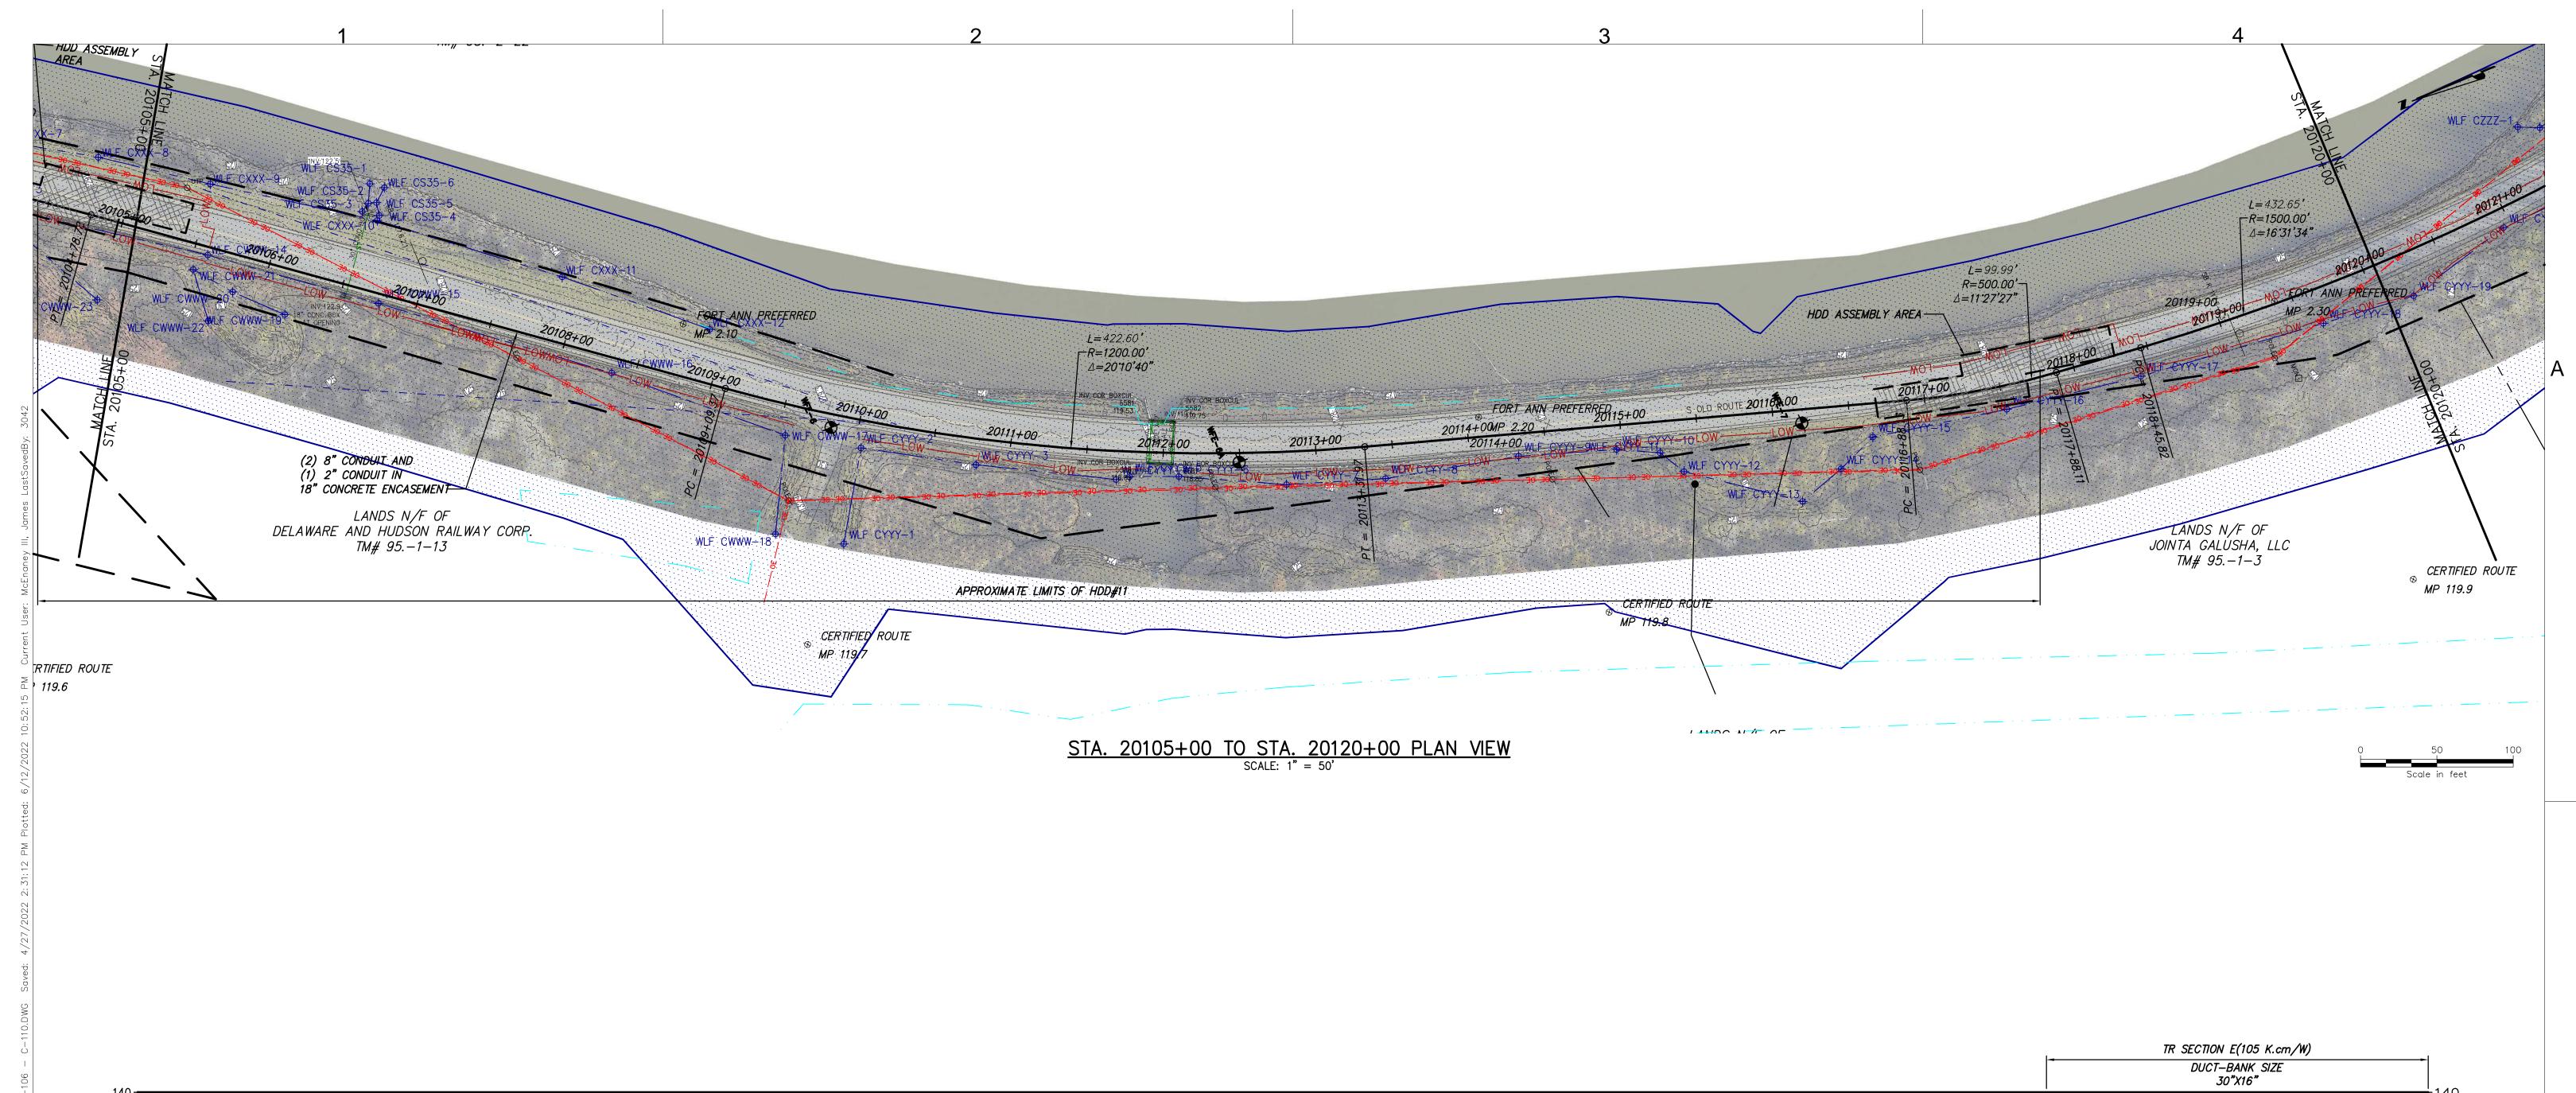
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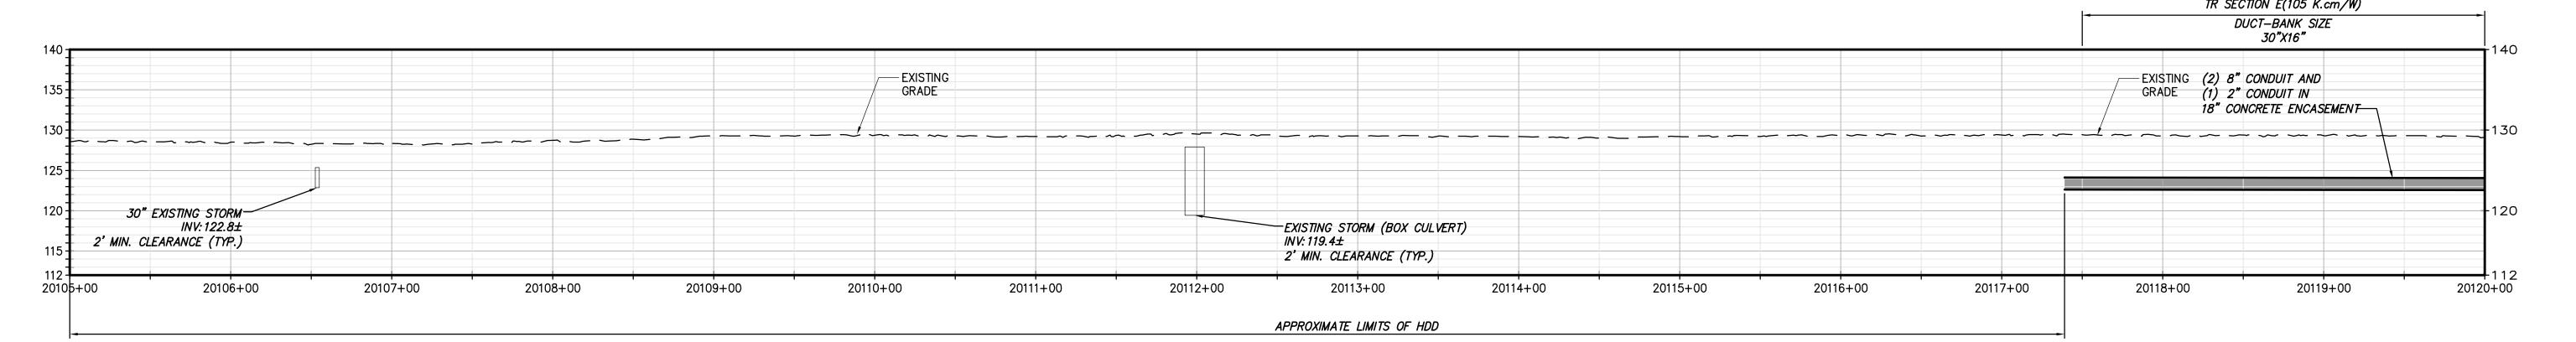
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DRAWING NO.

C-107

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RAWN BY: XXX DESIGNED BY: XXX APPROVED BY: XXX SAPROVED BY: XXX OF XXX





## STA. 20105+00 TO STA. 20120+00 PROFILE VIEW SCALE: H: 1" = 50' V: 1" = 10'







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D	04/28/2022	60% SUBMISSION	JM	JR	S
С	03/04/2022	PROGRESS SUBMISSION	JM	JR	
В	02/23/2022	PROGRESS SUBMISSION	JM	JR	
Α	01/26/2022	30% SUBMISSION	JM	JR	
No.	DATE	SUBMITTAL / REVISION DESCRIPTION	DB	APP	DRA


CHAMPLAIN HUDSON POWER EXPRESS	_
SEGMENT 3 - PACKAGE 2 - FORT ANN TO KINGSBURY	_
STA. 20105+00 TO STA. 20120+00 PLAN AND PROFILE	_


KIEWIT PROJECT NO. 21162 CHA PROJECT NO. 066076 DRAWING NO.


C-108

TE 03/04/20:

RAWN BY: XXX DESIGNED BY: XXX APPROVED BY: XXX REV. NO. XXX OF XXX

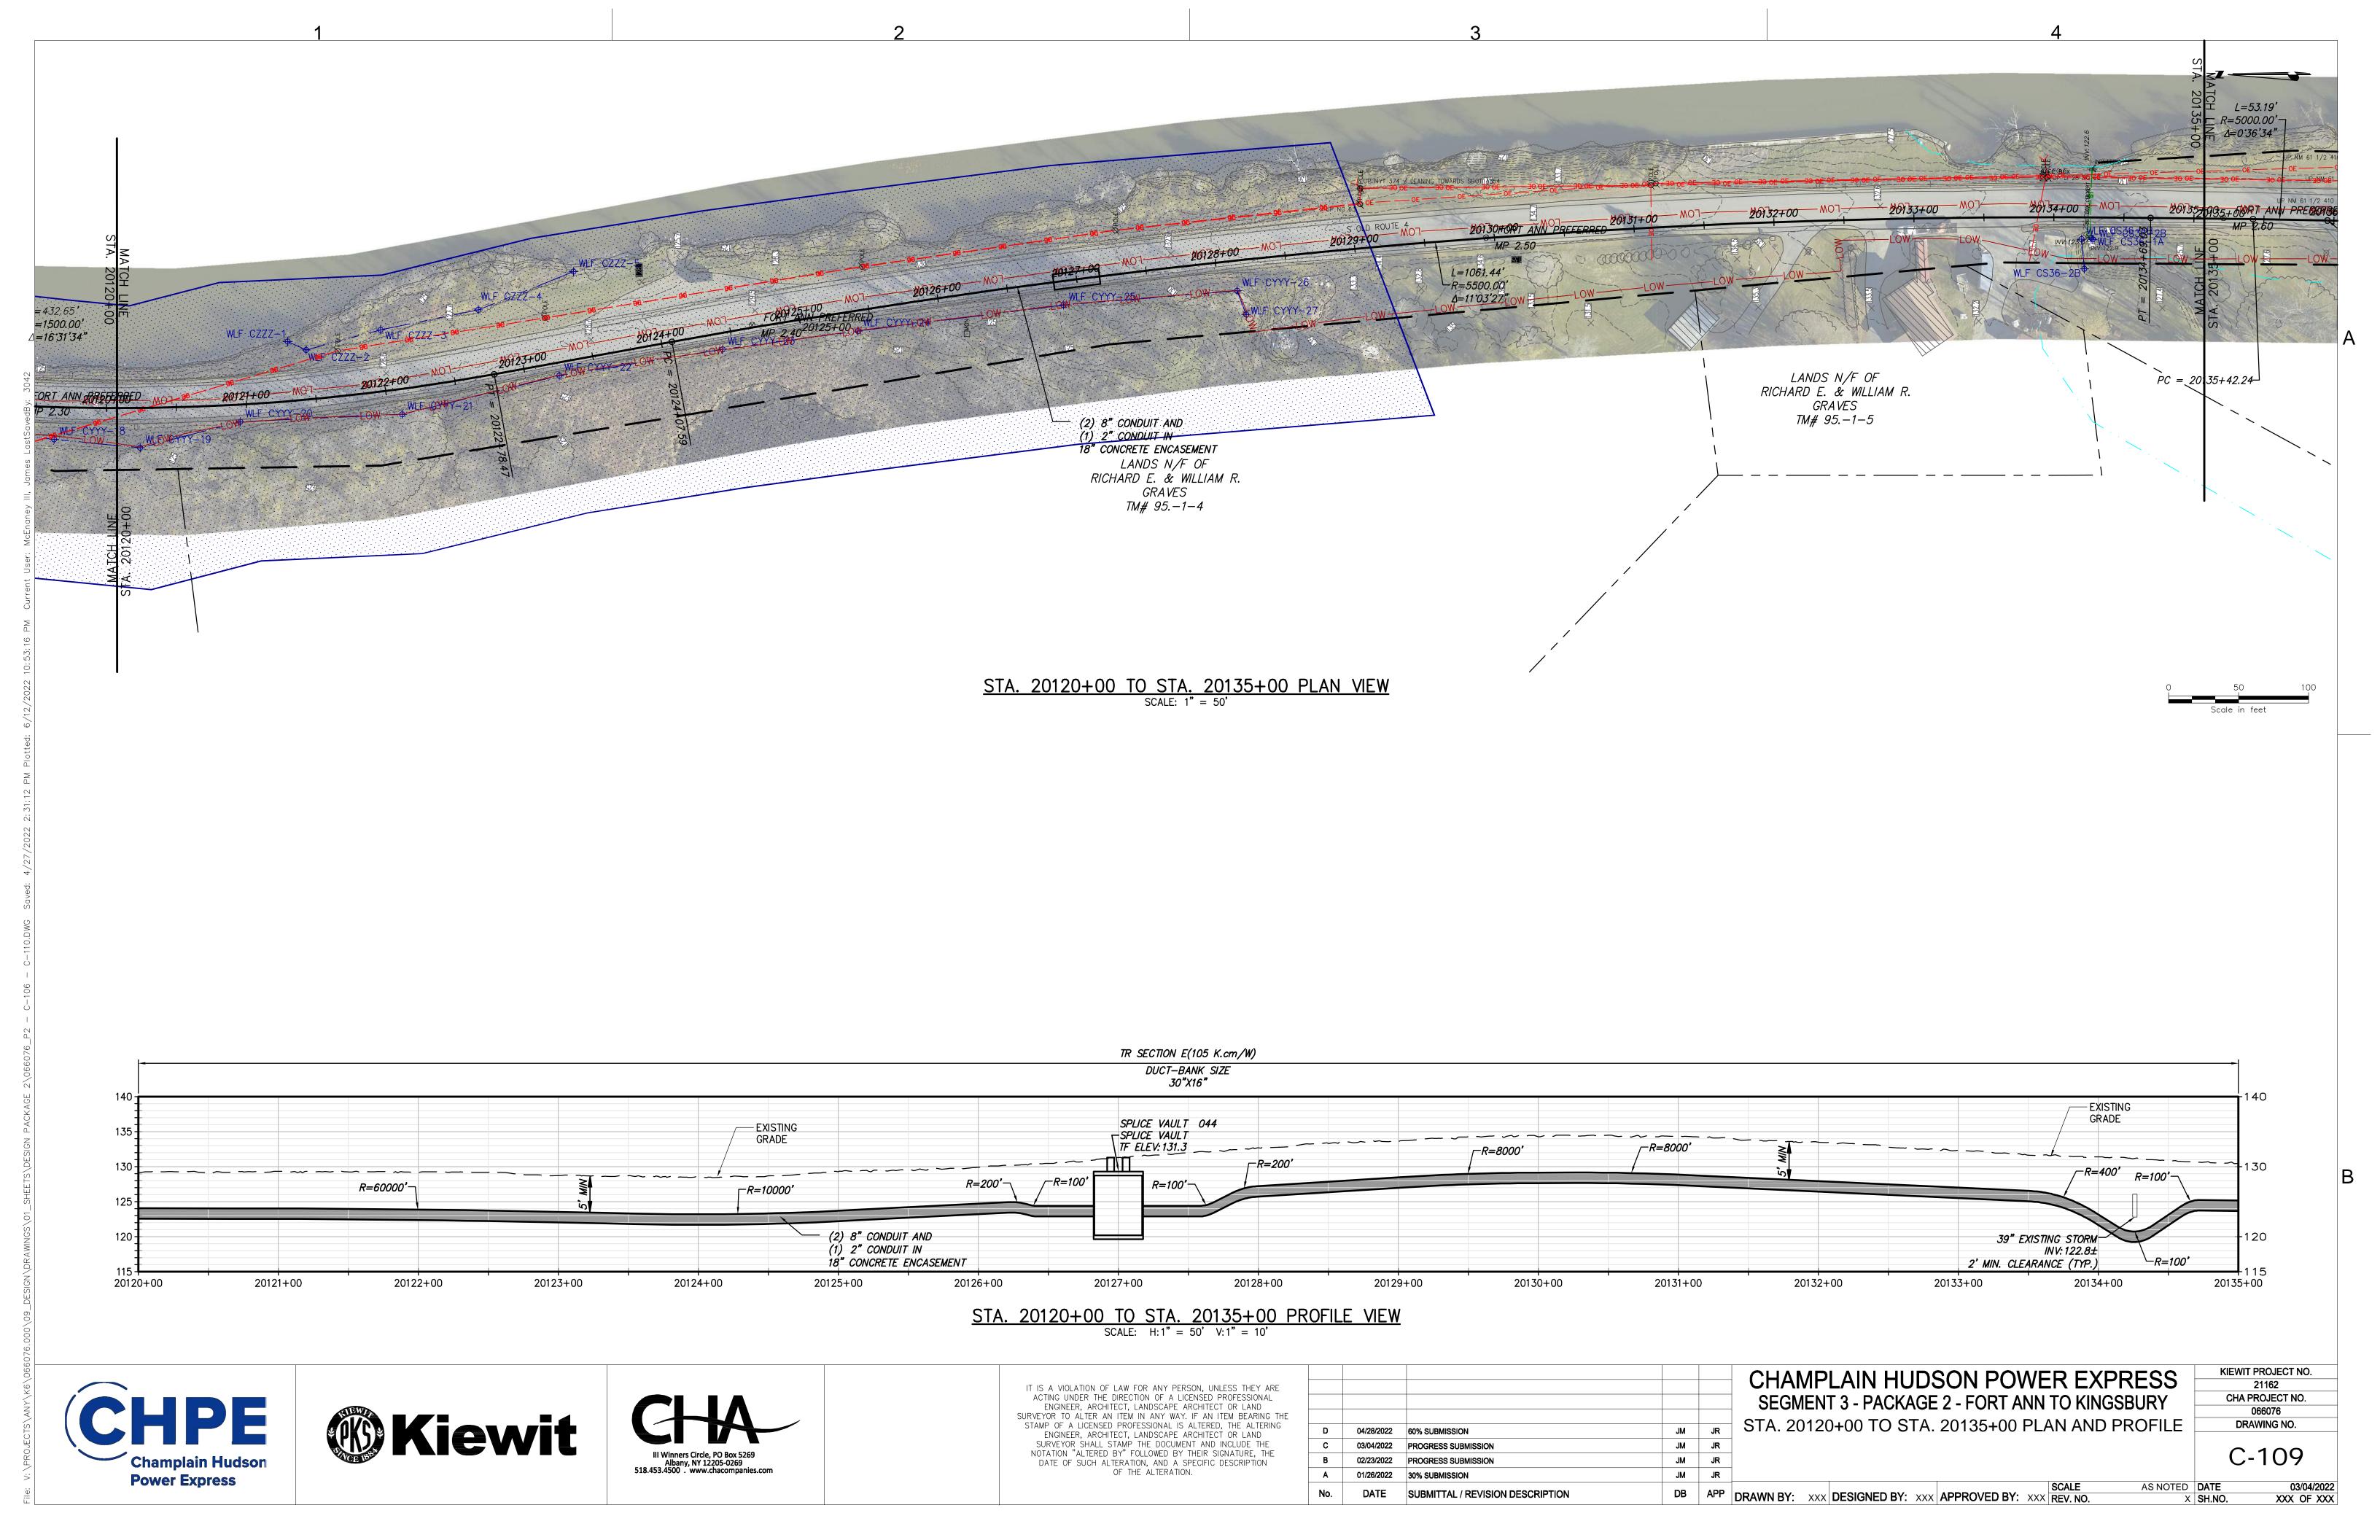

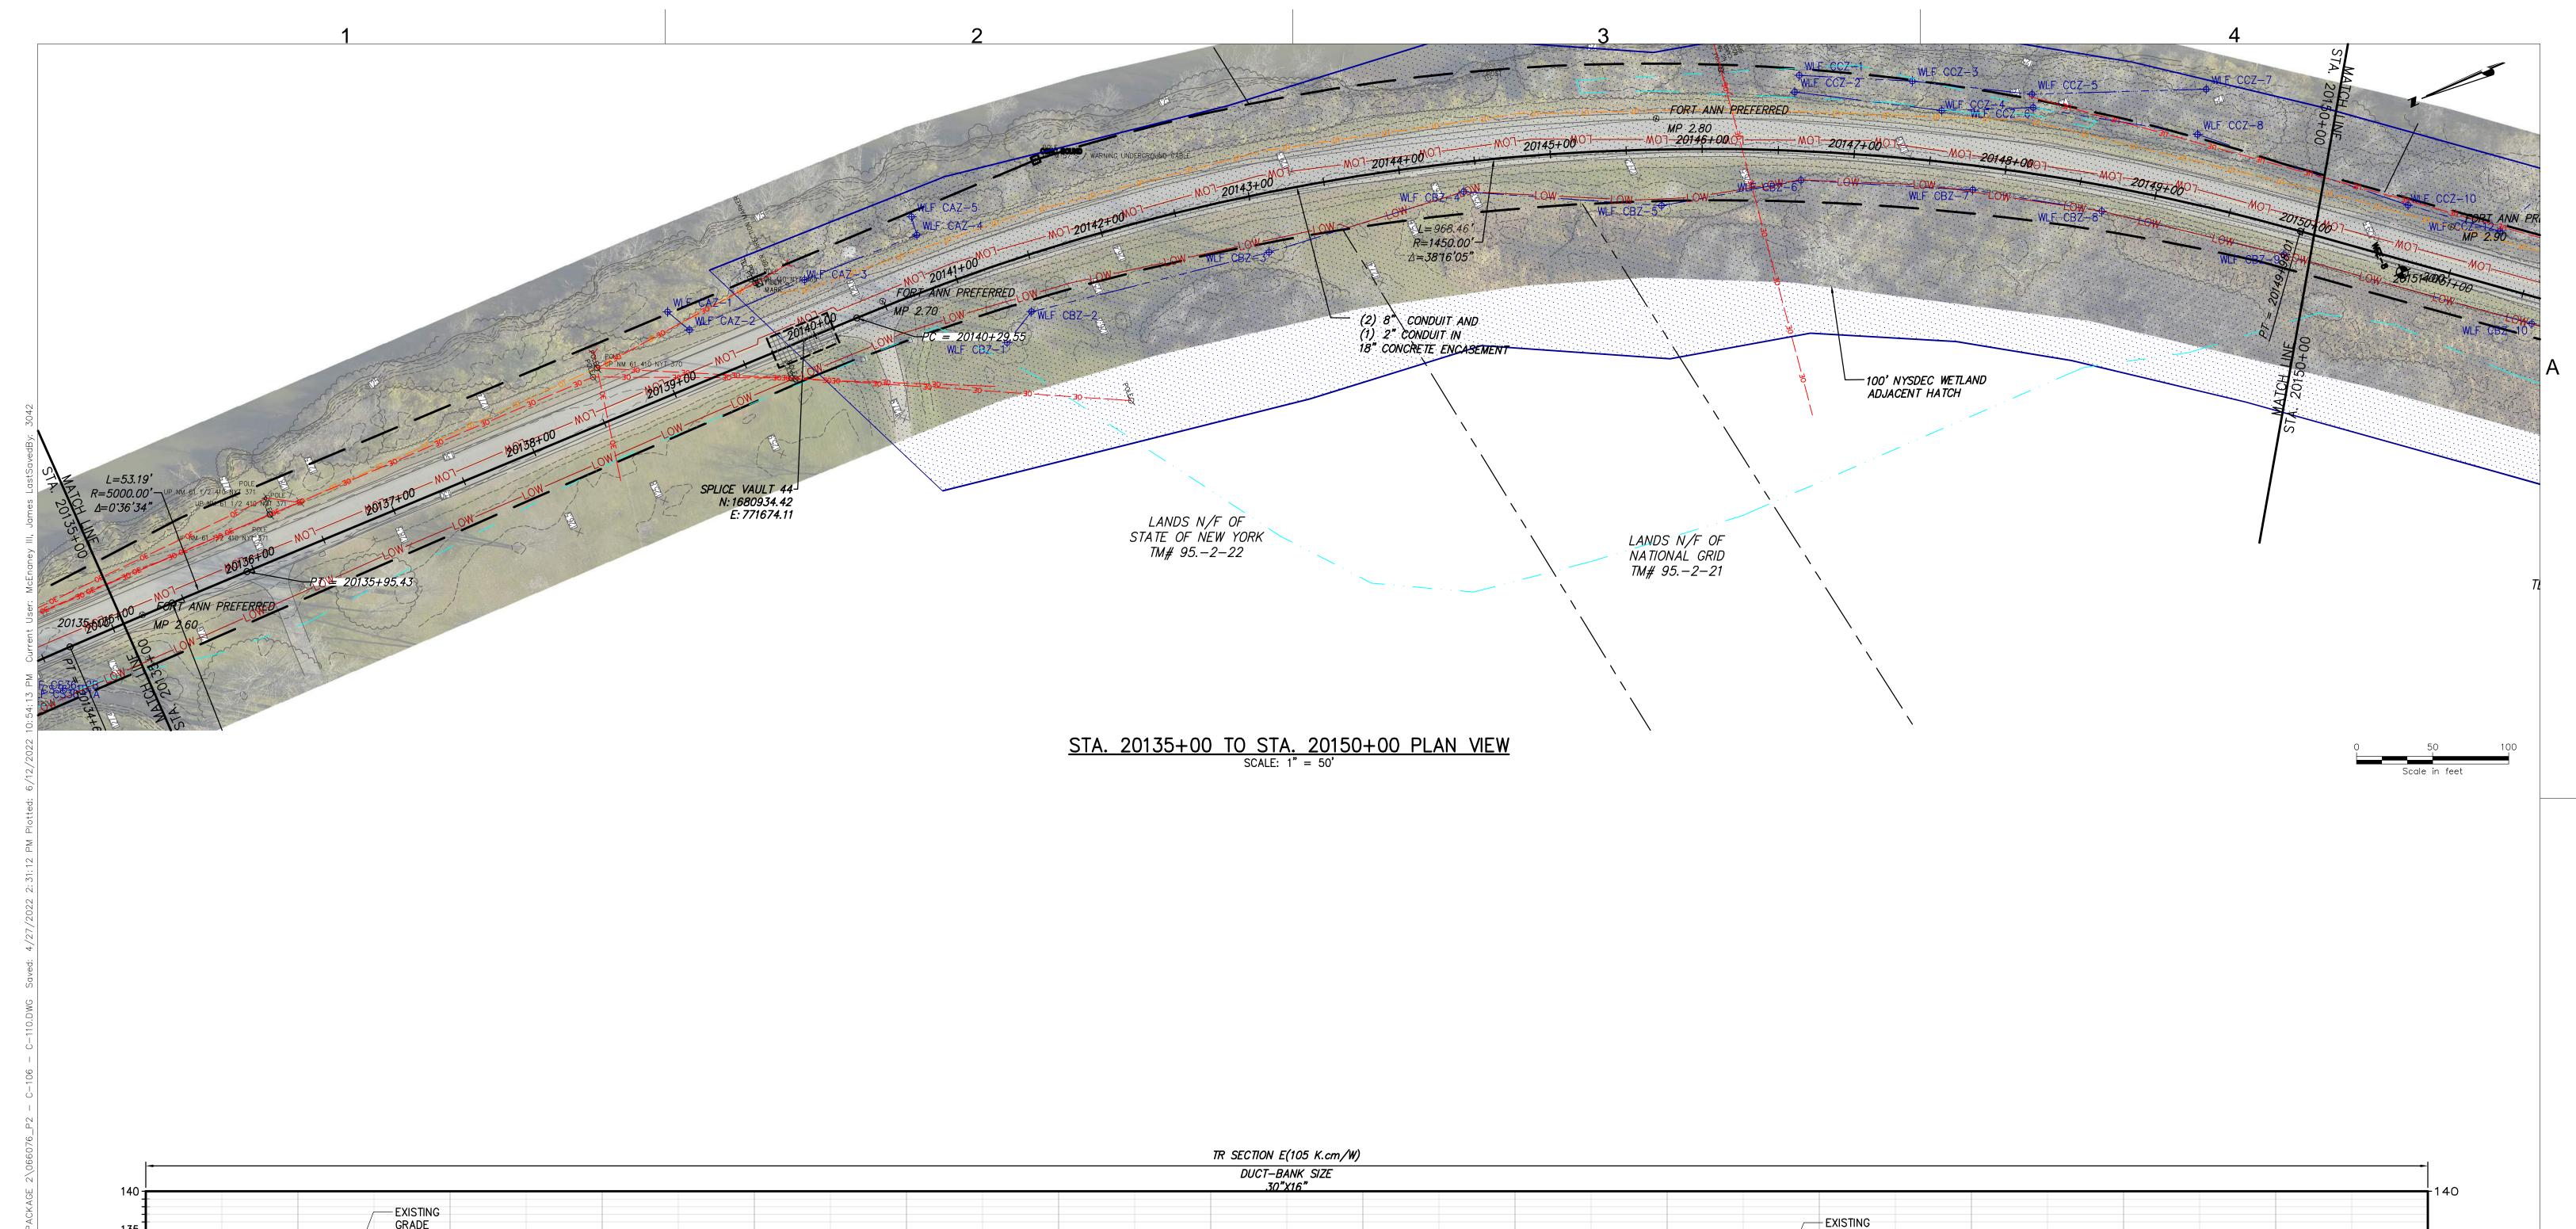

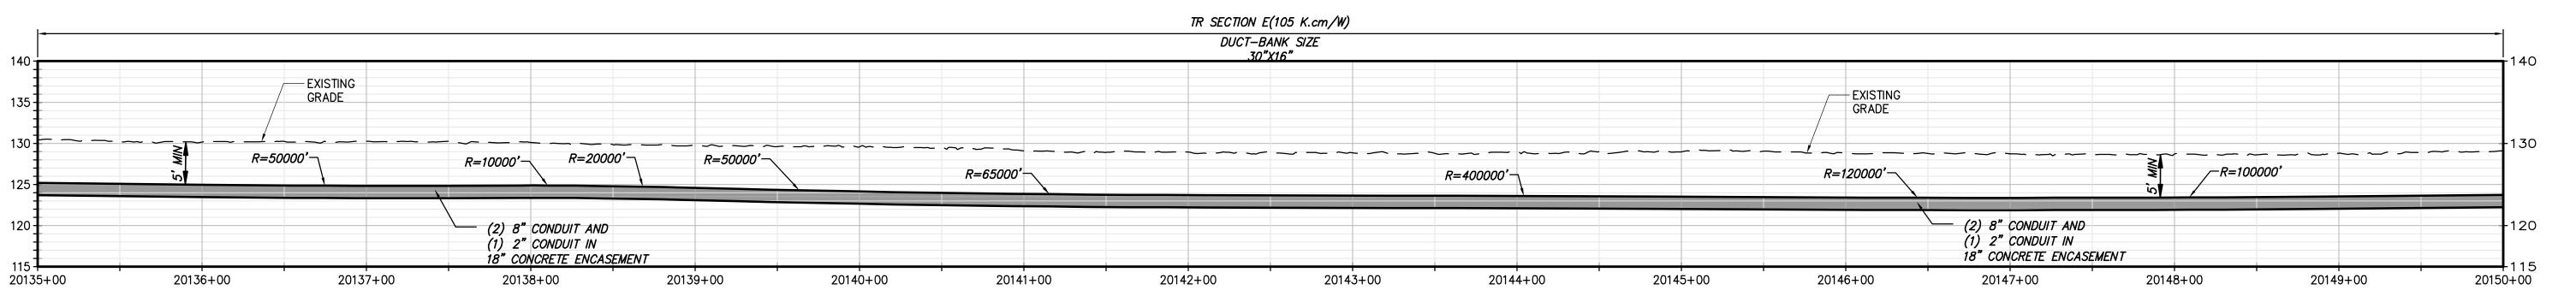

STA. 20135+00 TO STA. 20150+00 PROFILE VIEW

SCALE: H: 1" = 50' V: 1" = 10'







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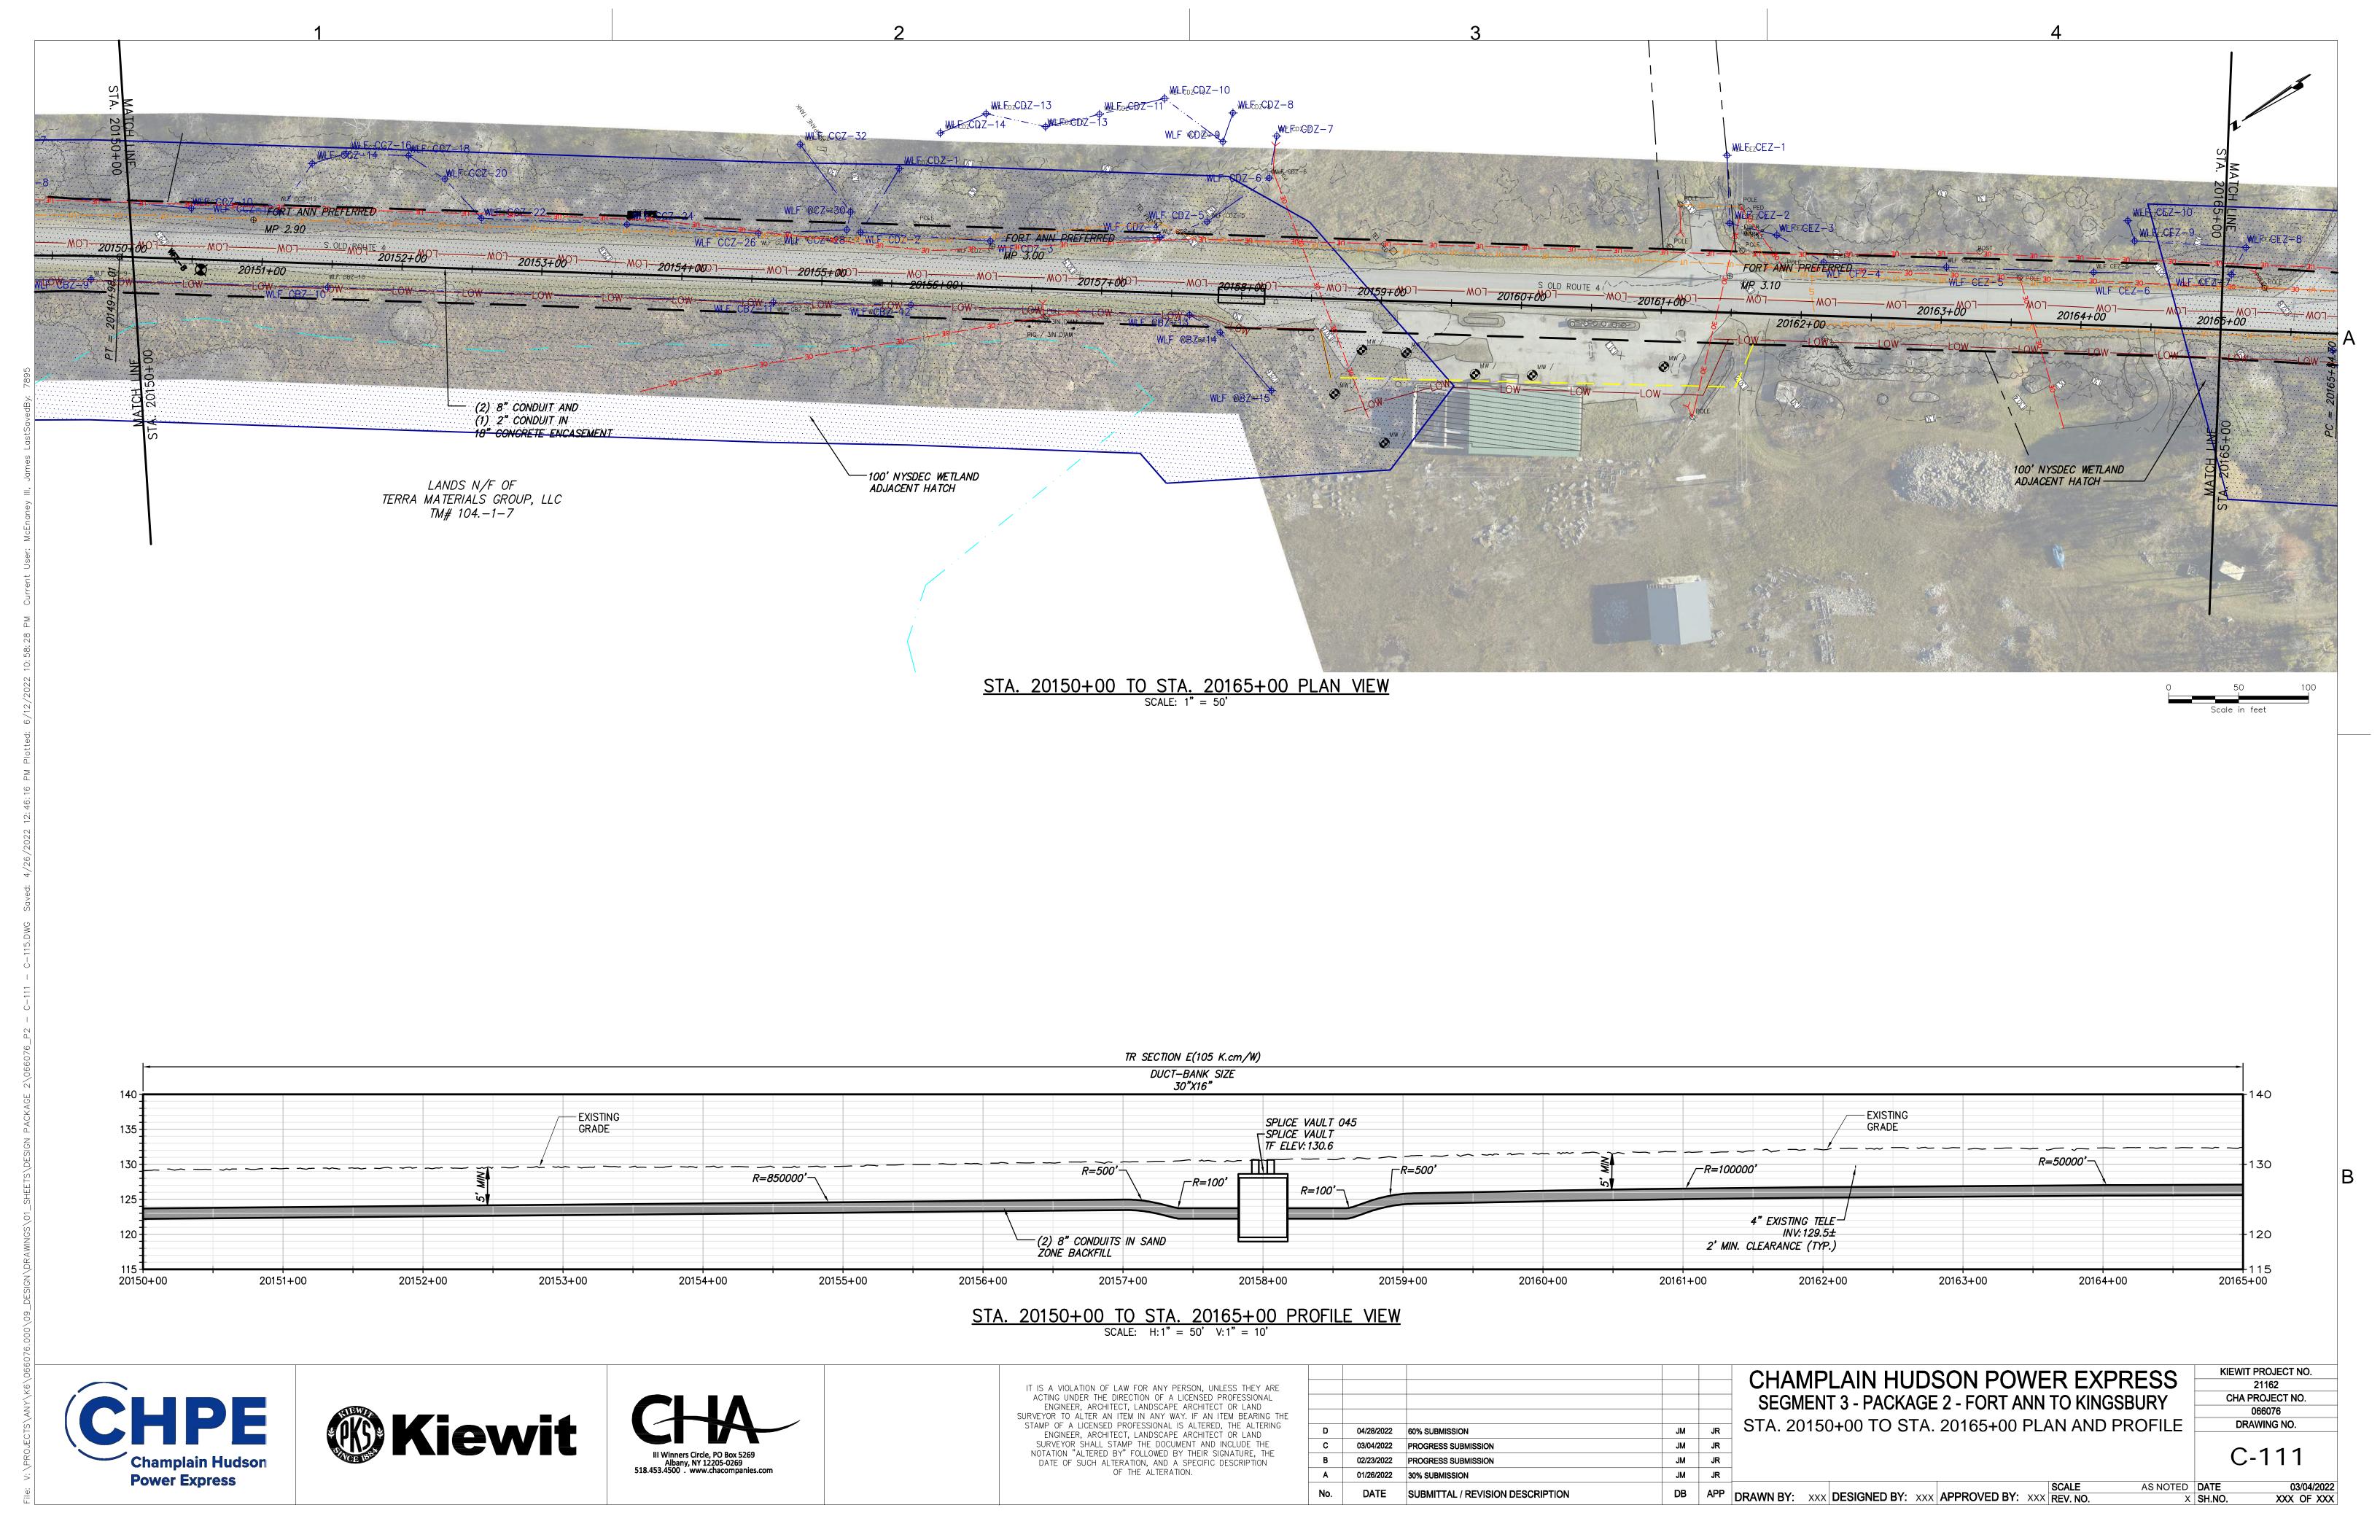
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	В	02/23/2022	PROGRESS SUBMISSION	JM	JR						
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	No.	DATE	SUBMITTAL / REVISION DESCRIPTION	DB	APP		DEGLONED B		4 5 5 5 6 7 6	D D\/	SCALE
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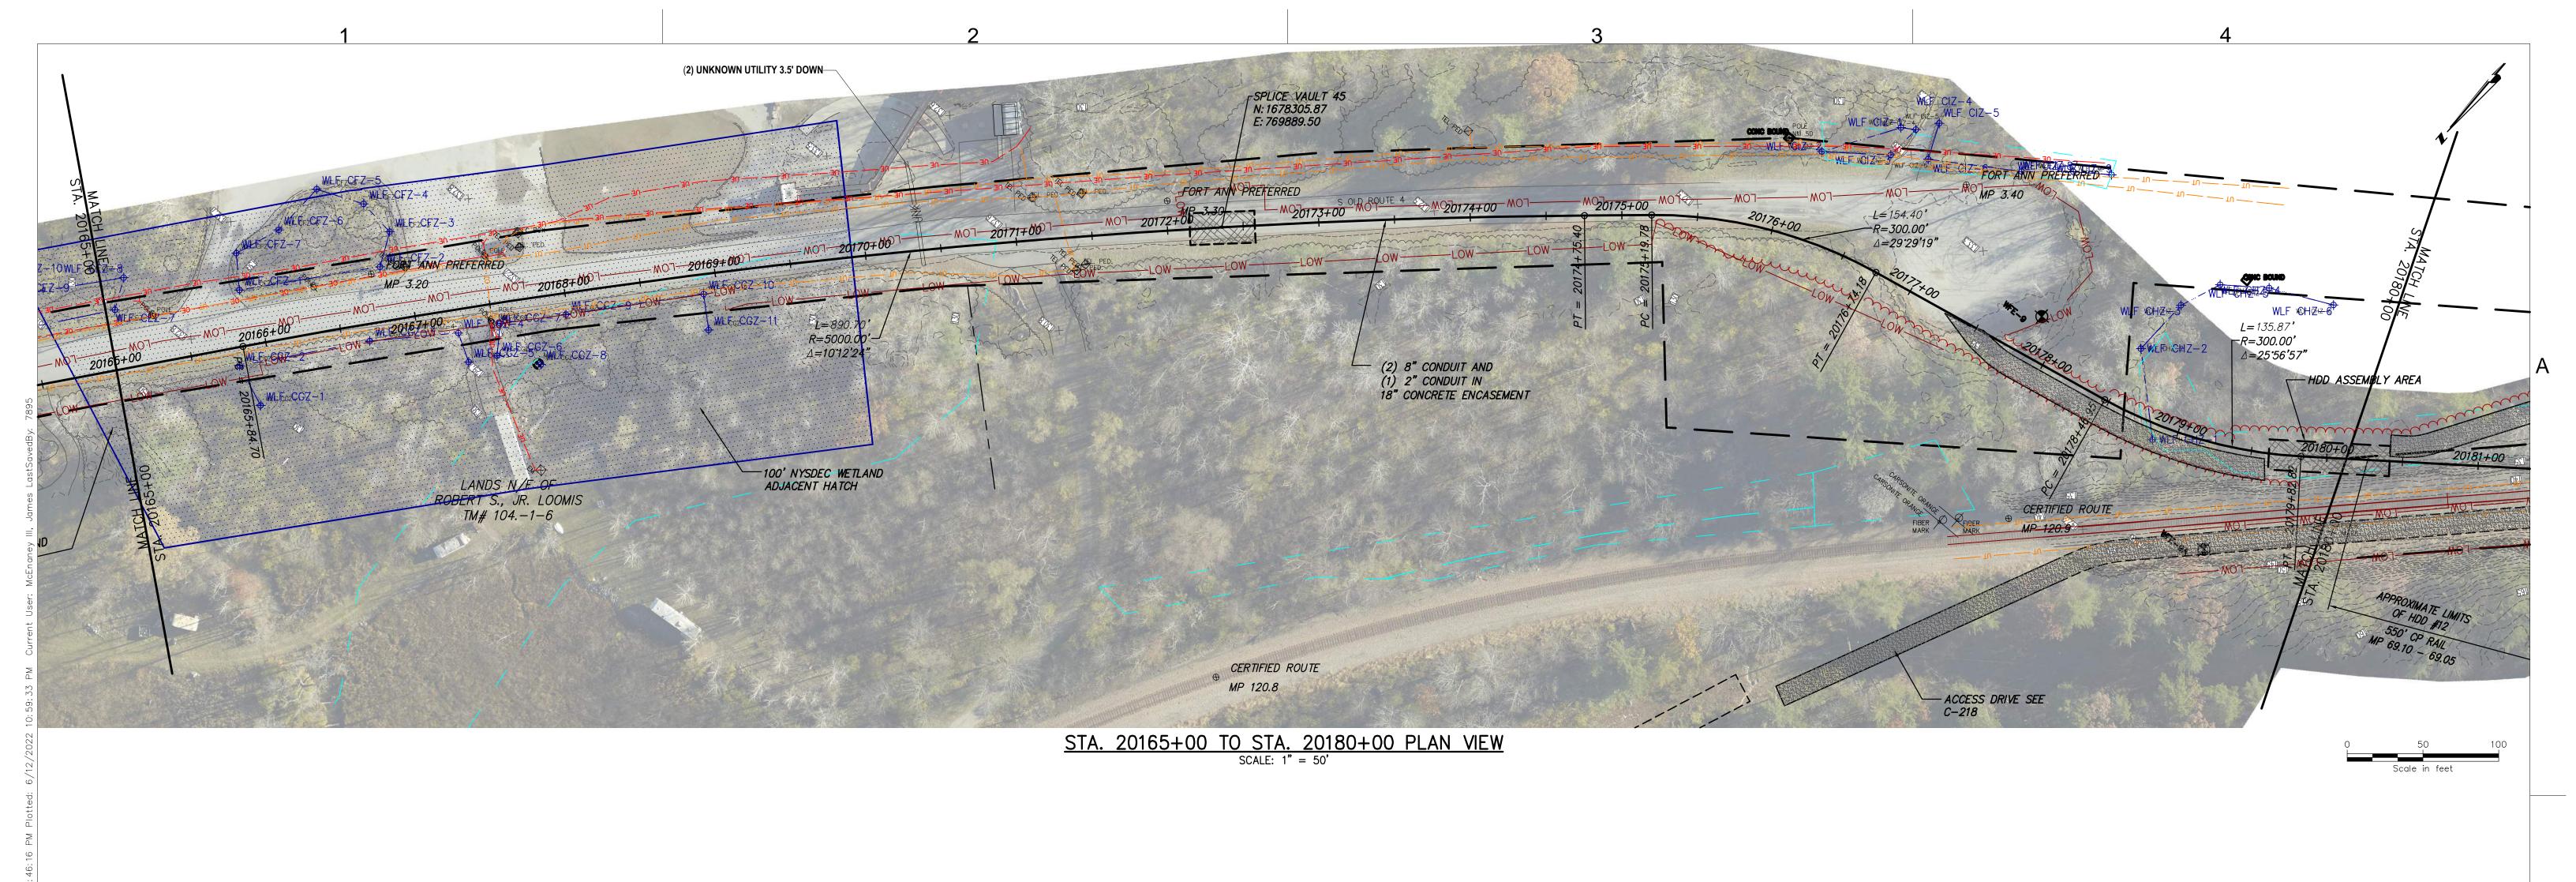
CHAMPLAIN HUDSON POWER EXPRESS							
SEGMENT 3 - PACKAGE 2 - FORT ANN TO KINGSBURY							
STA. 20135+00 TO STA. 20150+00 PLAN AND PROFILE							


KIEWIT PROJECT NO. 21162 CHA PROJECT NO. 066076 DRAWING NO.

C-110

AS NOTED DATE XXX OF XXX X SH.NO.





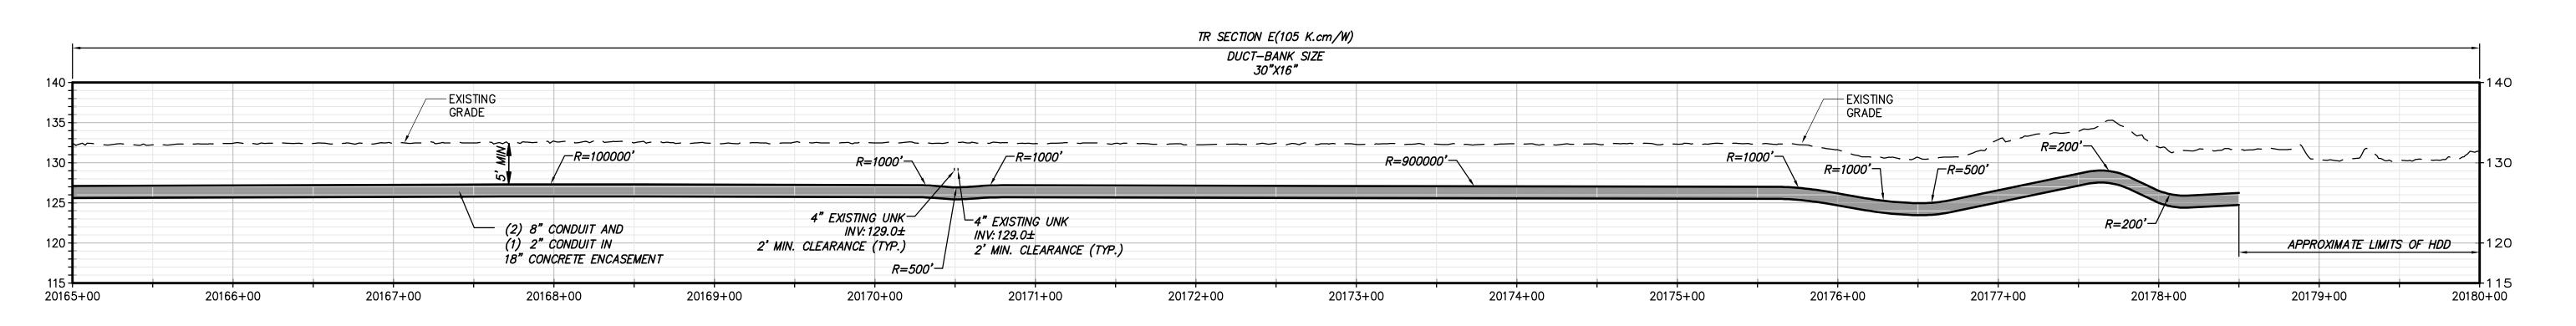

## STA. 20165+00 TO STA. 20180+00 PROFILE VIEW SCALE: H: 1" = 50' V: 1" = 10'







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В	02/23/2022	PROGRESS SUBMISSION	JM	JR						
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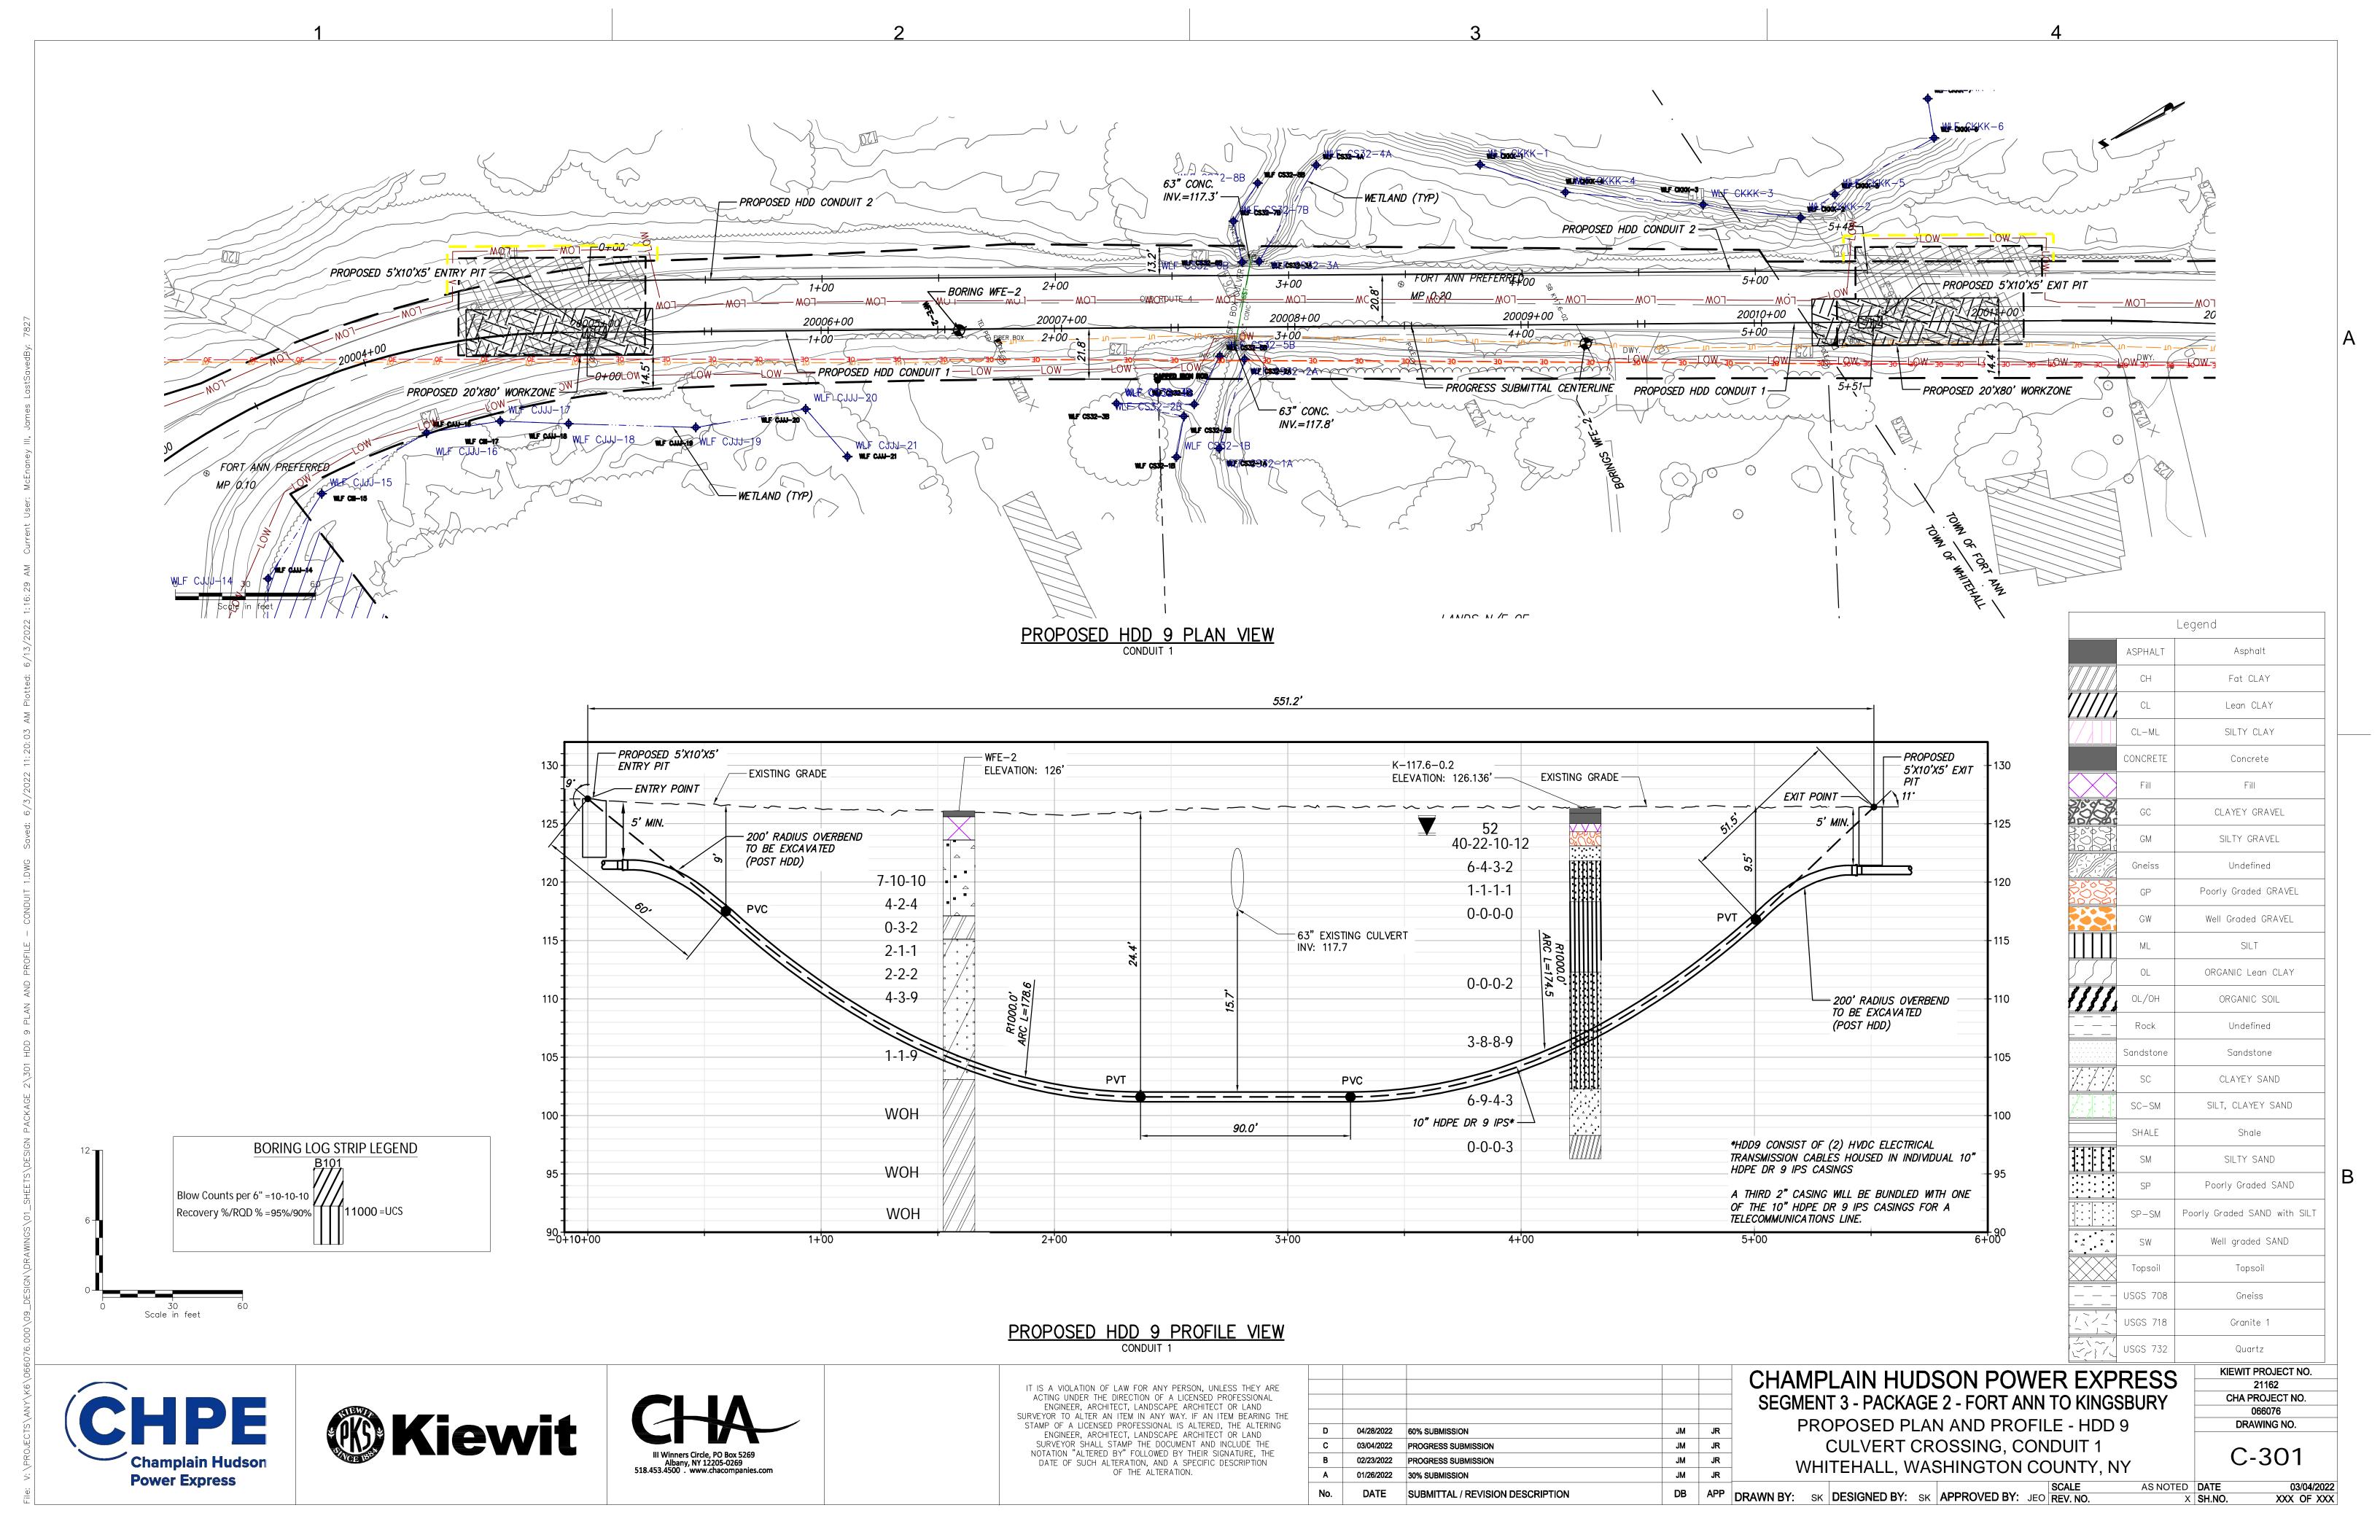
### CHAMPLAIN HUDSON POWER EXPRESS SEGMENT 3 - PACKAGE 2 - FORT ANN TO KINGSBURY STA. 20165+00 TO STA. 20180+00 PLAN AND PROFILE


KIEWIT PROJECT NO. 21162 CHA PROJECT NO. 066076 DRAWING NO.


C-112


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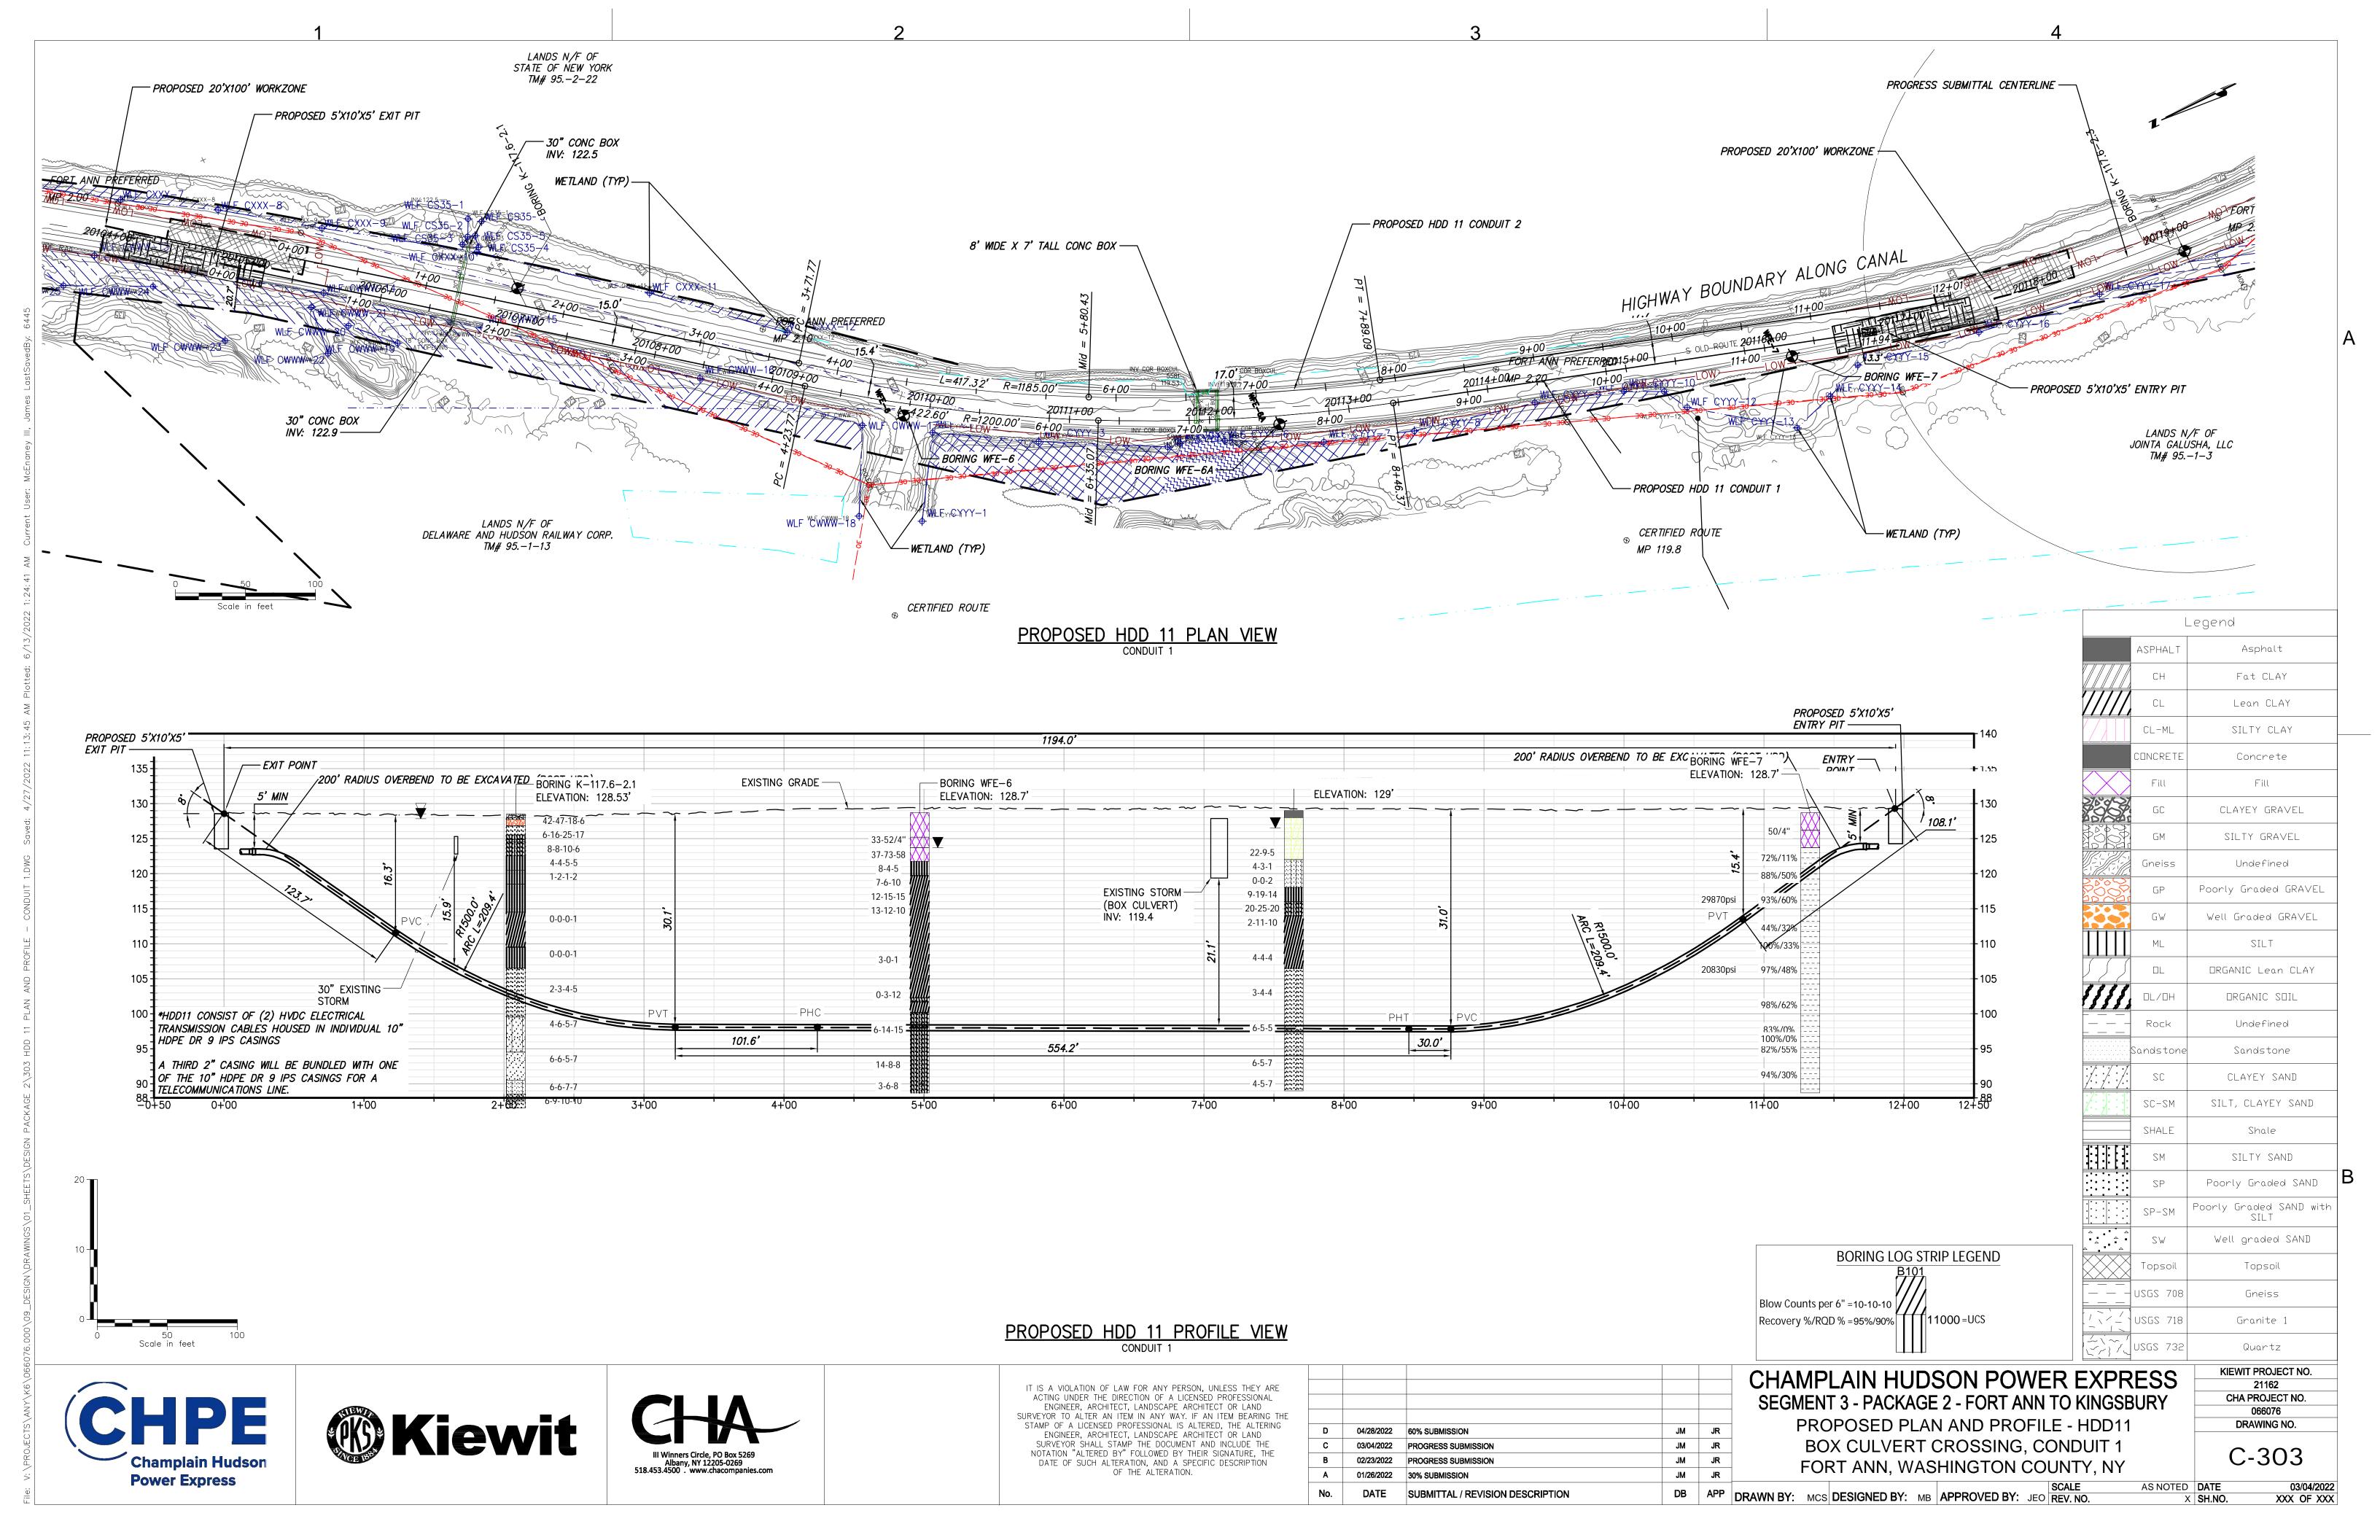
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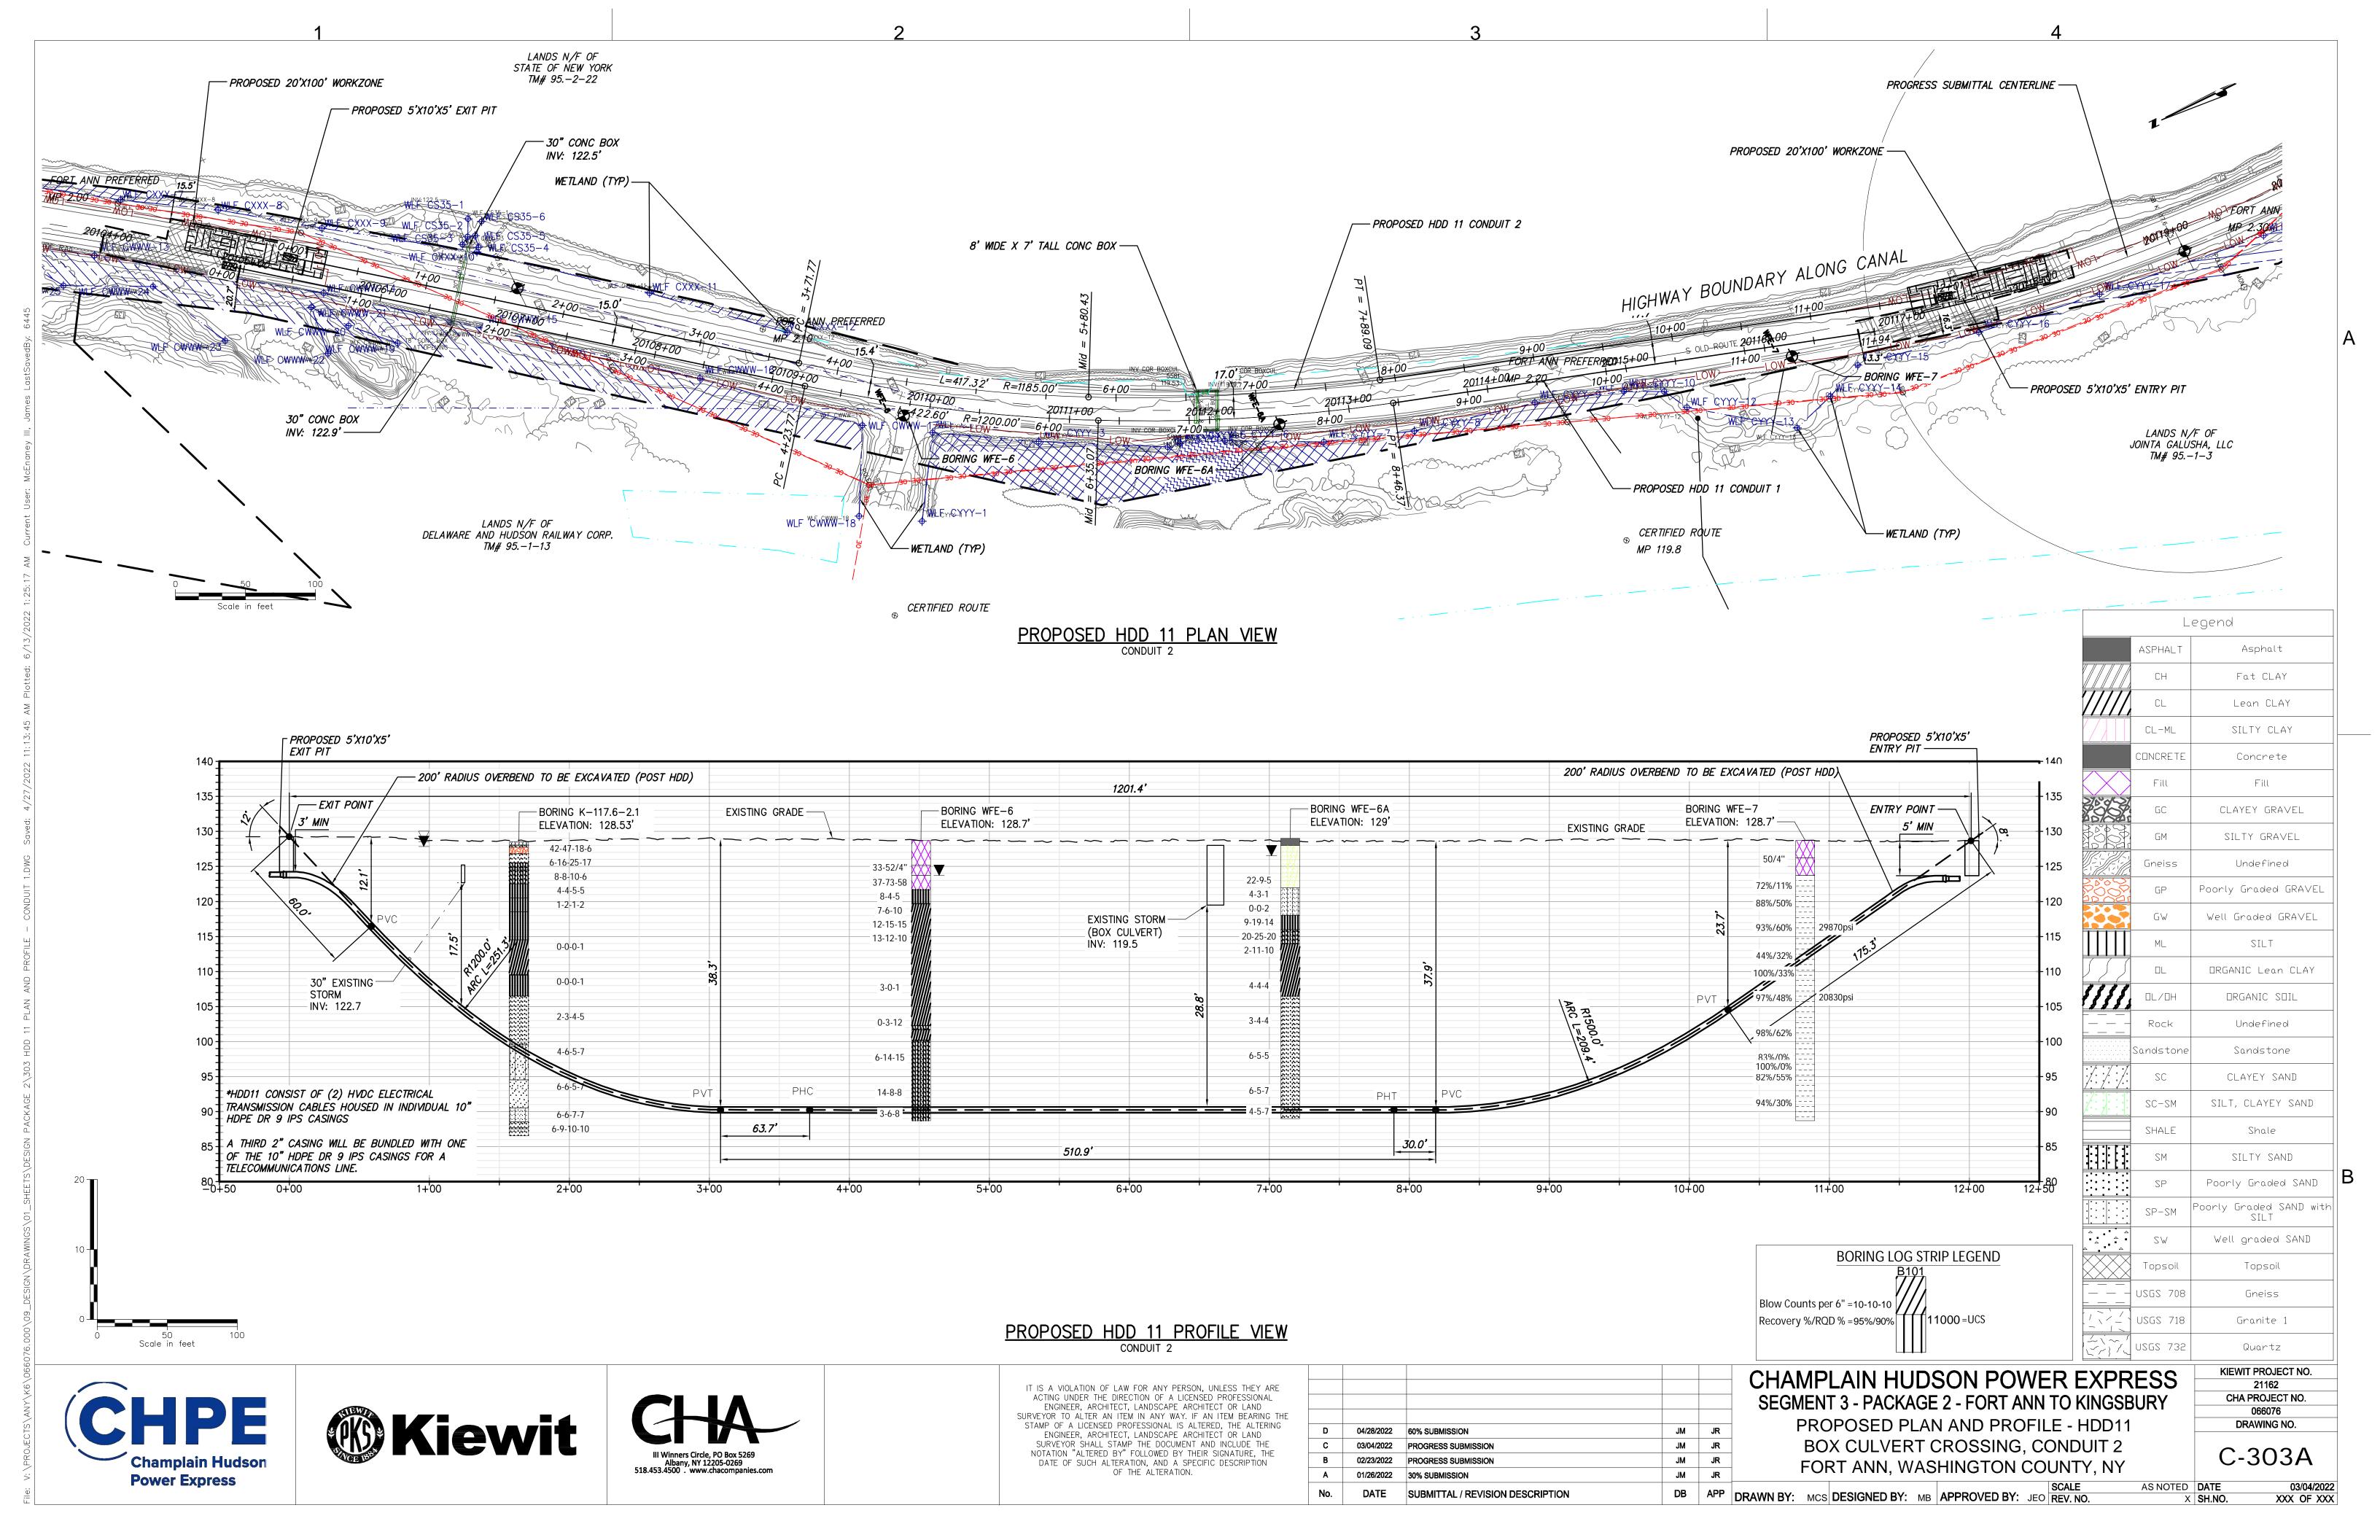








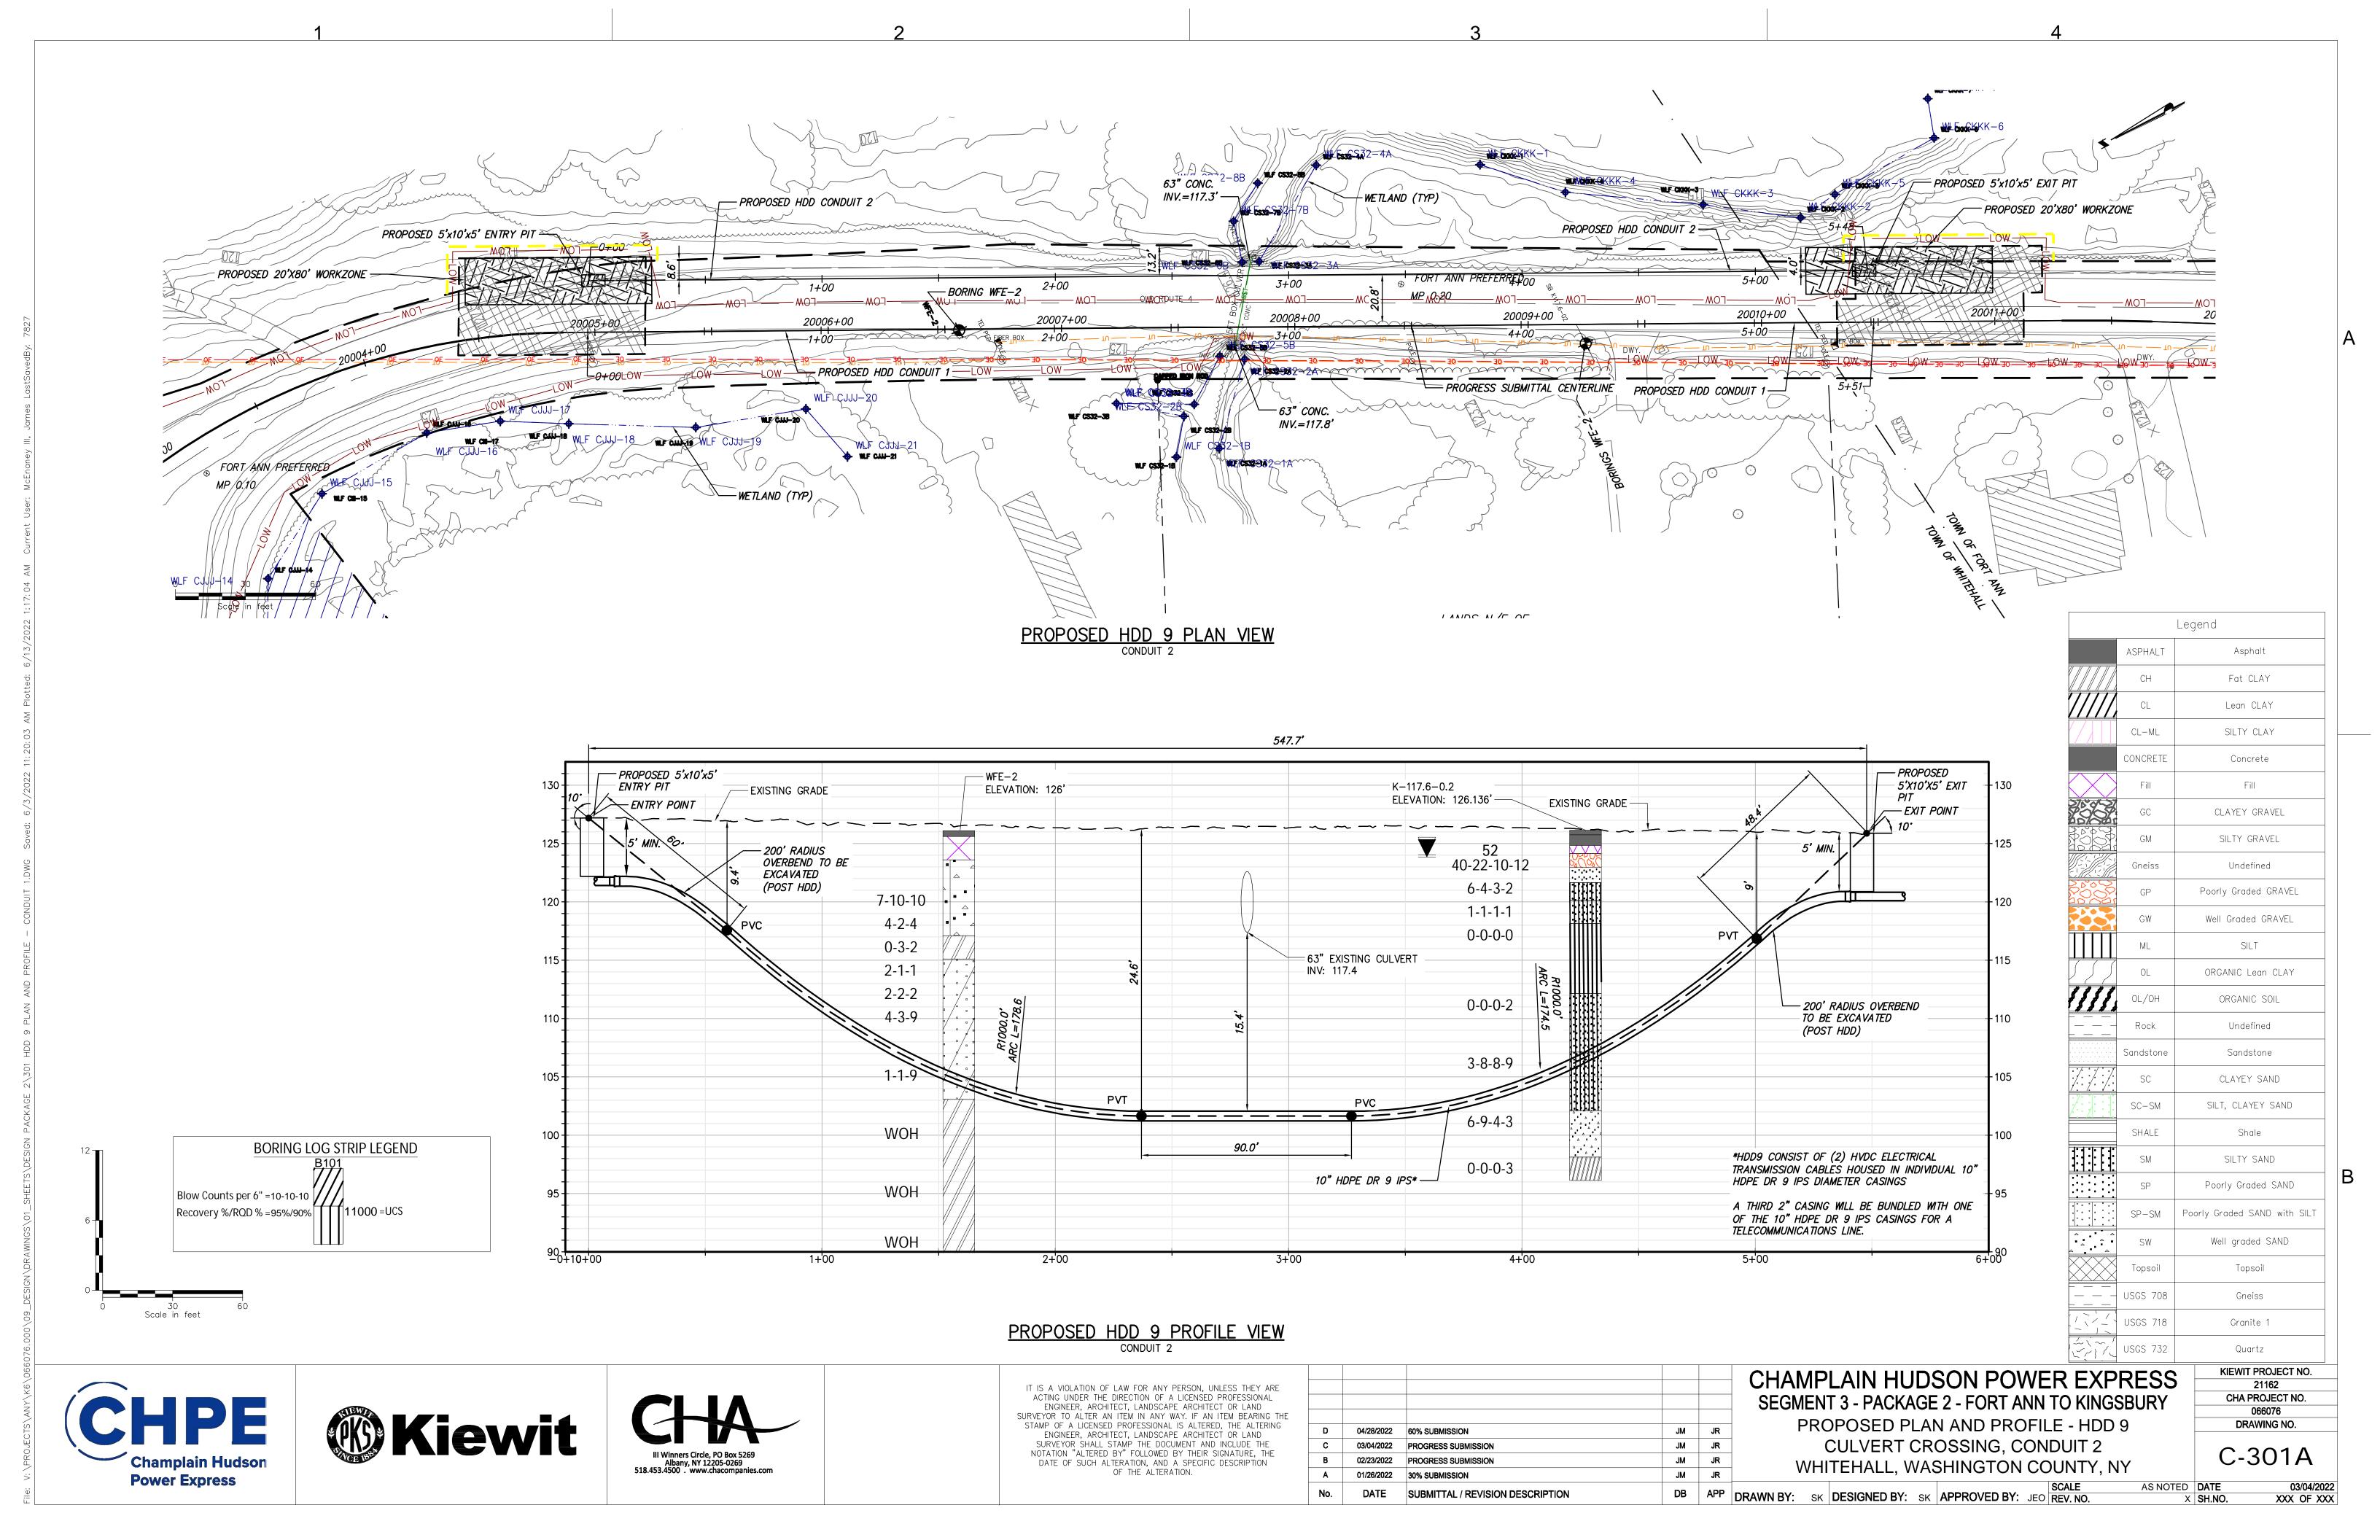

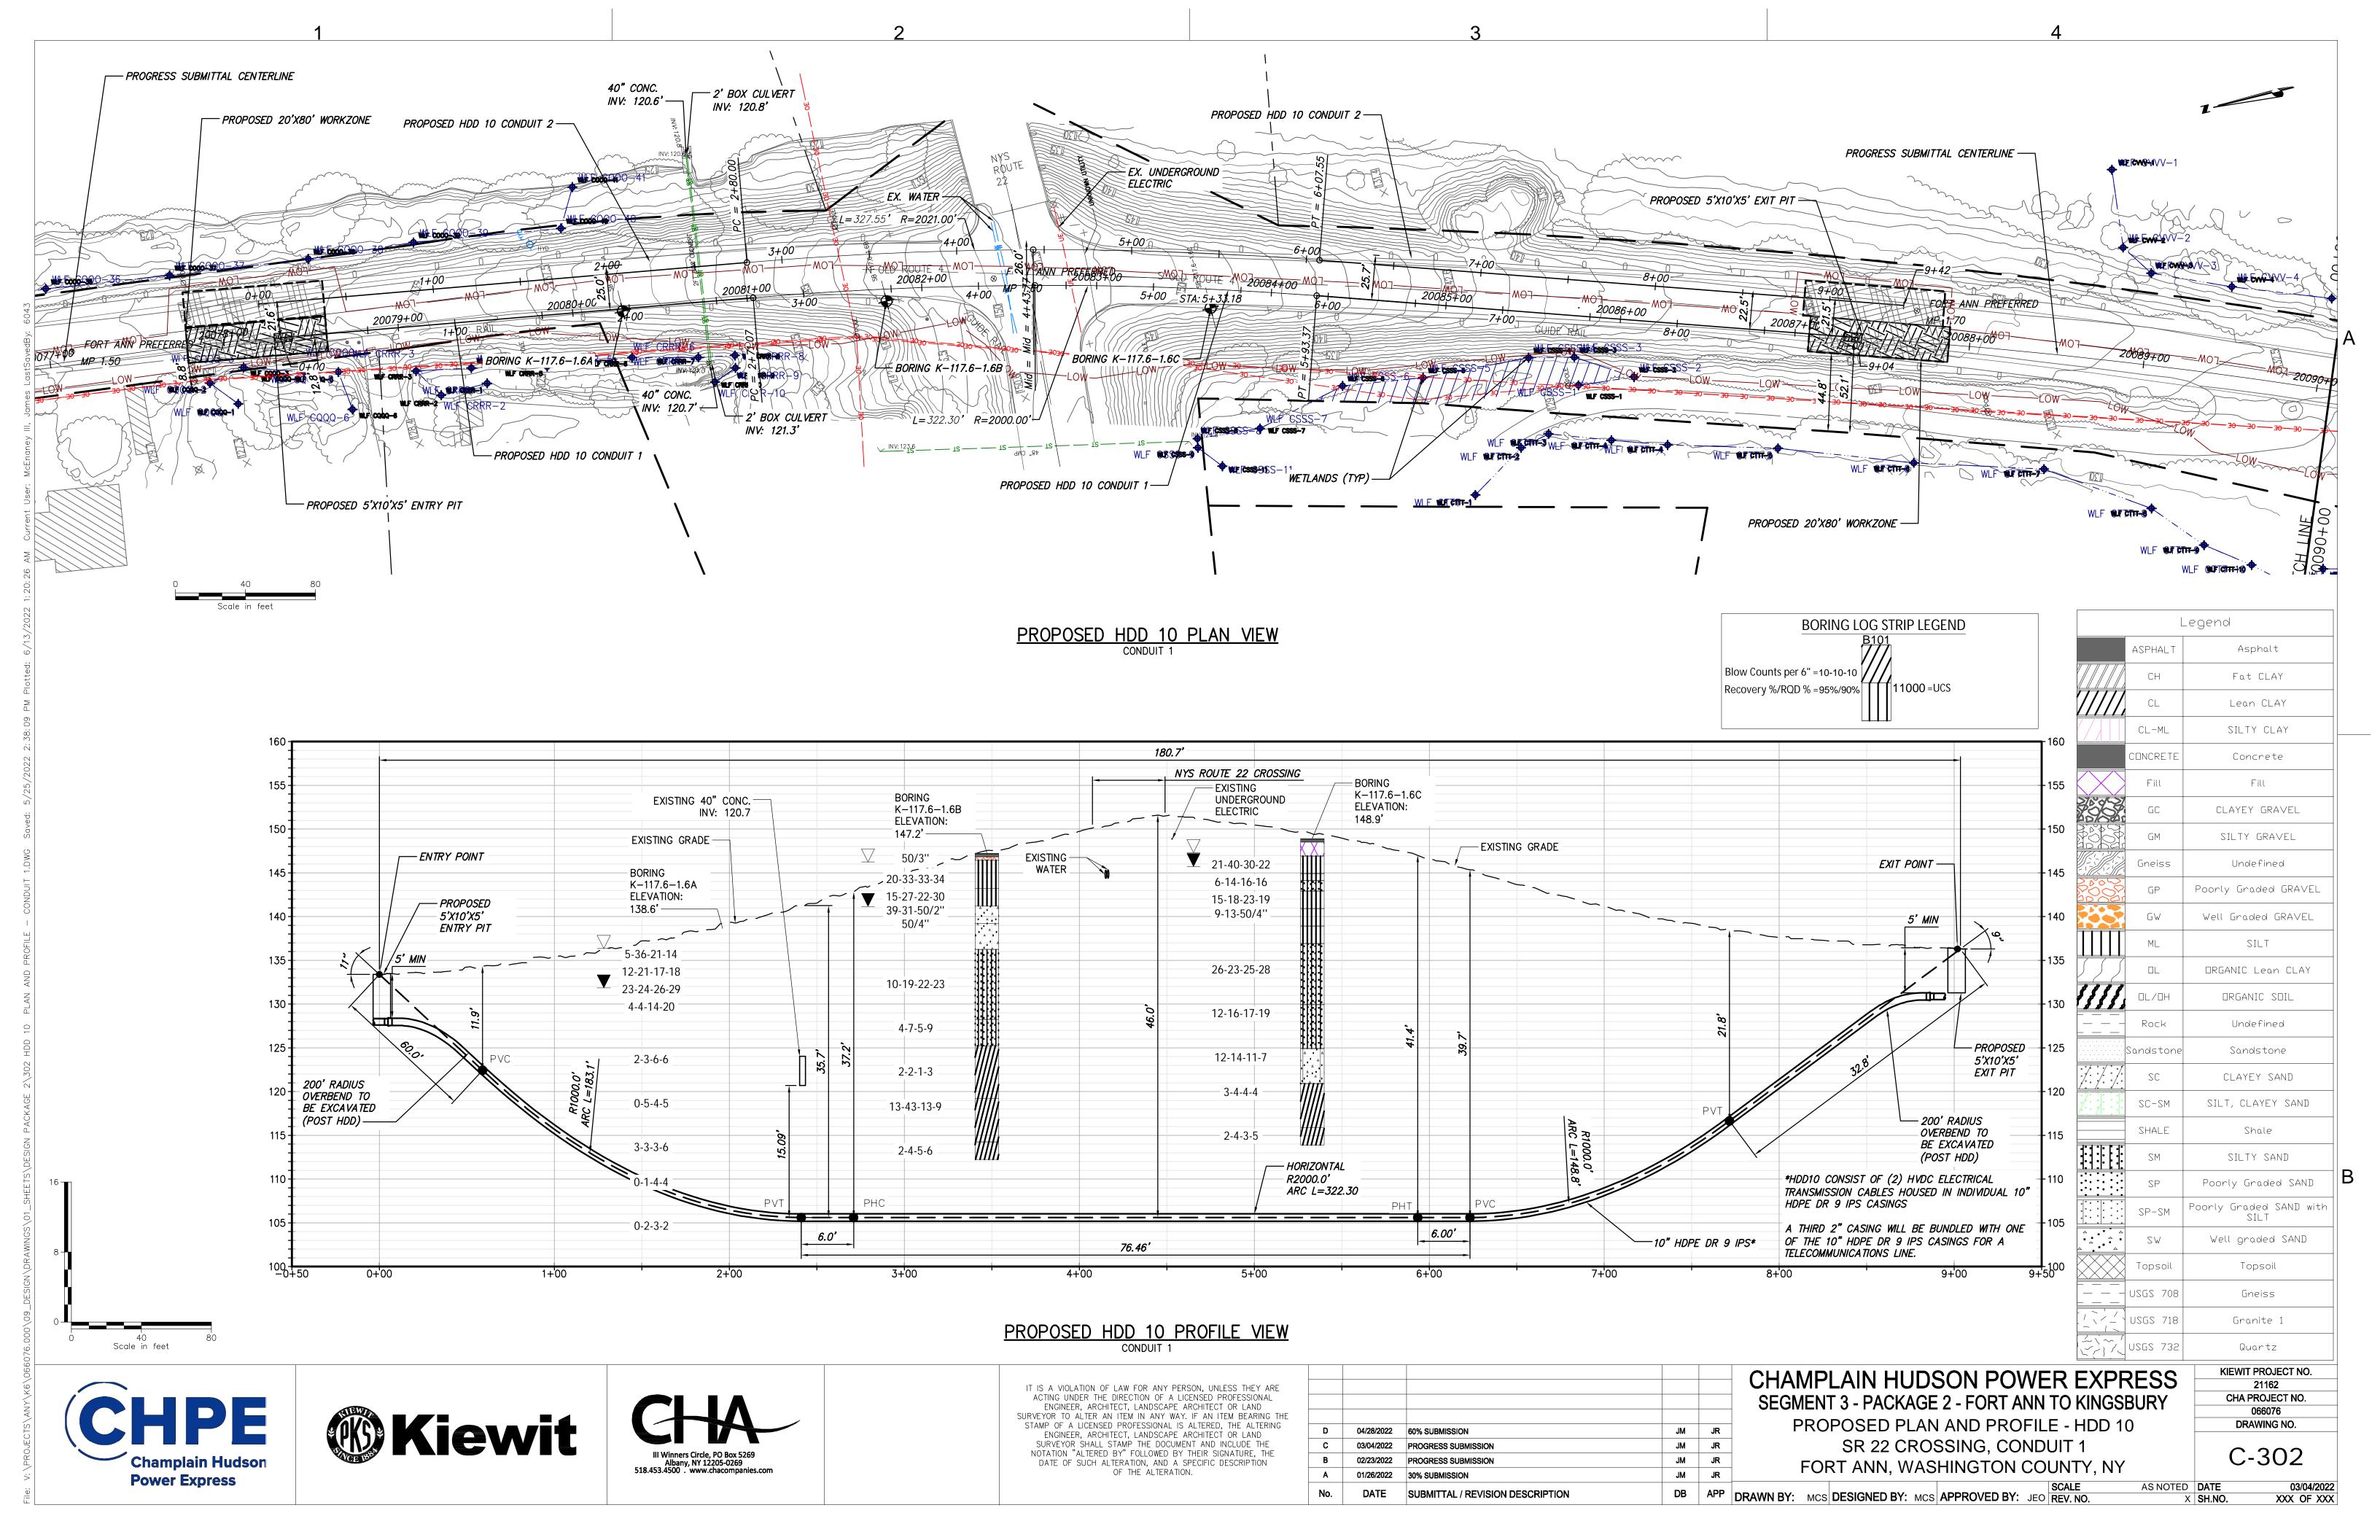

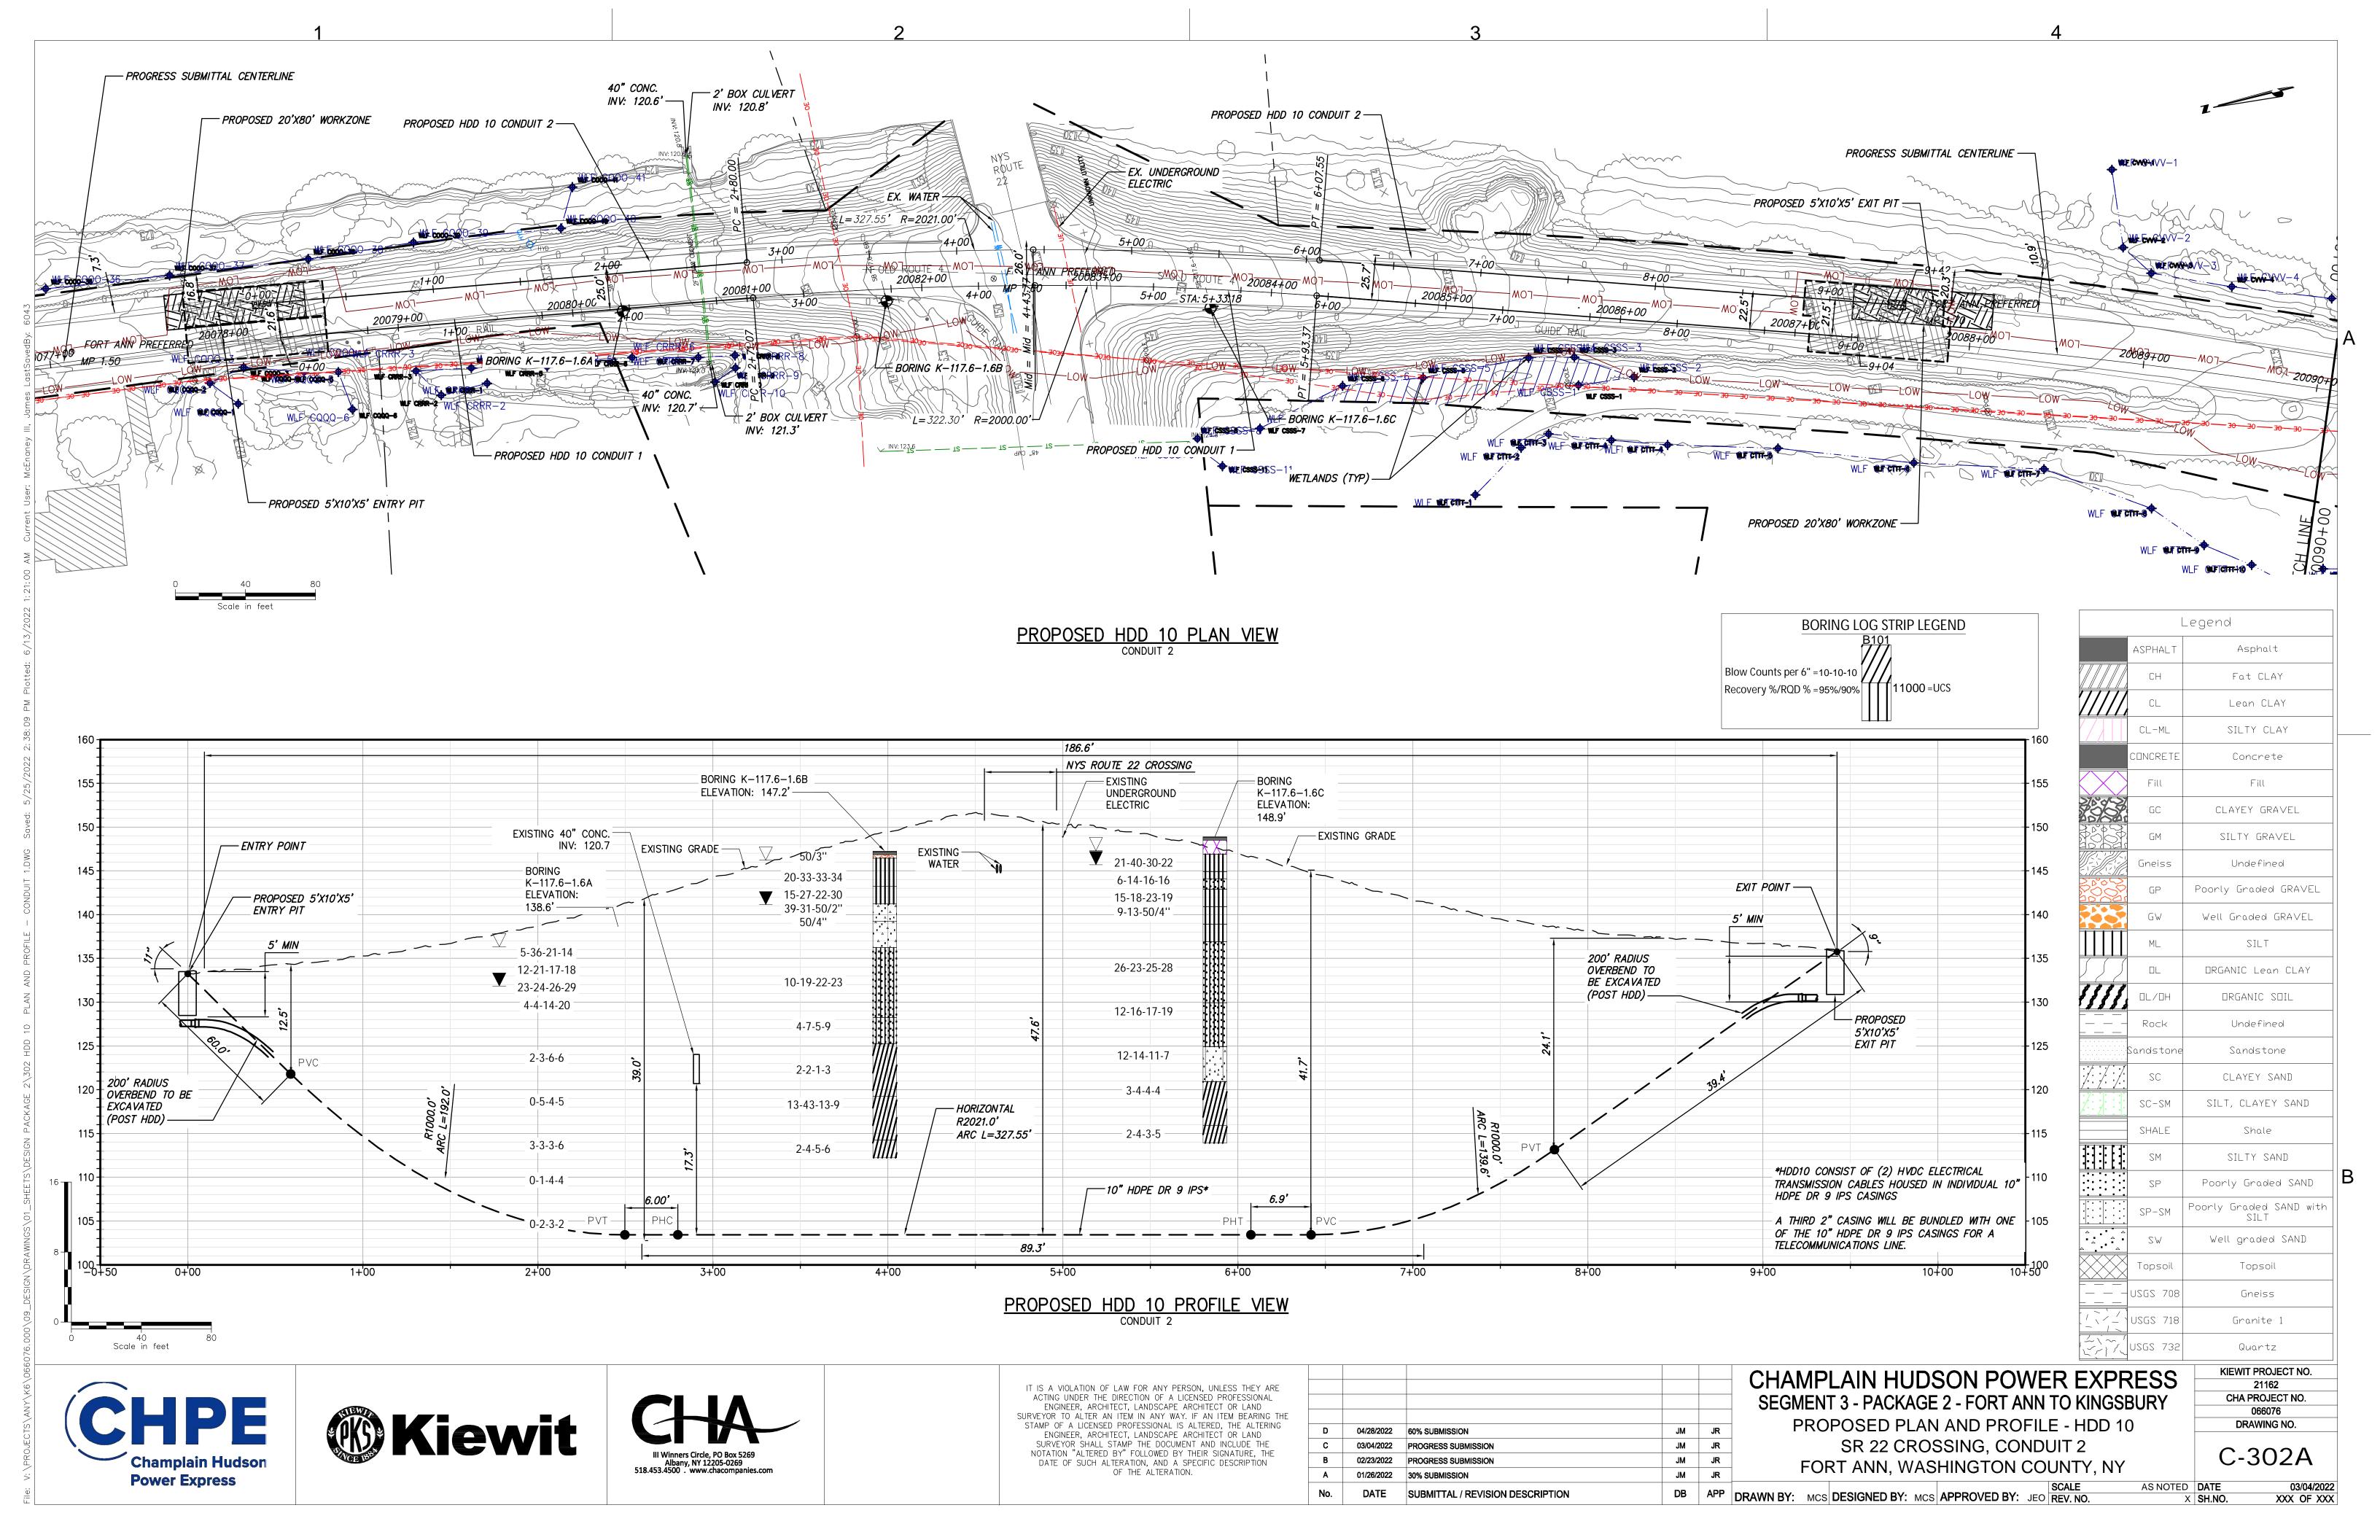


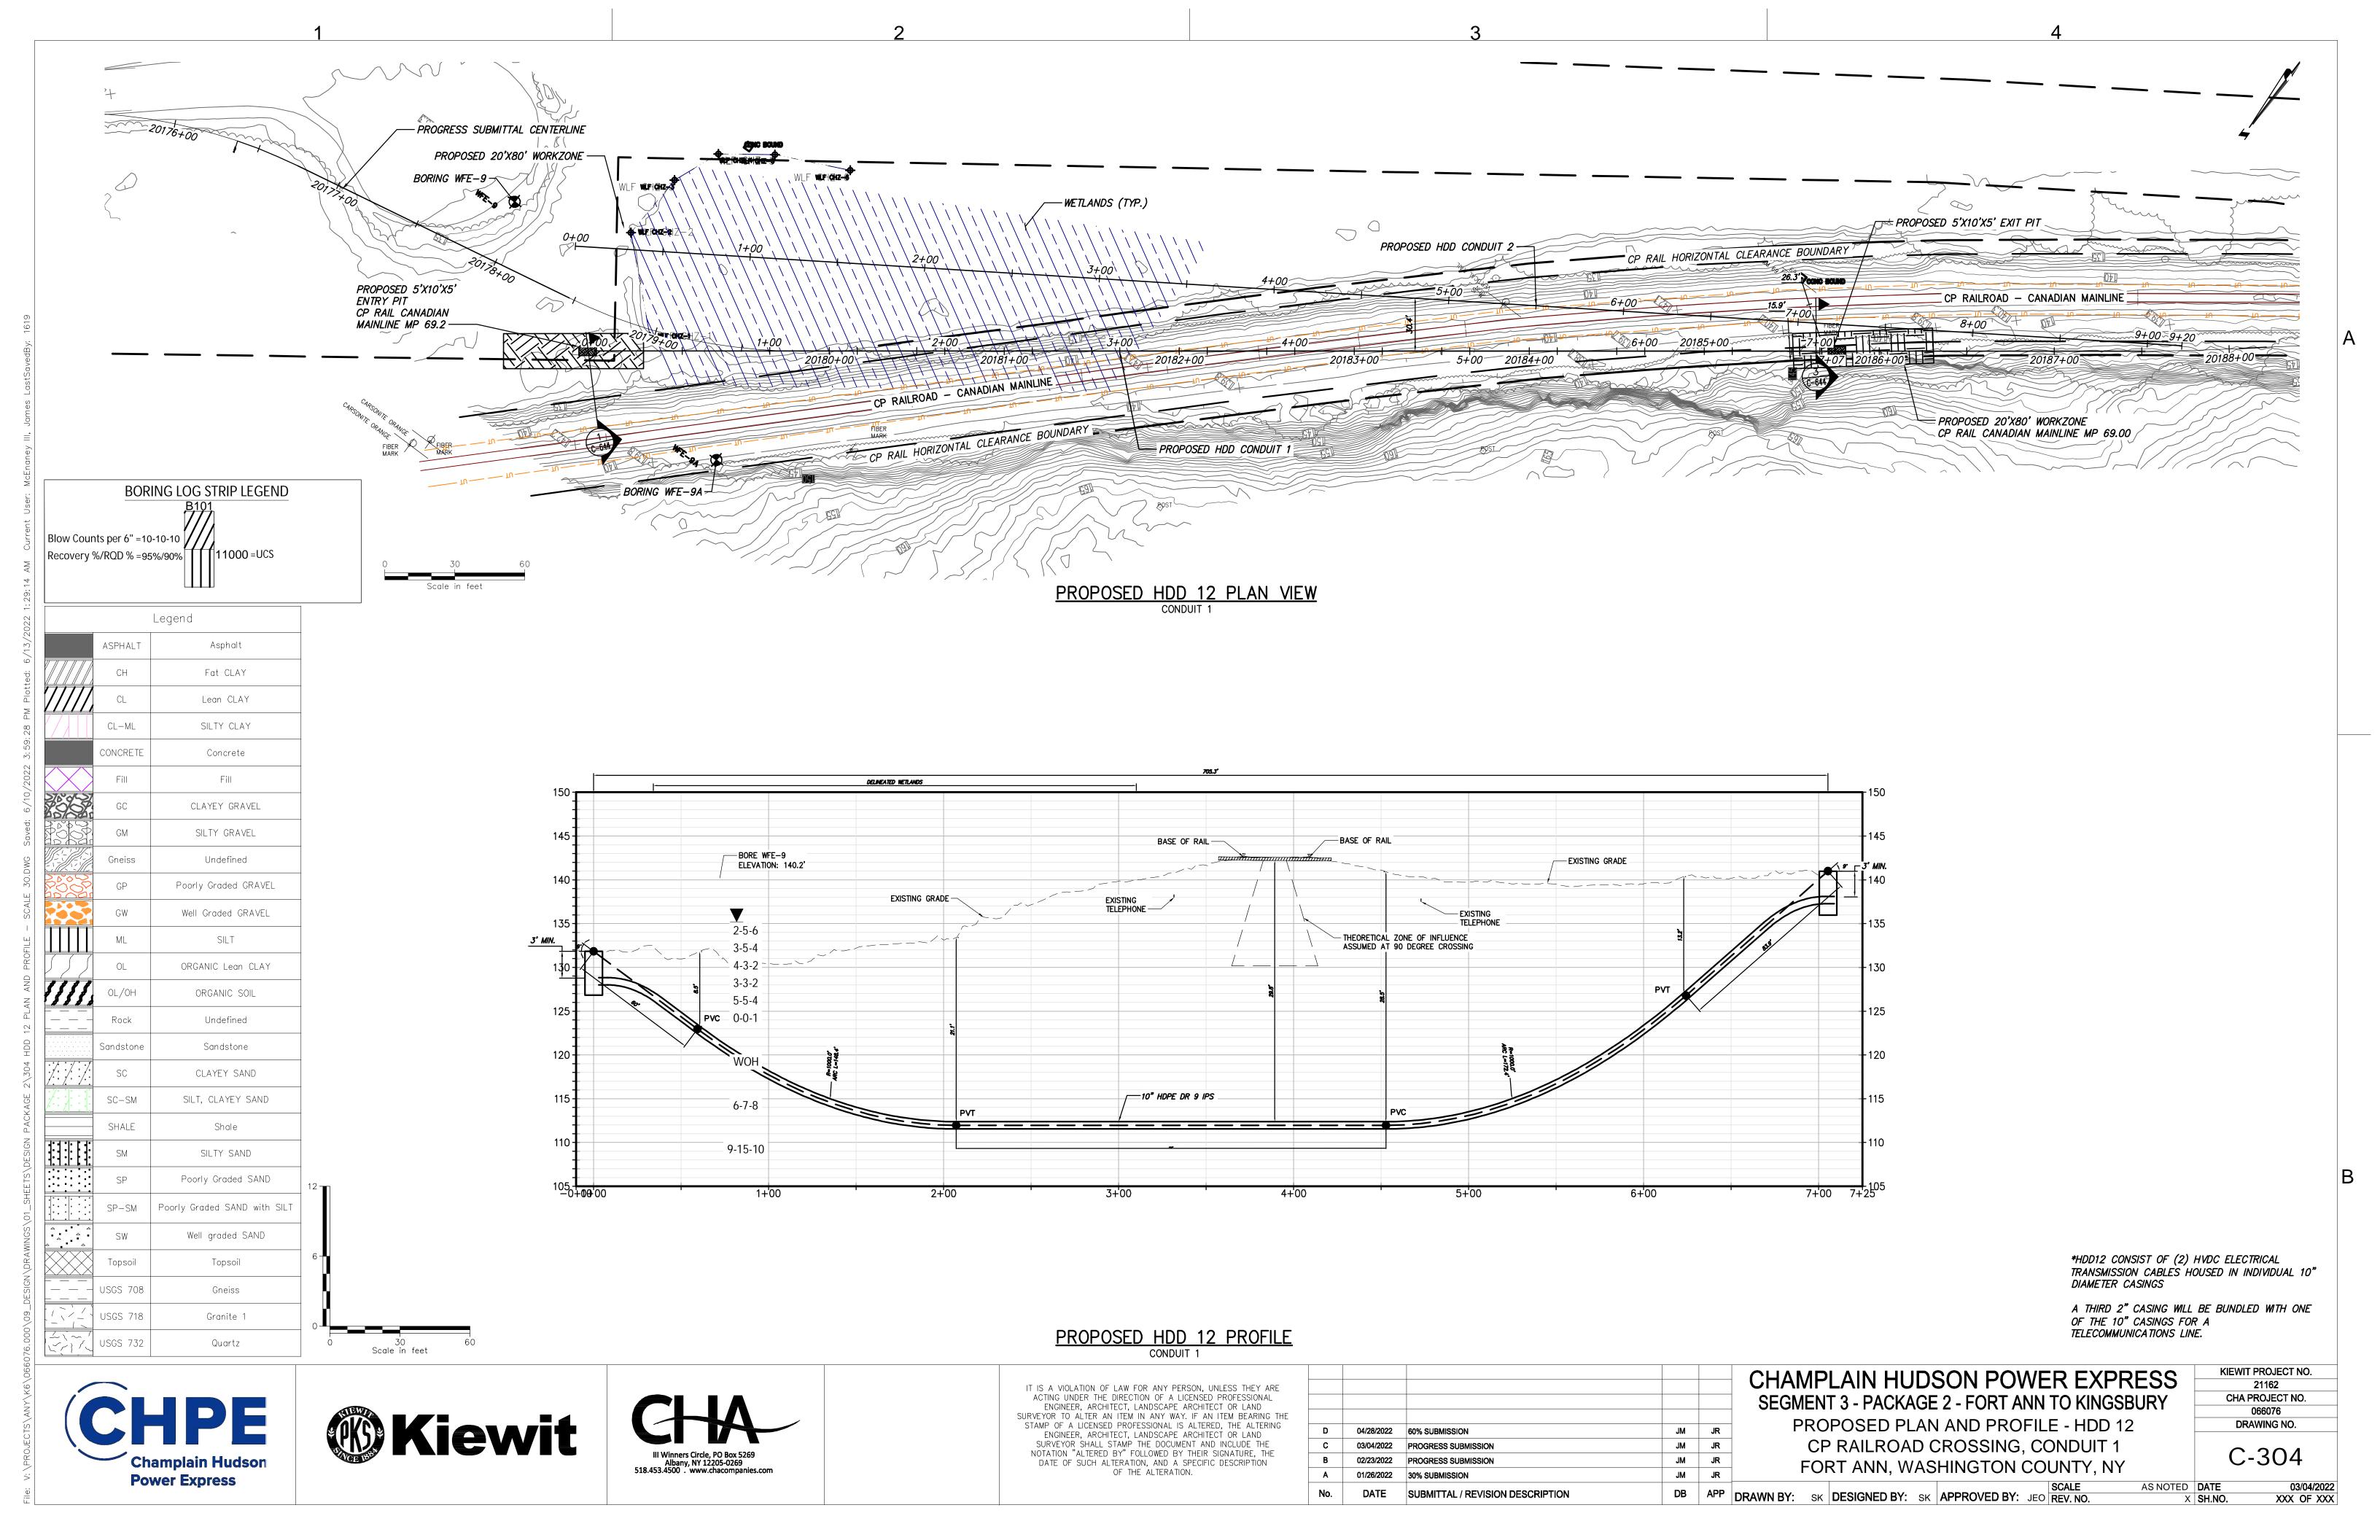


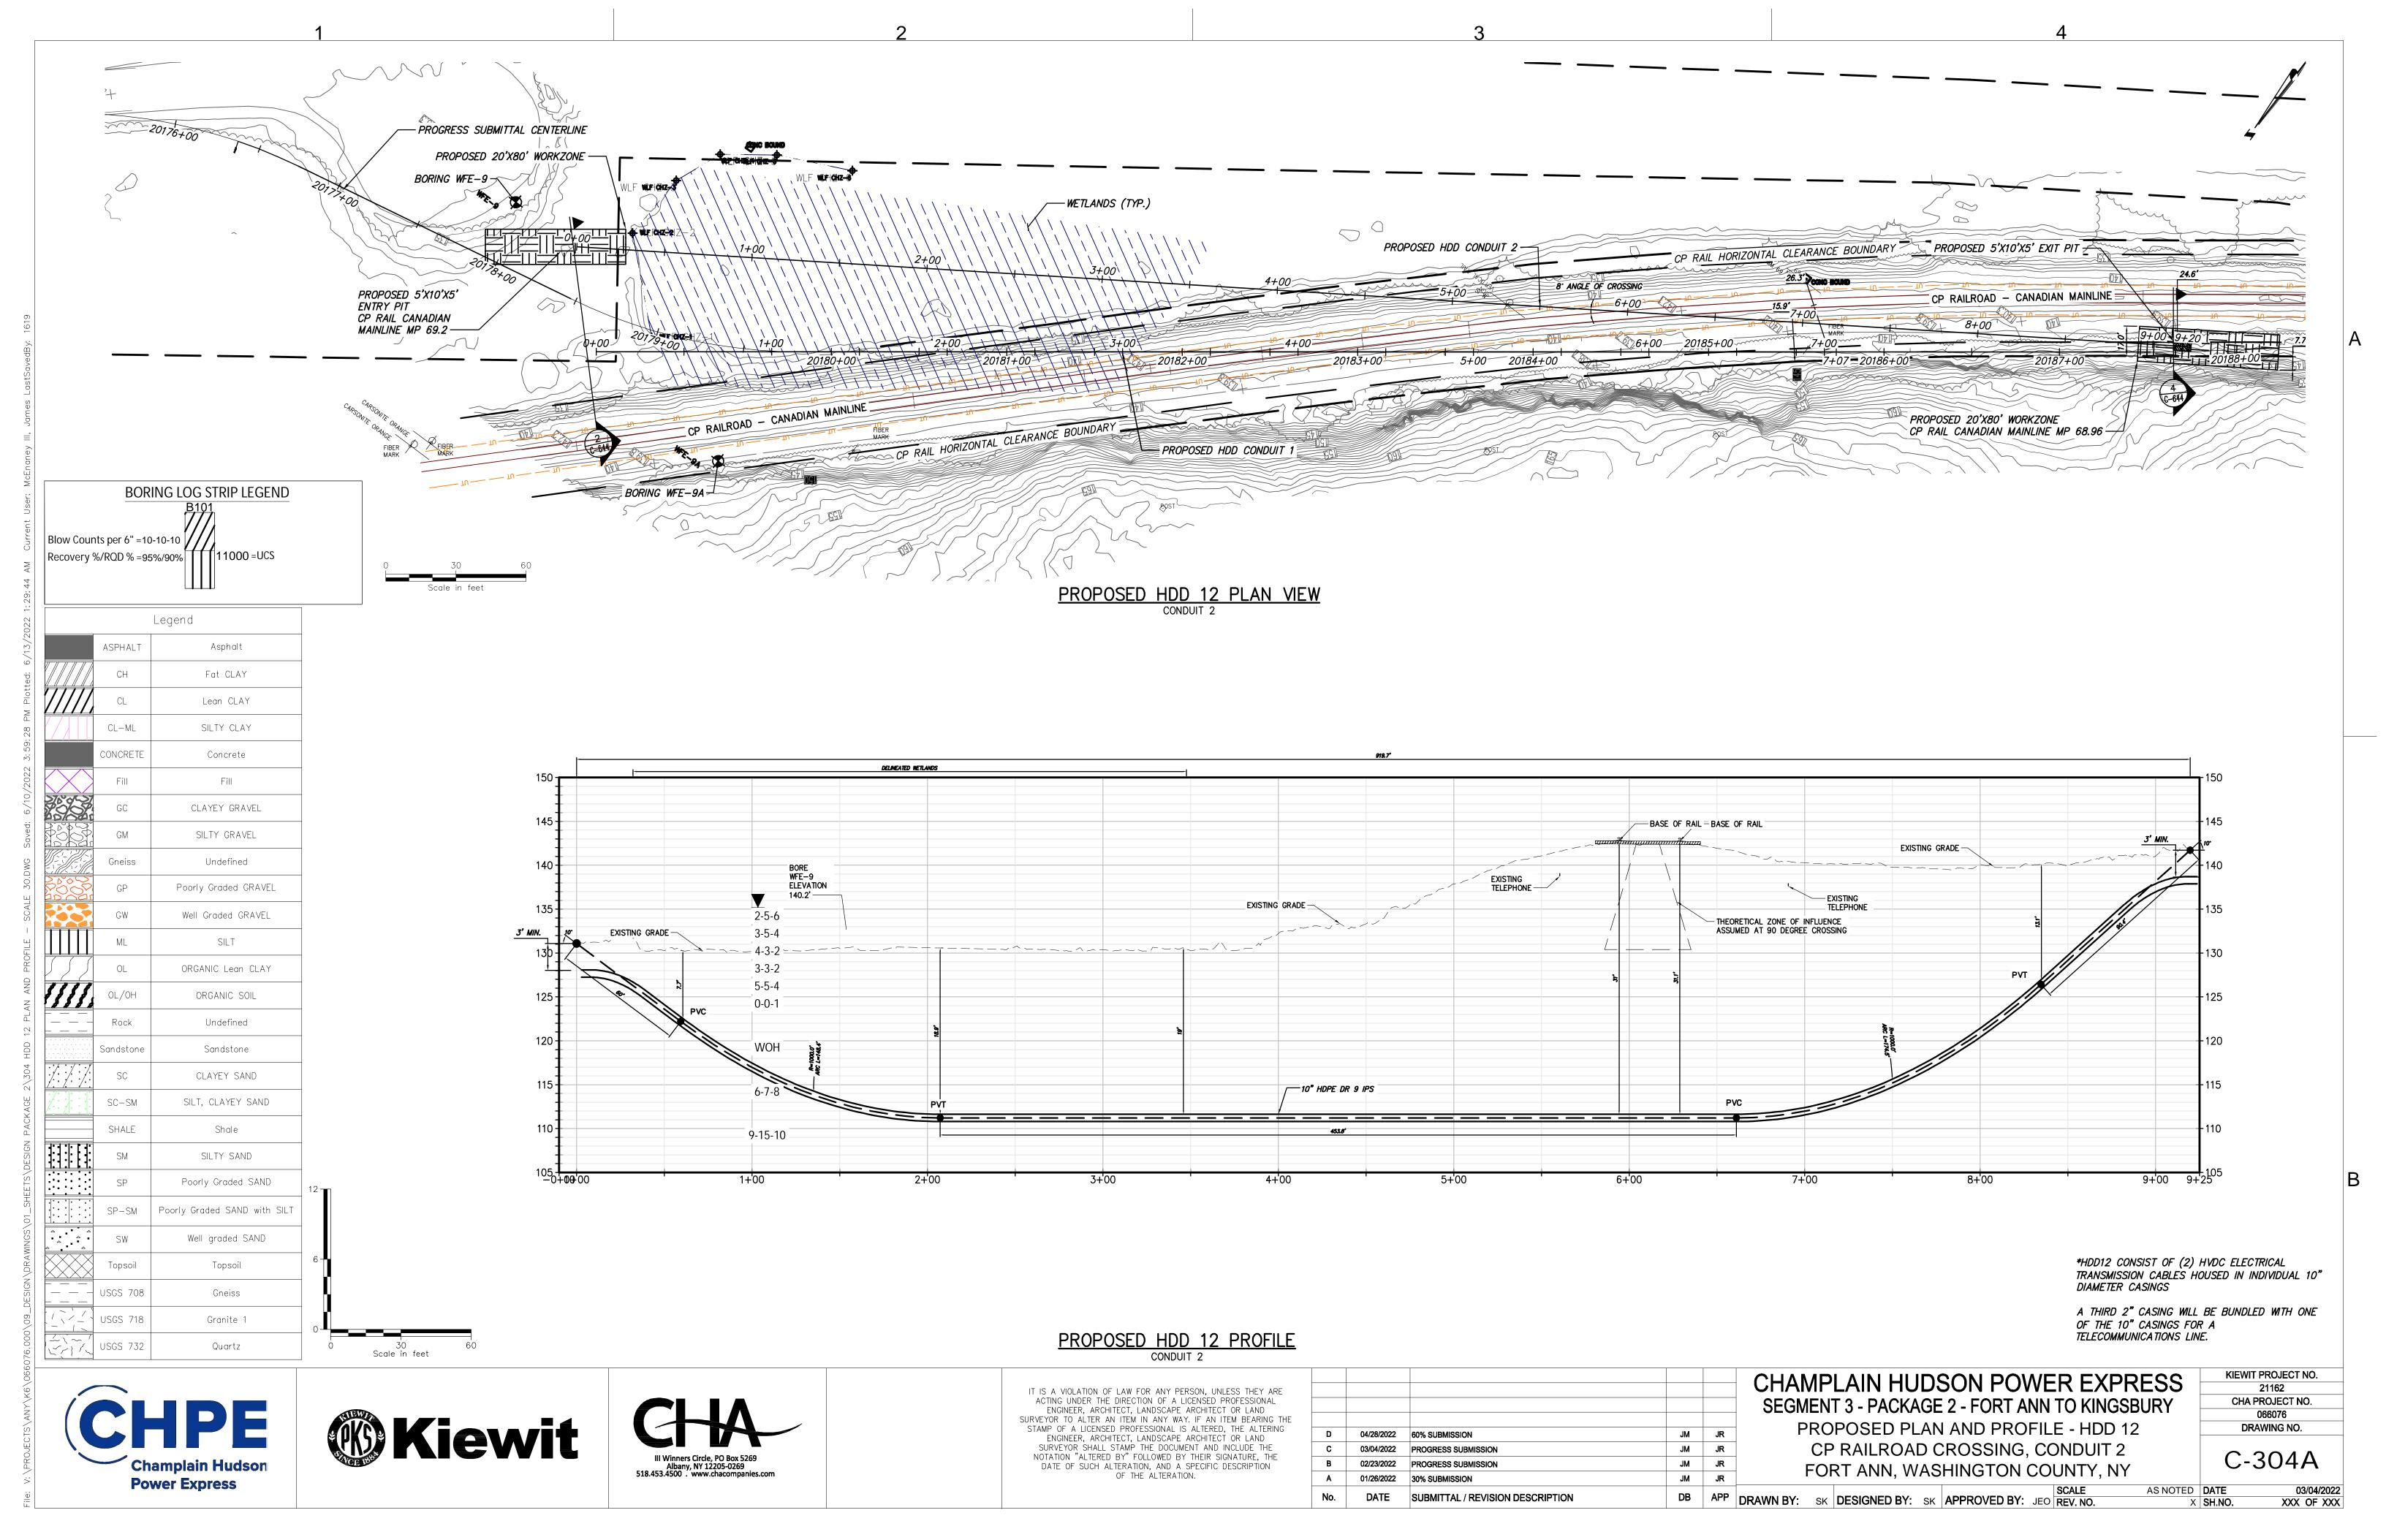


1. SLOPE SHALL BE BASED ON OSHA SHEETING AND SHORING REQUIREMENTS TO BE DETERMINED BY THE COMPETENT PERSON IN THE FIELD.

1 OPEN TRENCH (30" WIDTH, 16" CENTER TO CENTER SPACING)
NOT TO SCALE

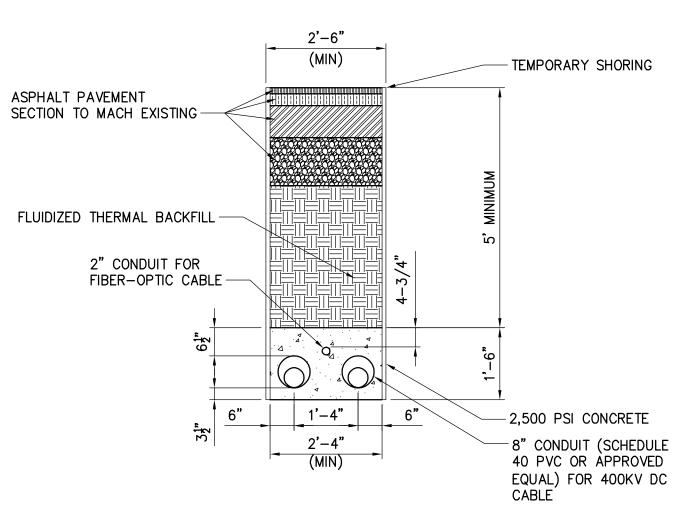


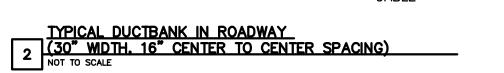

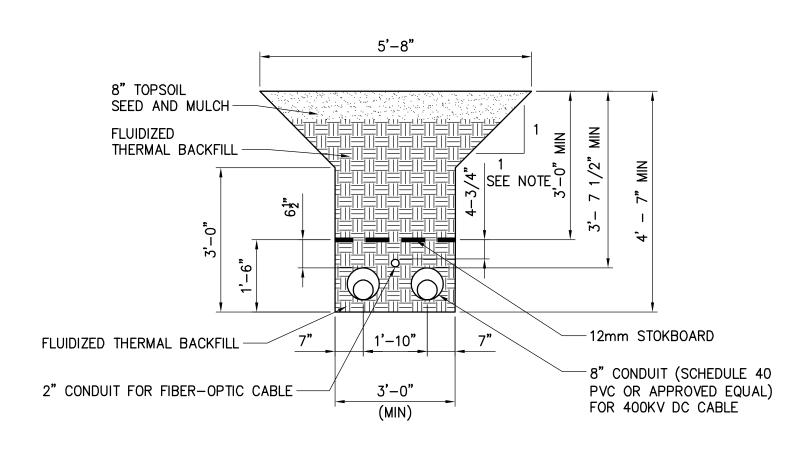


1. SLOPE SHALL BE BASED ON OSHA SHEETING AND SHORING REQUIREMENTS TO BE DETERMINED BY THE COMPETENT PERSON IN THE FIELD.

OPEN TRENCH (36" WIDTH. 22" CENTER TO CENTER SPACING)
NOT TO SCALE

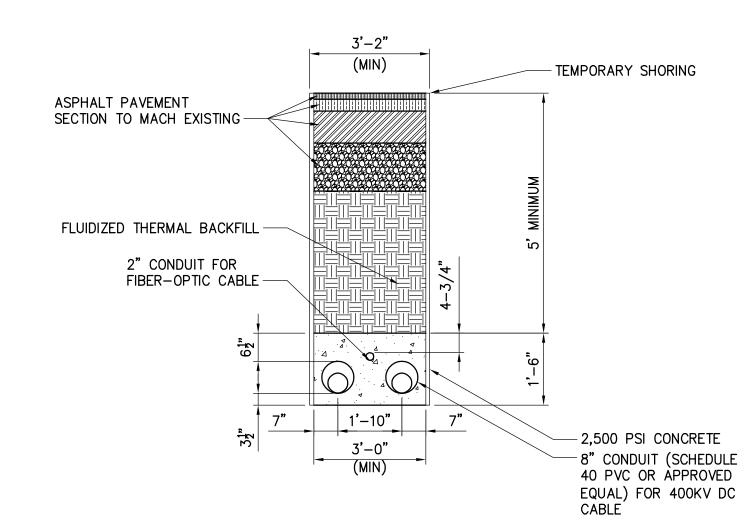


TYPICAL DUCTBANK IN ROADWAY

(36" WDTH. 22" CENTER TO CENTER SPACING)

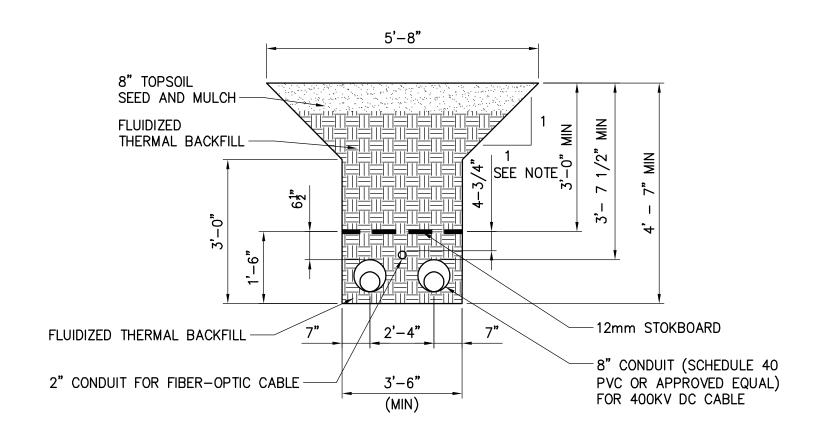

1. SLOPE SHALL BE BASED ON OSHA SHEETING AND SHORING REQUIREMENTS TO BE DETERMINED BY THE COMPETENT PERSON IN THE FIELD.

4 OPEN TRENCH (42" WIDTH. 28" CENTER TO CENTER SPACING)
NOT TO SCALE

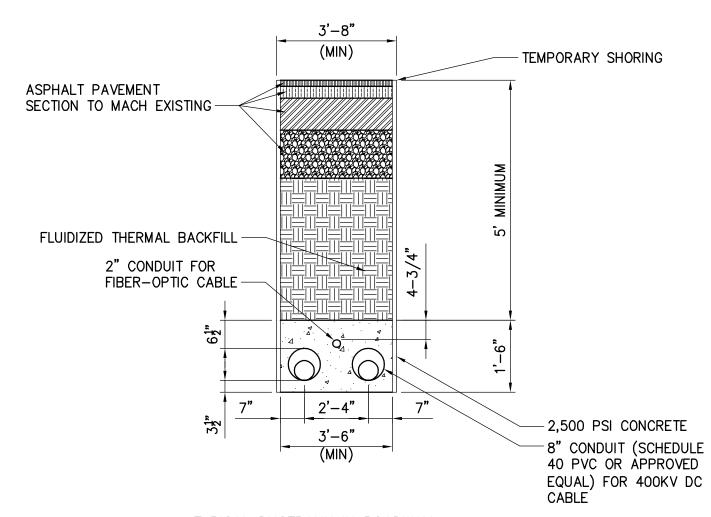

TYPICAL DUCTBANK IN ROADWAY

(42" WIDTH. 28" CENTER TO CENTER SPACING)

Champlain Hudson **Power Express** 





NOTATION "ALTERED BY" FOLLOWED BY THEIR SIGNATURE, THE  DATE OF SUCH ALTERATION, AND A SPECIFIC DESCRIPTION  OF THE ALTERATION.
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					SEGMENT 3 - PACKAGE 2 - FORT ANN TO KIN
D	04/28/2022	60% SUBMISSION	JM	JR	TRENCH CROSS SECTION DETAIL
С	03/04/2022	PROGRESS SUBMISSION	JM	JR	
В	02/23/2022	PROGRESS SUBMISSION	JM	JR	
Α	01/26/2022	30% SUBMISSION	JM	JR	
No.	DATE	SUBMITTAL / REVISION DESCRIPTION	DB	APP	DRAWN BY: XXX DESIGNED BY: XXX APPROVED BY: XXX REV. NO.

CHAMPLAIN HUDSON POWER EXPRESS
SEGMENT 3 - PACKAGE 2 - FORT ANN TO KINGSBURY
TRENCH CROSS SECTION DETAILS

KIEWIT PROJECT NO. 21162 CHA PROJECT NO. 066076 DRAWING NO.


C-621

AS NOTED DATE 03/04/2022


XXX OF XXX

X SH.NO.



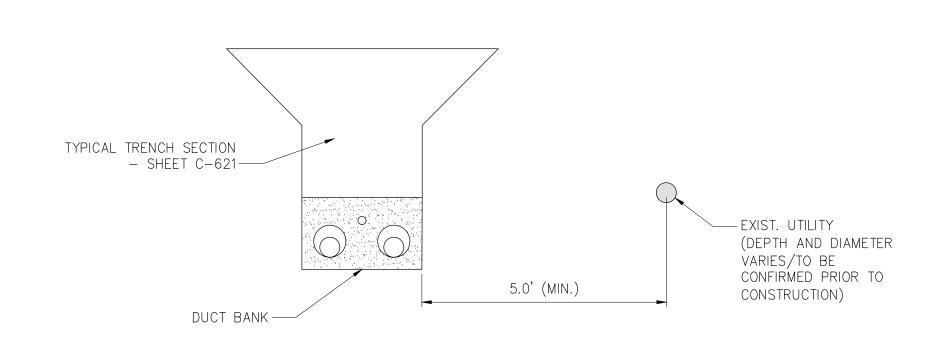


TYPICAL TRENCH SECTION
- SHEET C-621-EXIST. UTILITY 2.0' (MIN.) (DEPTH AND DIAMETER VARIES/TO BE CONFIRMED PRIOR TO CONSTRUCTION) DUCT BANK-

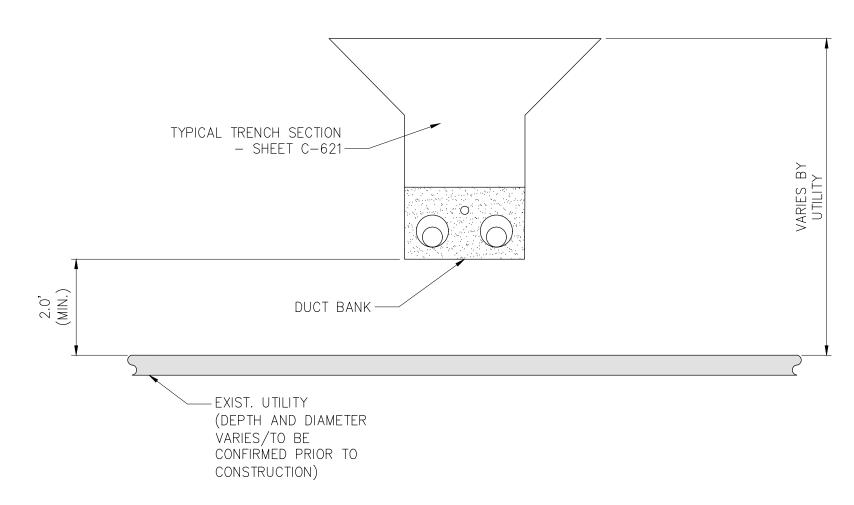

1 OPEN TRENCH - HORIZONTAL SEPARATION
NOT TO SCALE

3 OPEN TRENCH - VERTICAL SEPARATION (UNDER)
NOT TO SCALE

5 OPEN TRENCH - VERTICAL SEPARATION (OVER)
NOT TO SCALE

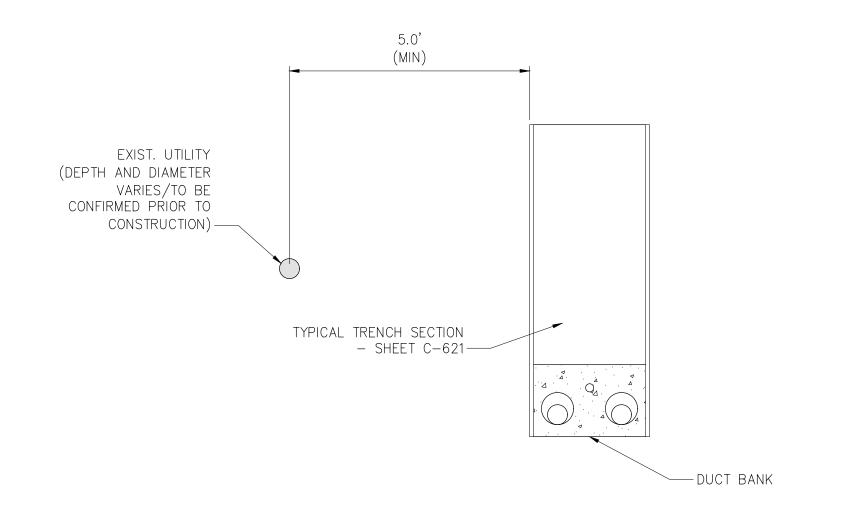

EXIST. UTILITY (DEPTH AND DIAMETER VARIES/TO BE CONFIRMED PRIOR TO CONSTRUCTION) — TYPICAL TRENCH SECTION
- SHEET C-621TYPICAL TRENCH SECTION
- SHEET C-621-- DUCT BANK - EXIST. UTILITY (DEPTH AND DIAMETER VARIES/TO BE CONFIRMED PRIOR TO CONSTRUCTION)

2 TYPICAL DUCTBANK IN ROADWAY - HORIZONTAL SEPARATION
NOT TO SCALE

4 TYPICAL DUCTBANK IN ROADWAY - VERTICAL SEPARATION (UNDER)
NOT TO SCALE

6 TYPICAL DUCTBANK IN ROADWAY - VERTICAL SEPARATION (OVER)







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ENGINEER, ARCHITECT, LANDSCAPE ARCHITECT OR LAND
SURVEYOR TO ALTER AN ITEM IN ANY WAY. IF AN ITEM BEARING THE
STAMP OF A LICENSED PROFESSIONAL IS ALTERED, THE ALTERING
ENGINEER, ARCHITECT, LANDSCAPE ARCHITECT OR LAND
SURVEYOR SHALL STAMP THE DOCUMENT AND INCLUDE THE
NOTATION "ALTERED BY" FOLLOWED BY THEIR SIGNATURE, THE
DATE OF SUCH ALTERATION, AND A SPECIFIC DESCRIPTION
OF THE ALTERATION.

							<b>&gt;</b>
G	06/20/2022	PROGRESS SUBMISSION	JM	JR	_	LAIN HUD	
F	05/06/2022	PROGRESS SUBMISSION	JM	JR	SEGMEN <sup>*</sup>	T 3 - PACKAGE	: 2 - FORT AN
E	03/17/2022	PROGRESS SUBMISSION	JM	JR		UTUU	TV TVDIC AL
D	02/04/2022	PROGRESS SUBMISSION	JM	JR		UTILI	TY TYPICAL
С	01/28/2022	PROGRESS SUBMISSION	JM	JR		SEPARA	ATION DETA
В	12/21/2021	PROGRESS SUBMISSION	JM	JR			
Α	11/02/2021	30% SUBMISSION	JM	JR			
No.	DATE	SUBMITTAL / REVISION DESCRIPTION	DB	APP	DRAWN BY: wso	DESIGNED BY: wso	APPROVED BY:

CHAMPLAIN HUDSON POWER EXPRESS
SEGMENT 3 - PACKAGE 2 - FORT ANN TO KINGSBURY
UTILITY TYPICAL
SEPARATION DETAILS

KIEWIT PROJECT NO.	
21162	
CHA PROJECT NO.	
066076	
DRAWING NO.	
C-901	

XXX OF XXX

AS NOTED DATE

# CHAMPLAIN HUDSON POWER EXPRESS

SEGMENT 3 - PACKAGE 2 - FORT ANN TO KINGSBURY WASHINGTON COUNTY, NEW YORK CI OWNER SUBMISSION (July 14, 2022)


## NOTES TO CO-LOCATED INFRASTRUCTURE REVIEWERS:

Please review the attached information regarding the CHPE alignment relating to your infrastructure and provide your concurrence of the Project's cables separation and alignment and any feedback to ben.cole@wsp.com. It is important to TDI that the construction and operation of the CHPE does not interfere with the continued operation of your infrastructure.

Based on current documentation, we do not believe the jurisdiction owns assets within the project limits. However, we presenting the project limits within proximity to the Town to provide an opportunity for review and comment on underground crossing(s) and/or parallel interactions with the Town's maintained assets. Specific details applicable to each crossing are currently being developed and will depend on depth identified in the field of existing co-located infrastructure and other site conditions. However, Utility Typical Separation Details are presented on Drawing No. C-901 for your review and discussion initiation.

The basis of design for this package as it relates to the proposed Horizontal and Vertical underground separations from all Co-Located Infrastructure is 5' (H) and 2' (V). These separation distances are to be maintained as a minimum at all times and any variances (i.e. closer) will be presented to your jurisdiction prior to implementation and called out specifically on the plans.

Note that there may be some gaps in the pages provided, this is intentional as some of the pages do not present assets owned and maintained by your jurisdiction. In addition, please see attached the Champlain Hudson Power Express "Upland Co-Located Utility Summation Matrix" for the location (by Station) of assets that may interact with the proposed project.

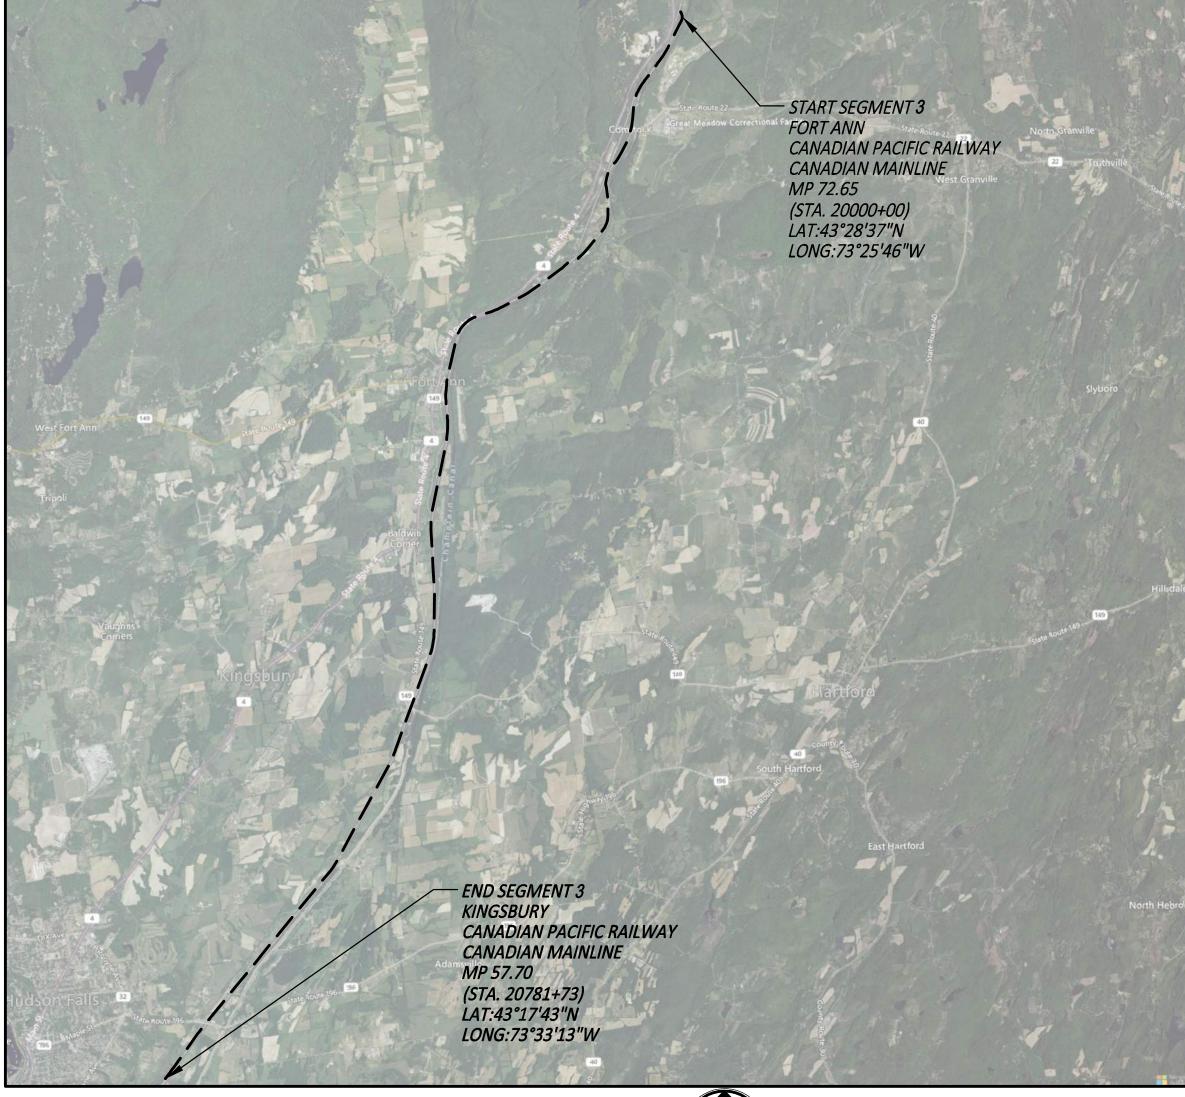

Note: This is a copy of the Plan and Profiles that were provided to the Town of Fort Ann

SITE LOCATION MAP

NOT FOR CONSTRUCTION

**Champlain Hudson Power Express** 





ENGINEER, ARCHITECT, LANDSCAPE ARCHITECT OR LAND SURVEYOR TO ALTER AN ITEM IN ANY WAY. IF AN ITEM BEARING THE STAMP OF A LICENSED PROFESSIONAL IS ALTERED, THE ALTERING ENGINEER, ARCHITECT, LANDSCAPE ARCHITECT OR LAND NOTATION "ALTERED BY" FOLLOWED BY THEIR SIGNATURE, THE DATE OF SUCH ALTERATION, AND A SPECIFIC DESCRIPTION OF THE ALTERATION.

					]
D	04/28/2022	60% SUBMISSION	JM	JR	
С	03/04/2022	PROGRESS SUBMISSION	JM	JR	
В	02/23/2022	PROGRESS SUBMISSION	JM	JR	]
Α	01/26/2022	30% SUBMISSION	JM	JR	L
No.	DATE	SUBMITTAL / REVISION DESCRIPTION	DB	APP	D

CHAMPLAIN HUDSON POWER EXPRESS **SEGMENT 3 - PACKAGE 2 - FORT ANN TO KINGSBURY COVER SHEET** 

KIEWIT PROJECT NO. CHA PROJECT NO. DRAWING NO.

G-000

AS NOTED DATE XXX OF XXX

DRAWN BY: JTM DESIGNED BY: JTM APPROVED BY: JPR REV. NO.





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С	03/04/2022	PROGRESS SUBMISSION	JM	JR
В	02/23/2022	PROGRESS SUBMISSION	JM	JR
Α	01/26/2022	30% SUBMISSION	JM	JR
No.	DATE	SUBMITTAL / REVISION DESCRIPTION	DB	APP

CHAMPLAIN HUDSON POWER EXPRESS SEGMENT 3 - PACKAGE 2 - FORT ANN TO KINGSBURY SHEET INDEX KIEWIT PROJECT NO. 21162 CHA PROJECT NO. 066076 DRAWING NO.

G-001

DRAWN BY: JTM DESIGNED BY: JTM APPROVED BY: JPR SCALE AS NOTED DATE 03/04/2022

REV. NO. X SH.NO. XXX OF XXX

ETS\DESIGN PACKAGE 2\066076\_P2 - G-001.DWG Saved: 5/25/2022 2:55:3

В

- 2. THE GENERAL CONTRACTOR SHALL STRICTLY ADHERE TO THE STORM WATER POLLUTION PREVENTION PLAN (SWPPP) DURING CONSTRUCTION OPERATIONS.
- 3. NO LAND CLEARING OR GRADING SHALL BEGIN UNTIL ALL PERIMETER EROSION AND SEDIMENT CONTROL MEASURES HAVE BEEN INSTALLED. (WETLAND PROTECTION FENCE, SILT FENCE AND STABILIZED CONSTRUCTION ENTRANCE)
- 4. SITE DISTURBANCE SHALL NOT EXCEED FIVE (5) ACRES OF SOIL AT ANY ONE TIME WITHOUT PRIOR WRITTEN AUTHORIZATION FROM NYSDEC.
- 5. ALL EXPOSED AREAS SHALL BE SEEDED AND MULCHED AS SPECIFIED WITHIN 7 DAYS OF FINAL GRADING.
- 6. INACTIVE PORTIONS OF THE SITE ARE TO BE SEEDED AND MULCHED AS SPECIFIED WITHIN 7 DAYS.
- 7. SEDIMENT AND EROSION CONTROL MEASURES SHALL BE INSPECTED AT LEAST ONCE EVERY SEVEN (7) DAYS OR MORE FREQUENTLY IF REQUIRED. ALL MAINTENANCE REQUIRED BY INSPECTION SHALL COMMENCE WITHIN 24 HOURS AND BE COMPLETED WITHIN 48 HOURS OF REPORT.
- 8. THIS PLAN SHALL NOT BE CONSIDERED ALL INCLUSIVE AS THE GENERAL CONTRACTOR SHALL TAKE ALL NECESSARY PRECAUTIONS TO PREVENT SOIL SEDIMENT FROM LEAVING THE SITE.
- 9. GENERAL CONTRACTOR SHALL COMPLY WITH ALL STATE AND LOCAL ORDINANCES THAT APPLY.
- 10. ADDITIONAL EROSION AND SEDIMENT CONTROL MEASURES WILL BE INSTALLED IF DEEMED NECESSARY FOLLOWING SITE INSPECTION.
- 11. GENERAL CONTRACTOR SHALL BE RESPONSIBLE TO TAKE WHATEVER MEANS NECESSARY TO ESTABLISH PERMANENT SOIL STABILIZATION.
- 12. AT THE END OF EACH WORK DAY DISTURBED SOILS ARE TO BE REGRADED TO DRAIN INTO THE TEMPORARY DIVERSION SWALES AND DISCHARGES FROM DEWATERING ACTIVITIES ARE TO BE DIRECTED INTO CATCH BASINS OR SWALES.

#### **GENERAL NOTES:**

- 1. THE PLANS SHOW SUBSURFACE STRUCTURES, ABOVE GROUND STRUCTURES AND/OR UTILITIES FROM FIELD LOCATION AND RECORD MAPPING. EXACT LOCATION OF WHICH MAY VARY FROM THE LOCATIONS INDICATED. IN PARTICULAR, THE CONTRACTOR IS WARNED THAT THE EXACT OR EVEN APPROXIMATE LOCATION OF SUCH PIPELINES, SUBSURFACE STRUCTURES AND/OR UTILITIES IN THE AREA MAY BE DIFFERENT FROM THAT SHOWN OR MAY NOT BE SHOWN, AND IT SHALL BE HIS RESPONSIBILITY TO PROCEED WITH GREAT CARE IN EXECUTING ANY WORK. 48 HOURS BEFORE YOU DIG, DRILL, OR BLAST, CALL U.F.P.O. 1-(800)-962-7962 TOLL FREE.
- 2. THE ENGINEER SHALL BE NOTIFIED IN WRITING OF ANY CONDITIONS THAT VARY FROM THOSE SHOWN ON THE PLANS. THE CONTRACTOR'S WORK SHALL NOT VARY FROM THE PLANS WITHOUT THE EXPRESSED APPROVAL OF THE ENGINEER.
- 3. THE CONTRACTOR SHALL RESTORE LAWNS, DRIVEWAYS, CULVERTS, SIGNS AND OTHER PUBLIC OR PRIVATE PROPERTY DAMAGED OR REMOVED TO AT LEAST AS GOOD A CONDITION AS BEFORE BEING DISTURBED AS DETERMINED BY THE ENGINEER.
- 4. THE CONTRACTOR SHALL BE RESPONSIBLE FOR OBTAINING AND INCURRING THE COST OF ALL REQUIRED PERMITS, INSPECTIONS, CERTIFICATES, ETC. AND SHALL COMPLY WITH ALL REQUIRED PERMITS.
- 5. ALL WORK SHALL BE DONE IN STRICT COMPLIANCE WITH ALL APPLICABLE NATIONAL, STATE, AND LOCAL CODES, STANDARDS, ORDINANCES, RULES, AND REGULATIONS.
- 6. ALL PROPOSED UTILITIES AND APPURTENANCES TO BE CONSTRUCTED IN COMPLIANCE WITH THE LOCAL MUNICIPALITIES' CODES AND REGULATIONS GOVERNING THE INSTALLATION OF SUCH UTILITIES.
- 7. THE ENGINEER RESERVES THE RIGHT TO EXAMINE ANY WORK DONE ON THIS PROJECT AT ANY TIME TO DETERMINE THE CONFORMANCE WITH THE REQUIREMENTS OF THE CONTRACT DOCUMENTS OF THIS PROJECT.
- 8. THE CONTRACTOR SHALL PROTECT EXISTING PROPERTY LINE MONUMENTATION. ANY MONUMENTATION DISTURBED OR DESTROYED, AS JUDGED BY THE ENGINEER OR OWNER, SHALL BE REPLACED AT THE CONTRACTOR'S EXPENSE UNDER THE SUPERVISION OF A NEW YORK STATE LICENSED LAND SURVEYOR.
- 9. IT IS THE CONTRACTOR'S RESPONSIBILITY TO EXAMINE ALL PLAN SHEETS AND COORDINATE WORK WITH ALL OTHER CONTRACTS FOR THE SITE.
- 10. THE CONTRACTOR SHALL:
  - A. VERIFY ALL CONDITIONS IN THE FIELD PRIOR TO COMMENCEMENT OF
  - WORK AND NOTIFY THE ENGINEER OF ANY DISCREPANCIES. B. EXAMINE THE SITE AND INCLUDE IN HIS WORK THE EFFECT OF ALL EXISTING CONDITIONS ON THE WORK.
  - C. PROVIDE AND INSTALL ALL MATERIALS AND PERFORM ALL WORK IN ACCORDANCE WITH RECOGNIZED GOOD STANDARD PRACTICE.

- 11. ALL TRENCH EXCAVATION AND ANY REQUIRED SHEETING AND SHORING SHALL BE DONE IN ACCORDANCE WITH THE LATEST REVISIONS OF NEW YORK STATE INDUSTRIAL CODE RULE 23 AND OSHA REGULATIONS FOR CONSTRUCTION. SHEET PILING SHALL BE DESIGNED AND SEALED BY A NEW YORK STATE PROFESSIONAL ENGINEER.
- 12. CONTRACTOR SHALL BE RESPONSIBLE FOR DEWATERING AND THE MAINTENANCE OF SURFACE DRAINAGE DURING THE COURSE OF WORK AND SHALL SUBMIT A DEWATERING PLAN DESIGNED AND SEALED BY A NEW YORK STATE PROFESSIONAL ENGINEER. CONTRACTOR SHALL MAINTAIN EXISTING SITE DRAINAGE PATTERNS THROUGHOUT CONSTRUCTION UNLESS OTHERWISE SHOWN ON THE PLANS.
- 13. MAINTAIN FLOW FOR ALL EXISTING UTILITIES.
- 14. ALL FRAMES/COVERS WITHIN PAVED AREAS SHALL HAVE THE TOPS SET FLUSH WITH THE EXISTING PAVEMENT GRADE. IN LANDSCAPED AREAS, ALL FRAMES SHALL BE 0.1' ABOVE GRADE.
- 15. THE CONTRACTOR SHALL BE RESPONSIBLE FOR PROVIDING ALL FIELD LAYOUT. THE CONTRACTOR SHALL TAKE TIES TO ALL UTILITY CONNECTIONS AND PROVIDE MARKED-UP AS-BUILT PLANS FOR ALL UTILITIES SHOWING TIES TO CONNECTIONS, BENDS, VALVES, LENGTHS OF LINES, AND INVERTS. AS-BUILT PLANS SHOWING ALL UNDERGROUND UTILITIES INSTALLED OR ENCOUNTERED SHALL BE REVIEWED BY THE OWNER AND HIS REPRESENTATIVES. THE CONTRACTOR SHALL PROVIDE ANY CORRECTION OR ADMISSIONS TO THE SATISFACTION OF THE OWNER AND HIS REPRESENTATIVES BEFORE UTILITIES WILL BE ACCEPTED.
- 16. TEMPORARY PAVEMENT SHALL BE PLACED WITHIN 48 HOURS OF COMPLETION OF BACKFILL OPERATIONS WITHIN THE EXISTING PAVEMENT
- 17. CONTRACTOR SHALL MAINTAIN ALL TRAFFIC IN ALL AREAS IN ACCORDANCE WITH THE NYSDOT MANUAL OF UNIFORM TRAFFIC CONTROL DEVICES.
- 18. ALL EXCAVATIONS SHALL BE PROTECTED AT THE END OF EACH WORK DAY.
- 19. CONTRACTOR SHALL TAKE CARE TO PREVENT DAMAGE TO EXISTING UTILITIES. DAMAGED UTILITIES SHALL BE IMMEDIATELY REPAIRED BY CONTRACTOR AT THE CONTRACTOR'S EXPENSE.

Champlain Hudson **Power Express** 





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В	02/23/2022	PROGRESS SUBMISSION	JM	JR	
Α	01/26/2022	30% SUBMISSION	JM	JR	
No.	DATE	SUBMITTAL / REVISION DESCRIPTION	DB	APP	DF

CHAMPLAIN HUDSON POWER EXPRESS **SEGMENT 3 - PACKAGE 2 - FORT ANN TO KINGSBURY GENERAL NOTES** 

KIEWIT PROJECT NO. 21162 CHA PROJECT NO. 066076 DRAWING NO.

G-002

AS NOTED DATE DRAWN BY: XXX DESIGNED BY: XXX APPROVED BY: XXX REV. NO. X SH.NO.

U

CAPPED IRON ROD O IRON PIPE CONCRETE BOUNDARY ⊕POST

(SYM.)

EXISTING IRON PIPE **EXISTING CONCRETE MONUMENT** EXISTING POST EXISTING REFLECTOR MARKER

**Champlain Hudson** 

**Power Express** 

EXIST. TELE. DOGHOUSE

EXIST. TELE. MARKER POST

EXIST. TELE. JUNCTION BOX

EXIST. TRAFFIC SIGNAL BOX

EXISTING MANHOLE UNKNOWN

EXISTING CAPPED IRON ROD

EXISTING UTILITY BOX UNKNOWN

EXIST. CELL TOWER

EXIST. CABLE BOX

EXISTING ANTENNA

EXISTING SYMBOL

**W**Kiewit

Albany, NY 12205-0269 518.453.4500 . www.chacompanies.com

EXISTING SIGN EXIST. STRUCTURE POST EXIST. STRUCTURE MAILBOX EXIST. WETLAND FLAG EXIST. GAS LINE EXIST. UNDERGROUND TELE.

— — UT — — UT — EXIST. FIBER OPTIC EXIST. OVERHEAD TELE. — — ot — — ot — EXIST. UNDERGROUND ELEC. — — UE — — UE — EXIST. OVERHEAD ELEC. — OE — OE —

EXIST. CULVERT — — ST — — ST — EXIST. SANITARY SEWER — ss — ss — EXIST. STORM SEWER — st — st — EXIST. POTABLE WATER LINE EXIST. RAILROAD TRACK

\_\_\_\_ G \_\_\_ G \_\_\_

 $\times 139.7$ 

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EXIST. WETLANDS ⊗ CERTIFIED ROUTE MP XX CERTIFIED ROUTE PROVIDED BY CHPE KMZ EXIST. CONTOUR, INDEX

EXIST. SPOT ELEVATION

EXIST. CONTOUR, DEPRESSION INDEX EXIST. CONTOUR, INTERMEDIATE EXIST. CONTOUR, DEPRESSION INTERMEDIATE

EXIST. CULTURAL DEBRIS EXIST. CULTURAL FIELD LINE

EXIST. CULTURAL LANDSCAPE AREA

EXIST. CULTURAL PILE EXIST. CULTURAL STORAGE AREA

EXIST. CULVERT

EXIST. HYDROGRAPHIC

EXIST. INUNDATED AREA EXIST. RIP-RAP

EXIST. STREAM EXIST. SWAMP

WATER LEVEL EXIST. NATURAL BOULDER

EXIST. NATURAL SHRUB LINE EXIST. NATURAL TREE LINE

EXIST. NATURAL SINGLE TREE/BUSH EXIST. STRUCTURAL BUILDING

EXIST. PAVED DRIVE

EXIST. PAVED ROAD EXIST. PAVED SHOULDER

EXIST. PAVED SIDEWALK EXIST. GUARDRAIL EXIST. RAILROAD

EXIST. TRAIL EXIST. FENCE

EXIST. WALL EXIST. RETAINING WALL

EXIST. RIGHT-OF-WAY

EXIST. ABUTTER

LEGEND & ABBRIVIATIONS

PEM - PALUSTRINE EMERGENT PSS - PALUSTRINE SCRUB-SHRUB PFO - PALUSTRINE FORESTED PUB - PALUSTRINE UNCONSOLIDATED BOTTOM 1...<del>\*</del>...\*...\* L1 - LACUSTRINE LIMNETIC L<u>\* \* \* \*</u> 2:2:2:2 L2 - LACUSTRINE LITTORAL PROP. NYSDEC FWW 100-FOOT ADJACENT AREA PROP. GIS — WETLAND PROP. JD BOUNDARY PROP. WETLAND PROTECTION FENCE PROP. COMPOST FILTER SOCK (OR SILT SOCK) ——FS—— PROP. LIMITS OF WORK/DISTURBANCE PROP. LIMITS OF CLEARING/LIMITS OF WORK IN CLEARING AREAS PROP. CONCRETE WASHOUT ----PROP. ACCESS ROAD ROUTE (EXISTING ROAD OR SURFACE) \_\_\_\_ PROP. REFURBISHED ACCESS ROAD PROP. ACCESS ROAD OR OFF SITE ACCESS ROAD PROP. TIMBER MATTING ACCESS ROAD  $\mathsf{L} = \mathsf{L}$ PROP. SPLICE LOCATION \_ \_ \_ \_ PROP. SPLICE VAULT PROP. LINK BOX HANDHOLE PROP. FIBER SPLICE HANDHOLE PROP. BORING LOCATION PROP. ALIGNMENT STATIONING PROP. RIGHT-OF-WAY PROP. ABUTTER PROP. ALIGNMENT CENTERLINE **ZZZ** PROP. LAYDOWN YARDS, PARKING, STORAGE & MUSTER AREA PROP. WORK AREAS PROP. PERMANENT EASEMENT \_\_\_\_ PROP. TEMPORARY EASEMENT 7' FOUL ZONE: NO VEHICLES, MATERIALS, DISTURBANCE, PERSONNEL, OR WORK SHALL ENCROACH THE ZONE WITHIN 7FT OF THE NEAREST RAIL WITHOUT CSX COORDINATION AND APPROVAL

SURVEY NOTES:

OF THE ALTERATION.

1. A ROW, UTILITY & WETLAND SURVEY PREPARED IN THE FIELD BY CONTROL POINT ASSOCIATES, INC., AND OTHER REFERENCE MATERIAL AS LISTED HEREON.

2. ELEVATIONS REFER TO THE NORTH AMERICAN VERTICAL DATUM OF 1988 (NAVD88), BASED ON GPS OBSERVATIONS TAKEN AT THE TIME OF THE

NORTH ORIENTATION SHOWN REFERS TO THE NAD83 STATE PLANE COORDINATE SYSTEM - NEW YORK EAST ZONE BASED ON GPS OBSERVATIONS TAKEN AT THE TIME OF THE FIELD SURVEY.

LOCATION OF UNDERGROUND UTILITIES ARE APPROXIMATE. LOCATIONS AND SIZES ARE BASED ON UTILITY MARK-OUTS, ABOVE GROUND STRUCTURES THAT WERE VISIBLE & ACCESSIBLE IN THE FIELD, AND THE MAPS AS LISTED IN THE REFERENCES AVAILABLE AT THE TIME OF THE SURVEY. AVAILABLE ASBUILT PLANS AND UTILITY MARKOUT DOES NOT ENSURE MAPPING OF ALL UNDERGROUND UTILITIES AND STRUCTURES. BEFORE ANY EXCAVATION IS TO BEGIN, ALL UNDERGROUND UTILITIES SHOULD BE VERIFIED AS TO THEIR LOCATION, SIZE AND TYPE BY THE PROPER UTILITY COMPANIES. CONTROL POINT ASSOCIATES, INC. DOES NOT GUARANTEE THE UTILITIES SHOWN COMPRISE ALL SUCH UTILITIES IN THE AREA EITHER IN SERVICE OR ABANDONED.

SUBSURFACE UTILITY ENGINEERING NOTES:

A QUALITY LEVEL SYSTEM IS UTILIZED TO IDENTIFY THE SOURCE OF THE UNDERGROUND UTILITY INFORMATION. THE METHOD OF DETERMINATION IS BASED ON CONTRACTUAL AGREEMENT WITH THE CLIENT AND IS DEPICTED ON THE SURVEY BY THE LINE TYPES SHOWN IN THE DRAWING LEGEND. FOR REFERENCE, THE QUALITY LEVELS ARE AS FOLLOWS:

QUALITY LEVEL B - UTILITY LOCATION DATA IS COLLECTED THROUGH GEOPHYSICAL SENSING TECHNOLOGY TO SUPPLEMENT SURFACE FEATURES AND OR REFERENCE MAPPING. INCLUDES MARKOUT BY CONTROL POINT ASSOCIATES, INC.

04/28/2022 60% SUBMISSION

01/26/2022 30% SUBMISSION

03/04/2022 PROGRESS SUBMISSION

02/23/2022 PROGRESS SUBMISSION

DATE SUBMITTAL / REVISION DESCRIPTION

**SEGMENT 3 - PACKAGE 2 - FORT ANN TO KINGSBURY** SURVEY LEGEND JM JR JM JR

JM JR

JM JR

KIEWIT PROJECT NO. CHAMPLAIN HUDSON POWER EXPRESS 21162 CHA PROJECT NO. 066076 DRAWING NO.

G-003

DB | APP | DRAWN BY: JTM | DESIGNED BY: JTM | APPROVED BY: JPR | REV. NO.

**APPROVED** 

CENTERLINE

CONCRETE

DEGREES

DRIVE

**EASTING** 

**ELEVATION** 

GAS PIPE

**HORIZONTAL** 

INVERT ELEVATION

LIMITS OF WORK

FEET

LEFT

MAXIMUM

MINIMUM

**NORTHING** 

NUMBER

RADIUS

ROAD

RIGHT

ROUTE

SHEET

**STREET** 

STATION

**TEMPORARY** 

**TYPICAL** 

**VERTICAL** 

WATERLINE

REVISION

RIGHT-OF-WAY

SANITARY SEWER PIPE

STORM DRAIN PIPE

THERMAL RESISTIVITY

TELECOMMUNICATIONS CABLE

**NEW YORK** 

PACKAGE #

POLYVINYL CHLORIDE

POINT OF VERTICAL INTERSECTION

REINFORCED CONCRETE PIPE

DESIGNED BY

DEVIATION ZONE

ELECTRIC CABLE

FIBER OPTIC CABLE

HORIZONTAL DIRECTIONAL DRILLING

HIGH-VOLTAGE DIRECT CURRENT TRANSMISSION LINE

CONC

DB

DEC

DEG

DR

DΖ

ELECTRIC

**ELEV** 

**FIBER** 

FΤ

GAS

HDD

HVDC

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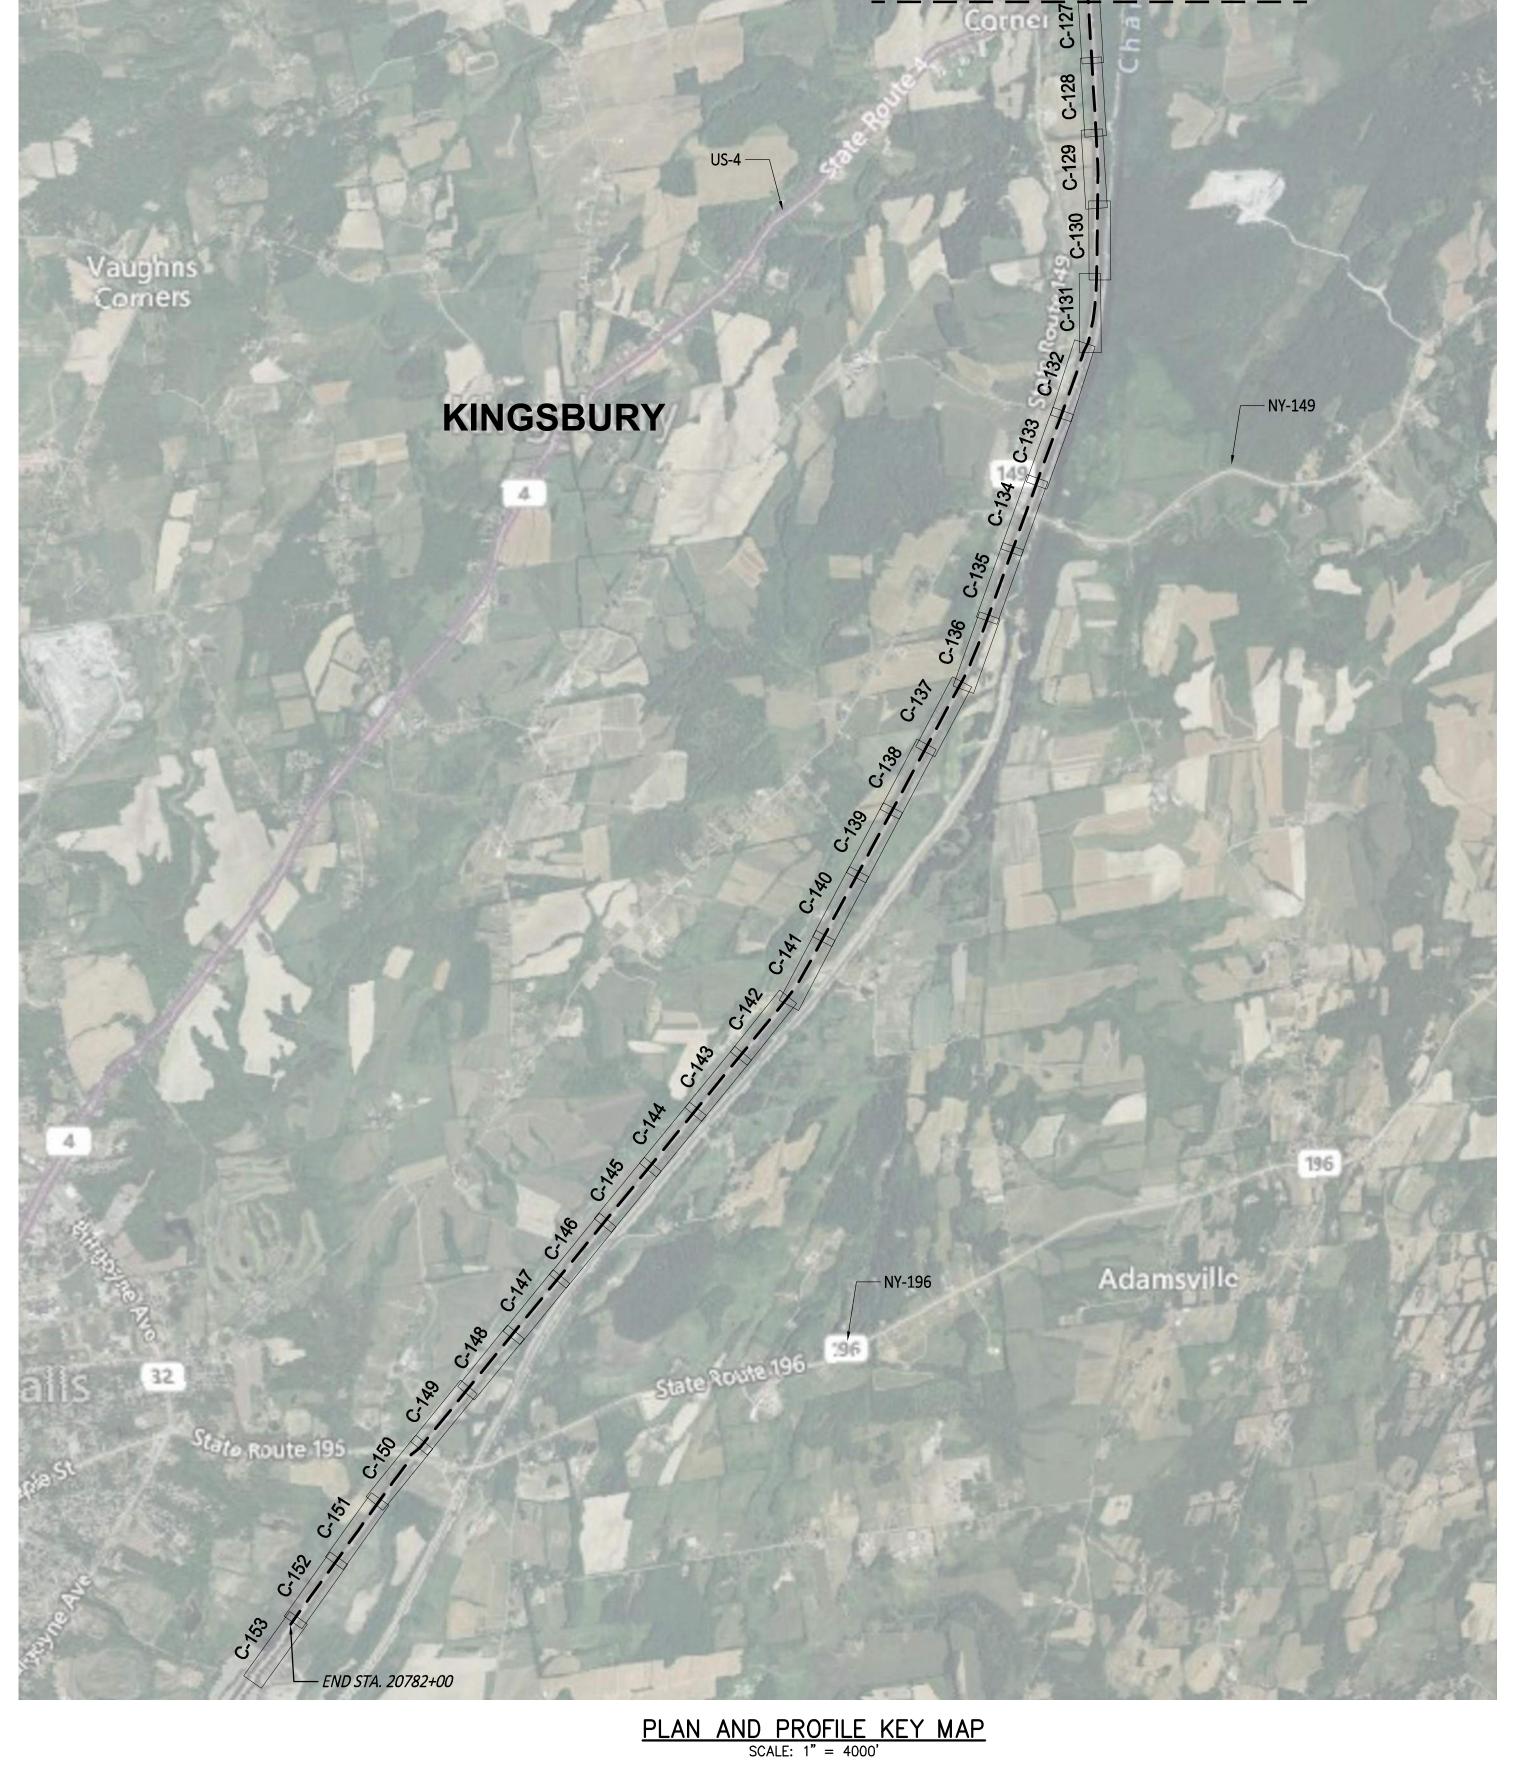
CORRUGATED METAL PIPE

NEW YORK STATE DEPARTMENT OF ENVIRONMENTAL CONSERVATION

AS NOTED DATE X SH.NO. XXX OF XXX

IT IS A VIOLATION OF LAW FOR ANY PERSON, UNLESS THEY ARE ACTING UNDER THE DIRECTION OF A LICENSED PROFESSIONAL ENGINEER, ARCHITECT, LANDSCAPE ARCHITECT OR LAND SURVEYOR TO ALTER AN ITEM IN ANY WAY, IF AN ITEM BEARING THE STAMP OF A LICENSED PROFESSIONAL IS ALTERED, THE ALTERING ENGINEER, ARCHITECT, LANDSCAPE ARCHITECT OR LAND SURVEYOR SHALL STAMP THE DOCUMENT AND INCLUDE THE NOTATION "ALTERED BY" FOLLOWED BY THEIR SIGNATURE, THE DATE OF SUCH ALTERATION, AND A SPECIFIC DESCRIPTION











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					SEGMENT 3 - PACKAGE 2 - FORT ANN TO KIN
_					KEYPLAN
D	04/28/2022	60% SUBMISSION	JM	JR	
С	03/04/2022	PROGRESS SUBMISSION	JM	JR	
В	02/23/2022	PROGRESS SUBMISSION	JM	JR	
Α	01/26/2022	30% SUBMISSION	JM	JR	
No.	DATE	SUBMITTAL / REVISION DESCRIPTION	DB	APP	SCALE SCALE
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CHAMPLAIN HUDSON POWER EXPRESS SEGMENT 3 - PACKAGE 2 - FORT ANN TO KINGSBURY KEYPLAN

KIEWIT PROJECT NO. 21162 CHA PROJECT NO. 066076 DRAWING NO.

G-004 AS NOTED DATE

#### CLEANUP STANDARDS AND PRACTICES

FROM THE BMP'S, CLEAN-UP, RESTORATION, AND REVEGETATION PROCEDURES WILL BE ONGOING DURING CONSTRUCTION AS EACH PROJECT SEGMENT IS COMPLETED. DURING CONSTRUCTION, THE RIGHT-OF-WAY (ROW) WILL BE KEPT FREE OF DEBRIS AND DISCARDED MATERIAL TO THE GREATEST EXTENT POSSIBLE AS CONSTRUCTION CONTINUES, EACH SECTION OF THE ROW WILL BE THOROUGHLY CLEANED AFTER CONSTRUCTION IS COMPLETED ON THAT PARTICULAR SECTION. ALL FABRICATED DEBRIS RESULTING FROM CONSTRUCTION WILL BE DISPOSED OF AT AN APPROVED DISPOSAL SITE IN COMPLIANCE WITH ALL APPROPRIATE ENVIRONMENTAL REGULATIONS (CC#8). FABRICATED DEBRIS GENERATED DURING CONSTRUCTION INCLUDES PIPING, FENCING, WIRING, AND ANY OTHER MATERIALS USED DURING CONSTRUCTION. NO FABRICATED DEBRIS BE BURNED OR BURIED (2012 BMPS, SECTION 11.1).

#### RESTORATION AND PLANTING

THE FINAL STAGE OF CONSTRUCTION WILL CONSIST OF RESTORING THE ROW SEGMENTS TO ITS ORIGINAL CONDITION AND CHARACTER AS MUCH AS POSSIBLE/IS PRACTICAL. RESTORATION ACTIVITIES MAY VARY WITH THE SPECIFIC AREA TO BE RESTORED, BUT WILL CONSIST PREDOMINANTLY OF RESTORING TOPOGRAPHY TO ORIGINAL GRADIENTS, AND RESEEDING EXCAVATED OR PAVING AREAS OVER THE TRENCH AS IDENTIFIED HEREIN.

#### SITE PREPARATION FOR REVEGETATION

THE SURFACE OF THE ROW DISTURBED BY CONSTRUCTION ACTIVITIES WILL BE GRADED TO MATCH THE ORIGINAL TOPOGRAPHIC CONTOURS AND TO BE COMPATIBLE WITH SURROUNDING DRAINAGE PATTERNS WHERE APPROPRIATE. IT SHOULD BE NOTED THAT SUBCONTRACTORS WILL TYPICALLY LIMIT GRUBBING (THE REMOVAL OF STUMPS AND ROOTS) TO THE FOOTPRINT OF THE EXCAVATED TRENCH AND ACCESS ROADS TO ALLOW RE-SPROUTING AND ASSIST IN THE RECOVERY OF WOODY SPECIES. EXCEPT WHERE REMOVAL IS REQUIRED FOR SAFE CONSTRUCTION. WHERE NEEDED, IT MAY BE NECESSARY TO IMPORT TOPSOIL TO RETURN AN AREA TO GRADE, HORIZONTAL DIRECTIONAL DRILLING (HDD) ENTRY AND EXIT PITS WILL BE BACKFILLED AND THE DISTURBED GROUND SURFACE WILL BE SIMILARLY GRADED.

THE CERTIFICATE HOLDERS SHALL BE RESPONSIBLE FOR CHECKING ALL CULVERTS AND ASSURING THAT THEY ARE NOT CRUSHED OR BLOCKED DURING CONSTRUCTION AND RESTORATION OF THE SEGMENT AND, IF A CULVERT IS BLOCKED OR CRUSHED. TAKING IMMEDIATE STEPS TO REPLACE OR REPAIR THE CULVERT IN ACCORDANCE WITH APPLICABLE STATE OR LOCAL STANDARDS.

#### SEEDING AND PLANTING

SEEDING OPERATIONS ACROSS THE 35-FOOT-WIDE TEMPORARY/PERMANENT ROW AS WELL AS WITHIN STAGING AND LAYDOWN AREAS WILL COMMENCE ONLY AFTER AN ACCEPTABLE SEEDBED HAS BEEN ESTABLISHED. SEED WILL BE APPLIED BY HAND, OR VIA HYDRO-SEEDERS. THE ENTIRE SEEDED AREA WILL BE WATERED WITH A FINE SPRAY UNTIL A UNIFORM MOISTURE DEPTH OF APPROXIMATELY ONE (1) INCH HAS BEEN OBTAINED, AS APPLICABLE. MULCHING AND ANCHORING OF THE MULCH MAY BE NECESSARY IN SOME AREAS UNLESS A HYDROMULCH/SEED SLURRY IS USED. ON STEEP SLOPES, JUTE NET WILL BE USED TO PROVIDE STABILIZATION. FERTILIZER WILL BE ADDED. AS APPLICABLE. AT THE APPROPRIATE RATES AFTER SEED IS APPLIED AND/OR TO A HYDROMULCH/SEED SLURRY TO BUFFER AREAS BUT NOT FOR WETLAND RESOURCE AREAS. SEEDING/MULCHING WILL TAKE PLACE UNDER THE SUPERVISION OF THE ENVIRONMENTAL INSPECTOR THE SEED MIXTURE AND RATE OF APPLICATION WILL DEPEND ON THE SOIL TYPE, LAND USE, AVAILABLE MOISTURE, AND SEASON AT THE TIME OF APPLICATION. THE LOCAL SOIL AND WATER CONSERVATION DISTRICT AND THE LANDOWNER/OPERATOR WILL BE CONSULTED REGARDING APPROPRIATE SEED MIXTURES AND APPLICATION RATES. ALL SEED MIXES WILL BE FREE OF INVASIVE SPECIES. ALL SEED BAG TAGS WILL BE PROVIDED TO THE ENVIRONMENTAL INSPECTOR. SEEDED AREAS WILL BE MONITORED FOLLOWING RESTORATION UNTIL A MINIMUM VEGETATIVE COVER OF EIGHTY (80) PERCENT IS ACHIEVED. THE SEED MIXTURES ARE AS FOLLOWS: GENERAL SEED FOR UPLANDS AND WETLAND BUFFER ZONES. FOR WETLAND RESOURCE AREAS, EMERGENT COMMUNITIES SHOULD BE REVEGETATED WITH AN ERNST FACW WETLAND MEADOW MIX (ERNMX-122) OR EQUIVALENT, AND FOR SHADED SITES WITHIN FORESTED/SHRUB-SHRUB WETLAND COMMUNITIES, DISTURBED AREAS SHOULD BE REVEGETATED WITH ERNST SPECIALIZED WETLAND MIX FOR SHADED AREAS (ERNMX-137) OR EQUIVALENT. FOR UPLANDS AND WETLAND BUFFER ZONES LOCATED WITHIN THE ADIRONDACK PARK SHOULD BE ADIRONDACK SEED.

SOIL EXCAVATION IS ONLY PROPOSED OVER THE TRENCH-LINE FOR THE CONDUIT/CABLE AND THE TRENCH WILL BE RESEEDED WITH AN APPROPRIATE SEED MIX AS IDENTIFIED HEREIN. VEGETATION THROUGHOUT THE TEMPORARY RIGHT-OF-WAY WILL BE CUT TO GROUND LEVEL AND ROOT SYSTEMS WILL REMAIN INTACT TO ALLOW FOR RESPROUTING FOLLOWING CONSTRUCTION.

ALL TREES OVER TWO (2) INCHES IN DIAMETER AT BREAST HEIGHT OR SHRUBS OVER FOUR (4) FEET IN HEIGHT DAMAGED OR DESTROYED BY ACTIVITIES DURING CONSTRUCTION, OPERATION, OR MAINTENANCE, ASSOCIATED URBAN, RESIDENTIAL OR ADIRONDACK PARK LANDSCAPED AREAS, SHALL BE REPLACED WITHIN THE FOLLOWING YEAR BY THE CERTIFICATE HOLDERS WITH THE EQUIVALENT TYPE OF TREES OR SHRUBS EXCEPT IF:

a) EQUIVALENT TYPE REPLACEMENT TREES OR SHRUBS WOULD INTERFERE WITH THE PROPER CLEARING, CONSTRUCTION, OPERATION, OR MAINTENANCE OF THE PROJECT OR WOULD BE INCONSISTENT WITH STATE-INVASIVE SPECIES POLICY;

b)REPLACEMENT WOULD BE CONTRARY TO SOUND ROW MANAGEMENT PRACTICES, OR TO ANY APPROVED LONG-RANGE ROW MANAGEMENT PLAN APPLICABLE TO THE PROJECT OR ADJOINING ROW; OR

c)THE OWNER OF LAND WHERE THE DAMAGED OR DESTROYED TREES OR SHRUBS WERE LOCATED (OR OTHER RECORDED EASEMENT OR LICENSE HOLDERS WITH THE RIGHT TO CONTROL REPLACEMENT) DECLINES REPLACEMENT.

#### RESTORATION OF WETLANDS

THESE AREAS WILL BE RESTORED AS CLOSE AS PRACTICABLE TO PRE-CONSTRUCTION CONDITIONS AND CONTOURS. ALL TEMPORARY FENCING AND EROSION CONTROLS WILL BE REMOVED AND DISPOSED OF IN AN ACCEPTABLE MANNER AT A STATE-APPROVED DISPOSAL FACILITY APPROVED BY DPS STAFF AND THE CERTIFICATE HOLDERS. ALL MOTORIZED CONSTRUCTION EQUIPMENT WILL BE TRANSPORTED TO OFF-SITE FACILITIES. ALL WETLAND MATS AND MATERIALS WILL BE COLLECTED, PACKED, AND TRANSPORTED TO OFF-SITE STORAGE FACILITIES OR TO THE NEXT SEGMENT'S STAGING AREA AS NEEDED.

#### RESTORATION OF ROADWAY

THESE AREAS WILL BE RESTORED AS CLOSE AS PRACTICABLE TO PRE-CONSTRUCTION CONDITIONS AND CONTOURS. TRENCHES WILL BE BACKFILLED PER THE APPROPRIATE DETAIL, FULL WIDTH OF THE TRENCH WILL BE RESTORED TO MATCH THE EXISTING PAVEMENT SECTION, THE FULL WIDTH OF THE TRAVEL LANE TO THE CENTERLINE WILL BE MILLED AND OVERLAYED WITH A TOP COURSE OF ASPHALT. ALL TEMPORARY FENCING AND EROSION CONTROLS WILL BE REMOVED AND DISPOSED OF IN AN ACCEPTABLE MANNER AT A STATE-APPROVED DISPOSAL FACILITY APPROVED BY DPS STAFF AND THE CERTIFICATE HOLDERS.

#### RESTORATION OF ROADWAY SHOULDER

THESE AREAS WILL BE RESTORED AS CLOSE AS PRACTICABLE TO PRE-CONSTRUCTION CONDITIONS AND CONTOURS. TRENCHES WILL BE BACKFILLED PER THE APPROPRIATE DETAIL. FULL WIDTH OF THE TRENCH WILL BE RESTORED TO MATCH THE EXISTING PAVEMENT SHOULDER SECTION, THE FULL WIDTH OF THE SHOULDER WILL BE MILLED AND OVERLAYED WITH A TOP COURSE OF ASPHALT. ALL TEMPORARY FENCING AND EROSION CONTROLS WILL BE REMOVED AND DISPOSED OF IN AN ACCEPTABLE MANNER AT A STATE-APPROVED DISPOSAL FACILITY APPROVED BY DPS STAFF AND THE CERTIFICATE HOLDERS.

### RESTORATION OF CONSTRUCTION MATERIALS AND EQUIPMENT STAGING LOCATIONS

THE CONSTRUCTION MATERIALS EQUIPMENT STAGING LOCATIONS FOR THE PACKAGE SEGMENT ARE SHOWN IN THE PLAN AND PROFILE DRAWINGS AND EROSION AND SEDIMENT CONTROL PLAN. THESE AREAS WILL BE RESTORED AS CLOSE AS PRACTICABLE TO PRE-CONSTRUCTION CONDITIONS AND CONTOURS. ALL TEMPORARY FENCING AND EROSION CONTROLS WILL BE REMOVED AND DISPOSED OF IN AN ACCEPTABLE MANNER AT A STATE-APPROVED DISPOSAL FACILITY APPROVED BY DPS STAFF AND THE CERTIFICATE HOLDERS. ALL MOTORIZED CONSTRUCTION EQUIPMENT WILL BE TRANSPORTED TO OFF-SITE FACILITIES. ALL OTHER USABLE CONSTRUCTION EQUIPMENT AND MATERIALS WILL BE COLLECTED, PACKED, AND TRANSPORTED TO OFF-SITE STORAGE FACILITIES OR TO THE NEXT SEGMENT'S STAGING AREA AS NEEDED. ALL UNUSABLE EQUIPMENT AND MATERIALS WILL BE REMOVED FROM THE LAYDOWN YARD AND DISPOSED OF APPROPRIATELY

#### PLANT INSPECTION. GUARANTEE AND MAINTENANCE

VEGETATION RESTORATION ALSO INCLUDES THE MAINTENANCE OF PLANTINGS FOR SPECIFIED TIME PERIODS AND THE REPLACEMENT OF UNSUCCESSFUL PLANTINGS. ALL VEGETATION REPLACED WILL HAVE A MINIMUM TWO (2) YEAR SURVIVAL GUARANTEE. TEMPORARY EROSION CONTROLS WILL BE REMOVED ONCE REVEGETATION IS ESTABLISHED. REVEGETATION WILL BE MONITORED UNTIL THERE IS A MINIMUM OF EIGHTY (80) PERCENT REGROWTH. WHERE TREE OR SHRUB PLANTINGS ARE NEEDED, A POST CONSTRUCTION SURVIVAL SURVEY WILL BE PERFORMED ONE YEAR AFTER THE PLANTINGS. IF ANY TREE OR SHRUB HAS NOT SURVIVED OR IS IN POOR HEALTH, THE TREE/SHRUB WILL BE REPLACED.

THE ENVIRONMENTAL INSPECTOR WILL INSPECT ALL PLANTS IN CONTAINERS PRIOR TO PLANTING. PLANTINGS WILL BE PERFORMED BY A QUALIFIED LANDSCAPE OR NURSERY CONTRACTOR. THE ENVIRONMENTAL INSPECTOR WILL INSPECT ALL PLANTS PRIOR TO PLANTING AND AFTER COMPETITION OF PLANTING TO ENSURE PROPER PLANTING PROCEDURES AND THE CORRECT PLANT SPECIES WERE USED. ADDITIONALLY, THE ENVIRONMENTAL INSPECTOR WILL CONDUCT A FINAL INSPECTION OF ALL REVEGETATED AREAS AFTER THE END OF THE MONITORING PERIOD TO ENSURE FINAL STABILIZATION.

RESTORATION OR SEEDED AREAS WILL BE CONSIDERED TO HAVE MET FINAL STABILIZATION WHEN ALL SOIL DISTURBING ACTIVITIES HAVE CEASED AND A UNIFORM, PERENNIAL VEGETATIVE COVER WITH A DENSITY OF 80 PERCENT.

STORMWATER POLLUTION PREVENTION PLAN (SWPPP) INSPECTIONS WILL BE PERFORMED BY THE ENVIRONMENTAL INSPECTOR ON A WEEKLY BASIS UNTIL ALL DISTURBED AREAS HAVE ACHIEVED THE 80% REVEGETATION REQUIRED FOR FINAL RESTORATION. FOLLOWING FINAL RESTORATION, EROSION AND SEDIMENT CONTROL MEASURES WILL BE REMOVED FROM THE SITE AND DISPOSED OF APPROPRIATELY.

### RESTORATION WITHIN NYSDOT ROW

ALL RESTORATION WITHIN THE NYSDOT ROW SHALL BE DONE IN ACCORDANCE WITH THE LATEST VERSION OF THE NYSDOT STANDARD SPECIFICATIONS AND STANDARD SHEETS.

#### SEED MIXES

#### A. GENERAL SEED:

1. PIPELINE MIX W/SWITCHGRASS (ERNMX-102-1)

2. MIX COMPOSITION

33.0% PANICUM VIRGATUM, 'SHAWNEE' (SWITCHGRASS, 'SHAWNEE')

25.0% FESTUCA RUBRA (CREEPING RED FESCUE)

18.0% LOLIUM MULTIFLORUM (ANNUAL RYEGRASS) 16.0% PHLEUM PRATENSE, CLIMAX (TIMOTHY, CLIMAX)

5.0% TRIFOLIUM HYBRIDUM (ALSIKE CLOVER)

3.0% AGROSTIS ALBA (REDTOP)

3. APPLIED AT A RATE OF 40 LBS/ACRE.

#### B. ADIRONDACK SEED:

1. MIX COMPOSITION

25% VIRGINIA WILD RYE (ELYMUS VIRGINICUS VAR. VIRGINICUS)

25% CANADA WILD RYE (ELYMUS CANADENSIS)

25% AUTUMN BENTGRASS (AGROSTIS PERENNANS)

25% CAMPER LITTLE BLUESTEM (SCHIZACHYRIUM SCOPARIUM)

2. APPLIED AT A RATE OF 40 LBS/ACRE.

#### C. SPECIALIZED WETLAND MIX FOR SHADED OBL-FACW AREAS (ERNMX-137) 1. MIX COMPOSITION

35.0% CAREX VULPINOIDEA, PA ECOTYPE (FOX SEDGE, PA ECOTYPE)

15.0% CAREX SCOPARIA, PA ECOTYPE (BLUNT BROOM SEDGE, PA ECOTYPE)

20.0% ELYMUS VIRGINICUS, MADISON-NY ECOTYPE (VIRGINIA WILDRYE, MADISON-NY ECOTYPE)

12.8% CAREX LURIDA, PA ECOTYPE (LURID SEDGE, PA ECOTYPE)

5.0% CAREX LUPULINA. PA ECOTYPE (HOP SEDGE. PA ECOTYPE)

4.0% VERBENA HASTATA, PA ECOTYPE (BLUE VERVAIN, PA ECOTYPE)

2.0% HELIOPSIS HELIANTHOIDES, PA ECOTYPE (OXEYE SUNFLOWER, PA ECOTYPE)

1.0% CAREX INTUMESCENS, PA ECOTYPE (STAR SEDGE, PA ECOTYPE)

1.0% SPARGANIUM AMERICANUM (EASTERN BUR REED)

0.7% IRIS VERSICOLOR (BLUEFLAG)

0.5% BIDENS CERNUA, PA ECOTYPE (NODDING BUR MARIGOLD, PA ECOTYPE)

0.5% CAREX CRINITA, PA ECOTYPE (FRINGED SEDGE, PA ECOTYPE)

0.5% CAREX STIPATA, PA ECOTYPE (AWL SEDGE, PA ECOTYPE)

0.5% EUPATORIUM PERFOLIATUM, PA ECOTYPE (BONESET, PA ECOTYPE) 0.5% SCIRPUS CYPERINUS, PA ECOTYPE (WOOLGRASS, PA ECOTYPE)

0.5% VERNONIA NOVEBORACENSIS, PA ECOTYPE (NEW YORK IRONWEED, PA ECOTYPE)

0.3% LOBELIA SIPHILITICA, PA ECOTYPE (GREAT BLUE LOBELIA, PA ECOTYPE)

0.2% PENTHORUM SEDOIDES, PA ECOTYPE (DITCH STONECROP, PA ECOTYPE)

2. APPLIED AT A RATE OF APPROXIMATELY 20 LBS/ACRE, ALONG WITH THE COVER CROP

3. COVER CROP SHOULD BE APPLIED AT A RATE OF 60-80 LBS/ACRE. COVER CROP TO BE AN ANNUAL RYE. COVER CROP BASED ON SEASON OF RESTORATION AN ANNUAL RYE THROUGH SPRING AND SUMMER AND WINTER RYE FOR LATE FALL.

## D. FACW WETLAND MEADOW MIX (ERNMX-122)

1. MIX COMPOSITION

21.0% CAREX VULPINOIDEA, PA ECOTYPE (FOX SEDGE, PA ECOTYPE)

20.0% ELYMUS VIRGINICUS, PA ECOTYPE (VIRGINIA WILDRYE, PA ECOTYPE)

16.0% CAREX LURIDA, PA ECOTYPE (LURID SEDGE, PA ECOTYPE)

12.0% CAREX LUPULINA, PA ECOTYPE (HOP SEDGE, PA ECOTYPE)

12.0% CAREX SCOPARIA, PA ECOTYPE (BLUNT BROOM SEDGE, PA ECOTYPE) 3.0% VERBENA HASTATA, PA ECOTYPE (BLUE VERVAIN, PA ECOTYPE)

2.4% ASCLEPIAS INCARNATA, PA ECOTYPE (SWAMP MILKWEED, PA ECOTYPE)

2.0% JUNCUS EFFUSUS (SOFT RUSH)

2.0% ZIZIA AUREA, PA ECOTYPE (GOLDEN ALEXANDERS, PA ECOTYPE)

1.6% ASTER NOVAE-ANGLIAE, PA ECOTYPE (NEW ENGLAND ASTER, PA ECOTYPE)

1.3% CAREX STIPATA, PA ECOTYPE (AWL SEDGE, PA ECOTYPE)

1.0% BIDENS CERNUA, PA ECOTYPE (NODDING BUR MARIGOLD, PA ECOTYPE)

1.0% JUNCUS TENUIS, PA ECOTYPE (PATH RUSH, PA ECOTYPE) 0.8% SOLIDAGO RUGOSA, PA ECOTYPE (WRINKLELEAF GOLDENROD, PA ECOTYPE)

0.6% VERBENA URTICIFOLIA, PA ECOTYPE (WHITE VERVAIN, PA ECOTYPE)

0.5% CAREX CRINITA, PA ECOTYPE (FRINGED SEDGE, PA ECOTYPE)

0.5% EUPATORIUM PERFOLIATUM, PA ECOTYPE (BONESET, PA ECOTYPE)

0.5% HELENIUM AUTUMNALE, PA ECOTYPE (COMMON SNEEZEWEED, PA ECOTYPE)

0.5% MIMULUS RINGENS, PA ECOTYPE (SQUARE STEMMED MONKEYFLOWER, PA ECOTYPE)

0.3% LOBELIA SIPHILITICA, PA ECOTYPE (GREAT BLUE LOBELIA, PA ECOTYPE) 0.3% SCIRPUS CYPERINUS, PA ECOTYPE (WOOLGRASS, PA ECOTYPE)

0.2% ALISMA SUBCORDATUM, PA ECOTYPE (MUD PLANTAIN, PA ECOTYPE)

0.2% ASTER PUNICEUS, PA ECOTYPE (PURPLESTEM ASTER, PA ECOTYPE)

0.2% ASTER UMBELLATUS, PA ECOTYPE (FLAT TOPPED WHITE ASTER, PA ECOTYPE)

0.1% PENTHORUM SEDOIDES, PA ECOTYPE (DITCH STONECROP, PA ECOTYPE)

2. APPLIED AT A RATE OF APPROXIMATELY 20 LBS/ACRE, ALONG WITH THE COVER CROP.

3. COVER CROP SHOULD BE APPLIED AT A RATE OF 60-80 LBS/ACRE. COVER CROP TO BE AN ANNUAL RYE. COVER CROP BASED ON SEASON OF RESTORATION AN ANNUAL RYE THROUGH SPRING AND SUMMER AND WINTER RYE FOR LATE FALL.







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D	04/28/2022	60% SUBMISSION	JM	JR	RESTORATION NOTES
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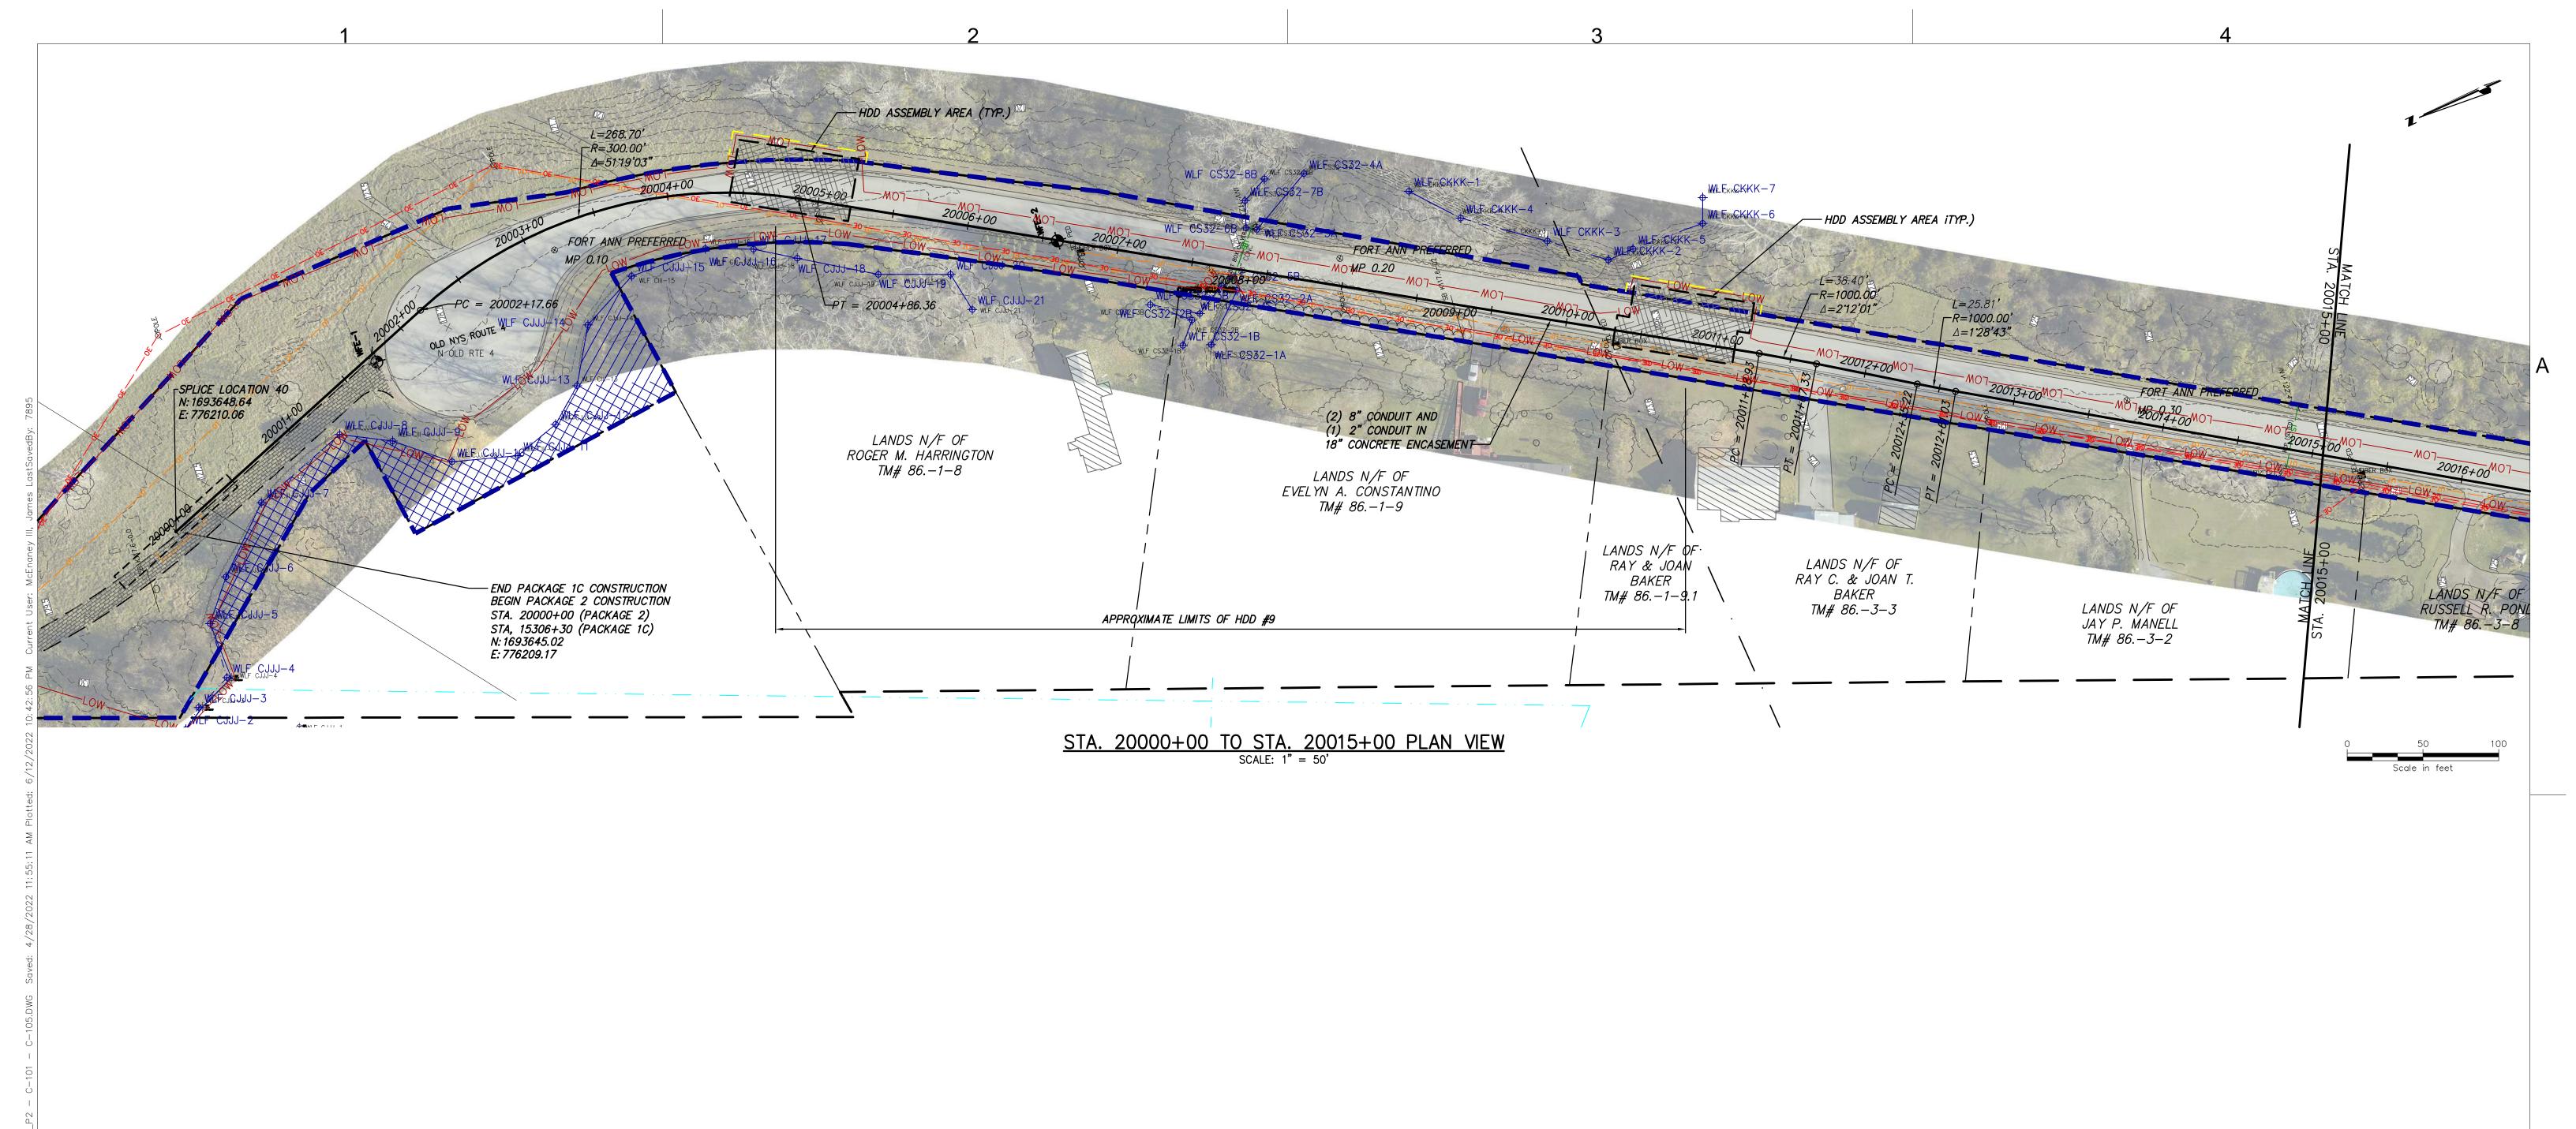
CHAMPLAIN HUDSON POWER EXPRESS **SEGMENT 3 - PACKAGE 2 - FORT ANN TO KINGSBURY** RESTORATION NOTES


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# STA. 20000+00 TO STA. 20015+00 PROFILE VIEW SCALE: H: 1" = 50' V: 1" = 10'







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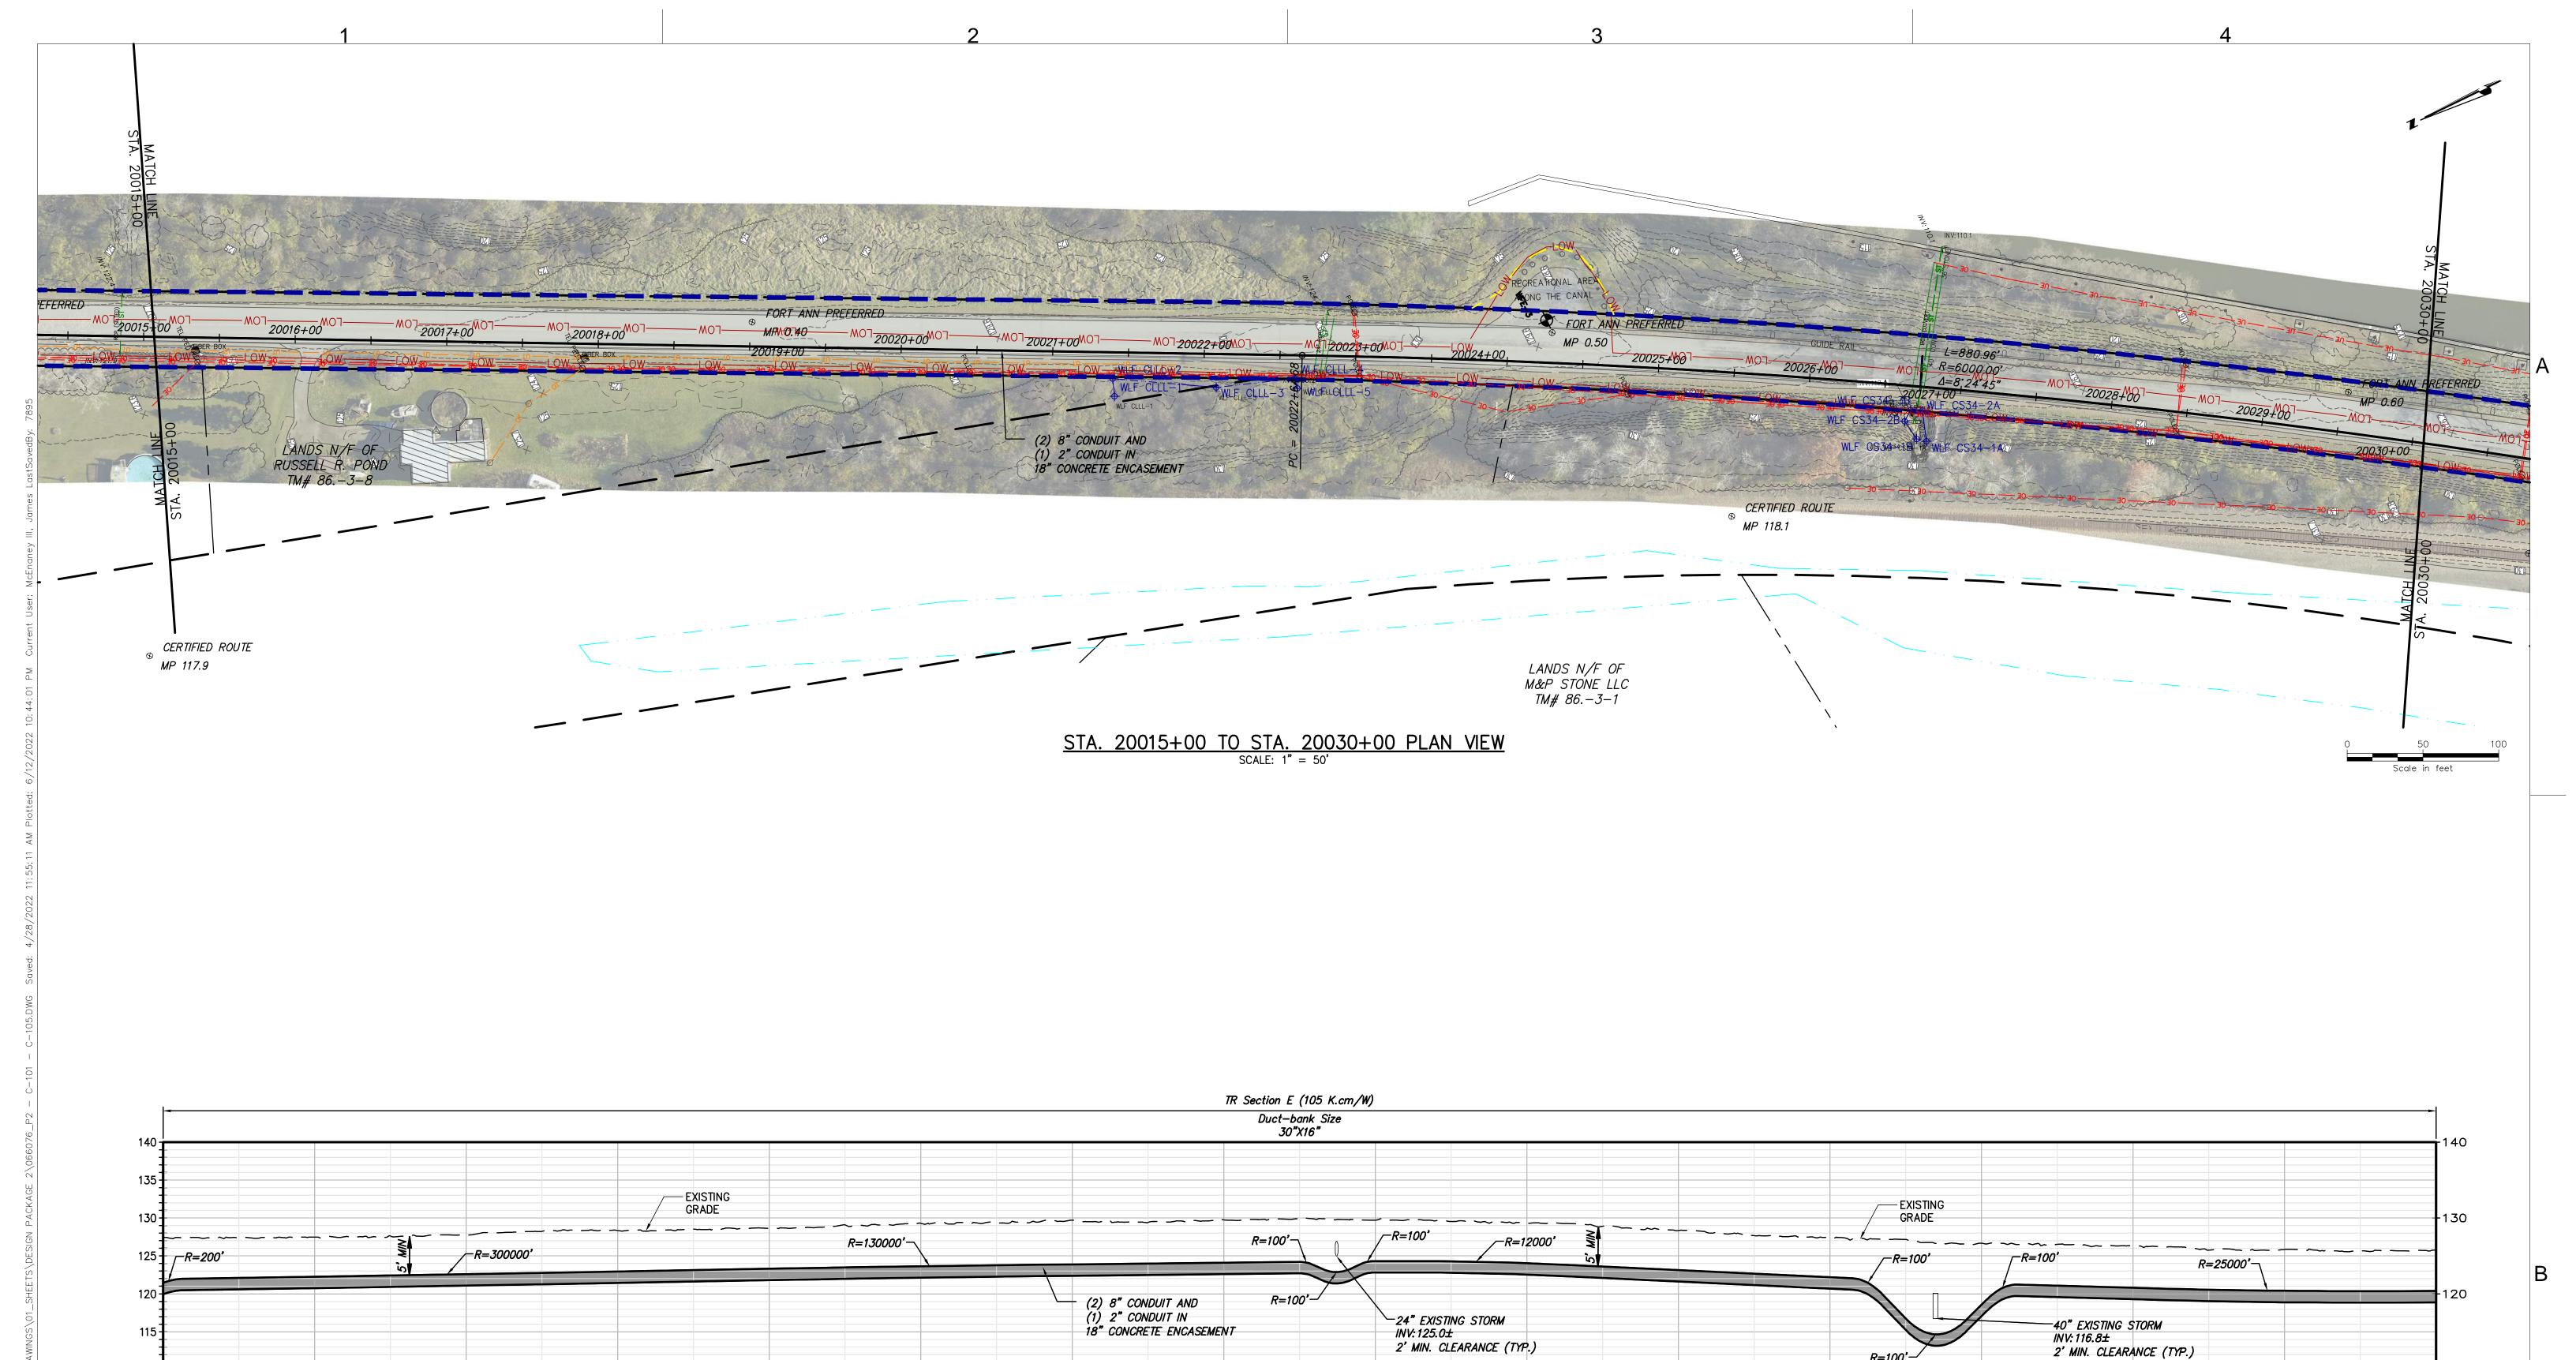
-						CHAMPLAIN HUDSON POWER EX SEGMENT 3 - PACKAGE 2 - FORT ANN TO KIN
	D	04/28/2022	60% SUBMISSION	JM	JR	STA. 20000+00 TO STA. 20015+00 PLAN AND
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## CHAMPLAIN HUDSON POWER EXPRESS **SEGMENT 3 - PACKAGE 2 - FORT ANN TO KINGSBURY** STA. 20000+00 TO STA. 20015+00 PLAN AND PROFILE

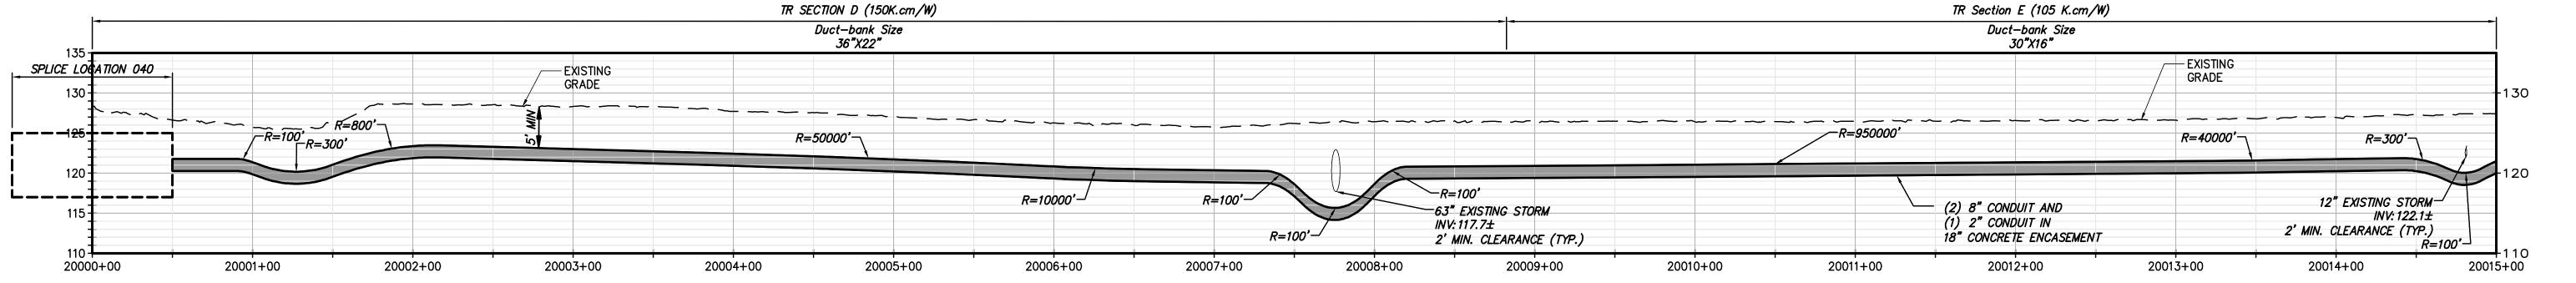KIEWIT PROJECT NO. 21162 CHA PROJECT NO. DRAWING NO.

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AS NOTED DATE X SH.NO. XXX OF XXX



STA. 20015+00 TO STA. 20030+00 PROFILE VIEW

SCALE: H: 1" = 50' V: 1" = 10'

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20024+00



20015+00

20016+00



20017+00

20018+00



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CHAMPLAIN HUDSON POWER EXPRESS SEGMENT 3 - PACKAGE 2 - FORT ANN TO KINGSBURY STA. 20015+00 TO STA. 20030+00 PLAN AND PROFILE

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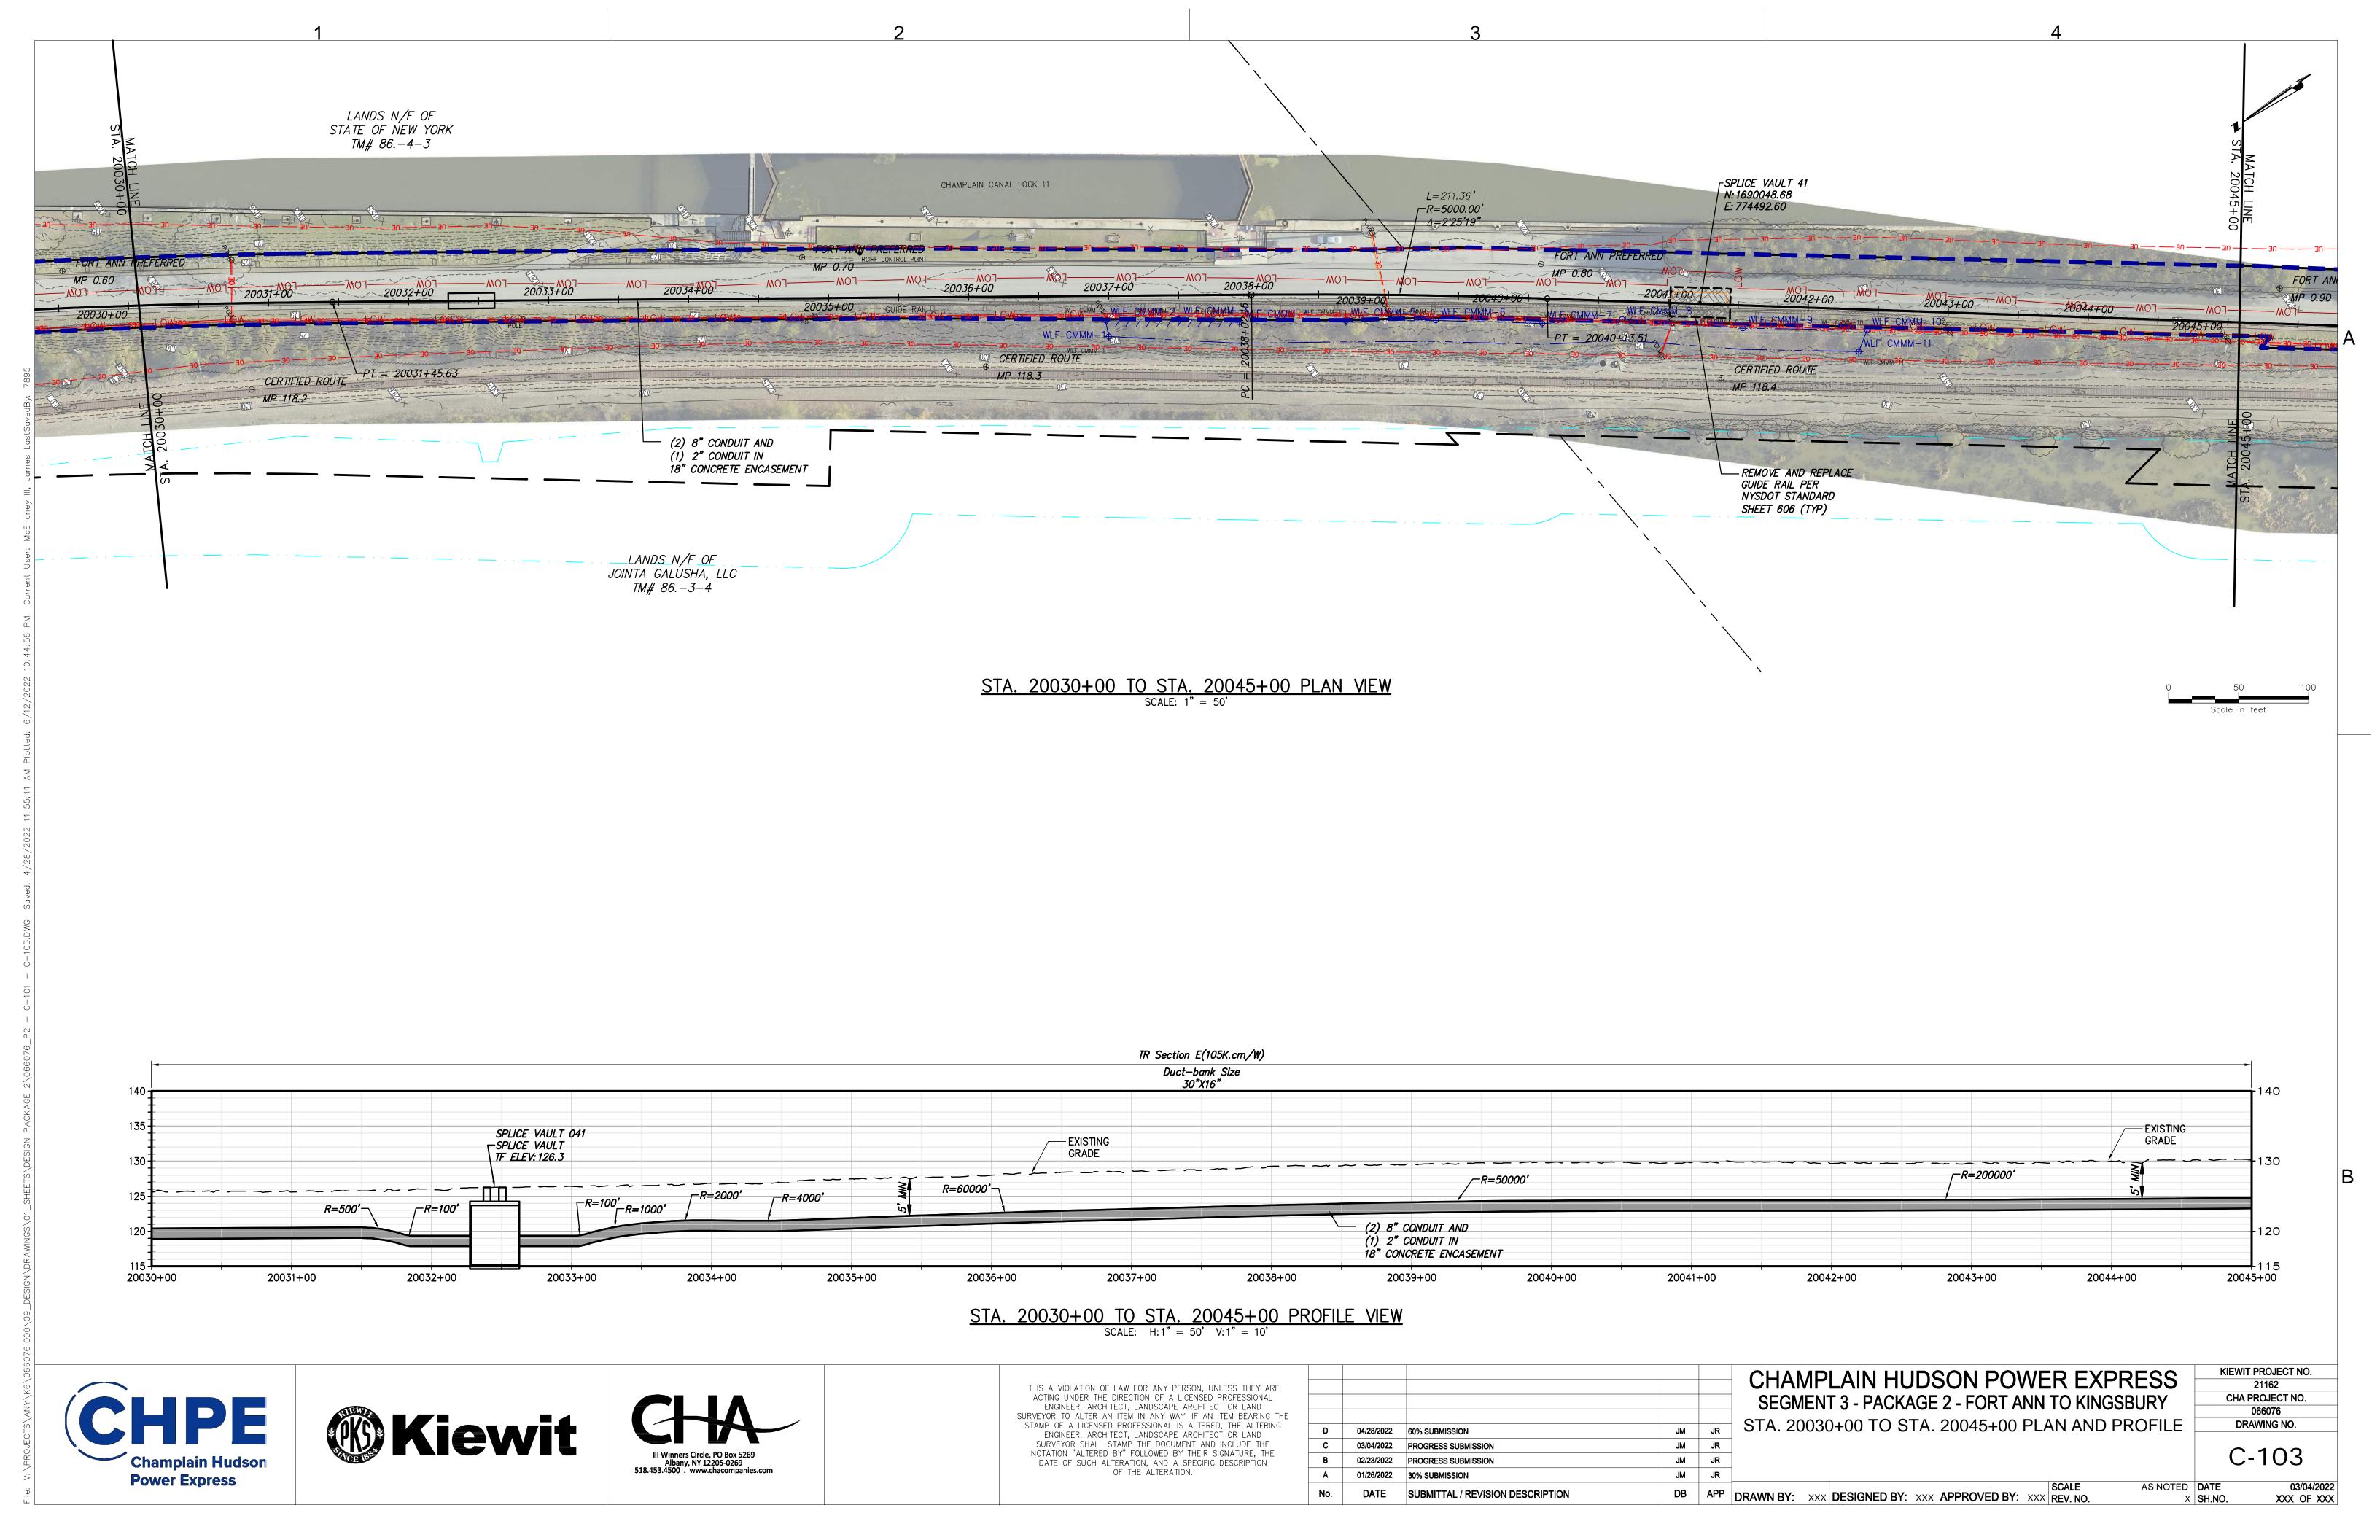
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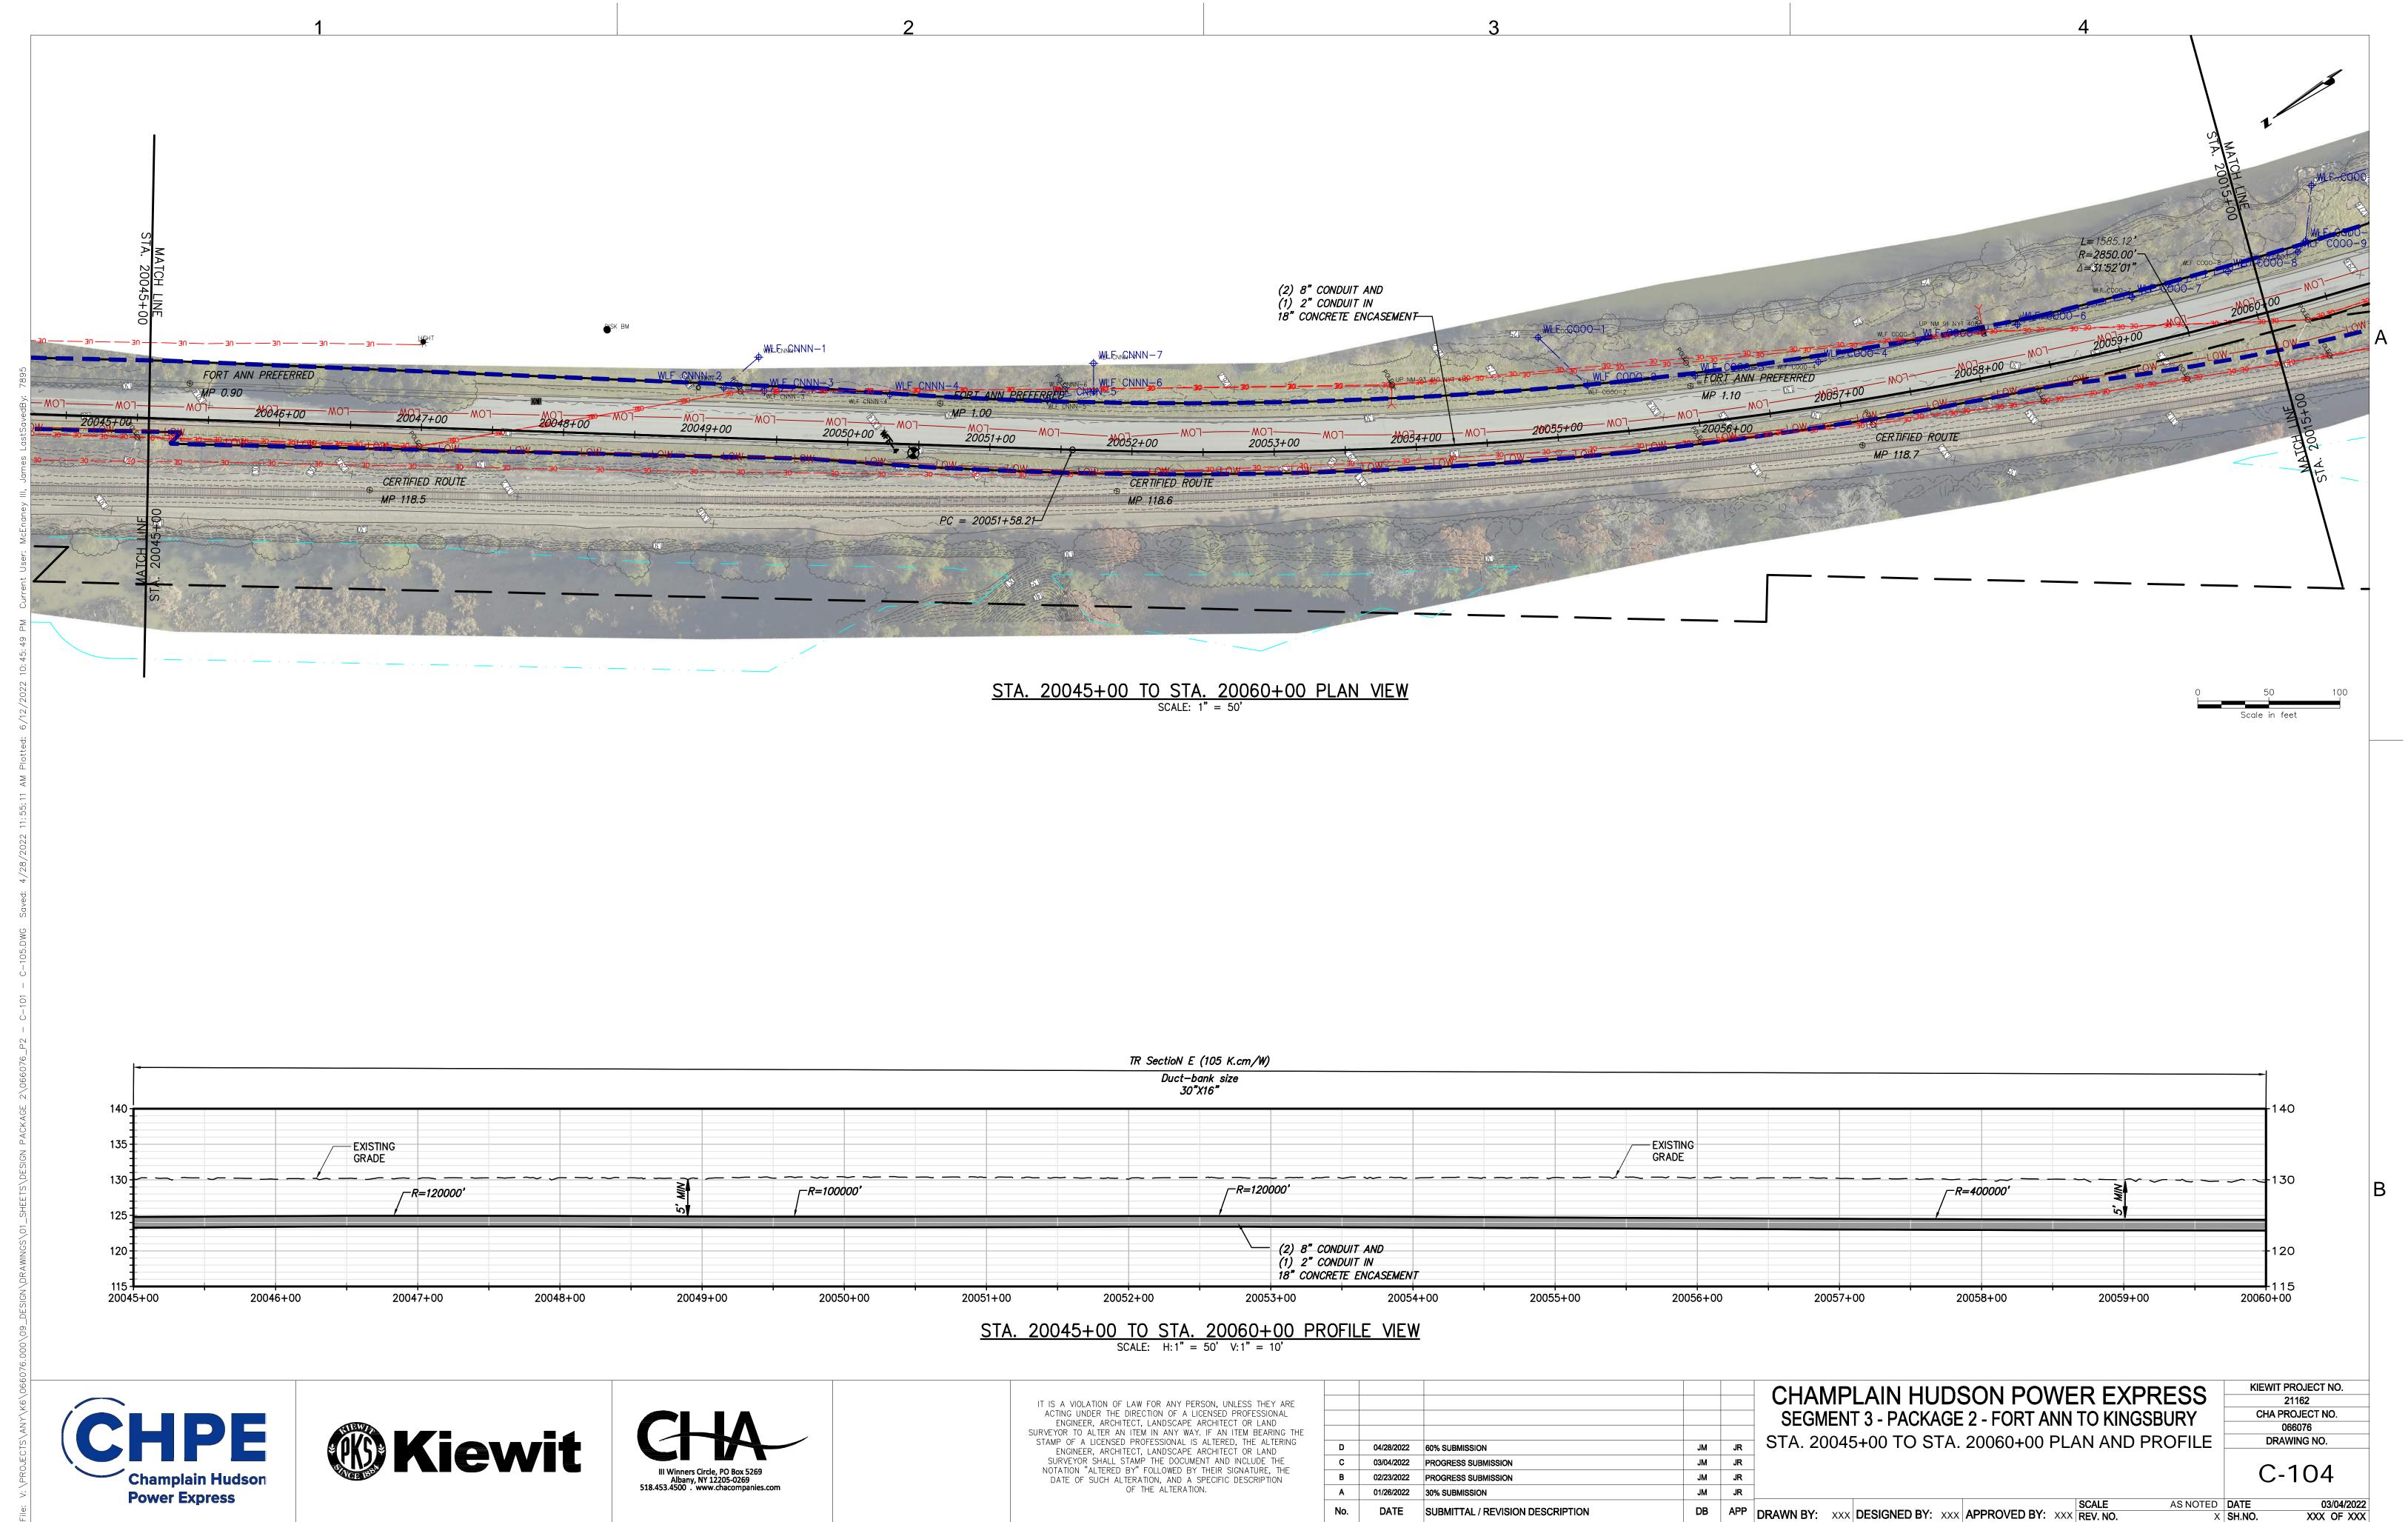
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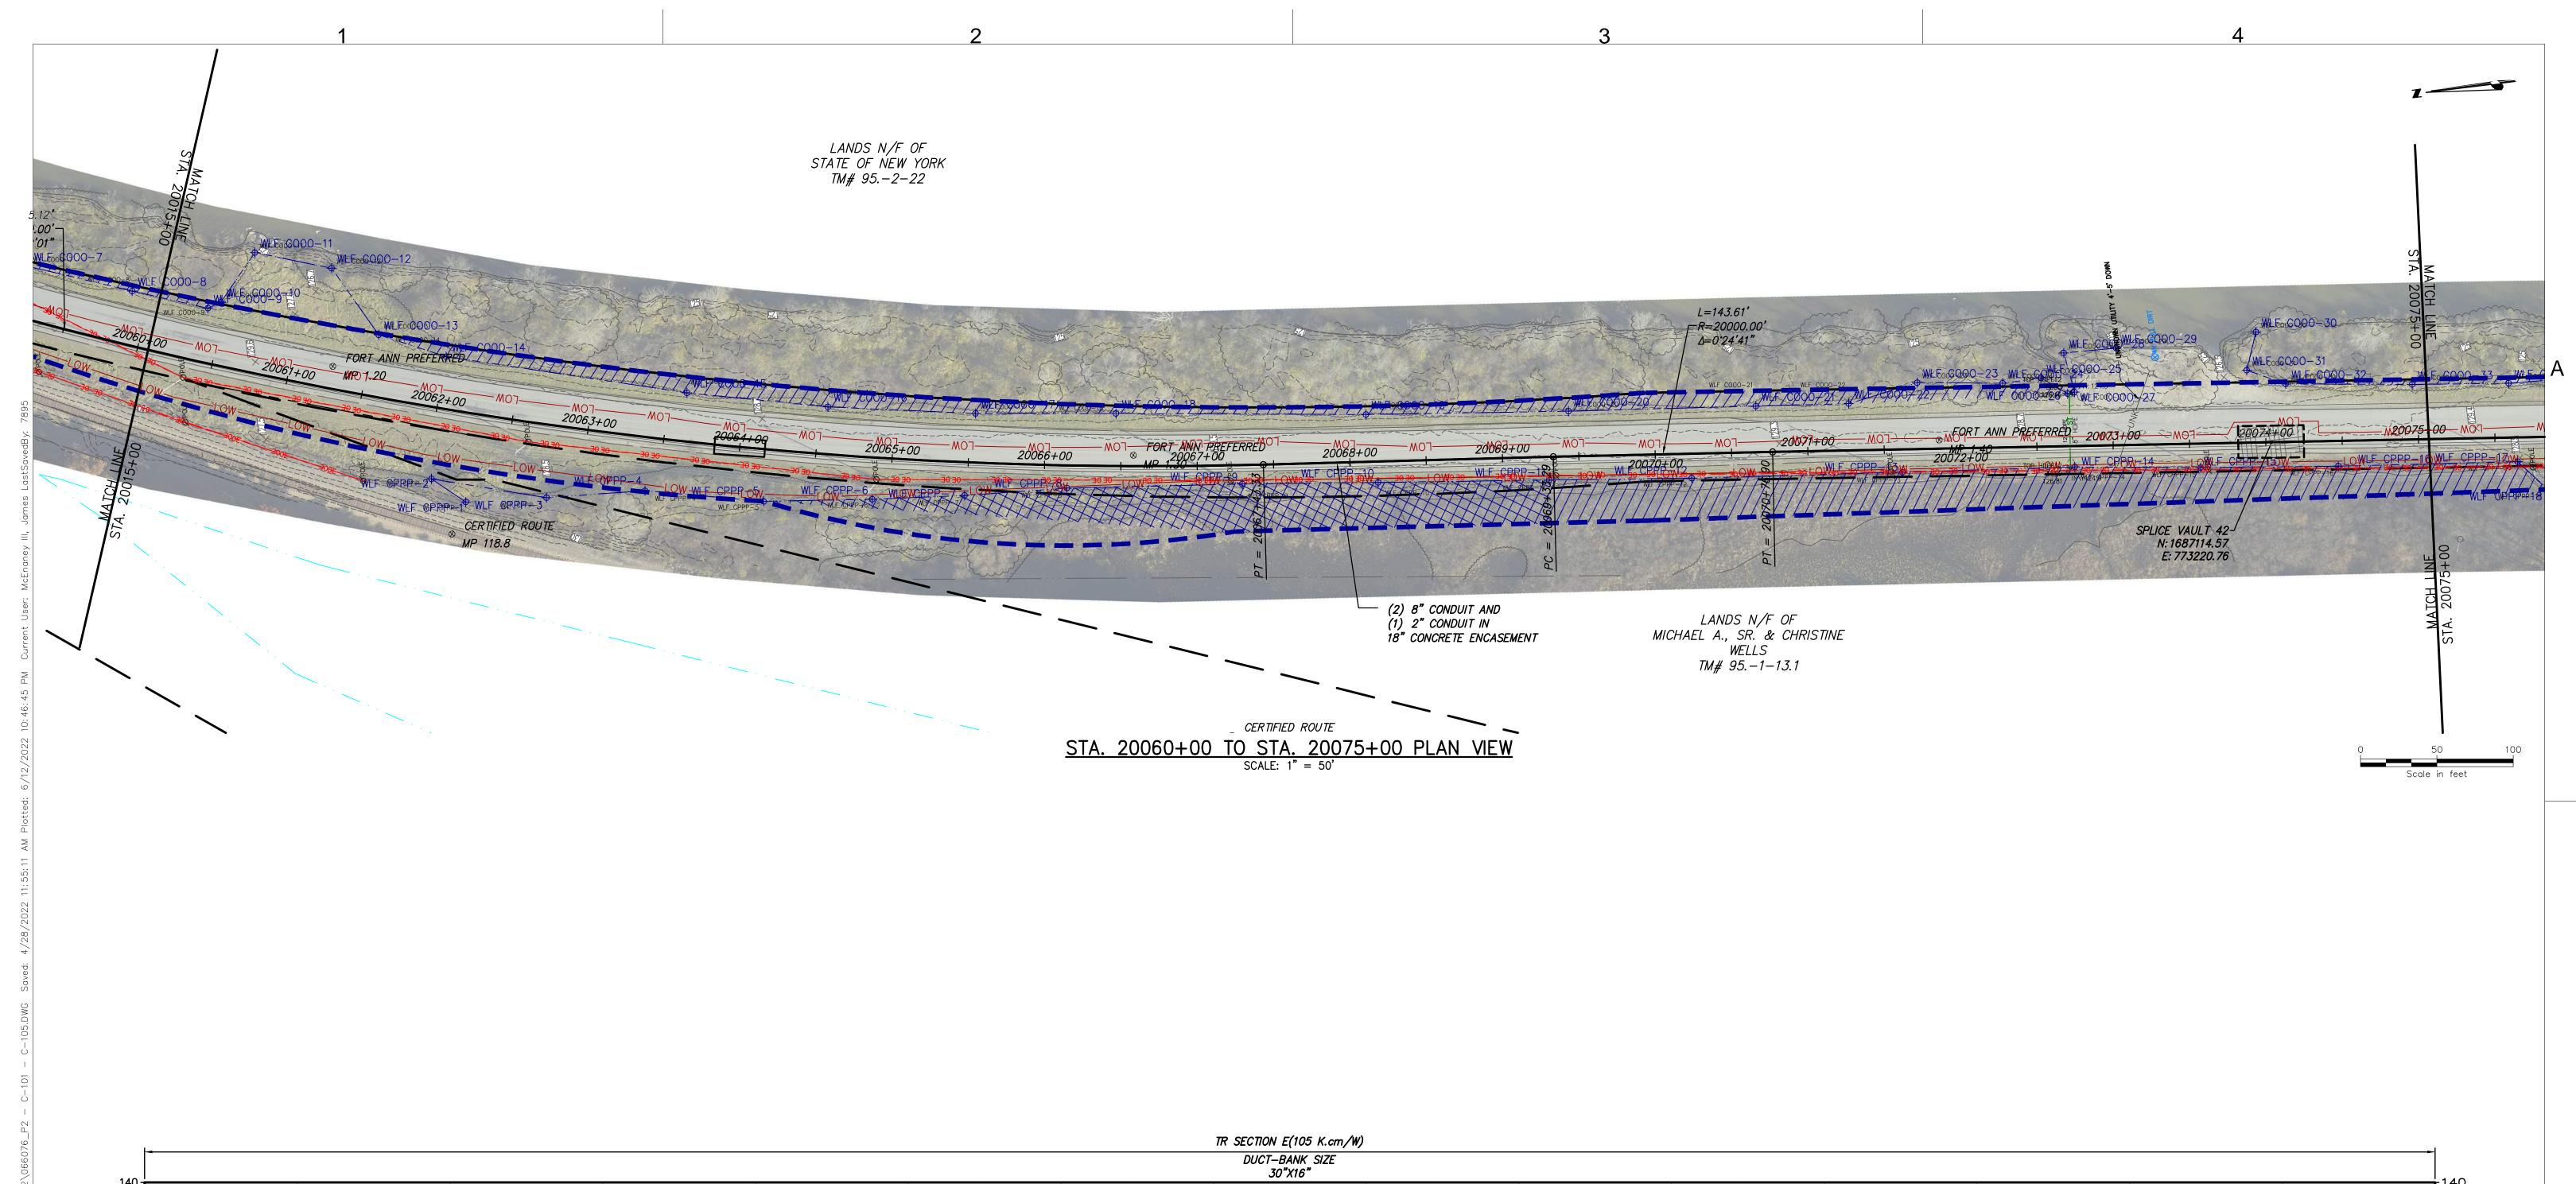
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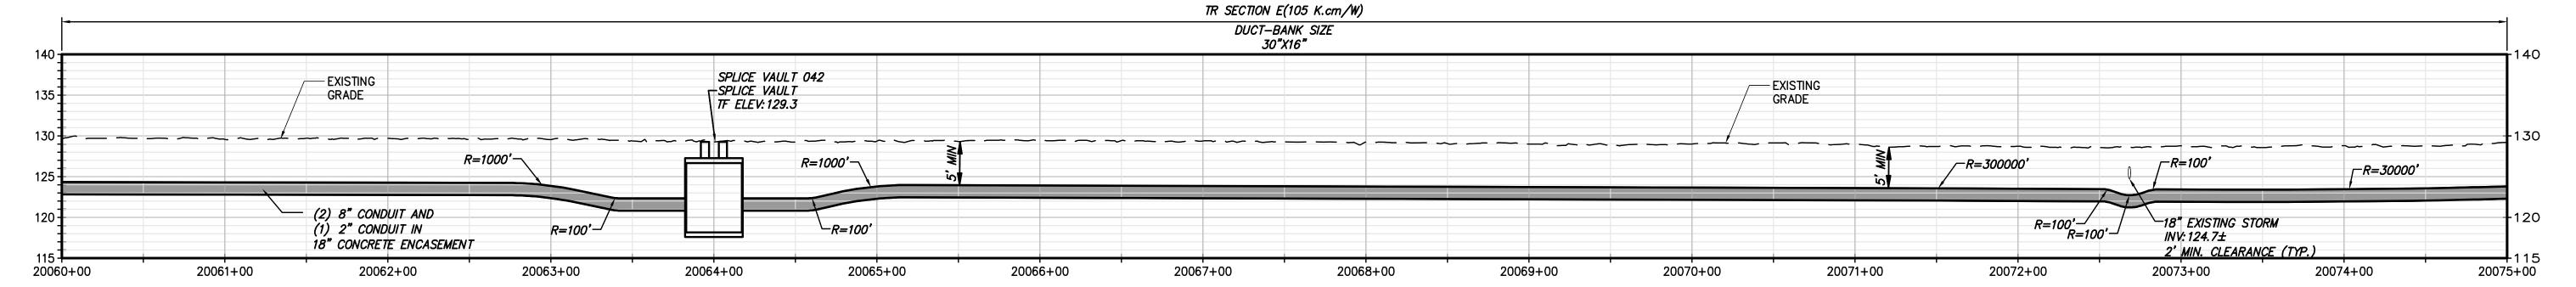




DATE SUBMITTAL / REVISION DESCRIPTION

X SH.NO.





# STA. 20060+00 TO STA. 20075+00 PROFILE VIEW SCALE: H: 1" = 50' V: 1" = 10'







IT IS A VIOLATION OF LAW FOR ANY PERSON, UNLESS THEY ARE
ACTING UNDER THE DIRECTION OF A LICENSED PROFESSIONAL
ENGINEER, ARCHITECT, LANDSCAPE ARCHITECT OR LAND
SURVEYOR TO ALTER AN ITEM IN ANY WAY. IF AN ITEM BEARING THE
STAMP OF A LICENSED PROFESSIONAL IS ALTERED, THE ALTERING
ENGINEER, ARCHITECT, LANDSCAPE ARCHITECT OR LAND
SURVEYOR SHALL STAMP THE DOCUMENT AND INCLUDE THE
NOTATION "ALTERED BY" FOLLOWED BY THEIR SIGNATURE, THE
DATE OF SUCH ALTERATION, AND A SPECIFIC DESCRIPTION
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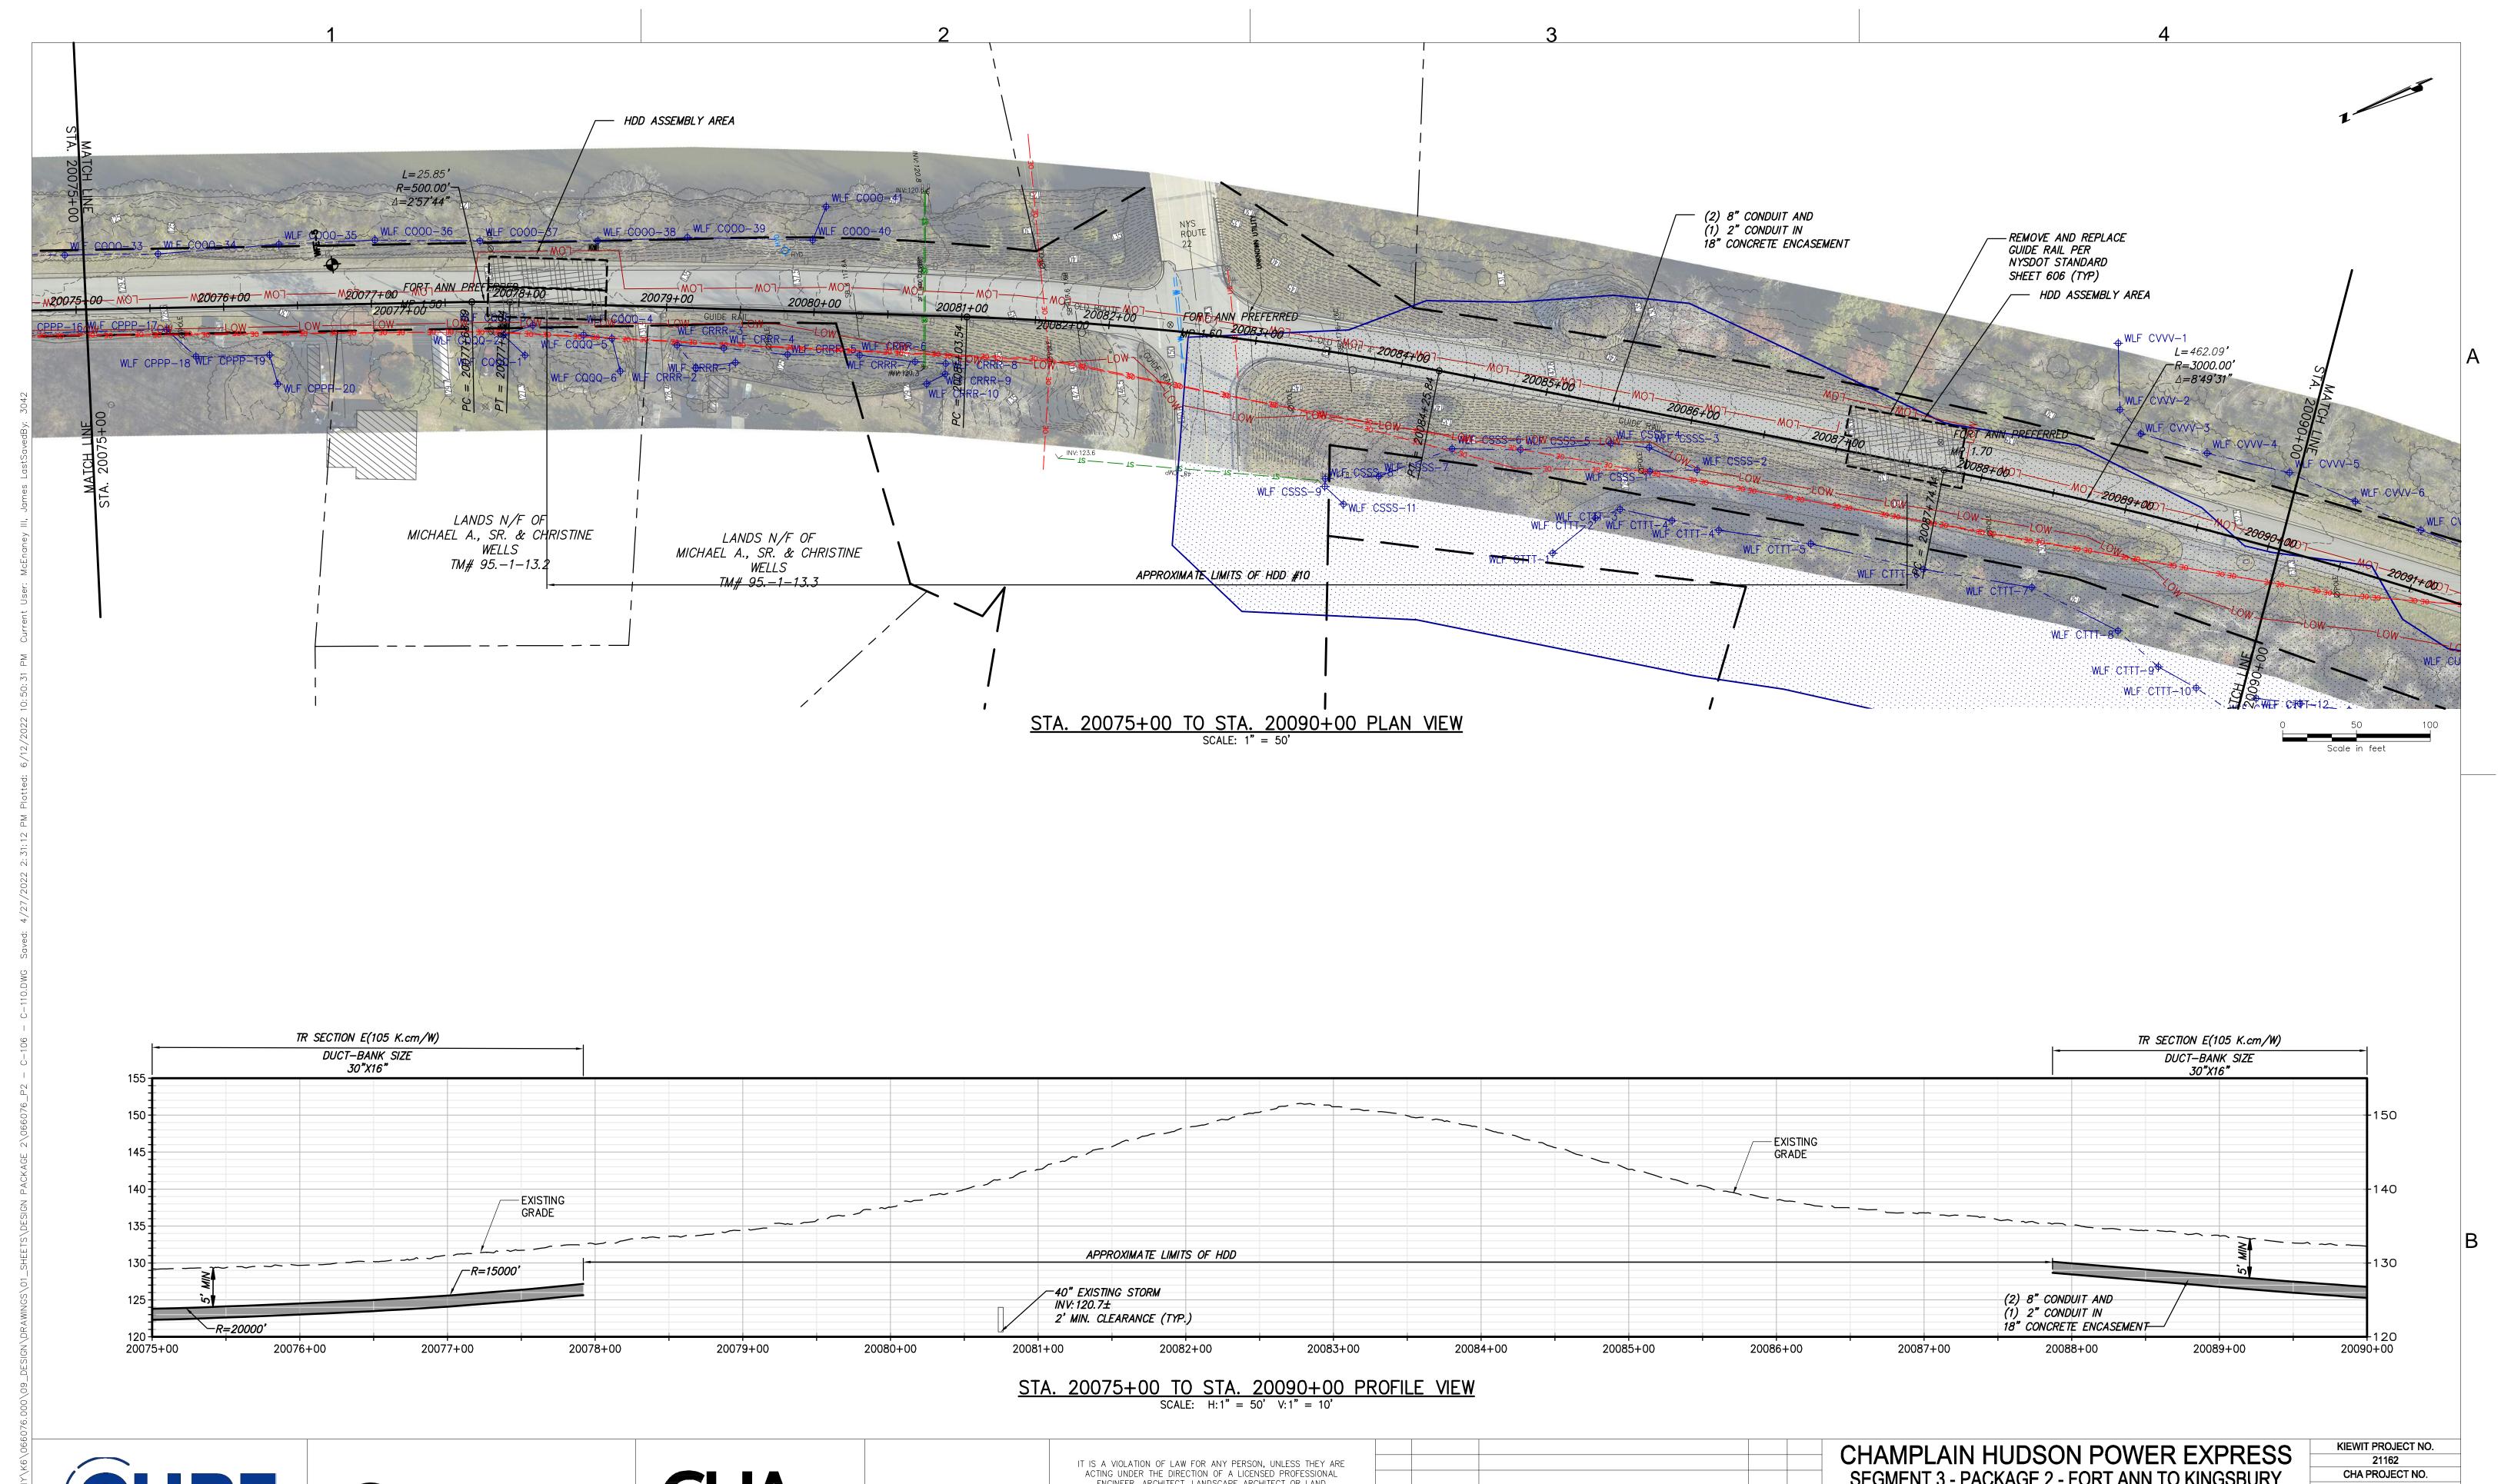
					CHAMPLAIN HUDSON POWER EX
					SEGMENT 3 - PACKAGE 2 - FORT ANN TO KIN
D	04/28/2022	60% SUBMISSION	JM	JR	STA. 20060+00 TO STA. 20075+00 PLAN AND
С	03/04/2022	PROGRESS SUBMISSION	JM	JR	
В	02/23/2022	PROGRESS SUBMISSION	JM	JR	
Α	01/26/2022	30% SUBMISSION	JM	JR	
No.	DATE	SUBMITTAL / REVISION DESCRIPTION	DB	APP	DRAWN BY: XXX DESIGNED BY: XXX APPROVED BY: XXX REV. NO.

CHAMPLAIN HUDSON POWER EXPRESS				
SEGMENT 3 - PACKAGE 2 - FORT ANN TO KINGSBURY				
STA. 20060+00 TO STA. 20075+00 PLAN AND PROFILE				

KIEWIT PROJECT NO.
21162
CHA PROJECT NO.
066076
DRAWING NO.

C-105

AS NOTED DATE 03/04/2022 XXX OF XXX









ENGINEER, ARCHITECT, LANDSCAPE ARCHITECT OR LAND SURVEYOR TO ALTER AN ITEM IN ANY WAY. IF AN ITEM BEARING THE STAMP OF A LICENSED PROFESSIONAL IS ALTERED, THE ALTERING ENGINEER, ARCHITECT, LANDSCAPE ARCHITECT OR LAND SURVEYOR SHALL STAMP THE DOCUMENT AND INCLUDE THE NOTATION "ALTERED BY" FOLLOWED BY THEIR SIGNATURE, THE DATE OF SUCH ALTERATION, AND A SPECIFIC DESCRIPTION
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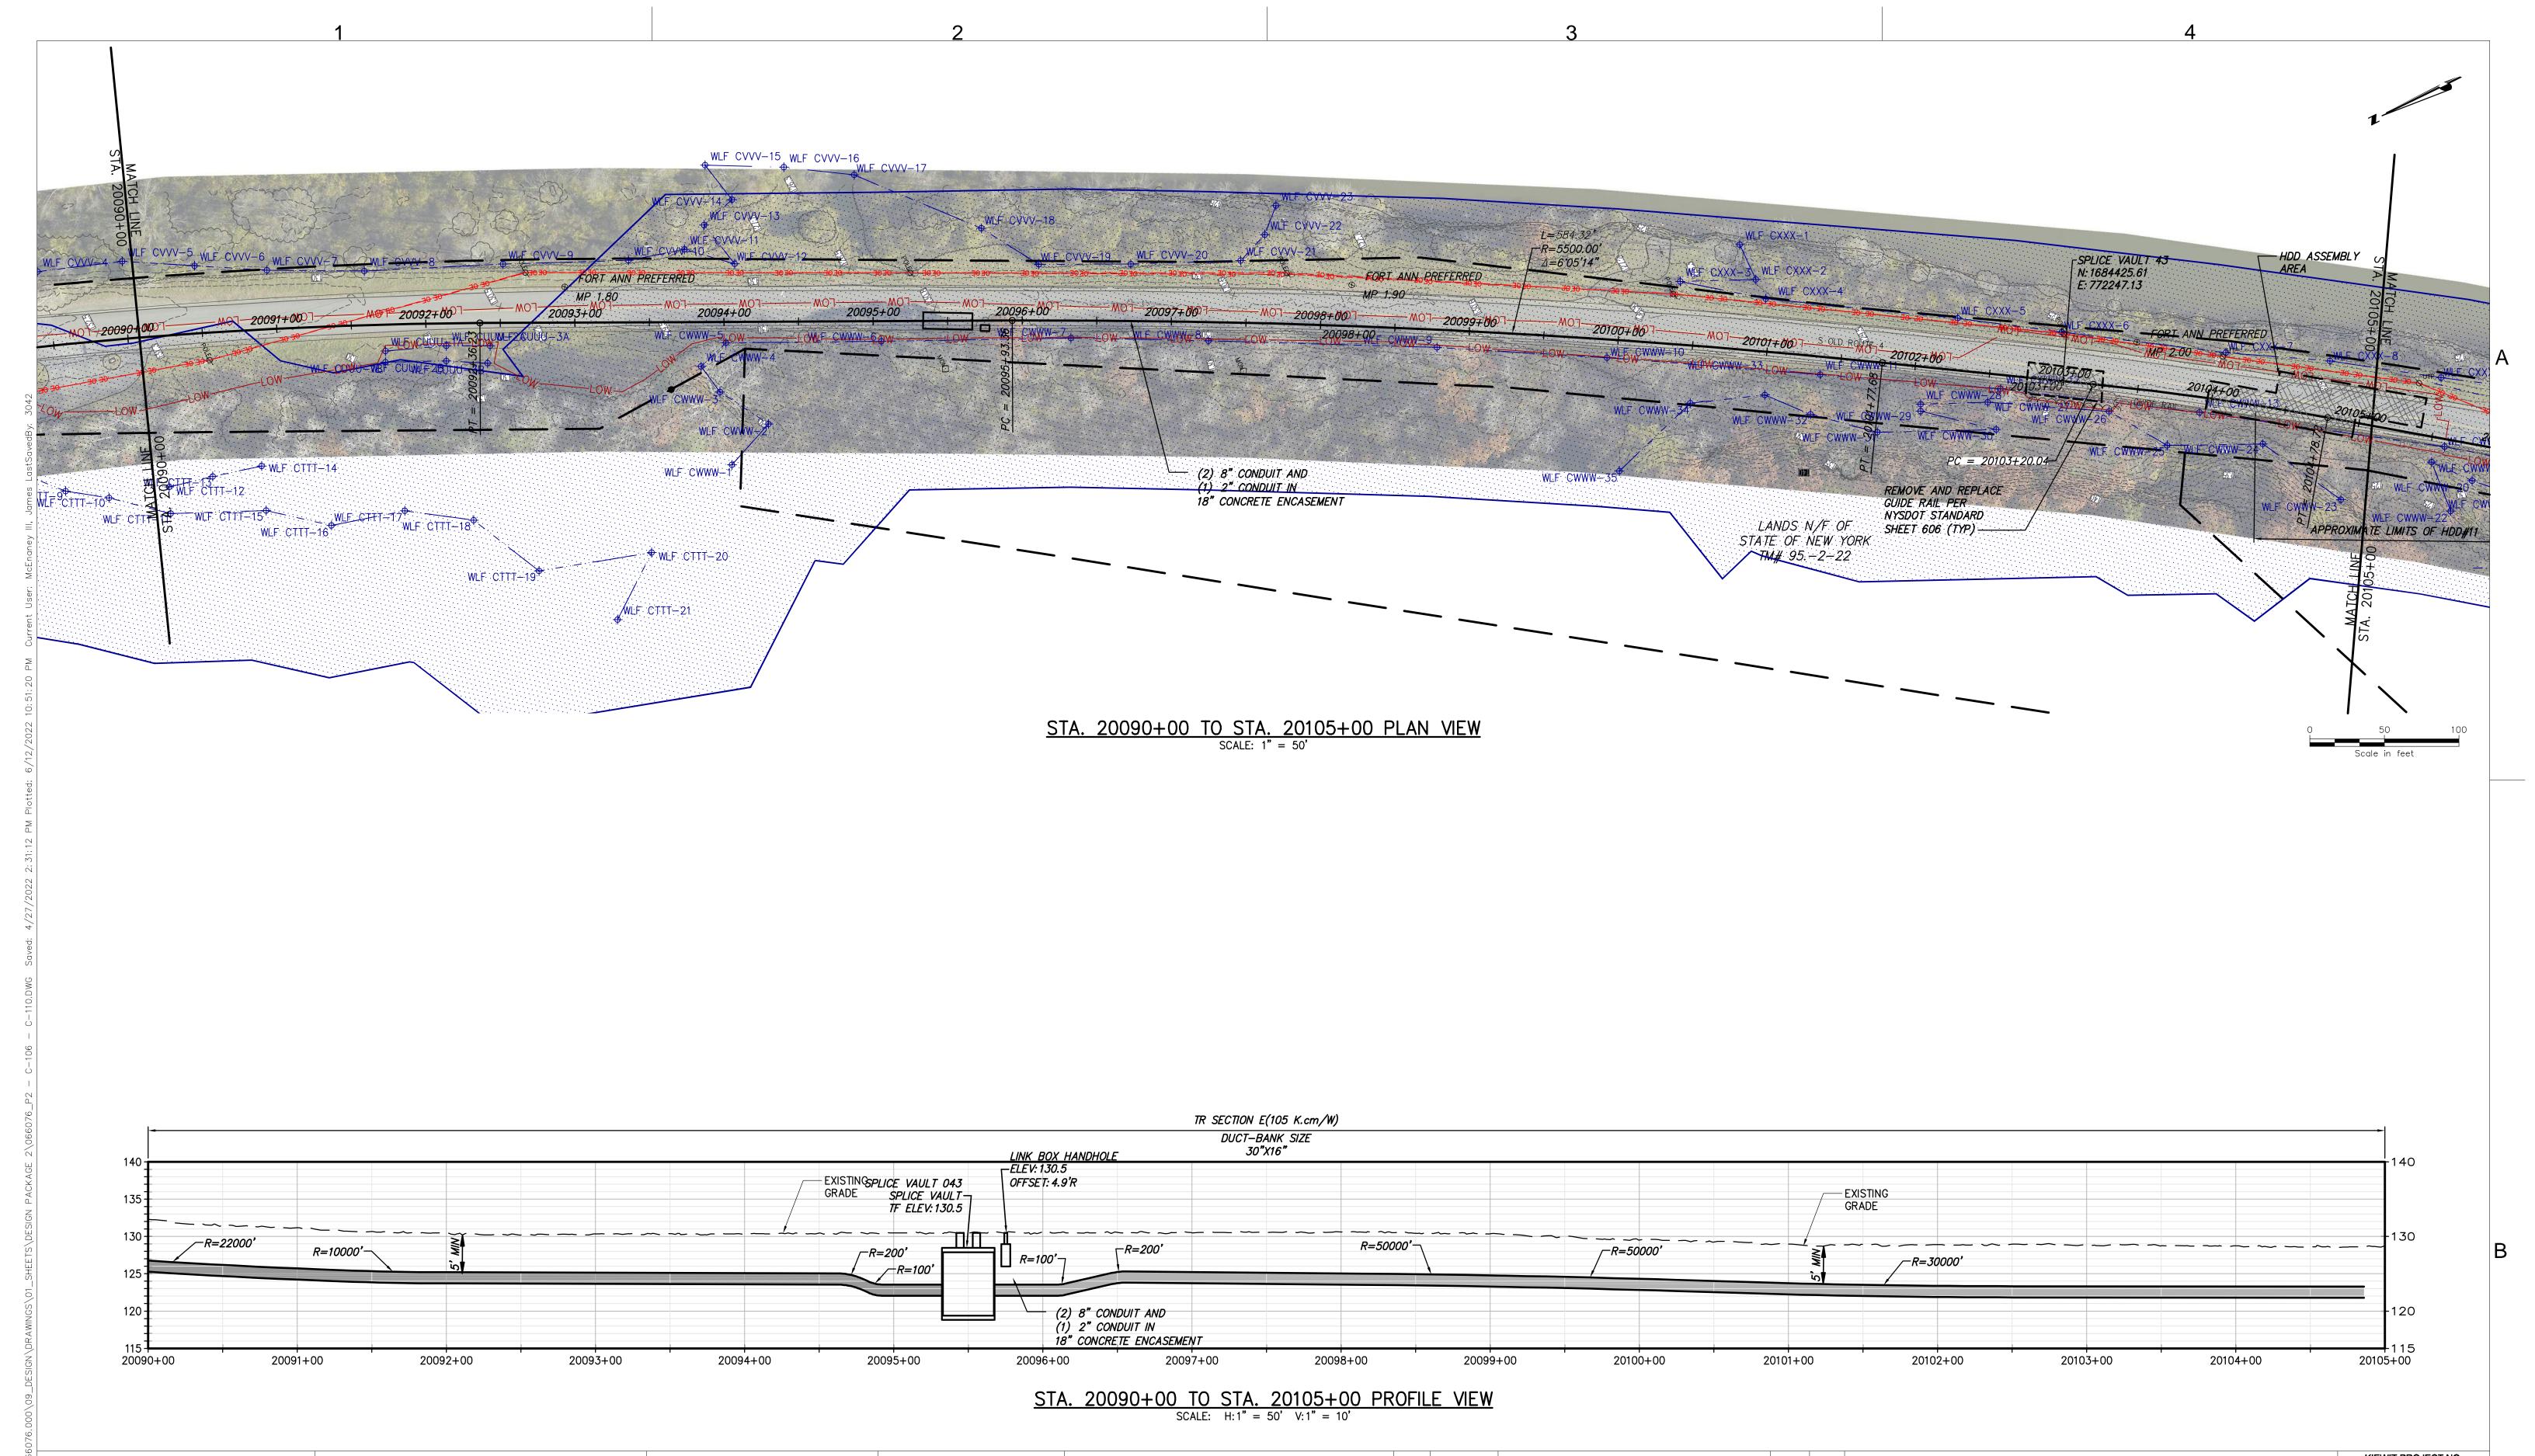
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	В	02/23/2022	PROGRESS SUBMISSION	JM	JR	
	Α	01/26/2022	30% SUBMISSION	JM	JR	
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SEGMENT 3 - PACKAGE 2 - FORT ANN TO KINGSBURY STA. 20075+00 TO STA. 20090+00 PLAN AND PROFILE

066076 DRAWING NO.

C-106

AS NOTED DATE









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В	02/23/2022	PROGRESS SUBMISSION	JM	JR	
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CHAMPLAIN HUDSON POWER EXPRESS SEGMENT 3 - PACKAGE 2 - FORT ANN TO KINGSBURY STA. 20090+00 TO STA. 20105+00 PLAN AND PROFILE

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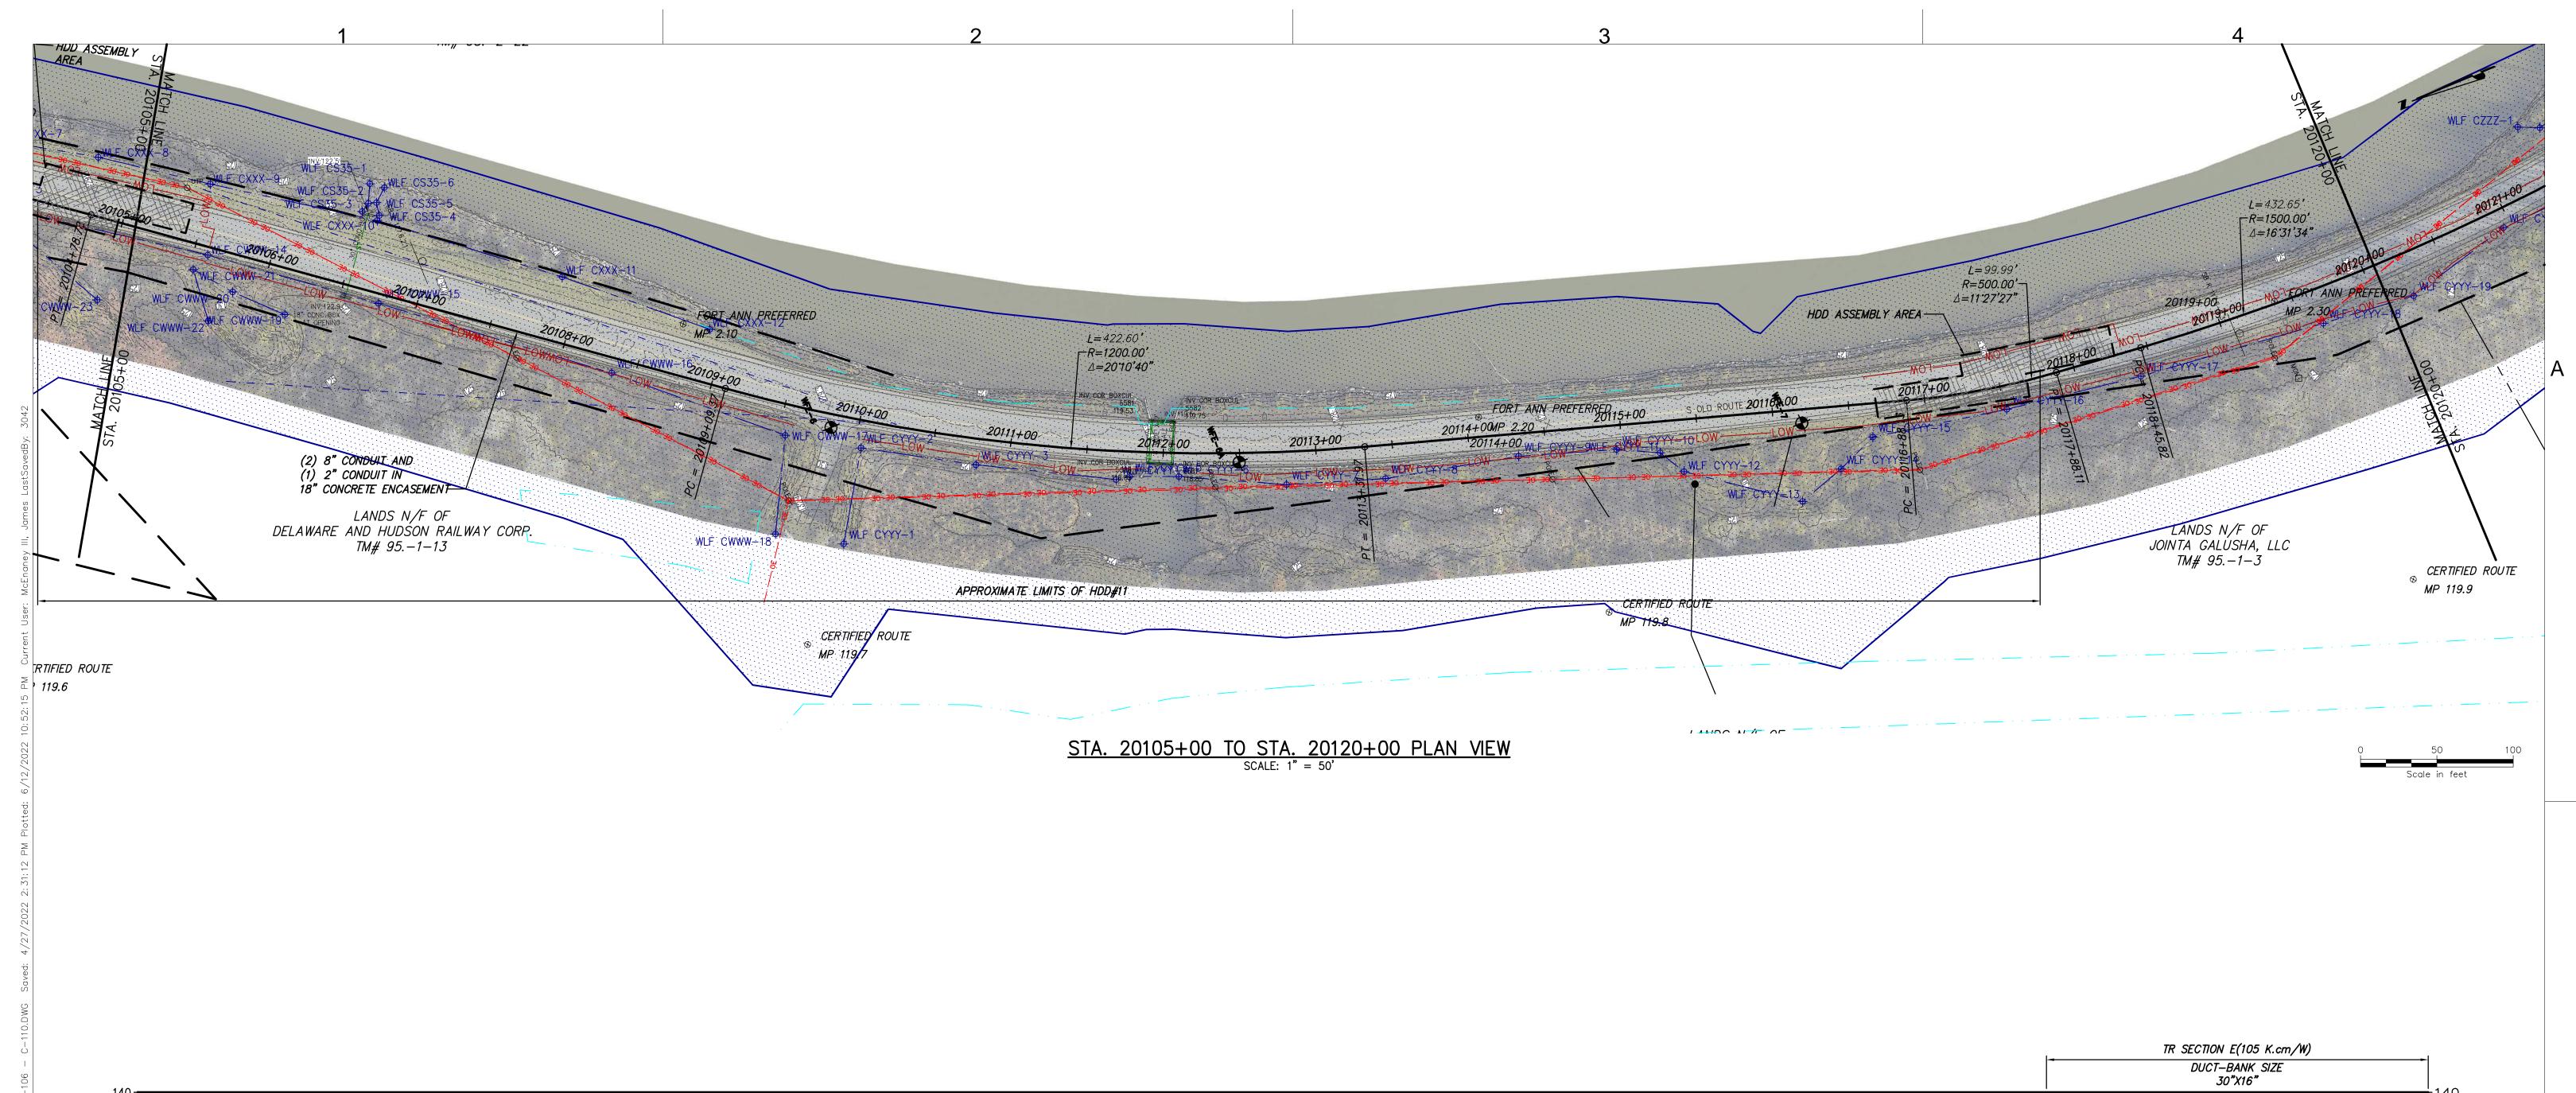
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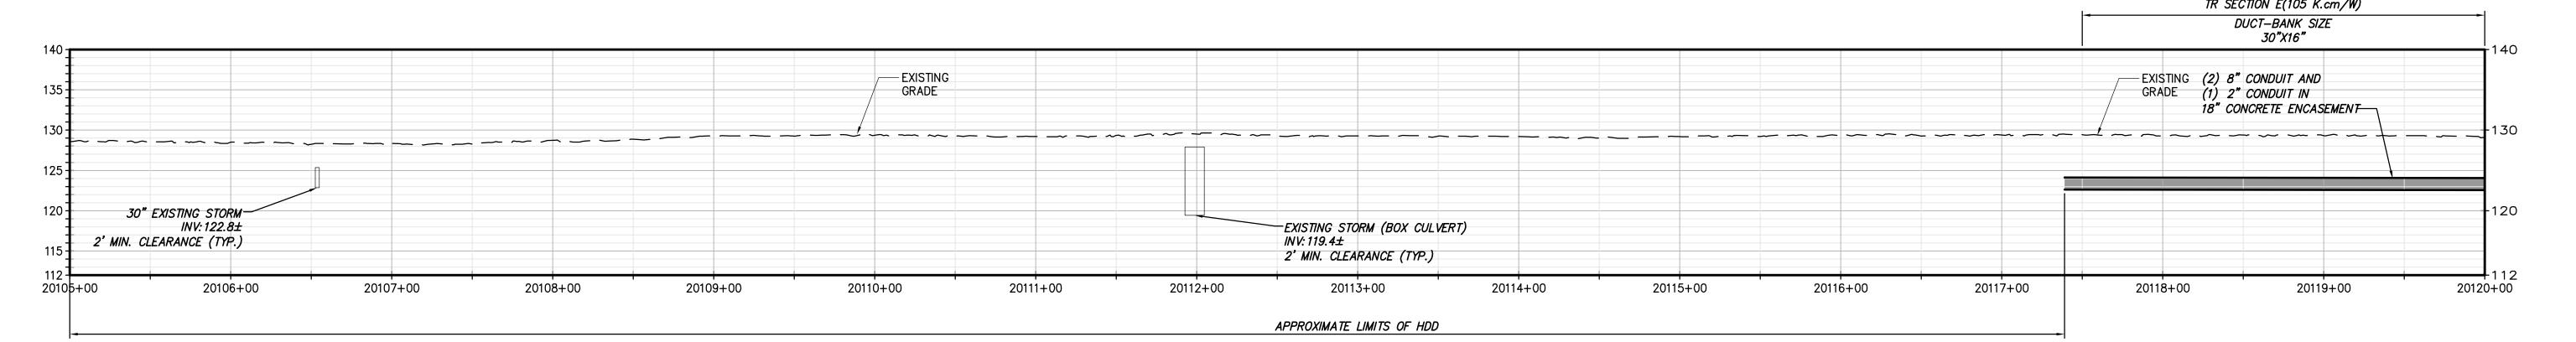
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RAWN BY: XXX DESIGNED BY: XXX APPROVED BY: XXX SAPROVED BY: XXX OF XXX





# STA. 20105+00 TO STA. 20120+00 PROFILE VIEW SCALE: H: 1" = 50' V: 1" = 10'







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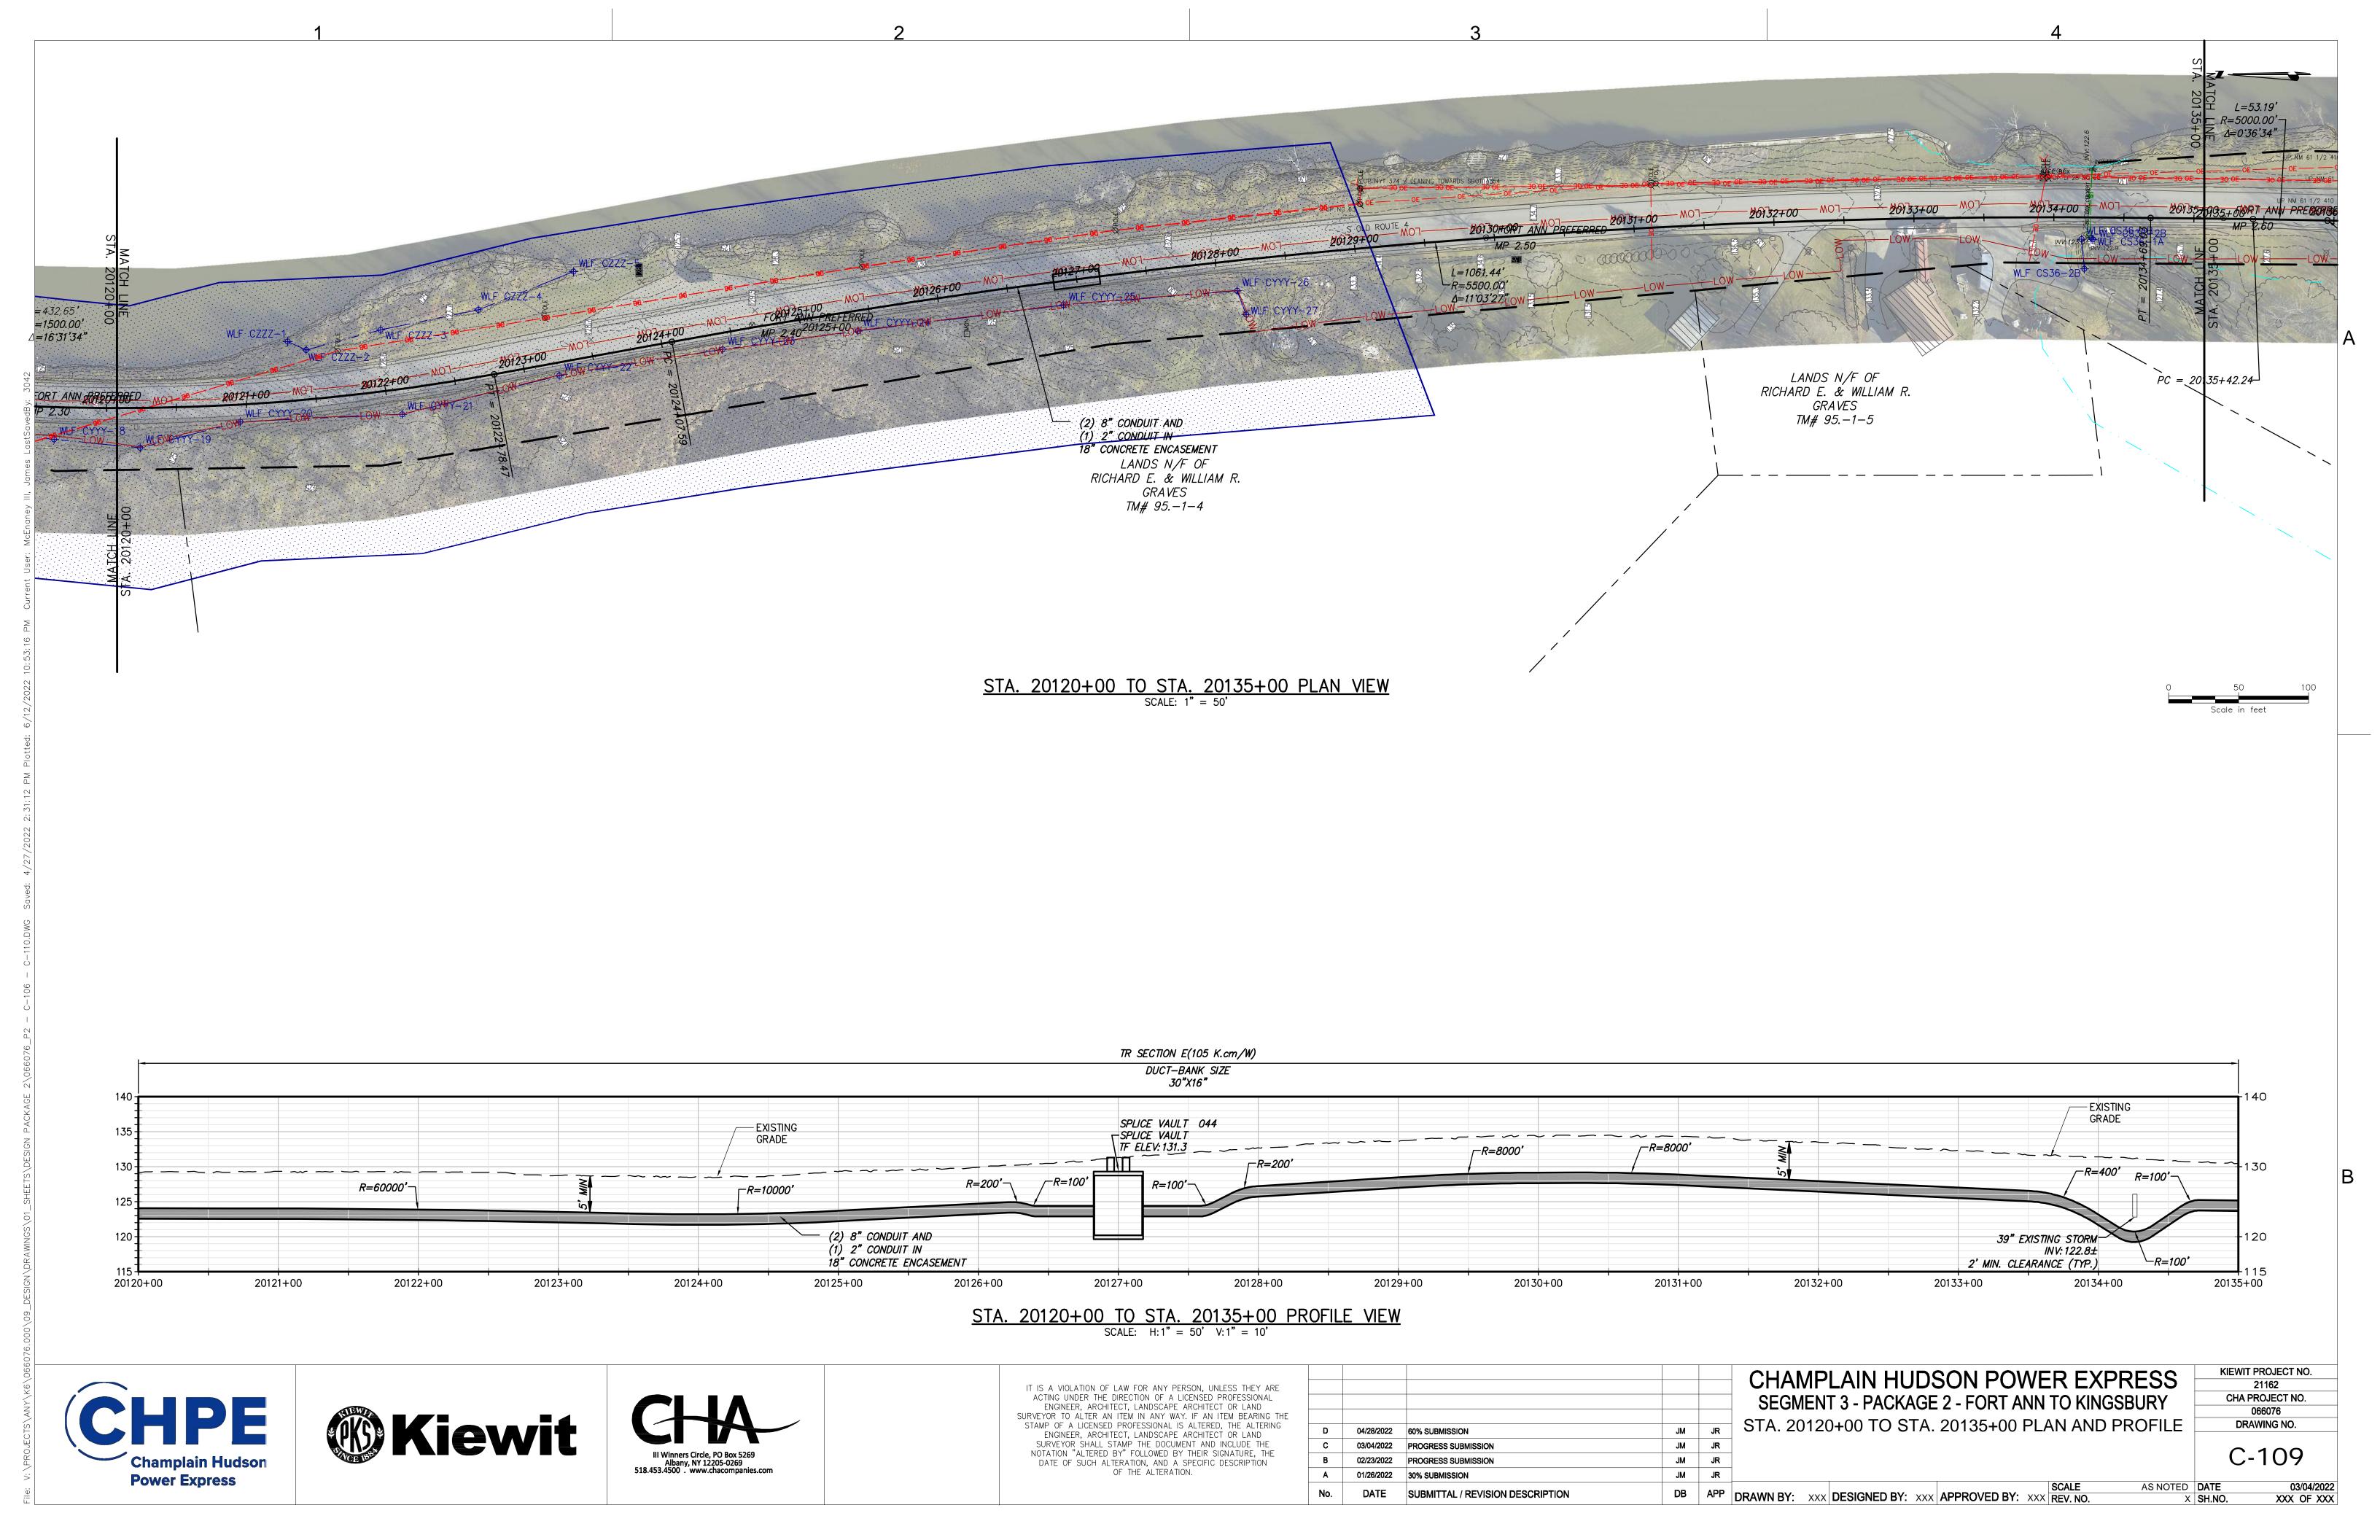
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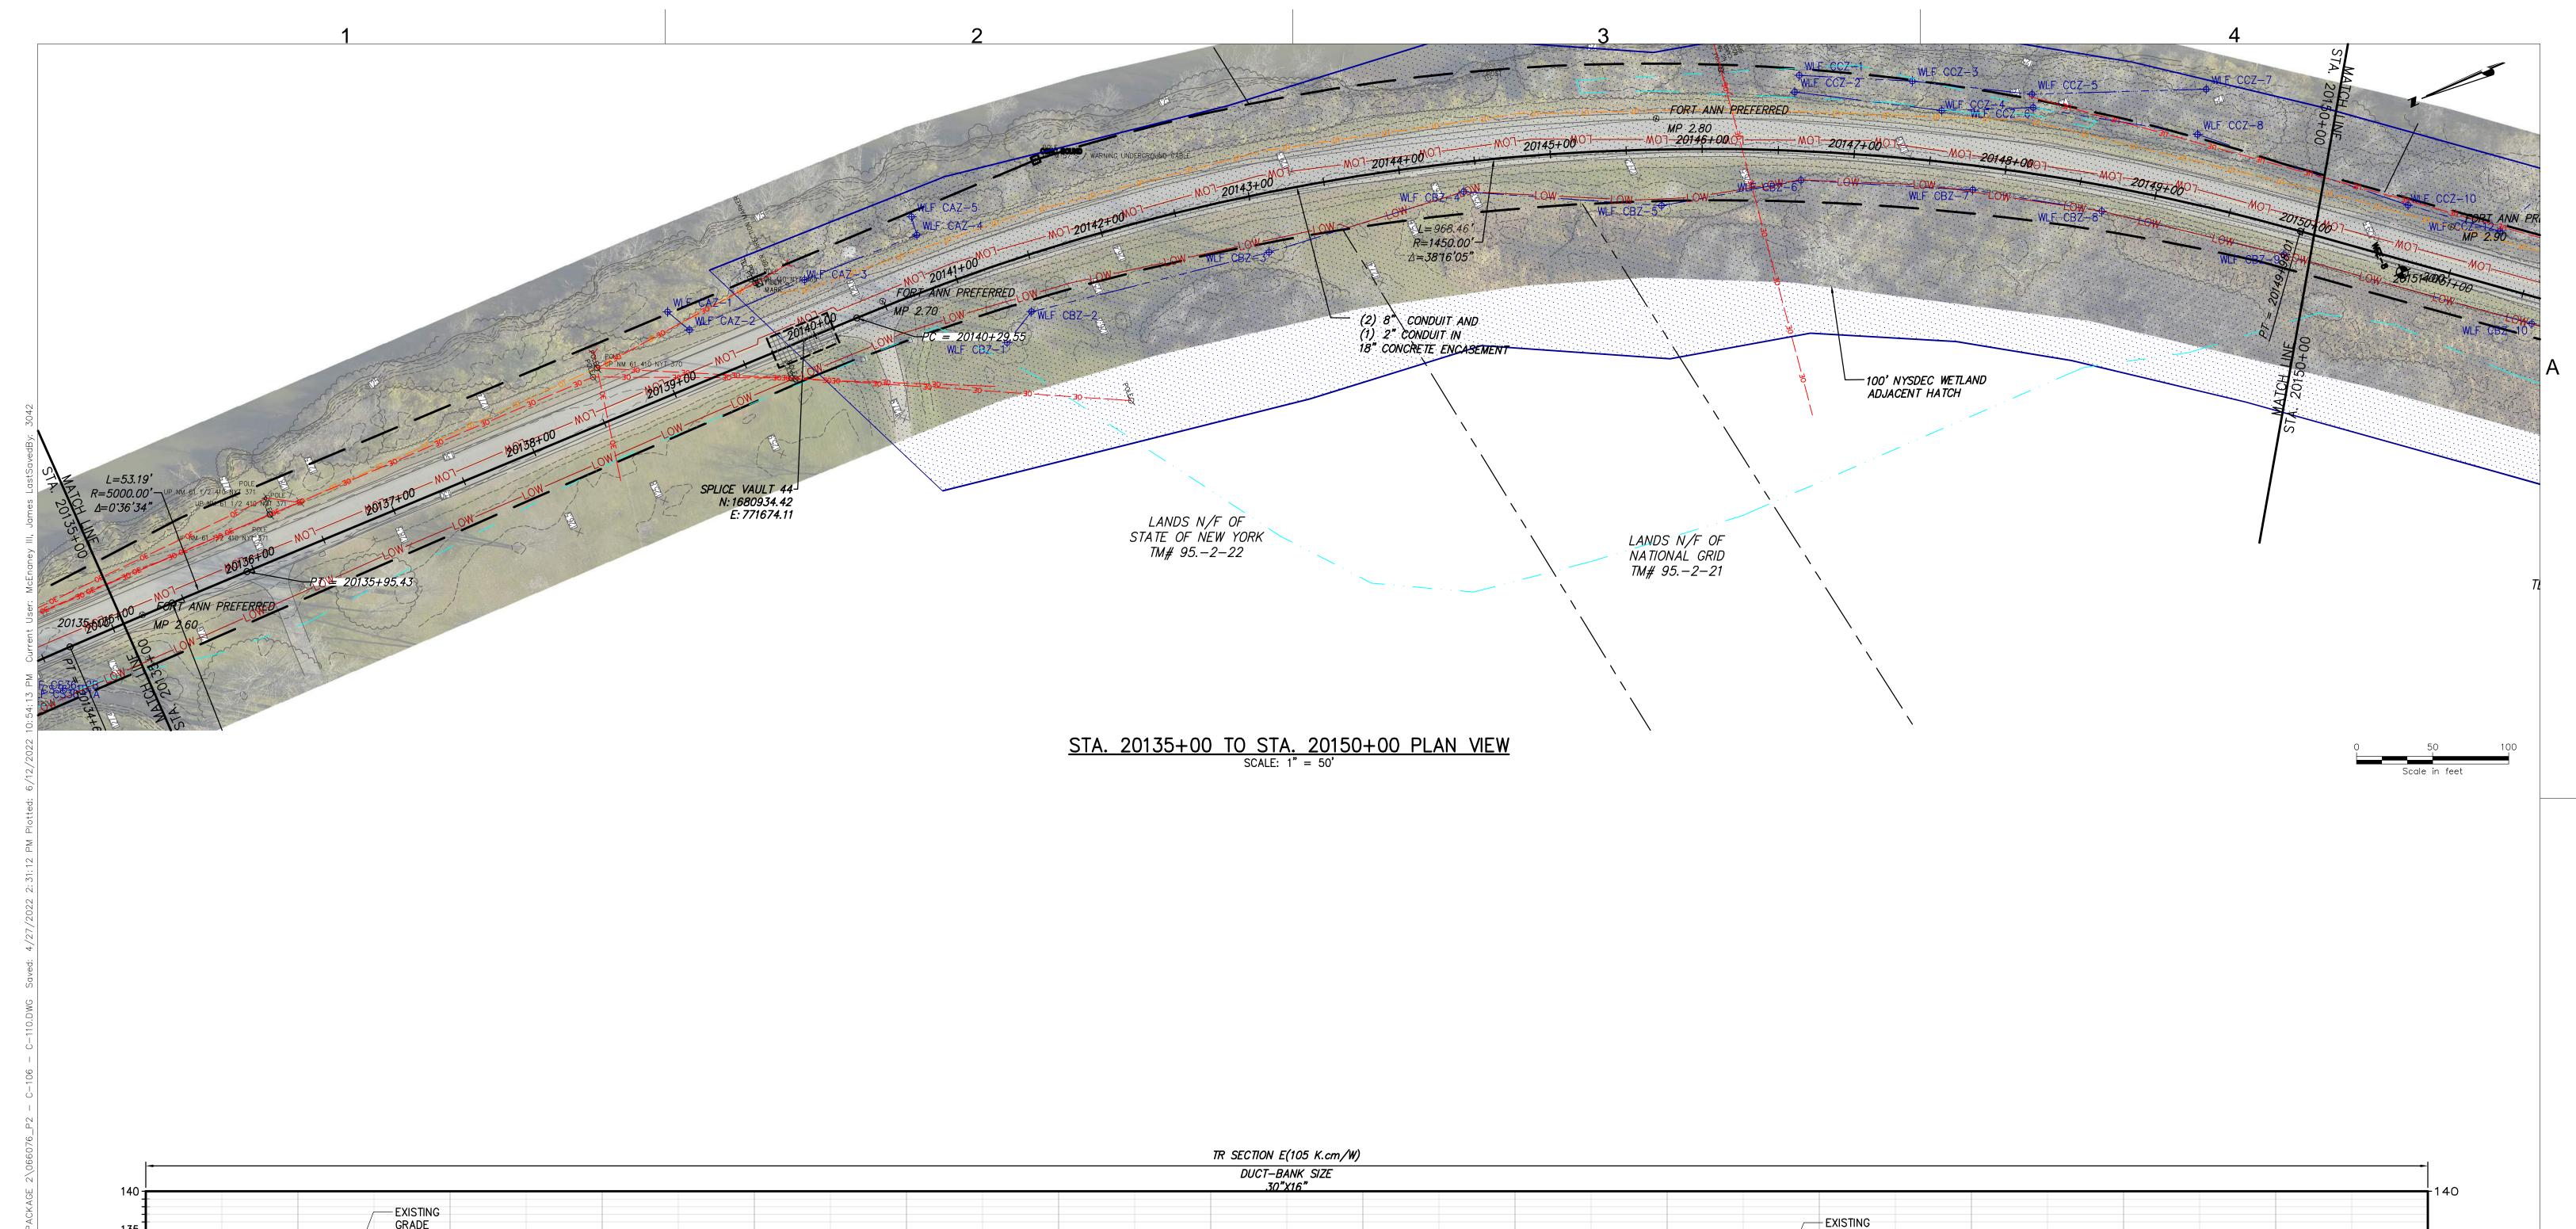
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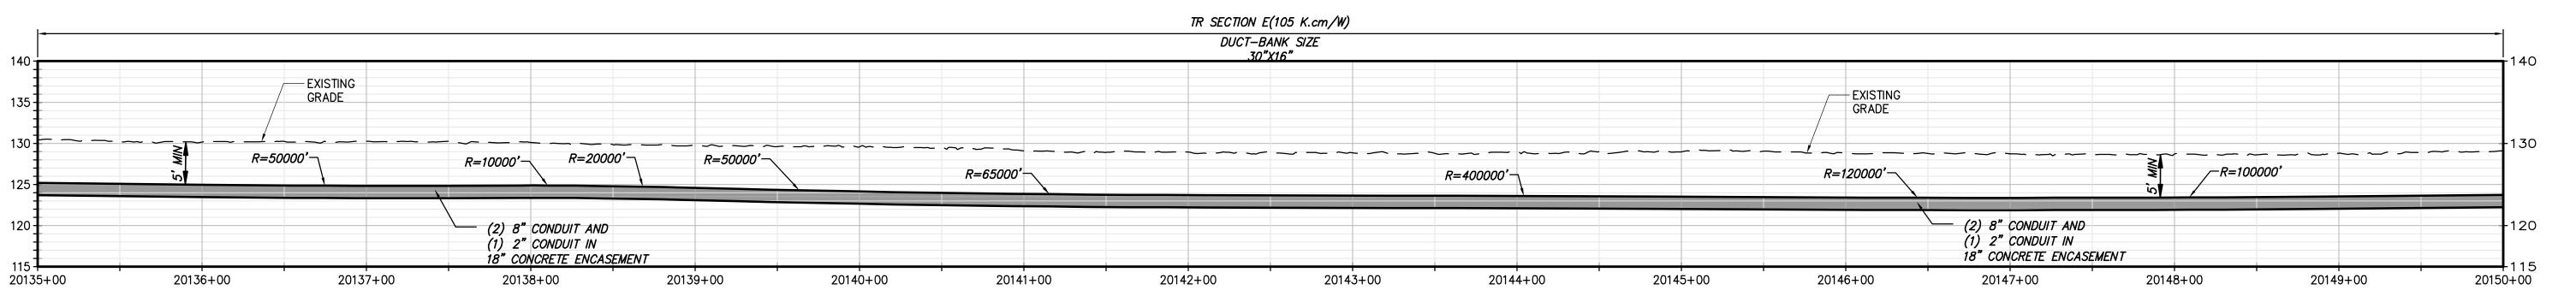
C-108

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RAWN BY: XXX DESIGNED BY: XXX APPROVED BY: XXX REV. NO. XXX OF XXX







STA. 20135+00 TO STA. 20150+00 PROFILE VIEW

SCALE: H: 1" = 50' V: 1" = 10'







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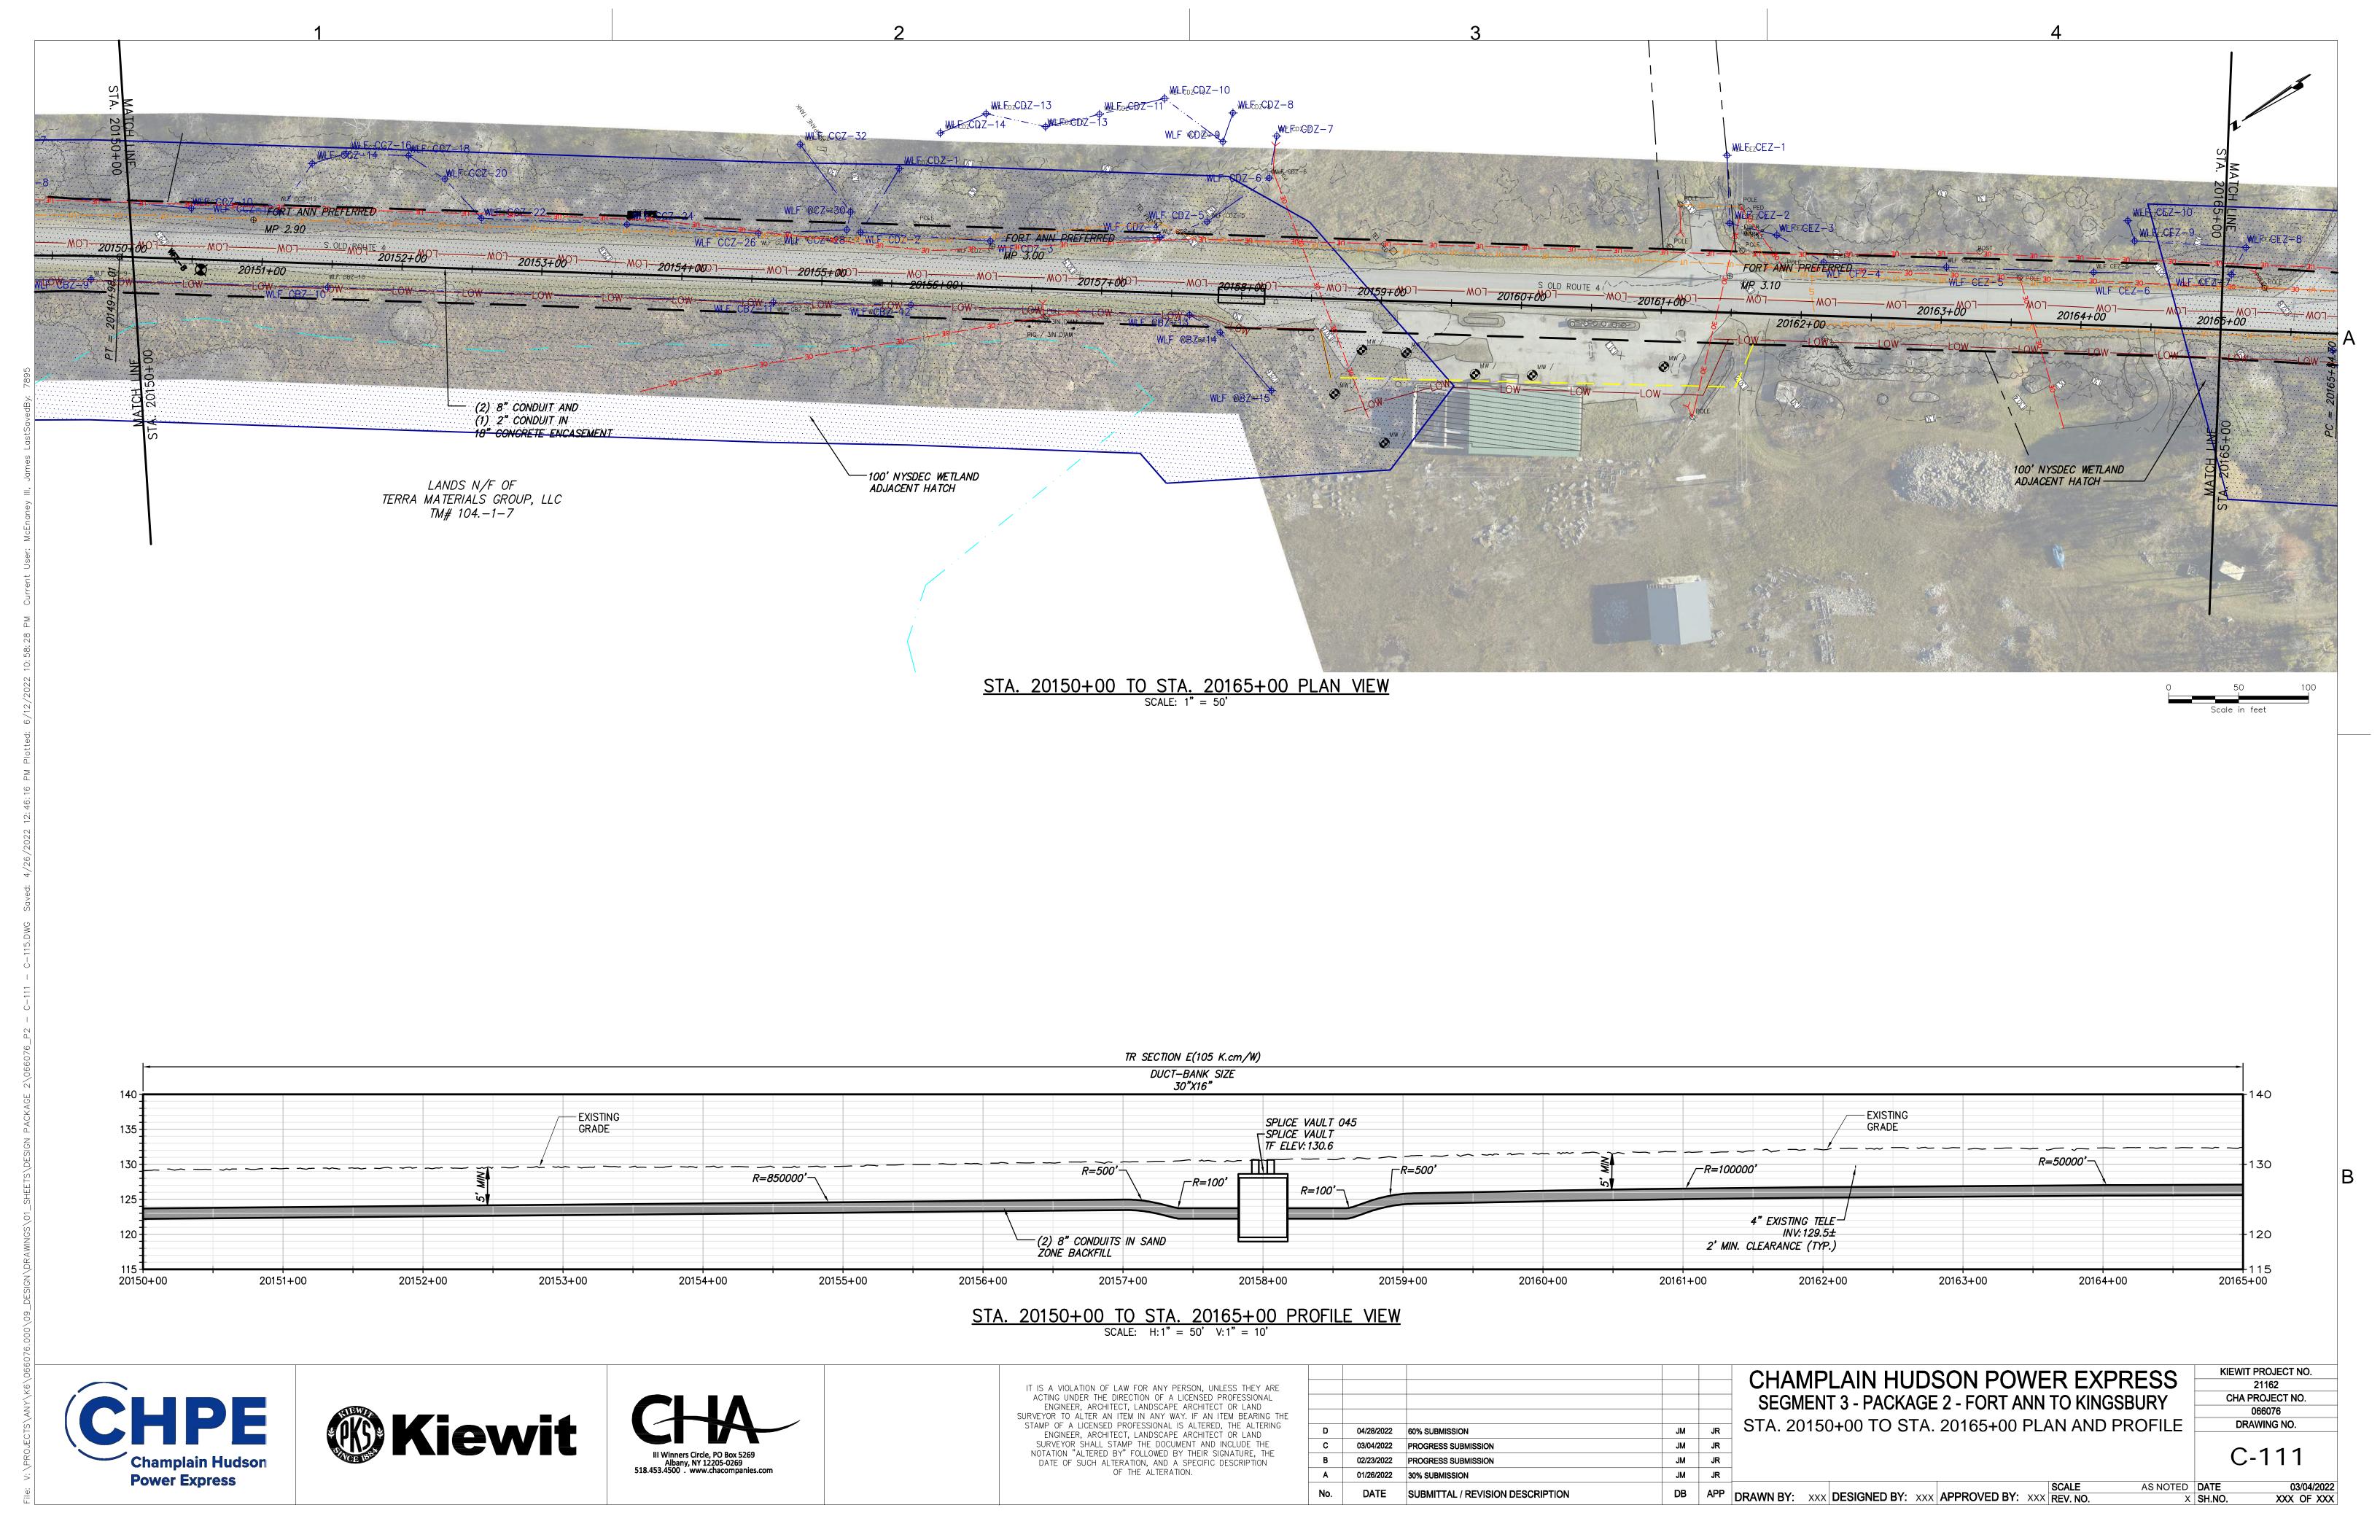
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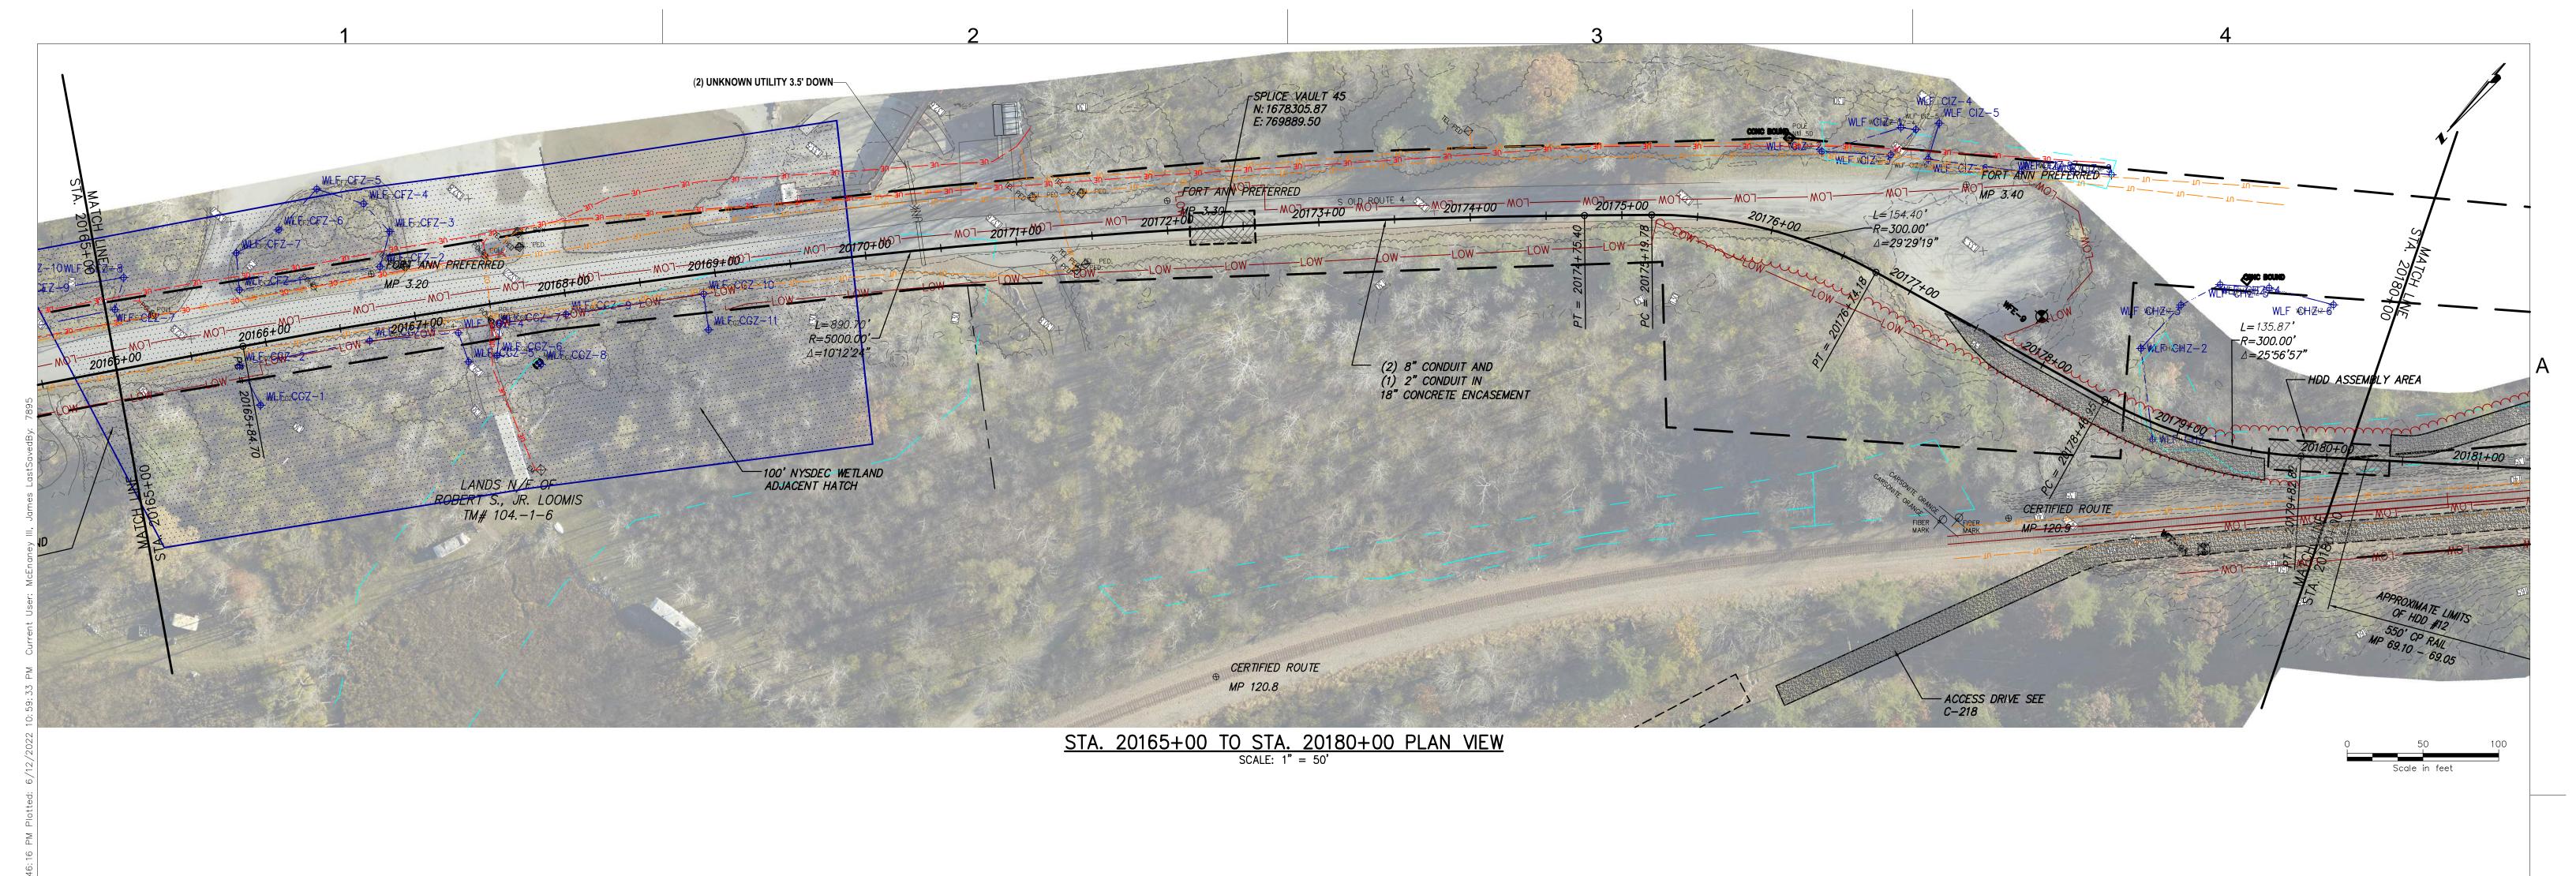
CHAMPLAIN HUDSON POWER EXPRESS
SEGMENT 3 - PACKAGE 2 - FORT ANN TO KINGSBURY
STA. 20135+00 TO STA. 20150+00 PLAN AND PROFILE


KIEWIT PROJECT NO. 21162 CHA PROJECT NO. 066076 DRAWING NO.

C-110

AS NOTED DATE XXX OF XXX X SH.NO.





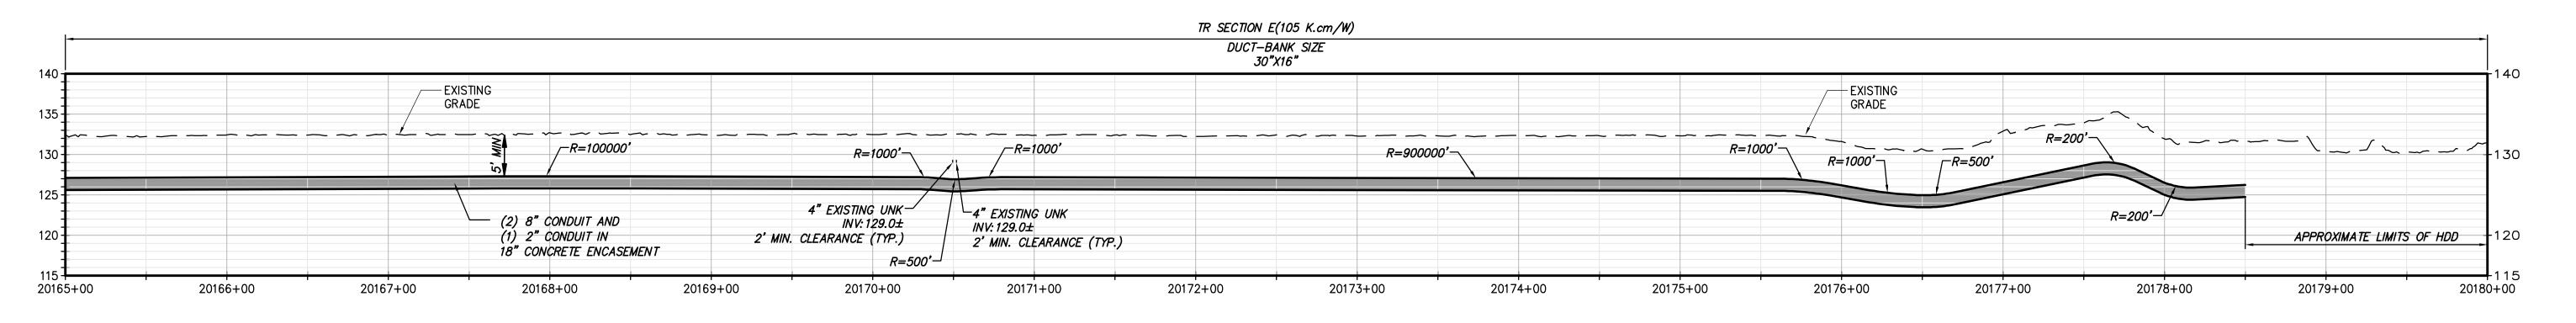

# STA. 20165+00 TO STA. 20180+00 PROFILE VIEW SCALE: H: 1" = 50' V: 1" = 10'







IT IS A VIOLATION OF LAW FOR ANY PERSON, UNLESS THEY ARE ACTING UNDER THE DIRECTION OF A LICENSED PROFESSIONAL ENGINEER, ARCHITECT, LANDSCAPE ARCHITECT OR LAND SURVEYOR TO ALTER AN ITEM IN ANY WAY. IF AN ITEM BEARING THE STAMP OF A LICENSED PROFESSIONAL IS ALTERED, THE ALTERING ENGINEER, ARCHITECT, LANDSCAPE ARCHITECT OR LAND SURVEYOR SHALL STAMP THE DOCUMENT AND INCLUDE THE NOTATION "ALTERED BY" FOLLOWED BY THEIR SIGNATURE, THE DATE OF SUCH ALTERATION, AND A SPECIFIC DESCRIPTION
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В	02/23/2022	PROGRESS SUBMISSION	JM	JR	
Α	01/26/2022	30% SUBMISSION	JM	JR	
No.	DATE	SUBMITTAL / REVISION DESCRIPTION	DB	APP	DRAWN BY: XXX DESIGNED BY: XXX APPROVED BY: XXX REV. NO.

CHAMPLAIN HUDSON POWER EXPRESS **SEGMENT 3 - PACKAGE 2 - FORT ANN TO KINGSBURY** STA. 20165+00 TO STA. 20180+00 PLAN AND PROFILE KIEWIT PROJECT NO. 21162 CHA PROJECT NO. 066076 DRAWING NO.

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AS NOTED DATE

XXX OF XXX

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