# APPENDIX C.25 CASE 10-T-0139 SITE PLANS AND CONSTRUCTION DRAWINGS COMMUNICATIONS PACKAGE ASTORIA HVDC CONVERTER STATION SEGMENT 22



### ASTORIA HVDC CONVERTER STATION

### COMMUNICATIONS PACKAGE

SCOPE OF WORK

FLOOD ZONE DESIGN CERTIFICATION:

THE COMMUNICATIONS SYSTEM SCOPE OF WORK INCLUDES BOTH THE NETWORK DESIGN FOR THE ASTORIA FACILITY AND THE DESIGN OF THE FOLLOWING SYSTEMS.

ACCESS CONTROL AND INTRUSION DETECTION (SEC)

CLOSED-CIRCUIT TELEVISION (CCTV)

PUBLIC ADDRESS (PA)

TELEPHONE (TEL)

THE VARIOUS LOCATIONS AND THEIR ASSOCIATED SYSTEMS ARE INDICATED BELOW:


- 1. CONVERTER BUILDING (SEC, CCTV, TEL)
- 2. SERVICE BUILDING (SEC, CCTV, PA, TEL)
- 3. HVAC BUILDING (SEC)
- 4. STORAGE ENCLOSURE (SEC, CCTV, TEL)
- 5. RELAY ENCLOSURE (SEC, CCTV, TEL)
- 6. MVS ENCLOSURE (SEC, TEL)
  7. MAIN ENTRANCE GATE (SEC, CCTV, TEL)
- MAIN ENTRANCE GATE (SEC, CCTV, TEL)
   EXTERIOR SWITCHYARD (CCTV, PA)


THE EXISTING PROPERTY IS IN THE SPECIAL FLOOD HAZARD AREA (SFHA), ZONE AE PER EFFECTIVE 2015 FLOOD INSURANCE RATE MAP(FIRM). THIS IS TO CONFIRM THAT THE PROPOSED INSTALLATION IS IN COMPLIANCE WITH THE REQUIREMENTS SET FORTH IN APPENDIX Q OF THE NYC BUILDING CODE.


### **NYC ENERGY CODE COMPLIANCE:**

STATEMENT: TO THE BEST OF MY KNOWLEDGE, BELIEF AND PROFESSIONAL JUDGEMENT, THESE PLANS AND SPECIFICATIONS ARE IN COMPLIANCE WITH THE NEW YORK CITY ENERGY CONSERVATION CODE. PROPOSED WORK MEETS THE GUIDELINES AND INSTRUCTIONS OUTLINED IN THE 2020 NYC ECC CHAPTER 4.

APPLICABLE CYBERSECURITY MEASURES WILL ALSO BE IMPLEMENTED AS PER NERC-CIP RELIABILITY STANDARDS.

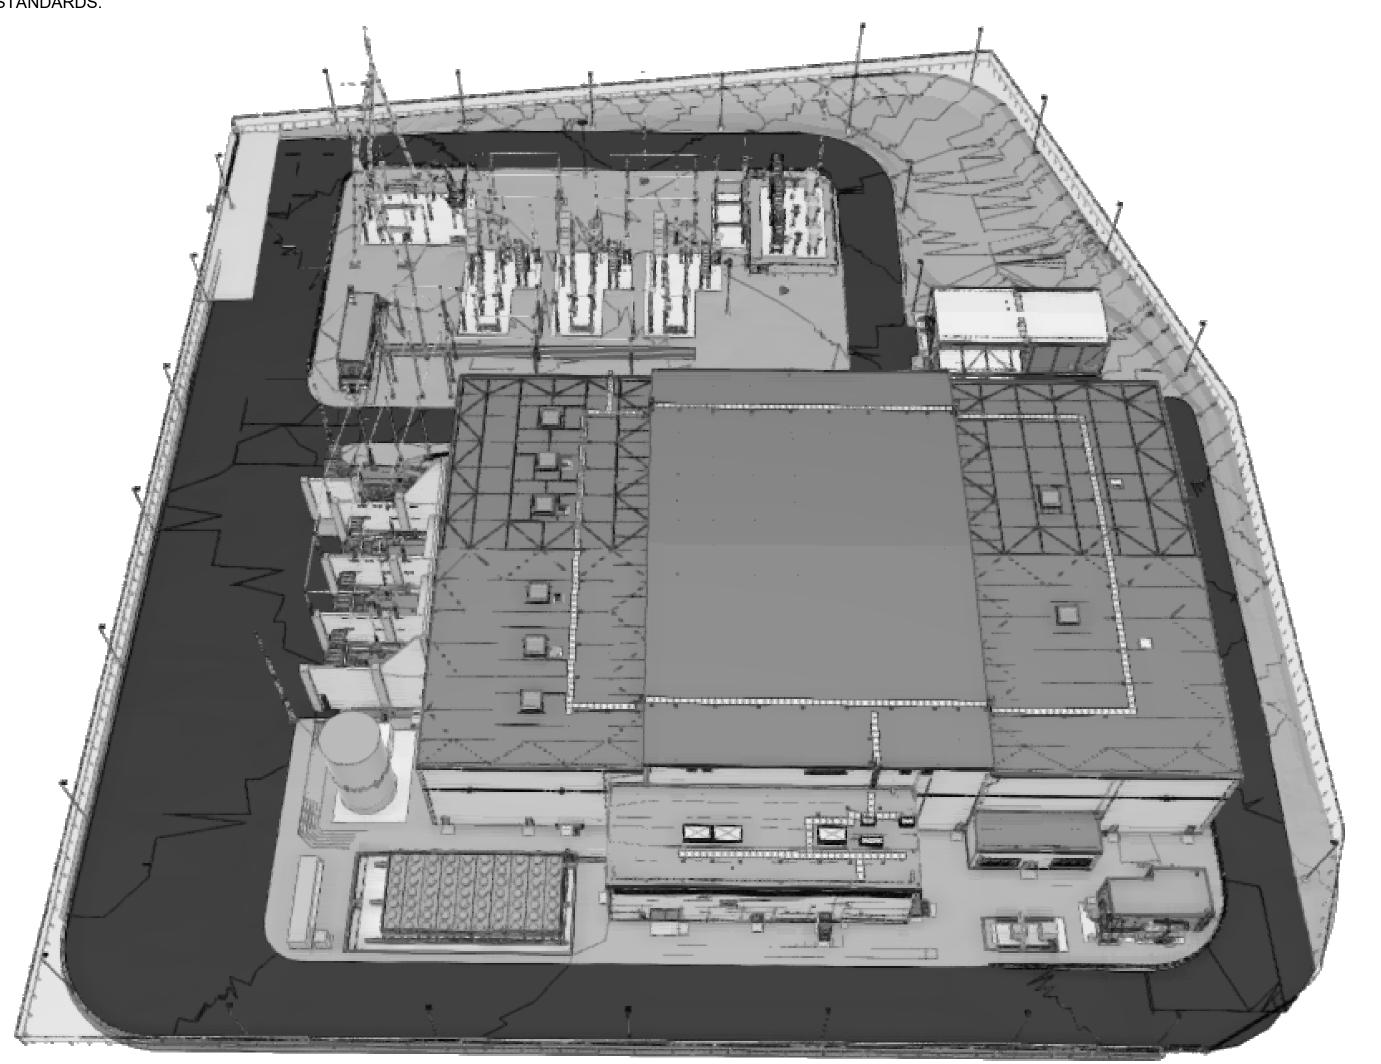

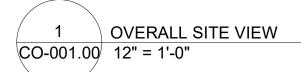

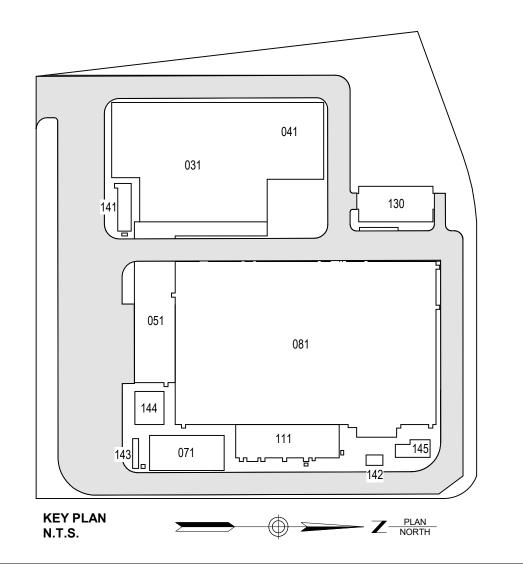

Engineering and Land Surveying, P.C.

370 7th Avenue SUITE 1604 New York, NY 10001



25 Mohawk Avenue Sparta, NJ 07871

#### CONFIDENTIAL

THESE DRAWINGS ARE CONFIDENTIAL IN NATURE. ANY MISUSE OR UNAUTHORIZED DISTRIBUTION OF THE DRAWINGS CONTAINED HEREIN WILL BE A VIOLATION OF THIS CONFIDENTIALITY REQUIREMENT AND SUBJECT THE VIOLATOR TO LIABILITY. REVIEW OF THESE MATERIALS BY RECEIPT SHALL CONSTITUTE ACCEPTANCE OF THESE TERMS AND THE TERMS OF ANY UNDERLYING CONFIDENTIALITY AGREEMENT WE MAY HAVE EXCLUDED IN OBTAINING THIS INFORMATION FROM A THIRD PARTY. IF THE RECIPIENT IS NOT IN AGREEMENT WITH THE OBLIGATION OF CONFIDENTIALITY THEN THE DRAWINGS SHALL BE RETURNED TO THE ORIGINATOR.

				·
·				
В	FINAL SUBMISSION	VSP	EK	12/12/2022
Α	INTERIM SUBMISSION	VSP	EK	09/13/2022
REV	DESCRIPTION	DRW BY	CHK BY	DATE



901 Main Campus Drive Raleigh, North Carolina 27606

PROJECT



### Astoria HVDC Converter Station

31-45 20<sup>th</sup> Avenue, Astoria, Queens NY 11105 Block #850 - Lot #310 - BIN #4624437

**COVER SHEET** 

1		
DATE	12/08	/2022
PROJECT NO	10512	21
DRAWING BY	V. PA	TEL
CHECKED BY	E. KIE	DANE
DRAWING NO		
$CO_{-}$	001	$\cap$
	<i><b>\</b> </i>	


### ISSUED FOR PERMIT

SHEET NO.		TIONS SYSTEMS (SEC, CCTV, PA, INT/TEL, NET)
1	CO-001.00	COVER SHEET
2	CO-001.01	CO - SHEET LIST
3	CO-001.02	CO - SYMBOLS, NOTES AND ABBREVIATIONS
4	CO-100.00	CO - OVERALL SITE PLAN
5	CO-100.00 CO-101.00	CO - DEVICE LAYOUT - DC HALL (WEST)
6	CO-101.00 CO-102.00	CO - DEVICE LAYOUT - DC HALL (WEST)
7	CO-102.00 CO-103.00	CO - DEVICE LAYOUT - DC HALL (EAST)  CO - DEVICE LAYOUT - VALVE HALL (WEST)
8	CO-103.00 CO-104.00	CO - DEVICE LAYOUT - VALVE HALL (WEST)  CO - DEVICE LAYOUT - VALVE HALL (EAST)
9	CO-105.00	CO - DEVICE LAYOUT - REACTOR HALL (WEST)
10	CO-106.00	CO - DEVICE LAYOUT - REACTOR HALL (EAST)
11	CO-107.00	CO - DEVICE LAYOUT - SERVICE BUILDING LEVEL 1 (SOUTH)
12	CO-108.00	CO - DEVICE LAYOUT - SERVICE BUILDING LEVEL 1 (NORTH)
13	CO-109.00	CO - DEVICE LAYOUT - SERVICE BUILDING LEVEL 2 (SOUTH)
14	CO-110.00	CO - DEVICE LAYOUT - SERVICE BUILDING LEVEL 2 (NORTH)
15	CO-111.00	CO - DEVICE LAYOUT - RELAY ENCLOSURE
16	CO-112.00	CO - DEVICE LAYOUT - MVS ENCLOSURE
17	CO-113.00	CO - DEVICE LAYOUT - STORAGE ENCLOSURE
18	CO-201.00	CO - OVERALL BLOCK DIAGRAM
19	CO-202.00	CO - NETWORK RISER (SERVICE BUILDING)
20	CO-203.00	CO - NETWORK RISER (SMALL FORM CABINETS) SHEET 1 OF 2
21	CO-204.00	CO - NETWORK RISER (SMALL FORM CABINETS) SHEET 2 OF 2
22	CO-205.00	CO - COMUNICATIONS CABINET ELEVATION (SERVICE BLDG.)
23	CO-206.00	CO - SMALL FORM CABINET DETAILS (TYPICAL)
24	CO-207.00	CO - SMALL FORM CABINET MOUNTING DETAILS
25	CO-208.00	CO - TYPICAL DOOR CONFIGURATIONS
26	CO-209.00	CO - INTRUSION SYSTEM CABINET MOUNTING DETAILS
27	CO-210.00	CO - POWER SUPPLY AND INTELLIGENT CONTROLLER CABINET MOUNTING DETAILS
28	CO-211.00	CO - ACCESS CONTROL CABINET MOUNTING DETAILS
29	CO-212.00	CO - CARD READER DUAL HEIGHT PEDESTAL MOUNTING DETAILS
30	CO-213.00	CO - ACS RISER DIAGRAM
31	CO-214.00	CO - ACS POWER SUPPLY DIAGRAM
32	CO-215.00	CO - ACS WIRING DETAILS - GATE ENTRANCE AND EXIT
33	CO-216.00	CO - TWO DOUBLE DOOR WIRING WITH READERS
34	CO-217.00	CO - ONE SINGLE, ONE DOUBLE DOOR WIRING WITH READERS
35	CO-218.00	CO - INTELLIGENT CONTROLLER WIRING DIAGRAM
36	CO-219.00	CO - INPUT MODULE WIRING DIAGRAM
37	CO-220.00	CO - OUTPUT MODULE WIRING DIAGRAM
38	CO-221.00	CO - INTRUSION ALARM PANEL WIRING DIAGRAM
39	CO-222.00	CO - SECURITY SYSTEM DEVICE SCHEDULE
40	CO-223.00	CO - SECURITY SYSTEM BILL OF MATERIALS
41	CO-224.00	CO - INTERCOM WIRING DETAILS
42	CO-225.00	CO - INTERCOM DUAL HEIGHT PEDESTAL MOUNTING
43	CO-226.00	CO - PA SYSTEM WIRING DIAGRAM (SERVICE BLDG.)
44	CO-227.00	CO - PA SYSTEM WIRING DIAGRAM (EXTERIOR SITE)
45	CO-228.00	CO - PUBLIC ADDRESS SYSTEM DIAGRAM
46	CO-229.00	CO - PA SYSTEM POWER SUPPLY DIAGRAM
47	CO-230.00	CO - PA SYSTEM CEILING SPEAKER MOUNTING DETAILS
48	CO-231.00	CO - PA SYSTEM EXTERNAL HORN SPEAKER MOUNTING DETAILS
49	CO-232.00	CO - PA SYSTEM SPEAKER SCHEDULE
50	CO-233.00	CO - CAMERA MOUNT DETAILS
51	CO-234.00	CO - CCTV SYSTEM CAMERA SCHEDULE
		<u> </u>

**SHEET NO:** 

**DRAWING#** 

DRAWING/DOCUMENT NAME

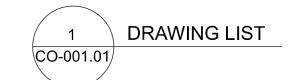



370 7th Avenue SUITE 1604 New York, NY 10001



25 Mohawk Avenue Sparta, NJ 07871

#### CONFIDENT

THESE DRAWINGS ARE CONFIDENTIAL IN NATURE. ANY MISUSE OR UNAUTHORIZED DISTRIBUTION OF THE DRAWINGS CONTAINED HEREIN WILL BE A VIOLATION OF THIS CONFIDENTIALITY REQUIREMENT AND SUBJECT THE VIOLATOR TO LIABILITY, REVIEW OF THESE MATERIALS BY RECEIPT SHALL CONSTITUTE ACCEPTANCE OF THESE TERMS AND THE TERMS OF ANY UNDERLYING CONFIDENTIALITY AGREEMENT WE MAY HAVE EXCLUDED IN OBTAINING THIS INFORMATION FROM A THIRD PARTY. IF THE RECIPIENT IS NOT IN AGREEMENT WITH THE OBLIGATION OF CONFIDENTIALITY THEN THE DRAWINGS SHALL BE RETURNED TO THE ORIGINATOR.

В	FINAL SUBMISSION	JDH	RAB	12/08/2022
Α	INTERIM SUBMISSION	JDH	CC	09/13/2022
REV	DESCRIPTION	DRW BY	CHK BY	DATE



901 Main Campus Drive Raleigh, North Carolina 27606

PROJEC



### Astoria HVDC Converter Station

31-45 20<sup>th</sup> Avenue, Astoria, Queens NY 11105 Block #850 - Lot #310 - BIN #4624437

COMMUNICATIONS
SYSTEM DRAWING LIST

 DATE
 08/29/2022

 PROJECT NO
 105121

 DRAWING BY
 C. CARROLL

 CHECKED BY
 J. Howard

CO-001.01

Autodesk Docs://CHPE
Astoria/CHA-KIE-200-00-M2-CO-001.rvt

### PA LEGEND



CEILING SPEAKER

ANS AMBIENT NOISE SENSOR

AMP - AMPLIFIER

- DIGITAL SIGNAL PROCESSOR

- VOLUME CONTROL

- ANALOG TELEPHONE ADAPTER

### ACS/IDS LEGEND

ACCESS CONTROL CABINET

PX - PIR REX DEVICE

- INTRUSION ALARM CABINET

R - CARD READER

- DOOR CONTROLLER

PS - POWER SUPPLY

- INTELLIGENT CONTROLLER CABINET

| | - DOOR POSITION SENSOR

ICM - INTELLIGENT CONTROLLER MODULE

ES - ELECTRONIC DOOR STRIKE

- POWER SUPPY CABINET

MS - MOTION SENSOR

- INPUT OUTPUT CABINET

### CCTV LEGEND

INDOOR 360-DEGREE CAMERA

D - DUAL DOME CAMERA

- FIXED CAMERA

- PTZ CAMERA

### NETWORK LEGEND



CABINET / RACK

- CABINET / RACK

- DATA PORT

- DUPLEX OUTLET

- HVAC DATA PORT

### TELEPHONE LEGEND



- INTERCOM PORT

### **GENERAL NOTES:**

- ALL DIMENSIONS ARE IMPERIAL, UNLESS OTHERWISE
- ALL DRAWING BACKGROUNDS COORDINATED WITH THE FEDERATED MODEL.
- DRAWINGS ARE TO BE USED IN CONJUNCTION WITH PROJECT SPECIFICATIONS TO DETERMINE THE FULL SCOPE OF PROJECT.
- 4. SCOPE OF WORK
  - A. A PUBLIC ADDRESS SYSTEM IS PROVIDED IN THE SWITCHYARD AND SERVICE BUILDING.
  - B. A CCTV SYSTEM IS PROVIDED FOR THE EXTERIOR DOORS, INSIDE THE CONERTER BUILDING AND NEAR MONITORED AND CONTROLLED DOORS.
  - C. A SECURITY SYSTEM IS PROVIDED AT THE MAIN GATE AND OTHER DOORS AS OUTLINED IN PROJECT SPECIFICATIONS.
  - D. TELEPHONE AND NETWORK PORTS ARE BEING PROVIDED IN STRATEGIC LOCATIONS OUTLINED IN THESE DRAWINGS.
- DOCUMENT 681857-47ES-0001, ASTORIA CONVERTER STATION PERFORMANCE SPECIFICATION, REVISION 1 DATED JUNE 30TH, 2022, IS THE PRIMARY DESIGN CRITERIA USED FOR TELECÓMMUNICATIONS AND SECURITY
- DOCUMENT 1JNL1100109, TELECOMMUNICATIONS AND SECURITY SYSTEM, REVISION A, DATED 2021-10-20, IS AN ADDITIONAL SOURCE OF DESIGN CRITERIA USED FOR TELECOMMUNICATIONS AND SECURITY SYSTEMS
- DOCUMENT O-ENG-S-015, DESIGN CRITERIA FOR DEVELOPER CONNECTION TO THE NEW YORK POWER AUTHORITY TRANSMISSION SYSTEM, DATED 4/11/2020, IS USED AS DESIGN CRITERIA WHERE SPECIFIED BY 691957-47ES-0001, ASTORIA CONVERTER STATION PERFORMANCE SPECIFICATION
- COMPLIANCE WITH NORTH AMERICAN ELECTRIC RELIABILITY CORPORATION (NERC) CIP CYBER SECURITY STANDARDS AS RELATED TO SYSTEM DESIGN IS REPRESENTED WITHIN THESE DRAWINGS ONLY. THE PROCESSES AND PROCEDURES REQUIRED BY NERC CIP STANDARDS ARE THE RESPONSIBILITY OF THE OWNER.
- NERC CIP IMPACT CATEGORY IS UNDERSTOOD TO BE "MEDIUM IMPACT BES CYBER SYSTEMS WITH EXTERNAL ROUTABLE CONNECTIVITY".
- INSTALLATION OF TELECOMMUNICATIONS, SECURITY EQUIPMENT AND CABLING WILL BE COMPLIANT WITH NFPA 70 NATIONAL ELECTRIC CODE, 2020 EDITION.
- 11. ETHERNET CABLES WILL BE CAT6A.
- 12. CAT6A CABLE LENGTHS TO BE COMPLIANT WITH TIA-568.5.

- 13. ALL WORK SHALL BE PERFORMED IN ACCORDANCE WITH STATE AND NATIONAL CODES, RULES AND REGULATIONS.
- CONTRACTOR SHALL TAKE REASONABLE CARE TO MAINTAIN A SAFE AND SECURE WORK AREA AT ALL TIMES THROUGH THE USE OF, AMONG OTHER ITEMS, SAFETY EQUIPMENT AND FALL PROTECTION.
- CONTRACTOR SHALL VERIFY ALL DIMENSIONS AND FIELD CONDITIONS PRIOR TO ORDERING MATERIALS OR COMMENCING WORK AND SHALL REPORT TO THE ENGINEER ANY DISCREPANCIES OR OMISSIONS WHICH WOULD INTERFERE WITH SATISFACTORY COMPLETION OF WORK.
- FIELD VERIFY EXACT LOCATION OF COMMUNICATIONS DEVICES AND MOUNTS. COORDINATE ALL WORK WITH OTHER TRADES AND CONTRACTORS
- PROVIDE ALL MOUNTING AND SUPPORT HARDWARE FOR COMMUNICATIONS DEVICES TO MEET SPECIFIED MOUNTING HEIGHTS.
- CEILING MOUNTED SPEAKERS OR CAMERAS INSTALLED IN TILE SHALL BE CENTERED WITHIN THE TILE. DEVICES SHALL NOT BE INSTALLED IN THE TILE DIRECTLY ADJACENT TO AN HVAC DIFFUSER.
- ALL DISSIMILAR METALS SHALL BE EFFECTIVELY ISOLATED FROM EACH OTHER TO PREVENT GALVANIC ACTION.
- ALL EQUIPMENT SHALL BE GROUNDED ACCORDING TO MANUFACTURER RECOMMENDATIONS.
- ANY EQUIPMENT INSIDE THE CONVERTER BUILDING SHALL BE RFI/EMC COMPLIANT, AND BE ABLE TO WITHSTAND HV ENVIRONMENT.
- ALL CABLES SHALL BE COMPLIANT WITH HITACHI ENERGY'S SPECIFICATION INCLUDING BE LOW SMOKE ZERO HALOGEN.

### Engineering and Land Surveying, P.C.

370 7th Avenue **SUITE 1604** New York, NY 10001



25 Mohawk Avenue **Sparta, NJ 07871** 

#### CONFIDENTIAL

THESE DRAWINGS ARE CONFIDENTIAL IN NATURE. ANY MISUSE OR UNAUTHORIZED DISTRIBUTION OF THE DRAWINGS CONTAINED HEREIN WILL BE A VIOLATION OF THIS CONFIDENTIALITY REQUIREMENT AND SUBJECT THE VIOLATOR TO LIABILITY. REVIEW OF THESE MATERIALS BY RECEIPT HALL CONSTITUTE ACCEPTANCE OF THESE TERMS AND THE TERMS OF ANY UNDERLYING CONFIDENTIALITY AGREEMENT WE MAY HAVE EXCLUDED IN OBTAINING THIS INFORMATION FROM A THIRD PARTY. IF THE RECIPIENT IS NOT IN AGREEMENT WITH THE OBLIGATION OF CONFIDENTIALITY THEN THE DRAWINGS SHALL BE RETURNED TO THE ORIGINATOR.

**ISSUED FOR PERMIT** 

В	FINAL SUBMISSION	JDH	RAB	12/08/2022
Α	INTERIM SUBMISSION	JDH	CC	09/13/2022
REV	DESCRIPTION	DRW BY	CHK BY	DATE



**@**Hitachi Energy

901 Main Campus Drive Raleigh, North Carolina 27606

PROJECT



### **Astoria HVDC Converter Station**

31-45 20th Avenue, Astoria, Queens NY 11105 Block #850 - Lot #310 - BIN #4624437

**COMMUNICATIONS** SYSTEM SYMBOLS, NOTES **AND ABBREVIATIONS** 

> 08/29/2022 PROJECT NO 105121 C. CARROLL CHECKED BY

CO-001.02

CADD FILE NO
Autodesk Docs://CHPE
Astoria/CHA-KIE-200-00-M2-CO-001.rvt

**BUILDING - NAME** 

**RH - REACTOR HALL** 

ME - MVS ENCLOSURE

STE - STORAGE ENCLOSURE

**RLE - RELAY ENCLOSURE** 

**EX - EXTERIOR SITE** 

ID - SCHEME

ID - BLDG - #####

VH - VALVE HALL

DH - DC HALL

SVB - SERVICE BUILDING

ABBREVATIONS

ACS - ACCESS CONTROL SYSTEM CCTV - CLOSED CIRCUIT TELEVISION

PA - PUBLIC ADDRESS

IDS - INTRUSION DETECTION SYSTEM MVS - MEDIUM-VOLTAGE SWITCHGEAR

PTZ - PAN, TILT, ZOOM

ICM - INTELLIGENT CONTROLLER MODULE PSC - POWER SUPPLY CABINET PSU - POWER SUPPLY UNIT **ACC - ACCESS CONTROL CABINET** 

IOM - INPUT/OUTPUT MODULE

IOC - INPUT/OUTPUT CABINET

IAP - INTRUSION ALARM PANEL

ACP - ACCESS CONTROL PANEL

**DEVICE ID - NAME** 

DEVICE LABELING

AMP - AMPLIFIER

**CS - CEILING SPEAKER** 

CC - CCTV CAMERA

INT - INTERCOM

TEL - TELEPHONE PORT

DC - DOOR CONTROLLER MS - MOTION SENSOR

DSP - DIGITAL SIGNAL PROCESSOR

PSU - POWER SUPPLY UNIT

ANS - AMBIENT NOISE SENSOR

VC - VOLUME CONTROL

LAN - ETHERNET PORT

**COM - COMMUNICATIONS ENCLOSURE** 

HS - HORN SPEAKER

#### - DEVICE NUMBER

001- 100 - CCTV 101- 200 - PA

LV- LOW VOLTAGE

PX - PIR REX DEVICE

SMO - SINGLE MODE FIBER

**REX - REQUEST-TO-EXIT** 

GWB - GYPSUM WALL BOARD


OSDP - OPEN SUPERVISED DEVICE PROTOCOL


201- 300 - ACS / IDS 301-400 - NETWORK

DC-SVB-B107

EXAMPLES: CS-SVB-113

SYMBOLS, NOTES AND ABBREVIATIONS CO-001.02 NOT TO SCALE

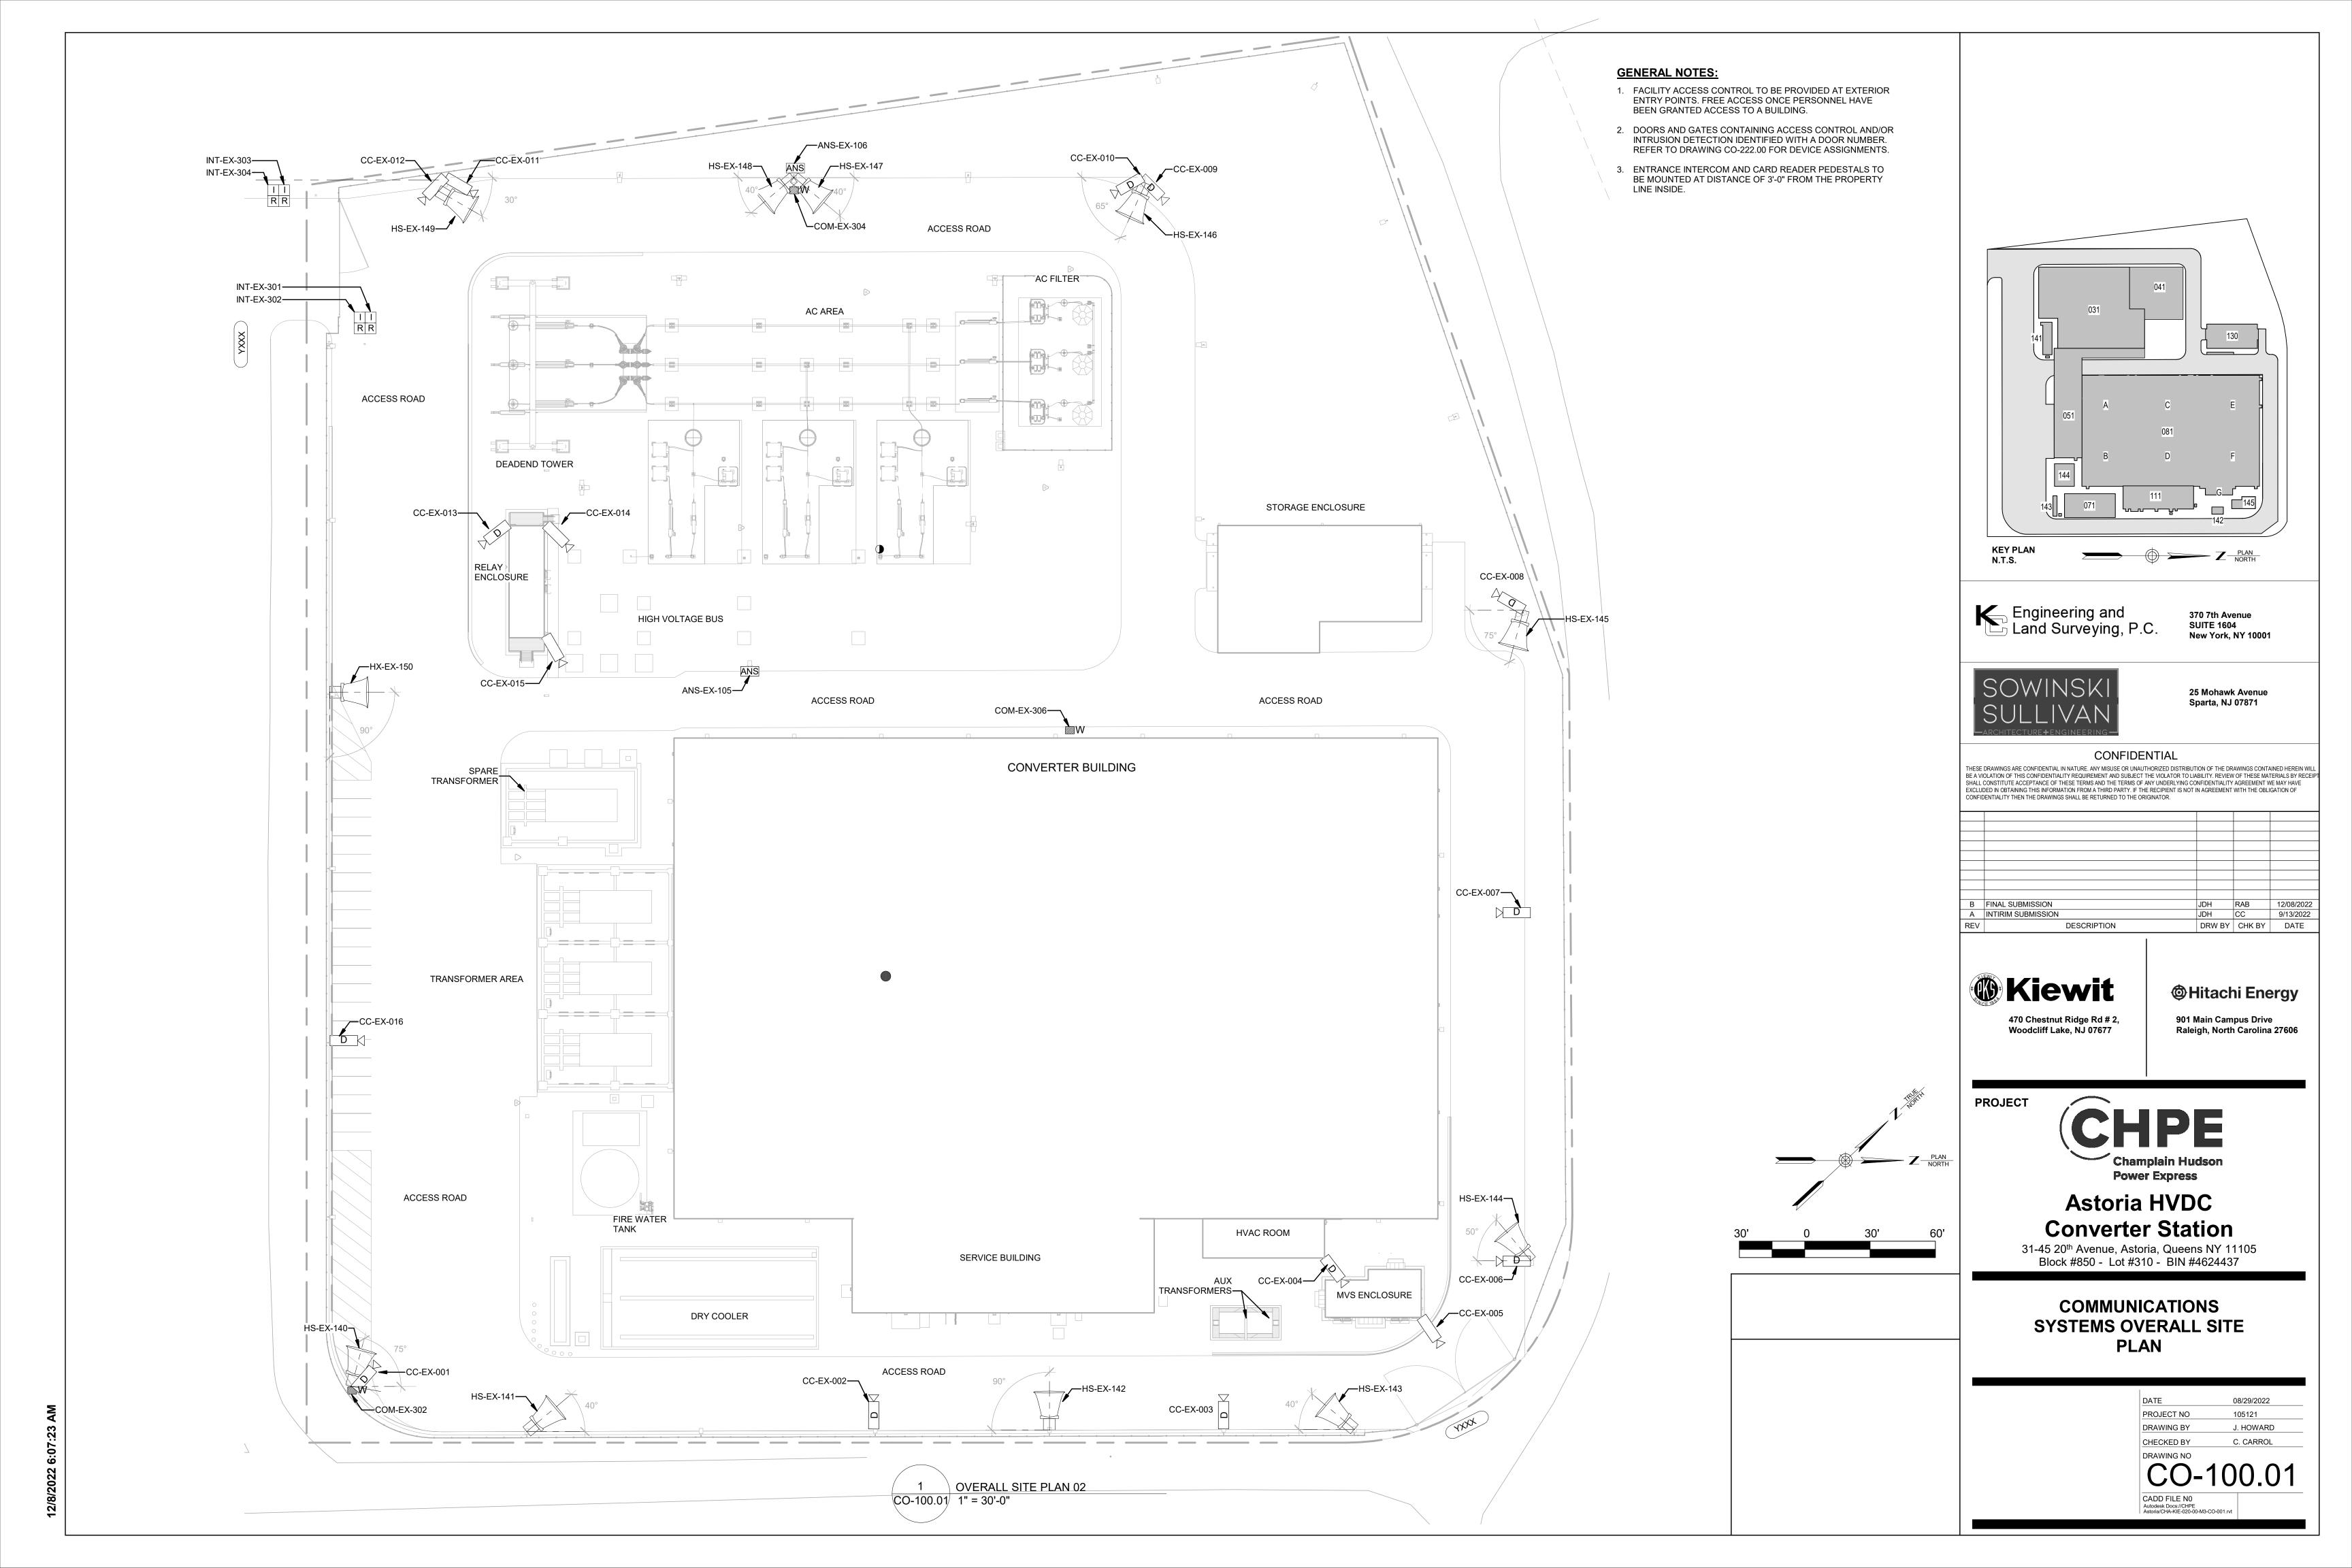

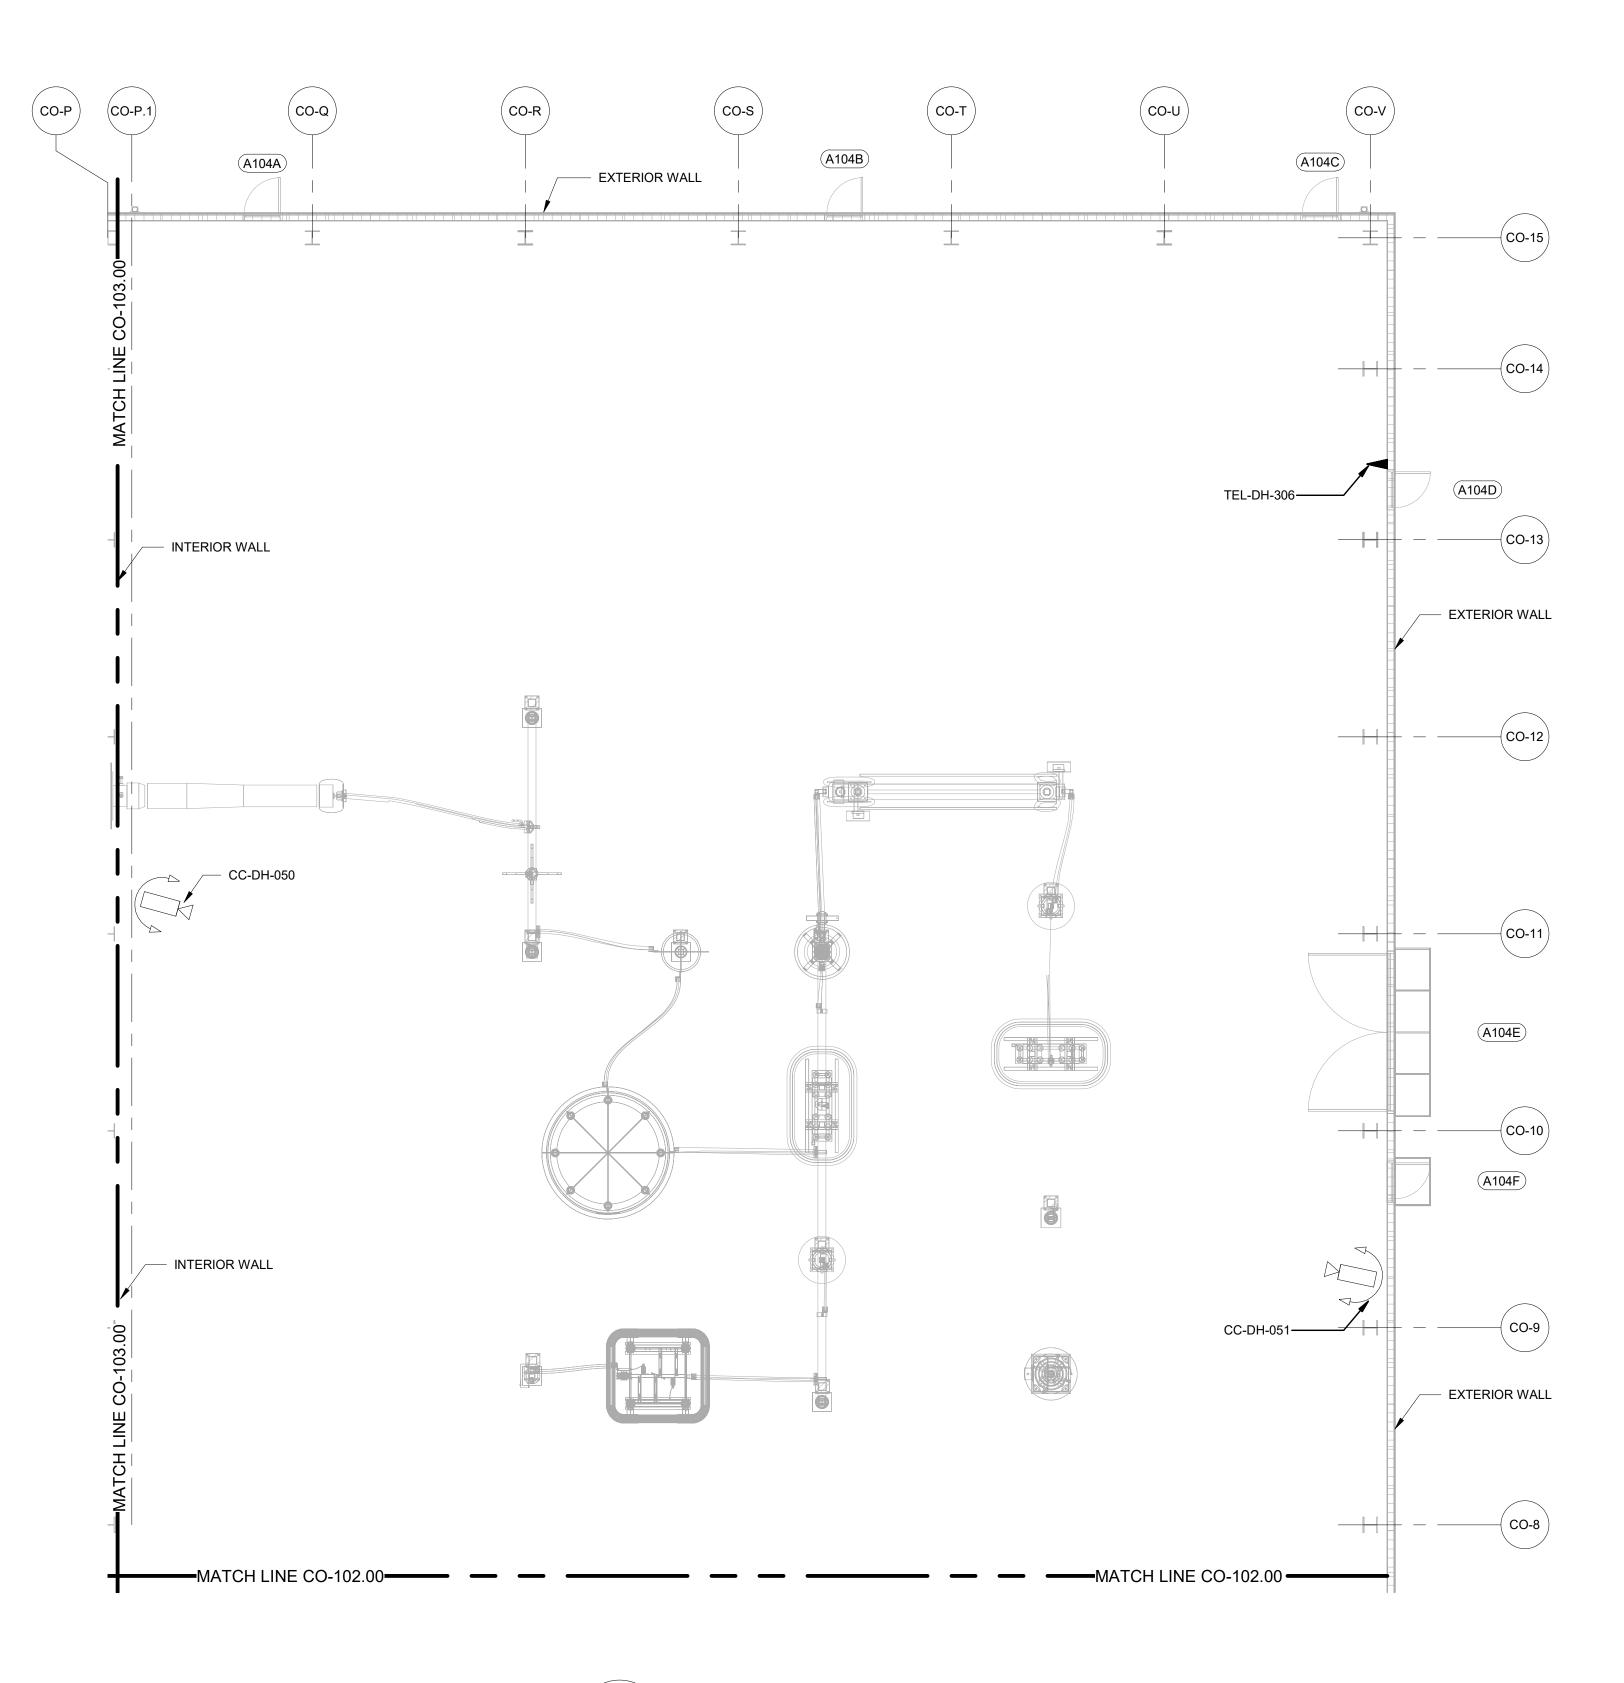


### 1 DC HALL (NORTH) CO-101.00 1/8" = 1'-0"

### **GENERAL NOTES:**

- DOORS AND GATES CONTAINING ACCESS CONTROL AND/OR INTRUSION DETECTION IDENTIFIED WITH A DOOR NUMBER. REFER TO DRAWING CO-222.00 FOR DEVICE ASSIGNMENTS.
- 2. ALL PTZ CAMERAS WITHIN THE CONVERTER BUILDING ARE EMI/RFI RATED

### ISSUED FOR PERMIT

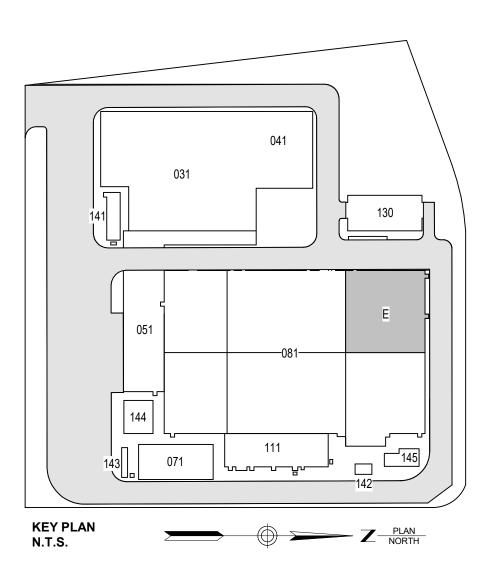

Engineering and Land Surveying, P.C.


370 7th Avenue SUITE 1604 New York, NY 10001



25 Mohawk Avenue Sparta, NJ 07871

#### CONFIDENTIAL

THESE DRAWINGS ARE CONFIDENTIAL IN NATURE. ANY MISUSE OR UNAUTHORIZED DISTRIBUTION OF THE DRAWINGS CONTAINED HEREIN WILL BE A VIOLATION OF THIS CONFIDENTIALITY REQUIREMENT AND SUBJECT THE VIOLATOR TO LIABILITY. REVIEW OF THESE MATERIALS BY RECEIPT SHALL CONSTITUTE ACCEPTANCE OF THESE TERMS AND THE TERMS OF ANY UNDERLYING CONFIDENTIALITY AGREEMENT WE MAY HAVE EXCLUDED IN OBTAINING THIS INFORMATION FROM A THIRD PARTY. IF THE RECIPIENT IS NOT IN AGREEMENT WITH THE OBLIGATION OF CONFIDENTIALITY THEN THE DRAWINGS SHALL BE RETURNED TO THE ORIGINATOR.

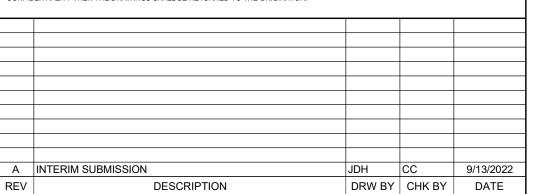

Kiewit

470 Chestnut Ridge Rd # 2, Woodcliff Lake, NJ 07677 **@**Hitachi Energy

901 Main Campus Drive Raleigh, North Carolina 27606

PROJECT




### Astoria HVDC Converter Station

31-45 20<sup>th</sup> Avenue, Astoria, Queens NY 11105 Block #850 - Lot #310 - BIN #4624437

COMMUNICATION SYSTEMS DEVICE LAYOUT DC HALL (NORTH)


DATE	08/29/2022
PROJECT NO	105121
DRAWING BY	J. HOWARD
CHECKED BY	C. CARROL
DRAWING NO	
	101 00



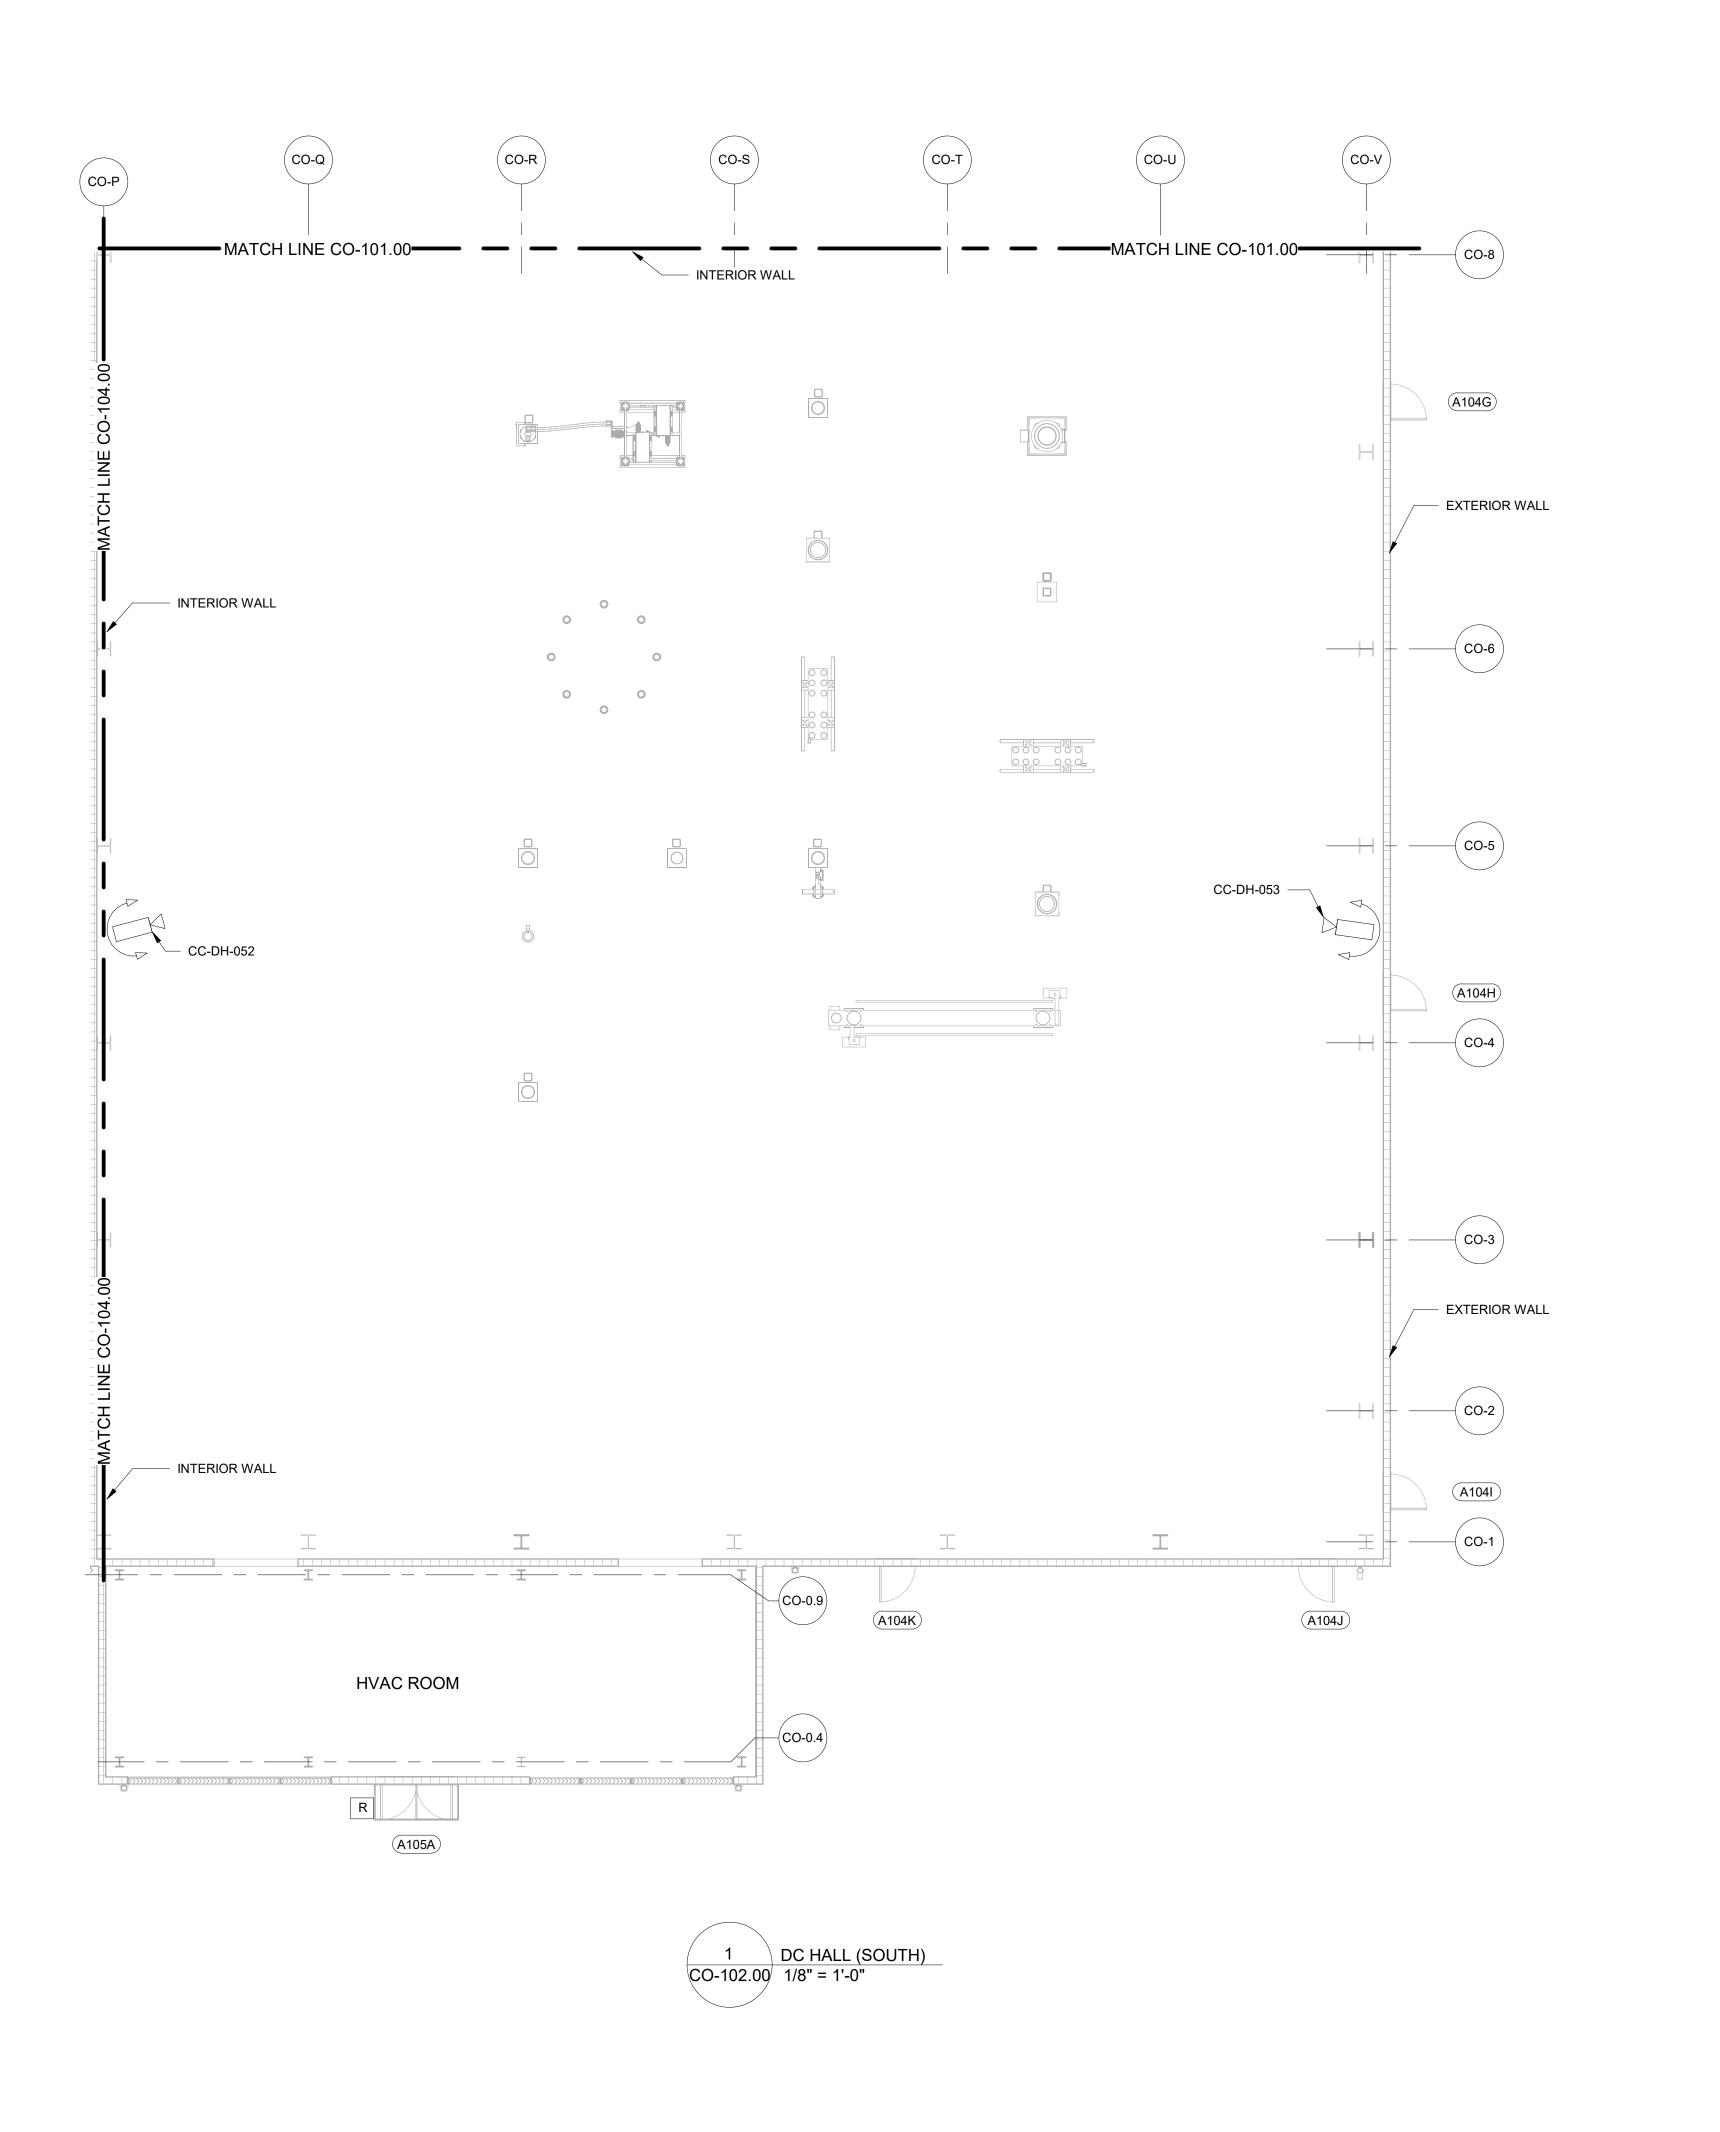

- DOORS AND GATES CONTAINING ACCESS CONTROL AND/OR INTRUSION DETECTION IDENTIFIED WITH A DOOR NUMBER. REFER TO DRAWING CO-222.00 FOR DEVICE ASSIGNMENTS.
- 2. ALL PTZ CAMERAS WITHIN THE CONVERTER BUILDING ARE EMI/RFI

### ISSUED FOR PERMIT

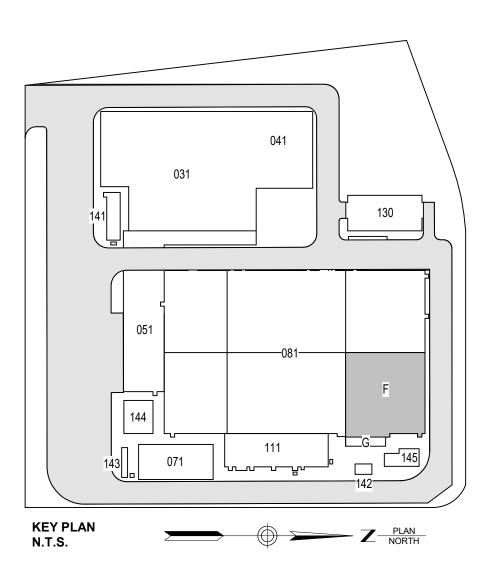

Engineering and Land Surveying, P.C.


370 7th Avenue SUITE 1604 New York, NY 10001



25 Mohawk Avenue Sparta, NJ 07871

#### CONFIDENTIAL

THESE DRAWINGS ARE CONFIDENTIAL IN NATURE. ANY MISUSE OR UNAUTHORIZED DISTRIBUTION OF THE DRAWINGS CONTAINED HEREIN WILL BE A VIOLATION OF THIS CONFIDENTIALITY REQUIREMENT AND SUBJECT THE VIOLATOR TO LIABILITY. REVIEW OF THESE MATERIALS BY RECEIPT SHALL CONSTITUTE ACCEPTANCE OF THESE TERMS AND THE TERMS OF ANY UNDERLYING CONFIDENTIALITY AGREEMENT WE MAY HAVE EXCLUDED IN OBTAINING THIS INFORMATION FROM A THIRD PARTY. IF THE RECIPIENT IS NOT IN AGREEMENT WITH THE OBLIGATION OF CONFIDENTIALITY THEN THE DRAWINGS SHALL BE RETURNED TO THE ORIGINATOR.

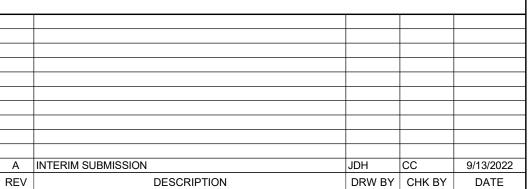

470 Chestnut Ridge Rd # 2, Woodcliff Lake, NJ 07677

901 Main Campus Drive Raleigh, North Carolina 27606

PROJECT



### Astoria HVDC Converter Station


31-45 20<sup>th</sup> Avenue, Astoria, Queens NY 11105 Block #850 - Lot #310 - BIN #4624437

COMMUNICATIONS SYSTEMS DEVICE LAYOUT DC HALL (SOUTH)

DATE 08/29/2022
PROJECT NO 105121
DRAWING BY J. HOWARD
CHECKED BY C. CARROL
DRAWING NO


- DOORS AND GATES CONTAINING ACCESS CONTROL AND/OR INTRUSION DETECTION IDENTIFIED WITH A DOOR NUMBER. REFER TO DRAWING CO-222.00 FOR DEVICE ASSIGNMENTS.
- ALL PTZ CAMERAS WITHIN THE CONVERTER BUILDING ARE EMI/RFI RATED

### ISSUED FOR PERMIT

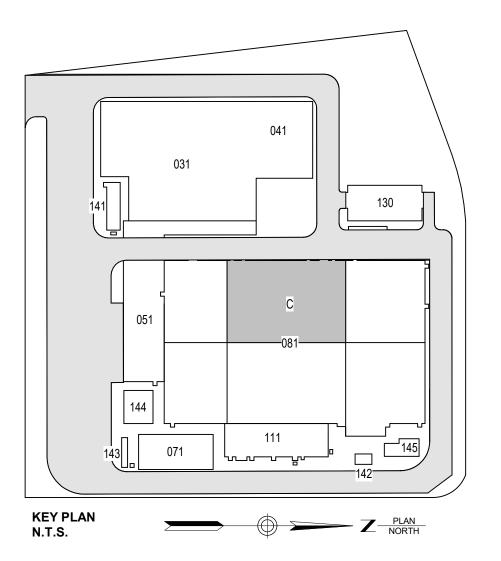

Engineering and Land Surveying, P.C.


370 7th Avenue SUITE 1604 New York, NY 10001

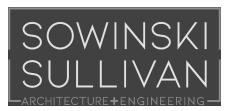

25 Mohawk Avenue Sparta, NJ 07871

### CONFIDENTIAL

THESE DRAWINGS ARE CONFIDENTIAL IN NATURE. ANY MISUSE OR UNAUTHORIZED DISTRIBUTION OF THE DRAWINGS CONTAINED HEREIN WILL BE A VIOLATION OF THIS CONFIDENTIALITY REQUIREMENT AND SUBJECT THE VIOLATOR TO LIABILITY. REVIEW OF THESE MATERIALS BY RECEIPT SHALL CONSTITUTE ACCEPTANCE OF THESE TERMS AND THE TERMS OF ANY UNDERLYING CONFIDENTIALITY AGREEMENT WE MAY HAVE EXCLUDED IN OBTAINING THIS INFORMATION FROM A THIRD PARTY. IF THE RECIPIENT IS NOT IN AGREEMENT WITH THE OBLIGATION OF CONFIDENTIALITY THEN THE DRAWINGS SHALL BE RETURNED TO THE ORIGINATOR.

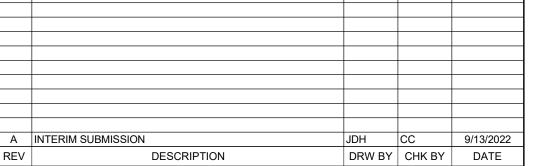

470 Chestnut Ridge Rd # 2, Woodcliff Lake, NJ 07677

**@**Hitachi Energy

901 Main Campus Drive Raleigh, North Carolina 27606

PROJECT




Astoria HVDC Converter Station


31-45 20<sup>th</sup> Avenue, Astoria, Queens NY 11105 Block #850 - Lot #310 - BIN #4624437

COMMUNICATIONS SYSTEMS DEVICE LAYOUT VALVE HALL (NORTH)

I	
DATE	08/29/2022
PROJECT NO	105121
DRAWING BY	J. HOWARD
CHECKED BY	C. CARROL
DRAWING NO	
$\sim$	100 00

CO-103.00

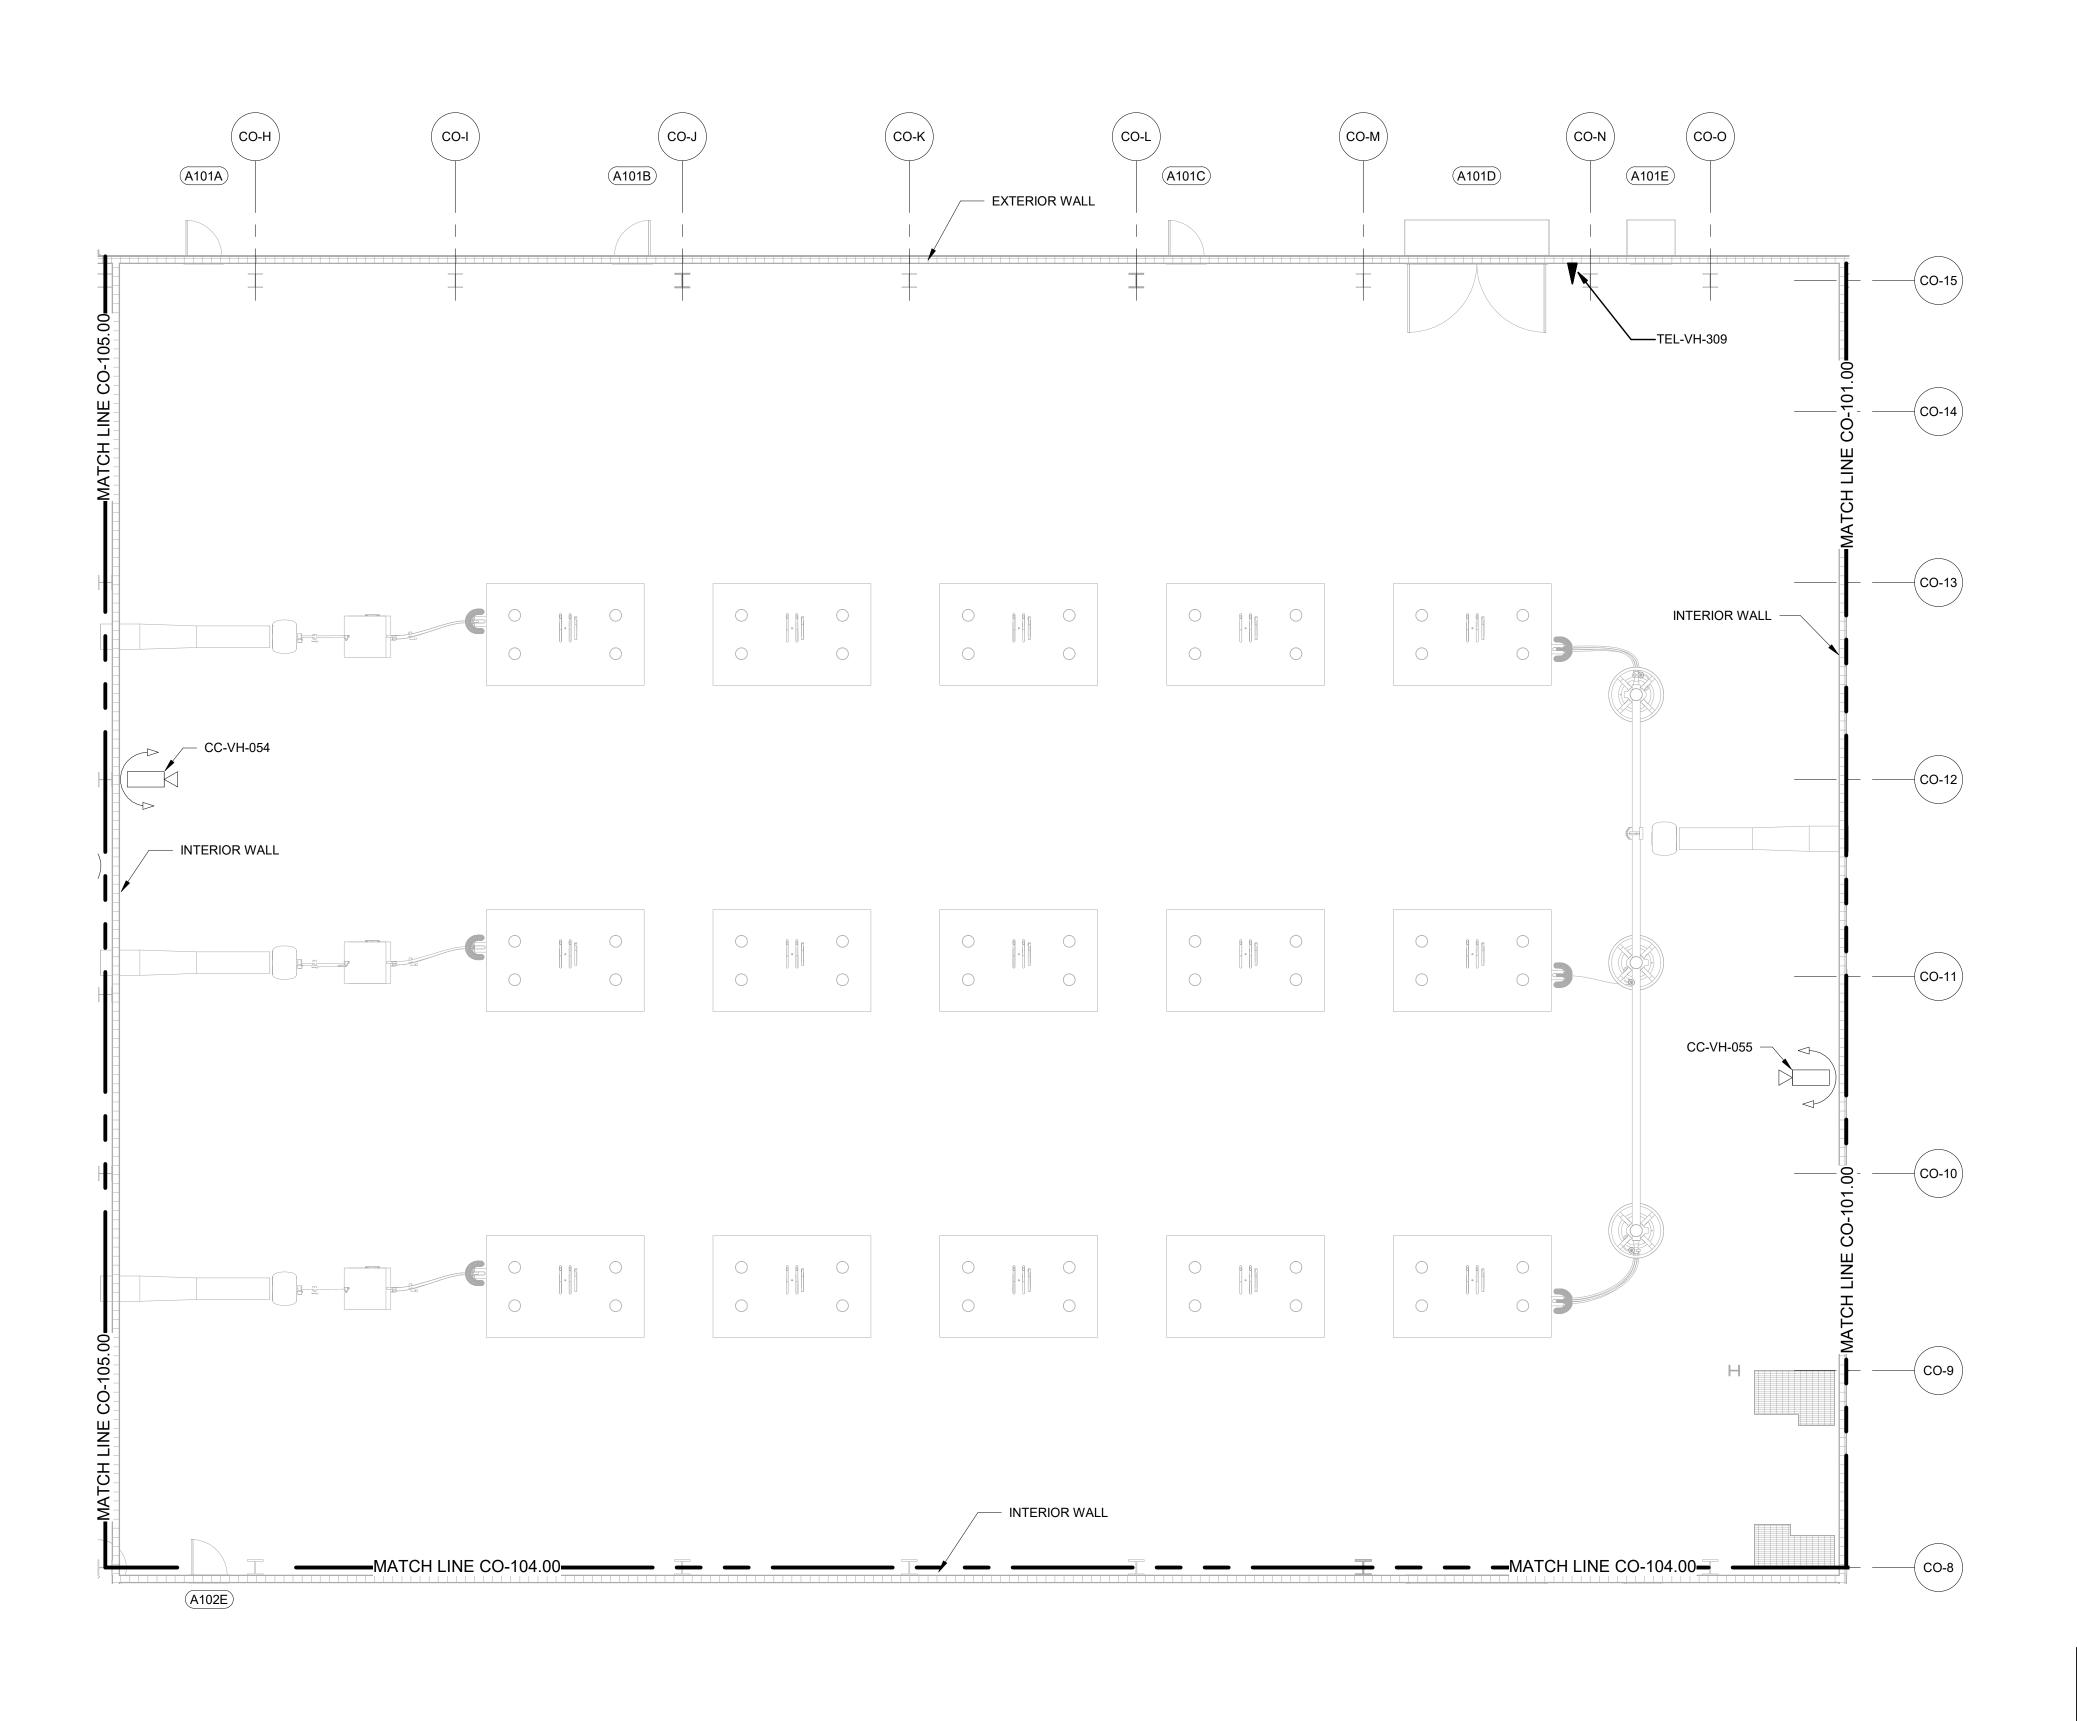


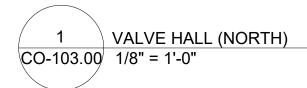



- DOORS AND GATES CONTAINING ACCESS CONTROL AND/OR INTRUSION DETECTION IDENTIFIED WITH A DOOR NUMBER. REFER TO DRAWING CO-222.00 FOR DEVICE ASSIGNMENTS.
- 2. ALL PTZ CAMERAS WITHIN THE CONVERTER BUILDING ARE EMI/RFI RATED

### ISSUED FOR PERMIT

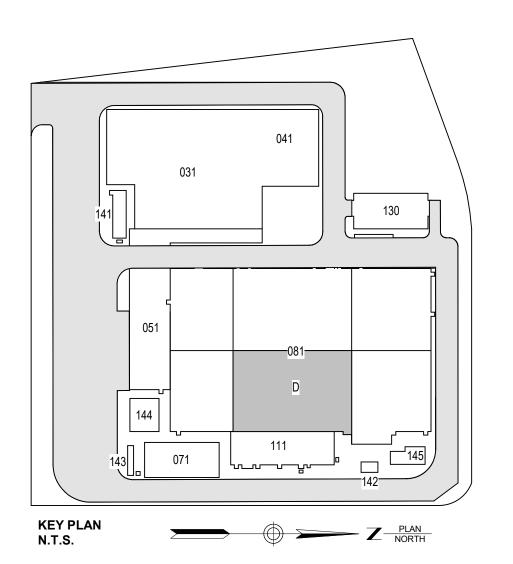

Engineering and Land Surveying, P.C.


370 7th Avenue SUITE 1604 New York, NY 10001



25 Mohawk Avenue Sparta, NJ 07871

#### CONFIDENTIAL

THESE DRAWINGS ARE CONFIDENTIAL IN NATURE. ANY MISUSE OR UNAUTHORIZED DISTRIBUTION OF THE DRAWINGS CONTAINED HEREIN WILL BE A VIOLATION OF THIS CONFIDENTIALITY REQUIREMENT AND SUBJECT THE VIOLATOR TO LIABILITY. REVIEW OF THESE MATERIALS BY RECEIPT SHALL CONSTITUTE ACCEPTANCE OF THESE TERMS AND THE TERMS OF ANY UNDERLYING CONFIDENTIALITY AGREEMENT WE MAY HAVE EXCLUDED IN OBTAINING THIS INFORMATION FROM A THIRD PARTY. IF THE RECIPIENT IS NOT IN AGREEMENT WITH THE OBLIGATION OF CONFIDENTIALITY THEN THE DRAWINGS SHALL BE RETURNED TO THE ORIGINATOR.

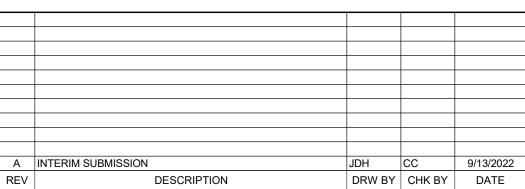

470 Chestnut Ridge Rd # 2, Woodcliff Lake, NJ 07677

**@**Hitachi Energy

901 Main Campus Drive Raleigh, North Carolina 27606

ROJECT




Astoria HVDC Converter Station


31-45 20<sup>th</sup> Avenue, Astoria, Queens NY 11105 Block #850 - Lot #310 - BIN #4624437


COMMUNICATIONS SYSTEMS DEVICE LAYOUT VALVE HALL (SOUTH)

I	
DATE	08/29/2022
PROJECT NO	105121
DRAWING BY	J. HOWARD
CHECKED BY	C. CARROL
DRAWING NO	
	40400

CO-104.00

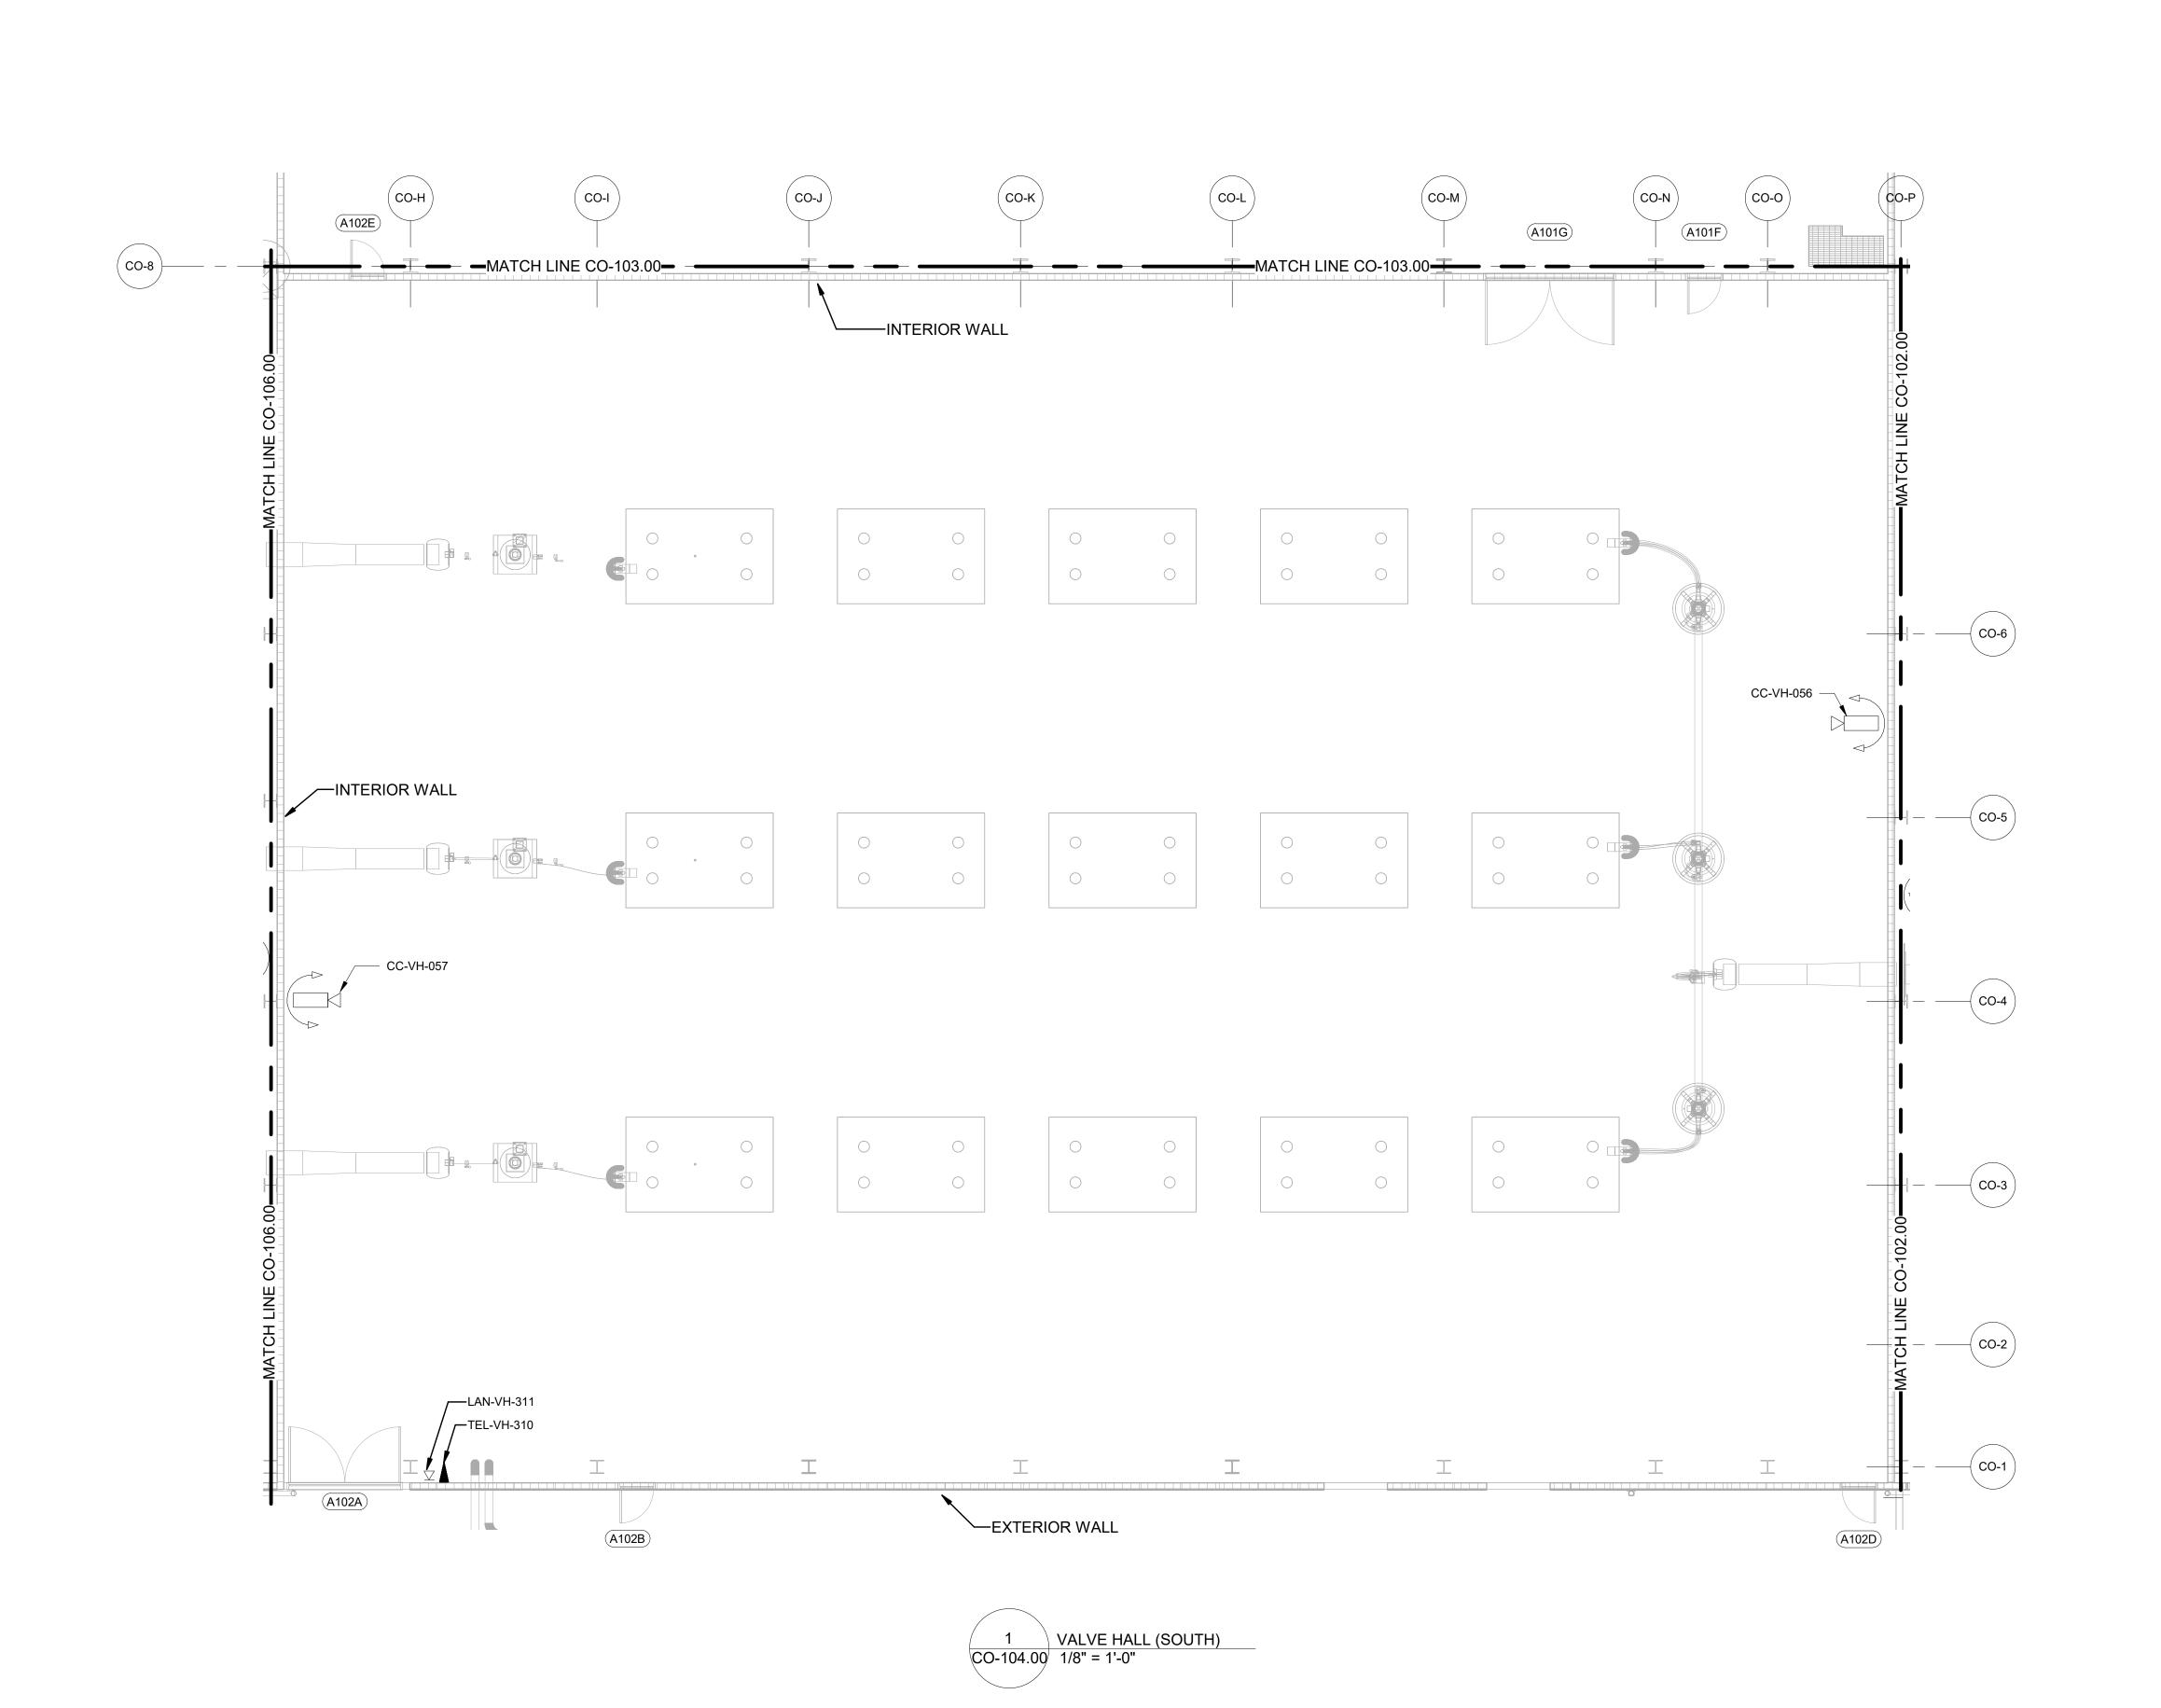


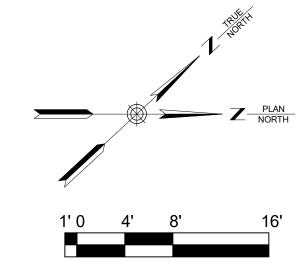

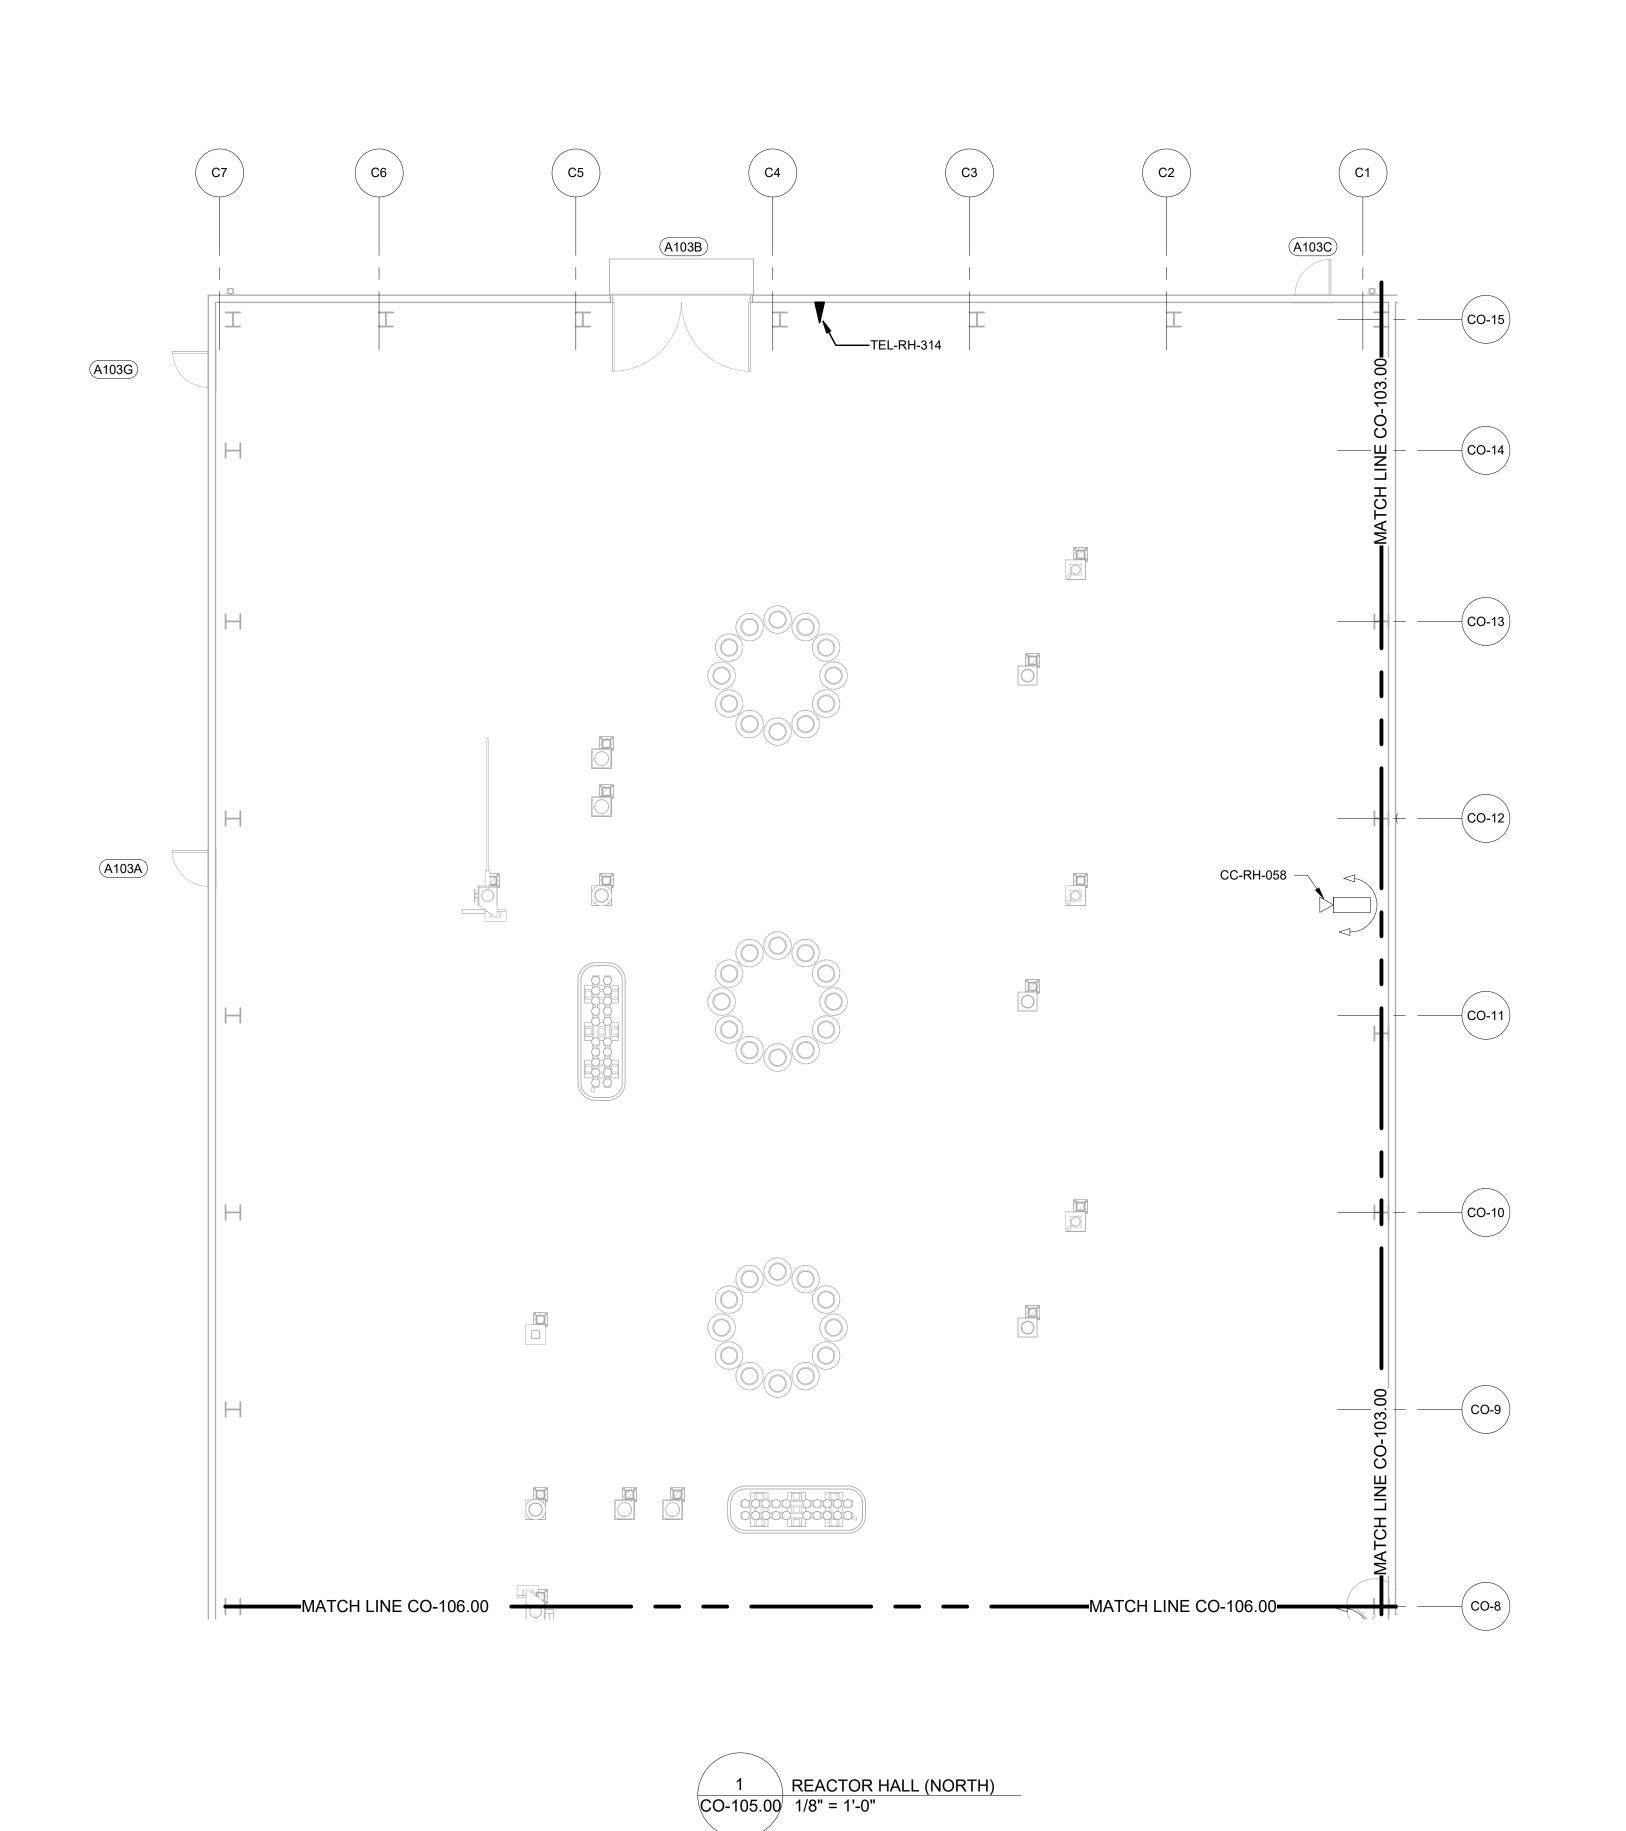

- DOORS AND GATES CONTAINING ACCESS CONTROL AND/OR INTRUSION DETECTION IDENTIFIED WITH A DOOR NUMBER. REFER TO DRAWING CO-222.00 FOR DEVICE ASSIGNMENTS.
- 2. ALL PTZ CAMERAS WITHIN THE CONVERTER BUILDING ARE EMI/RFI RATED

### ISSUED FOR PERMIT

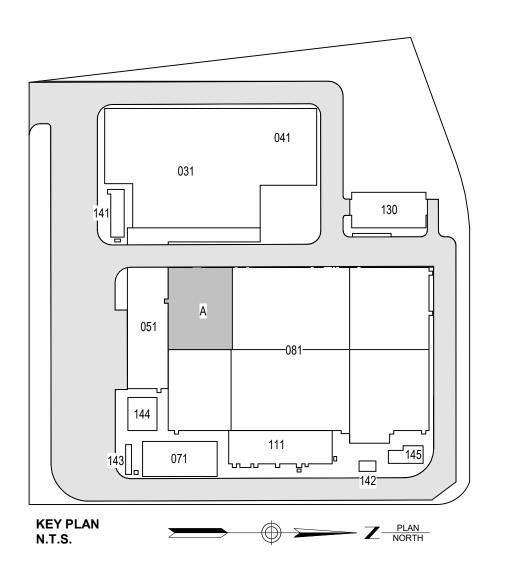

Engineering and Land Surveying, P.C.


370 7th Avenue SUITE 1604 New York, NY 10001



25 Mohawk Avenue Sparta, NJ 07871

#### CONFIDENTIAL

THESE DRAWINGS ARE CONFIDENTIAL IN NATURE. ANY MISUSE OR UNAUTHORIZED DISTRIBUTION OF THE DRAWINGS CONTAINED HEREIN WILL BE A VIOLATION OF THIS CONFIDENTIALITY REQUIREMENT AND SUBJECT THE VIOLATOR TO LIABILITY. REVIEW OF THESE MATERIALS BY RECEIPT SHALL CONSTITUTE ACCEPTANCE OF THESE TERMS AND THE TERMS OF ANY UNDERLYING CONFIDENTIALITY AGREEMENT WE MAY HAVE EXCLUDED IN OBTAINING THIS INFORMATION FROM A THIRD PARTY. IF THE RECIPIENT IS NOT IN AGREEMENT WITH THE OBLIGATION OF CONFIDENTIALITY THEN THE DRAWINGS SHALL BE RETURNED TO THE ORIGINATOR.

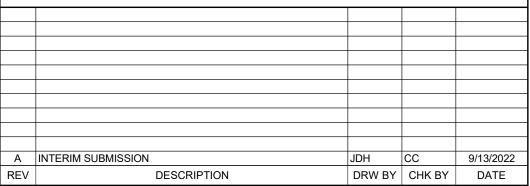



901 Main Campus Drive Raleigh, North Carolina 27606

PROJEC




### Astoria HVDC Converter Station

31-45 20<sup>th</sup> Avenue, Astoria, Queens NY 11105 Block #850 - Lot #310 - BIN #4624437

COMMUNICATIONS SYSTEMS DEVICE LAYOUT REACTOR HALL (NORTH)


DATE	08/29/2022
PROJECT NO	105121
DRAWING BY	J. HOWARD
CHECKED BY	C. CARROL
DRAWING NO	
CO	105 00

CO-105.00

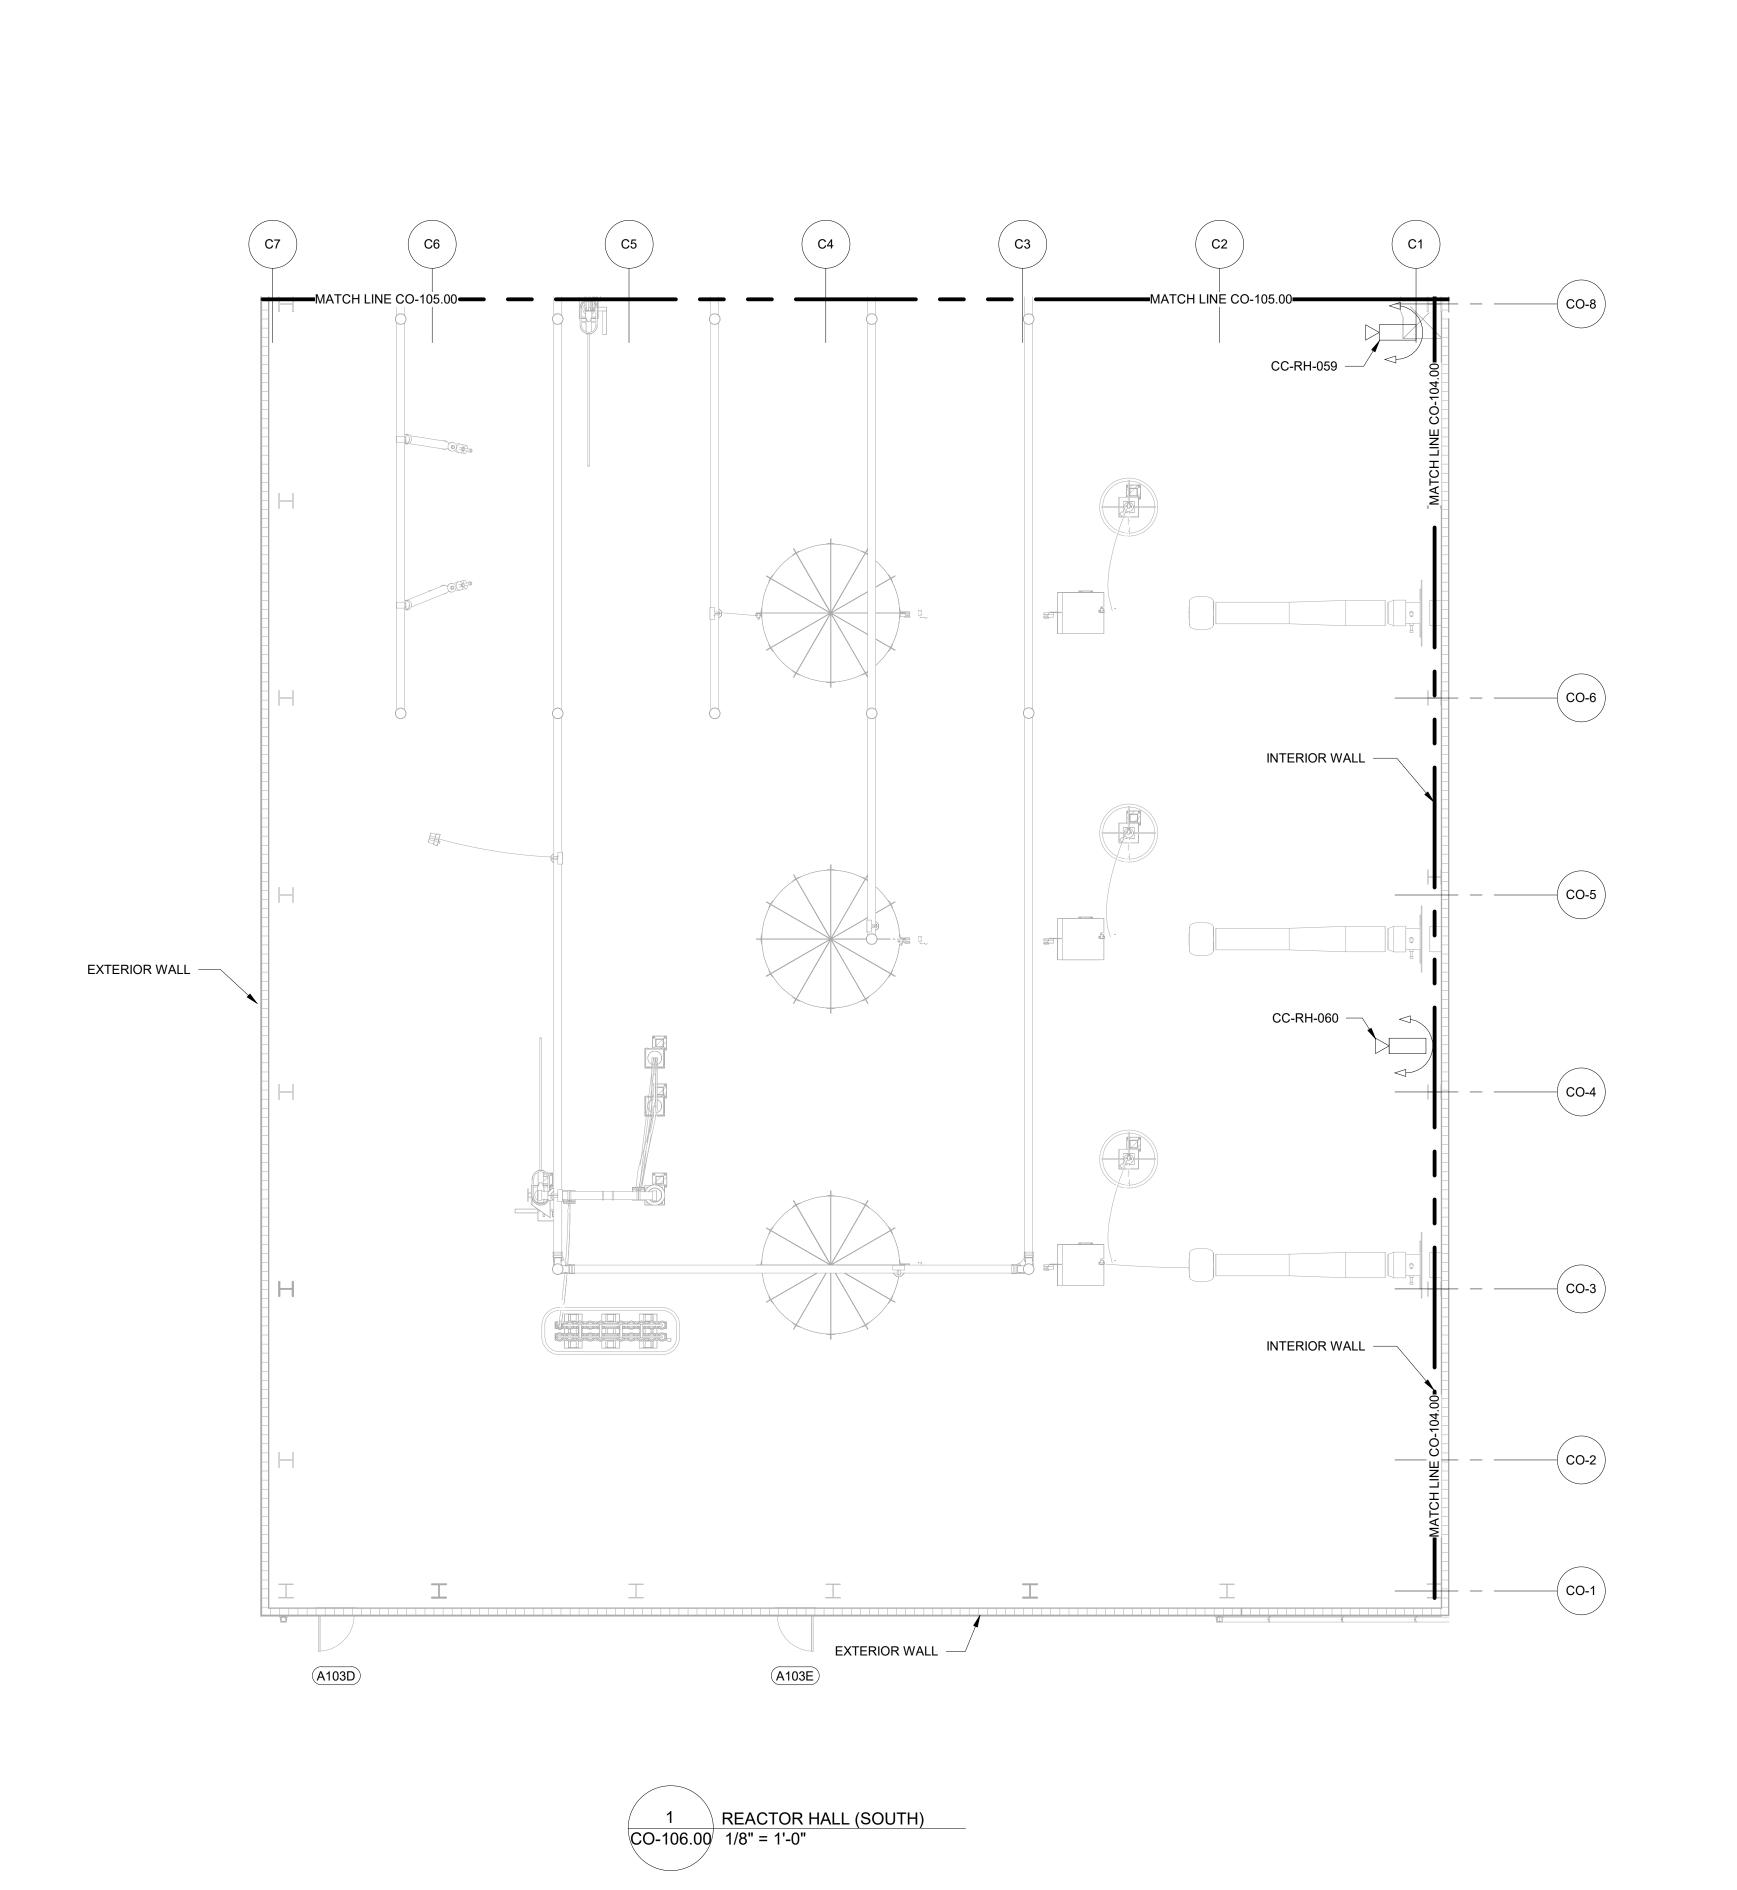

- DOORS AND GATES CONTAINING ACCESS CONTROL AND/OR INTRUSION DETECTION IDENTIFIED WITH A DOOR NUMBER. REFER TO DRAWING CO-222.00 FOR DEVICE ASSIGNMENTS.
- 2. ALL PTZ CAMERAS WITHIN THE CONVERTER BUILDING ARE EMI/RFI RATED

### ISSUED FOR PERMIT

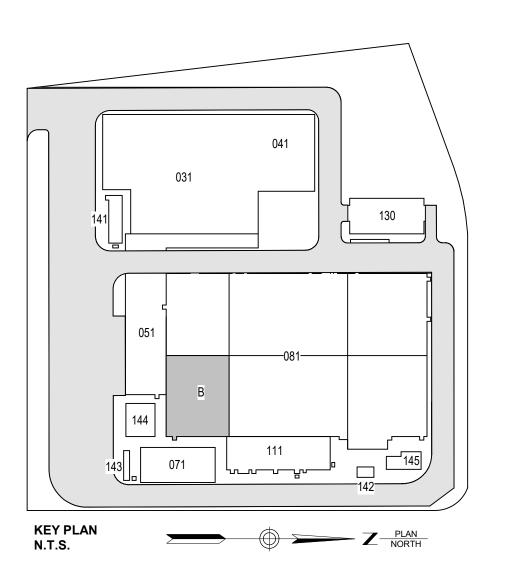




370 7th Avenue SUITE 1604 New York, NY 10001



25 Mohawk Avenue Sparta, NJ 07871

#### CONFIDENTIAL

THESE DRAWINGS ARE CONFIDENTIAL IN NATURE. ANY MISUSE OR UNAUTHORIZED DISTRIBUTION OF THE DRAWINGS CONTAINED HEREIN WILL BE A VIOLATION OF THIS CONFIDENTIALITY REQUIREMENT AND SUBJECT THE VIOLATOR TO LIABILITY. REVIEW OF THESE MATERIALS BY RECEIPT SHALL CONSTITUTE ACCEPTANCE OF THESE TERMS AND THE TERMS OF ANY UNDERLYING CONFIDENTIALITY AGREEMENT WE MAY HAVE EXCLUDED IN OBTAINING THIS INFORMATION FROM A THIRD PARTY. IF THE RECIPIENT IS NOT IN AGREEMENT WITH THE OBLIGATION OF CONFIDENTIALITY THEN THE DRAWINGS SHALL BE RETURNED TO THE ORIGINATOR.

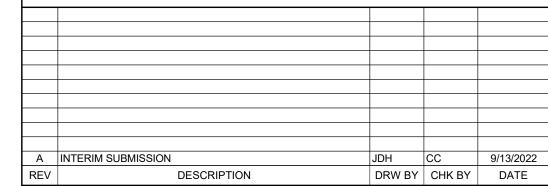



901 Main Campus Drive Raleigh, North Carolina 27606

PROJECT



Astoria HVDC Converter Station

31-45 20<sup>th</sup> Avenue, Astoria, Queens NY 11105 Block #850 - Lot #310 - BIN #4624437


COMMUNICATIONS SYSTEMS DEVICE LAYOUT REACTOR HALL (SOUTH)


I	
DATE	08/29/2022
PROJECT NO	105121
DRAWING BY	J. HOWARD
CHECKED BY	C. CARROL
DRAWING NO	
$\sim$	100 00

CO-106.00

 DOORS AND GATES CONTAINING ACCESS CONTROL AND/OR INTRUSION DETECTION IDENTIFIED WITH A DOOR NUMBER. REFER TO DRAWING CO-222.00 FOR DEVICE ASSIGNMENTS.

### ISSUED FOR PERMIT

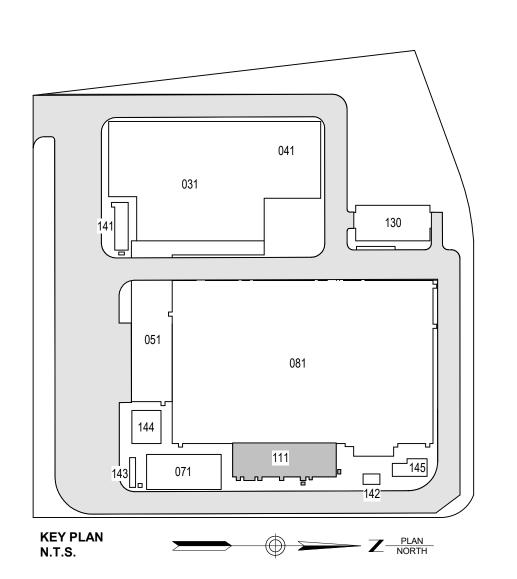

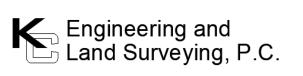

370 7th Avenue SUITE 1604 New York, NY 10001



25 Mohawk Avenue Sparta, NJ 07871

#### CONFIDENTIAL

THESE DRAWINGS ARE CONFIDENTIAL IN NATURE. ANY MISUSE OR UNAUTHORIZED DISTRIBUTION OF THE DRAWINGS CONTAINED HEREIN WILL BE A VIOLATION OF THIS CONFIDENTIALITY REQUIREMENT AND SUBJECT THE VIOLATOR TO LIABILITY. REVIEW OF THESE MATERIALS BY RECEIPT SHALL CONSTITUTE ACCEPTANCE OF THESE TERMS AND THE TERMS OF ANY UNDERLYING CONFIDENTIALITY AGREEMENT WE MAY HAVE EXCLUDED IN OBTAINING THIS INFORMATION FROM A THIRD PARTY. IF THE RECIPIENT IS NOT IN AGREEMENT WITH THE OBLIGATION OF CONFIDENTIALITY THEN THE DRAWINGS SHALL BE RETURNED TO THE ORIGINATOR.

В	FINAL SUBMISSION	JDH	RAB	12/08/2022
Α	INTERIM SUBMISSION	JDH	CC	9/13/2022
REV	DESCRIPTION	DRW BY	CHK BY	DATE



Hitachi Energy901 Main Campus Drive Raleigh, North Carolina 27606

PROJECT



### Astoria HVDC Converter Station


31-45 20<sup>th</sup> Avenue, Astoria, Queens NY 11105 Block #850 - Lot #310 - BIN #4624437


COMMUNICATIONS
SYSTEMS DEVICE LAYOUT
SERVICE BULDING
LEVEL-1 (SOUTH)

DATE	08/29/2022
PROJECT NO	105121
DRAWING BY	J.HOWARD
CHECKED BY	C.CARROL
DRAWING NO	
	107 00

CO-107.00

CADD FILE NO
Autodesk Docs://CHPE
Astoria/CHA-KIE-111-2Z-M3-CO-001.rvt

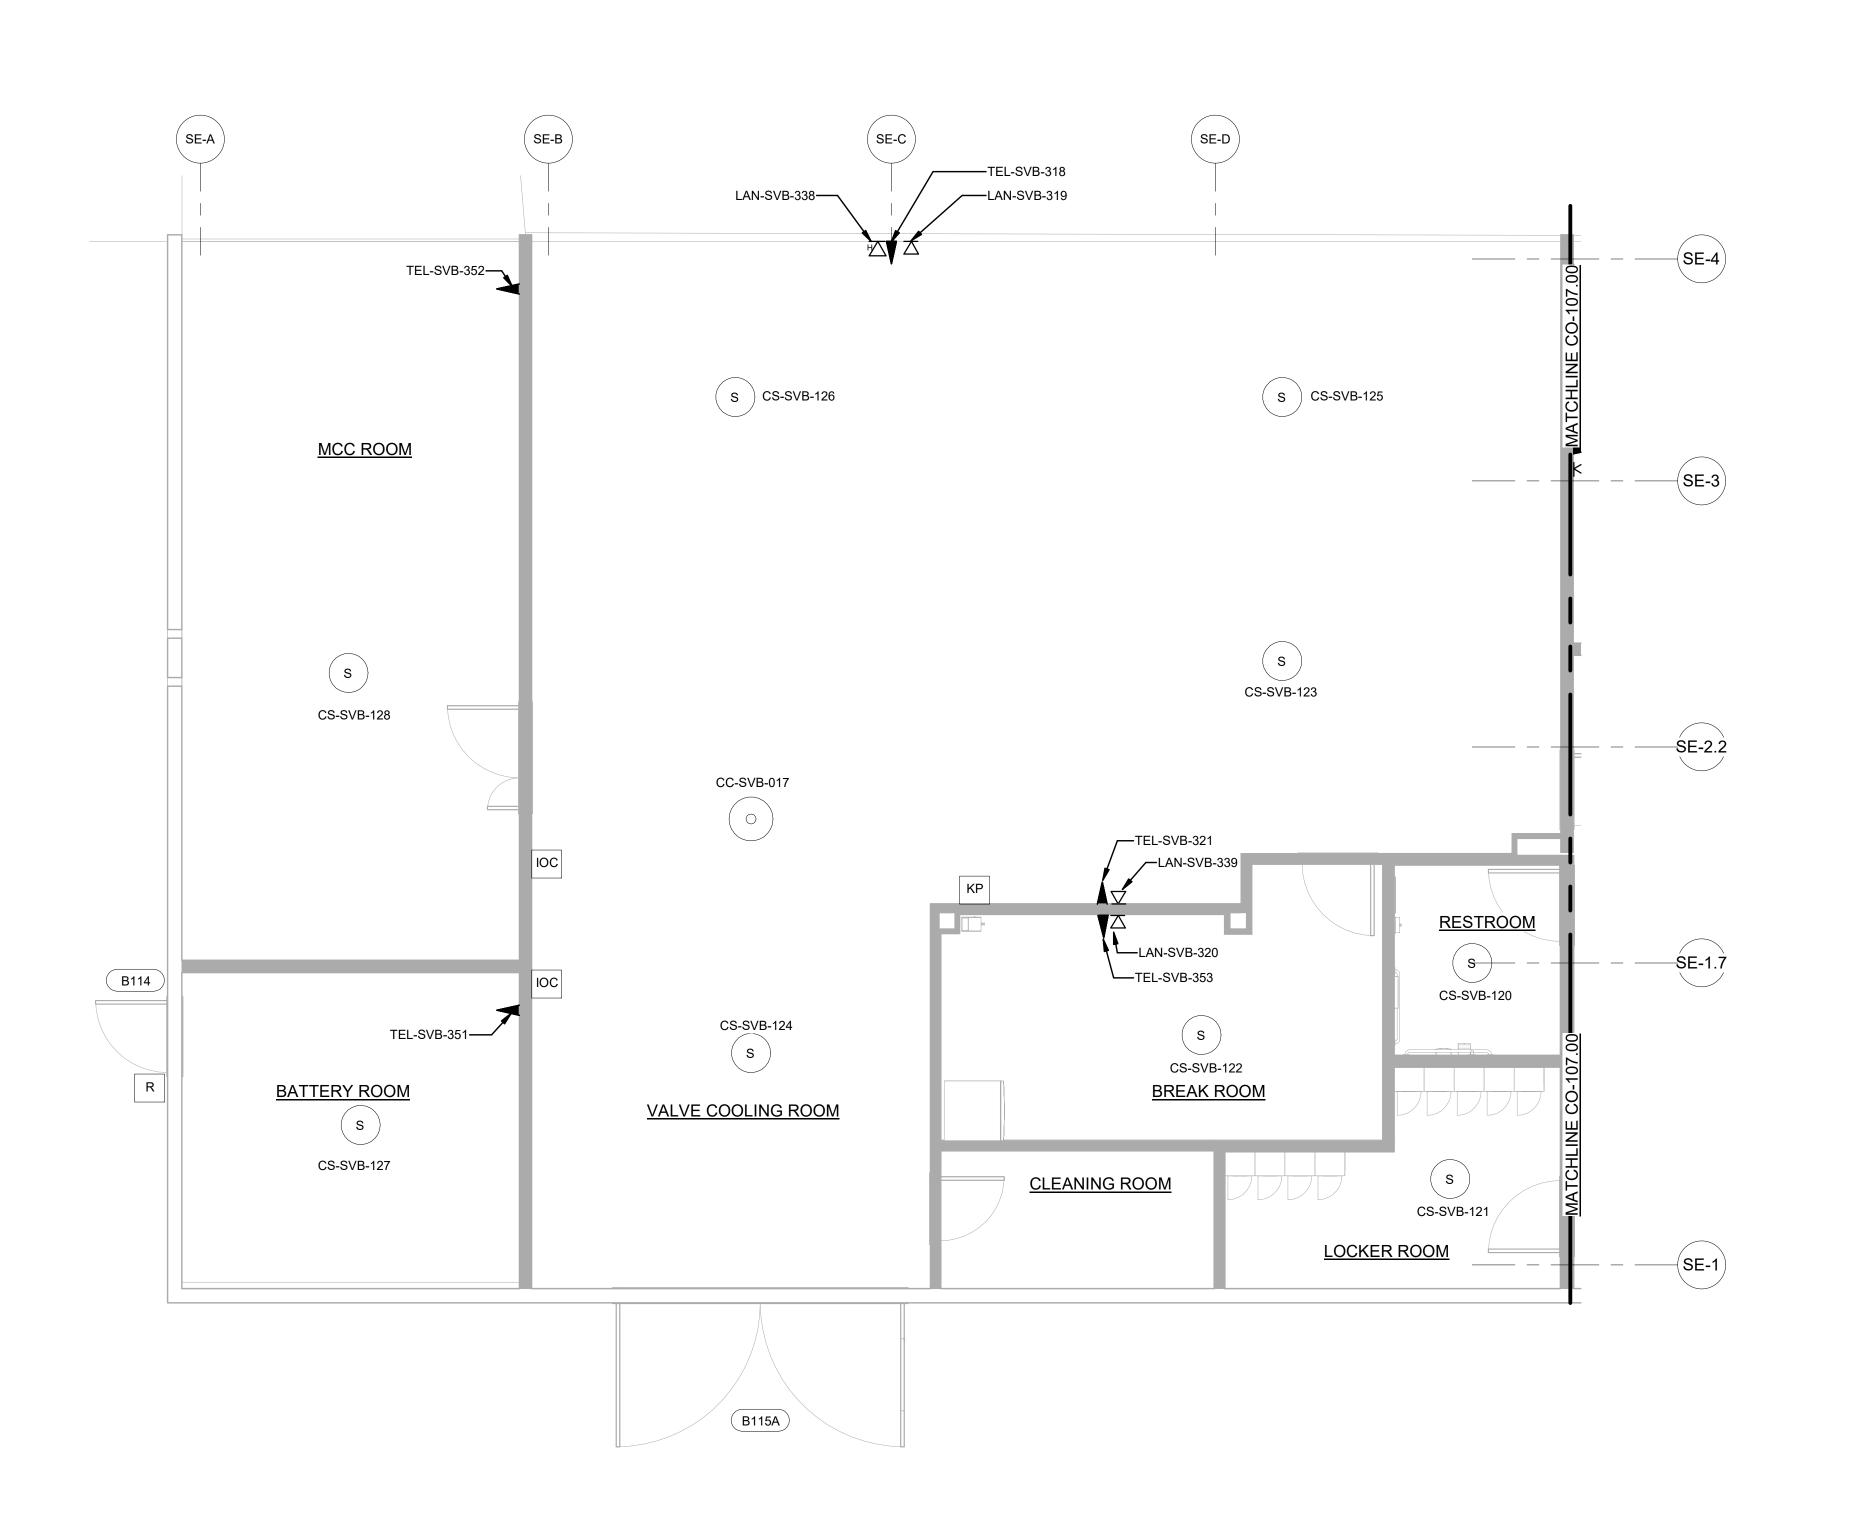


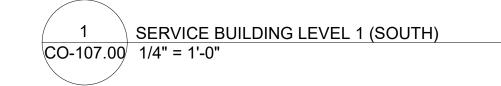



 DOORS AND GATES CONTAINING ACCESS CONTROL AND/OR INTRUSION DETECTION IDENTIFIED WITH A DOOR NUMBER. REFER TO DRAWING CO-222.00 FOR DEVICE ASSIGNMENTS.



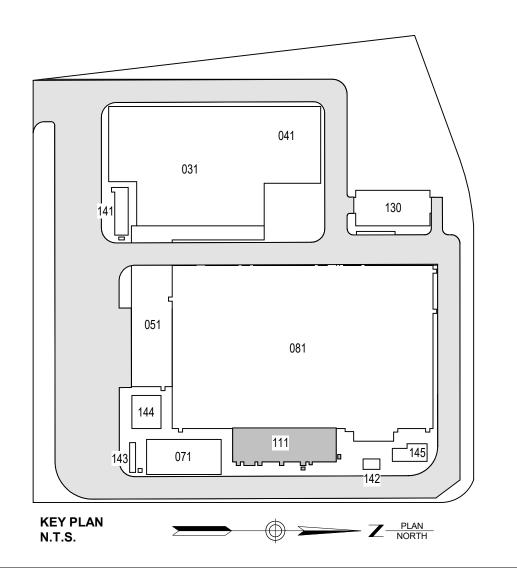

Engineering and Land Surveying, P.C.

370 7th Avenue SUITE 1604 New York, NY 10001



25 Mohawk Avenue Sparta, NJ 07871

### CONFIDENTIAL

THESE DRAWINGS ARE CONFIDENTIAL IN NATURE. ANY MISUSE OR UNAUTHORIZED DISTRIBUTION OF THE DRAWINGS CONTAINED HEREIN WILL BE A VIOLATION OF THIS CONFIDENTIALITY REQUIREMENT AND SUBJECT THE VIOLATOR TO LIABILITY. REVIEW OF THESE MATERIALS BY RECEIPT SHALL CONSTITUTE ACCEPTANCE OF THESE TERMS AND THE TERMS OF ANY UNDERLYING CONFIDENTIALITY AGREEMENT WE MAY HAVE EXCLUDED IN OBTAINING THIS INFORMATION FROM A THIRD PARTY. IF THE RECIPIENT IS NOT IN AGREEMENT WITH THE OBLIGATION OF CONFIDENTIALITY THEN THE DRAWINGS SHALL BE RETURNED TO THE ORIGINATOR.

				·
В	FINAL SUBMISSION	JDH	RAB	12/08/2022
Α	INTERIM SUBMISSION	JDH	CC	9/13/2022
REV	DESCRIPTION	DRW BY	CHK BY	DATE

470 Chestnut Ridge Rd # 2, Woodcliff Lake, NJ 07677

**@ Hitachi Energy**901 Main Campus Drive

901 Main Campus Drive Raleigh, North Carolina 27606

PROJECT



### Astoria HVDC Converter Station

31-45 20<sup>th</sup> Avenue, Astoria, Queens NY 11105 Block #850 - Lot #310 - BIN #4624437


COMMUNICATIONS
SYSTEMS DEVICE LAYOUT
SERVICE BUILDING
LEVEL-1 (NORTH)

DATE	08/29/2022
PROJECT NO	105121
DRAWING BY	J.HOWARD
CHECKED BY	C.CARROL
DRAWING NO	
	100 00

CO-108.00


CADD FILE NO
Autodesk Docs://CHPE
Astoria/CHA-KIE-111-ZZ-M3-CO-001.rvt

1 SERVICE BUILDING LEVEL 1 (NORTH)
CO-108.00 1/4" = 1'-0"

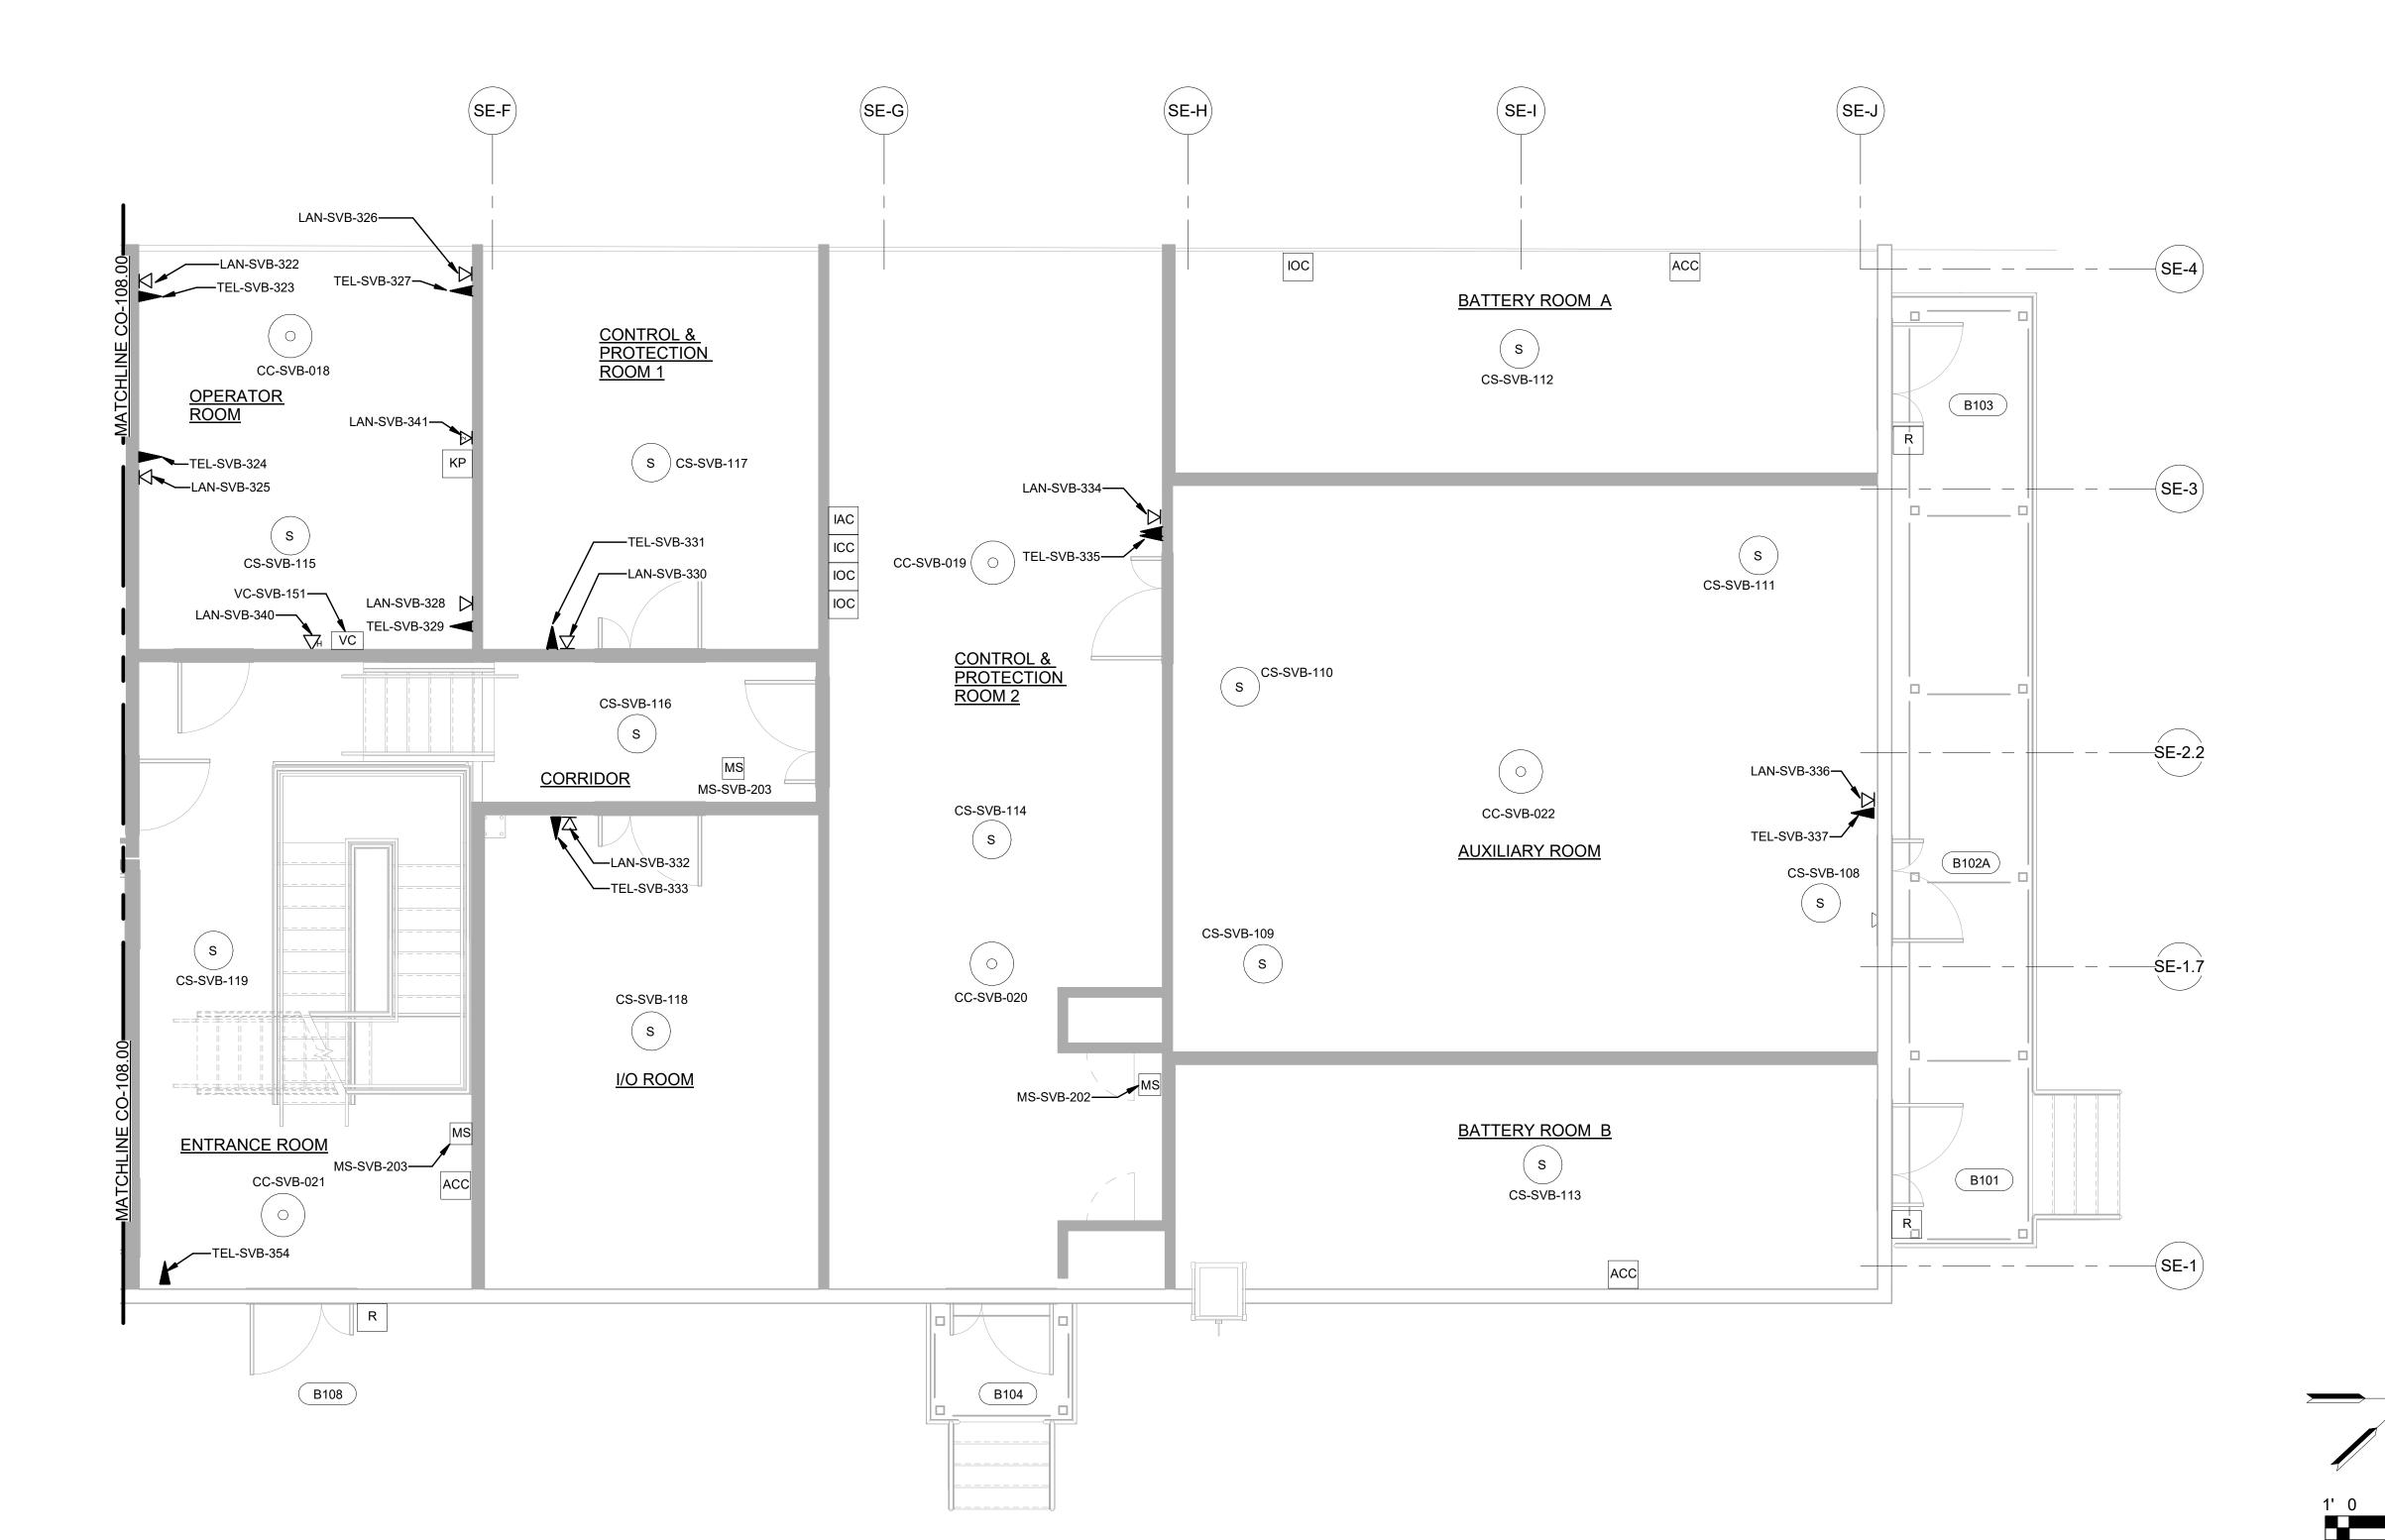

 DOORS AND GATES CONTAINING ACCESS CONTROL AND/OR INTRUSION DETECTION IDENTIFIED WITH A DOOR NUMBER. REFER TO DRAWING CO-222.00 FOR DEVICE ASSIGNMENTS.

### ISSUED FOR PERMIT

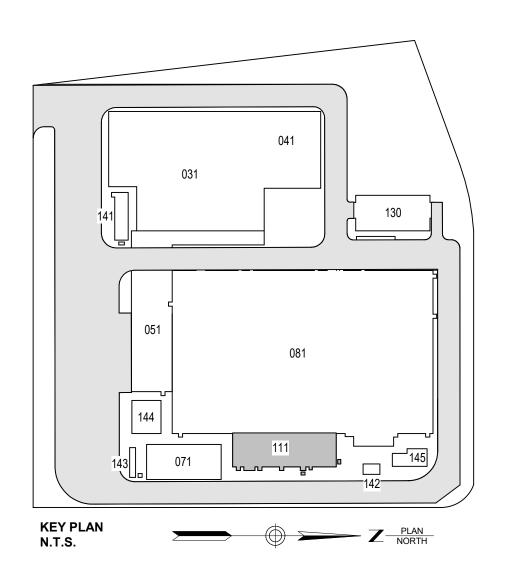

Engineering and Land Surveying, P.C.

370 7th Avenue SUITE 1604 New York, NY 10001



25 Mohawk Avenue Sparta, NJ 07871

#### CONFIDENTIAL

THESE DRAWINGS ARE CONFIDENTIAL IN NATURE. ANY MISUSE OR UNAUTHORIZED DISTRIBUTION OF THE DRAWINGS CONTAINED HEREIN WILL BE A VIOLATION OF THIS CONFIDENTIALITY REQUIREMENT AND SUBJECT THE VIOLATOR TO LIABILITY. REVIEW OF THESE MATERIALS BY RECEIPT SHALL CONSTITUTE ACCEPTANCE OF THESE TERMS AND THE TERMS OF ANY UNDERLYING CONFIDENTIALITY AGREEMENT WE MAY HAVE EXCLUDED IN OBTAINING THIS INFORMATION FROM A THIRD PARTY. IF THE RECIPIENT IS NOT IN AGREEMENT WITH THE OBLIGATION OF CONFIDENTIALITY THEN THE DRAWINGS SHALL BE RETURNED TO THE ORIGINATOR.

В	FINAL SUBMISSION	JDH	RAB	12/08/2022
Α	INTERIM SUBMISSION	JDH	CC	9/13/2022
REV	DESCRIPTION	DRW BY	CHK BY	DATE



Hitachi Energy901 Main Campus Drive Raleigh, North Carolina 27606

NJ 07677 Raleigh, North Carolina 2

PROJECT




### Astoria HVDC Converter Station

31-45 20<sup>th</sup> Avenue, Astoria, Queens NY 11105 Block #850 - Lot #310 - BIN #4624437

COMMUNICATIONS
SYSTEMS DEVICE LAYOUT
SERVICE BUILDING
LEVEL-2 (SOUTH)

DATE 08/29/2022
PROJECT NO 105121
DRAWING BY J.HOWARD
CHECKED BY C.CARROL
DRAWING NO
CO-109.00

CADD FILE NO
Autodesk Docs://CHPE
Astoria/CHA-KIE-111-ZZ-M3-CO-001.rvt

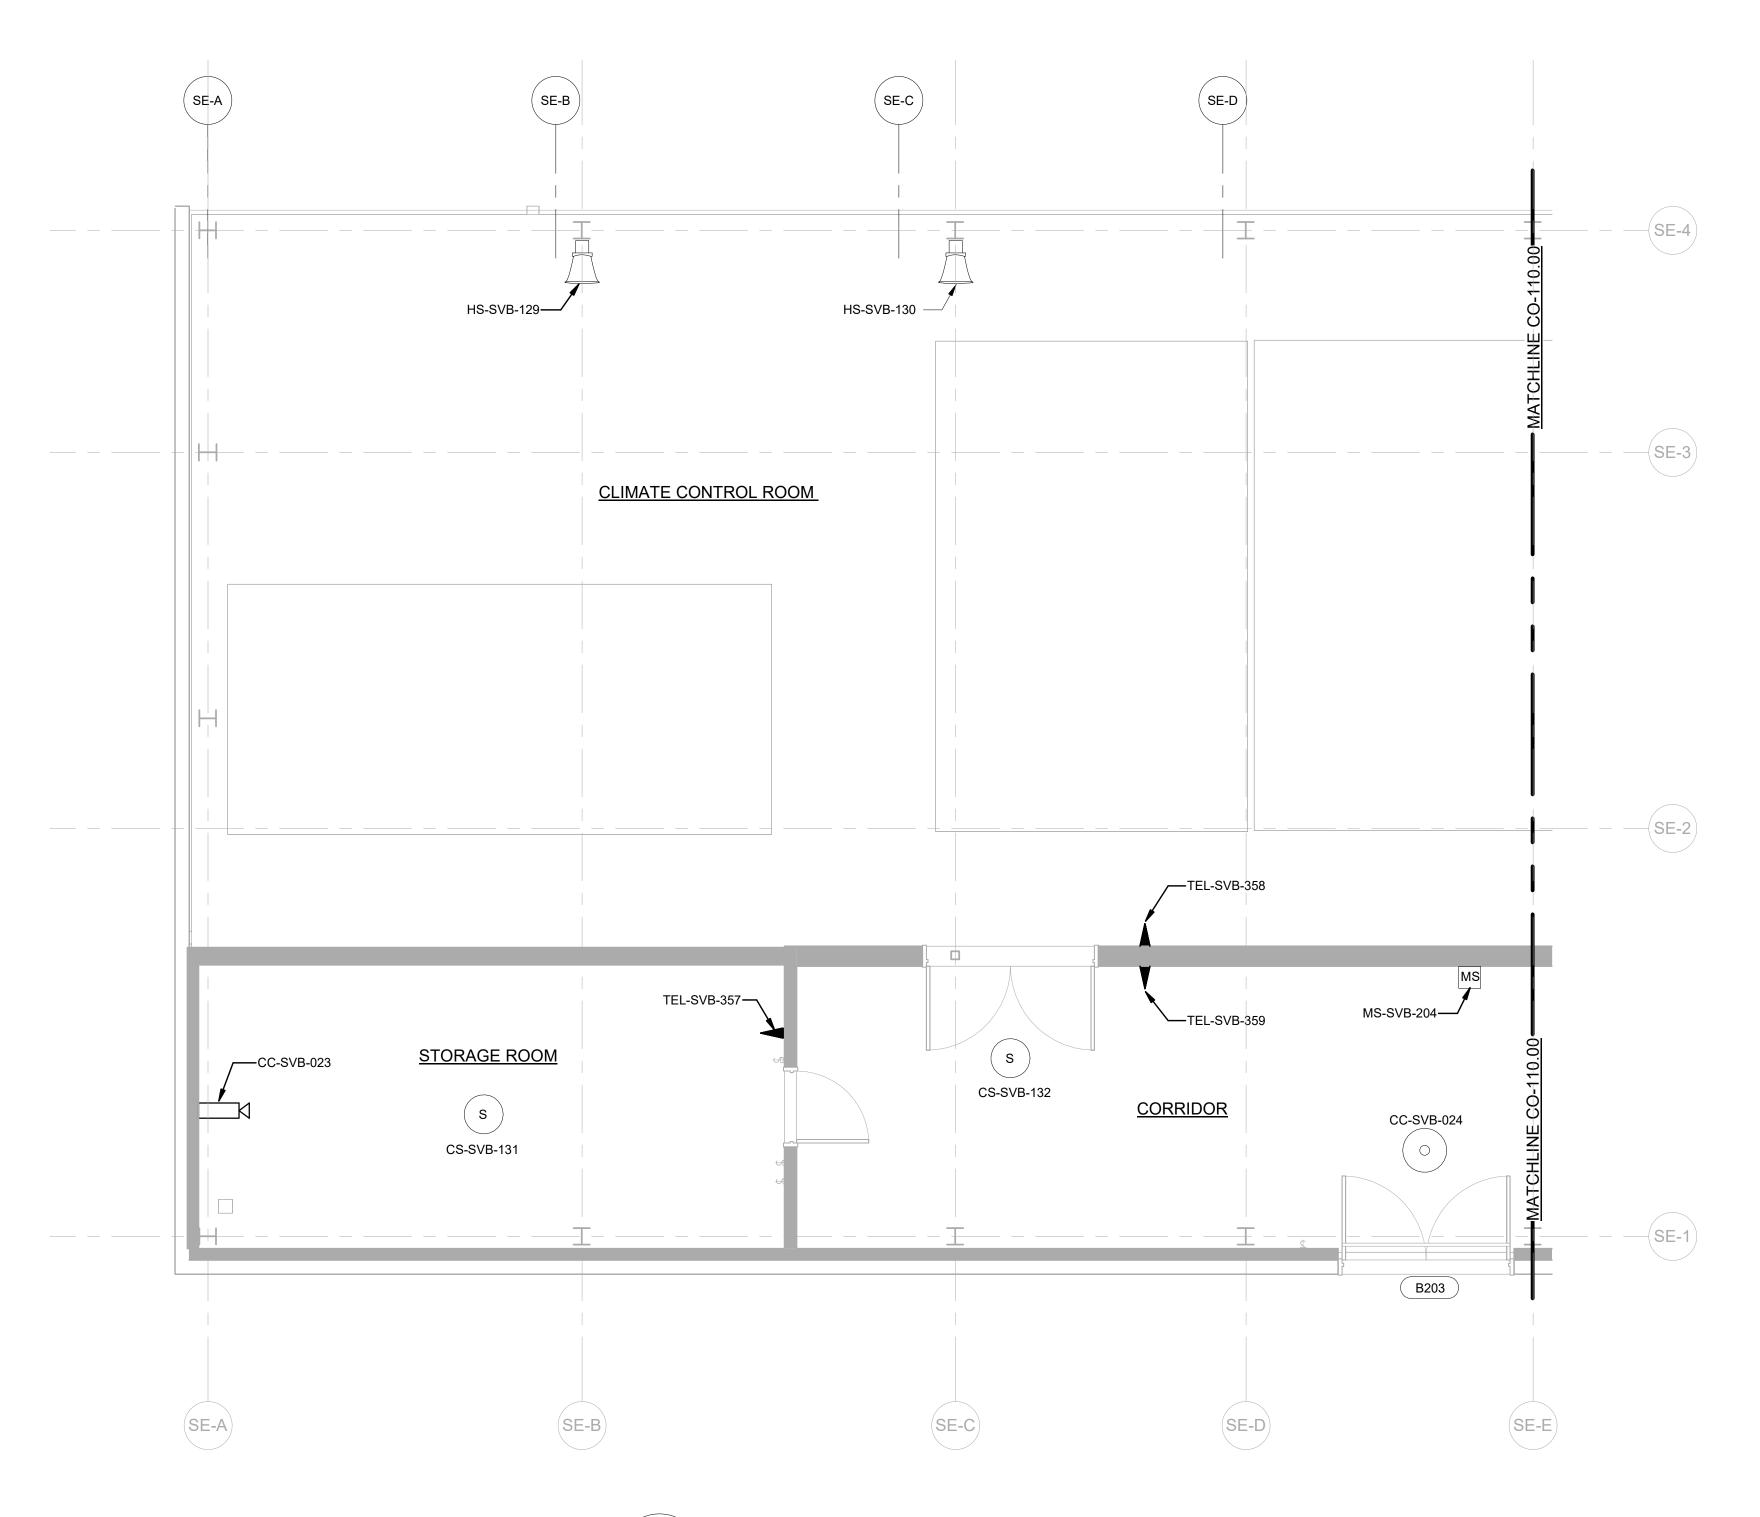


1 SERVICE BUILDING LEVEL 2 (SOUTH)
CO-109.00 1/4" = 1'-0"



 DOORS AND GATES CONTAINING ACCESS CONTROL AND/OR INTRUSION DETECTION IDENTIFIED WITH A DOOR NUMBER. REFER TO DRAWING CO-222.00 FOR DEVICE ASSIGNMENTS.

### ISSUED FOR PERMIT

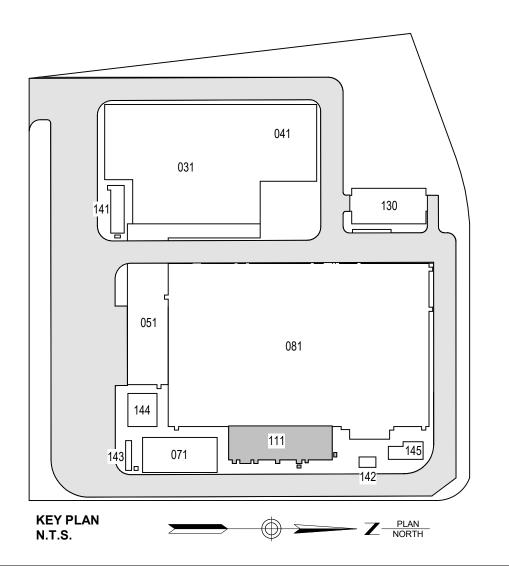

Engineering and Land Surveying, P.C.

370 7th Avenue SUITE 1604 New York, NY 10001



25 Mohawk Avenue Sparta, NJ 07871

#### CONFIDENTIAL

THESE DRAWINGS ARE CONFIDENTIAL IN NATURE. ANY MISUSE OR UNAUTHORIZED DISTRIBUTION OF THE DRAWINGS CONTAINED HEREIN WILL BE A VIOLATION OF THIS CONFIDENTIALITY REQUIREMENT AND SUBJECT THE VIOLATOR TO LIABILITY. REVIEW OF THESE MATERIALS BY RECEIPT SHALL CONSTITUTE ACCEPTANCE OF THESE TERMS AND THE TERMS OF ANY UNDERLYING CONFIDENTIALITY AGREEMENT WE MAY HAVE EXCLUDED IN OBTAINING THIS INFORMATION FROM A THIRD PARTY. IF THE RECIPIENT IS NOT IN AGREEMENT WITH THE OBLIGATION OF CONFIDENTIALITY THEN THE DRAWINGS SHALL BE RETURNED TO THE ORIGINATOR.

В	FINAL SUBMISSION	JDH	RAB	12/08/2022
Α	INTERIM SUBMISSION	JDH	CC	9/13/2022
RFV	DESCRIPTION	DRW BY	CHK BY	DATE



901 Main Campus Drive Raleigh, North Carolina 27606

PROJECT




### Astoria HVDC Converter Station

31-45 20<sup>th</sup> Avenue, Astoria, Queens NY 11105 Block #850 - Lot #310 - BIN #4624437

COMMUNICATIONS
SYSTEMS DEVICE LAYOUT
SERVICE BUILDING
LEVEL-2 (NORTH)

DATE	08/29/2022
PROJECT NO	105121
DRAWING BY	J.HOWARD
CHECKED BY	C.CARROL
DRAWING NO	
CO	110 00


CADD FILE NO
Autodesk Docs://CHPE
Astoria/CHA-KIE-111-ZZ-M3-CO-001.rvt

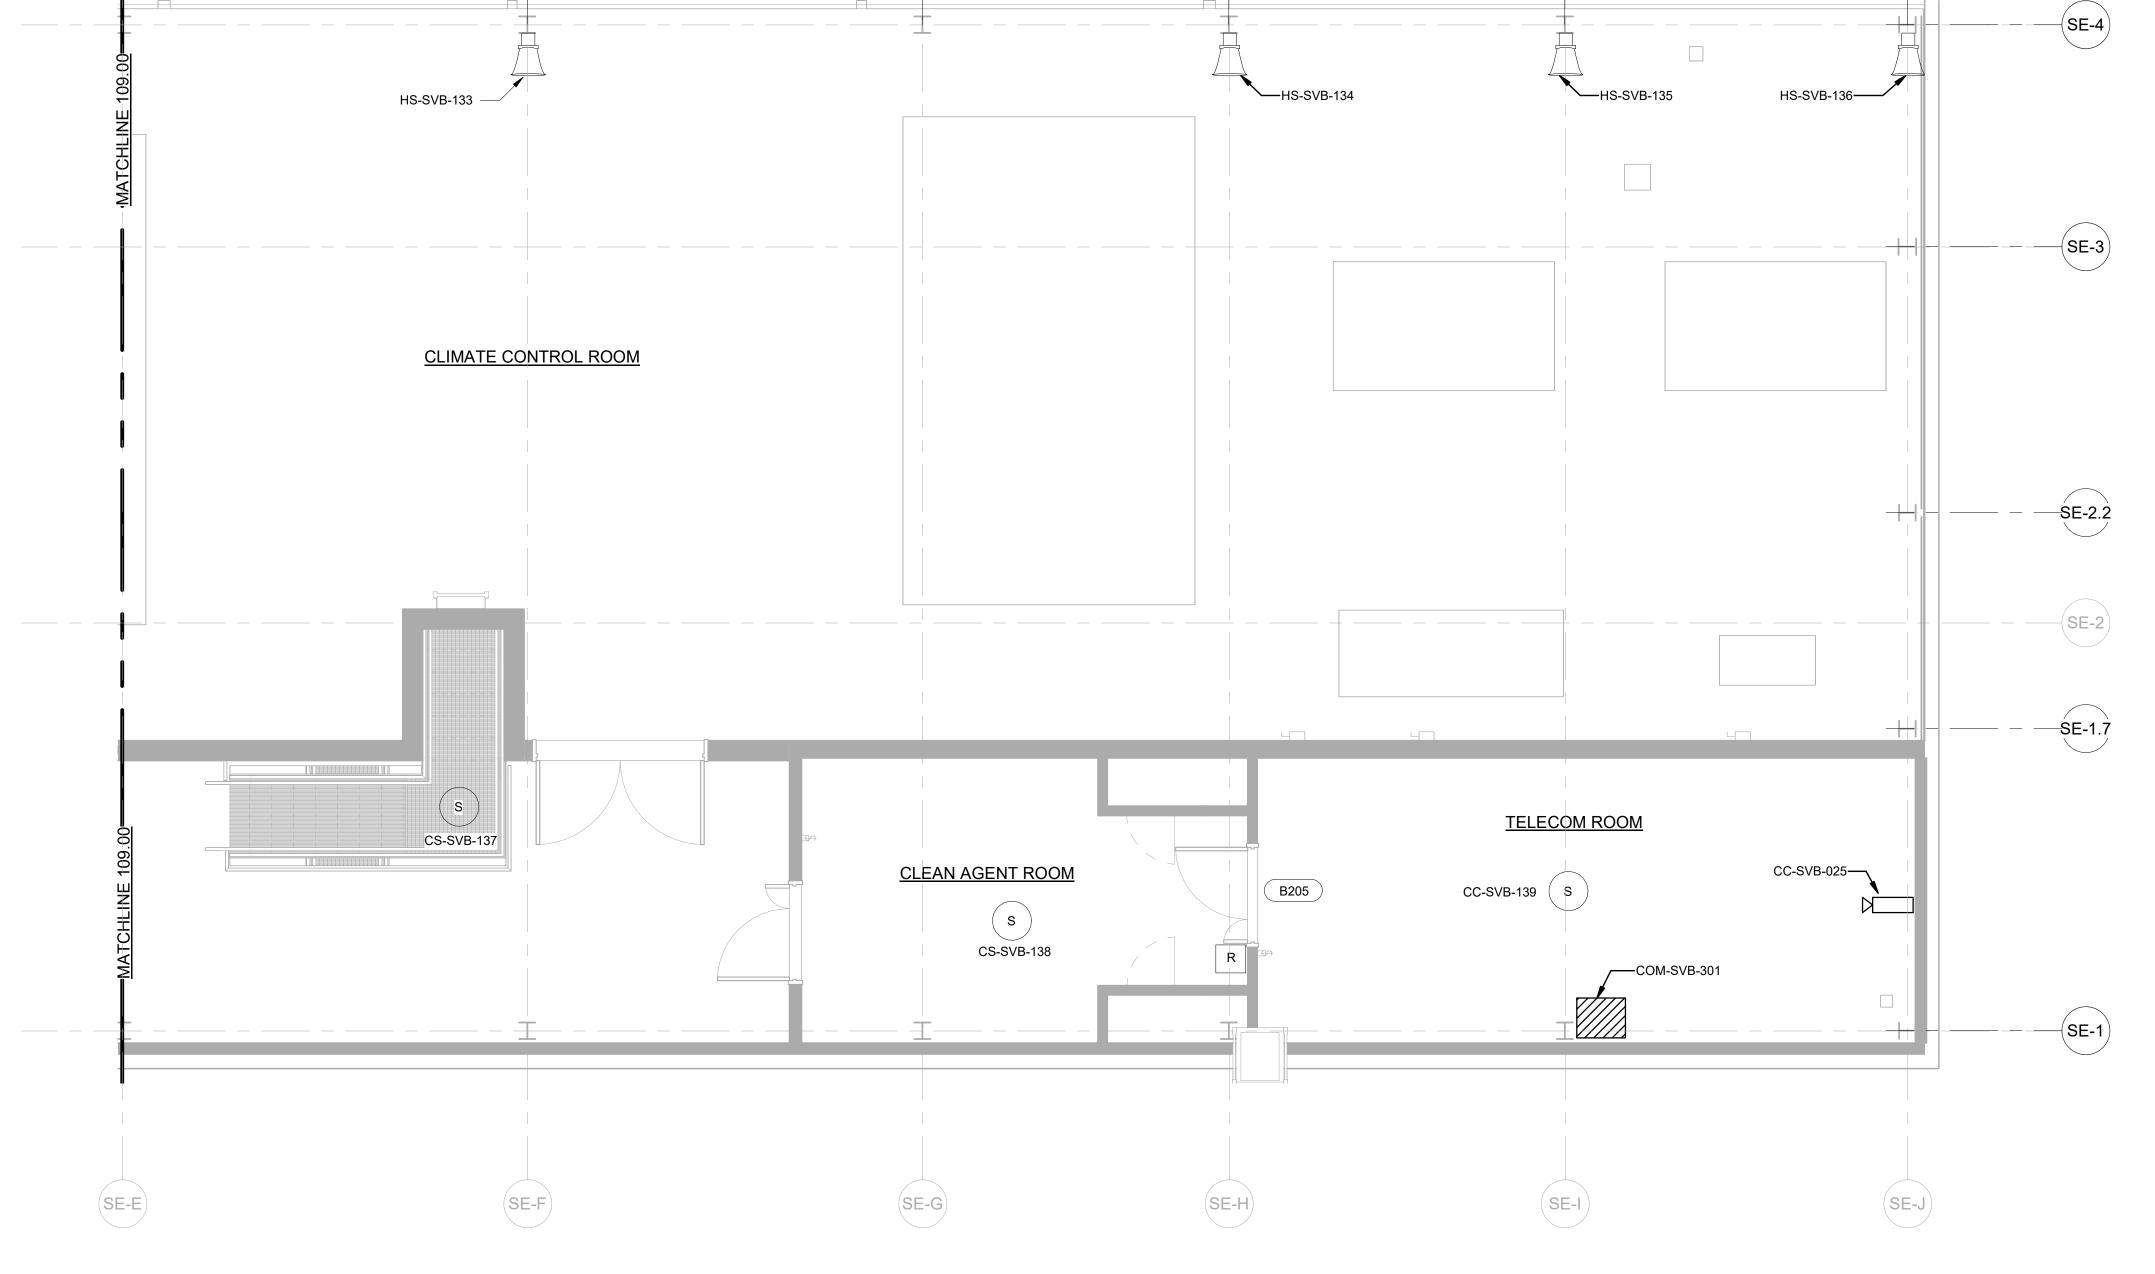

1 SERVICE BUILDING LEVEL 2 (NORTH)
CO-110.00 1/4" = 1'-0"

1. DOORS AND GATES CONTAINING ACCESS CONTROL AND/OR INTRUSION DETECTION IDENTIFIED WITH A DOOR NUMBER. REFER TO DRAWING CO-223.00 FOR DEVICE ASSIGNMENTS.

### ISSUED FOR PERMIT

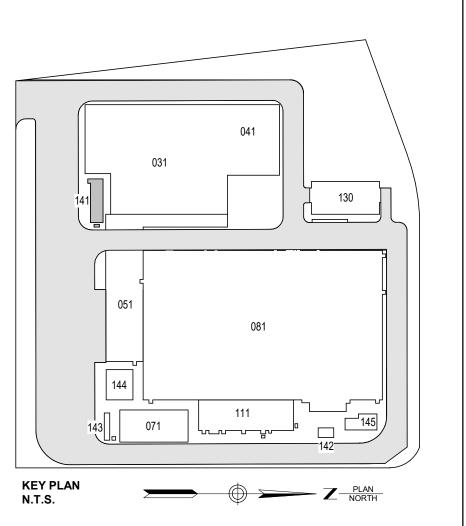




370 7th Avenue SUITE 1604 New York, NY 10001



25 Mohawk Avenue Sparta, NJ 07871

### CONFIDENTIAL THESE DRAWINGS ARE CONFIDENTIAL IN NATURE. ANY MISUSE OR UNAUTHORIZED DISTRIBUTION OF THE DRAWINGS CONTAINED HEREIN WILL BE A VIOLATION OF THIS CONFIDENTIALITY REQUIREMENT AND SUBJECT THE VIOLATOR TO LIABILITY. REVIEW OF THESE MATERIALS BY RECEIPT SHALL CONSTITUTE ACCEPTANCE OF THESE TERMS AND THE TERMS OF ANY UNDERLYING CONFIDENTIALITY AGREEMENT WE MAY HAVE EXCLUDED IN OBTAINING THIS INFORMATION FROM A THIRD PARTY. IF THE RECIPIENT IS NOT IN AGREEMENT WITH THE OBLIGATION OF CONFIDENTIALITY THEN THE DRAWINGS SHALL BE RETURNED TO THE ORIGINATOR.

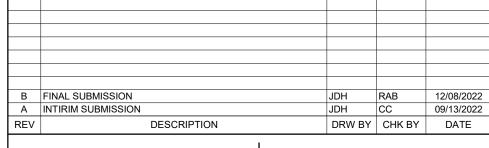



901 Main Campus Drive Raleigh, North Carolina 27606



### **Astoria HVDC Converter Station**


31-45 20<sup>th</sup> Avenue, Astoria, Queens NY 11105 Block #850 - Lot #310 - BIN #4624437


COMMUNICATIONS **SYSTEMS DEVICE LAYOUT** 

**RELAY ENCLOSURE** 


DATE	08/29/2022
PROJECT NO	105121
DRAWING BY	J. HOWARD
CHECKED BY	C. CARROL
DRAWING NO	

CO-111.00 CADD FILE N0
Autodesk Docs://CHPE
Astoria/CHA-KIE-141-00-M3-CO-001.rvt

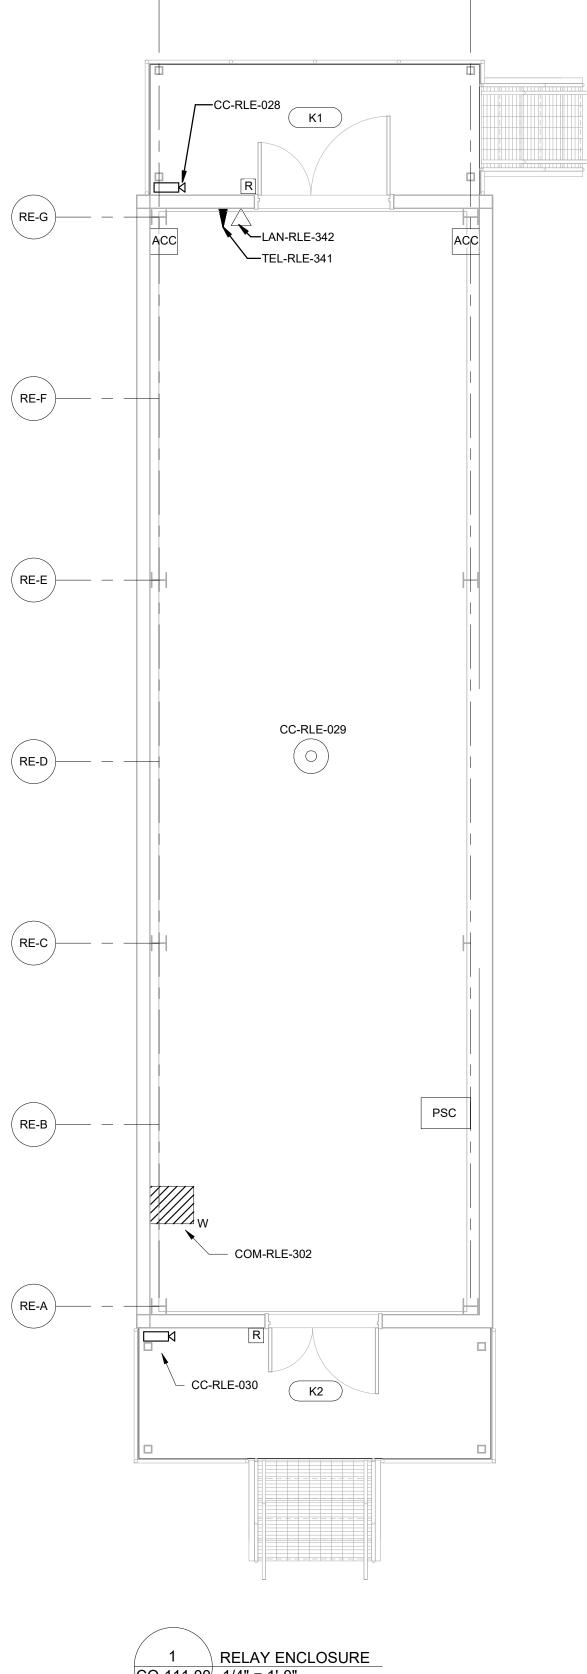

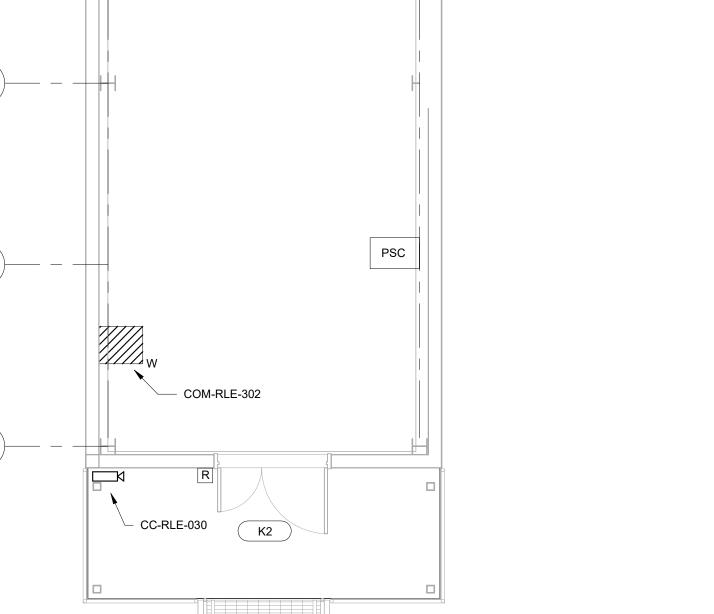


( RE-2 )

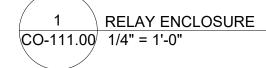

 DOORS AND GATES CONTAINING ACCESS CONTROL AND/OR INTRUSION DETECTION IDENTIFIED WITH A DOOR NUMBER. REFER TO DRAWING CO-223.00 FOR DEVICE ASSIGNMENTS.



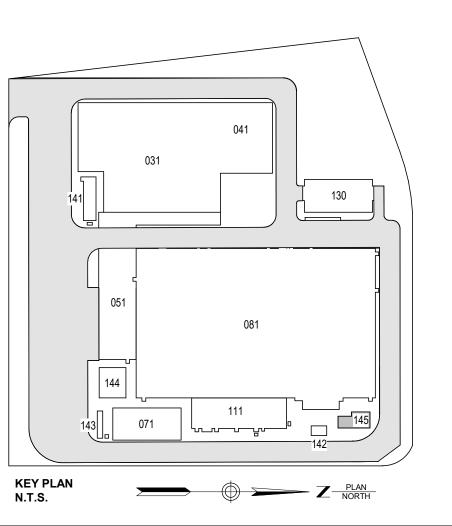




370 7th Avenue SUITE 1604 New York, NY 10001



25 Mohawk Avenue Sparta, NJ 07871

## CONFIDENTIAL THESE DRAWINGS ARE CONFIDENTIAL IN NATURE. ANY MISUSE OR UNAUTHORIZED DISTRIBUTION OF THE DRAWINGS CONTAINED HEREIN WILL BE A VIOLATION OF THIS CONFIDENTIALITY REQUIREMENT AND SUBJECT THE VIOLATOR TO LIABILITY. REVIEW OF THESE MATERIALS BY RECEIPT SHALL CONSTITUTE ACCEPTANCE OF THESE TERMS AND THE TERMS OF ANY UNDERLYING CONFIDENTIALITY AGREEMENT WE MAY HAVE EXCLUDED IN OBTAINING THIS INFORMATION FROM A THIRD PARTY. IF THE RECIPIENT IS NOT IN AGREEMENT WITH THE OBLIGATION OF CONFIDENTIALITY THEN THE DRAWINGS SHALL BE RETURNED TO THE ORIGINATOR.

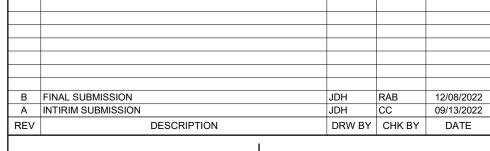



Hitachi Energy901 Main Campus DriveRaleigh, North Carolina 27606

PROJEC<sup>\*</sup>





### Astoria HVDC Converter Station


31-45 20<sup>th</sup> Avenue, Astoria, Queens NY 11105 Block #850 - Lot #310 - BIN #4624437

COMMUNICATIONS
SYSTEMS DEVICE LAYOUT
MVS ENCLOSURE


DATE	08/29/2022
PROJECT NO	105121
DRAWING BY	J. HOWARD
CHECKED BY	C .CARROL
DRAWING NO	

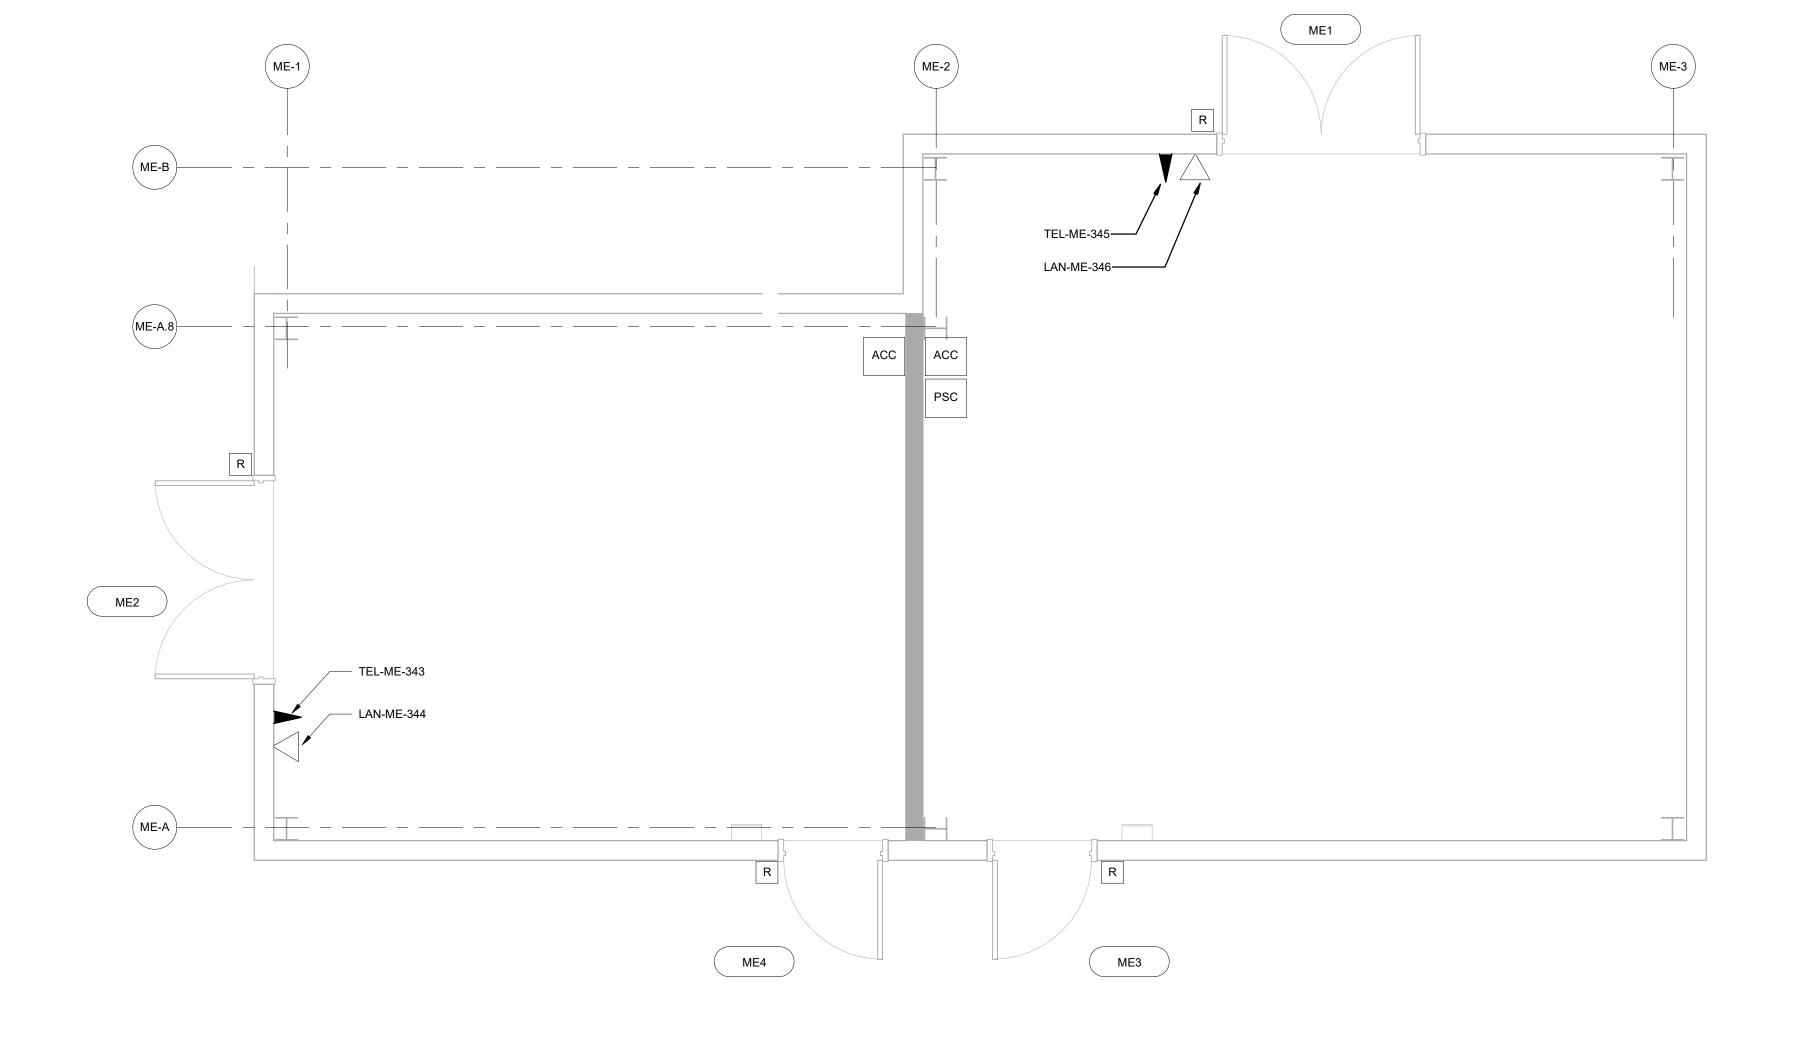

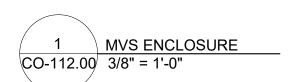

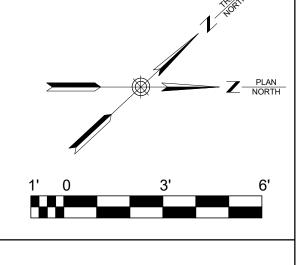


DOORS AND GATES CONTAINING ACCESS CONTROL AND/OR INTRUSION DETECTION IDENTIFIED WITH A DOOR NUMBER. REFER TO DRAWING CO-223.00 FOR DEVICE ASSIGNMENTS.

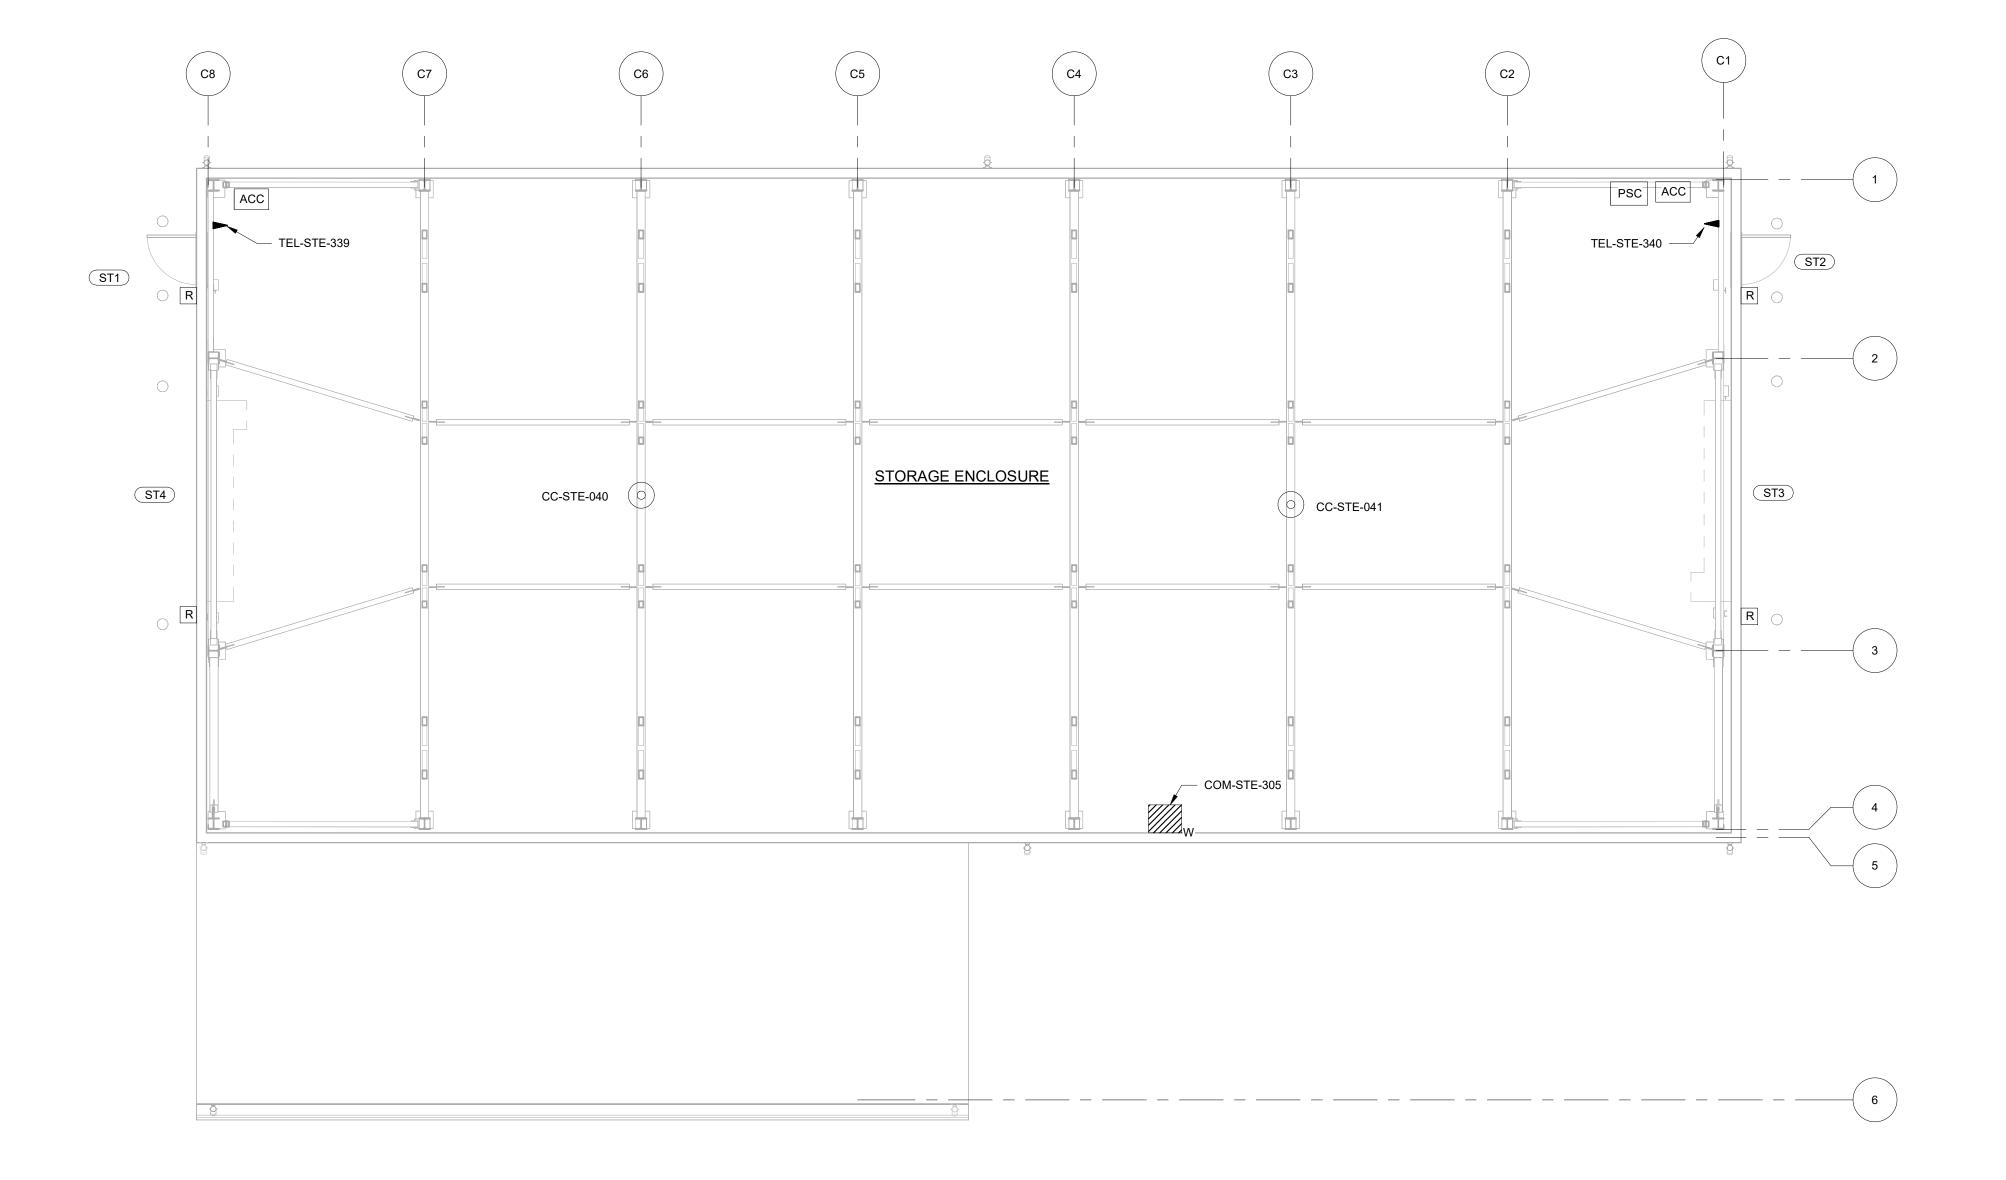

STORAGE ENCLOSURE CO-113.00 3/16" = 1'-0"



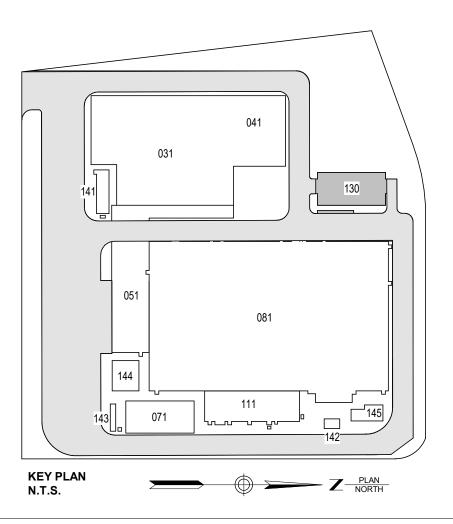



370 7th Avenue SUITE 1604 New York, NY 10001



25 Mohawk Avenue Sparta, NJ 07871

	CONFIDENTIAL			
BE A VI SHALL EXCLUI	DRAWINGS ARE CONFIDENTIAL IN NATURE. ANY MISUSE OR UNAUTHORIZED DISTRIBUT OLATION OF THIS CONFIDENTIALITY REQUIREMENT AND SUBJECT THE VIOLATOR TO LIZ CONSTITUTE ACCEPTANCE OF THESE TERMS AND THE TERMS OF ANY UNDERLYING CO DED IN OBTAINING THIS INFORMATION FROM A THIRD PARTY. IF THE RECIPIENT IS NOT I DENTIALITY THEN THE DRAWINGS SHALL BE RETURNED TO THE ORIGINATOR.	ABILITY. REVIEW	OF THESE MATAGREEMENT V	TERIALS BY RECEIP VE MAY HAVE
Α	INTIRIM SUBMISSION	JDH	CC	9/13/2022
REV	DESCRIPTION	DRW BY	CHK BY	DATE



**@**Hitachi Energy 901 Main Campus Drive Raleigh, North Carolina 27606




### **Astoria HVDC Converter Station**


31-45 20th Avenue, Astoria, Queens NY 11105 Block #850 - Lot #310 - BIN #4624437

COMMUNICATIONS SYSTEMS DEVICE LAYOUT STORAGE ENCLOSURE

DATE	08/29/2022
PROJECT NO	105121
DRAWING BY	J. HOWARD
CHECKED BY	C. CARROL
DRAWING NO	

CO-113.00 CADD FILE N0
Autodesk Docs://CHPE
Astoria/CHA-KIE-130-00-M3-CO-001.rvt

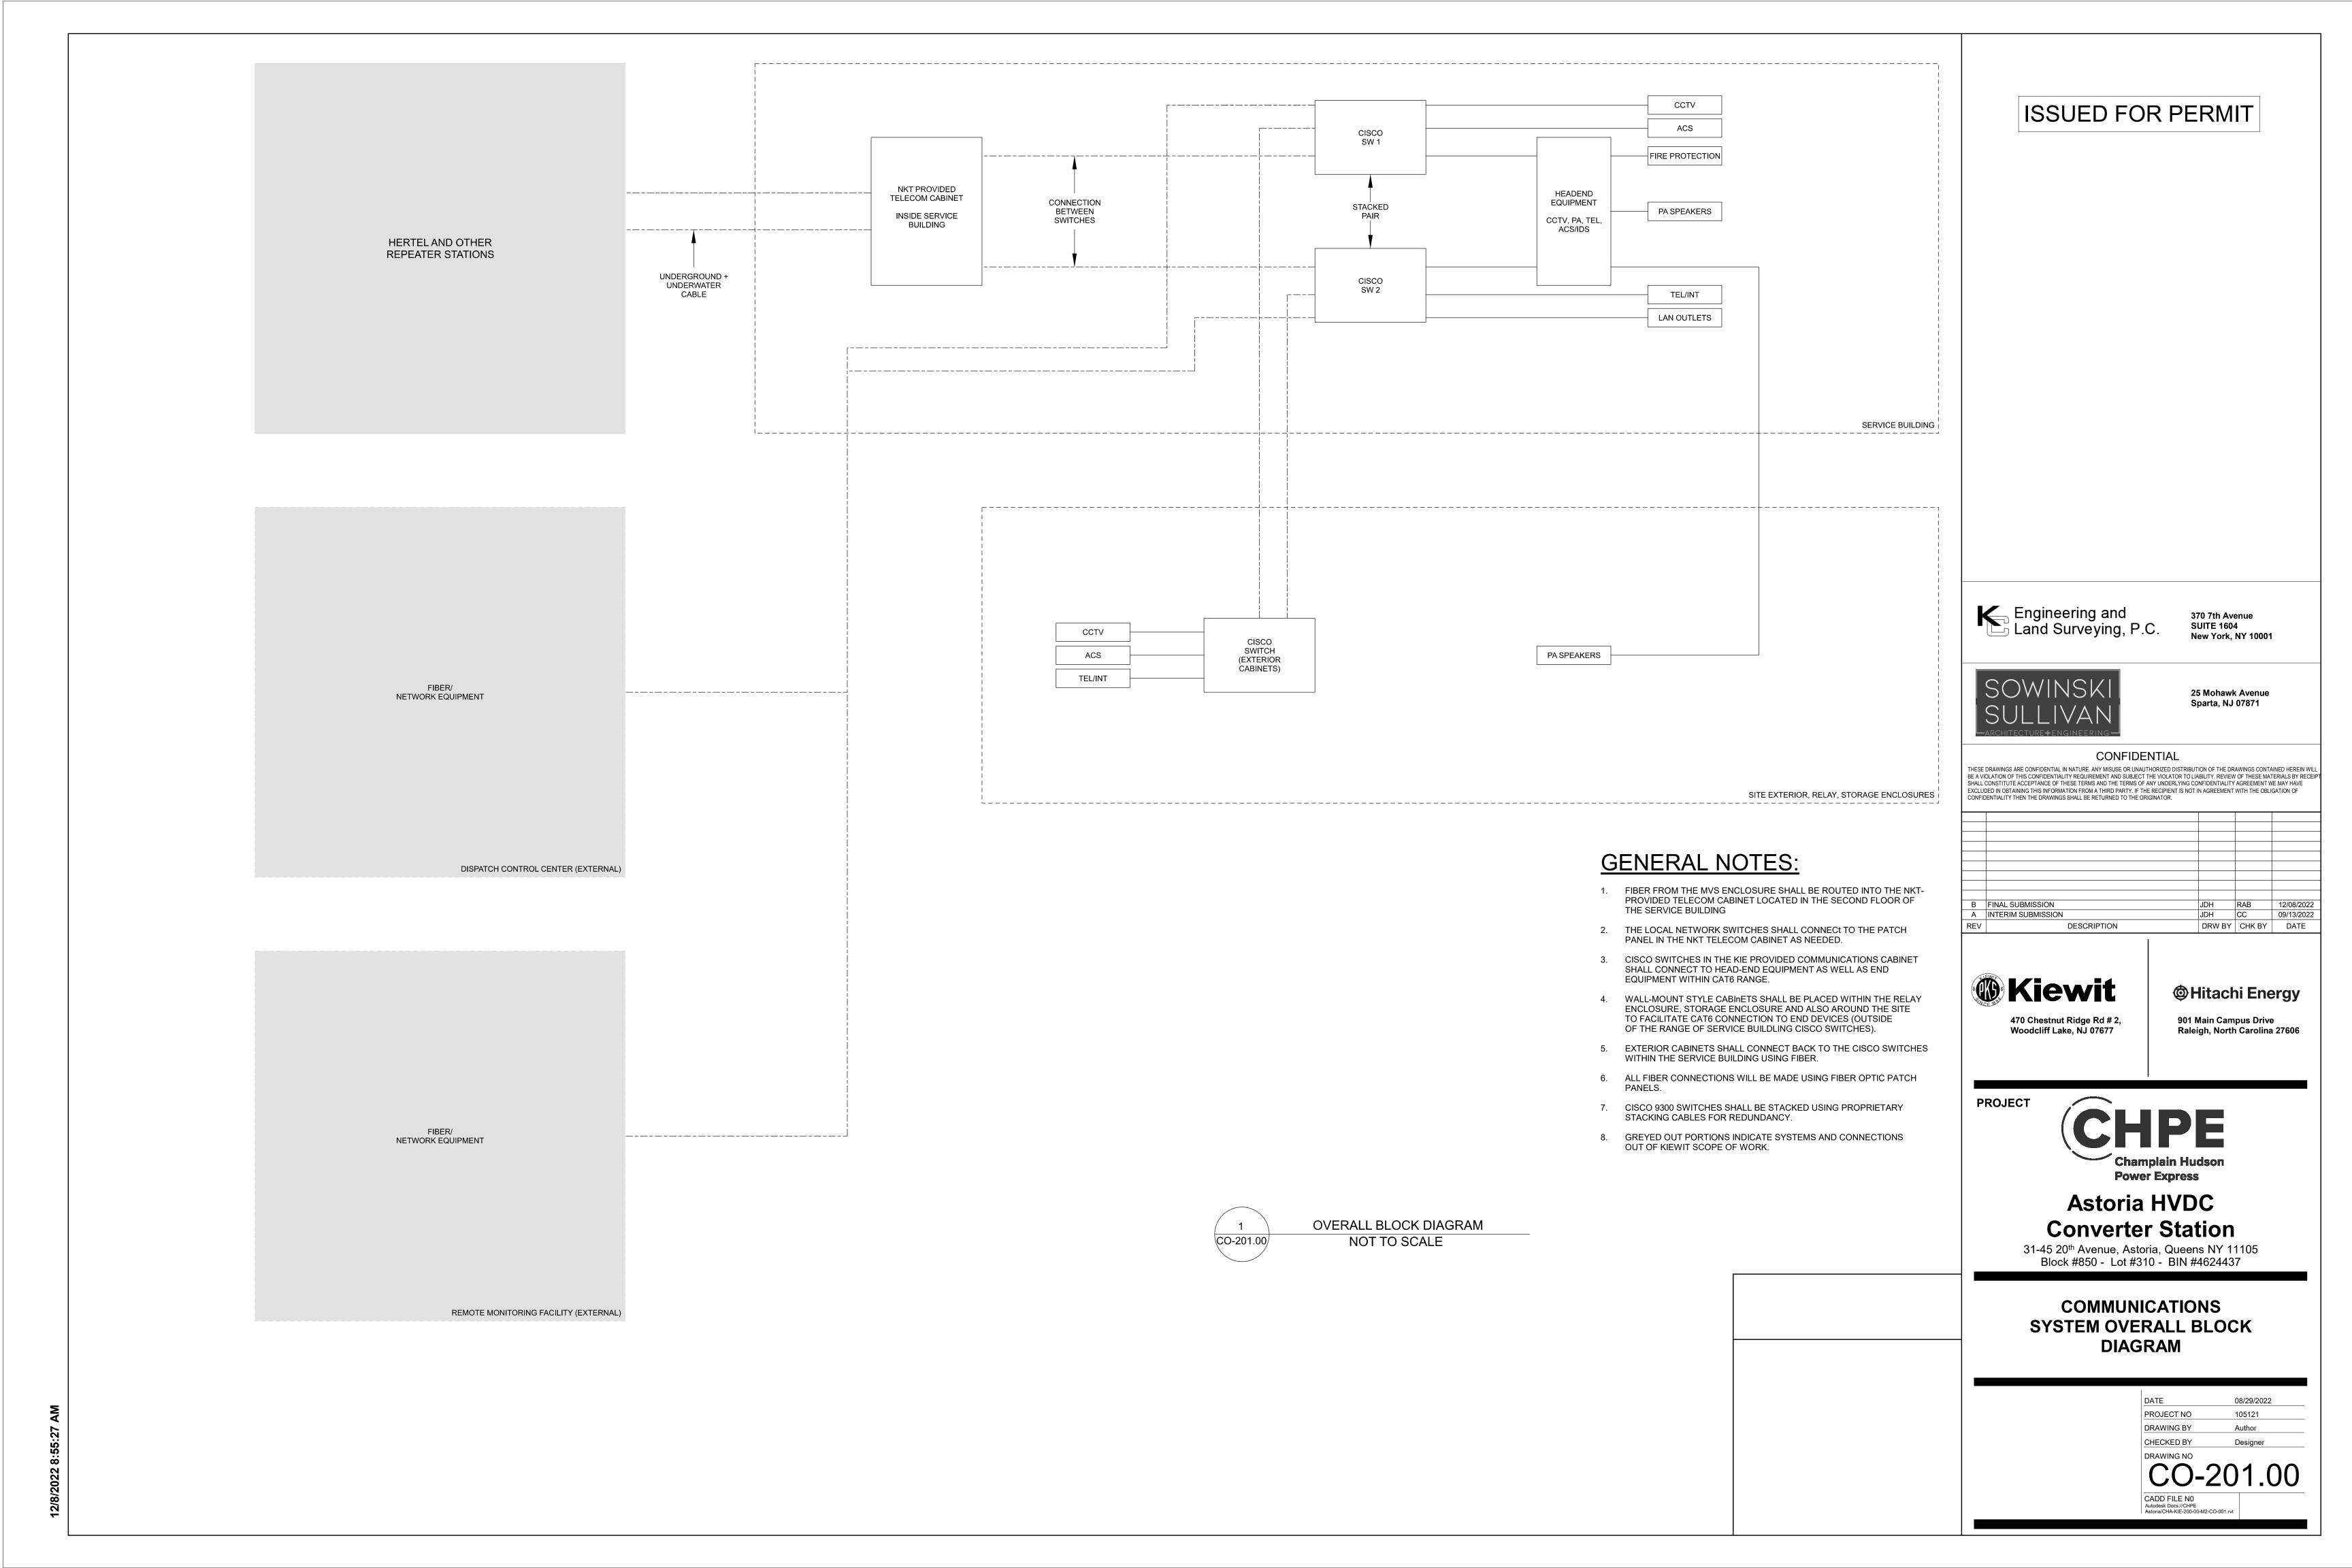

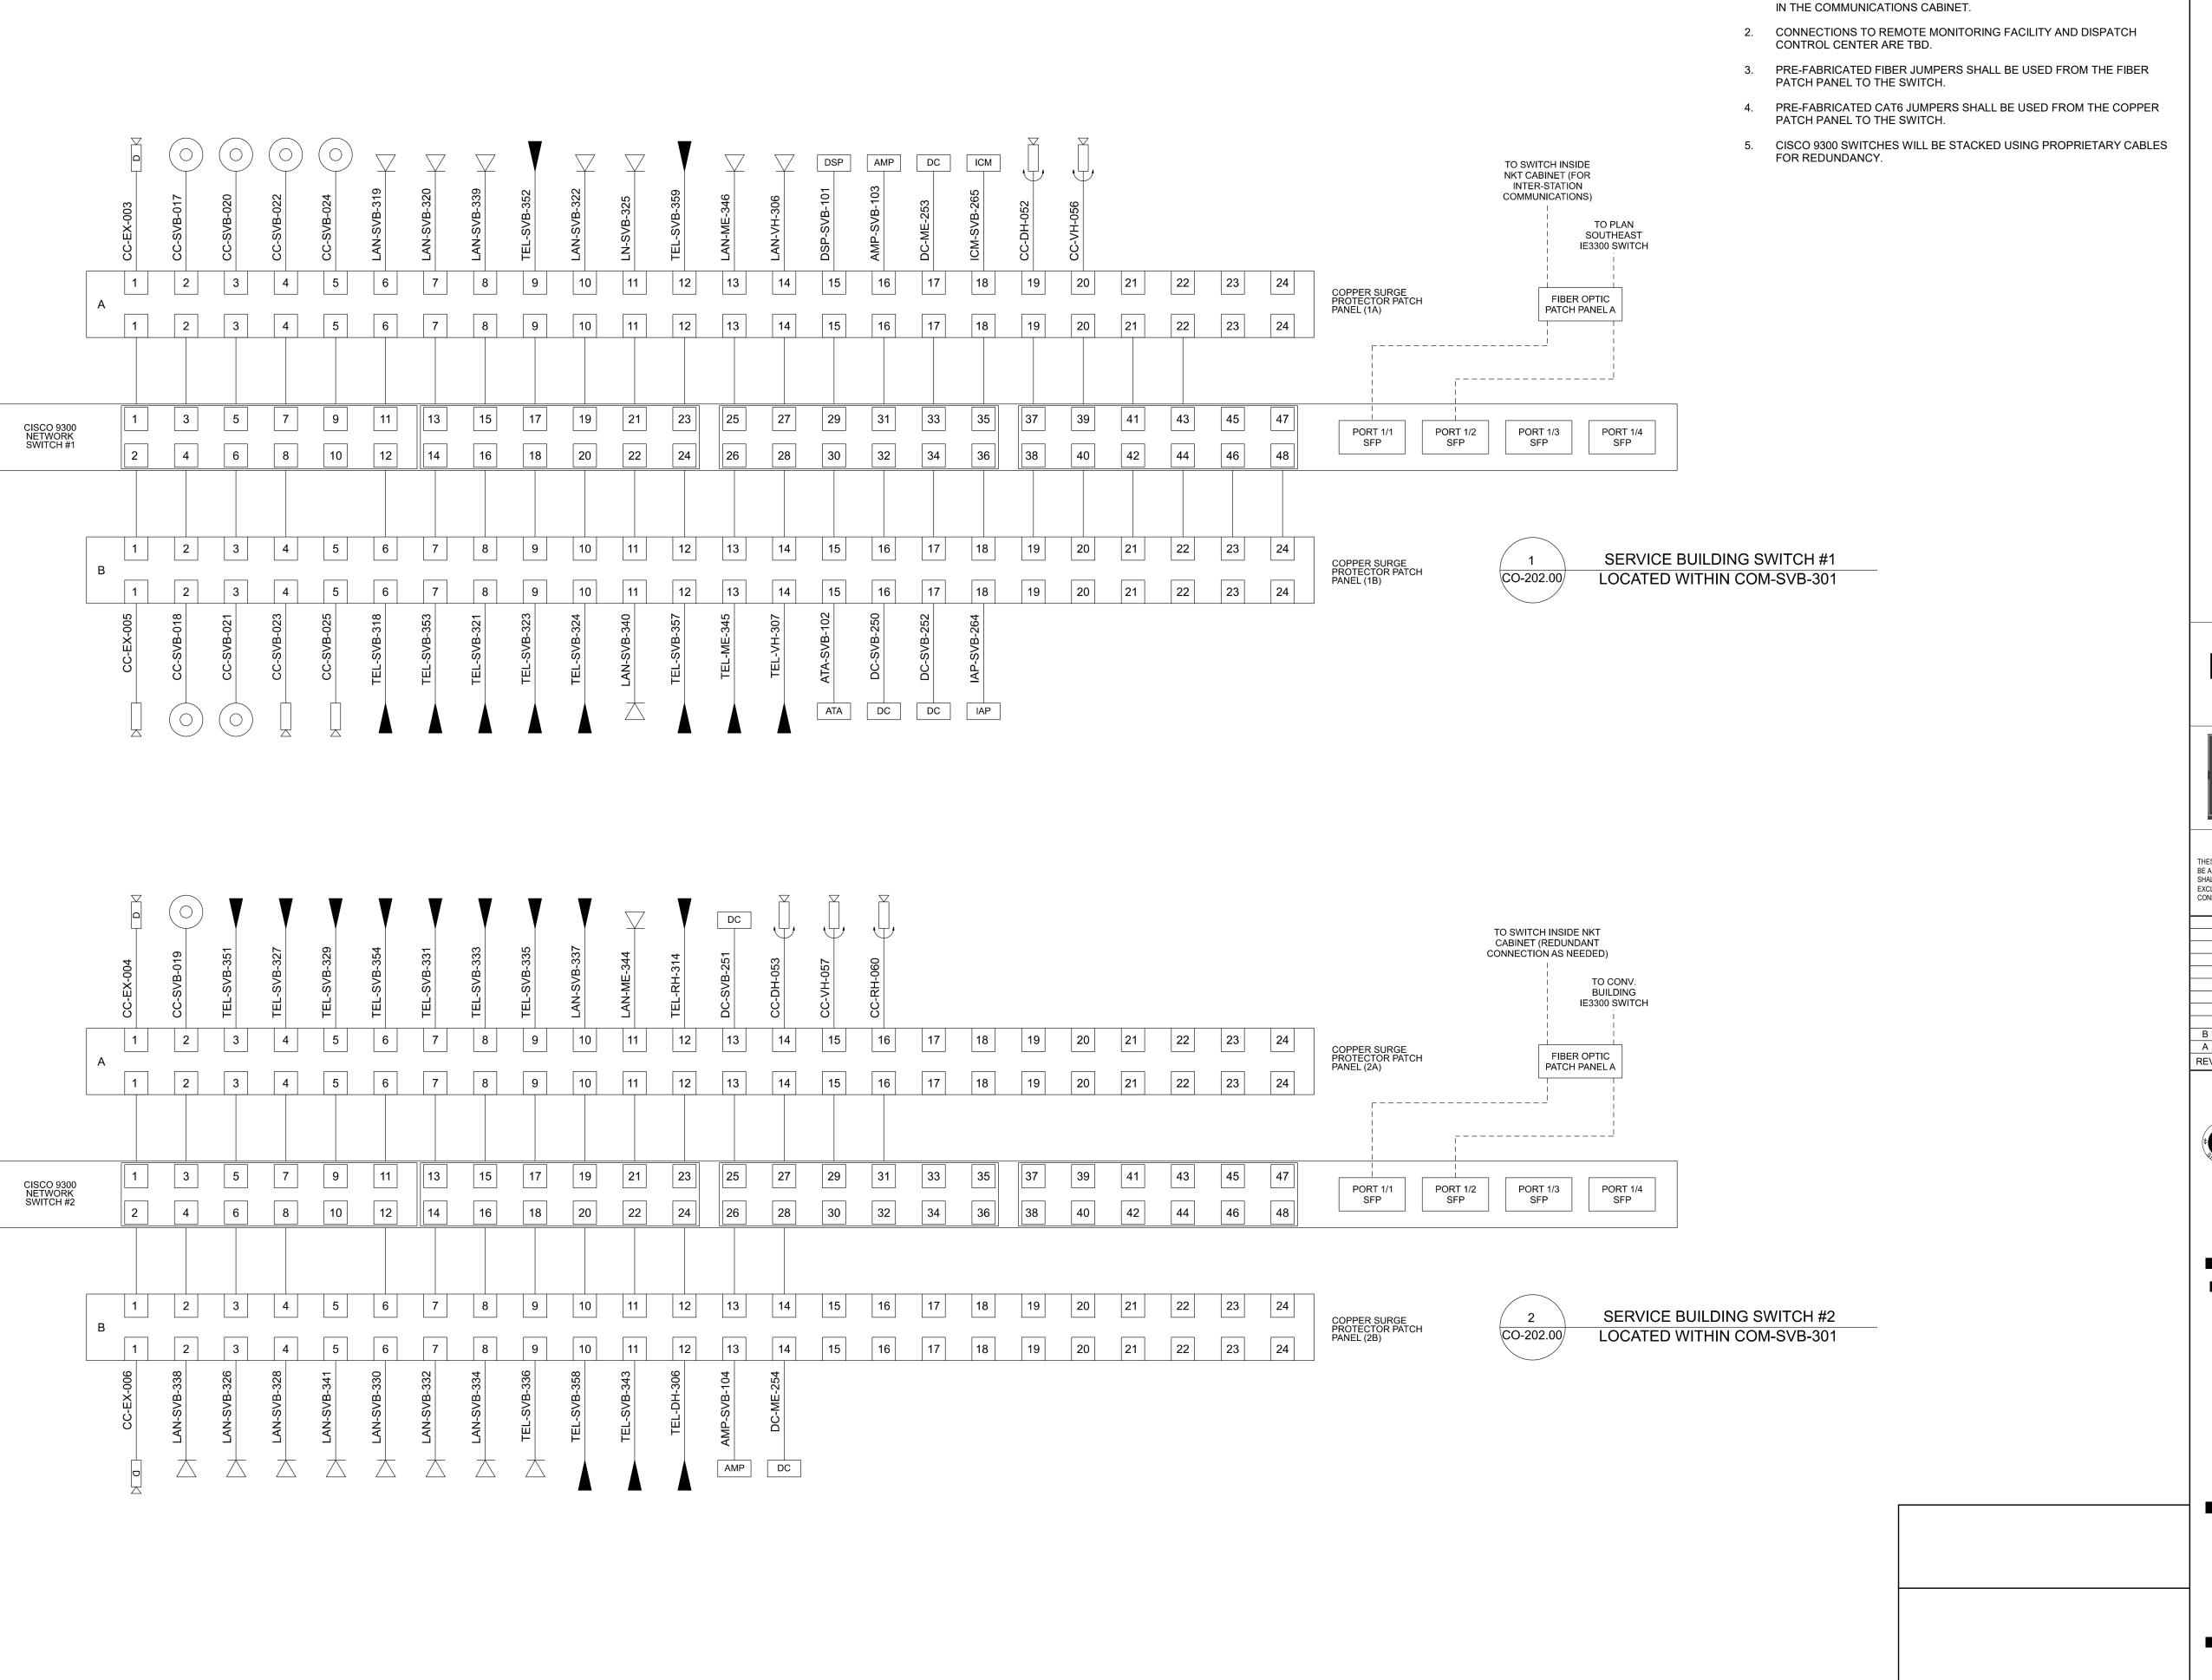

ISSUED FOR PERMIT

**GENERAL NOTES:** 

1. ALL CAT6 FIELD CABLES SHALL TERMINATE ON A CAT6 PATCH PANEL

Engineering and Land Surveying, P.C.

370 7th Avenue SUITE 1604 New York, NY 10001



25 Mohawk Avenue Sparta, NJ 07871

CONFIDENTIA

THESE DRAWINGS ARE CONFIDENTIAL IN NATURE. ANY MISUSE OR UNAUTHORIZED DISTRIBUTION OF THE DRAWINGS CONTAINED HEREIN WILL BE A VIOLATION OF THIS CONFIDENTIALITY REQUIREMENT AND SUBJECT THE VIOLATOR TO LIABILITY. REVIEW OF THESE MATERIALS BY RECEIPT SHALL CONSTITUTE ACCEPTANCE OF THESE TERMS AND THE TERMS OF ANY UNDERLYING CONFIDENTIALITY AGREEMENT WE MAY HAVE EXCLUDED IN OBTAINING THIS INFORMATION FROM A THIRD PARTY. IF THE RECIPIENT IS NOT IN AGREEMENT WITH THE OBLIGATION OF CONFIDENTIALITY THEN THE DRAWINGS SHALL BE RETURNED TO THE ORIGINATOR.

FINAL SUBMISSION	JDH	RAB	12/08/2022
INTERIM SUBMISSION	JDH	CC	09/13/2022
DESCRIPTION	DRW BY	CHK BY	DATE
	INTERIM SUBMISSION	INTERIM SUBMISSION JDH	INTERIM SUBMISSION JDH CC



901 Main Campus Drive Raleigh, North Carolina 27606

PROJECT



### Astoria HVDC Converter Station

31-45 20<sup>th</sup> Avenue, Astoria, Queens NY 11105 Block #850 - Lot #310 - BIN #4624437

COMMUNICATIONS
SYSTEM NETWORK RISER
(SERVICE BUILDING)

 DATE
 08/29/2022


 PROJECT NO
 105121

 DRAWING BY
 J. HOWARD

 CHECKED BY
 C. CARROLL

 DRAWING NO

CO-202.00

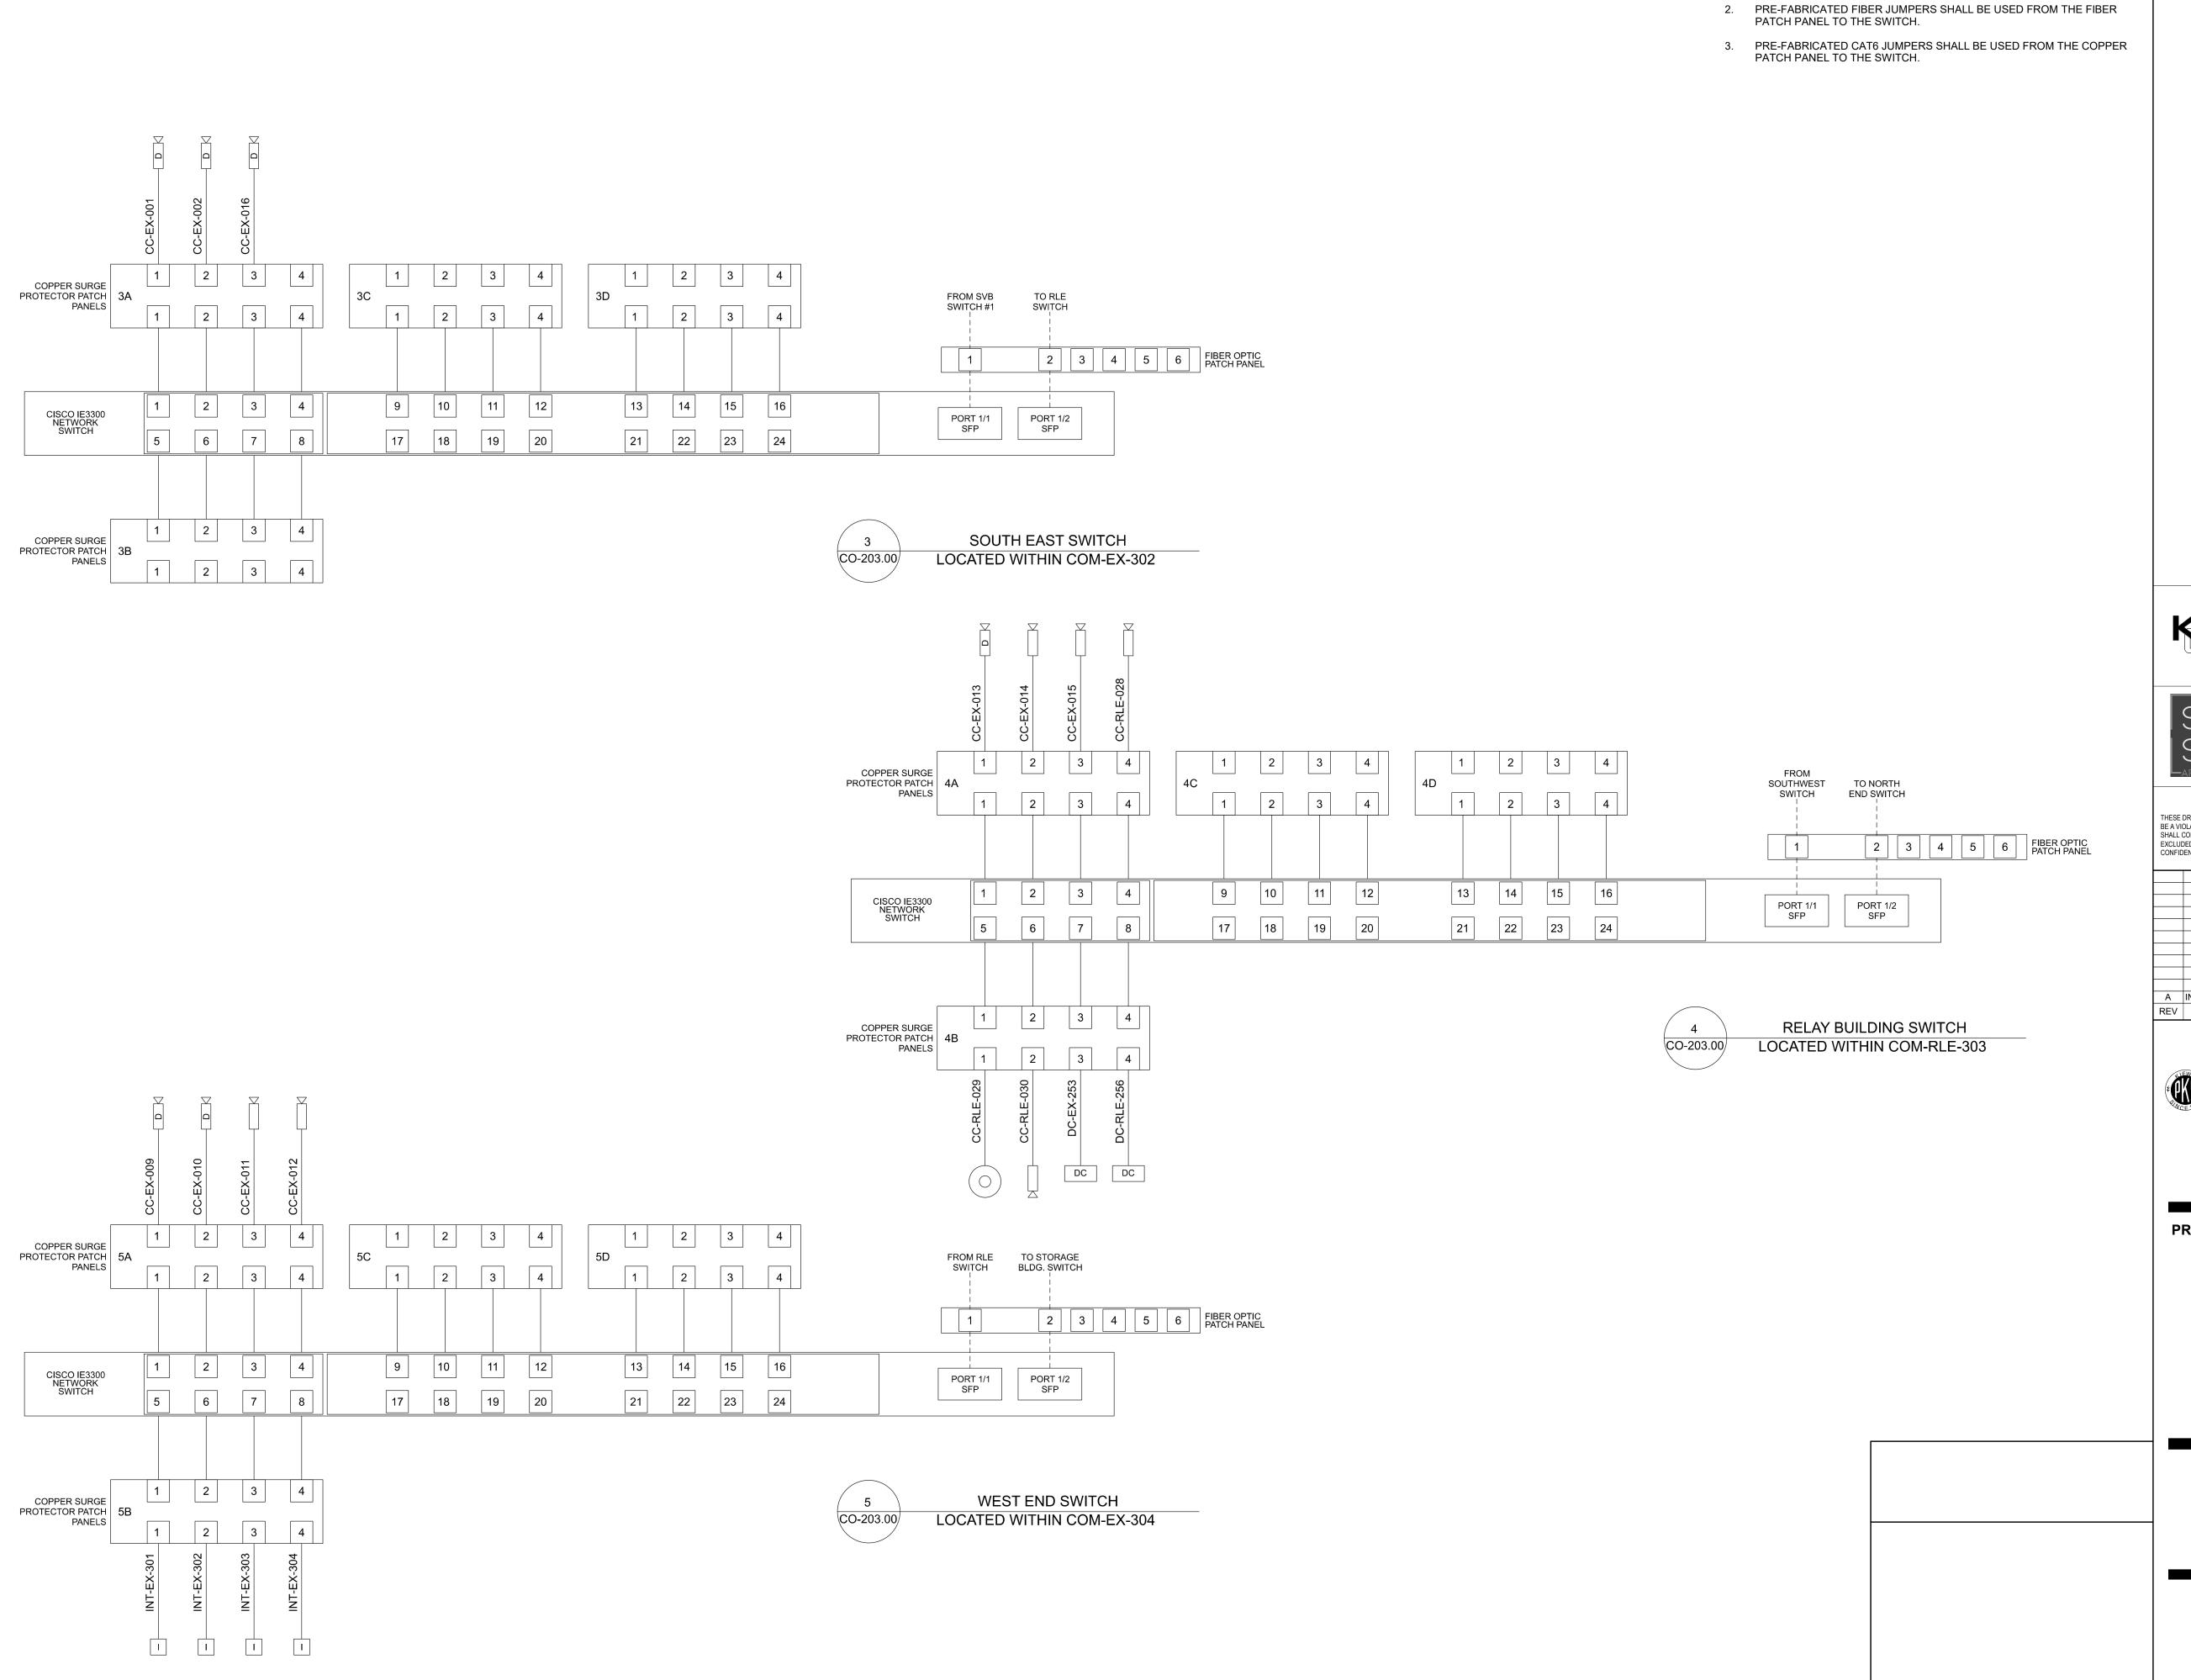

ISSUED FOR PERMIT

**GENERAL NOTES:** 

 ALL CAT6 FIELD CABLES SHALL TERMINATE ON A CAT6 PATCH PANEL IN THE COMMUNICATIONS CABINET.

Engineering and Land Surveying, P.C.

370 7th Avenue SUITE 1604 New York, NY 10001



25 Mohawk Avenue Sparta, NJ 07871

CONFIDENTIAL

THESE DRAWINGS ARE CONFIDENTIAL IN NATURE. ANY MISUSE OR UNAUTHORIZED DISTRIBUTION OF THE DRAWINGS CONTAINED HEREIN WILL BE A VIOLATION OF THIS CONFIDENTIALITY REQUIREMENT AND SUBJECT THE VIOLATOR TO LIABILITY. REVIEW OF THESE MATERIALS BY RECEIPT SHALL CONSTITUTE ACCEPTANCE OF THESE TERMS AND THE TERMS OF ANY UNDERLYING CONFIDENTIALITY AGREEMENT WE MAY HAVE EXCLUDED IN OBTAINING THIS INFORMATION FROM A THIRD PARTY. IF THE RECIPIENT IS NOT IN AGREEMENT WITH THE OBLIGATION OF CONFIDENTIALITY THEN THE DRAWINGS SHALL BE RETURNED TO THE ORIGINATOR.

A INTERIM SUBMISSION

BESCRIPTION

DESCRIPTION

DRW BY CHK BY

DATE



Hitachi Energy901 Main Campus Drive Raleigh, North Carolina 27606



Astoria HVDC Converter Station


31-45 20<sup>th</sup> Avenue, Astoria, Queens NY 11105 Block #850 - Lot #310 - BIN #4624437


COMMUNICATIONS SYSTEM NETWORK RISER (SMALL FORM CABINETS)

SHEET 1 OF 2

DATE 08/29/2022
PROJECT NO 105121
DRAWING BY J. HOWARD
CHECKED BY C. CARROLL
DRAWING NO

CO-203.00

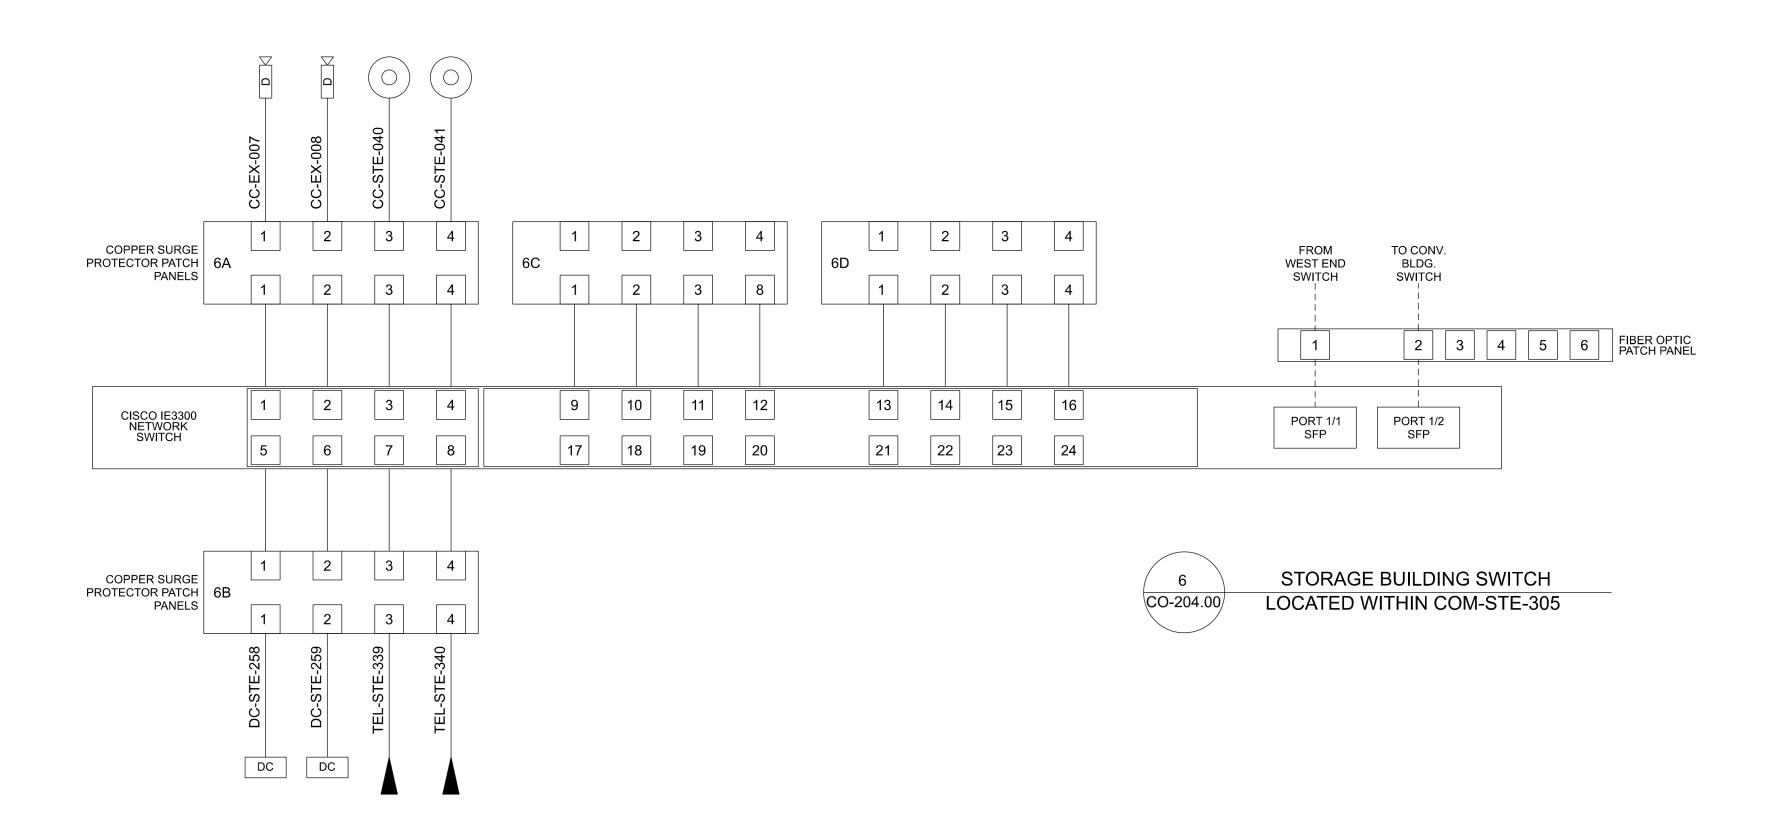

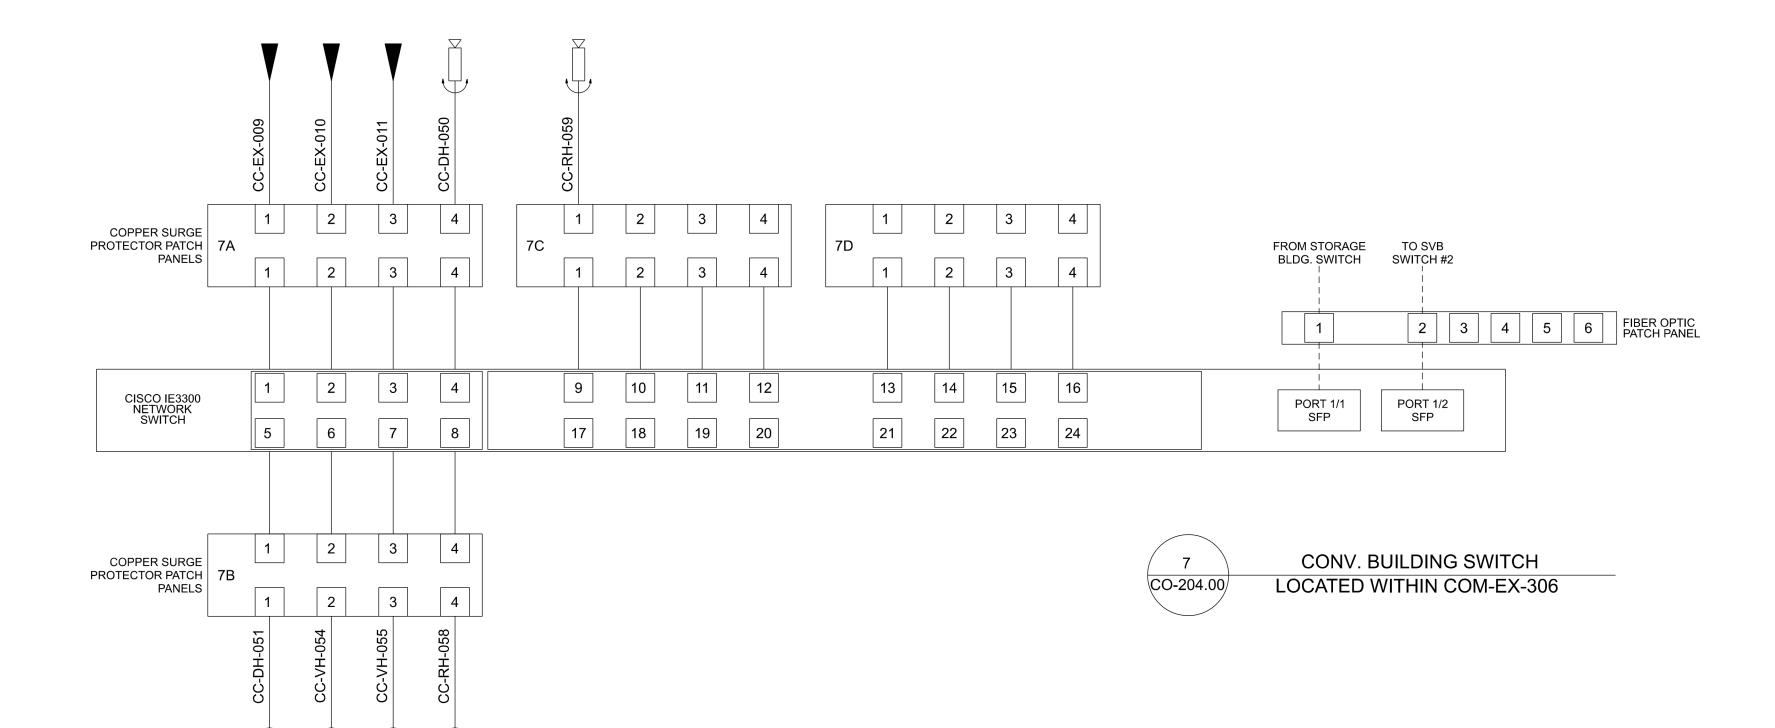

- 1. ALL CAT6 FIELD CABLES SHALL TERMINATE ON A CAT6 PATCH PANEL IN THE COMMUNICATIONS CABINET.
- 2. PRE-FABRICATED FIBER JUMPERS SHALL BE USED FROM THE FIBER PATCH PANEL TO THE SWITCH.
- 3. PRE-FABRICATED CAT6 JUMPERS SHALL BE USED FROM THE COPPER PATCH PANEL TO THE SWITCH.

ISSUED FOR PERMIT



370 7th Avenue **SUITE 1604** New York, NY 10001



25 Mohawk Avenue **Sparta, NJ 07871** 

CONFIDENTIAL

THESE DRAWINGS ARE CONFIDENTIAL IN NATURE. ANY MISUSE OR UNAUTHORIZED DISTRIBUTION OF THE DRAWINGS CONTAINED HEREIN WILL BE A VIOLATION OF THIS CONFIDENTIALITY REQUIREMENT AND SUBJECT THE VIOLATOR TO LIABILITY. REVIEW OF THESE MATERIALS BY RECEIPT SHALL CONSTITUTE ACCEPTANCE OF THESE TERMS AND THE TERMS OF ANY UNDERLYING CONFIDENTIALITY AGREEMENT WE MAY HAVE EXCLUDED IN OBTAINING THIS INFORMATION FROM A THIRD PARTY. IF THE RECIPIENT IS NOT IN AGREEMENT WITH THE OBLIGATION OF CONFIDENTIALITY THEN THE DRAWINGS SHALL BE RETURNED TO THE ORIGINATOR.

В	FINAL SUBMISSION	JDH	RAB	12/08/2022
Α	INTERIM SUBMISSION	JDH	CC	09/13/2022
RFV	DESCRIPTION	DRW BY	CHK BY	DATE



**@**Hitachi Energy

901 Main Campus Drive Raleigh, North Carolina 27606



**Astoria HVDC Converter Station** 

31-45 20<sup>th</sup> Avenue, Astoria, Queens NY 11105 Block #850 - Lot #310 - BIN #4624437


COMMUNICATIONS SYSTEMS NETWORK RISER (SMALL FORM CABINETS) SHEET 2 OF 2

DATE	08/29/2022
PROJECT NO	105121
DRAWING BY	Author
CHECKED BY	Designer
DRAWING NO	


CO-204.00

- 1. CONTRACTOR SHALL INSTALL AND LABEL ALL NEW EQUIPMENT AND CABLING AS INDICATED IN THE CONTRACT DOCUMENTS.
- CONTRACTOR MAY ADJUST THE RACKS AS NEEDED TO FIT IN THE ROOM.
- 3. ALL EQUIPMENT AS LISTED OR APPROVED EQUAL.

**ISSUED FOR PERMIT** 

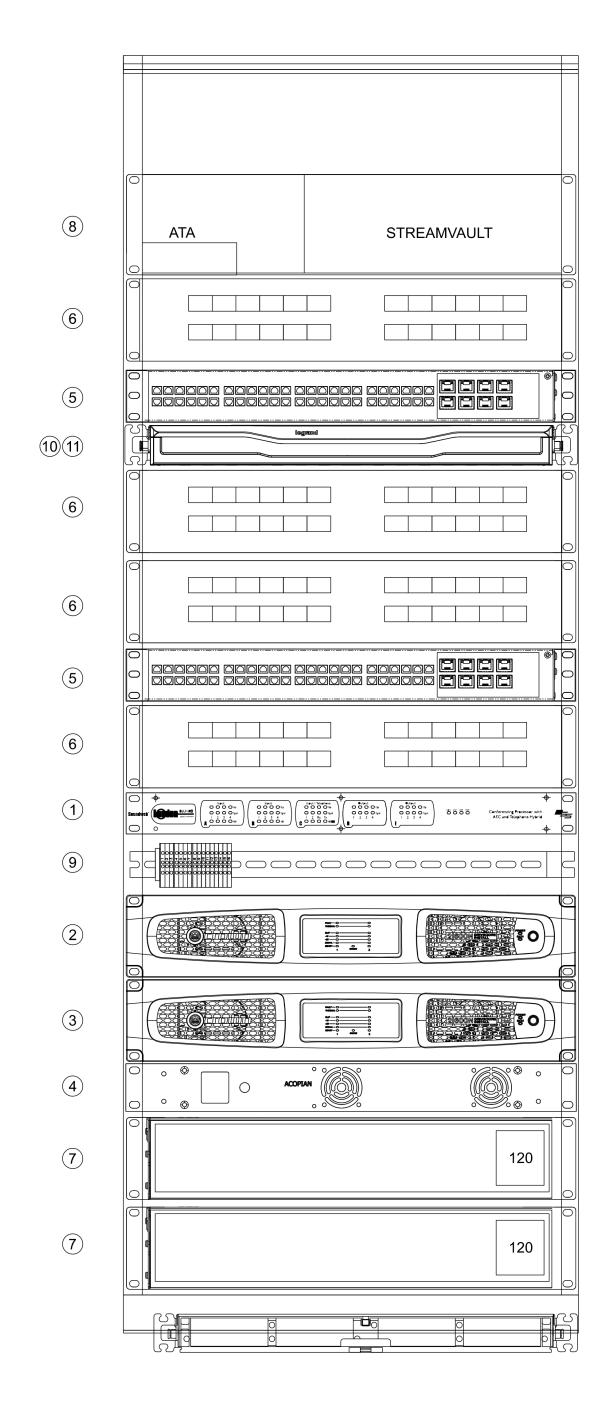



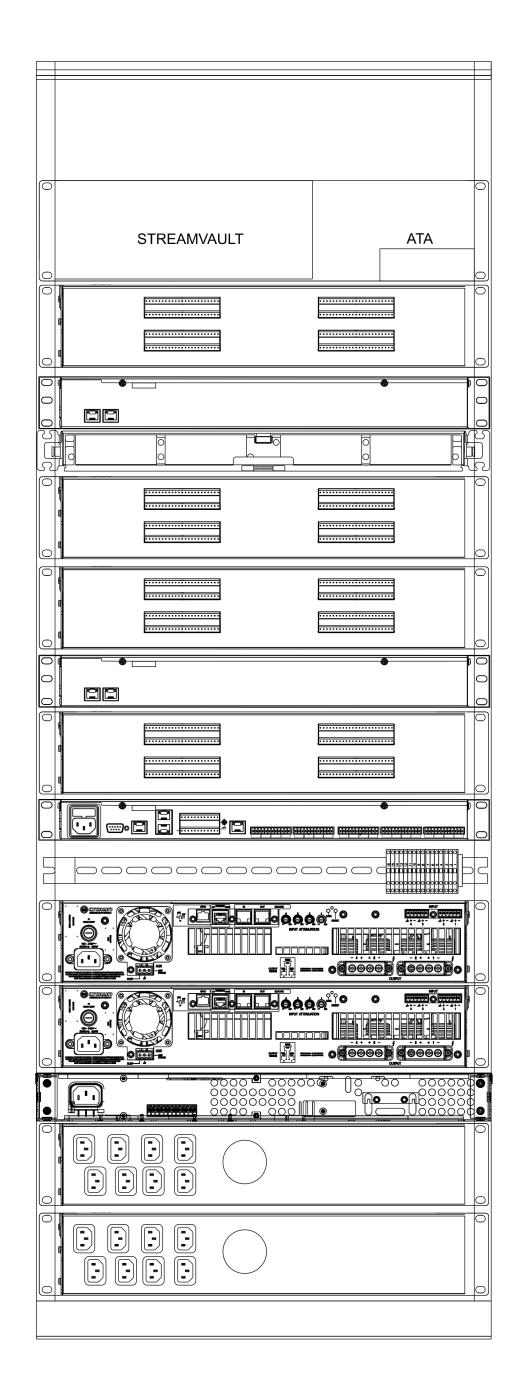



ITEM	DESCRIPTION	QUANTITY	UANTITY MANUFACTURE PART NUMB		
1	DIGITAL SIGNAL PROCESSOR	1	BSS AUIDO	BLU-102	
2	4 CHANNEL, 300W/ CHANNEL AMPLILFIER	1	CROWN	4300N	
3	2 CHANNEL, 300W/CHANNEL AMPLIFIER	1	CROWN	2600N1-204-002	
4	POWER SUPPLY	1	ACOPAN	W24LTU3000	
5	48 PORT. PoE+ NETWORK SWITCH	2	CISCO	C9300-48U	
6	19" RACK MOUNTED SURGE PROTECTION PANEL	4	CITEL	PCH24-POE-A	
7	UNINTERTUPTIBLE POWER SUPPLY	2	TRIPP LITE	SMART3000RMXLN	
8	UTILITY RACK SHELF	1	SHOWME CABLES	71-204-002	
9	DISCONNECT TERMINAL BLOCK	15	PHOENIX CONTACT	3064027	
10	FIBER ENCLOSURE	1	LEGRAND	INFC01U-M4-E	
11)	OFP ADAPTER PANEL 6 SC-DUPLEX	2	LEGRAND	OFP-SCD12LC	



370 7th Avenue SUITE 1604 New York, NY 10001



25 Mohawk Avenue Sparta, NJ 07871

CONFIDENTIAL

THESE DRAWINGS ARE CONFIDENTIAL IN NATURE. ANY MISUSE OR UNAUTHORIZED DISTRIBUTION OF THE DRAWINGS CONTAINED HEREIN WILL BE A VIOLATION OF THIS CONFIDENTIALITY REQUIREMENT AND SUBJECT THE VIOLATOR TO LIABILITY. REVIEW OF THESE MATERIALS BY RECEIPT SHALL CONSTITUTE ACCEPTANCE OF THESE TERMS AND THE TERMS OF ANY UNDERLYING CONFIDENTIALITY AGREEMENT WE MAY HAVE EXCLUDED IN OBTAINING THIS INFORMATION FROM A THIRD PARTY. IF THE RECIPIENT IS NOT IN AGREEMENT WITH THE OBLIGATION OF CONFIDENTIALITY THEN THE DRAWINGS SHALL BE RETURNED TO THE ORIGINATOR.

В	FINAL SUBMISSION	JDH	RAB	12/08/2022
Α	INTERIM SUBMISSION	JDH	CC	09/13/2022
REV	DESCRIPTION	DRW BY	CHK BY	DATE



Hitachi Energy901 Main Campus Drive Raleigh, North Carolina 27606

PROJEC



### Astoria HVDC Converter Station

31-45 20<sup>th</sup> Avenue, Astoria, Queens NY 11105 Block #850 - Lot #310 - BIN #4624437

COMMUNICATIONS
SYSTEM COMMUNICATION
CABINET ELEVATION
(SERVICE BLDG.)

 DATE
 08/29/2022

 PROJECT NO
 105121

 DRAWING BY
 Author


 CHECKED BY
 Designer

 DRAWING NO

CO-205.00

- ALL EQUIPMENT WITHIN THE CABINET SHALL AFFIXED WITH THE APPROPRIATE LABEL.
- ALL EQUIPMENT CABINET INSTALLATIONS SHALL ADHERE TO APPLICABLE BONDING AND GROUNDING WITH EQUIPMENT GROUNDING CONDUCTORS.
- 3. THE CONTRACTOR MUST MAINTAIN THE STRUCTURAL AND ENVIROMENTAL INTEGRITY OF THE ENCLOSURE AT ALL TIMES DURING
- 4. WHEN INSTALLED OUTDOORS, CONDUIT ENTRY SHALL BE FROM THE BOTTOM ONLY. TOP OR SIDE ENTRY MUST BE APPROVED BY
- 5. ALL EQUIPMENT AS LISTED OR APPROVED EQUAL.



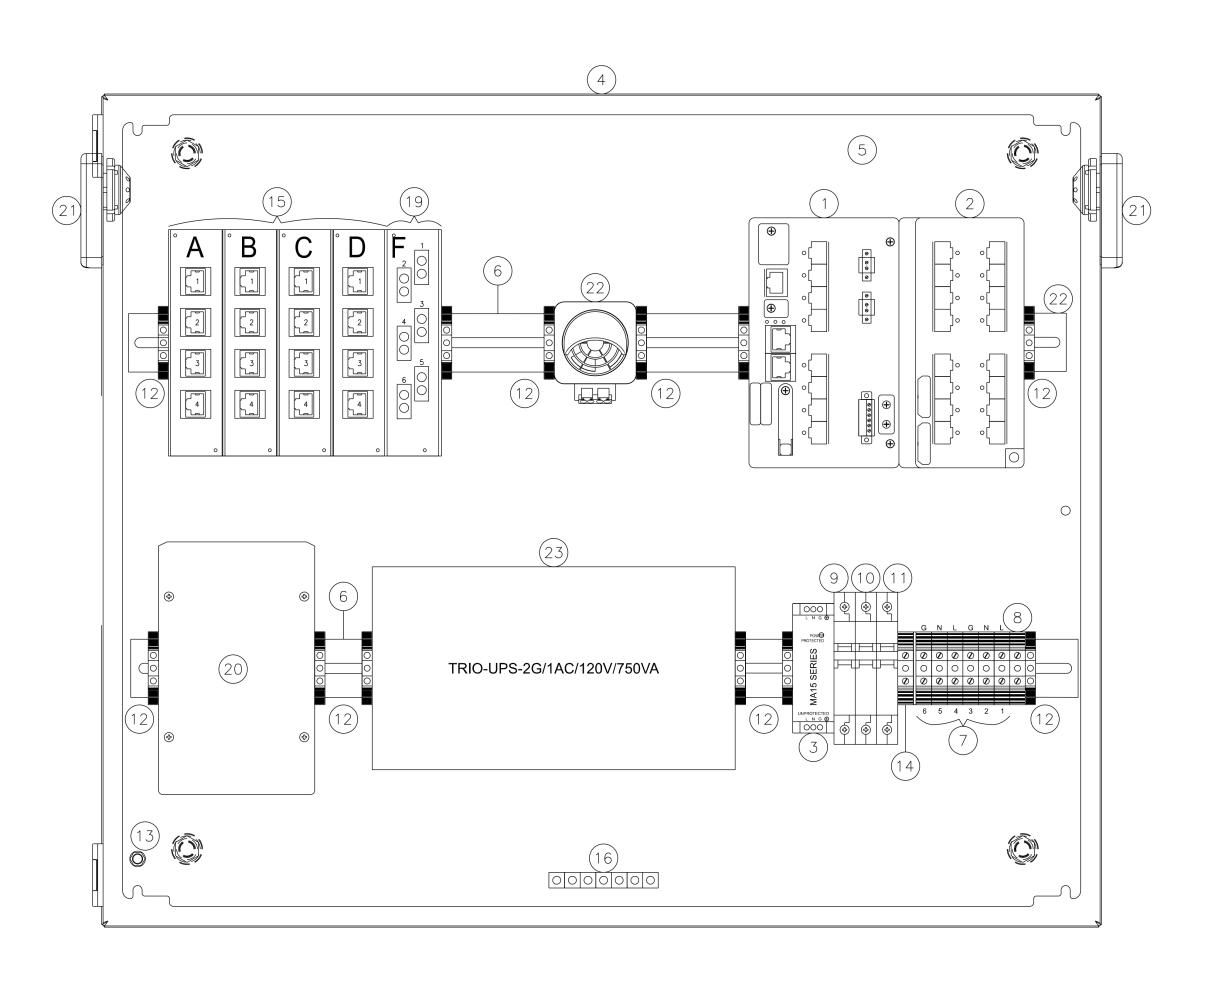

BILL OF MATERIALS						
ITEM	DESCRIPTION	QUANTITY	MANUFACTURER	PART NUMBER		
1	HARDENED 8-PORT ETHERNET SWITCH, 48VDC	1	CISCO	IE3300-8P2S-E		
2	EXPANSION MODULE (AS REQUIRED)	1	CISCO	IEM-3300-16P		
3	POWER SURGE PROTECTIVE DEVICE	1	WEIDMULLER	MA15D1S1		
4	EQUIPMENT ENCLOSURE, NEMA TYPE 4X-SS, WALL MT.	1	SAGINAW	SCE-20EL248SSLP		
5	BACK PANEL 20" x 24" x 8"	1	SAGINAW	SCE-20P24J		
6	DIN RAIL	2	PHOENIX CONTACT	0801733		
7	DIN RAIL FEED-THROUGH TERMINAL, DARK BEIGE	6	PHOENIX CONTACT	3044131		
8	DIN RAIL GROUND TERMINAL, GREEN/YELLOW	1	PHOENIX CONTACT	3044157		
9	DIN RAIL CIRCUIT BREAKER, 120VAC, 15A	1	WEIDMULLER	9926251015		
(10)	DIN RAIL CIRCUIT BREAKER, 120VAC, .5A	1	WEIDMULLER	9926251000		
(11)	DIN RAIL CIRCUIT BREAKER, 120VAC, 4A	1	WEIDMULLER	9926251004		
(12)	DIN RAIL MOUNT END BRACKET	10	WEIDMULLER	0800886		
(13)	BOLT PACK GROUNDING KIT, 10-32	1	SAGINAW	SCE-102297		
<u>(14)</u>	DIN RAIL MOUNT TERMINAL END PLATE	1	PHOENIX CONTACT	3047028		
(15)	16 COPPER PATCH PANEL	4	BELDEN	MPP/BD-CUE4/CUE4./CUE4/CUE4/CUE		
16)	GROUND BAR	1	EATON	GBK5		
(17)	PADLOCK HASP (NOT SHOWN)	1	SAGINAW	SCE-PLHG		
(18)	PRINT PAT (NO SHOWN)	1	SAGINAW	SCE-PP7701		
(19)	12 FIBER MIPP PN	1	BELDEN	MPP/GP/IS3N		
20	POWER SUPPLY, POE, IN 480W AC 100-240V/6.0A	1	CISCO	PWR-IE480W-PCAC-L		
21)	BREATHER VENT KIT	2	SAGINAW	SCE-BVK		
22)	COOLING FAN	1	STEGOJET	019250-00		
(23)	UNINTERRUPTABLE POWER SUPPLY	1	PHOENIX CONTACT	2905908		



370 7th Avenue **SUITE 1604** New York, NY 10001



25 Mohawk Avenue **Sparta, NJ 07871** 

#### CONFIDENTIAL

THESE DRAWINGS ARE CONFIDENTIAL IN NATURE. ANY MISUSE OR UNAUTHORIZED DISTRIBUTION OF THE DRAWINGS CONTAINED HEREIN WILL BE A VIOLATION OF THIS CONFIDENTIAL IN NATURE: ANY MISUSE OR UNAUTHORIZED DISTRIBUTION OF THE DRAWINGS CONTAINED HEREIN WILL 
BE A VIOLATION OF THIS CONFIDENTIALITY REQUIREMENT AND SUBJECT THE VIOLATOR TO LIABILITY. REVIEW OF THESE MATERIALS BY RECEIPT 
SHALL CONSTITUTE ACCEPTANCE OF THESE TERMS AND THE TERMS OF ANY UNDERLYING CONFIDENTIALITY AGREEMENT WE MAY HAVE 
EXCLUDED IN OBTAINING THIS INFORMATION FROM A THIRD PARTY. IF THE RECIPIENT IS NOT IN AGREEMENT WITH THE OBLIGATION OF 
CONFIDENTIALITY THEN THE DRAWINGS SHALL BE RETURNED TO THE ORIGINATOR.

В	FINAL SUBMISSION	JDH	RAB	12/08/2022
Α	INTERIM SUBMISSION	JDH	CC	09/13/2022
REV	DESCRIPTION	DRW BY	CHK BY	DATE



**@**Hitachi Energy

901 Main Campus Drive Raleigh, North Carolina 27606




### **Astoria HVDC Converter Station**

31-45 20<sup>th</sup> Avenue, Astoria, Queens NY 11105 Block #850 - Lot #310 - BIN #4624437

COMMUNICATIONS SYSTEMS SMALL FORM **CABINET DETAILS** 

I	
DATE	08/29/2022
PROJECT NO	105121
DRAWING BY	Author
CHECKED BY	Designer
DDAMING NO	

	SMALL FORM CABINETS DETAILS
CO-206.00	NOT TO SCALE

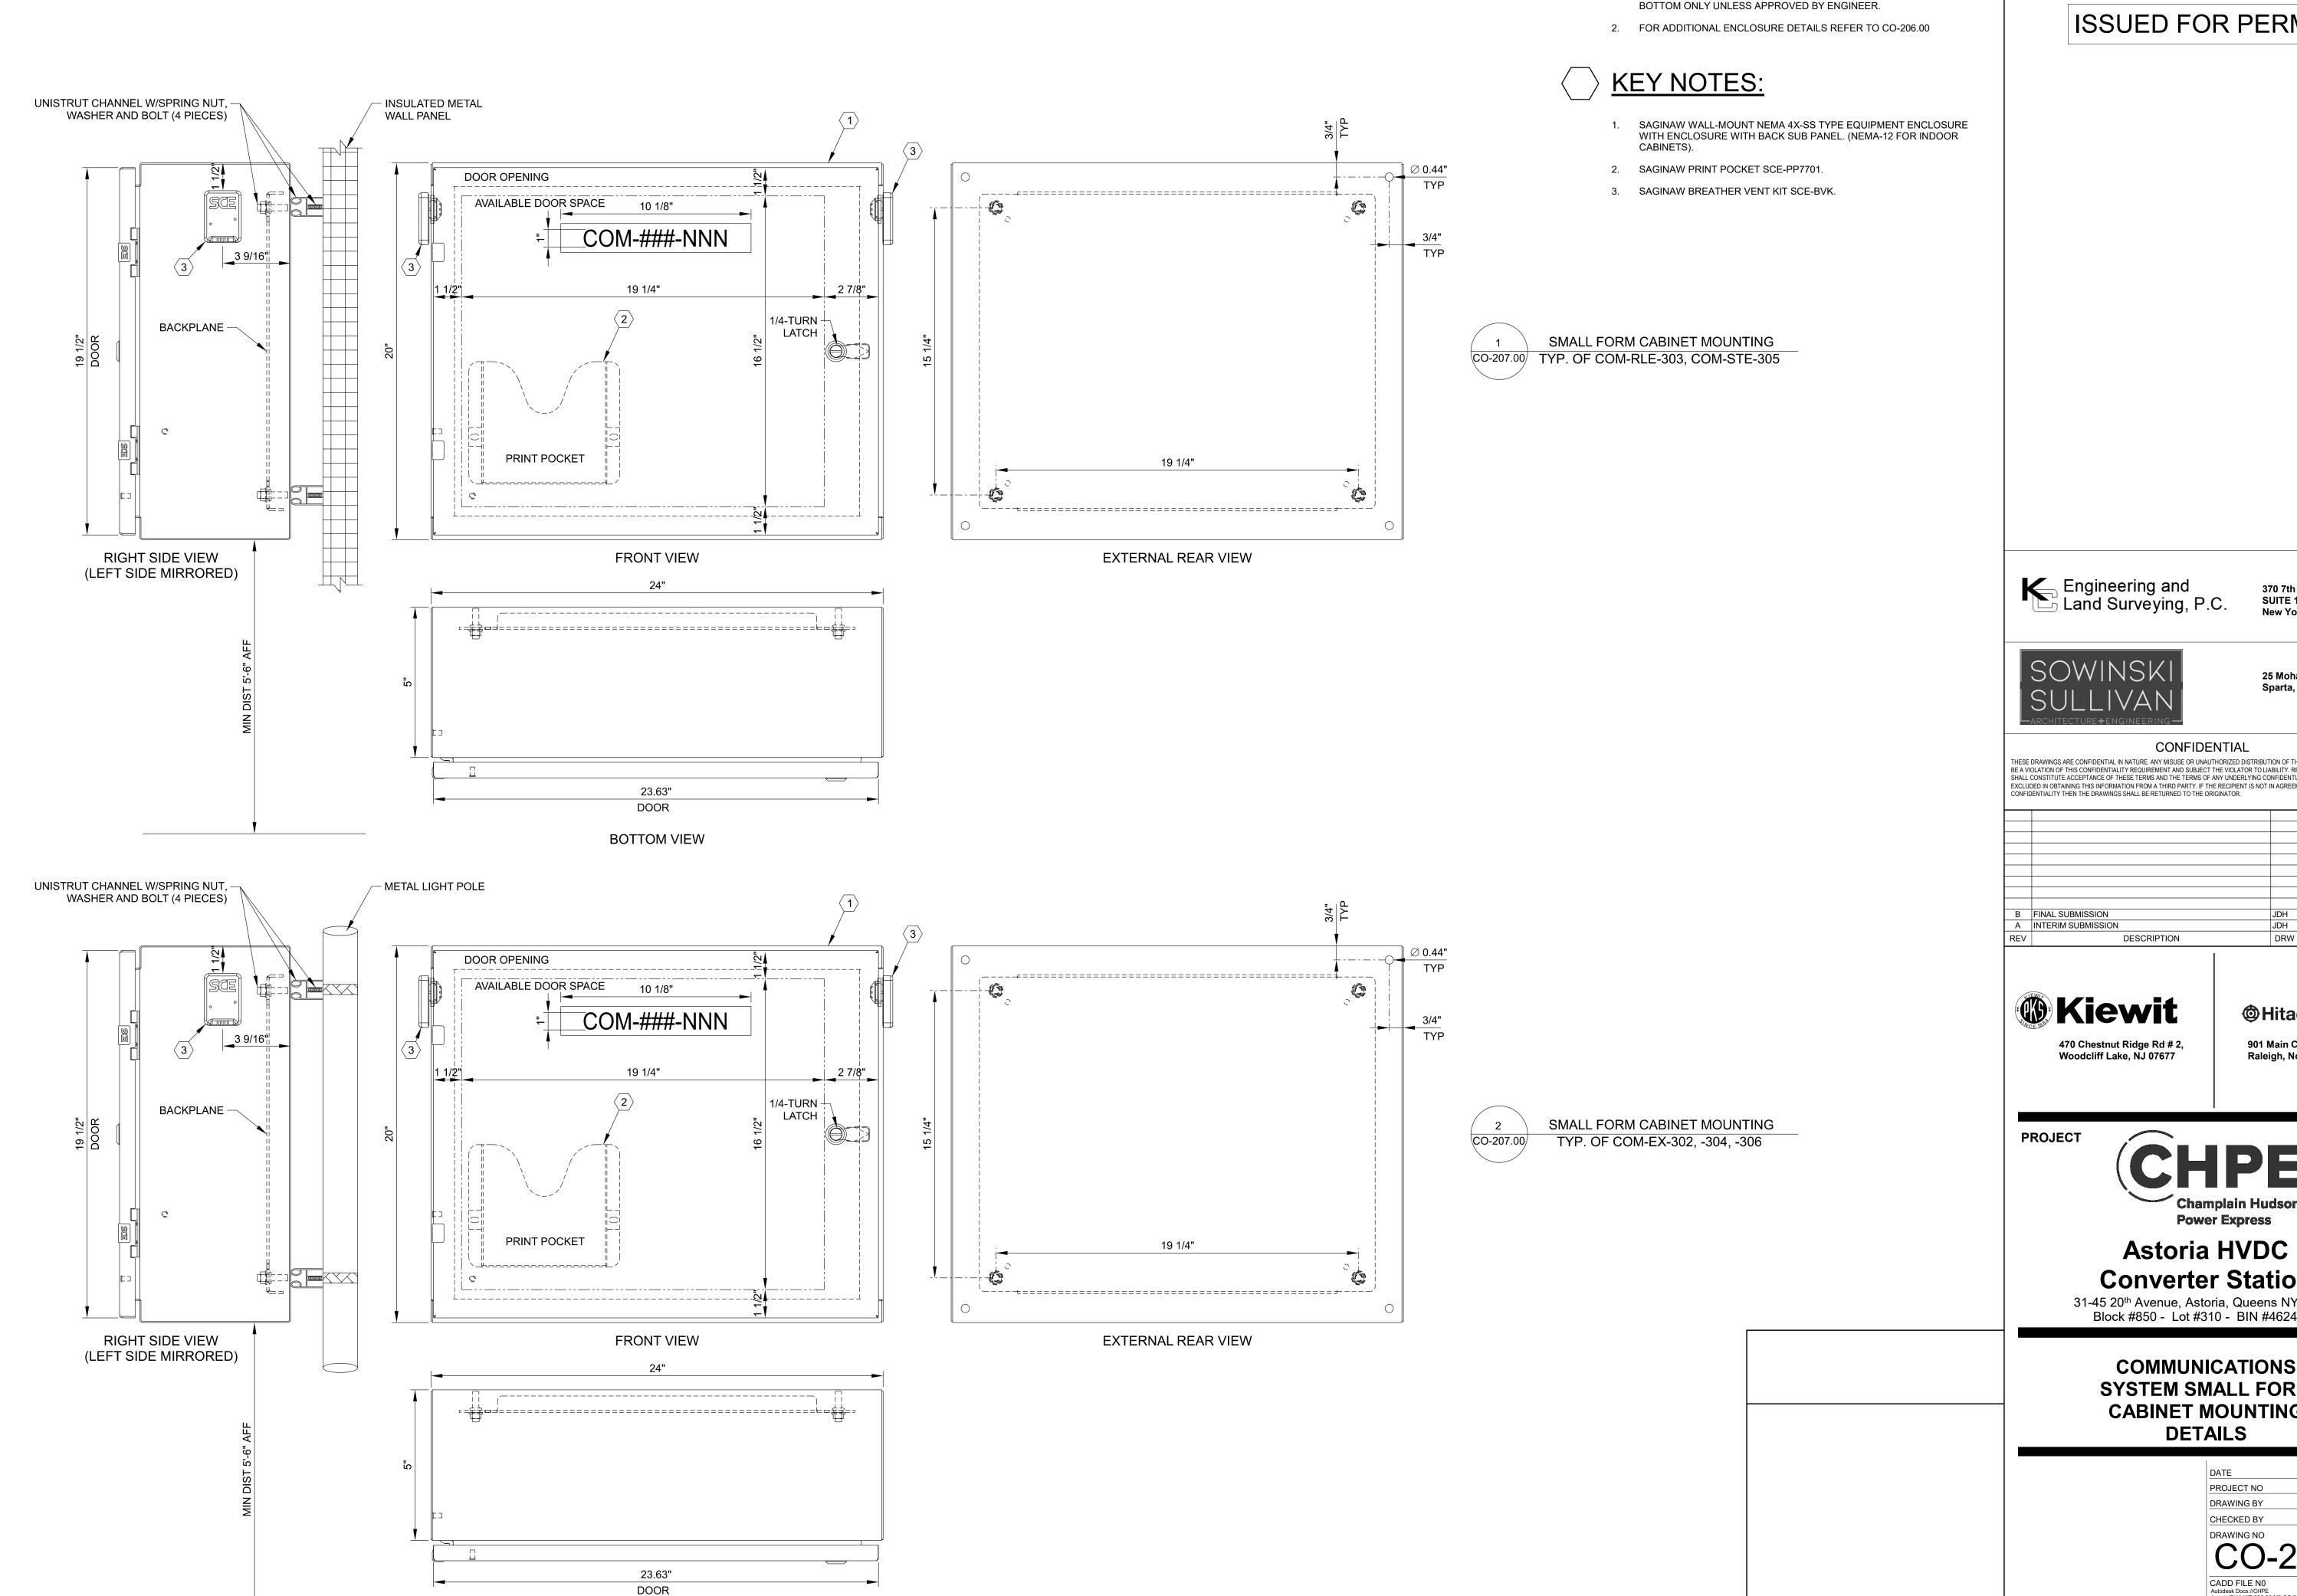

ISSUED FOR PERMIT

**GENERAL NOTES:** 

WHEN INSTALLED OUTDOORS, CONDUIT ENTRY SHALL BE FROM THE

370 7th Avenue **SUITE 1604** New York, NY 10001



25 Mohawk Avenue **Sparta, NJ 07871** 

THESE DRAWINGS ARE CONFIDENTIAL IN NATURE. ANY MISUSE OR UNAUTHORIZED DISTRIBUTION OF THE DRAWINGS CONTAINED HEREIN WILL BE A VIOLATION OF THIS CONFIDENTIALITY REQUIREMENT AND SUBJECT THE VIOLATOR TO LIABILITY. REVIEW OF THESE MATERIALS BY RECEIPT SHALL CONSTITUTE ACCEPTANCE OF THESE TERMS AND THE TERMS OF ANY UNDERLYING CONFIDENTIALITY AGREEMENT WE MAY HAVE EXCLUDED IN OBTAINING THIS INFORMATION FROM A THIRD PARTY. IF THE RECIPIENT IS NOT IN AGREEMENT WITH THE OBLIGATION OF CONFIDENTIALITY THEN THE DRAWINGS SHALL BE RETURNED TO THE ORIGINATOR.

DRW BY CHK BY DATE

**@**Hitachi Energy 901 Main Campus Drive

Raleigh, North Carolina 27606




**Converter Station** 

31-45 20th Avenue, Astoria, Queens NY 11105


Block #850 - Lot #310 - BIN #4624437

COMMUNICATIONS SYSTEM SMALL FORM **CABINET MOUNTING DETAILS** 

> 08/29/2022 PROJECT NO CHECKED BY

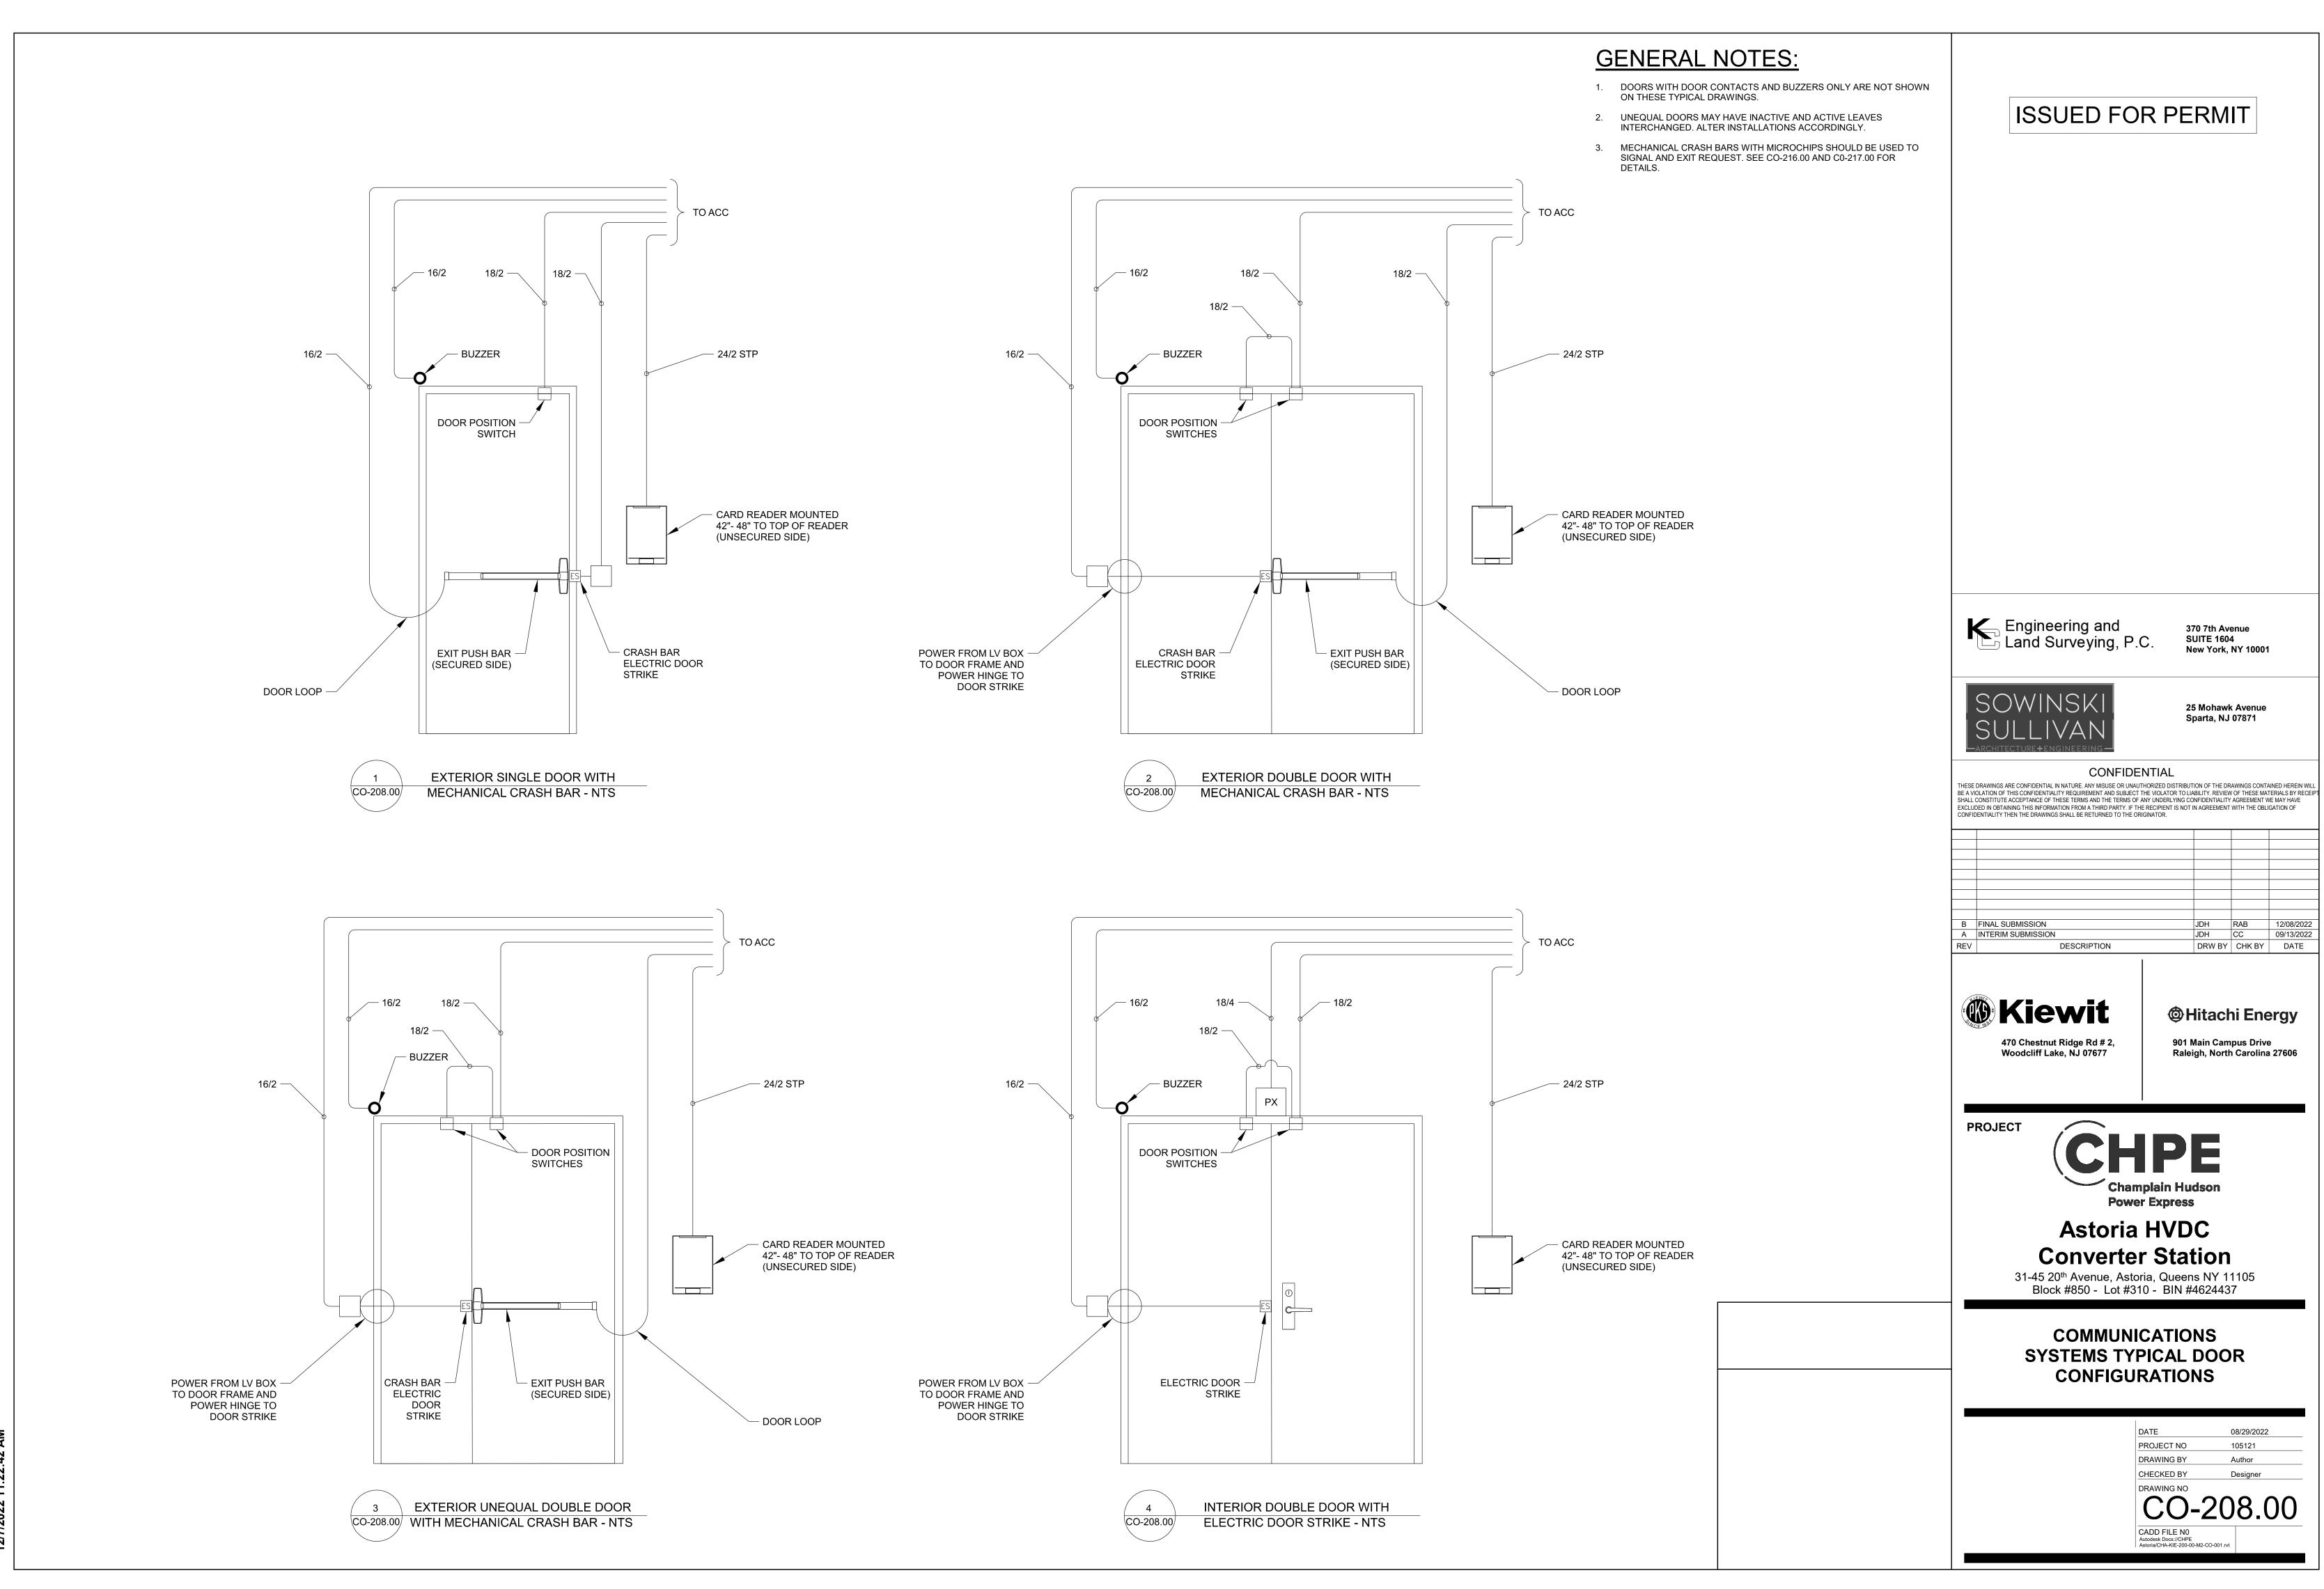

MA CA.CC. 44.000/7/0

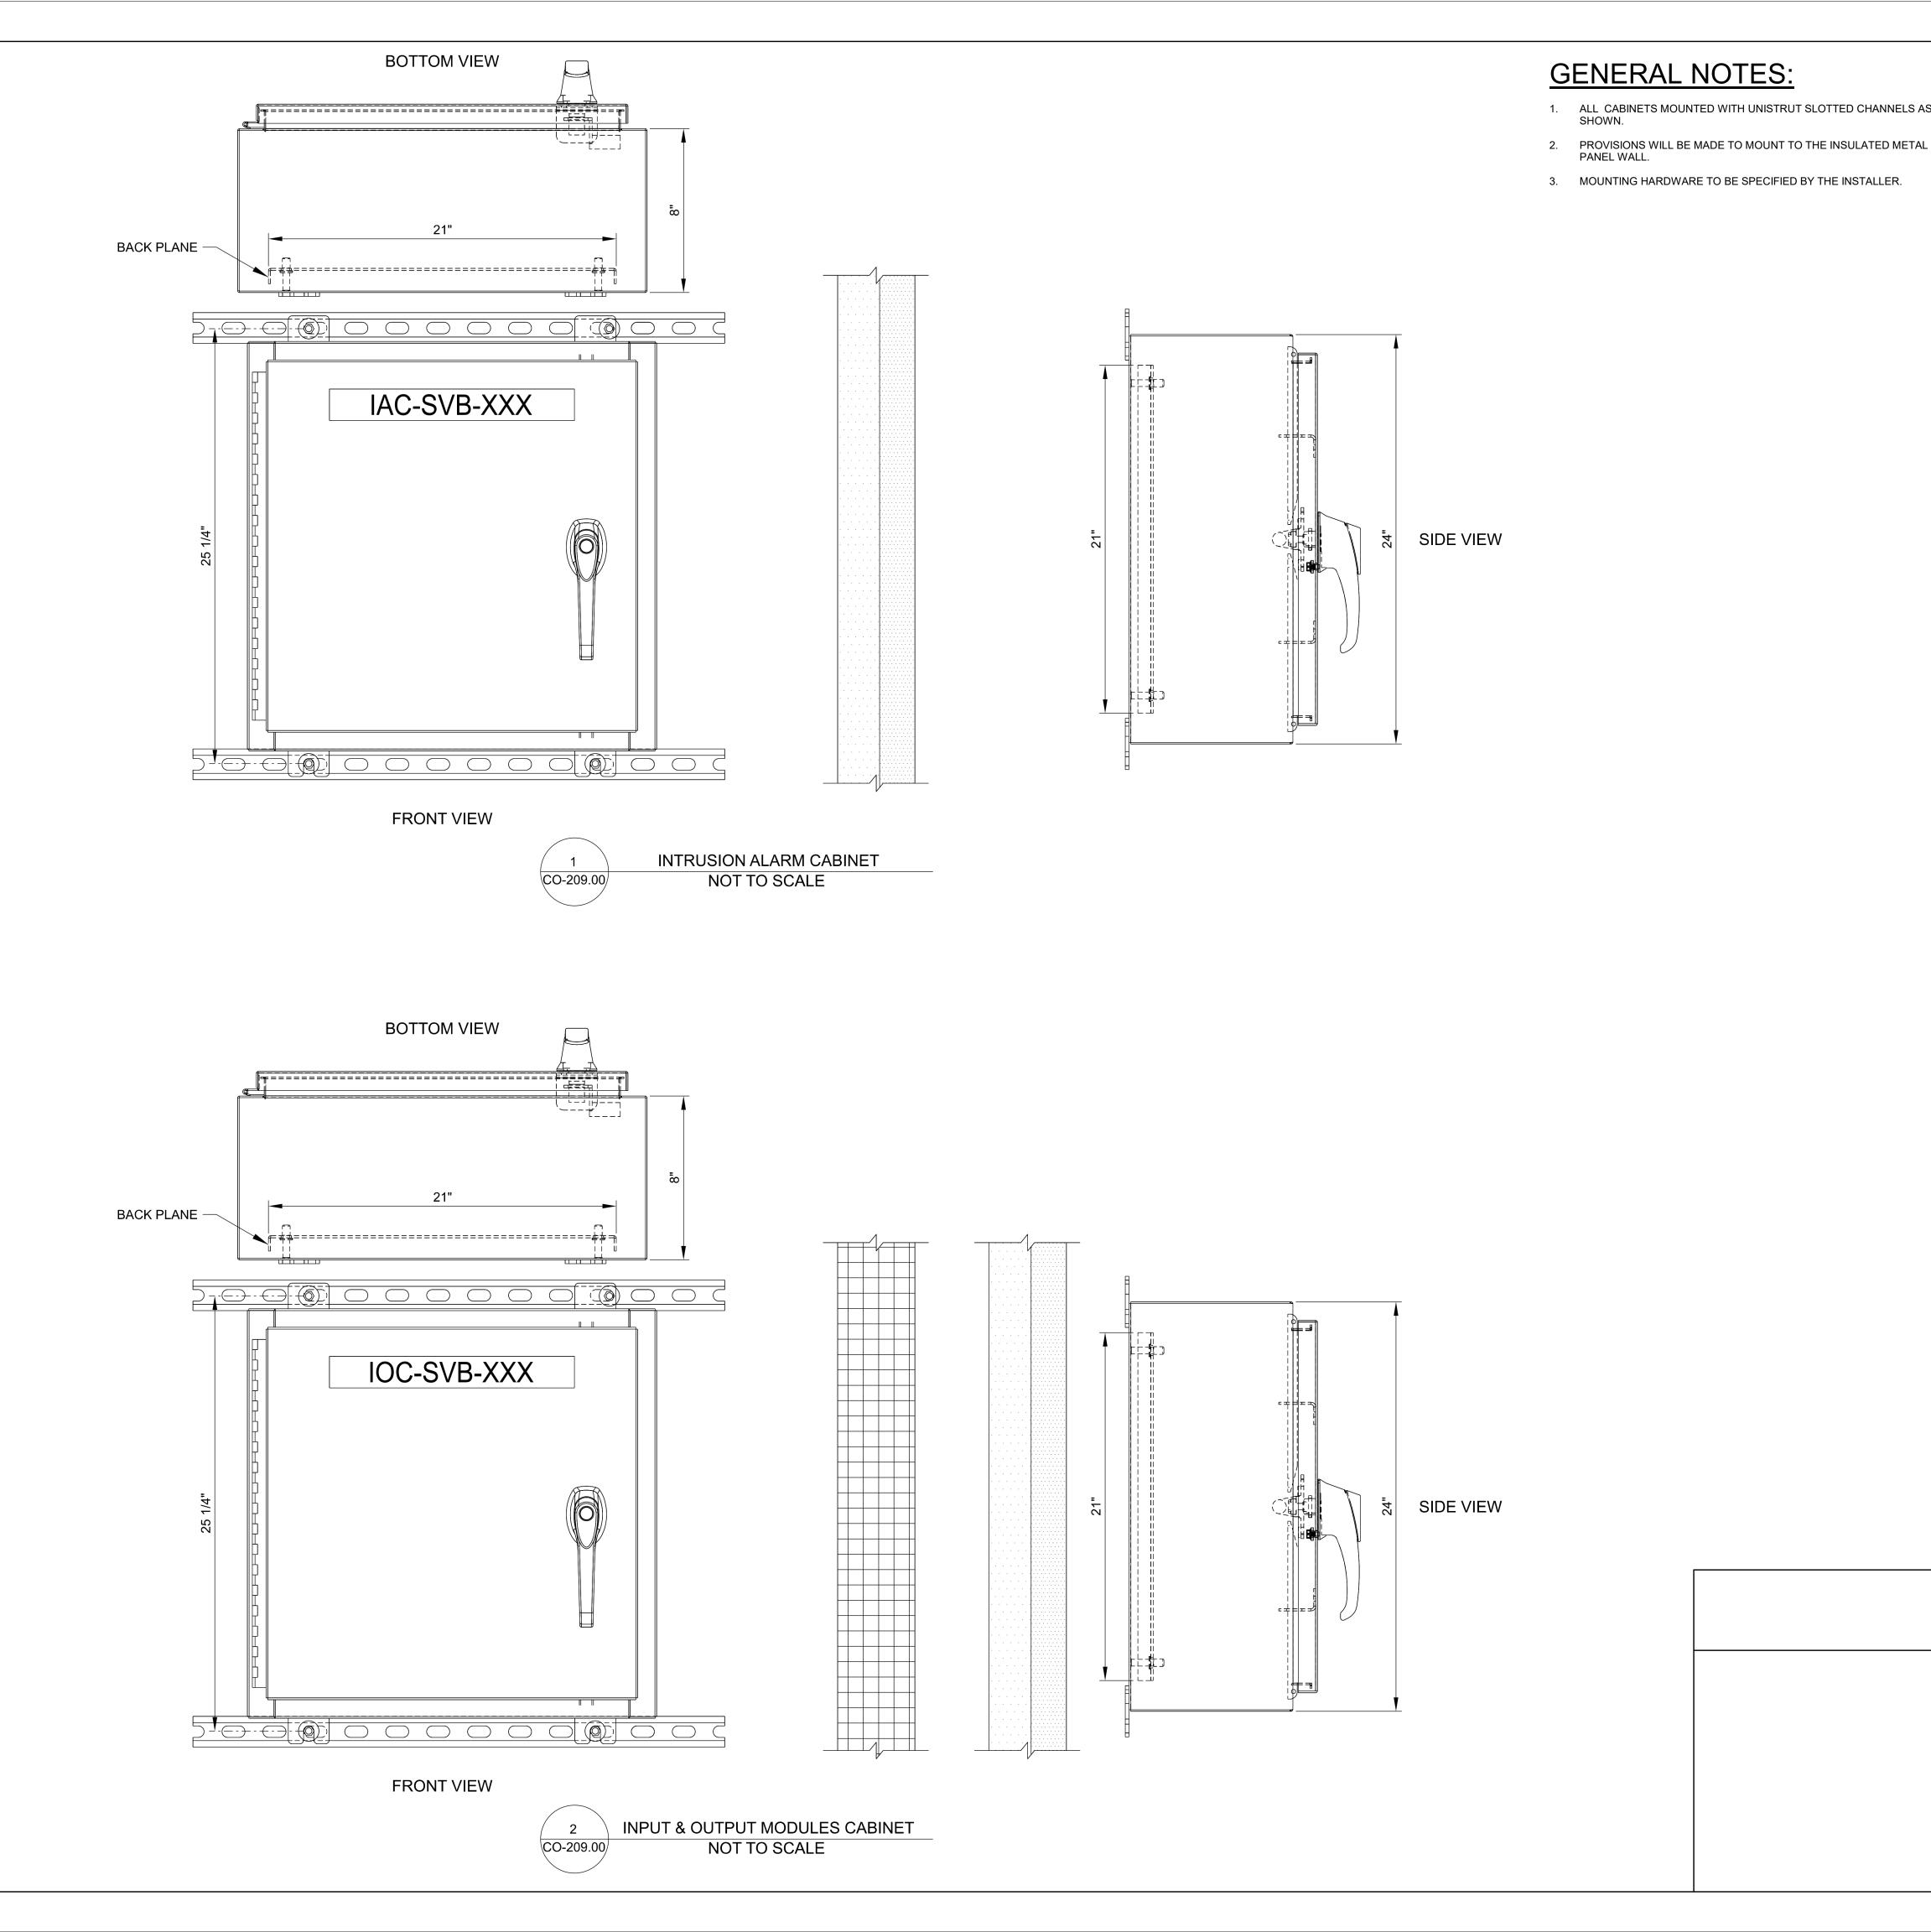

### 1. ALL CABINETS MOUNTED WITH UNISTRUT SLOTTED CHANNELS AS

ISSUED FOR PERMIT

Engineering and Land Surveying, P.C.

370 7th Avenue **SUITE 1604** New York, NY 10001



25 Mohawk Avenue **Sparta, NJ 07871** 

THESE DRAWINGS ARE CONFIDENTIAL IN NATURE. ANY MISUSE OR UNAUTHORIZED DISTRIBUTION OF THE DRAWINGS CONTAINED HEREIN WILL BE A VIOLATION OF THIS CONFIDENTIALITY REQUIREMENT AND SUBJECT THE VIOLATOR TO LIABILITY. REVIEW OF THESE MATERIALS BY RECEIPT SHALL CONSTITUTE ACCEPTANCE OF THESE TERMS AND THE TERMS OF ANY UNDERLYING CONFIDENTIALITY AGREEMENT WE MAY HAVE EXCLUDED IN OBTAINING THIS INFORMATION FROM A THIRD PARTY. IF THE RECIPIENT IS NOT IN AGREEMENT WITH THE OBLIGATION OF CONFIDENTIALITY THEN THE DRAWINGS SHALL BE RETURNED TO THE ORIGINATOR.

В	FINAL SUBMISSION	JDH	RAB	12/08/2022
Α	INTERIM SUBMISSION	JDH	CC	09/13/2022
REV	DESCRIPTION	DRW BY	CHK BY	DATE



**@**Hitachi Energy 901 Main Campus Drive Raleigh, North Carolina 27606



### **Astoria HVDC Converter Station**


31-45 20<sup>th</sup> Avenue, Astoria, Queens NY 11105 Block #850 - Lot #310 - BIN #4624437

COMMUNICATIONS **SYSTEMS INTRUSION SYSTEM CABINET MOUNTING DETAILS** 

1	
DATE	08/29/2022
PROJECT NO	105121
DRAWING BY	Author
CHECKED BY	Designer
DRAWING NO	

CO-209.00


#### **BOTTOM VIEW**

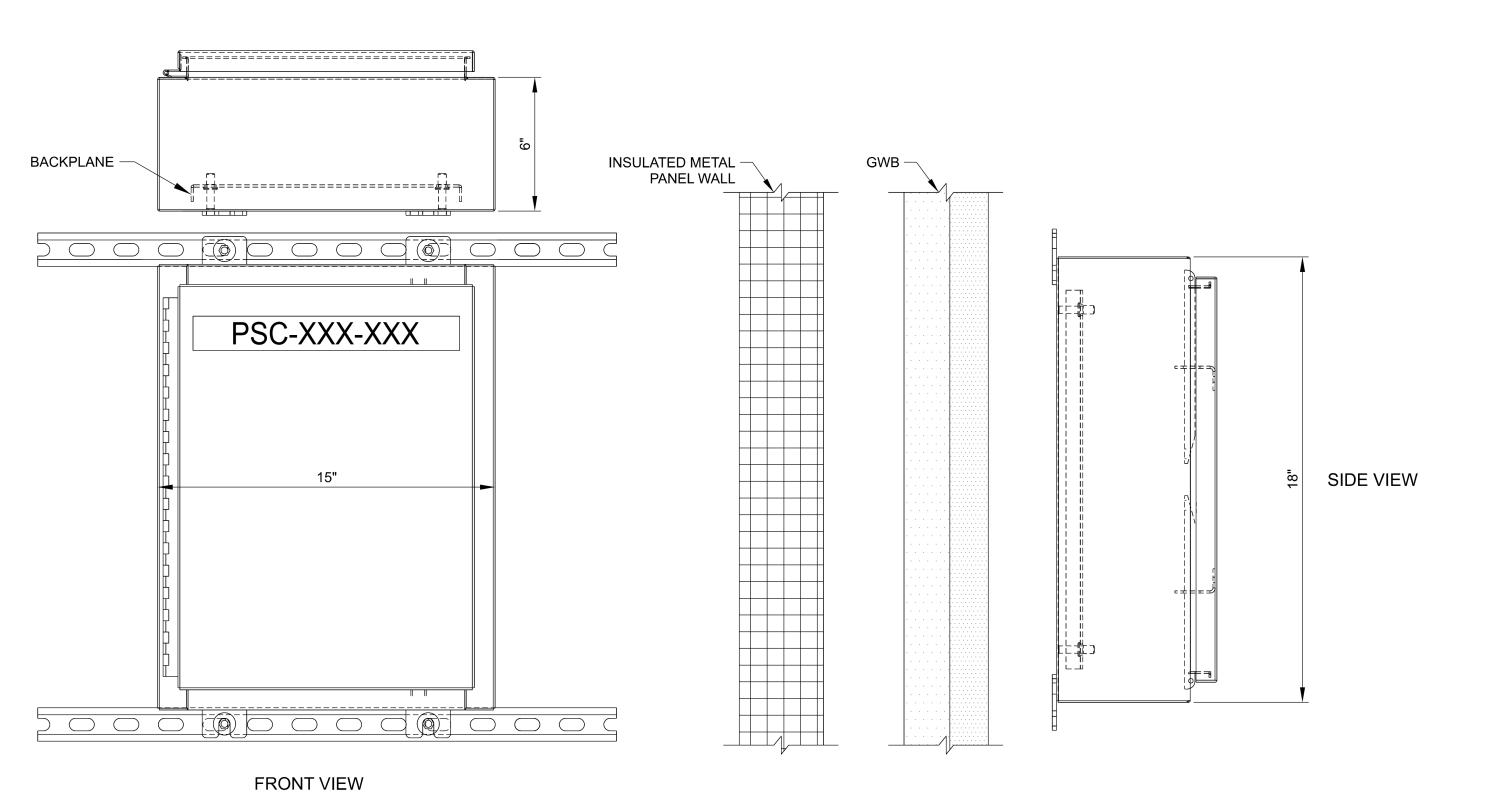



POWER SUPPLY CABINET


NOT TO SCALE

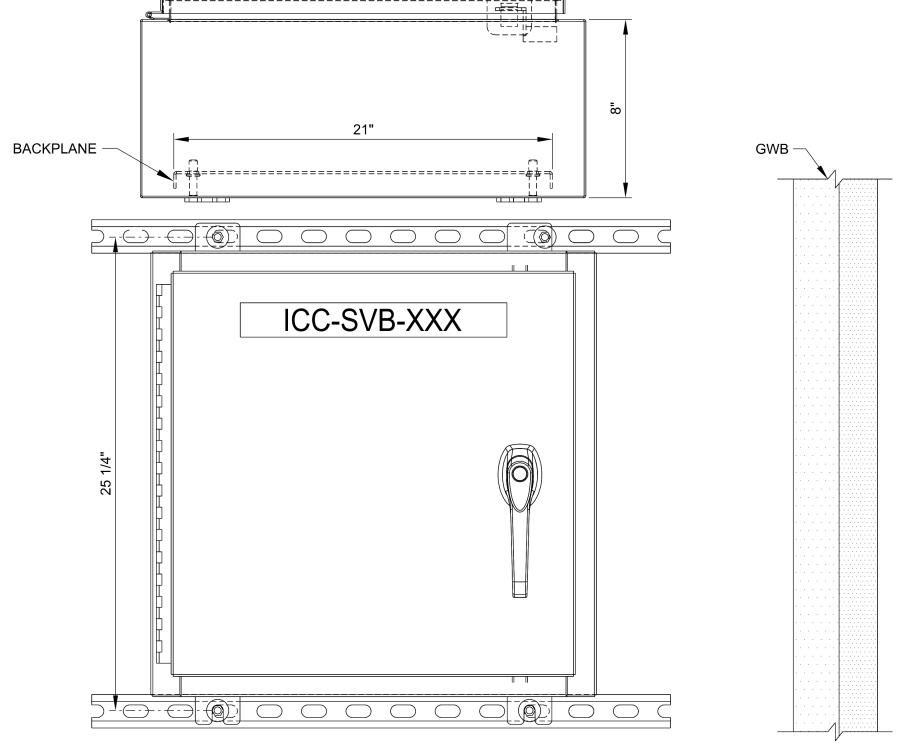

FRONT VIEW

CO-210.00



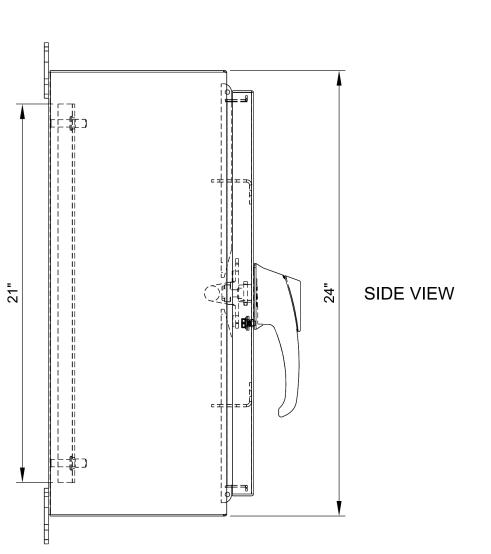


### **GENERAL NOTES:**

- 1. ALL CABINETS MOUNTED WITH UNISTRUT SLOTTED CHANNELS AS
- PROVISIONS WILL BE MADE TO MOUNT TO THE INSULATED METAL PANEL WALL.

### KEY NOTES:

- 1. ELECTRIC DISCONNECT SWITCH, SEE CO-214.00 & CO-233.00 FOR
- 2. POWER SUPPLY, SEE CO-214.00 & CO-223 FOR DETAILS
- 3. TERMINAL BOARD.
- 4. BATTERY.

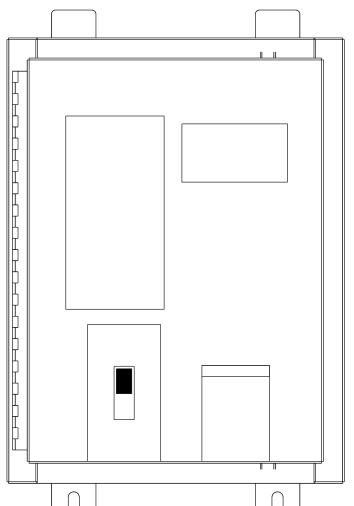

ISSUED FOR PERMIT

Engineering and Land Surveying, P.C.

370 7th Avenue SUITE 1604 New York, NY 10001



25 Mohawk Avenue Sparta, NJ 07871

CONFIDENTI

THESE DRAWINGS ARE CONFIDENTIAL IN NATURE. ANY MISUSE OR UNAUTHORIZED DISTRIBUTION OF THE DRAWINGS CONTAINED HEREIN WILL BE A VIOLATION OF THIS CONFIDENTIALITY REQUIREMENT AND SUBJECT THE VIOLATOR TO LIABILITY. REVIEW OF THESE MATERIALS BY RECEIPT SHALL CONSTITUTE ACCEPTANCE OF THESE TERMS AND THE TERMS OF ANY UNDERLYING CONFIDENTIALITY AGREEMENT WE MAY HAVE EXCLUDED IN OBTAINING THIS INFORMATION FROM A THIRD PARTY. IF THE RECIPIENT IS NOT IN AGREEMENT WITH THE OBLIGATION OF CONFIDENTIALITY THEN THE DRAWINGS SHALL BE RETURNED TO THE ORIGINATOR.

В	FINAL SUBMISSION	JDH	RAB	12/08/2022
Α	INTERIM SUBMISSION	JDH	CC	09/13/2022
REV	DESCRIPTION	DRW BY	CHK BY	DATE



**@**Hitachi Energy

901 Main Campus Drive Raleigh, North Carolina 27606

PROJECT



Astoria HVDC Converter Station

31-45 20<sup>th</sup> Avenue, Astoria, Queens NY 11105 Block #850 - Lot #310 - BIN #4624437

COMMUNICATIONS

SYSTEMS PSC & ICC MOUNTING DETAILS

 DATE
 08/29/2022

 PROJECT NO
 105121

 DRAWING BY
 Author

 CHECKED BY
 Designer


CO-210.00

Autodesk Docs://CHPE Astoria/CHA-KIE-200-00-M2-CO-001.rvt


- 1. ACCESS CONTROL CABINETS WILL BE USED ANYWHERE THE MR62e CONTROLLERS ARE USED. THIS INCLUDES THE MVS ENCLOSURE, STORAGE ENCLOSURE, RELAY ENCLOSURE, AND SERVICE BUILDING
- 2. ALL MOUNTING LOCATIONS WITH THE EXCEPTIONS OF THE SERVICE BUILDING, HAVE INSULATED METAL PANEL WALLS THAT WILL BE MOUNTED AS SHOWN.
- 3. THE SERVICE BUILDING ACCESS CONTROL CABINETS WILL BE MOUNTED TO THE GWB WALLS SPECIFIED IN THE ARCHITECTURE PACKAGE.

### **KEY NOTES:**


- ACCESS CONTROL CABINET.
- BACKPLANE.
- 3. MR62e NETWORK DOOR CONTROLLER
- 5. WIRE MANAGEMENT SPOOL

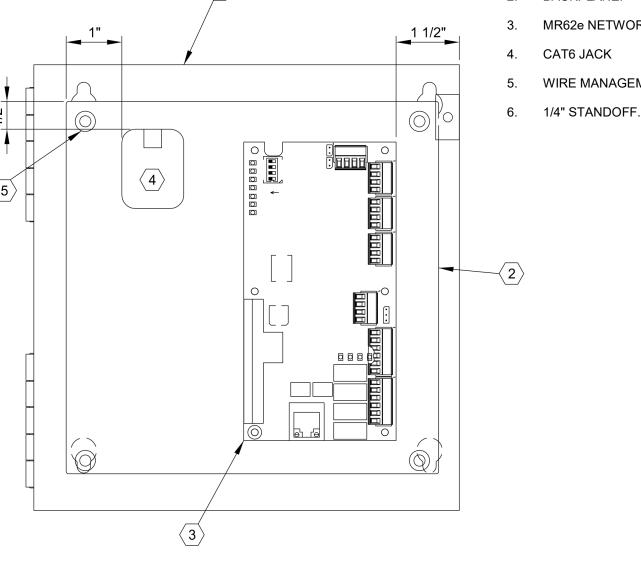

1 (DOOR NOT SHOWN)

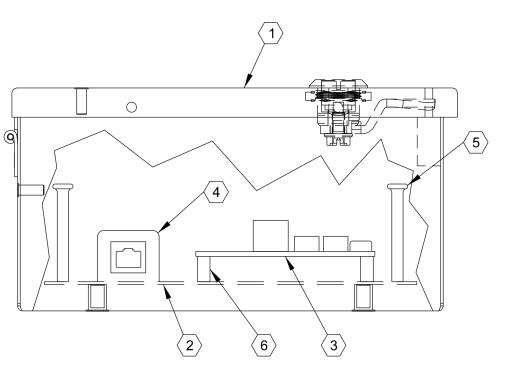



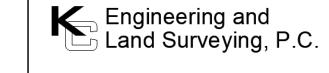

370 7th Avenue **SUITE 1604** New York, NY 10001



25 Mohawk Avenue **Sparta, NJ 07871** 

CONFIDENTIAL

**ISSUED FOR PERMIT** 

THESE DRAWINGS ARE CONFIDENTIAL IN NATURE. ANY MISUSE OR UNAUTHORIZED DISTRIBUTION OF THE DRAWINGS CONTAINED HEREIN WILL BE A VIOLATION OF THIS CONFIDENTIALITY REQUIREMENT AND SUBJECT THE VIOLATOR TO LIABILITY. REVIEW OF THESE MATERIALS BY RECEIPT SHALL CONSTITUTE ACCEPTANCE OF THESE TERMS AND THE TERMS OF ANY UNDERLYING CONFIDENTIALITY AGREEMENT WE MAY HAVE EXCLUDED IN OBTAINING THIS INFORMATION FROM A THIRD PARTY. IF THE RECIPIENT IS NOT IN AGREEMENT WITH THE OBLIGATION OF CONFIDENTIALITY THEN THE DRAWINGS SHALL BE RETURNED TO THE ORIGINATOR.

В	FINAL SUBMISSION	JDH	RAB	12/08/2022
Α	INTERIM SUBMISSION	JDH	CC	09/13/2022
REV	DESCRIPTION	DRW BY	CHK BY	DATE



**@**Hitachi Energy 901 Main Campus Drive Raleigh, North Carolina 27606




**Astoria HVDC Converter Station** 

31-45 20<sup>th</sup> Avenue, Astoria, Queens NY 11105 Block #850 - Lot #310 - BIN #4624437


COMMUNICATIONS SYSTEMS ACCESS **CONTROL CABINET MOUNTING DETAILS** 


DATE	08/29/2022
PROJECT NO	105121
DRAWING BY	Author
CHECKED BY	Designer
DRAWING NO	

CO-211.00

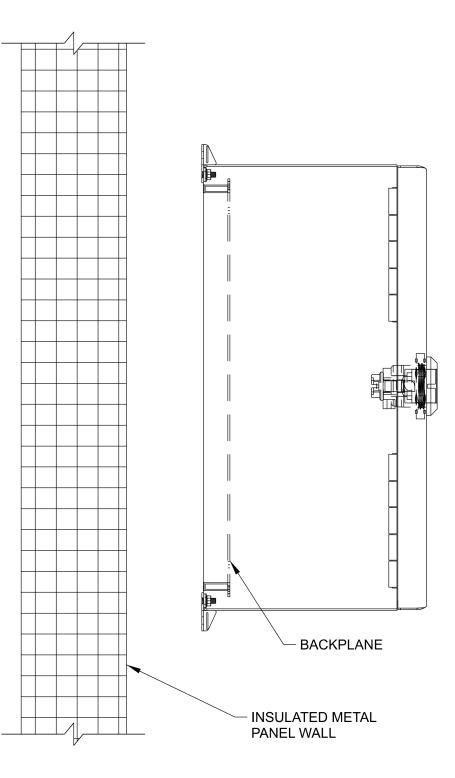





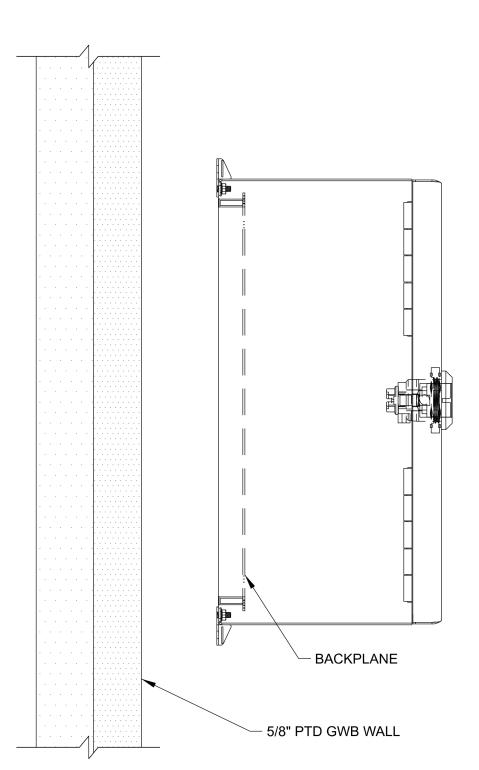

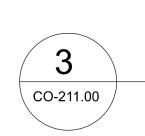


ACCESS CONTROL CABINET DRYWALL MOUNTING - NTS

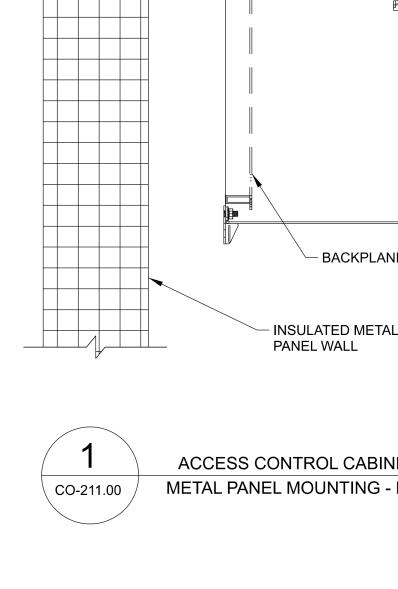


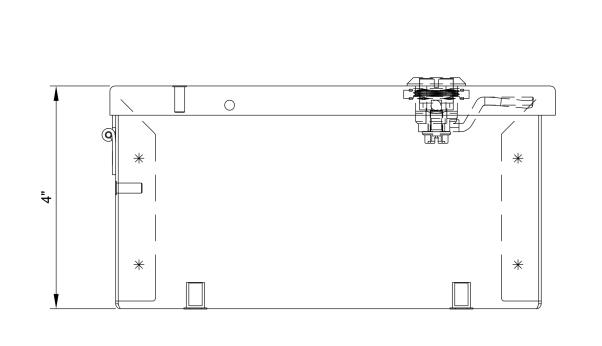


ACC-SVB-XXX

1/4-TURN LATCH -

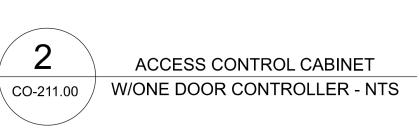

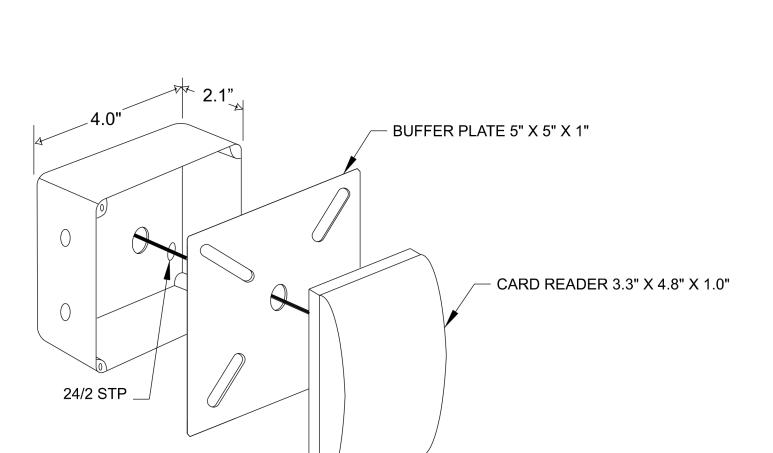

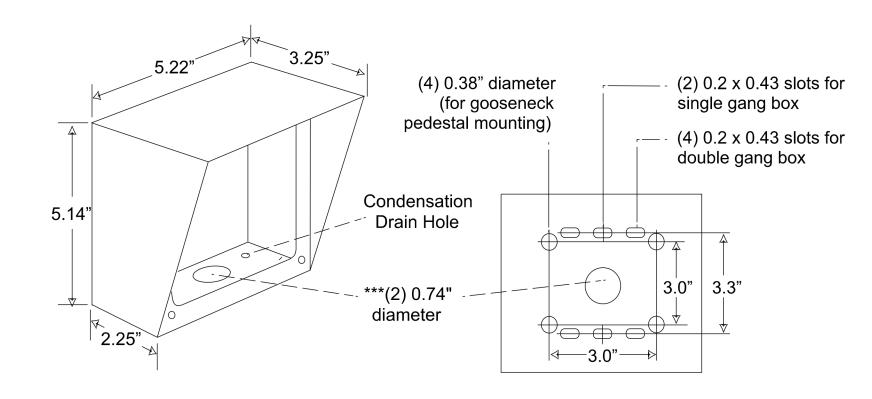



FRONT VIEW OF OPTIONAL VE-5X5


REAR VIEW OF VE-5X5





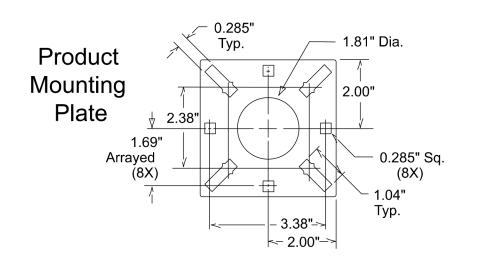

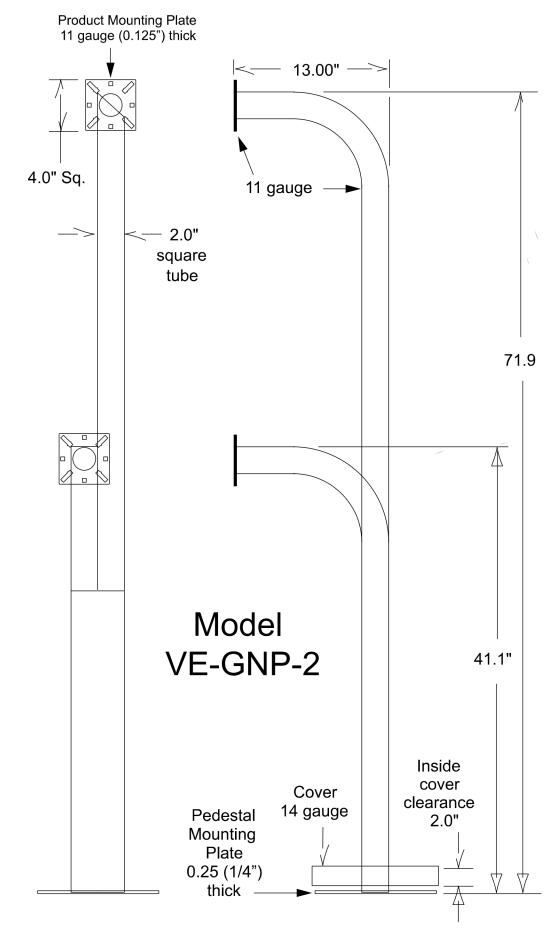

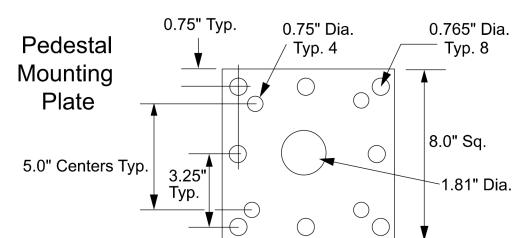

### ISSUED FOR PERMIT



370 7th Avenue SUITE 1604 New York, NY 10001



25 Mohawk Avenue Sparta, NJ 07871

CONFIDENTIAL

THESE DRAWINGS ARE CONFIDENTIAL IN NATURE. ANY MISUSE OR UNAUTHORIZED DISTRIBUTION OF THE DRAWINGS CONTAINED HEREIN WILL BE A VIOLATION OF THIS CONFIDENTIALITY REQUIREMENT AND SUBJECT THE VIOLATOR TO LIABILITY. REVIEW OF THESE MATERIALS BY RECEIPT SHALL CONSTITUTE ACCEPTANCE OF THESE TERMS AND THE TERMS OF ANY UNDERLYING CONFIDENTIALITY AGREEMENT WE MAY HAVE EXCLUDED IN OBTAINING THIS INFORMATION FROM A THIRD PARTY. IF THE RECIPIENT IS NOT IN AGREEMENT WITH THE OBLIGATION OF CONFIDENTIALITY THEN THE DRAWINGS SHALL BE RETURNED TO THE ORIGINATOR.

В	FINAL SUBMISSION	JDH	RAB	12/08/202
Α	INTERIM SUBMISSION	JDH	CC	09/13/202
RF\/	DESCRIPTION	DRW BY	CHK BY	DATE



901 Main Campus Drive Raleigh, North Carolina 27606

PROJEC



Astoria HVDC Converter Station

31-45 20<sup>th</sup> Avenue, Astoria, Queens NY 11105 Block #850 - Lot #310 - BIN #4624437

Block #850 - Lot #310 - BIN #4624437

COMMUNICATIONS
SYSTEMS CARD READER
DUAL HEIGHT PEDESTAL
MOUNTING

 DATE
 08/29/2022


 PROJECT NO
 105121

 DRAWING BY
 Author

 CHECKED BY
 Designer

 DRAWING NO

CO-212.00

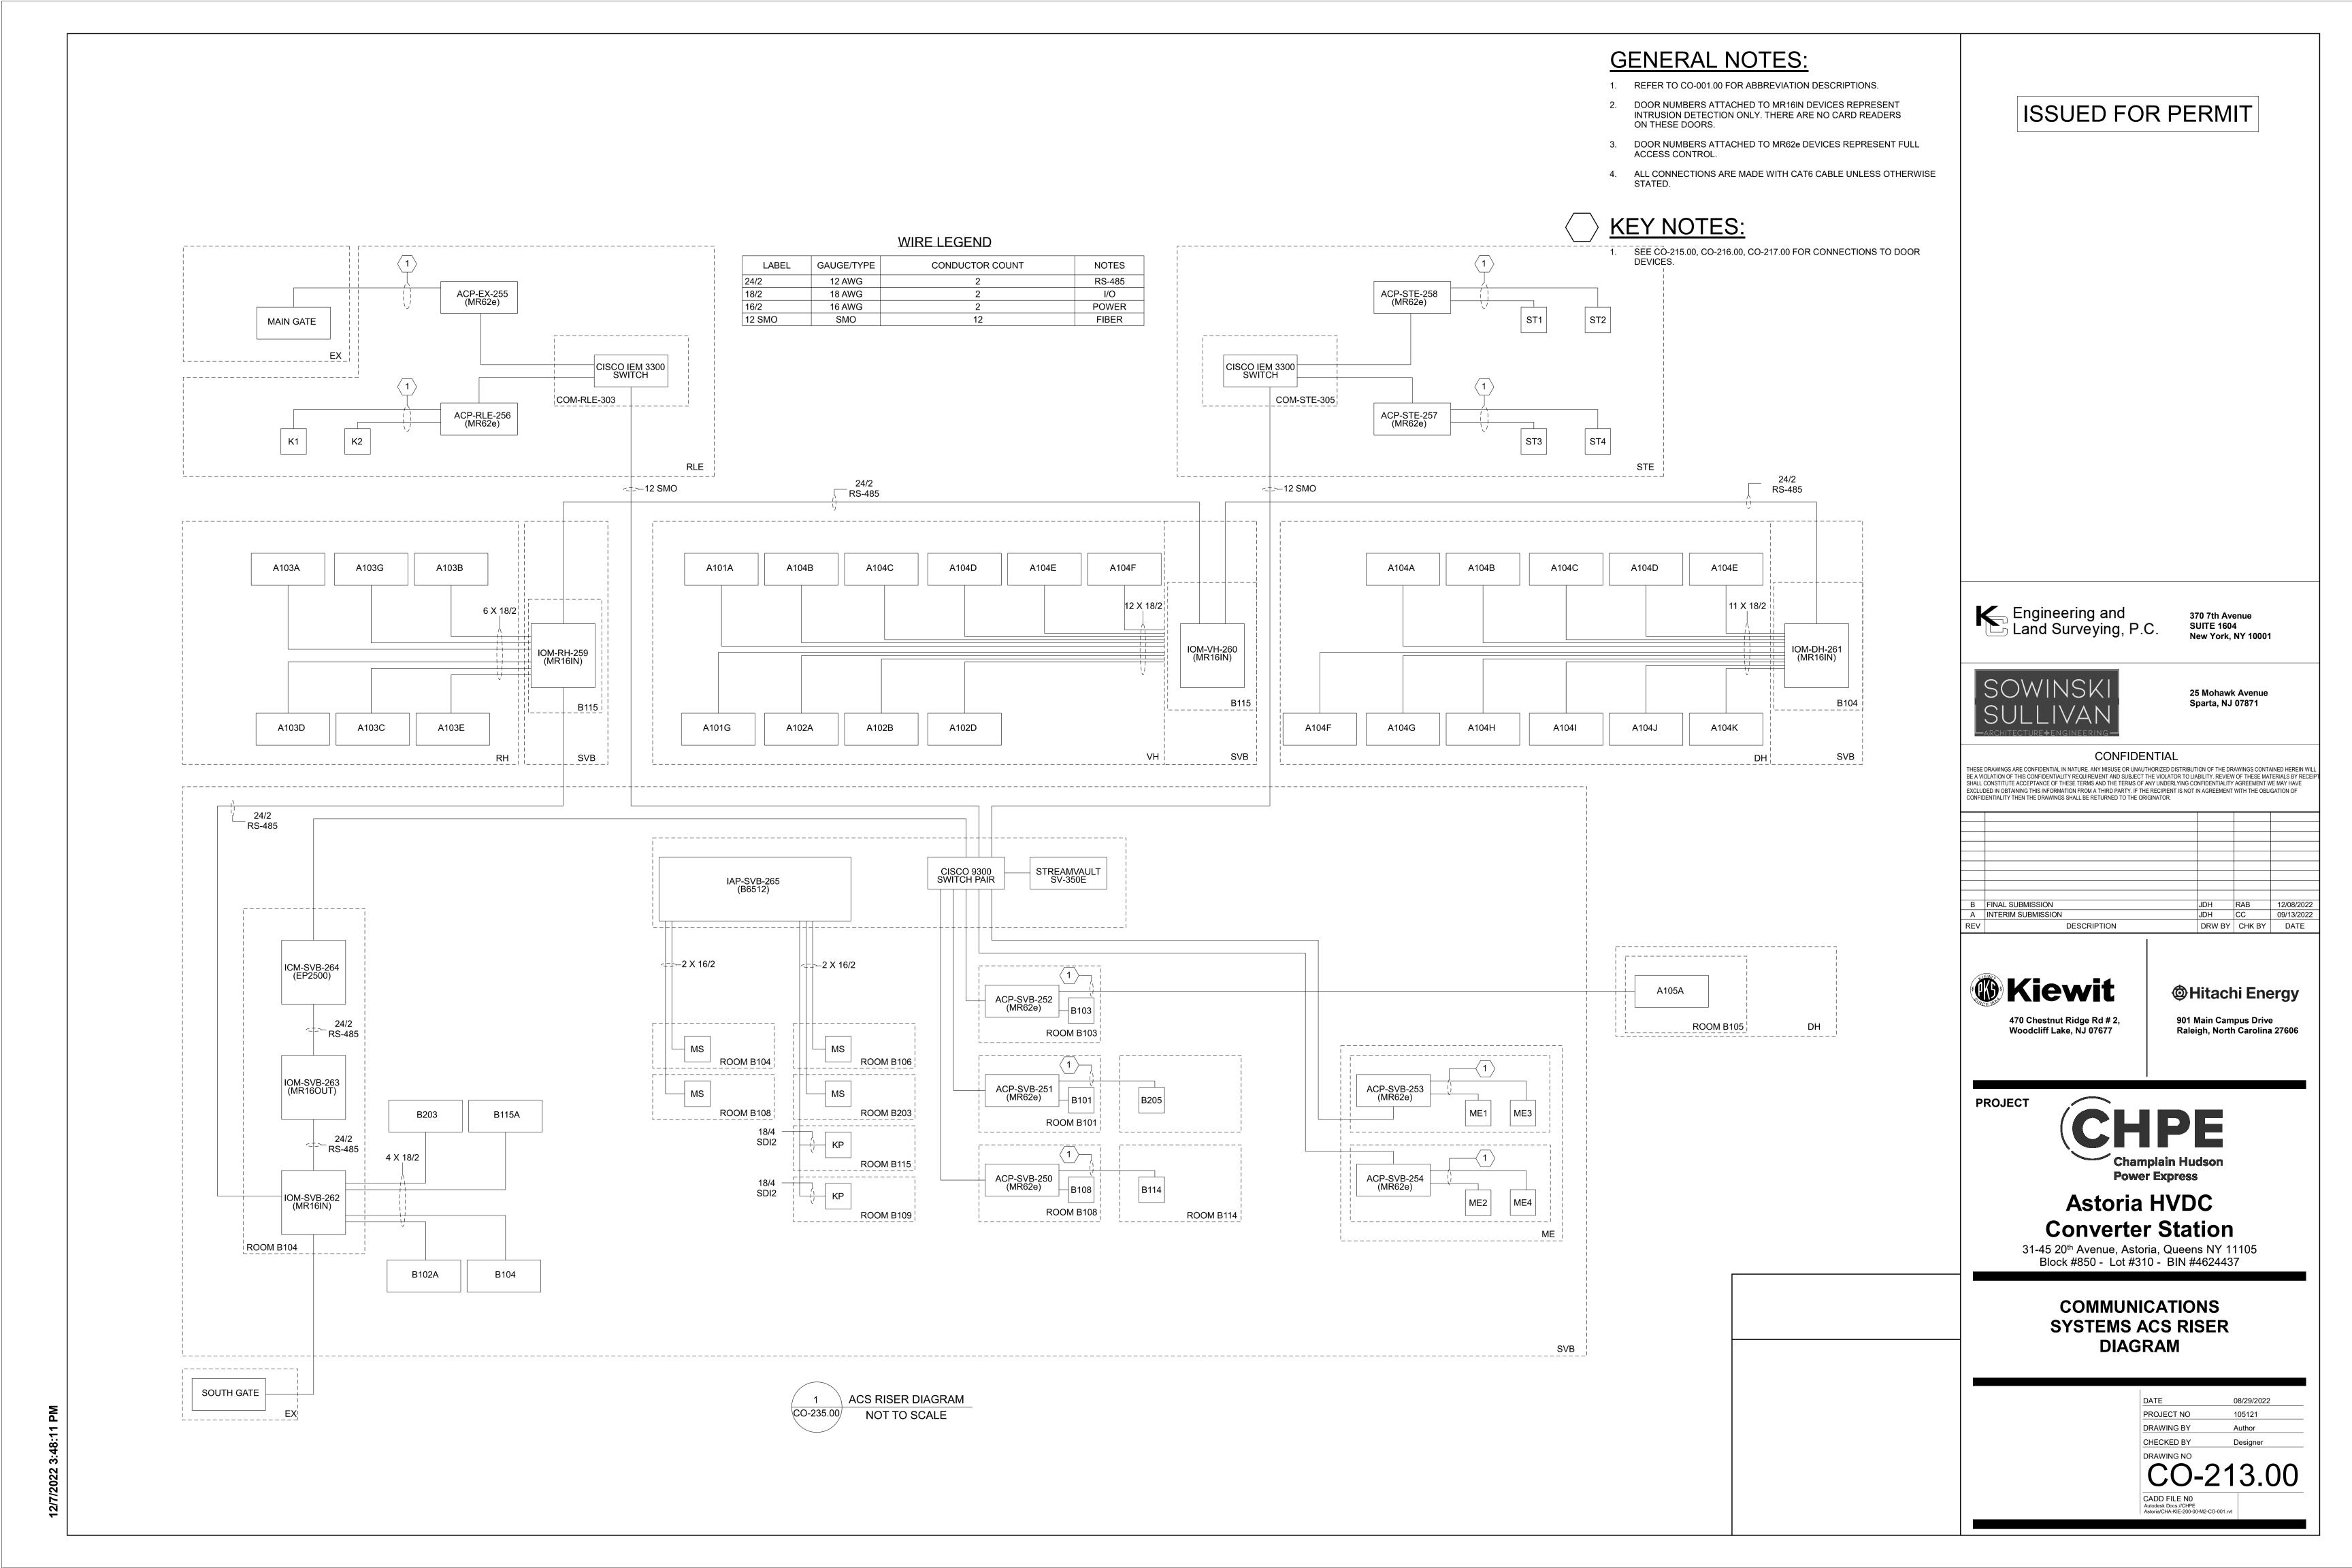




 SEE ELECTRICAL DRAWINGS FOR FURTHER DETAILS ON BREAKERS AND PANELBOARDS.




- 1. 120VAC, 30A DISCONNECT SWITCH
- 2. 24VDC POWER SUPPLY WITH 8 OUTPUT TERMINALS. SEE STANDARD SPECIFICATIONS FOR ADDITIONAL DETAILS.
- 3. CX4010 PLUG-IN 18VAC, 22VA TRANSFORMER 60HZ.
- 4. POWER SUPPLIES WILL SUPPLY POWER TO ALL MR62e BOARDS WITHIN THE SPECIFIED AREA. THESE CONTROLLER BOARD ARE NOT SHOWN HERE FOR SIMPLICITY.
- 5. SEE DRAWING CO-229.00 FOR ADDITIONAL POWER LOADS.

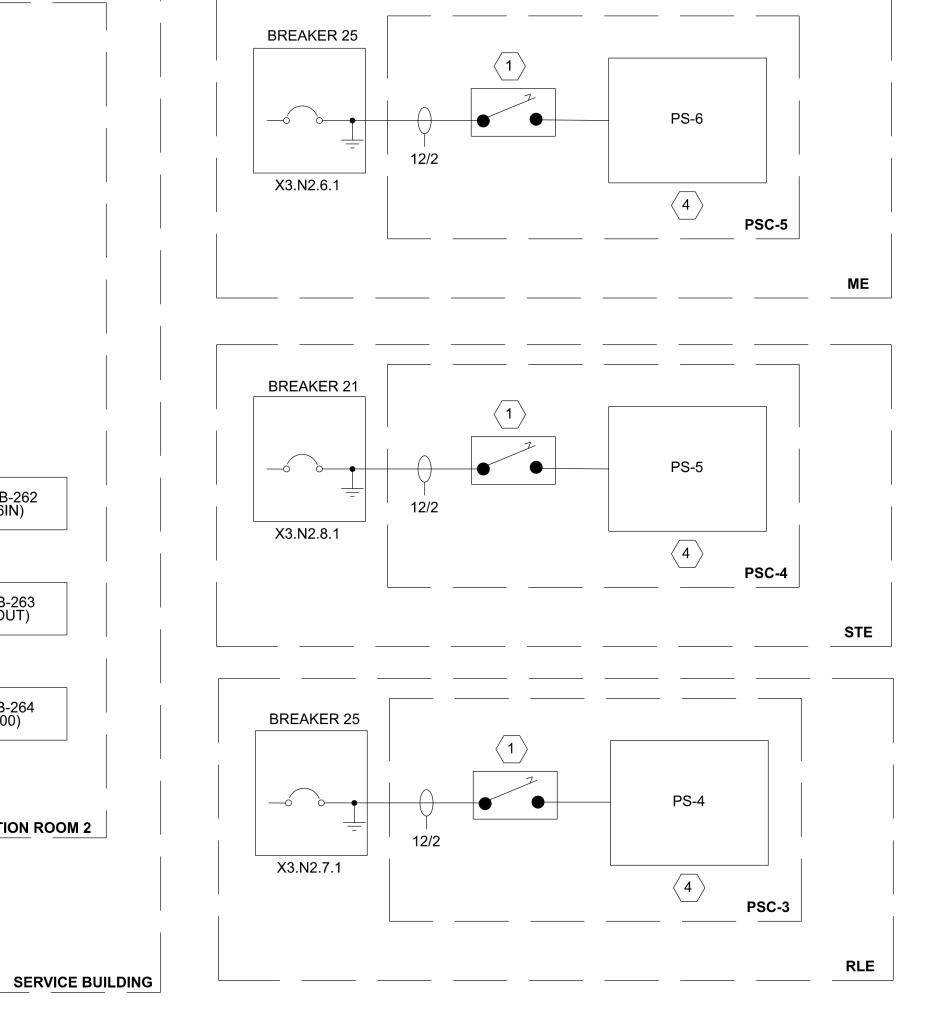

ISSUED FOR PERMIT



370 7th Avenue SUITE 1604 New York, NY 10001

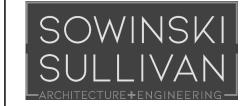

25 Mohawk Avenue Sparta, NJ 07871

#### CONFIDENTIAL

THESE DRAWINGS ARE CONFIDENTIAL IN NATURE. ANY MISUSE OR UNAUTHORIZED DISTRIBUTION OF THE DRAWINGS CONTAINED HEREIN WILL BE A VIOLATION OF THIS CONFIDENTIALITY REQUIREMENT AND SUBJECT THE VIOLATOR TO LIABILITY. REVIEW OF THESE MATERIALS BY RECEIPT SHALL CONSTITUTE ACCEPTANCE OF THESE TERMS AND THE TERMS OF ANY UNDERLYING CONFIDENTIALITY AGREEMENT WE MAY HAVE EXCLUDED IN OBTAINING THIS INFORMATION FROM A THIRD PARTY. IF THE RECIPIENT IS NOT IN AGREEMENT WITH THE OBLIGATION OF CONFIDENTIALITY THEN THE DRAWINGS SHALL BE RETURNED TO THE ORIGINATOR.

В	FINAL SUBMISSION	JDH	RAB	12/08/2022
Α	INTERIM SUBMISSION	JDH	CC	09/13/2022
REV	DESCRIPTION	DRW BY	CHK BY	DATE



Hitachi Energy901 Main Campus Drive Raleigh, North Carolina 27606



### Astoria HVDC Converter Station


31-45 20<sup>th</sup> Avenue, Astoria, Queens NY 11105 Block #850 - Lot #310 - BIN #4624437

COMMUNICATIONS SYSTEMS ACS POWER SUPPLY DIAGRAM

DATE	08/29/2022
PROJECT NO	105121
DRAWING BY	Author
CHECKED BY	Designer
	•

CO-214.00

Autodesk Docs://CHPE
Astoria/CHA-KIE-200-00-M2-CO-001.rvt

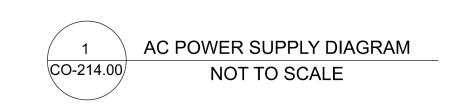

IOM-DH-259 (MR16IN)

REACTOR HALL

BREAKER 12

UPS

SVE-350E

COM-SVB-301

IOM-DH-261 (MR16IN)

DC HALL

BREAKER 14

**─**12/2

TRANSFORMER

IAP-SVB-265 (B6512)

PS-2

PS-3

CONTROL AND PROTECTION ROOM 2

PSC-2

TELECOM ROOM B205

IOM-DH-260 (MR16IN)

**VALVE HALL** 

**BREAKER 16** 

**BREAKER 18** 

<u>— 12/2</u>

PS-1

PSC-1

PANELBOARD TLC-EMG-111-X3.N2.11.1

- 16|2 (24VDC)


ICM-SVB-264 (EP2500)


CONTROL AND PROTECTION ROOM 2

- 1. THE POWER SUPPLY SHOWN IS A 8 TERMINAL DEVICE, BUT ONLY THOSE RELEVANT TO THIS WIRING DIAGRAM ARE DISPLAYED HERE. THE DEPICTION IS USED TO BETTER SHOW WHICH COMPONENTS SHARE TERMINALS.
- 2. REFER TO BILL OF MATERIALS ON SHEET CO-223.00 FOR ADDITIONAL

### **KEY NOTES:**

- 1. DOOR POSITION SWITCH. SEE CO-223.00 FOR DETAILS
- 2. OSDP CARD READER. SEE CO-223.00 FOR DETAILS
- 3. TWO DOOR ACCESS CONTROL MODULE. SEE CO-223.00 FOR DETAILS.
- 4. MOTOR CONTROLLER. SEE CO-223.00 FOR DETAILS.
- 5. RESISTOR RACK. SEE CO-223.00 FOR DETAILS.

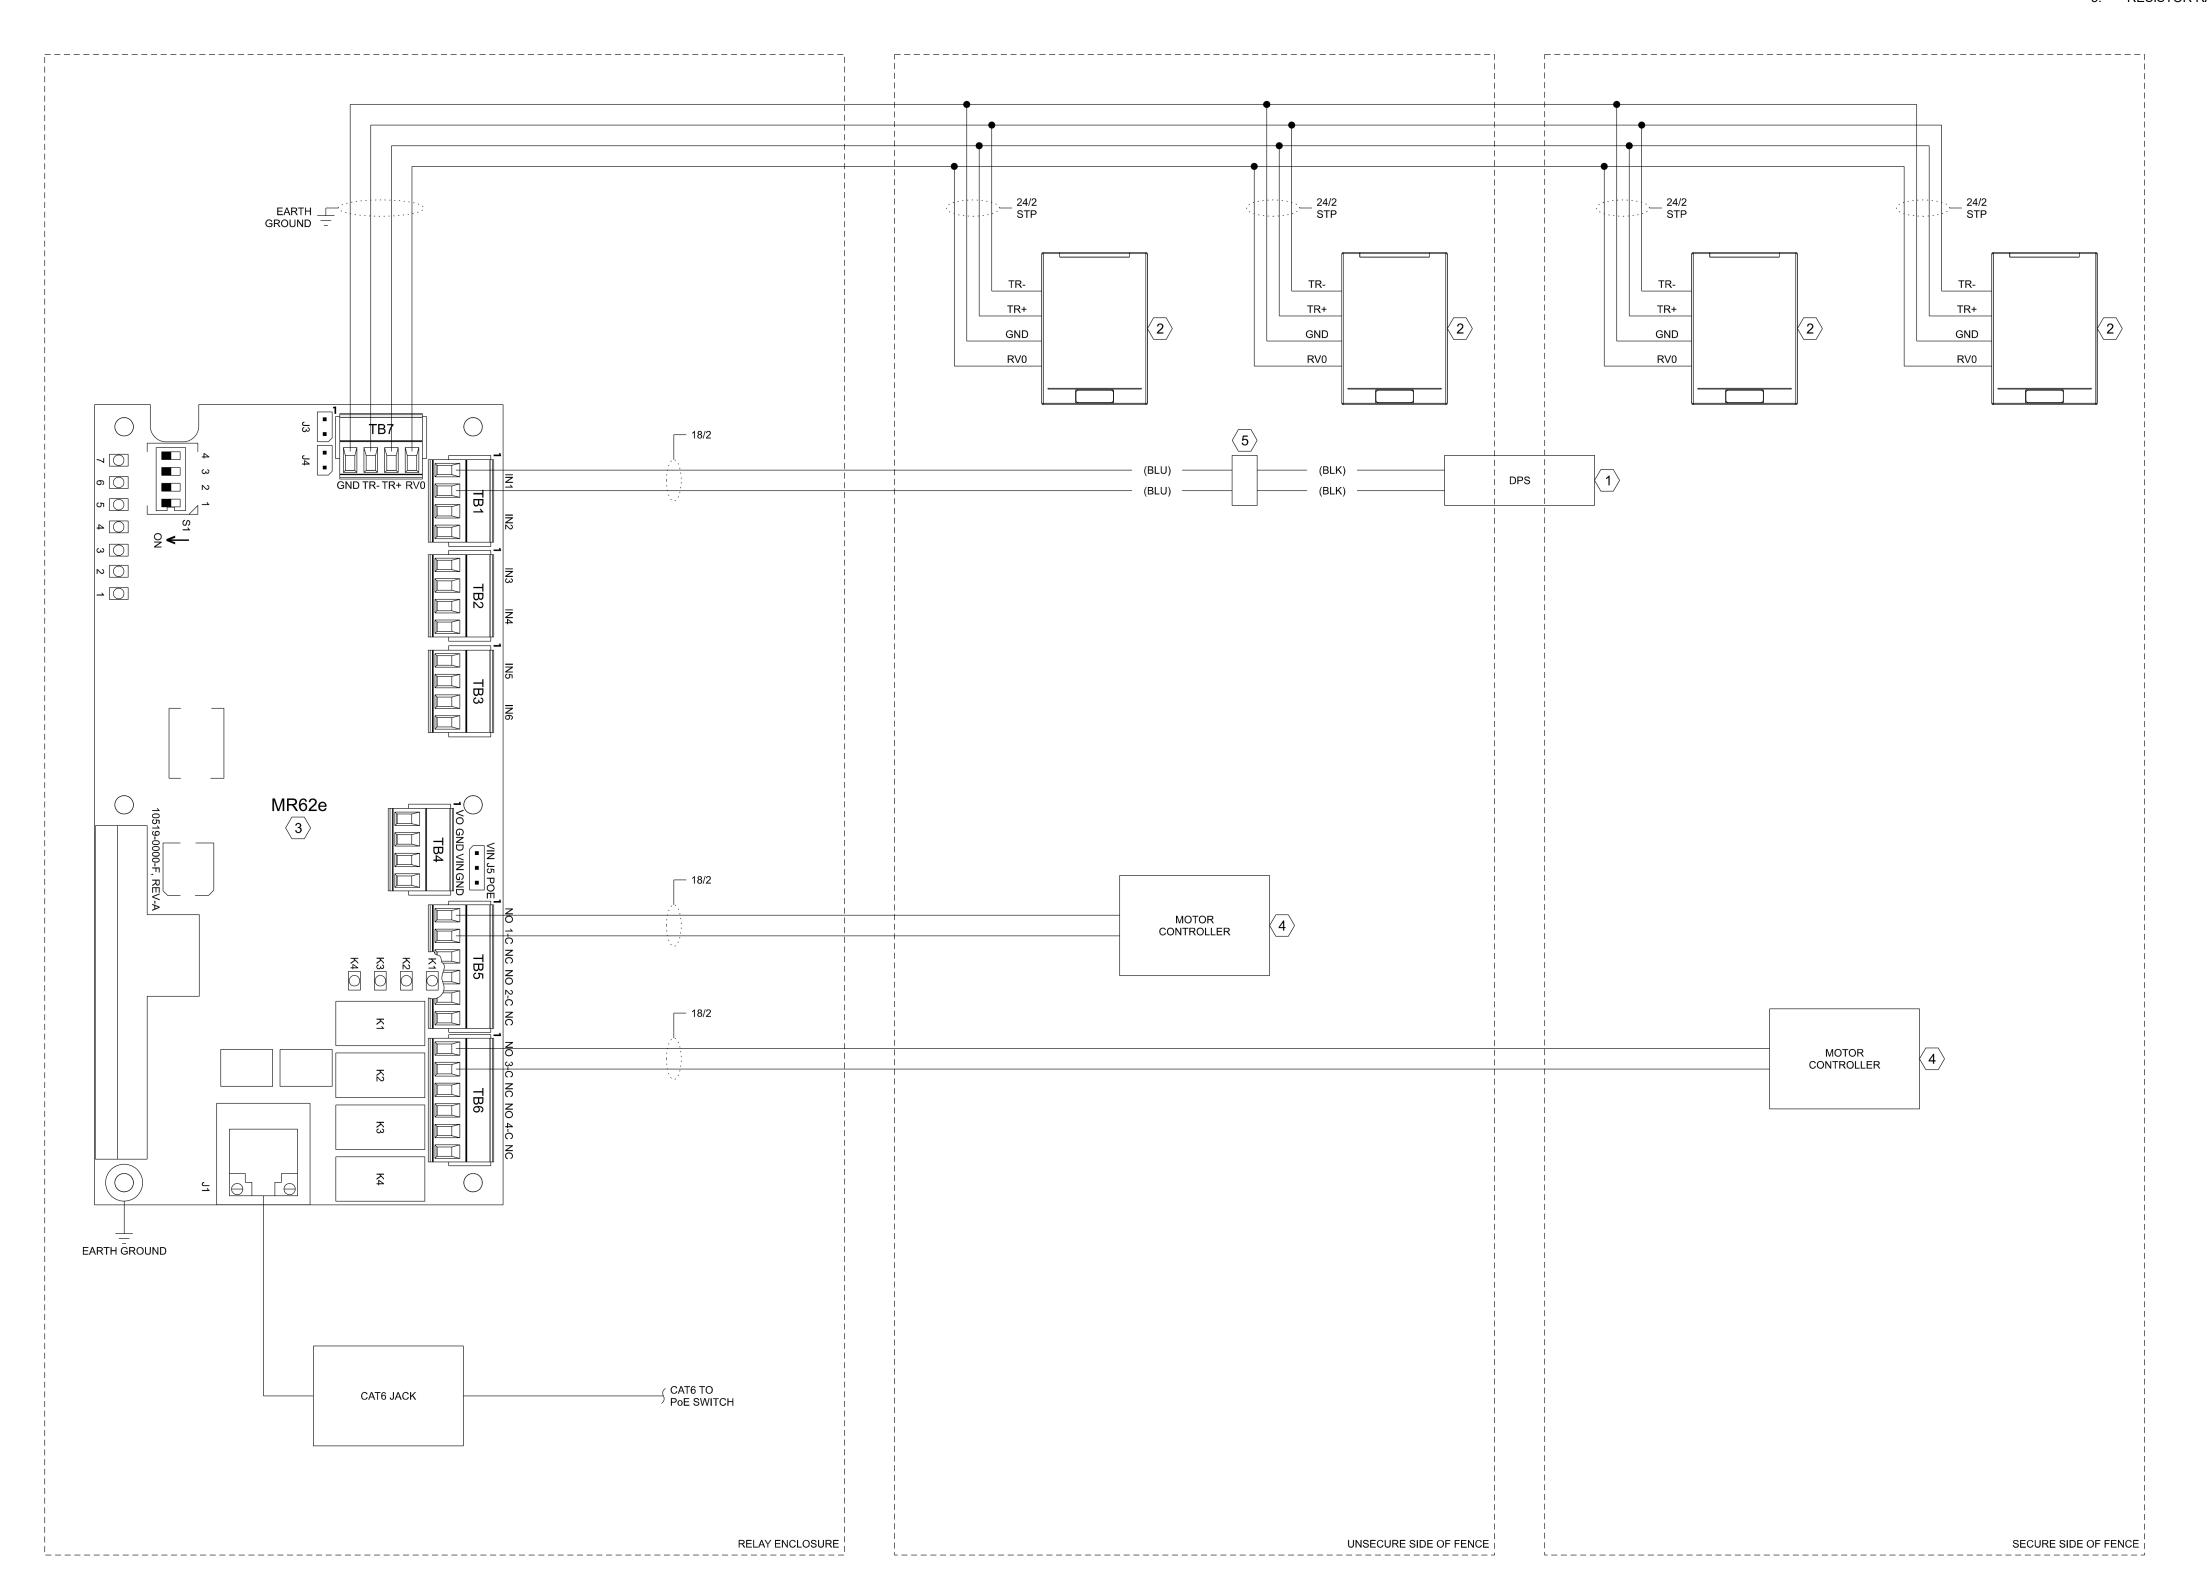

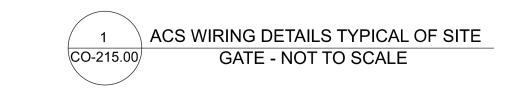

ISSUED FOR PERMIT

370 7th Avenue **SUITE 1604** New York, NY 10001



25 Mohawk Avenue **Sparta, NJ 07871** 

THESE DRAWINGS ARE CONFIDENTIAL IN NATURE. ANY MISUSE OR UNAUTHORIZED DISTRIBUTION OF THE DRAWINGS CONTAINED HEREIN WILL BE A VIOLATION OF THIS CONFIDENTIALITY REQUIREMENT AND SUBJECT THE VIOLATOR TO LIABILITY. REVIEW OF THESE MATERIALS BY RECEIPT SHALL CONSTITUTE ACCEPTANCE OF THESE TERMS AND THE TERMS OF ANY UNDERLYING CONFIDENTIALITY AGREEMENT WE MAY HAVE EXCLUDED IN OBTAINING THIS INFORMATION FROM A THIRD PARTY. IF THE RECIPIENT IS NOT IN AGREEMENT WITH THE OBLIGATION OF CONFIDENTIALITY THEN THE DRAWINGS SHALL BE RETURNED TO THE ORIGINATOR.

В	FINAL SUBMISSION	JDH	RAB	12/08/2022
Α	INTERIM SUBMISSION	JDH	CC	09/13/2022
REV	DESCRIPTION	DRW BY	CHK BY	DATE



**@**Hitachi Energy

901 Main Campus Drive Raleigh, North Carolina 27606




### **Astoria HVDC Converter Station**

31-45 20<sup>th</sup> Avenue, Astoria, Queens NY 11105 Block #850 - Lot #310 - BIN #4624437

**COMMUNICATIONS SYSTEMS ACS WIRING DETAILS GATE ENTRANCE AND EXIT** 

DATE	08/29/2022
PROJECT NO	105121
DRAWING BY	Author
CHECKED BY	Designer
DRAWING NO	

CO-215.00

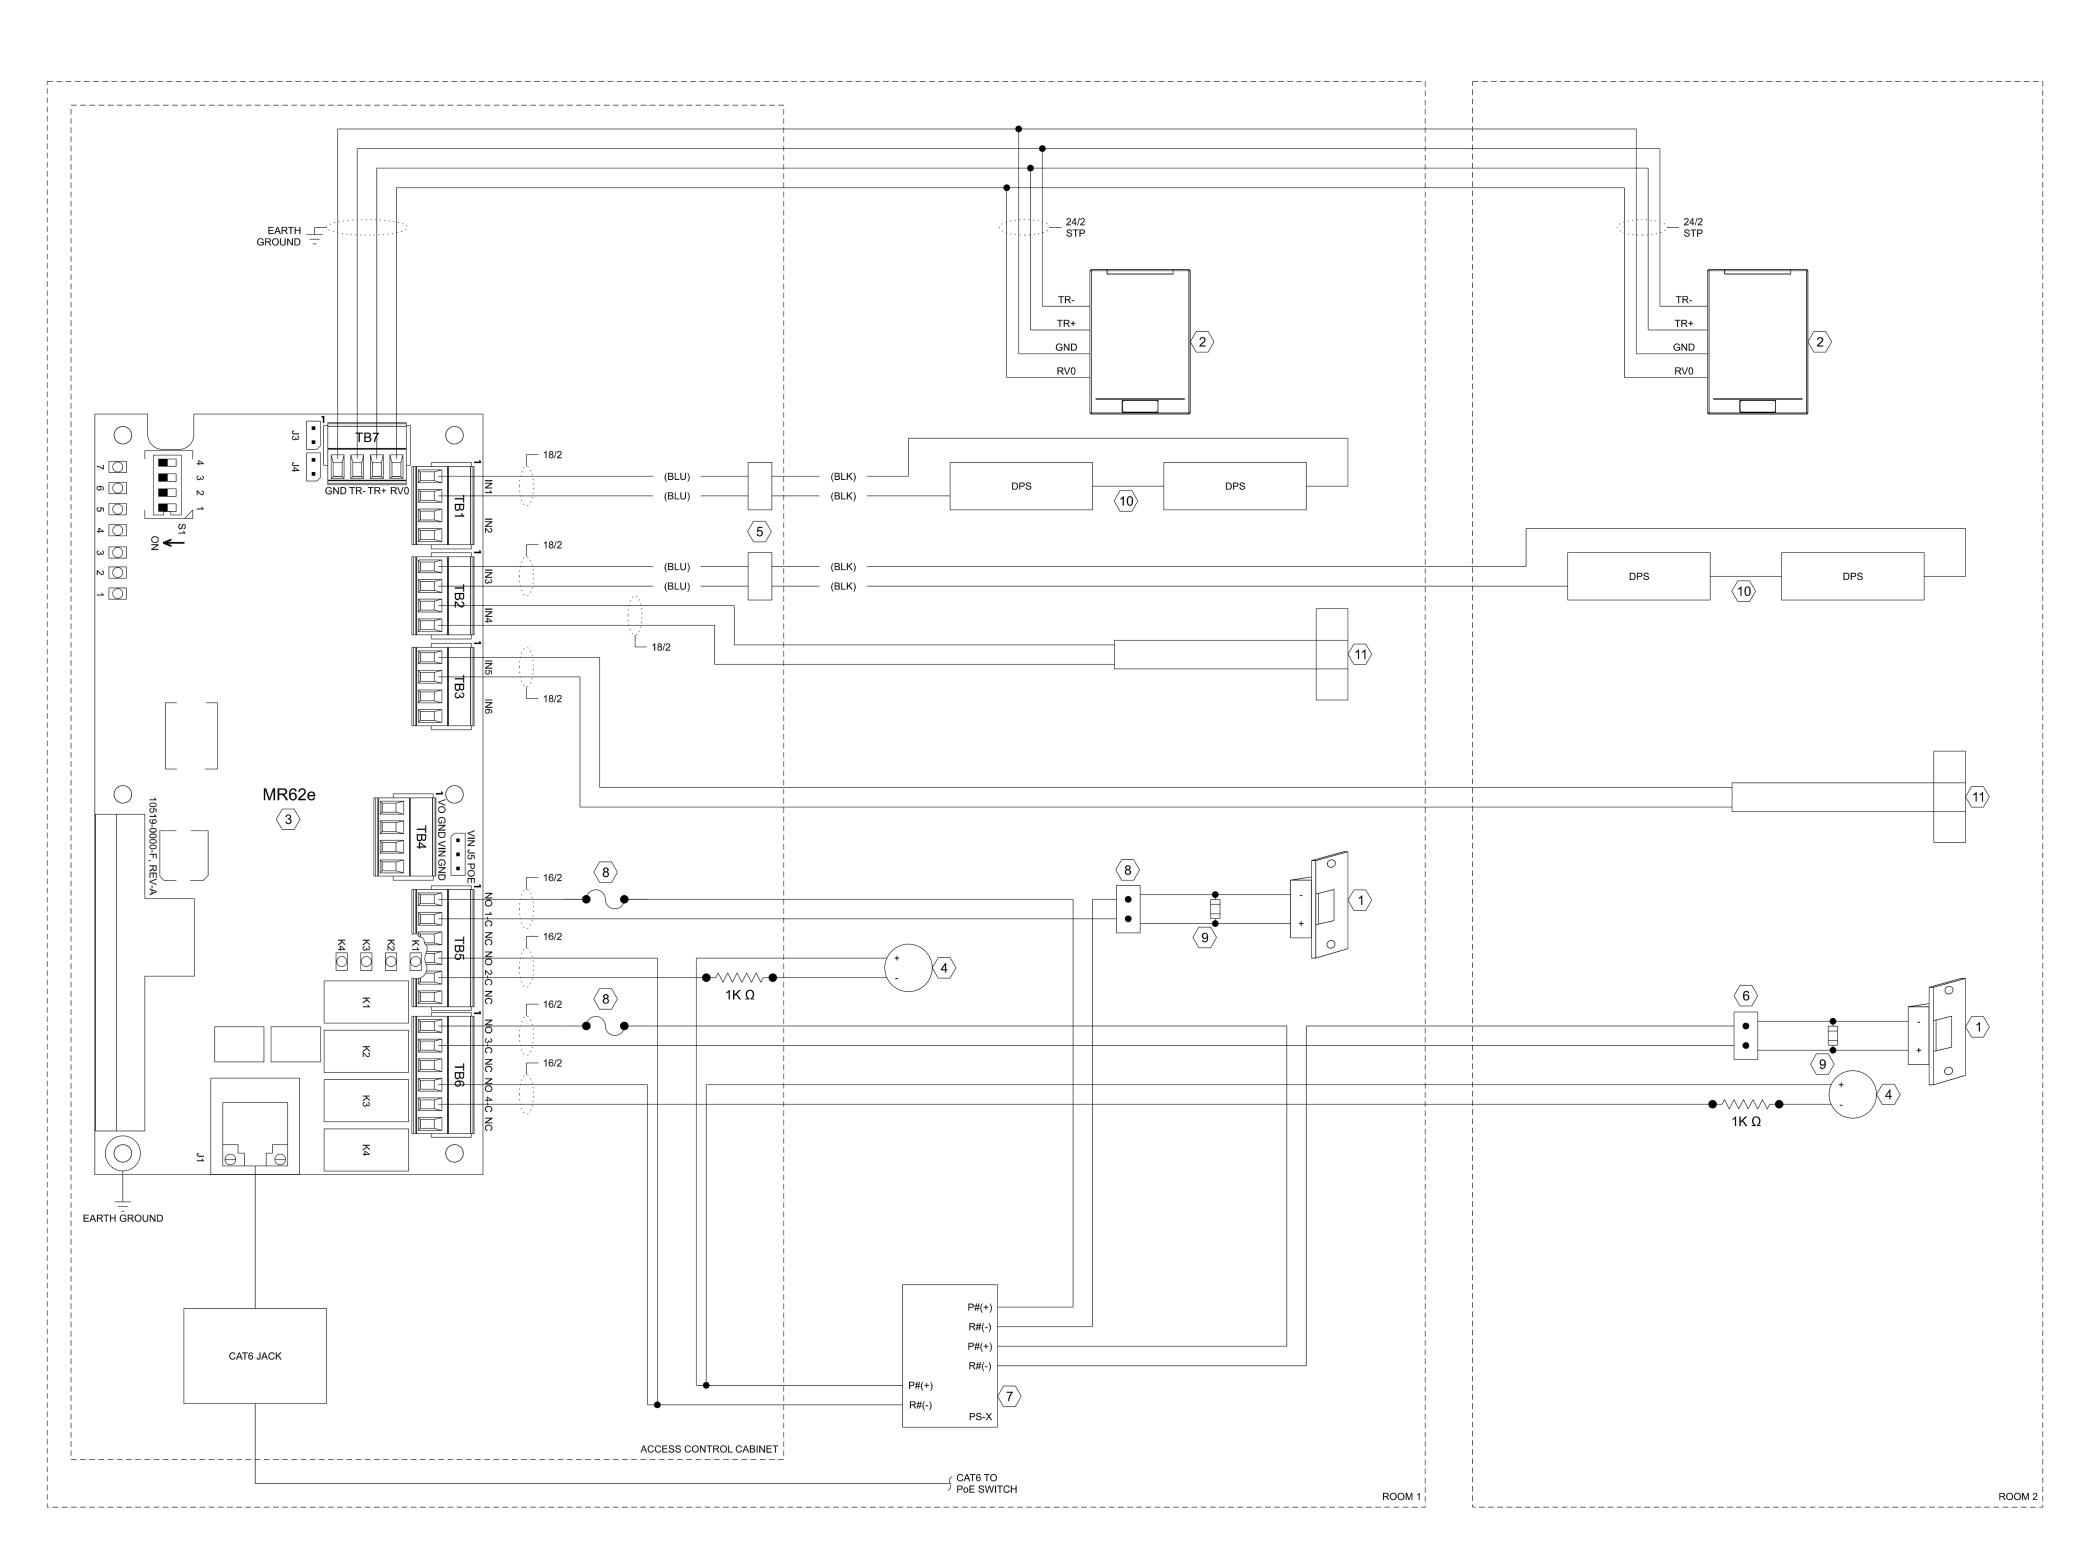

TWO DOUBLE DOOR WIRING WITH READERS

NOT TO SCALE

CO-216.00

### **GENERAL NOTES:**

- 1. THE POWER SUPPLY SHOWN IS A 8 TERMINAL DEVICE, BUT ONLY THOSE RELEVANT TO THIS WIRING DIAGRAM ARE DISPLAYED HERE. THE DEPICTION IS USED TO BETTER SHOW WHICH COMPONENTS SHARE
- ROOMS 1 & 2 DENOTE GENERIC LOCATIONS FOR THE READER AND CONTROLLER BOARD. REFER TO CO-213.00 FOR EXACT LOCATIONS OF
- REFER TO BILL OF MATERIALS ON SHEET CO-223.00 FOR ADDITIONAL

### **KEY NOTES:**

- ELECTRIC DOOR STRIKE.
- 2. OSDP CARD READER.
- 3. TWO DOOR ACCESS CONTROL MODULE.
- 4. LOW POWER BUZZER.
- RESISTOR PACK.
- 6. POWER TRANSFER HINGE.
- POWER SUPPLY.
- 2A FUSE.
- 9. DIODE.
- 10. DOOR POSITIONS SWITCH.
- 11. MECHANICAL CRASH BAR WITH MICROCHIP. ONLY TO BE USED WITH CRASH BAR INSTALLED DOORS.

ISSUED FOR PERMIT



370 7th Avenue **SUITE 1604** New York, NY 10001



25 Mohawk Avenue **Sparta, NJ 07871** 

THESE DRAWINGS ARE CONFIDENTIAL IN NATURE. ANY MISUSE OR UNAUTHORIZED DISTRIBUTION OF THE DRAWINGS CONTAINED HEREIN WILL BE A VIOLATION OF THIS CONFIDENTIAL IN NATIONAL ANT MISUSE OR UNAUTHORIZED DISTRIBUTION OF THE DRAWNINGS CONTAINED HEREIN WILL BE A VIOLATION OF THIS CONFIDENTIALITY REQUIREMENT AND SUBJECT THE VIOLATOR TO LIABILITY. REVIEW OF THESE MATERIALS BY RECEIPT SHALL CONSTITUTE ACCEPTANCE OF THESE TERMS AND THE TERMS OF ANY UNDERLYING CONFIDENTIALITY AGREEMENT WE MAY HAVE EXCLUDED IN OBTAINING THIS INFORMATION FROM A THIRD PARTY. IF THE RECIPIENT IS NOT IN AGREEMENT WITH THE OBLIGATION OF CONFIDENTIALITY THEN THE DRAWINGS SHALL BE RETURNED TO THE ORIGINATOR.

3	FINAL SUBMISSION	JDH	RAB	12/08/2022
4	INTERIM SUBMISSION	JDH	CC	09/13/2022
EV	DESCRIPTION	DRW BY	CHK BY	DATE



**@**Hitachi Energy 901 Main Campus Drive Raleigh, North Carolina 27606



### **Astoria HVDC Converter Station**

31-45 20<sup>th</sup> Avenue, Astoria, Queens NY 11105 Block #850 - Lot #310 - BIN #4624437

COMMUNICATIONS **SYSTEMS TWO DOUBLE** WIRING WITH READERS

- THE REX MOTION SENSOR IS ONLY USED IF A CRASH BAR IS NOT INSTALLED ON A GIVEN DOOR. REFER TO THE ARCHITECTURAL DRAWINGS SET FOR THE DOOR HARDWARE SCHEDULE.
- 2. THE POWER SUPPLY SHOWN IS AN 8 TERMINAL DEVICE, BUT ONLY THOSE
  RELEVANT TO THIS WIRING DIAGRAM ARE DISPLAYED HERE. THE DEPICTION IS USED TO BETTER SHOW WHICH COMPONENTS SHARE TERMINALS
- 3. ROOMS 1 & 2 DENOTE GENERIC LOCATIONS FOR THE READER AND CONTROLLER BOARD. REFER TO CO-213.00 FOR EXACT LOCATIONS OF
- 4. REFER TO BILL OF MATERIALS ON SHEET CO-223.00 FOR ADDITIONAL DETAILS.

### KEY NOTES:

- ELECTRIC DOOR STRIKE.
- 2. OSDP CARD READER.
- 3. TWO DOOR ACCESS CONTROL MODULE.
- 4. LOW POWER BUZZER.
- 5. RESISTOR PACK.
- 6. POWER TRANSFER HINGE.
- 7. POWER SUPPLY.
- 8. 2A FUSE.
- 9. DIODE.
- 10. DOOR POSITIONS SWITCH.
- 11. MECHANICAL CRASH BAR WITH MICROCHIP. ONLY TO BE USED WITH CRASH BAR INSTALLED DOORS.

ISSUED FOR PERMIT



370 7th Avenue SUITE 1604 New York, NY 10001

25 Mohawk Avenue



Sparta, NJ 07871

#### CONFIDENTI

THESE DRAWINGS ARE CONFIDENTIAL IN NATURE. ANY MISUSE OR UNAUTHORIZED DISTRIBUTION OF THE DRAWINGS CONTAINED HEREIN WILL BE A VIOLATION OF THIS CONFIDENTIALITY REQUIREMENT AND SUBJECT THE VIOLATOR TO LIABILITY. REVIEW OF THESE MATERIALS BY RECEIPT SHALL CONSTITUTE ACCEPTANCE OF THESE TERMS AND THE TERMS OF ANY UNDERLYING CONFIDENTIALITY AGREEMENT WE MAY HAVE EXCLUDED IN OBTAINING THIS INFORMATION FROM A THIRD PARTY. IF THE RECIPIENT IS NOT IN AGREEMENT WITH THE OBLIGATION OF CONFIDENTIALITY THEN THE DRAWINGS SHALL BE RETURNED TO THE ORIGINATOR.

FINAL SUBMISSION	JDH	RAB	12/08/2022
INTERIM SUBMISSION	JDH	CC	09/13/2022
DESCRIPTION	DRW BY	CHK BY	DATE
ŀ	INTERIM SUBMISSION	INTERIM SUBMISSION JDH	INTERIM SUBMISSION JDH CC



Hitachi Energy

901 Main Campus Drive Raleigh, North Carolina 27606

PROJECT



### Astoria HVDC Converter Station


31-45 20<sup>th</sup> Avenue, Astoria, Queens NY 11105 Block #850 - Lot #310 - BIN #4624437

COMMUNICATIONS
SYSTEMS ONE SINGLE,
ONE DOUBLE DOOR
WIRING WITH READERS

1	
DATE	08/29/2022
PROJECT NO	105121
DRAWING BY	Author
CHECKED BY	Designer
DRAWING NO	
	<b>A 1 B A A</b>

CO-217.00

CADD FILE NO Autodesk Docs://CHPE

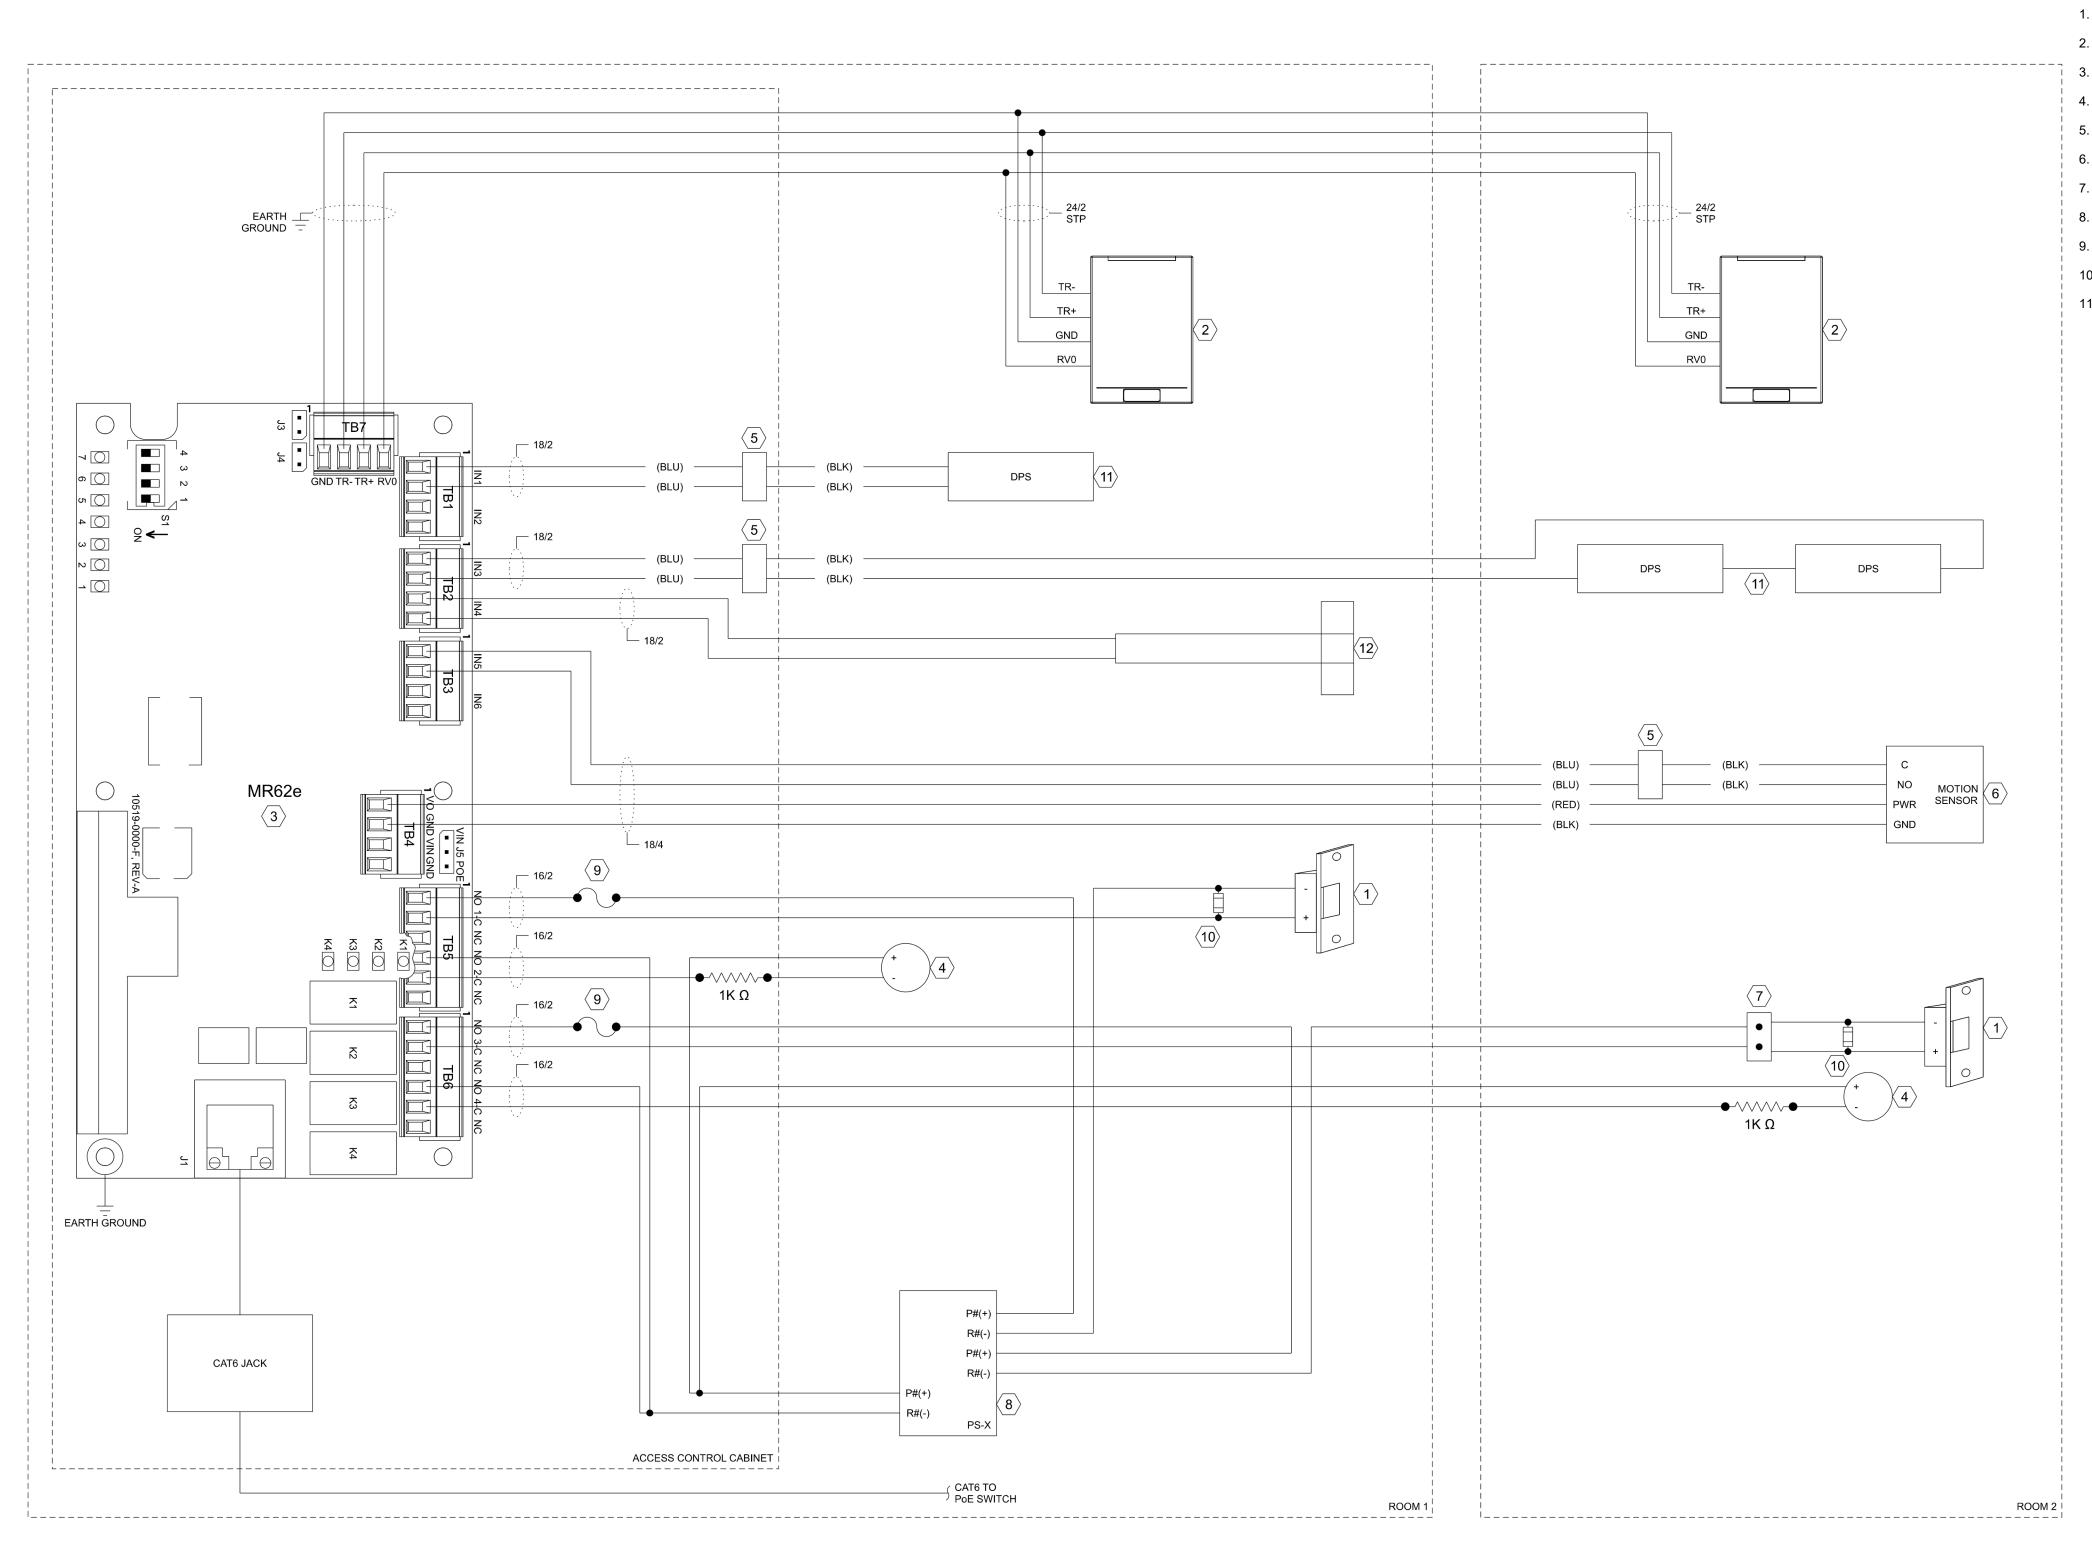


ONE SINGLE, ONE DOUBLE DOOR WIRLING WITH READERS

NOT TO SCALE

- SEE DRAWING CO-210.00 FOR MOUNTING DETAILS FOR THE INTELLIGENT CONTROLLER MODULE EP2500.
- THE POWER SUPPPLY SHOWN IS AN 8 TERMINAL DEVICE, BUT ONLY THOSE RELEVANT TO THIS WIRING DIAGRAM ARE DISPLAYED HERE.
- 3. REFER TO BILL OF MATERIALS ON SHEET CO-233.00 FOR ADDITIONAL



- POWER SUPPLY.
- 2. INTELLIGENT CONTROLLER MODULE.
- 3. PCB JUMPER REQUIRED AT J5 TO TERMINATE RS-485 SERIAL BUS.
- 4. WIRE JUMPER USED IN LIEU OF TAMPER SWITCH.
- 5. WIRE JUMPER USED IN LIEU OF POWER SUPERVISION.

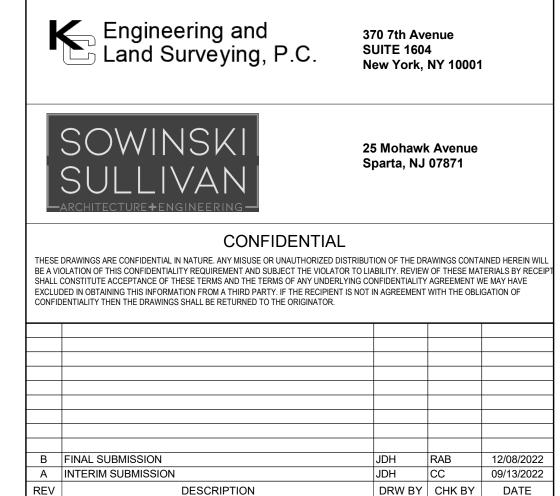

ISSUED FOR PERMIT



Hitachi Energy

901 Main Campus Drive Raleigh, North Carolina 27606

PROJEC



Astoria HVDC Converter Station

31-45 20<sup>th</sup> Avenue, Astoria, Queens NY 11105 Block #850 - Lot #310 - BIN #4624437

Block #850 - Lot #310 - BIN #4624437

COMMUNICATIONS
SYSTEMS INTELLIGENT
CONTROLLER WIRING
DIAGRAM

DATE	08/29/2022
PROJECT NO	105121
DRAWING BY	Author
CHECKED BY	Designer
DRAWING NO	
	0 10 00

CO-218.00

Autodesk Docs://CHPE Astoria/CHA-KIE-200-00-M2-CO-001.rvt

