APPENDIX C.22 CASE 10-T-0139 SITE PLANS AND CONSTRUCTION DRAWINGS PLUMBING DRAWINGS - SITE ASTORIA HVDC CONVERTER STATION SEGMENT 22



ASTORIA HVDC CONVERTER STATION

SITE PLUMBING PACKAGE

SCOPE OF WORK

THE PLUMBING SCOPE OF WORK INCLUDES FURNISHING AND INSTALLATION OF PLUMBING FIXTURES AND EQUIPMENT, POTABLE HOT AND COLD-WATER PIPING SYSTEMS, AND SANITARY WASTE AND VENT PIPING SYSTEMS FOR THE FOLLOWING AREAS AS SUBJECT TO THE REQUIREMENTS AND PERFORMANCE CRITERIA PROVIDED IN THE PRELIMINARY PERFORMANCE SPECIFICATION:

1. SITE PLUMBING

FLOOD ZONE DESIGN CERTIFICATION:

THE EXISTING PROPERTY IS IN THE SPECIAL FLOOD HAZARD AREA (SFHA), ZONE AE PER EFFECTIVE 2015 FLOOD INSURANCE RATE MAP(FIRM). THIS IS TO CONFIRM THAT THE PROPOSED INSTALLATION IS IN COMPLIANCE WITH THE REQUIREMENTS SET FORTH IN APPENDIX Q OF THE NYC BUILDING CODE.

NYC ENERGY CODE COMPLIANCE:


STATEMENT: TO THE BEST OF MY KNOWLEDGE, BELIEF AND PROFESSIONAL JUDGEMENT, THESE PLANS AND SPECIFICATIONS ARE IN COMPLIANCE WITH THE NEW YORK CITY ENERGY CONSERVATION CODE. PROPOSED WORK MEETS THE GUIDELINES AND INSTRUCTIONS OUTLINED IN THE 2020 NYC ECC CHAPTER 4.

SPECIAL INSPECTION AND PROGRESS INSPECTIONS:

FOLLOWING SPECIAL AND PROGRESS INSPECTIONS SHALL BE PERFORMED PER NYC BUILDING CODE 2022. NOTIFY ARCHITECT, ENGINEER AND OWNER FOR SPECIAL INSPECTIONS AT LEAST 72 HOURS BEFORE THE SPECIAL INSPECTION WORK STARTS.

SPECIAL INSPECTIONS			
INSPECTION AND TEST	CODE / SECTION		
HEATING SYSTEMS	BC 1704.25		
EMERGENCY & STAND BY POWER SYSTEMS (GENERATORS)	BC 1704.31		


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PROGRESS INSPECTION	DNS
INSPECTION AND TEST	CODE / SECTION
ENERGY CODE COMPLIANCE INSPECTIONS	BC 110.3.5
FINAL	28-116.2.4.2 BC 110.5
HVAC-R AND SERVICE WATER HEATING DESIGN AND INSULATION	IB5, IIB5
ELECTRICAL MOTORS AND ELEVATORS	IIC6
MAINTENANCE INFORMATION	ID1, IID1
	•

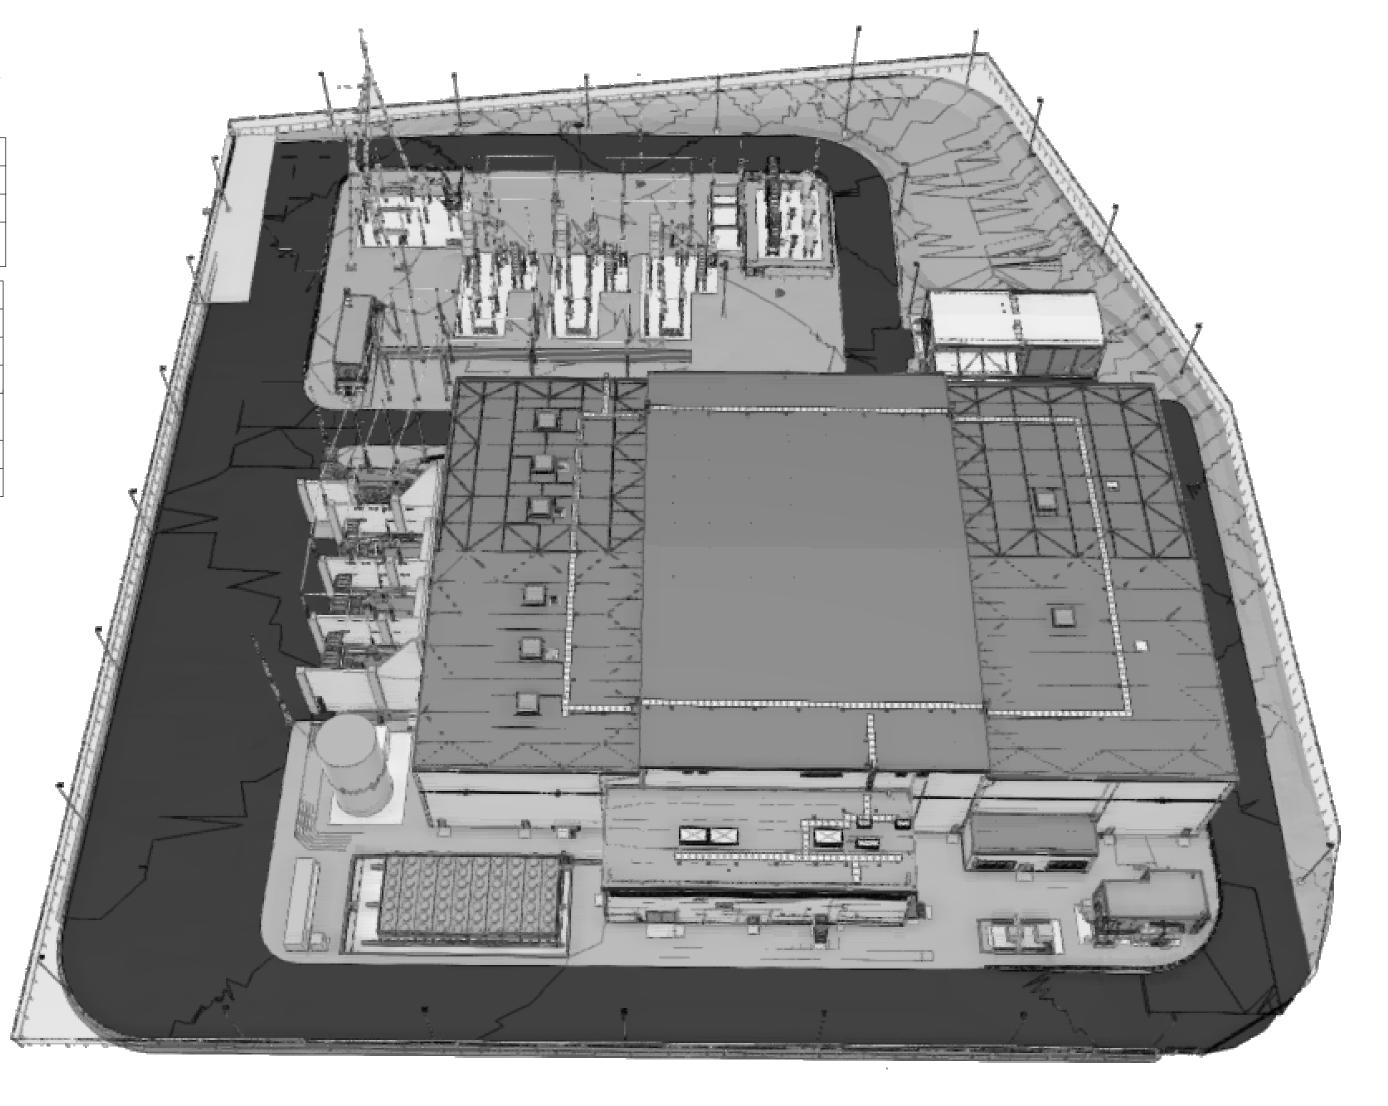

ISSUED FOR PERMIT



370 7th Avenue SUITE 1604 New York, NY 10001

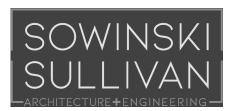

25 Mohawk Avenue Sparta, NJ 07871

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В	FINAL SUBMISSION	VSP	EK	12/12/2022
Α	INTERIM SUBMISSION	VSP	EK	09/13/2022
REV	DESCRIPTION	DRW BY	CHK BY	DATE



Hitachi Energy
 901 Main Campus Drive

Raleigh, North Carolina 27606

PROJECT



Astoria HVDC Converter Station

31-45 20th Avenue, Astoria, Queens NY 11105 Block #850 - Lot #310 - BIN #4624437

COVER SHEET




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DATE	12/12/2022
PROJECT NO	105121
DRAWING BY	V. PATEL
CHECKED BY	E. KIDANE
DRAWING NO	

P-001.00

FL FLOOD

- FL-1. THE SITE IS DEFINED AS A ZONE (NON-COASTAL).
- FL-2. BASE FLOOD ELEVATION, BFE, = 13 FEET NAVD 88.
- FL-3. RECOMMENDED FREE BOARD BY THE 2022 NYCBC-APPENDIX G IS 2.0 FEET.
- FL-4. RECOMMENDED DESIGN FLOOD ELEVATION, DFE = 15 FEET NAVD 88.
- FL-5. THE STRUCTURE IS NOT SUBJECTED TO HYDRODYNAMIC LOADS.

DESIGN ELEVATION / DEPTH	FEET IN NAVD 88
DESIGN BASE FLOOD ELEVATION	13.0
FINISH FLOOR ELEVATION	15.0
SEA LEVEL RISE	NOT CONSIDERED

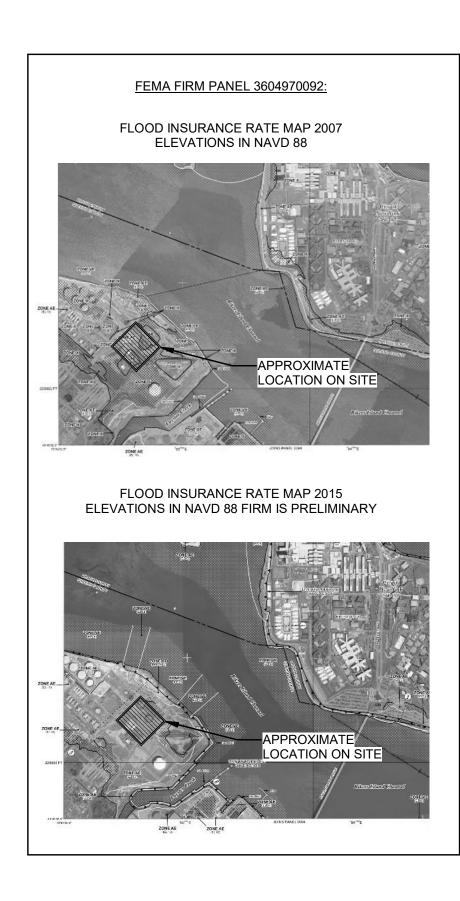


DRAWING LIST PLUMBING

HEET	
MBER	SHEET NAME

03-PLUMBING	
P-001.00	COVER SHEET
P-002-00	SHEET INDEX
P-003.00	OVERALL PLUMBING SITE PLAN
P-004.00	PLUMBING - GENERAL NOTES, LEGENDS, SYMBOLS & ABBREVIATIONS
P-005.00	LEGEND - P&ID PIPING AND COMPONENTS
P-200.00	SUMP PUMP PLUMBING PLAN
P-201.00	FIRE PROTECTION WATER & TANK ENLARGED PLAN
P-202.00	FIRE WATER TANK P&ID
P-203.00	TRANSFORMER SUMP 01
P-204.00	TRANSFORMER SUMP 02
P-205.00	TRANSFORMER SUMP 03
P-206.00	DRYCOOLER SUMP
P-207.00	SPARE TRANSFORMER SUMP
P-208.00	AUXILIARY TRANSFORMER SUMP 01
P-209.00	AUXILIARY TRANSFORMER SUMP 02
P-600.00	PLUMBING DETAILS SHEET #1
P-601.00	PLUMBING DETAILS SHEET #2
P-602.00	PLUMBING DETAILS SHEET #3
P-701.00	SERVICE BUILDING PLUMBING - SCHEDULES

ISSUED FOR PERMIT

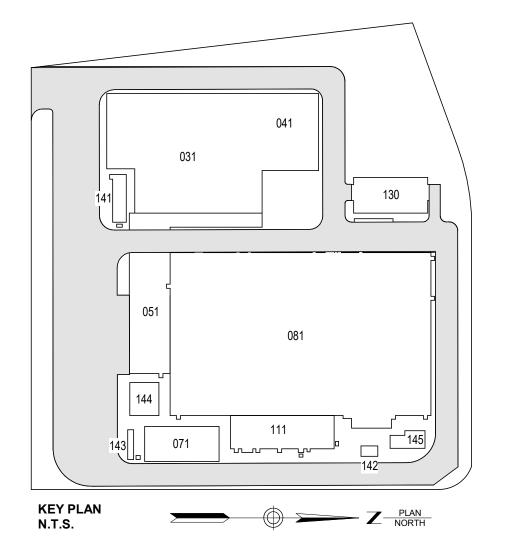



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25 Mohawk Avenue **Sparta, NJ 07871**

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Astoria HVDC Converter Station


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PROJECT NO W.PENDLETON CHECKED BY

P-002-00



PLUMBING GENERAL NOTES

- 1. THESE DRAWINGS ARE DIAGRAMMATIC AND INDICATE GENERAL ARRANGEMENT OF ALL MATERIALS, PIPING AND EQUIPMENT. DO NOT SCALE DRAWINGS. THE EXACT LOCATION AND/OR ROUTING OF EQUIPMENT, PLUMBING, SANITARY PIPING, ETC., SHALL BE FOLLOWED AS CLOSELY AS BUILDING CONSTRUCTION AND ALL OTHER WORK WILL PERMIT.
- 2. MATERIALS AND EQUIPMENT SHALL BE NEW AND INSTALLED AS INDICATED ON THE DRAWINGS AND/OR SPECIFICATIONS. THEY SHALL BE INSTALLED PLUMB, LEVEL AND TRUE-TO-LINE WITH ADJACENT WORK. WHERE INSTALLATION METHODS ARE NOT SPECIFICALLY COVERED BY THE DRAWINGS AND/OR SPECIFICATIONS, FIRST CLASS TRADE PRACTICES AND MANUFACTURER'S INSTRUCTIONS AND RECOMMENDATIONS SHALL GOVERN.
- 3. ALL WORK SHALL COMPLY WITH THE REQUIREMENTS OF ALL AUTHORITIES HAVING JURISDICTION, BUILDING DEPARTMENTS, APPLICABLE TO THE LATEST EDITION OF THE APPLICABLE BUILDING CODE, PROVINCIAL FIRE CODE, APPLICABLE OSHA AND NFPA STANDARDS, COUNTY AND CITY BUILDING REGULATIONS AND CODES.
- 4. CAREFULLY EXAMINE ALL ARCHITECTURAL, STRUCTURAL, PLUMBING, HVAC, FIRE PROTECTION, AND ELECTRICAL DRAWINGS PERTAINING TO CONSTRUCTION. COOPERATE WITH OTHER TRADES IN LOCATING DUCTWORK, PIPING, EQUIPMENT, ETC., IN ORDER TO AVOID CONFLICT WITH OTHER TRADE'S WORK. NO CLAIM FOR COSTS WILL BE ALLOWED FOR RELOCATING EQUIPMENT, PIPING, DUCTWORK, ETC., WHICH INTERFERES WITH OTHER TRADES WORK.
- 5. VERIFY ALL ROUGH-IN LOCATION AND COORDINATE PIPING AND EQUIPMENT LOCATIONS WITH WORK UNDER OTHER DIVISIONS OF THE SPECIFICATIONS TO AVOID CONFLICTS. CONTRACTOR MUST COORDINATE WITH OTHER TRADES FOR ALL STRUCTURES, PIPING, CONDUIT, DUCTWORK, LIGHTING, ETC. TO PROPERLY BE INSTALLED. ANY CONFLICTS SHALL BE RESOLVED AT NO EXPENSE TO THE OWNER.
- 6. LABEL ALL PLUMBING PIPING WITH ADHESIVE PIPE LABELS INDICATING SERVICE AND DIRECTION OF FLOW. PIPE LABELS SHALL BE LOCATED NEAR ALL BRANCH CONNECTIONS, NEAR ALL FLOOR AND WALL PENETRATIONS, AND AT MAXIMUM INTERVALS OF 10 FEET ALONG EACH RUN.
- 7. PLUMBING SYSTEMS INCLUDE, BUT ARE NOT LIMITED TO:
 - a. PLUMBING FIXTURES AND EQUIPMENTb. FIRE STOPPING
 - c. DOMESTIC WATER SYSTEM
- d. SANITARY WASTE AND VENT SYSTEM
- 8. PROVIDE COMPLETE FIXTURES AND INCLUDE SUPPLIES, STOPS, VALVES, FAUCETS, DRAINS, TRAPS, TAILPIECES, ESCUTCHEONS, ETC. EXPOSED COPPER OR BRASS MATERIALS SHALL BE CHROME PLATED.
- 9. SEAL ALL EDGES OF PLUMBING FIXTURES IN CONTACT WITH FLOORS, WALLS OR COUNTERTOPS USING SANITARY-TYPE, ONE-PART, MILDEW RESISTANT SILICONE SEALANT. USE CLEAR SEALANT OR MATCH SEALANT COLOR TO FIXTURE COLOR.
- 10. REFER TO ARCHITECTURAL DRAWINGS FOR MOUNTING HEIGHTS OF PLUMBING FIXTURES.
- 11. FIRE STOP ALL PENETRATIONS, BY PIPING OR CONDUITS, OF FIRE RATED WALLS, FLOORS, AND PARTITIONS. PROVIDE DEVICE(S) OR SYSTEM(S) WHICH HAS BEEN TESTED AND LISTED AS COMPLYING WITH ASTM E-814 OR UL 1479 AND INSTALL IN ACCORDANCE WITH THE CONDITIONS OF THEIR LISTING. PROVIDE DEVICE(S) OR SYSTEM(S) WITH AN 'F' RATING EQUAL TO THE RATING OF THE ASSEMBLY BEING PENETRATED.
- 12. FURNISH AND INSTALL A COMPLETE SYSTEM OF DOMESTIC HOT AND COLD WATER FROM EXISTING SUPPLIES TO ALL FIXTURES AND/OR EQUIPMENT REQUIRING DOMESTIC WATER SUPPLIES. VERIFY LOCATION OF BEGINNING POINTS.
- 13. DOMESTIC WATER PIPING: ASTM B 88 TYPE 'L' HARD COPPER TUBE WITH WROT COPPER FITTINGS, AND SOLDERED OR PRESSURE-SEALED JOINTS.
- 14. STERILIZE DOMESTIC WATER PIPING IN ACCORDANCE WITH THE NYC PLUMBING CODE AND LOCAL HEALTH DEPARTMENT REGULATIONS.

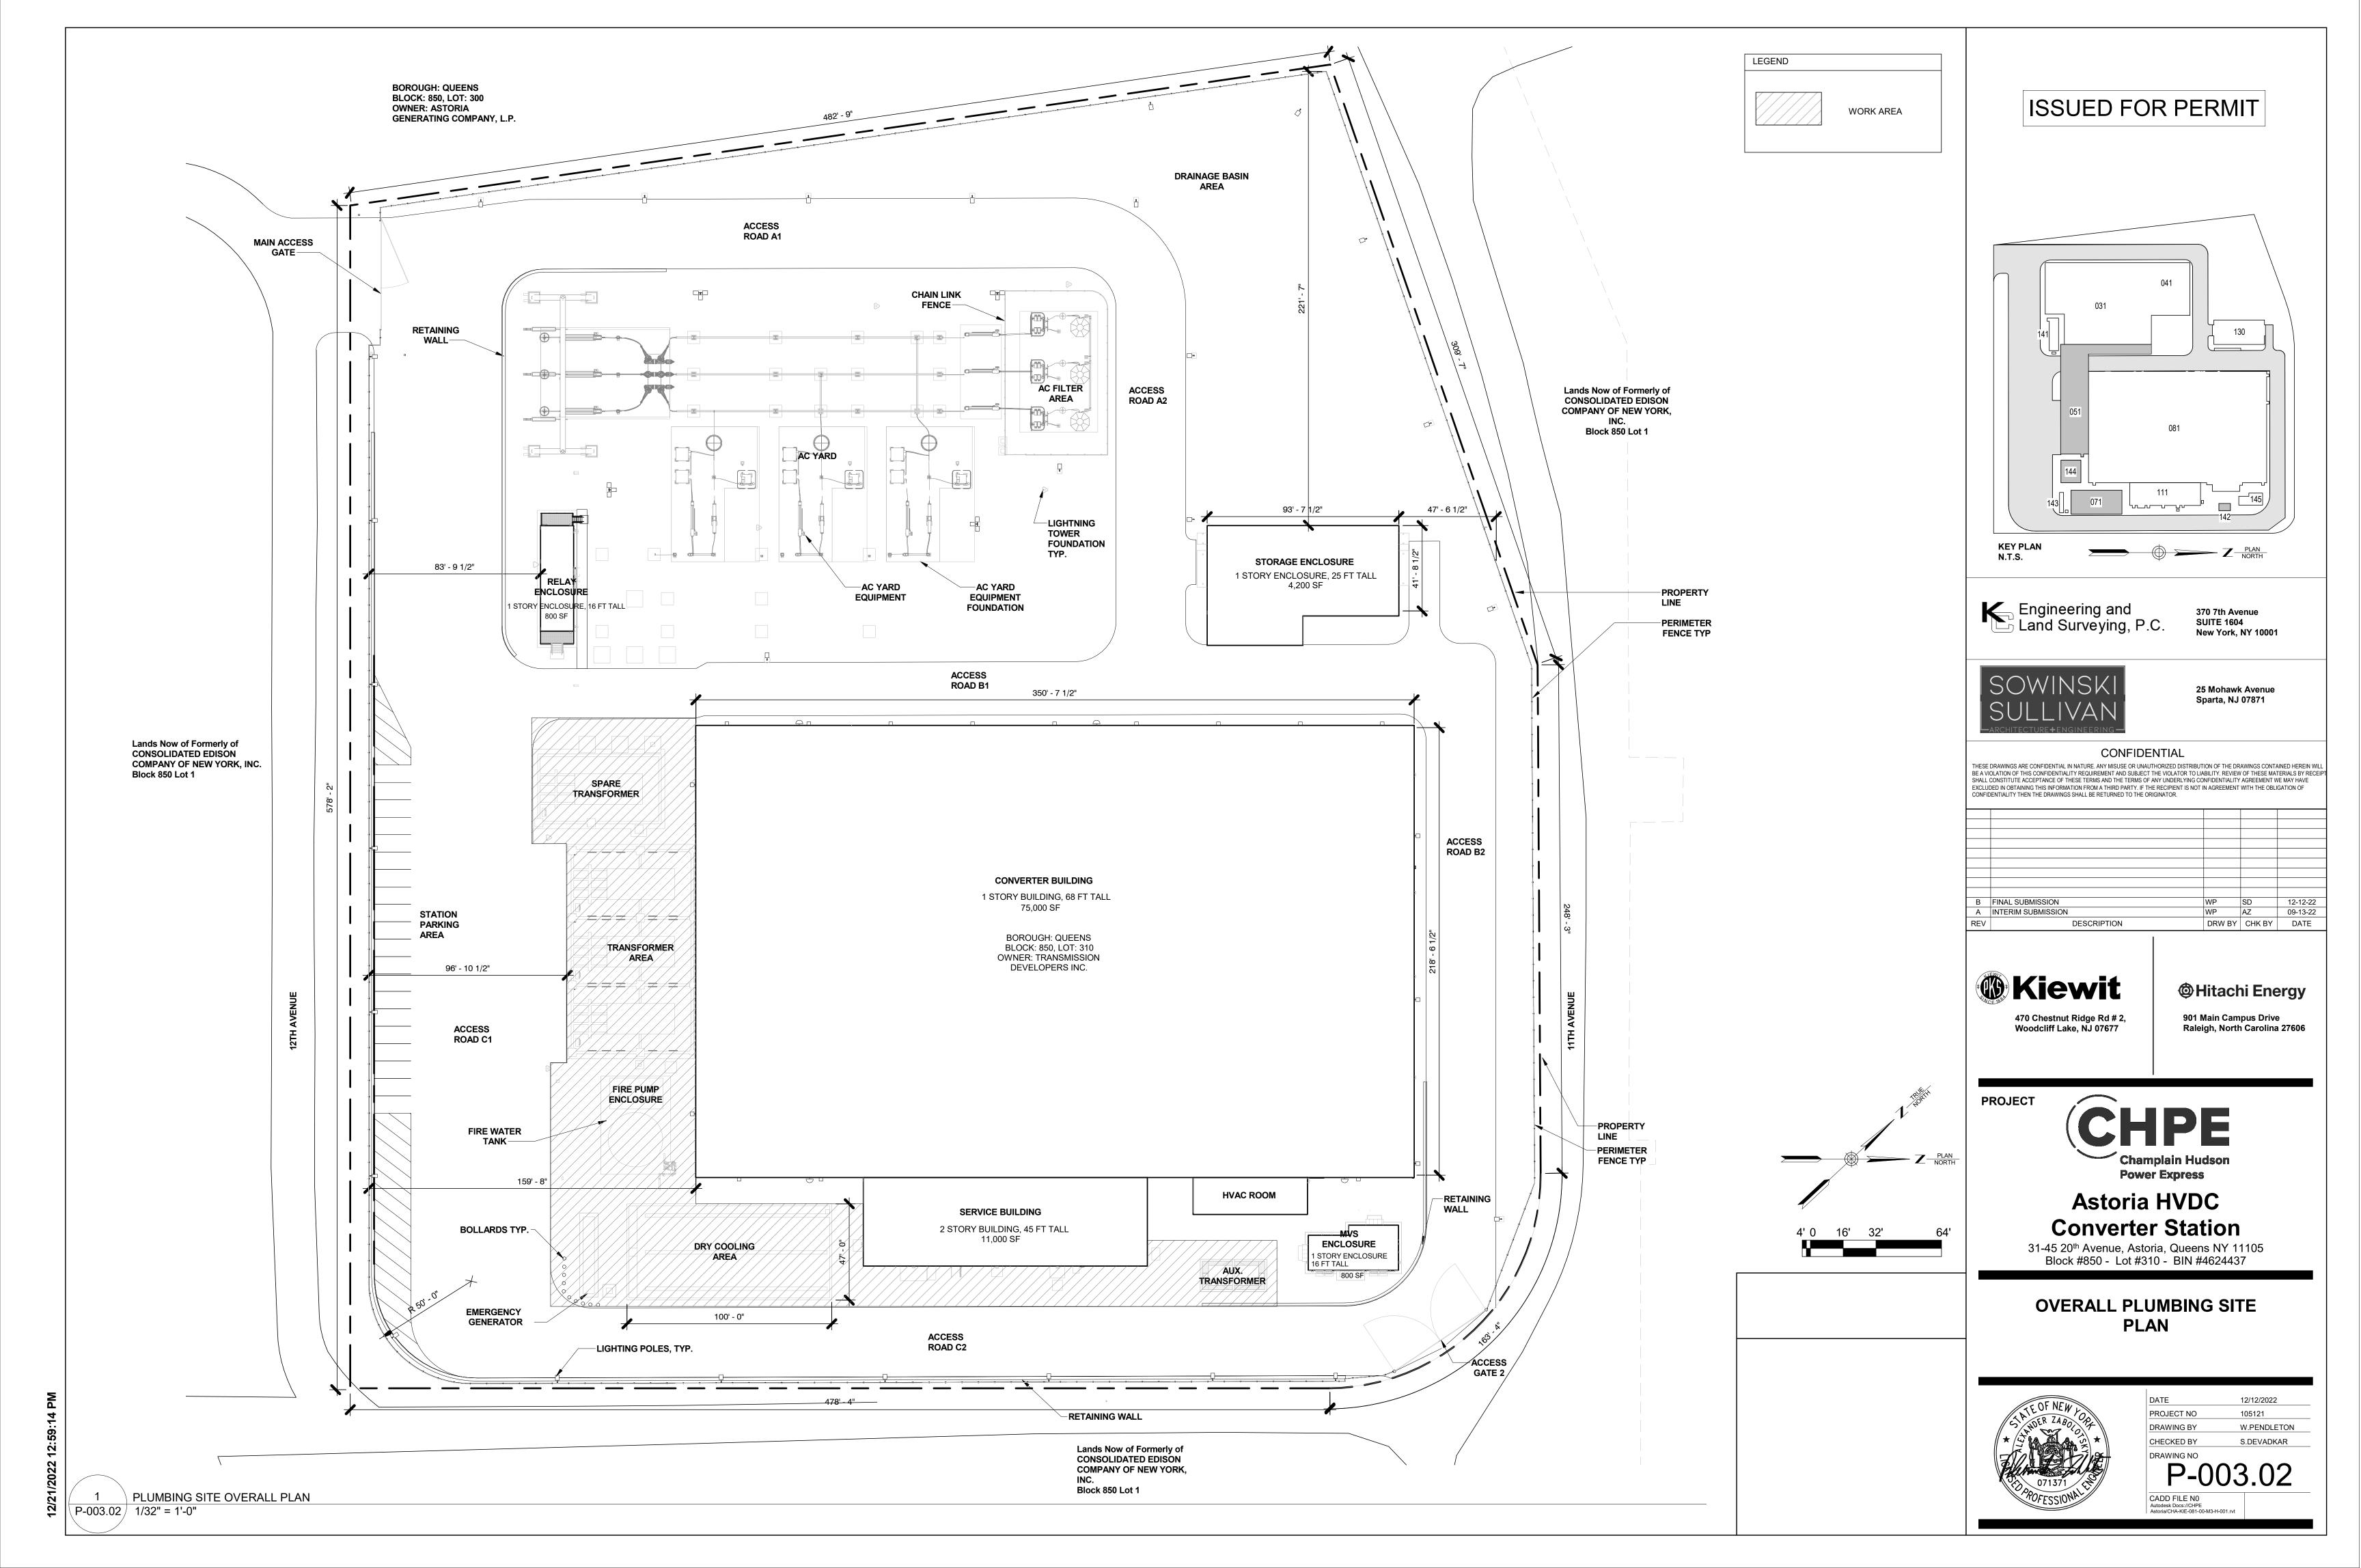PLANS AND NOTES.

ADJACENT SITES OR BUILDINGS.

15. INSULATE DOMESTIC WATER PIPING AS PER SPECIFICATION SECTION 220719 PLUMBING PIPING INSULATION.

GENERAL REQUIREMENTS:

APPROVALS AND PERMITS SHALL BE OBTAINED AND PAID FOR.

THESE DRAWINGS ARE DIAGRAMMATIC IN NATURE.

1. SYSTEMS SHALL COMPLY WITH 2022 NYC BUILDING CODE.

THE BUILDING SHALL REMAIN ACCESSIBLE TO THE OWNER AT ALL TIMES.

N.Y.C. BUILDING DEPARTMENT NOTES

ENERGY CONSERVATION CONSTRUCTION CODE OF NY CITY, AND WITH THE NYC BUILDING CODE.

THE DUCT SYSTEM AND ALL COMPONENTS THERETO SHALL COMPLY WITH NYC BUILDING CODE 2022.

EQUIPMENT WORK PERMIT SHALL BE PER NYC BUILDING CODE 2022 AND OBTAINED BY THE CONTRACTOR.

16. DOMESTIC WATER PIPING INSULATION, JACKETS, COVERINGS, SEALERS, MASTICS, AND ADHESIVES SHALL NOT EXCEED A FLAME SPREAD RATING OF 25 AND A SMOKE DEVELOP RATING OF 50 WHEN TESTED IN ACCORDANCE WITH ASTM E 84.

- 17. ALL PIPE INSULATION SHALL RUN CONTINUOUSLY THROUGH WALLS AND PARTITIONS.
- 18. DO NOT INSTALL DOMESTIC WATER PIPING IN AREAS SUBJECT TO FREEZING TEMPERATURES. INSTALL DOMESTIC WATER PIPING IN EXTERIOR WALLS ON THE CONDITIONED SIDE OF THE WALL INSULATION.
- 19. SHUT-OFF VALVES SHALL BE NIBCO TWO-PIECE, BRONZE, FULL PORT, BALL-TYPE. PROVIDE SHUT-OFF VALVES WHERE INDICATED ON THE SCHEDULES. INSTALL VALVES IN A LOCATION THAT PERMITS ACCESS FOR SERVICE AND OPERATION WITHOUT DAMAGE TO THE BUILDING OR FINISHED MATERIALS. PROVIDE ACCESS DOORS IF REQUIRED.
- 20. PROTECT COPPER PLATING AGAINST CONTACT WITH DISSIMILAR METALS. ALL HANGARS, ANCHORS, AND CLIPS SHALL BE COPPER OR COPPER-PLATED.
- 21. FURNISH AND INSTALL COMPLETE SYSTEMS OF SANITARY WASTE AND VENT PIPING FROM ALL PLUMBING FIXTURES AND/OR EQUIPMENT REQUIRING WASTE AND VENT CONNECTIONS. ALL WASTE AND VENT PIPING SHALL BE CONCEALED IN THE BUILDING CONSTRUCTION WHERE POSSIBLE
- 22. SANITARY WASTE AND VENT PIPING ABOVE GROUND: ASTM A 888 AND CISPI 301 HUBLESS, CAST IRON SOIL PIPE AND FITTINGS; AND HEAVY DUTY SHIELDED, STAINLESS STEEL COUPLINGS. ALL PIPE AND FITTINGS SHALL BE MARKED WITH THE COLLECTIVE TRADEMARK OF THE CAST IRON SOIL PIPE INSTITUTE, AND LISTED BY NSF INTERNATIONAL.
- 23. INVERTS ELEVATIONS SHALL BE ESTABLISHED AND VERIFIED BEFORE SANITARY PIPING IS INSTALLED IN ORDER THAT PROPER SLOPES WILL BE MAINTAINED. SLOPE SANITARY PIPING 2-1/2 IN AND SMALLER AT 2 PERCENT (1/4 IN/1 FOOT) MINIMUM, AND SLOPE SANITARY PIPING 3 IN AND LARGER AT 1 PERCENT (1/8 IN/1 FOOT) MINIMUM.
- 24. SANITARY WASTE BELOW GROUND: BELOW GROUND SANITARY WASTE PIPING SHALL BE CAST IRON.
- 25. WHERE SANITARY PIPING IS EXPOSED IN TOILET ROOMS, PROVIDE CHROME-PLATED BRASS PIPING WITH MATCHING STOPS AND ESCUTCHEONS. PROVIDE REMOVABLE TRAPS WITH INTEGRAL CLEANOUT PLUG FOR ALL LAVATORIES.
- 26. INSTALL CLEANOUTS IN A LOCATION THAT PERMITS ACCESS FOR SERVICE WITHOUT DAMAGE TO THE BUILDING OR FINISHED MATERIALS. CLEANOUT PLUGS SHALL BE IN ACCORDANCE WITH PLUMBING CODE REQUIREMENTS.
- 27. PROVIDE WATER HAMMER ARRESTORS CONFORMING TO PDI-WH201 OR ASSE 1010, INSTALLED PER MANUFACTURER'S SPECIFICATIONS, WHERE QUICK CLOSING VALVES ARE UTILIZED. A QUICK CLOSING VALVE IS A VALVE OR FAUCET THAT CLOSES AUTOMATICALLY WHEN RELEASED, OR THAT IS CONTROLLED BY MECHANICAL MEANS FOR FAST-ACTION CLOSING. REFER TO WATER HAMMER ARRESTOR SCHEDULE.
- 28. AS A MINIMUM PROVIDE ONE WATER HAMMER ARRESTOR FOR EACH BRANCH LINE TO EACH TOILET ROOM LESS THAN 20 FEET IN LENGTH, LOCATED BETWEEN THE LAST TWO FIXTURES SERVED. FOR BRANCH LINES GREATER THAN 20 FEET IN LENGTH, A SECOND WATER HAMMER ARRESTOR IS REQUIRED.
- 29. THE PLANS INCLUDE A COMBINATION OF INDVIDUAL AND COMMON VENTS AND SHALL BE INSTALLED PER: 2022 NYC PLUMBING CODE.
- 30. ALL PLUMBING WORK SHALL BE PERFORMED IN ACCORDANCE WITH 2022 NYC PLUMBING CODE.
- 31. ALL SUPPLY COLD AND HOT WATER PIPES ARE SIZED IN ACCORDANCE WITH 2022 NYC PLUMBING CODE. THE INSTALLATION OF HOT AND COLD WATER DISTRIBUTION SYSTEM SHALL BE INSTALLED IN ACCORDANCE WITH THE 2022 NYC PLUMBING CODE.

PLUMBING STANDARD ABBREVIATIONS

BCO **BUILDING CLEAN OUT** BFP **BACKFLOW PREVENTER** BOI **BOTTOM OF INSULATION** CI CAST IRON **CLEANOUT COLD WATER** CW DF DRINKING FOUNTAIN DRAIN OR DRAIN PIPING DRN OR D **EWC ELECTRIC WATER COOLER** FCO FLOOR CLEANOUT FLOOR DRAIN **HOT WATER** JANITORS SINK LAVATORY **NON-POTABLE WATER** OD OVERFLOW DRAIN OIL WATER SEPARATOR OWS PUMPED CONDENSATE **ROOF DRAIN**

S SINK
SS SANITARY DRAIN
SAN WASTE (SAME AS SS)
UR URINAL

V VENT
VTR VENT THRU ROOF

WC WATER CLOSET
WCO WALL CLEANOUT
WH WALL HYDRANT
WHA WALL HAMMER ARRESTOR

WATER METER

 REFER TO SHEETS A SERIES FOR ARCHITECTURAL DRAWINGS, NOTES, DETAILS, SCHEDULES AND REQUIREMENTS. FILED UNDER SEPARATE APPLICATION.

 REFER TO SHEETS E SERIES FOR BUILDING ELECTRICAL DRAWINGS, NOTES, DETAILS, SCHEDULES AND REQUIREMENTS. FILED UNDER SEPARATE APPLICATION.

SEPARATE APPLICATION.

3. REFER TO SHEETS M SERIES FOR HVAC MECHANICAL DRAWINGS, NOTES, DETAILS, SCHEDULES AND REQUIREMENTS. FILED UNDER SEPARATE

APPLICATION.

4. REFER TO SHEETS P SERIES FOR PLUMBING DRAWINGS, NOTES, DETAILS, SCHEDULES AND REQUIREMENTS. FILED UNDER SEPARATE APPLICATION.

5. REFER TO SHEETS S SERIES FOR BUILDING STRUCTURAL DRAWINGS,


NOTES, DETAILS, SCHEDULES AND REQUIREMENTS. FILED UNDER

SEPARATE APPLICATION.

6. REFER TO GENERAL NOTES ON MEP COVER SHEET FOR ADDITIONAL REQUIREMENTS OF WORK.

PLUMBING SYMBOLS


SHEET NOTES:

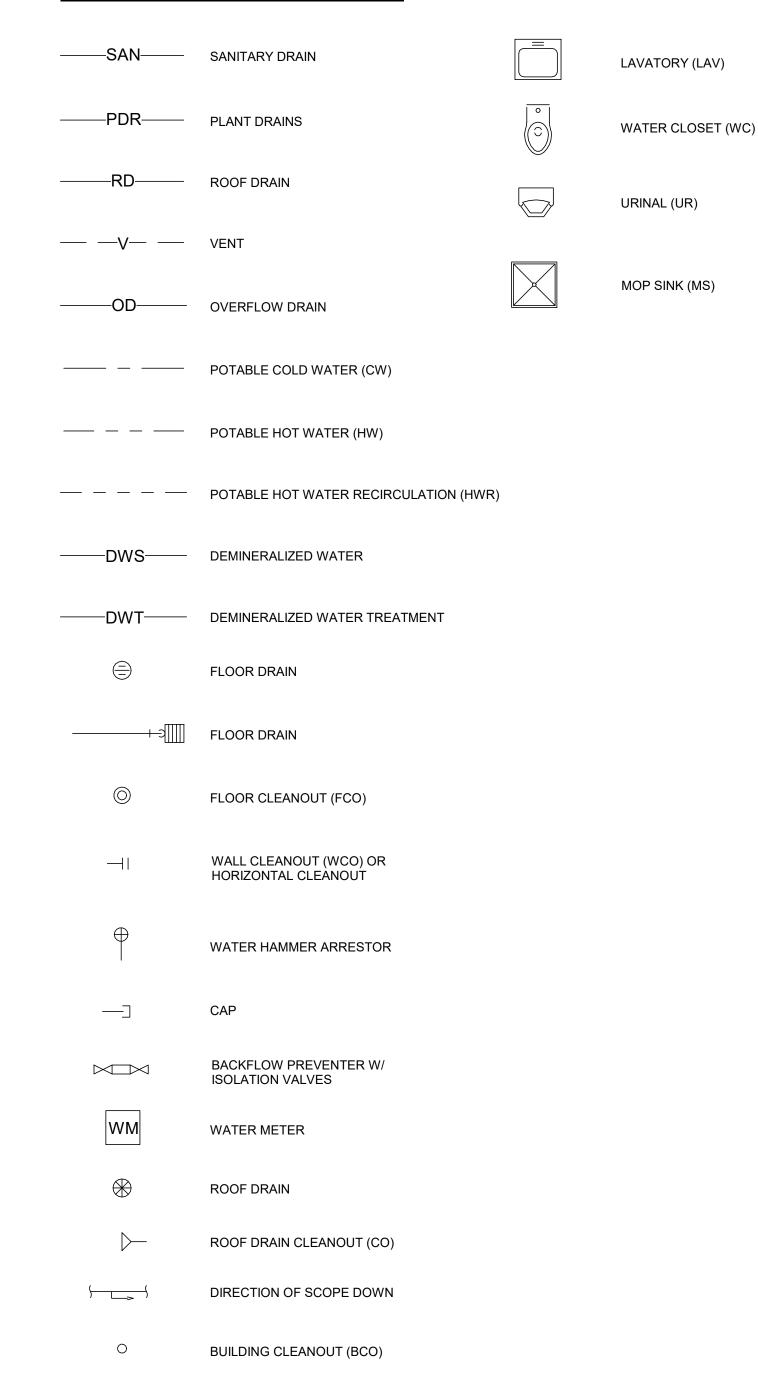

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Sparta, NJ 07871

25 Mohawk Avenue

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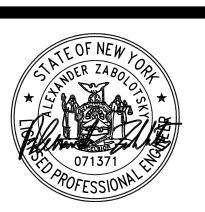
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31-45 20th Avenue, Astoria, Queens NY 11105 Block #850 - Lot #310 - BIN #4624437

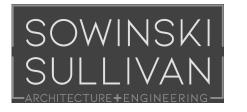PLUMBING - GENERAL NOTES, LEGENDS, SYMBOLS & ABBREVIATIONS



DATE 12/12/2022
PROJECT NO 105121
DRAWING BY W.PENDLETON
CHECKED BY S.DEVADKAR
DRAWING NO

P-004.00

CADD FILE NO
Autodesk Docs://CHPE
Astoria/CHA-KIE-081-00-M3-H-001.rvt

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EQUIPMENT SUBMITTAL NOTE:

EQUIPMENT SHALL BE INSPECTED AND TESTED PER NYC BUILDING CODE 2022.

EQUIPMENT USE PERMIT (EUP) SHALL BE OBTAINED AS PER NYC BUILDING CODE 2022.

ALL COORDINATED SUBMITTALS OF ALL HVAC INSTALLATION SHALL BE SUBMITTED FOR REVIEW. THIS SHALL BE DONE BEFORE THE INSTALLATION OF ANY PIPING / DUCTWORK OR EQUIPMENT. THE SUBMITTAL SHALL INCLUDE PIPE / DUCT ROUTING, SIZES, ELEVATIONS. THE DRAWINGS SHALL CONTAIN ALL THE INFORMATION NECESSARY FOR THE PROPER INSTALLATION OF THE JOB. THE SUBMITTAL SHALL BE COORDINATED WITH OTHER TRADES OR EQUIPMENT THAT MIGHT AFFECT THE INSTALLATION. THE DRAWINGS SHALL BE SUBMITTED AT A MIN. 3/8" SCALE OR AT A SCALE THAT IS EASILY LEGIBLE. THE DESIGN DRAWINGS ARE ESSENTIALLY DIAGRAMMATIC AND ARE NOT INTENDED TO BE USED AS A SUBMITTAL. THEREFORE A COPY OF THE DESIGN DRAWING IS NOT ACCEPTABLE AS A SUBMITTAL. REFER TO SUBMITTAL PROCEDURES SPECIFICATION SECTION FOR ADDITIONAL INFORMATION. THE GENERAL CONTRACTOR SHALL SUBMIT A COORDINATED SUBMITTAL WHICH INCLUDES ALL THE TRADES. THIS INCLUDES GENERAL CONSTRUCTION, ELECTRICAL, HVAC, PLUMBING & STRUCTURAL TRADES. ALL CONFLICTS MUST BE IDENTIFIED ON THE COORDINATED SUBMITTAL.

ALL WORK, MATERIALS AND WORKMANSHIP SHALL BE PERFORMED IN STRICT ACCORDANCE WITH, AND CONFORM WITH ALL

ALL WORK SHOWN ON THESE DRAWINGS SHALL COMPLY WITH ALL APPLICABLE BUILDING CODES AND REGULATIONS. ALL

BUILDING; ACCUMULATION OF DUST AND DEBRIS. THE CONTRACTOR SHALL LEAVE THE SITE BROOM CLEAN EACH DAY.

CONSTRUCTION AREA SHALL BE THOROUGHLY CLEANED PRIOR, DURING AND AFTER CONSTRUCTION.

SUBMITTALS SHALL BE IN COMPLIANCE WITH CONTRACT REQUIREMENTS AND ACTUAL FIELD CONDITIONS.

REQUIRED INSPECTIONS NECESSARY TO PERFORM WORK AND SERVICES HEREIN NOTED OR INDICATED ON THE DRAWINGS,

PROVIDE PROTECTION FOR THE GENERAL PUBLIC AND CONSTRUCTION WORKERS IN AND AROUND THE CONSTRUCTION SITE.

2. MATERIALS, EQUIPMENT, ASSEMBLIES, FORMS AND METHODS OF CONSTRUCTION SHALL BE APPROVED FOR INSTALLATION PER NYC

DEPARTMENT OF BUILDINGS, AS REQUIRED BY N.Y.C. BUILDING CODE. ALL MECHANICAL EQUIPMENT SHALL COMPLY WITH 2020

8. DUCTWORK SYSTEMS SHALL BE CONSTRUCTED WITH PROVISIONS FOR ACCESS AND INSPECTION IN ACCORDANCE WITH NYC

3. SPECIAL INSPECTIONS SHALL BE PREFORMED BY CERTIFIED SPECIAL INSPECTIONS AGENCY & SHALL BE FILED WITH THE


ALL WORK SHALL BE EXECUTED IN A NEAT AND ORDERLY MANNER WITH THE LEAST POSSIBLE NOISE. DUST. OR DISTURBANCE TO

SPECIAL PRECAUTIONS SHALL BE TAKEN BY THE CONTRACTOR SO THAT EQUIPMENT AND ITS INSTALLATION WILL NOT EFFECT ANY OF THE FOLLOWING: EGRESS TO AND FROM THE BUILDING; FIRE SAFETY, OR CREATE A FIRE HAZARD; STRUCTURAL SAFETY OF THE

FEDERAL, STATE AND LOCAL CODES, ORDINANCES, RULES AND REGULATIONS, SPECIFICATIONS AND RECOMMENDED PRACTICES

OF THE MANUFACTURERS AND THE APPROPRIATE APPLICABLE STANDARDS. WHERE SUCH CODES, RULES AND REGULATIONS ARE

AT VARIANCE WITH THE PLANS AND NOTES, SAID CODES, RULES AND REGULATIONS, ETC. SHALL TAKE PRECEDENCE OVER THE

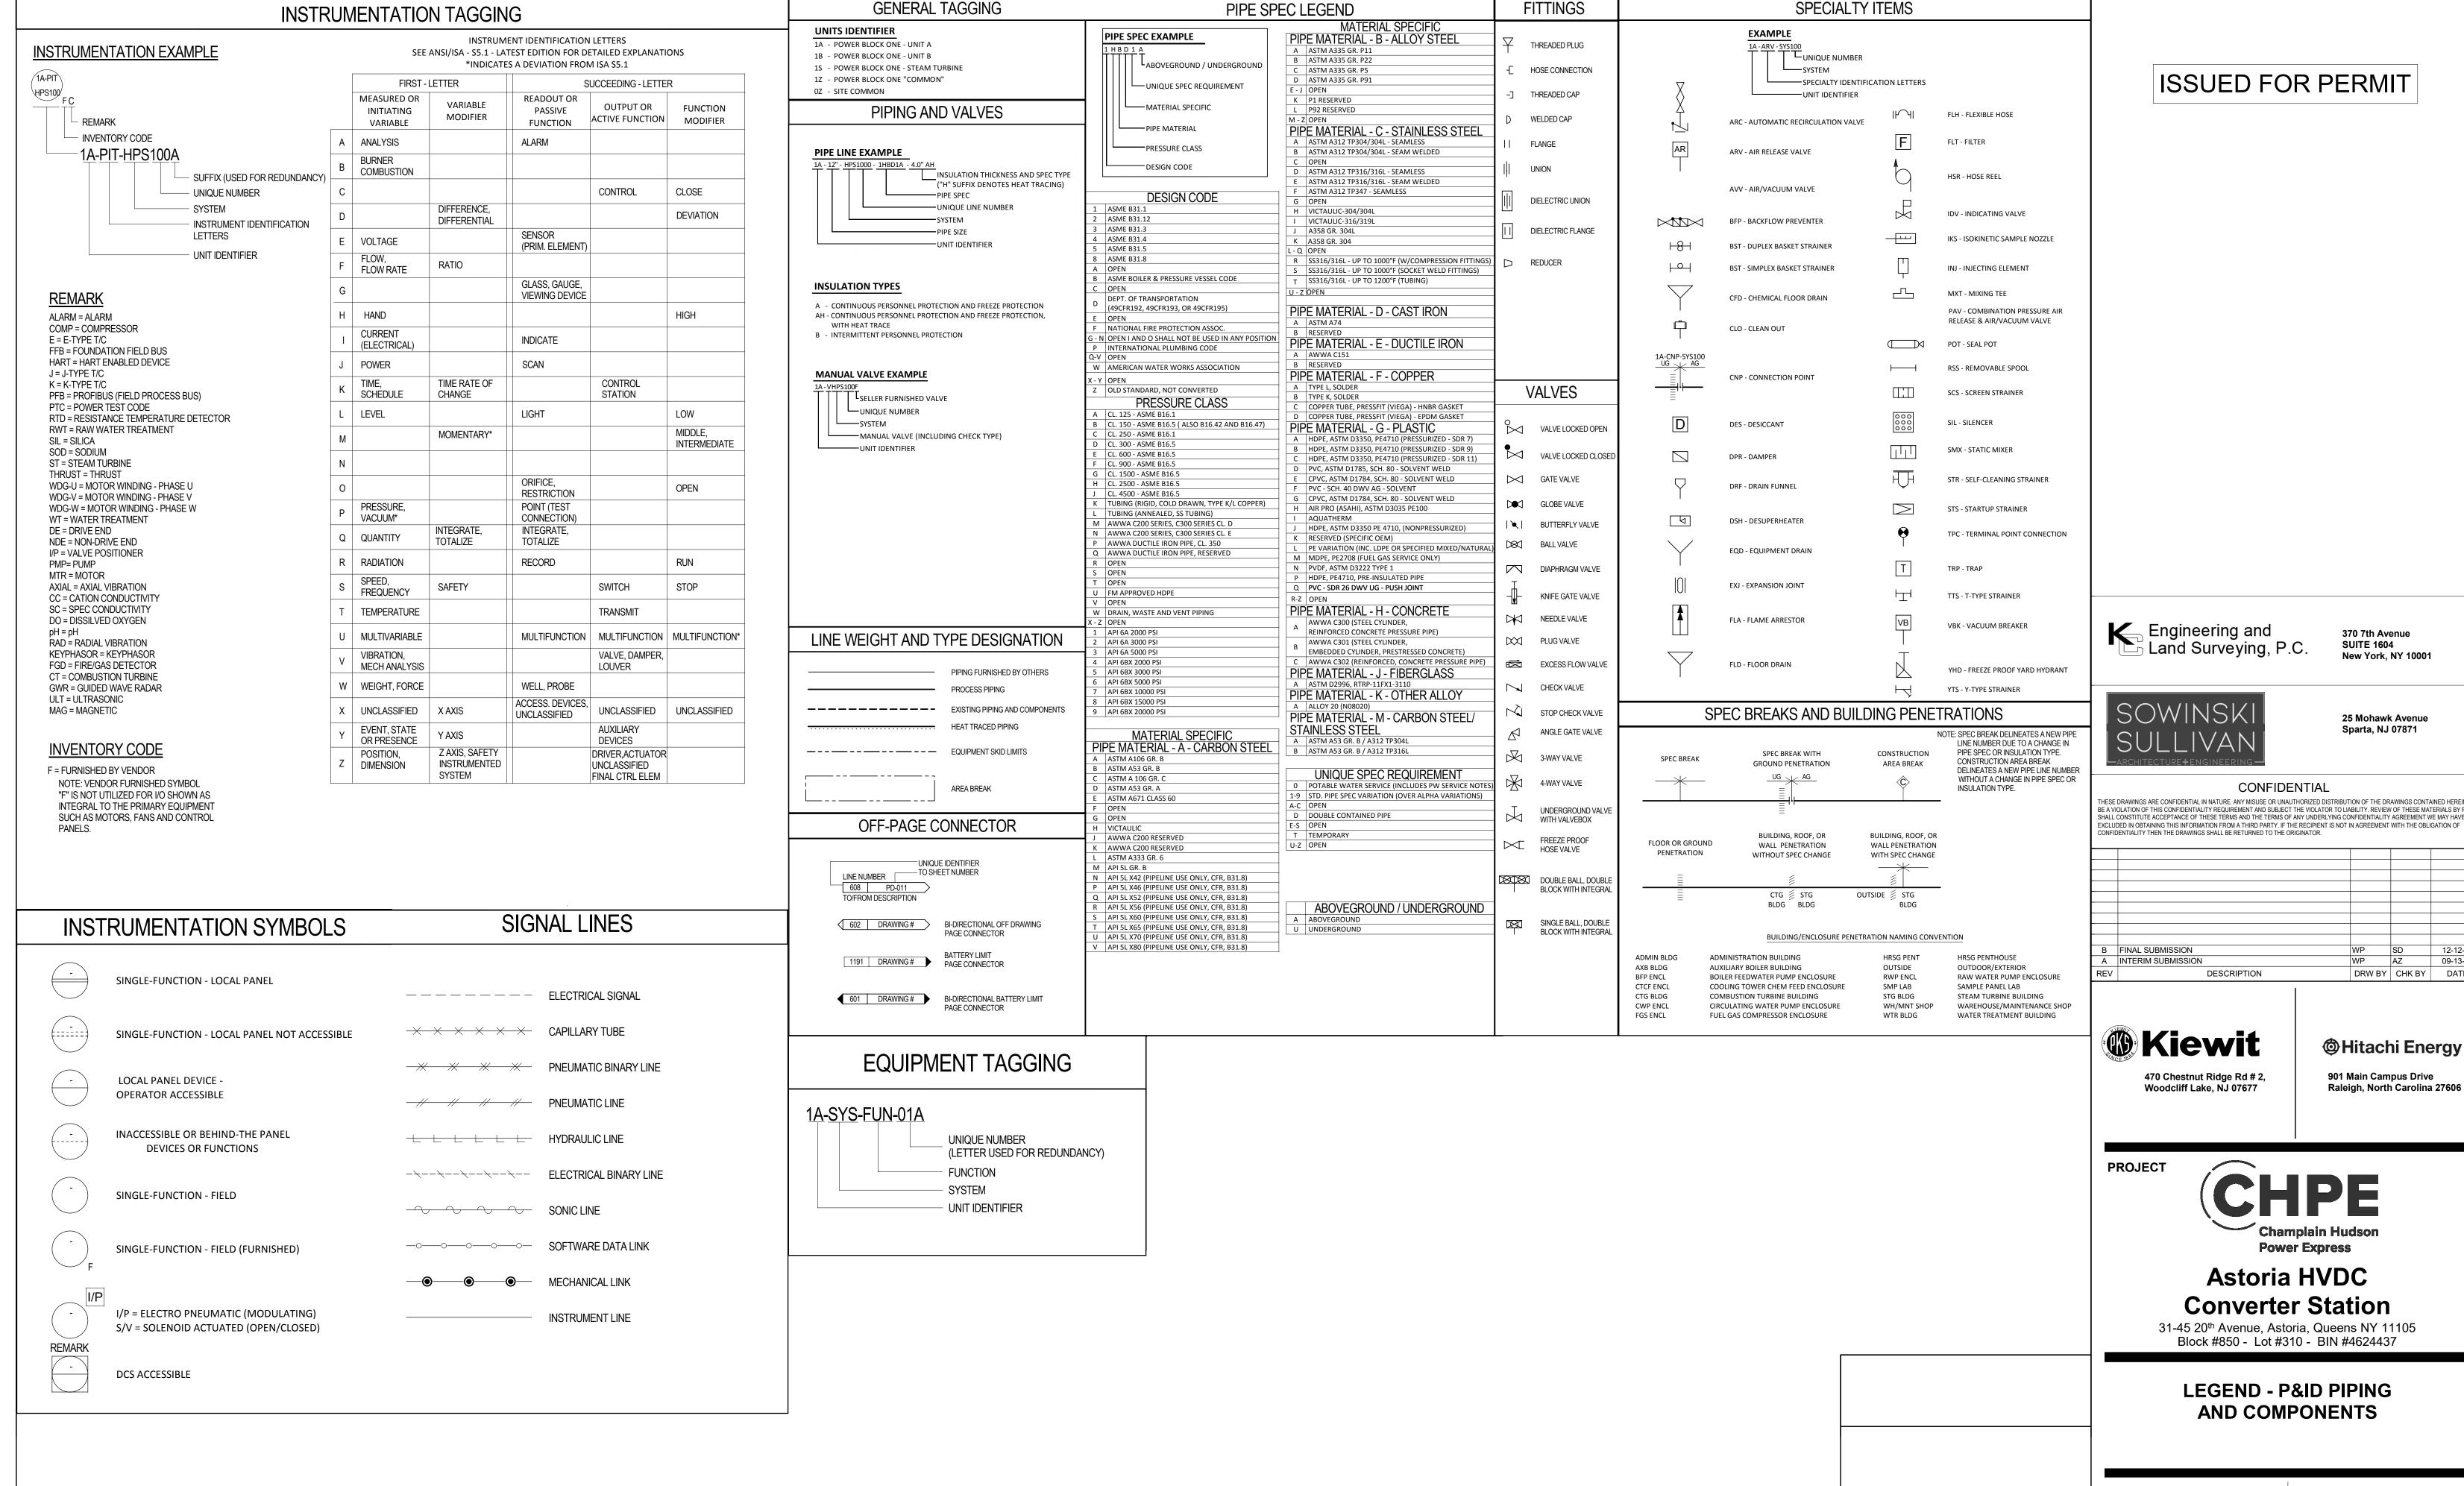

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Sparta, NJ 07871

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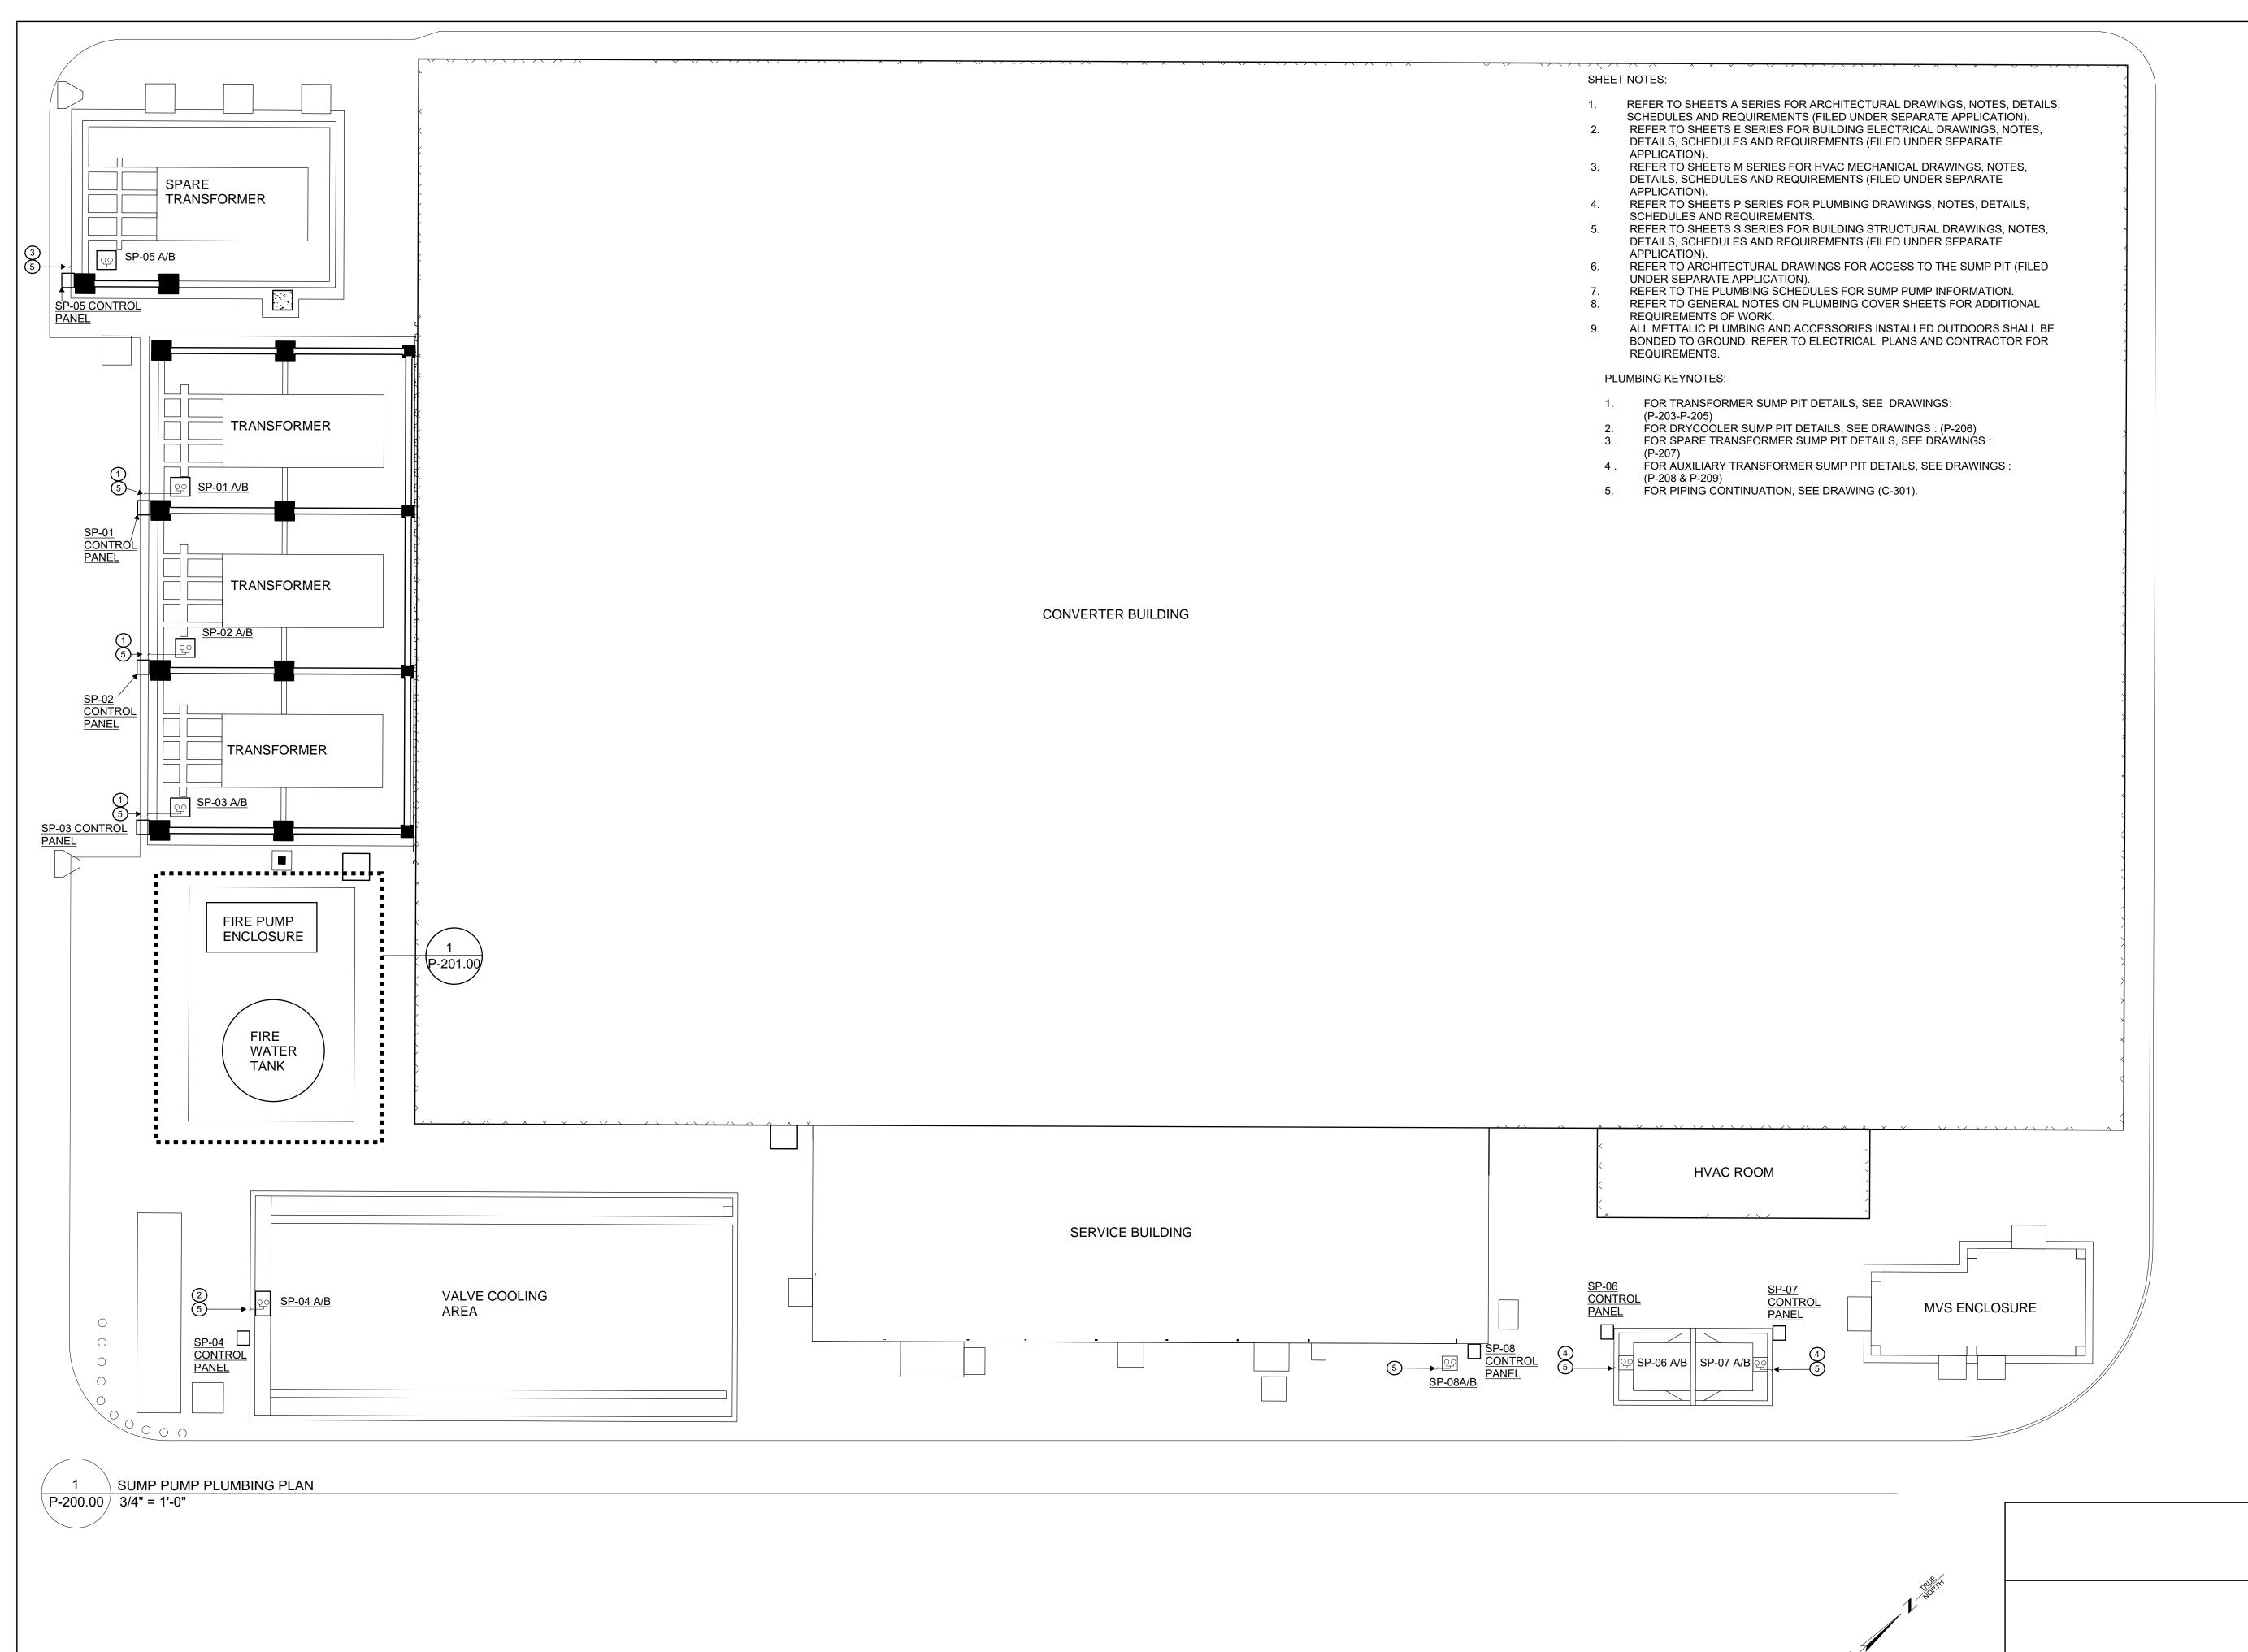
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> 901 Main Campus Drive




12/12/2022 PROJECT NO 105121 J.HUTTON CHECKED BY S.DEVADKAR DRAWING NO

P-005.00





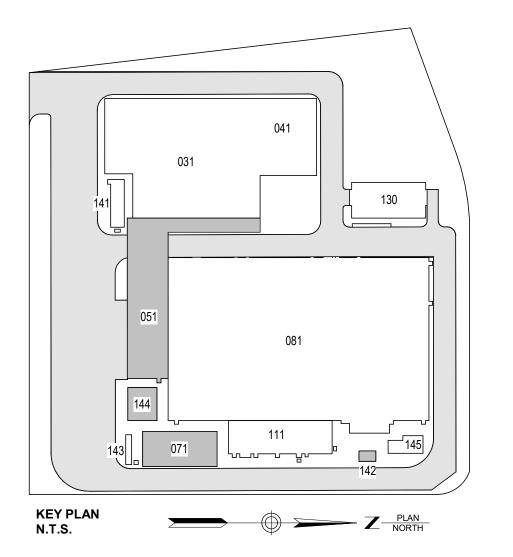

Engineering and Land Surveying, P.C.

370 7th Avenue SUITE 1604 New York, NY 10001



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PROJEC



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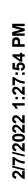
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SUMP PUMP PLUMBING PLAN



DATE	12/12/2022
PROJECT NO	105121
DRAWING BY	J.HUTTON
CHECKED BY	S.DEVADKAR
DRAWING NO	

P-200.00




- 1. REFER TO SHEETS A SERIES FOR ARCHITECTURAL DRAWINGS, NOTES, DETAILS, SCHEDULES AND REQUIREMENTS. FILED UNDER SEPARATE
- REFER TO SHEETS E SERIES FOR BUILDING ELECTRICAL DRAWINGS, NOTES, DETAILS, SCHEDULES AND REQUIREMENTS. FILED UNDER SEPARATE APPLICATION.
- 3. REFER TO SHEETS M SERIES FOR HVAC MECHANICAL DRAWINGS, NOTES, DETAILS, SCHEDULES AND REQUIREMENTS. FILED UNDER SEPARATE
- APPLICATION.
 4. REFER TO SHEETS P SERIES FOR PLUMBING DRAWINGS, NOTES, DETAILS,
- SCHEDULES AND REQUIREMENTS. FILED UNDER SEPARATE APPLICATION.
 5. REFER TO SHEETS S SERIES FOR BUILDING STRUCTURAL DRAWINGS,
 NOTES, DETAILS, SCHEDULES AND REQUIREMENTS. FILED UNDER
- SEPARATE APPLICATION.
 6. REFER TO GENERAL NOTES ON PLUMBING COVER SHEETS FOR
- ADDITIONAL REQUIREMENTS OF WORK.

 7. ALL METTALIC PLUMBING AND ACCESSORIES INSTALLED OUTDOORS
 SHALL BE BONDED TO GROUND REFER TO ELECTRICAL PLANS AND
- SHALL BE BONDED TO GROUND. REFER TO ELECTRICAL PLANS AND CONTRACTOR FOR REUIREMENTS.

PLUMBING KEYNOTES

- UNDERGROUND PIPE. REFER TO CIVIL DRAWINGS FOR INVERT ELEVATION AND CONTINUATION. PROVIDE DIELECTRIC CONNECTION WHEN CONNECTING PIPES WITH DISSIMILAR METALS. CIVIL DRAWINGS ARE FILED UNDER SEPARATE APPLICATION.
- FIRE-WATER MAIN PIPE FROM THE BOOSTER PUMP TO THE UNDERGROUND CIVIL PIPE SHALL BE INSULATED AND HEAT TRACED WITH 8 WATTS/FT OF HEAT. HEAT TRACE CONTROLLER TO BE INSTALLED ON BOOSTER PUMP ENCLOSURE. REFER TO ELECTRICAL DRAWINGS AND COORDINATE WITH ELECTRICAL CONTRACTOR FOR POWER.
- 6" CARBON STEEL WATER PIPE FROM BOOSTER PUMP TO FIRE TANK. PIPE TO BE HEAT TRACED WITH 8 WATTS/FT OF HEAT. HEAT TRACE CONTROLLER TO BE INSTALLED INSIDE FIRE PUMP ENCLOSURE. REFER TO FIRE TANK P&ID AND SPECS. REFER TO ELECTRICAL DRAWINGS AND COORDINATE WITH ELECTRICAL CONTRACTOR FOR POWER.
- FIRE TANK TO BE PROVIDED BY PLUMBING CONTRACTOR AND INSTALLED ON CONCRETE PAD. REFER TO FIRE TANK SPECS AND P&ID FOR MORE INFORMATION.
- BOOSTER PUMP TO BE INSTALLED INSIDE HEATED AND INSULATED ENCLOSURE. THE ENCLOSURE SHALL MEET ASSE STANDARD 1060 CLASS ONE FOR FREEZE PROTECTION. PROVIDED WITH ACCESS FROM ALL 4 SIDES. COORDINATE FINISH WITH ARCHITECT PRIOR TO ORDERING.
- WATTS SERIES 6" 957RPDA TO BE INSTALLED INSIDE HEATED AND INSULATED ENCLOSURE. THE ENCLOSURE SHALL MEET ASSE STANDARD 1060 CLASS ONE FOR FREEZE PROTECTION. PROVIDED WITH ACCESS FROM ALL 4 SIDES, PROVIDE HINGED DRAIN OPENING ON THE SIDE OF RPDA. COORDINATE FINISH WITH ARCHITECT PRIOR TO ORDERING.
- REFER TO FIRE PROTECTION DRAWINGS FOR THE FIRE PUMP ENCLOSURE, FIRE PROTECTION EQUIPMENT, AND PIPES. ALL PIPES, EQUIPMENT, AND ASSOCIATED ACCESSORIES DOWNSTREAM OF THE FIRE TANK ARE TO BE PROVIDED BY THE FIRE PROTECTION. CONTRACTOR. FIRE PRITECTION DRAWINGS ARE FILED UNDER SEPARATE APPLICATION.

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370 7th Avenue SUITE 1604 New York, NY 10001
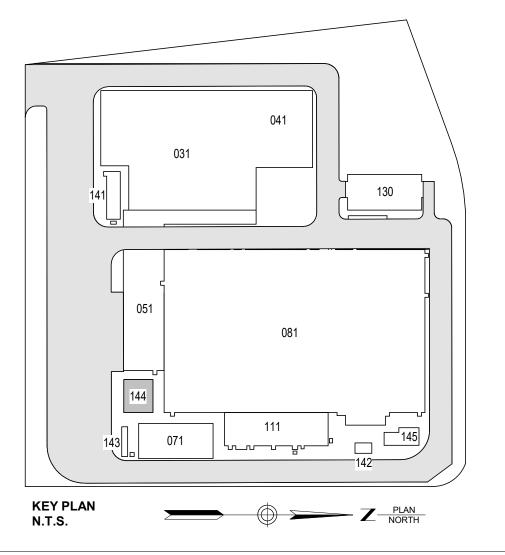
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В	FINAL SUBMISSION	WP	SD	12-12-22
Α	INTERIM SUBMISSION	WP	BH	09-13-22
REV	DESCRIPTION	DRW BY	CHK BY	DATE



901 Main Campus Drive Raleigh, North Carolina 27606

PROJECT



Astoria HVDC Converter Station

31-45 20th Avenue, Astoria, Queens NY 11105 Block #850 - Lot #310 - BIN #4624437

FIRE PROTECTION WATER & TANK ENLARGED PLAN





DATE	12/12/2022
PROJECT NO	105121
DRAWING BY	J.HUTTON
CHECKED BY	S.DEVADKAR
DRAWING NO	

P-201.00

CADD FILE NO
Autodesk Docs://CHPE
Astoria/CHA-KIE-081-00-M3-H-001.rvt

1 FIRE PROTECTION WATER & TANK ENLARGED PLAN P-201.00 1/4" = 1'-0"

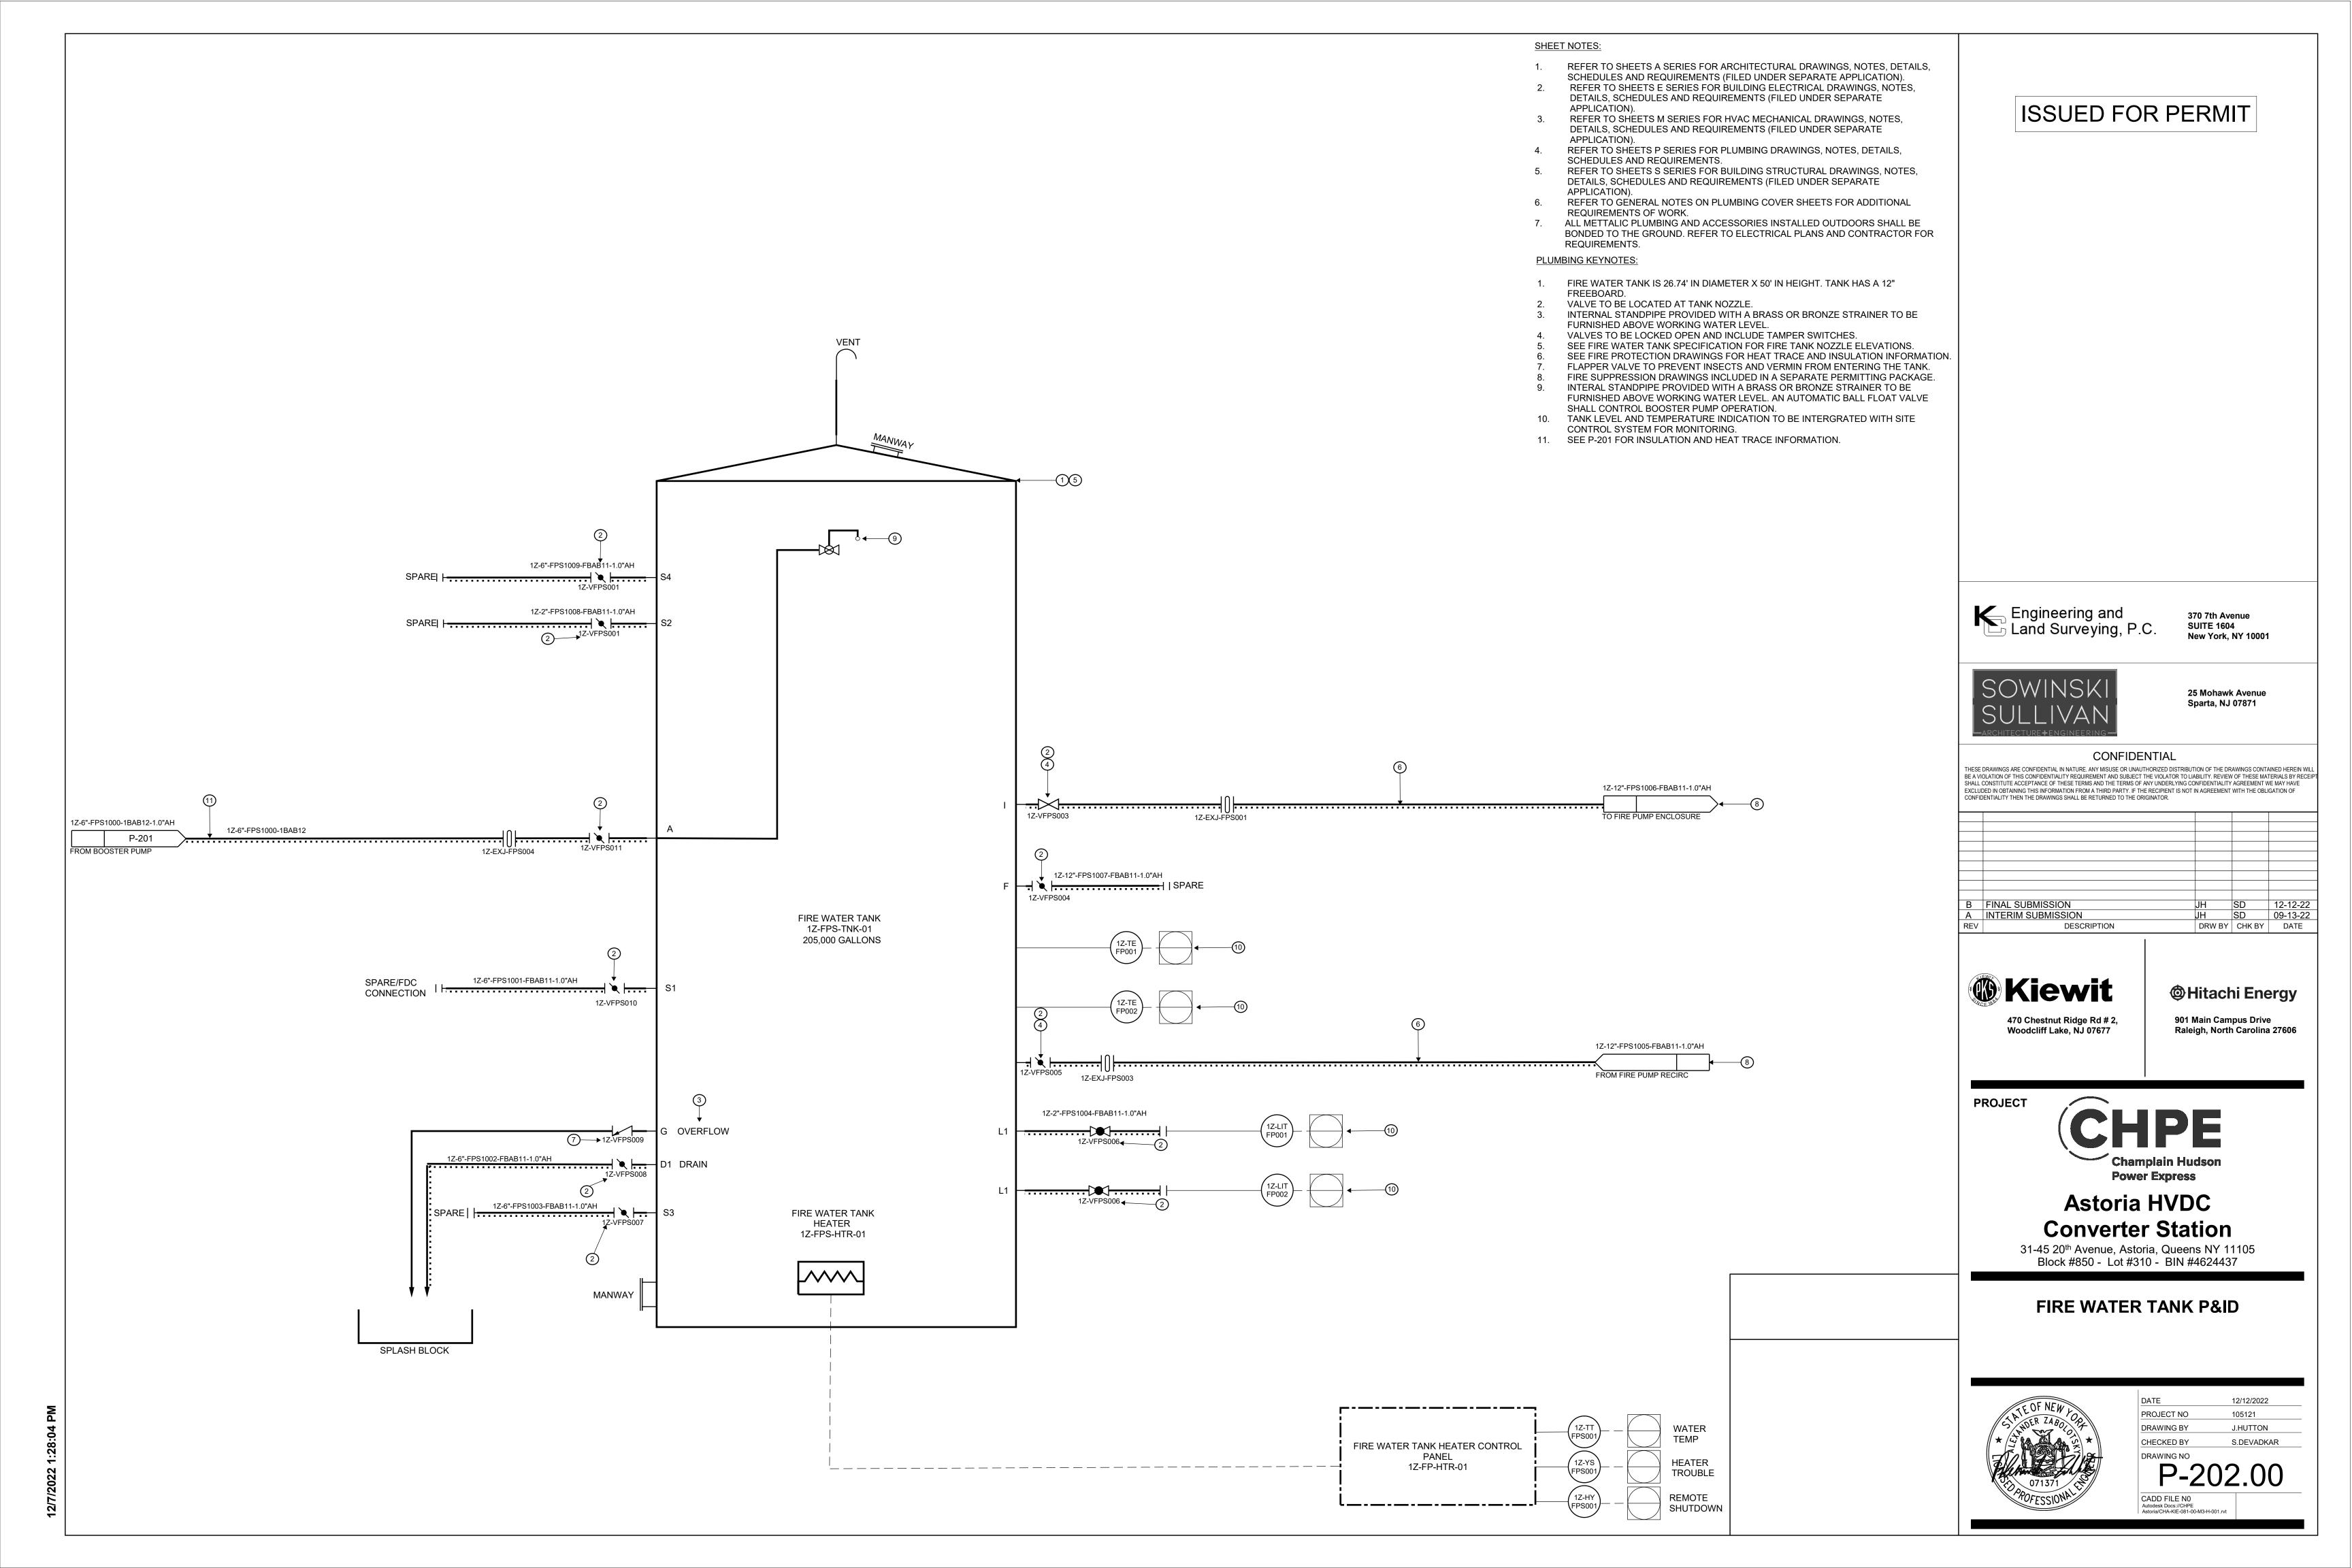

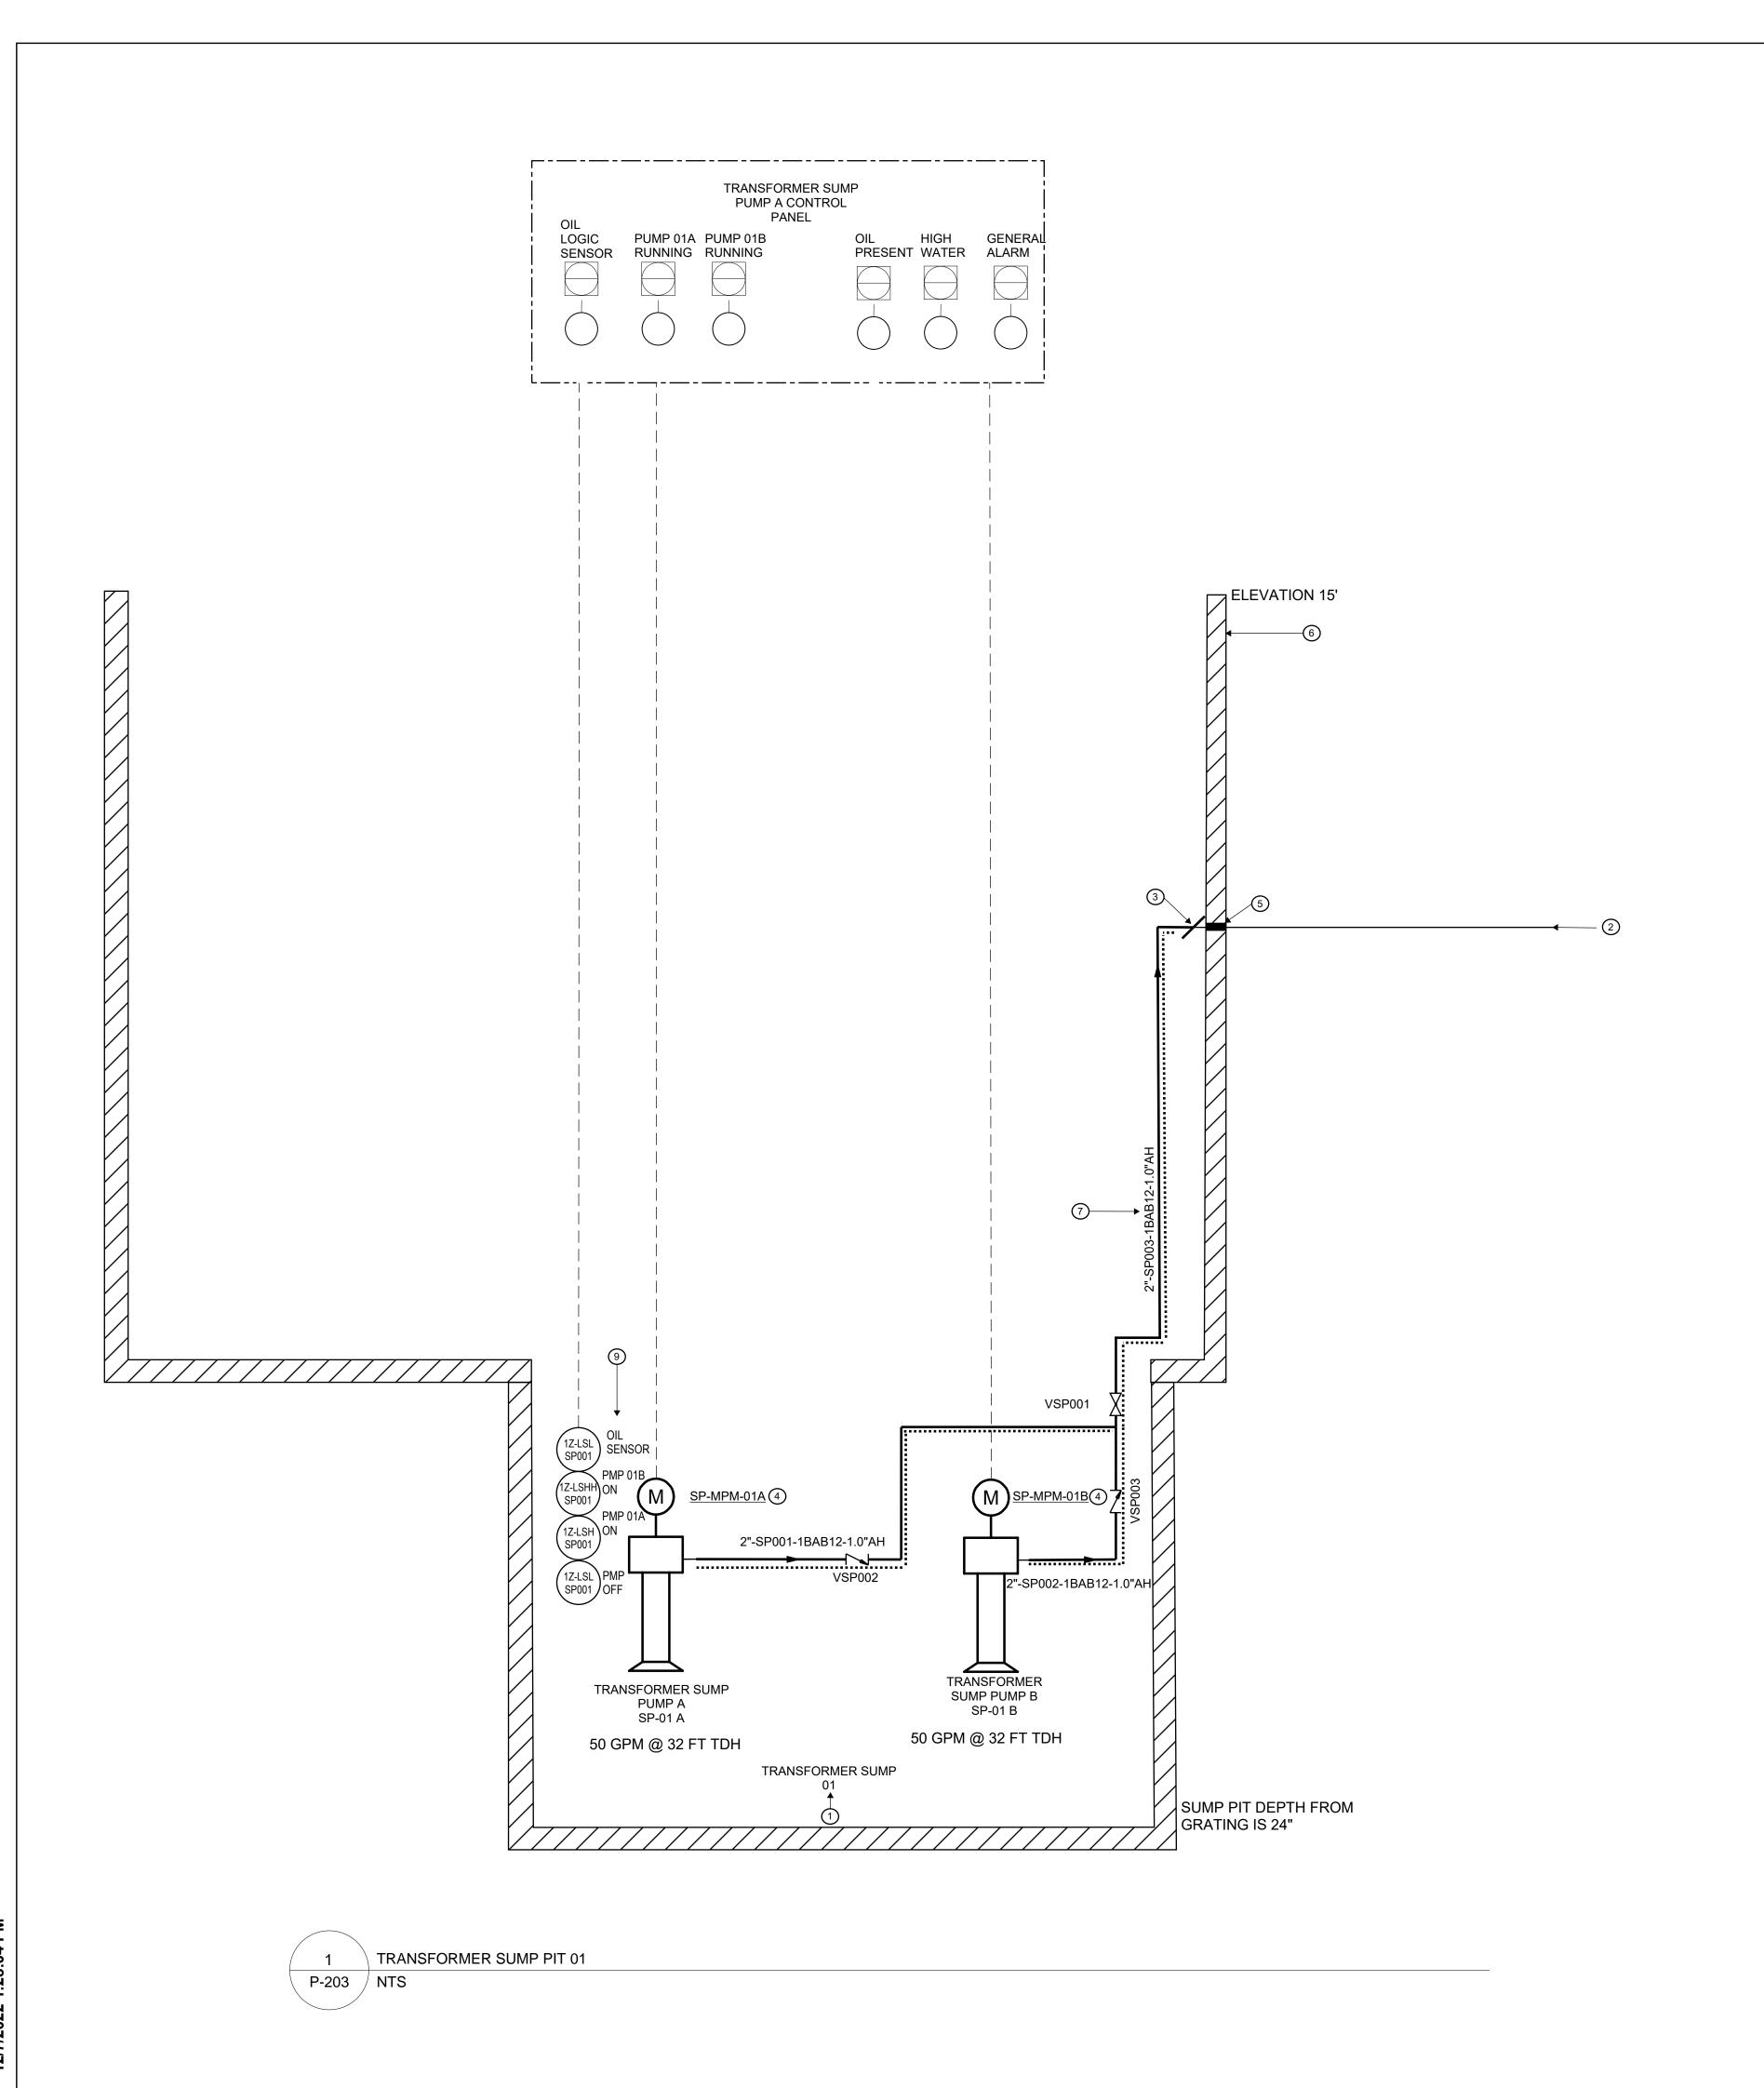

- 1. REFER TO SHEETS A SERIES FOR ARCHITECTURAL DRAWINGS, NOTES, DETAILS, SCHEDULES AND REQUIREMENTS (FILED UNDER SEPARATE APPLICATION).
- 2. REFER TO SHEETS E SERIES FOR BUILDING ELECTRICAL DRAWINGS, NOTES, DETAILS, SCHEDULES AND REQUIREMENTS (FILED UNDER SEPARATE APPLICATION).
- 3. REFER TO SHEETS M SERIES FOR HVAC MECHANICAL DRAWINGS, NOTES, DETAILS, SCHEDULES AND REQUIREMENTS (FILED UNDER SEPARATE
- 4. REFER TO SHEETS P SERIES FOR PLUMBING DRAWINGS, NOTES, DETAILS, SCHEDULES AND REQUIREMENTS.
- 5. REFER TO SHEETS S SERIES FOR BUILDING STRUCTURAL DRAWINGS, NOTES, DETAILS, SCHEDULES AND REQUIREMENTS (FILED UNDER SEPARATE
- APPLICATION).
 REFER TO ARCHITECTURAL DRAWINGS FOR ACCESS TO THE SUMP PIT (FILED UNDER SEPARATE APPLICATION).
- REFER TO THE PLUMBING SCHEDULES FOR SUMP PUMP INFORMATION.
 SEE COUGAR SPARTAN OIL LOGIC CONTROL PANEL SUBMITTAL. PANEL TO BE
- INTEGRATED WITH SITE BMS.

 9. REFER TO GENERAL NOTES ON PLUMBING COVER SHEETS FOR ADDITIONAL
- REQUIREMENTS OF WORK.

 ALL METTALIC PLUMBING AND ACCESSORIES INSTALLED OUTDOORS SHALL BE BONDED TO GROUND. REFER TO ELECTRICAL PLANS AND CONTRACTOR FOR REQUIREMENTS.

PLUMBING KEYNOTES:

- 1. SECONDARY CONTAINMENT TO SLOPE TOWARDS THE SUMP PIT. FOR CONTAINMENT DETAILS, SEE STRUCTURAL DRAWINGS: (FO-135, FO-136, FO-137)
- & FO-310 FILED UNDER SEPARATE APPLICATION).

 REFER TO C-301 CIVIL DRAWING FOR PIPING CONTINUATION AND INVERTED ELEVATION (FILE UNDER SEPARATE APPLICATION).
- 3. SUMP PUMP DRAIN PIPE TO BE CONNECTED TO CIVIL PIPE INSIDE THE CONTAINMENT PIT.
- FOR PUMP INFORMATION, REFER TO SUMP PUMP SCHEDULE.

 PIPE SEAL AND PENETRATION SLEEVE TO BE SPECIFIED BY CIVIL AND
- PROVIDED BY CIVIL (FILED UNDER SEPARATE APPLICATION).
 6. PIT ACCESS TO BE PROVIDED AND SHOWN ON STRUCTURAL DRAWINGS
- (FILED UNDER SEPARATE APPLICATION).
 7. SUMP PUMP DISCHARGE PIPING TO BE INSULATED AND HEAT TRACED UP
- UNTIL EXITING OF CONTAINMENT FOR FREEZE PROTECTION. REFER TO ELECTRICAL DRAWINGS FOR CONTROL PANEL AND JUNCTION BOX INFORMATION.
- 8. SEE PUMP PLAN (P-200) FOR TRANSFORMER SUMP PUMP DENOTATION.





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В	FINAL SUBMISSION	JH	SD	12-12-22
Α	INTERIM SUBMISSION	JH	SD	09-13-22
REV	DESCRIPTION	DRW BY	CHK BY	DATE



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901 Main Campus Drive Raleigh, North Carolina 27606

PROJECT



Astoria HVDC Converter Station

31-45 20th Avenue, Astoria, Queens NY 11105 Block #850 - Lot #310 - BIN #4624437

TRANSFORMER SUMP 01



 DATE
 12/12/2022

 PROJECT NO
 105121


 DRAWING BY
 J.HUTTON

 CHECKED BY
 S.DEVADKAR

P-203.00

CADD FILE NO
Autodesk Docs://CHPE
Astoria/CHA-KIE-081-00-M3-H-001.rvt

DRAWING NO

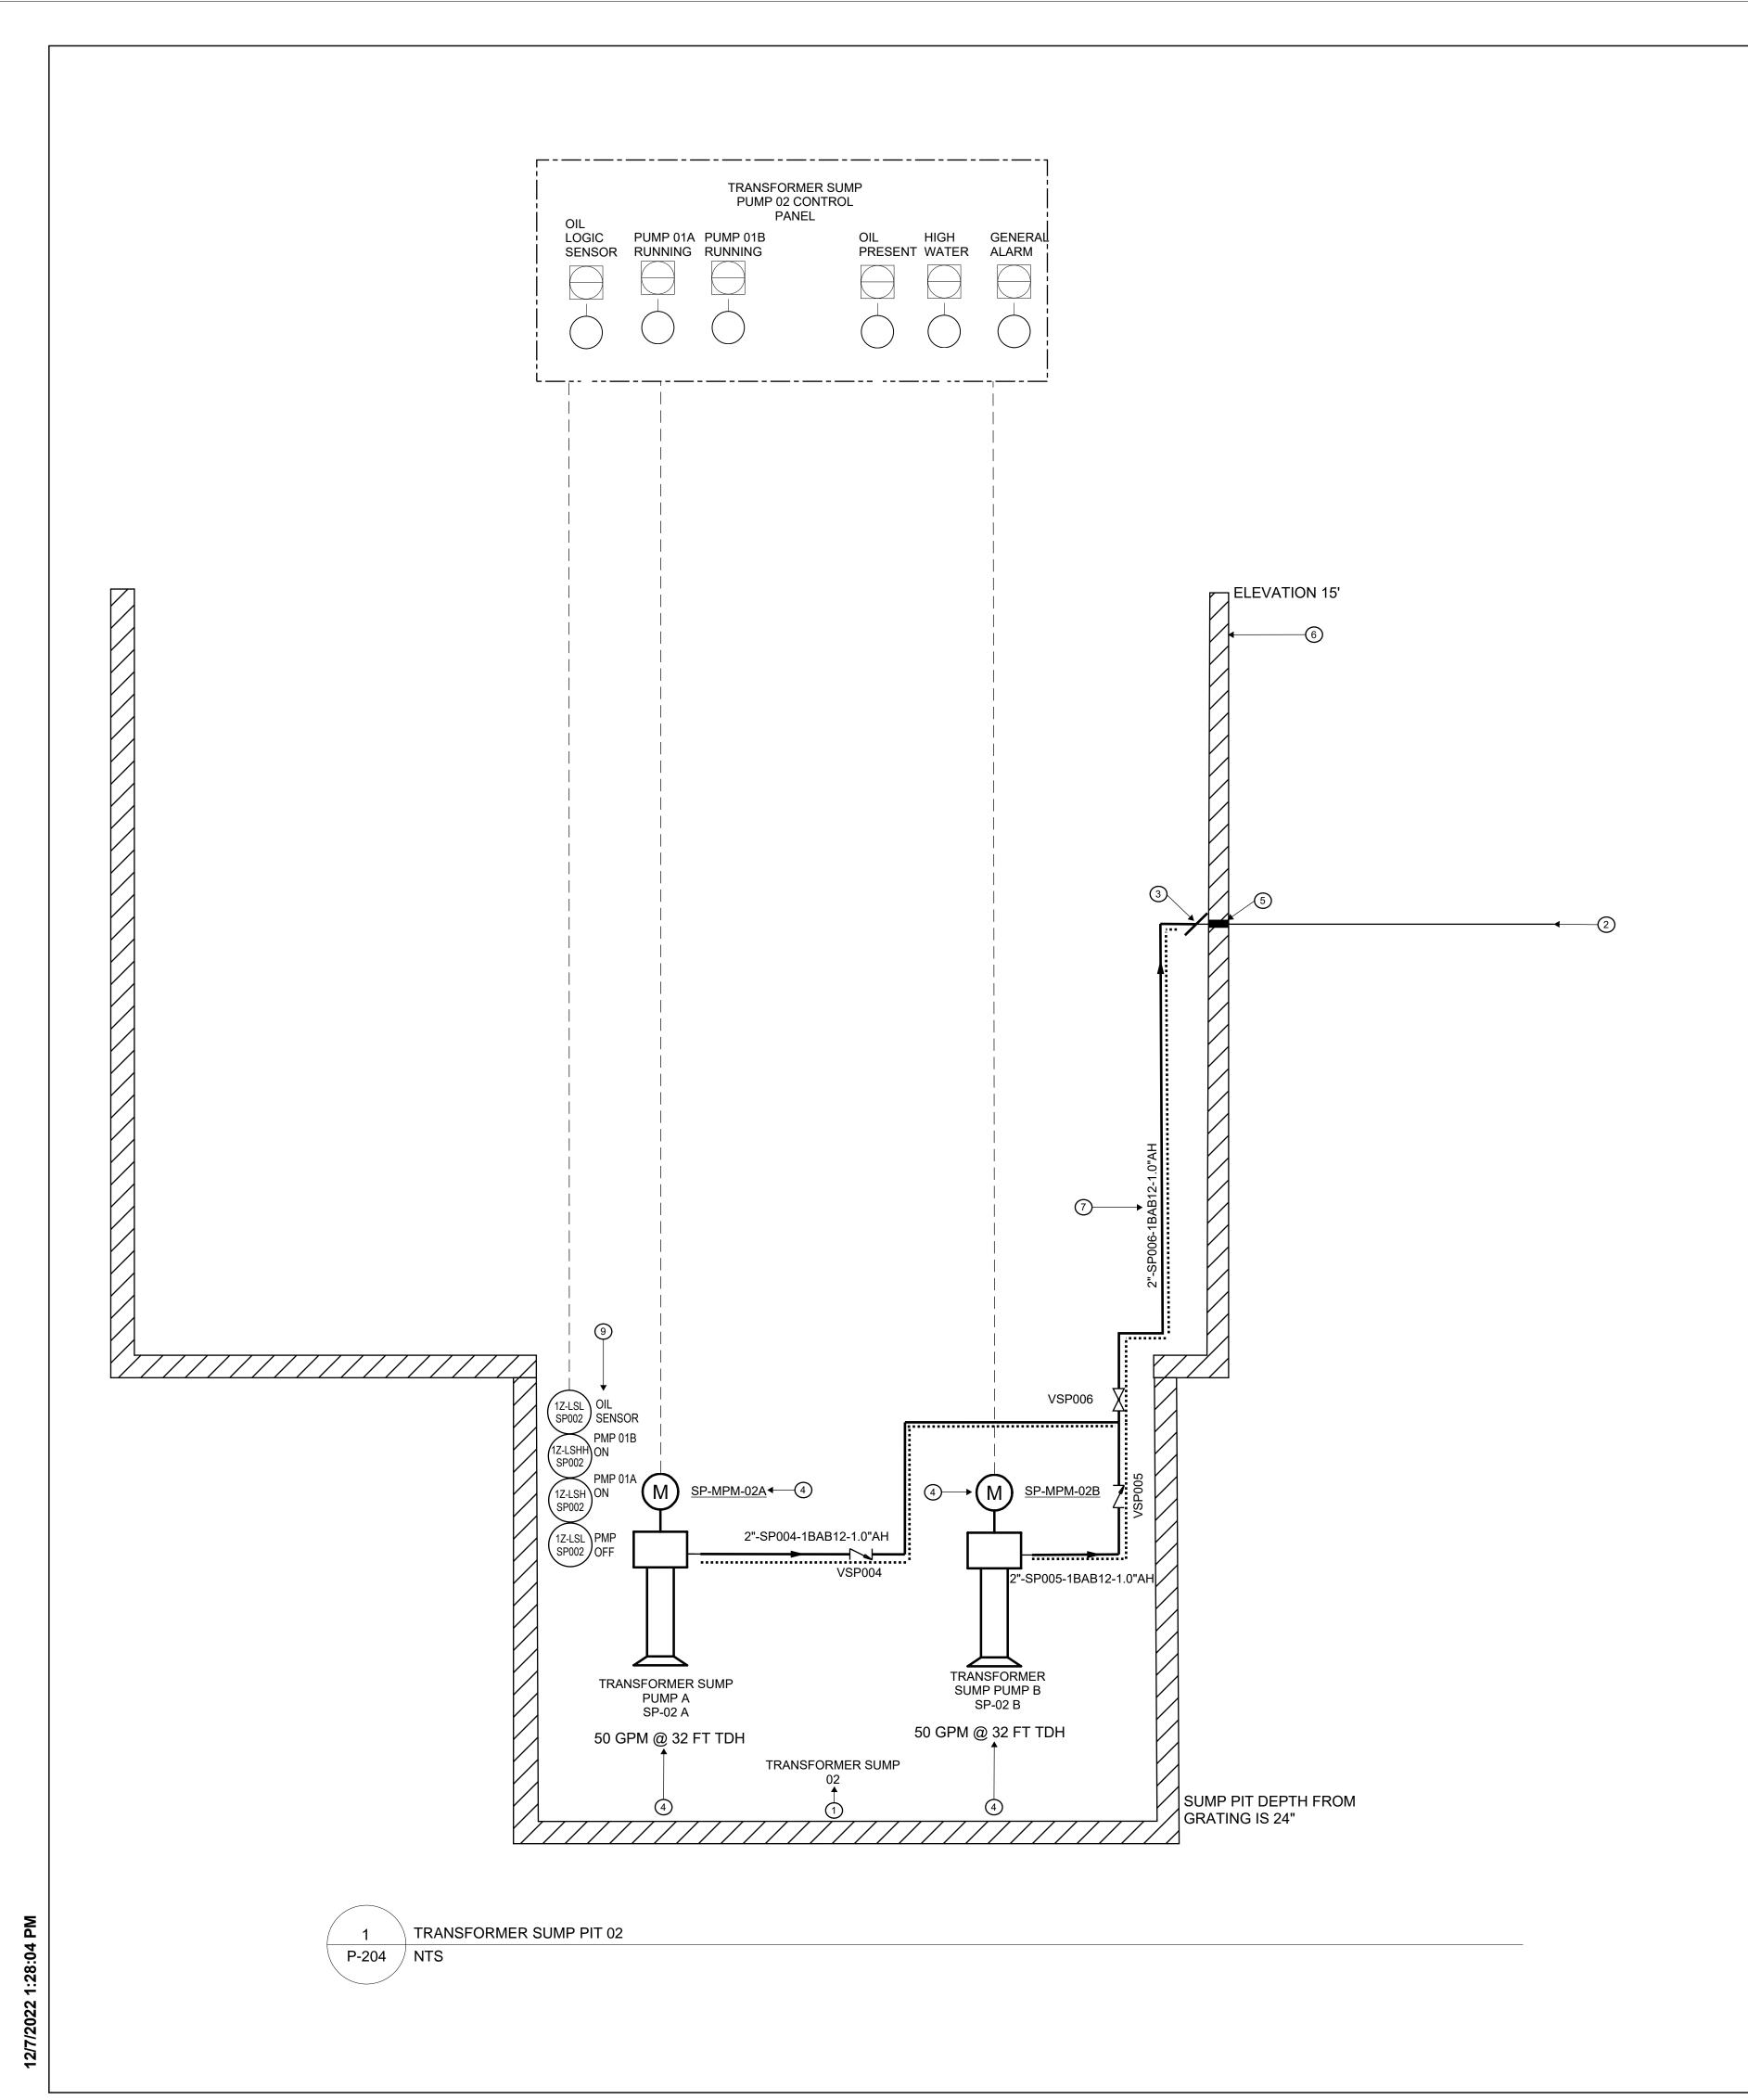


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- REFER TO SHEETS E SERIES FOR BUILDING ELECTRICAL DRAWINGS, NOTES, DETAILS, SCHEDULES AND REQUIREMENTS (FILED UNDER SEPARATE
- REFER TO SHEETS M SERIES FOR HVAC MECHANICAL DRAWINGS, NOTES, DETAILS, SCHEDULES AND REQUIREMENTS (FILED UNDER SEPARATE
- REFER TO SHEETS P SERIES FOR PLUMBING DRAWINGS, NOTES, DETAILS,
- SCHEDULES AND REQUIREMENTS. REFER TO SHEETS S SERIES FOR BUILDING STRUCTURAL DRAWINGS, NOTES, DETAILS, SCHEDULES AND REQUIREMENTS (FILED UNDER SEPARATE
- REFER TO ARCHITECTURAL DRAWINGS FOR ACCESS TO THE SUMP PIT (FILED
- UNDER SEPARATE APPLICATION). REFER TO THE PLUMBING SCHEDULES FOR SUMP PUMP INFORMATION. SEE COUGAR SPARTAN OIL LOGIC CONTROL PANEL SUBMITTAL. PANEL TO BE
- INTEGRATED WITH SITE BMS. REFER TO GENERAL NOTES ON PLUMBING COVER SHEETS FOR ADDITIONAL
- ALL METTALIC PLUMBING AND ACCESSORIES INSTALLED OUTDOORS SHALL BE BONDED TO GROUND. REFER TO ELECTRICAL PLANS AND CONTRACTOR FOR REQUIREMENTS.

PLUMBING KEYNOTES:

REQUIREMENTS OF WORK.

- SECONDARY CONTAINMENT TO SLOPE TOWARDS THE SUMP PIT. FOR CONTAINMENT DETAILS, SEE STRUCTURAL DRAWINGS: (FO-135, FO-136, FO-137
- REFER TO C-301 CIVIL DRAWING FOR PIPING CONTINUATION AND INVERT
- ELEVATION. (FILED UNDER SEPARATE APPLICATION) SUMP PUMP DRAIN PIPE TO BE CONNECTED TO CIVIL PIPE INSIDE THE
- CONTAINMENT PIT. FOR PUMP INFORMATION, REFER TO SUMP PUMP SCHEDULE.
- PIPE SEAL AND PENETRATION SLEEVE TO BE SPECIFIED BY CIVIL AND
- PROVIDED BY CIVIL. (FILED UNDER SEPARATE APPLICATION) PIT ACCESS TO BE PROVIDED AND SHOWN ON STRUCTURAL DRAWINGS. (FILED
- UNDER SEPARATE APPLICATION) SUMP PUMP DISCHARGE PIPING TO BE INSULATED AND HEAT TRACED UP
- UNTIL EXITING OF CONTAINMENT FOR FREEZE PROTECTION. REFER TO ELECTRICAL DRAWINGS FOR CONTROL PANEL AND JUNCTION BOX
- INFORMATION.
- SEE PUMP PLAN (P-200) FOR TRANSFORMER SUMP PUMP DENOTATION. SUMP PUMPS TO BE CONTROL BY FLOATS. THE PUMP OFF AND LOW LEVEL FLOAT WILL BE LOCATED AT THE MINIMUM SUBMERGENCE LEVEL OF THE PUMP. PUMP 01A ON WILL BE 6 INCHES ABOVE THE MINIMUM SUBMERGENCE. PUMP 01B WILL BE 1 FOOT ABOVE THE MINIMUM SUBMERGENCE.

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370 7th Avenue **SUITE 1604** New York, NY 10001

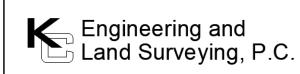

25 Mohawk Avenue **Sparta, NJ 07871**

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В	FINAL SUBMISSION	JH	SD	12-12-22
Α	INTERIM SUBMISSION	JH	SD	09-13-22
REV	DESCRIPTION	DRW BY	CHK BY	DATE



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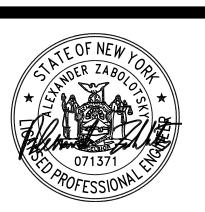
901 Main Campus Drive Raleigh, North Carolina 27606



Astoria HVDC Converter Station


31-45 20th Avenue, Astoria, Queens NY 11105 Block #850 - Lot #310 - BIN #4624437

TRANSFORMER SUMP 02



PROJECT NO CHECKED BY S.DEVADKAR DRAWING NO

P-204.00

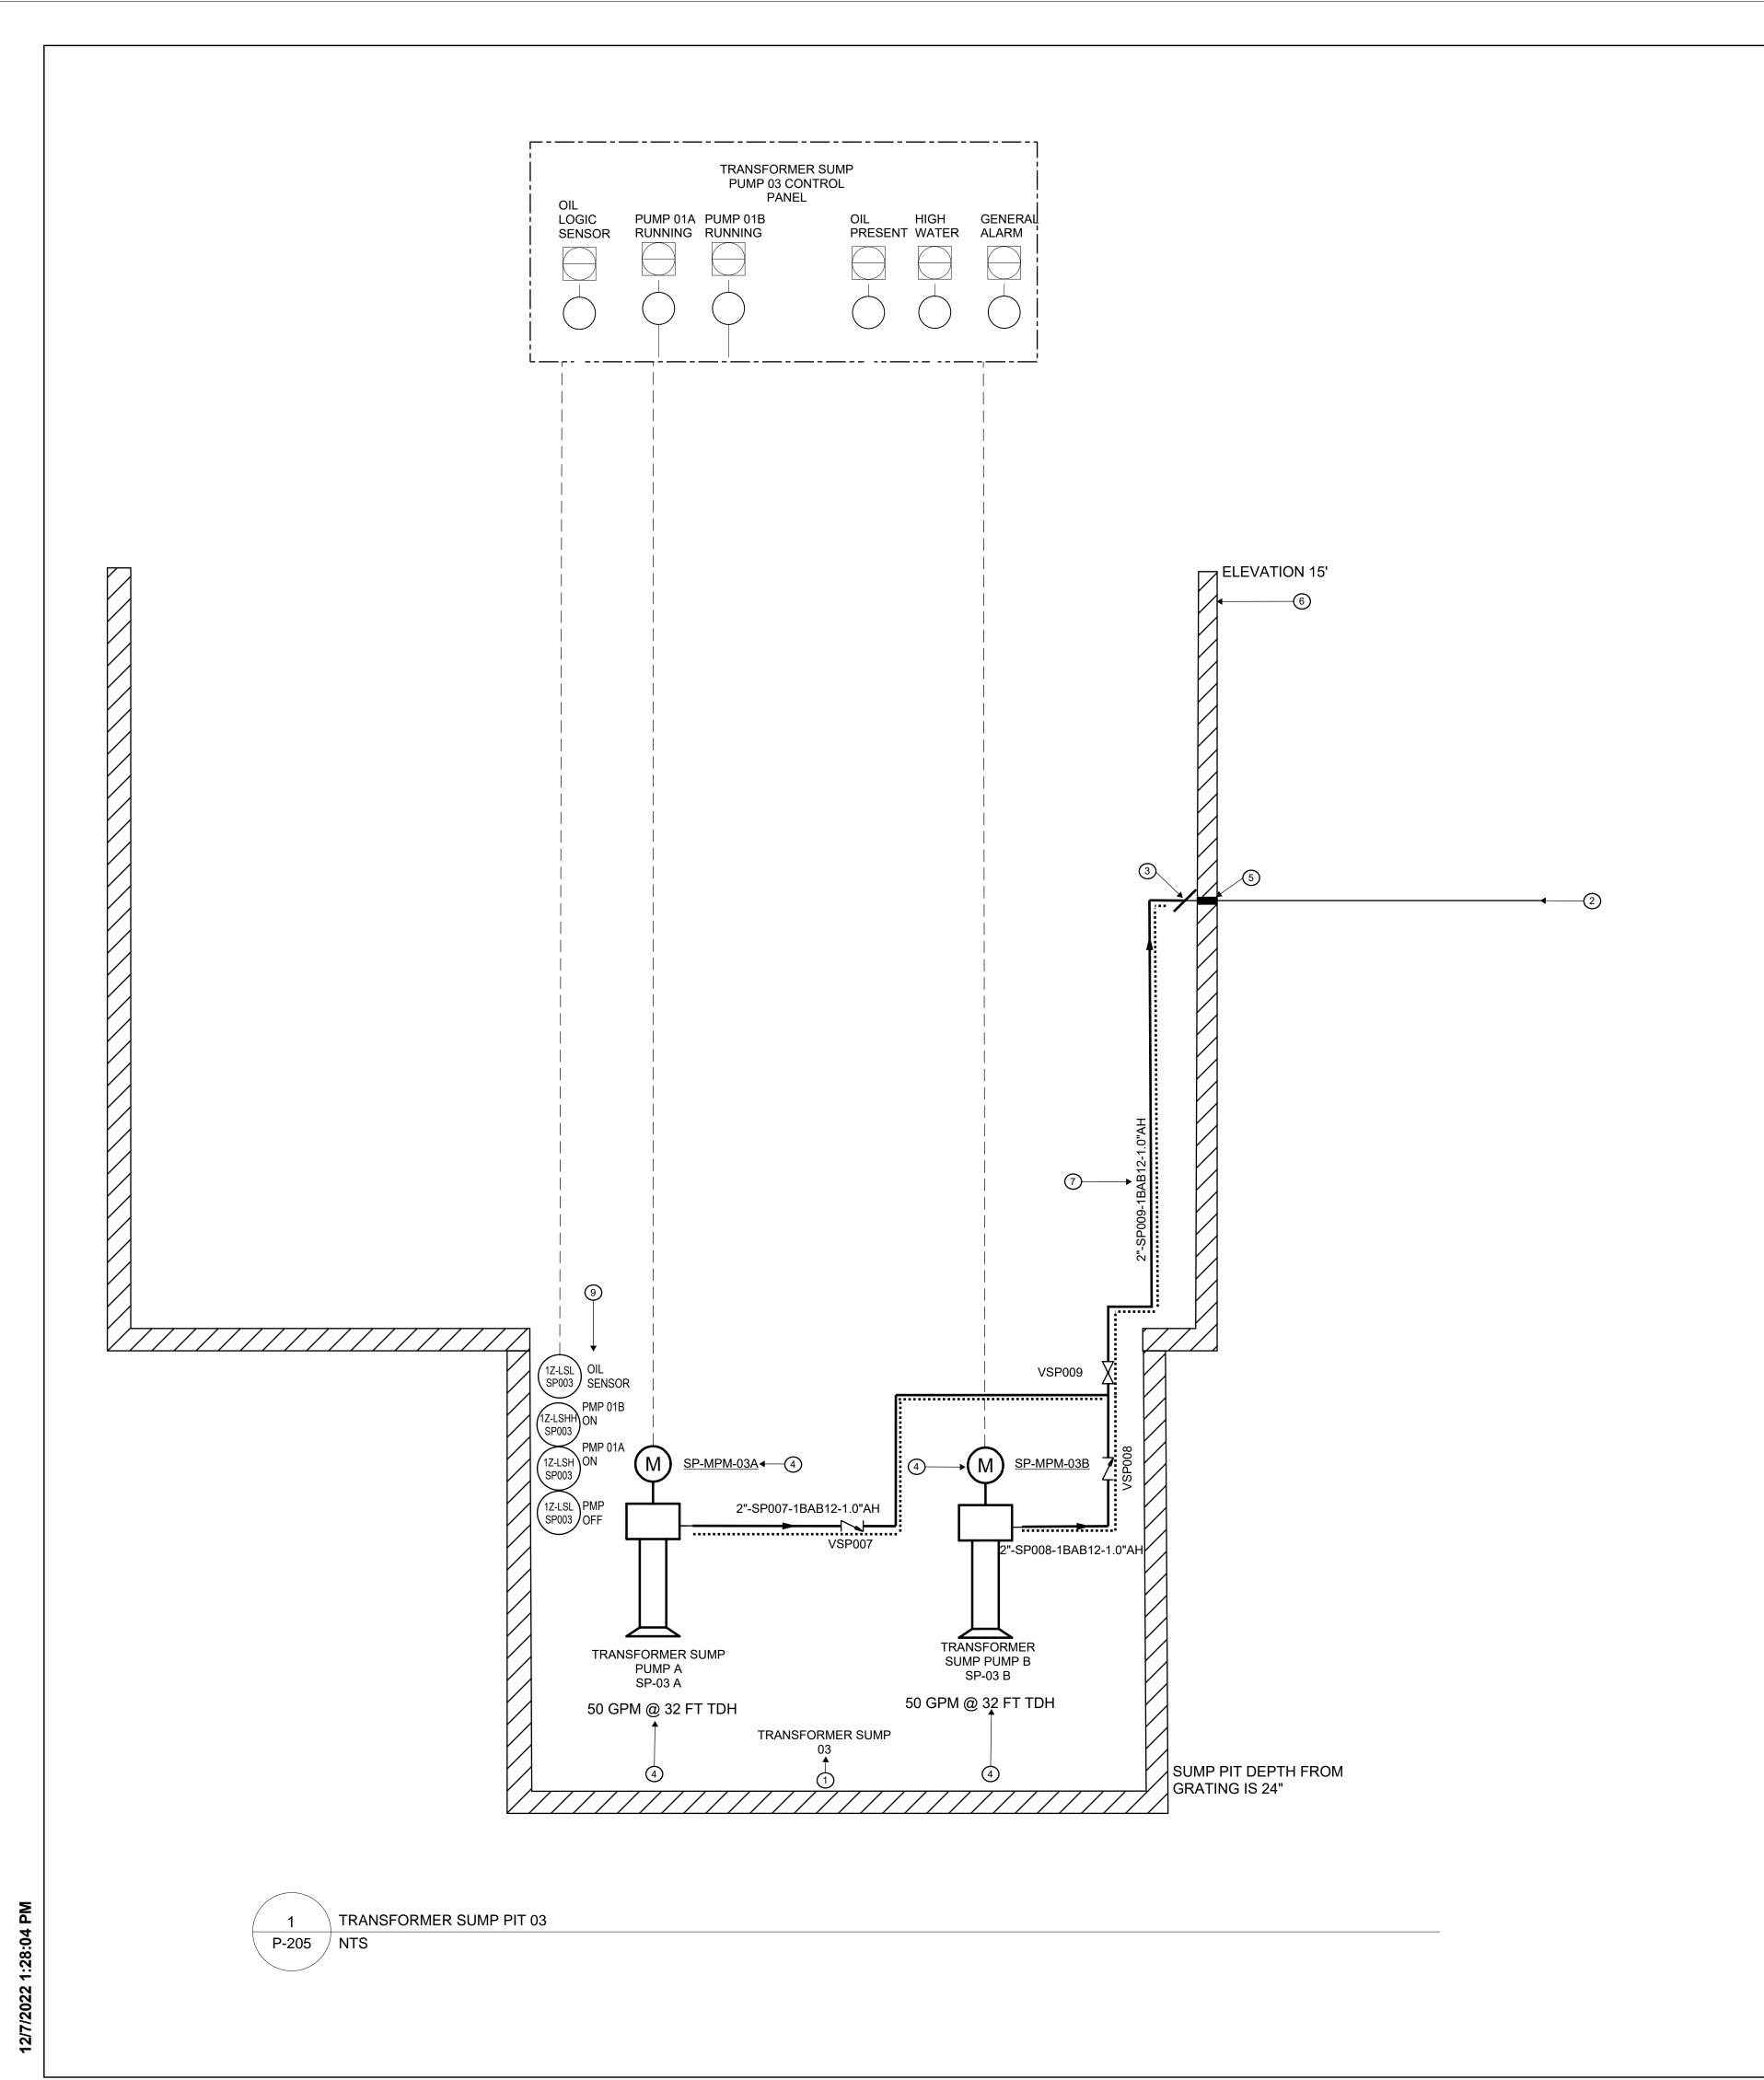

- 1. REFER TO SHEETS A SERIES FOR ARCHITECTURAL DRAWINGS, NOTES, DETAILS, SCHEDULES AND REQUIREMENTS (FILED UNDER SEPARATE APPLICATION).
- 2. REFER TO SHEETS E SERIES FOR BUILDING ELECTRICAL DRAWINGS, NOTES, DETAILS, SCHEDULES AND REQUIREMENTS (FILED UNDER SEPARATE
 - APPLICATION).

 REFER TO SHEETS M SERIES FOR HVAC MECHANICAL DRAWINGS, NOTES,
 DETAILS, SCHEDULES AND REQUIREMENTS (FILED UNDER SEPARATE
 - APPLICATION).

 REFER TO SHEETS P SERIES FOR PLUMBING DRAWINGS, NOTES, DETAILS, SCHEDULES AND REQUIREMENTS.
 - REFER TO SHEETS S SERIES FOR BUILDING STRUCTURAL DRAWINGS, NOTES, DETAILS, SCHEDULES AND REQUIREMENTS (FILED UNDER SEPARATE
- APPLICATION).

 6. REFER TO ARCHITECTURAL DRAWINGS FOR ACCESS TO THE SUMP PIT (FILED UNDER SEPARATE APPLICATION).
- REFER TO THE PLUMBING SCHEDULES FOR SUMP PUMP INFORMATION.
 SEE COUGAR SPARTAN OIL LOGIC CONTROL PANEL SUBMITTAL. PANEL TO BE
- INTEGRATED WITH SITE BMS.
- 9. REFER TO GENERAL NOTES ON PLUMBING COVER SHEETS FOR ADDITIONAL REQUIREMENTS OF WORK.
- 10. ALL METTALIC PLUMBING AND ACCESSORIES INSTALLED OUTDOORS SHALL BE BONDED TO GROUND. REFER TO ELECTRICAL PLANS AND CONTRACTOR FOR REQUIREMENTS.

PLUMBING KEYNOTES:

- 1. SECONDARY CONTAINMENT TO SLOPE TOWARDS THE SUMP PIT. FOR CONTAINMENT DETAILS, SEE STRUCTURAL DRAWINGS: (FO-135, FO-136, FO-137
- REFER TO C-301 CIVIL DRAWING FOR PIPING CONTINUATION AND INVERT
- ELEVATION. (FILED UNDER SEPARATE APPLICATION).

 SUMP PUMP DRAIN PIPE TO BE CONNECTED TO CIVIL PIPE INSIDE THE
- CONTAINMENT PIT.
 4. FOR PUMP INFORMATION, REFER TO SUMP PUMP SCHEDULE.
- 5. PIPE SEAL AND PENETRATION SLEEVE TO BE SPECIFIED BY CIVIL AND
- PROVIDED BY CIVIL. (FILED UNDER SEPARATE APPLICATION).
 6. PIT ACCESS TO BE PROVIDED AND SHOWN ON STRUCTURAL DRAWINGS.
- (FILED UNDER SEPARATE APPLICATION).

 7. SUMP PUMP DISCHARGE PIPING TO BE INSULATED AND HEAT TRACED UP
- UNTIL EXITING OF CONTAINMENT FOR FREEZE PROTECTION. REFER TO ELECTRICAL DRAWINGS FOR CONTROL PANEL AND JUNCTION BOX INFORMATION.
- SEE PUMP PLAN (P-200) FOR TRANSFORMER SUMP PUMP DENOTATION.
 SUMP PUMPS TO BE CONTROL BY FLOATS. THE PUMP OFF AND LOW LEVEL FLOAT WILL BE LOCATED AT THE MINIMUM SUBMERGENCE LEVEL OF THE PUMP. PUMP 01A ON WILL BE 6 INCHES ABOVE THE MINIMUM SUBMERGENCE. PUMP 01B WILL BE 1 FOOT ABOVE THE MINIMUM SUBMERGENCE.





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В	FINAL SUBMISSION	JH	SD	12-12-22
Α	INTERIM SUBMISSION	JH	SD	09-13-22
REV	DESCRIPTION	DRW BY	CHK BY	DATE



901 Main Campus Drive Raleigh, North Carolina 27606

PROJEC



Astoria HVDC Converter Station


31-45 20th Avenue, Astoria, Queens NY 11105 Block #850 - Lot #310 - BIN #4624437

TRANSFORMER SUMP 03



DATE 12/12/2022
PROJECT NO 105121
DRAWING BY J.HUTTON
CHECKED BY S.DEVADKAR
DRAWING NO

P-205.00

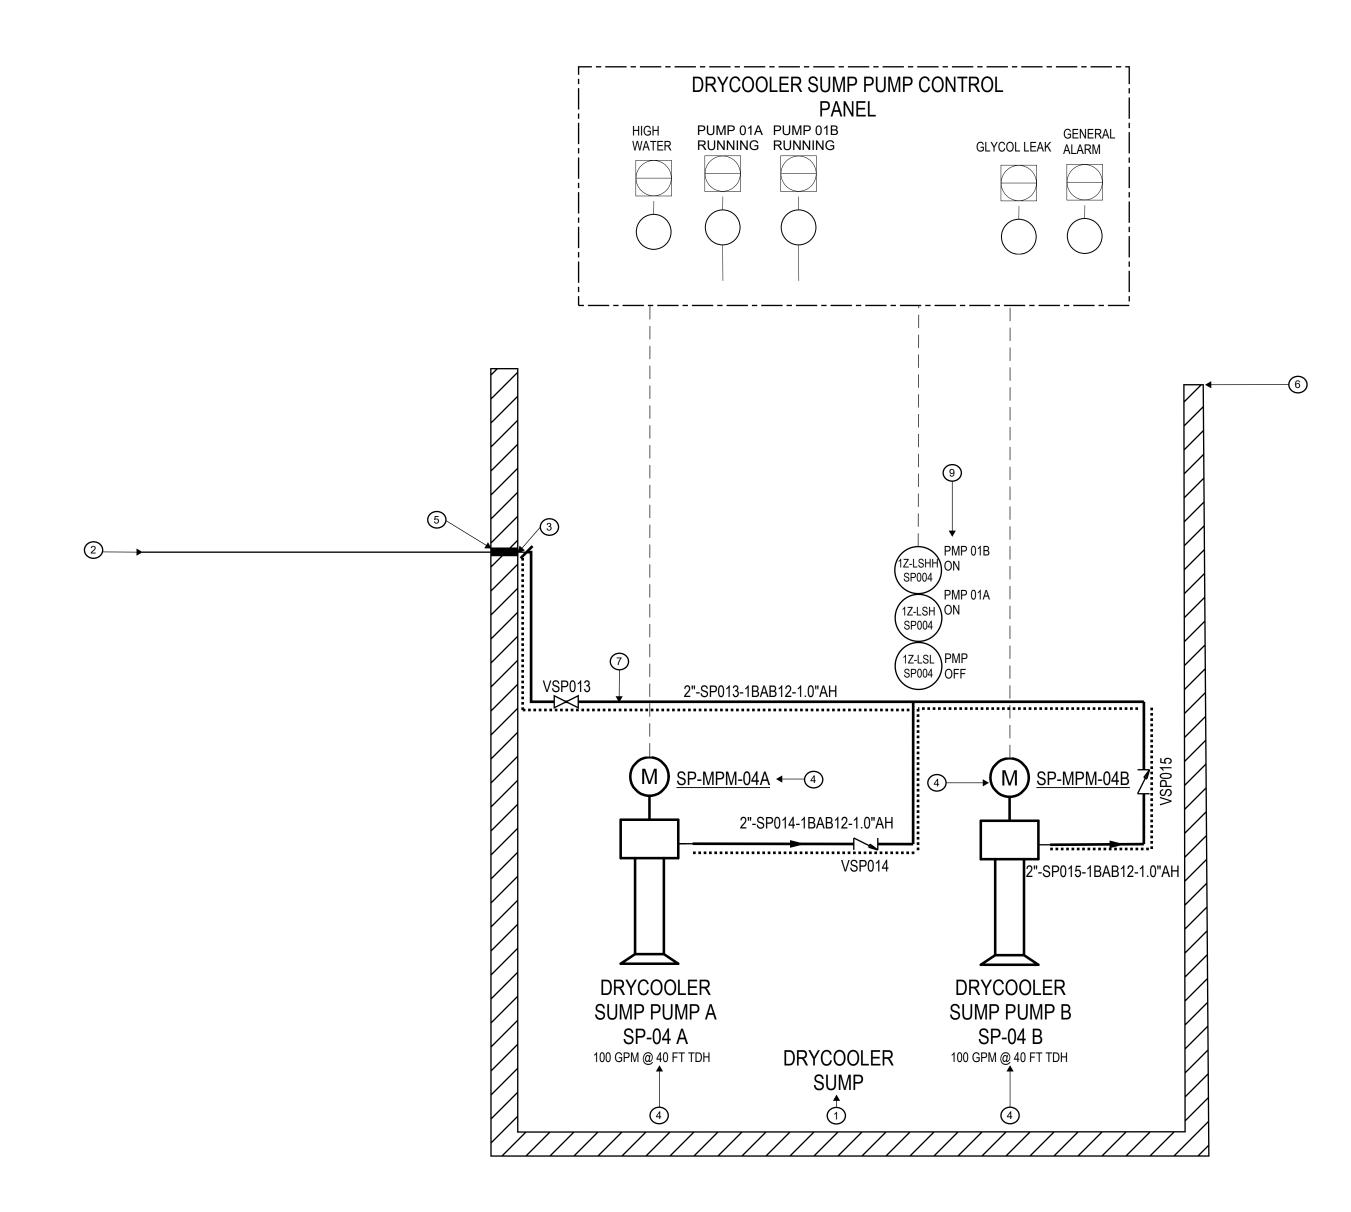

1 DRYCOOLER SUMP PIT
P-206 NTS

SHEET NOTES:

- 1. REFER TO SHEETS A SERIES FOR ARCHITECTURAL DRAWINGS, NOTES, DETAILS, SCHEDULES AND REQUIREMENTS (FILED UNDER SEPARATE APPLICATION).
- 2. REFER TO SHEETS E SERIES FOR BUILDING ELECTRICAL DRAWINGS, NOTES, DETAILS, SCHEDULES AND REQUIREMENTS (FILED UNDER SEPARATE
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- 4. REFER TO SHEETS P SERIES FOR PLUMBING DRAWINGS, NOTES, DETAILS, SCHEDULES AND REQUIREMENTS.
- 5. REFER TO SHEETS S SERIES FOR BUILDING STRUCTURAL DRAWINGS, NOTES, DETAILS, SCHEDULES AND REQUIREMENTS (FILED UNDER SEPARATE APPLICATION).
- . REFER TO ARCHITECTURAL DRAWINGS FOR ACCESS TO THE SUMP PIT (FILED UNDER SEPARATE APPLICATION).
- . REFER TO THE PLUMBING SCHEDULES FOR SUMP PUMP INFORMATION.
 CONTROL PANEL TO BE INTEGRATED WITH SITE BMS.
- . REFER TO GENERAL NOTES ON PLUMBING COVER SHEETS FOR ADDITIONAL REQUIREMENTS OF WORK.
- 10. ALL METTALIC PLUMBING AND ACCESSORIES INSTALLED OUTDOORS SHALL BE BONDED TO GROUND. REFER TO ELECTRICAL PLANS AND CONTRACTOR FOR REQUIREMENTS.

PLUMBING KEYNOTES:

- 1. SECONDARY CONTAINMENT TO SLOPE TOWARDS THE SUMP PIT. FOR CONTAINMENT DETAILS, SEE STRUCTURAL DRAWINGS: (FO-145 & FO-315).
- 2. REFER TO C-301 CIVIL DRAWING FOR PIPING CONTINUATION AND
- INVERT ELEVATION. (FILE UNDER SEPARATE APPLICATION)
 3. SUMP PUMP DRAIN PIPE TO BE CONNECTED TO CIVIL PIPE INSIDE
- THE CONTAINMENT PIT.

 4. FOR PUMP INFORMATION, REFER TO SUMP PUMP SCHEDULE.

 5. DIDE SEAL AND DENETRATION SLEEVE TO BE SPECIFIED BY CIVIL
- 5. PIPE SEAL AND PENETRATION SLEEVE TO BE SPECIFIED BY CIVIL AND PROVIDED BY CIVIL (FILE LINDER SEPARATE APPLICATION)
- AND PROVIDED BY CIVIL. (FILE UNDER SEPARATE APPLICATION)

 6. PIT ACCESS TO BE PROVIDED AND SHOWN ON STRUCTURAL
- DRAWINGS. (FILE UNDER SEPARATE APPLICATION)

 7. SUMP PUMP DISCHARGE PIPING TO BE INSULATED AND HEAT TRACED UP UNTIL EXITING OF CONTAINMENT FOR FREEZE
- PROTECTION.
 8. SUMP PUMP TO BE INTEGRATED WITH BMS. DRYCOOLER SYSTEM
- MUST BE ABLE TO SHUT OFF PUMP IN THE EVENT OF A LEAK.

 9. SUMP PUMPS TO BE CONTROL BY FLOATS. THE PUMP OFF AND LOW LEVEL FLOAT WILL BE LOCATED AT THE MINIMUM SUBMERGENCE LEVEL OF THE PUMP. PUMP 01A ON WILL BE 1 FOOT ABOVE THE MINIMUM SUBMERGENCE. PUMP 01B WILL BE 1 FOOT ABOVE THE MINIMUM SUBMERGENCE.





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25 Mohawk Avenue Sparta, NJ 07871

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В	FINAL SUBMISSION	JH	SD	12-12-22
A	INTERIM SUBMISSION	JH	SD	09-13-22
REV	DESCRIPTION	DRW BY	CHK BY	DATE



901 Main Campus Drive Raleigh, North Carolina 27606

PROJECT



Astoria HVDC Converter Station


31-45 20th Avenue, Astoria, Queens NY 11105 Block #850 - Lot #310 - BIN #4624437

DRYCOOLER SUMP



DATE 12/12/2022
PROJECT NO 105121
DRAWING BY J.HUTTON
CHECKED BY S.DEVADKAR
DRAWING NO

P-206.00

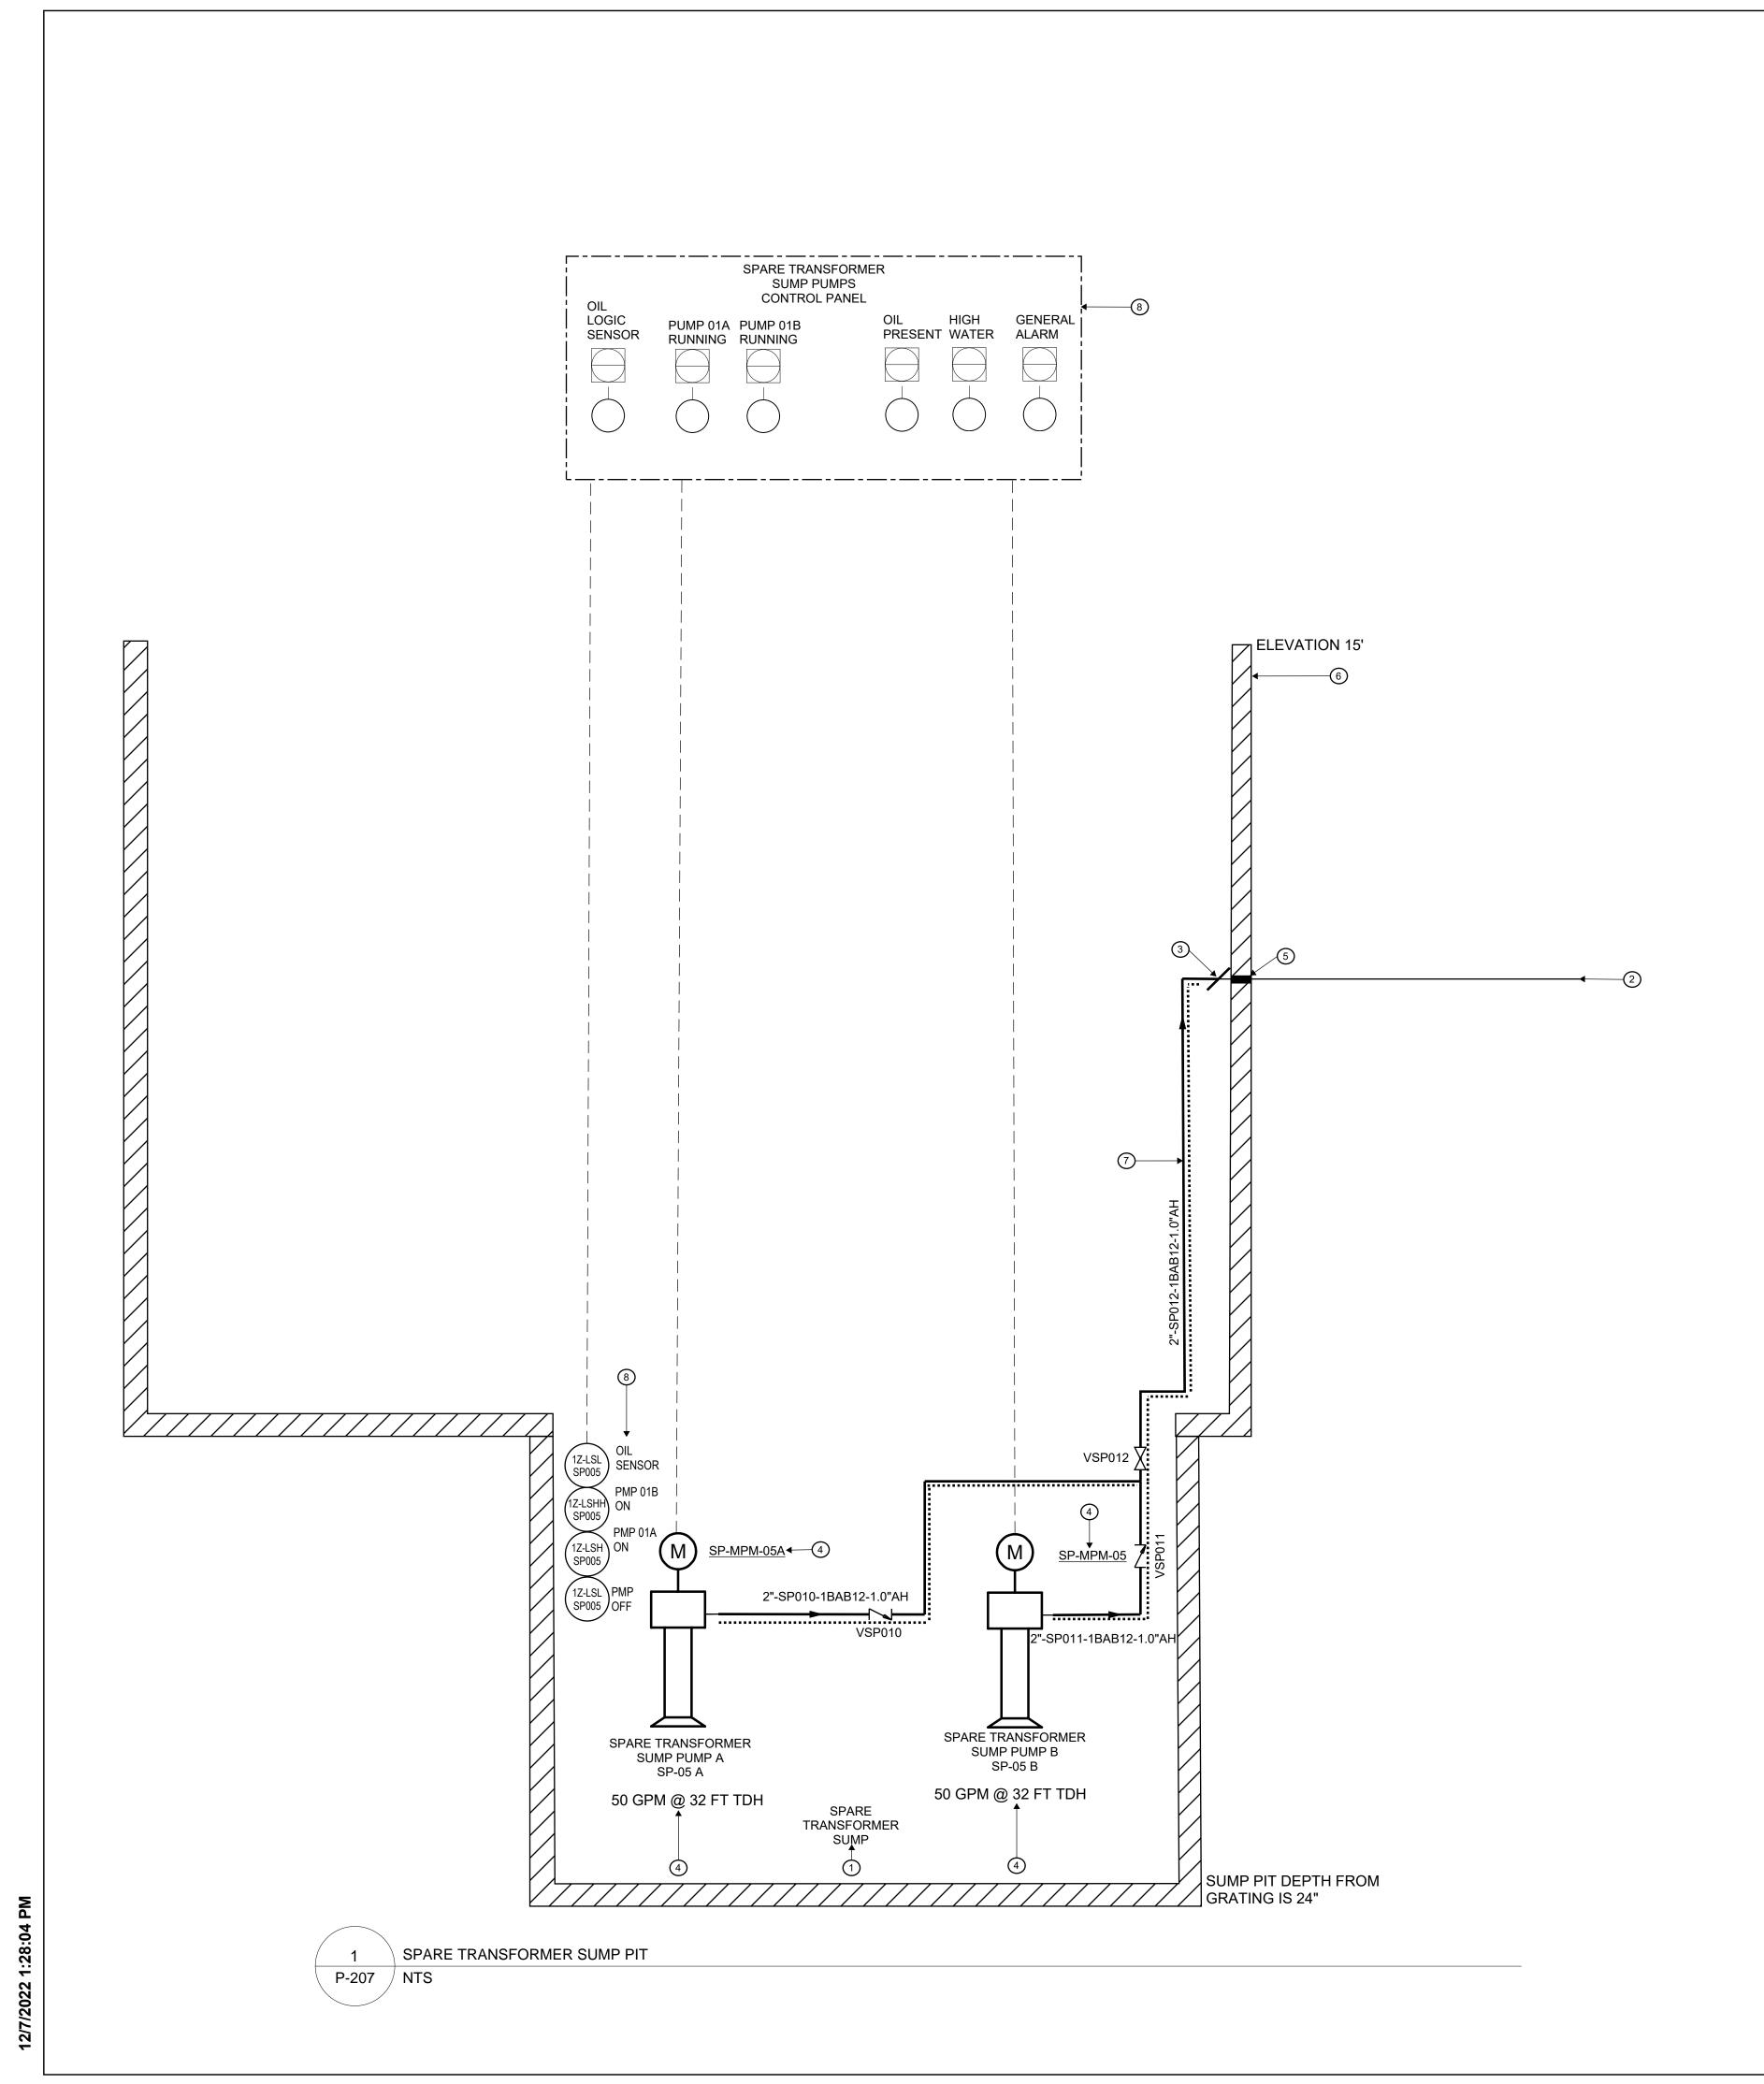

- . REFER TO SHEETS A SERIES FOR ARCHITECTURAL DRAWINGS, NOTES, DETAILS, SCHEDULES AND REQUIREMENTS (FILED UNDER SEPARATE APPLICATION).
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- REFER TO ARCHITECTURAL DRAWINGS FOR ACCESS TO THE SUMP PIT (FILED UNDER SEPARATE APPLICATION).
- 7. REFER TO THE PLUMBING SCHEDULES FOR SUMP PUMP INFORMATION. 3. SEE COUGAR SPARTAN OIL LOGIC CONTROL PANEL SUBMITTAL. PANEL TO BE
- INTEGRATED WITH SITE BMS.

 REFER TO GENERAL NOTES ON PLUMBING COVER SHEETS FOR ADDITIONAL
- REQUIREMENTS OF WORK.

 O. ALL METTALIC PLUMBING AND ACCESSORIES INSTALLED OUTDOORS SHALL BE BONDED TO GROUND. REFER TO ELECTRICAL PLANS AND CONTRACTOR FOR REQUIREMENTS.

PLUMBING KEYNOTES:

- 1. SECONDARY CONTAINMENT TO SLOPE TOWARDS THE SUMP PIT. FOR CONTAINMENT DETAILS, SEE STRUCTURAL DRAWINGS:
- (FO-175 & FO-320).2. REFER TO C-301 CIVIL DRAWING FOR PIPING CONTINUATION AND
- INVERT ELEVATION. (FILE UNDER SEPARATE APPLICATION)
 3. SUMP PUMP DRAIN PIPE TO BE CONNECTED TO CIVIL PIPE INSIDE
- THE CONTAINMENT PIT.
- FOR PUMP INFORMATION, REFER TO SUMP PUMP SCHEDULE.

 PIPE SEAL AND PENETRATION SLEEVE TO BE SPECIFIED BY CIVIL
- AND PROVIDED BY CIVIL. (FILE UNDER SEPARATE APPLICATION)
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- 7. SUMP PUMP DISCHARGE PIPING TO BE INSULATED AND HEAT TRACED UP UNTIL EXITING OF CONTAINMENT FOR FREEZE
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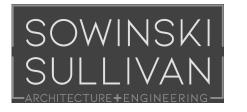
 8. SUMP PUMPS TO BE CONTROL BY FLOATS. THE PUMP OFF AND LOW LEVEL FLOAT WILL BE LOCATED AT THE MINIMUM

LOW LEVEL FLOAT WILL BE LOCATED AT THE MINIMUM SUBMERGENCE LEVEL OF THE PUMP. PUMP 01A ON WILL BE 6 INCHES ABOVE THE MINIMUM SUBMERGENCE. PUMP 01B WILL BE 1 FOOT ABOVE THE MINIMUM SUBMERGENCE.

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В	FINAL SUBMISSION	JH	SD	12-12-22
Α	INTERIM SUBMISSION	JH	SD	09-13-22
REV	DESCRIPTION	DRW BY	CHK BY	DATE



901 Main Campus Drive Raleigh, North Carolina 27606

PROJECT



Astoria HVDC Converter Station

31-45 20th Avenue, Astoria, Queens NY 11105 Block #850 - Lot #310 - BIN #4624437

SPARE TRANSFORMER SUMP



DATE 12/12/2022
PROJECT NO 105121
DRAWING BY W.PENDLETON
CHECKED BY J.HUTTON
DRAWING NO

P-207.00

AUXILIARY TRANSFORMER SUMP PIT 01

P-208 / NTS

SHEET NOTES:

REFER TO SHEETS A SERIES FOR ARCHITECTURAL DRAWINGS, NOTES, DETAILS,

SCHEDULES AND REQUIREMENTS (FILED UNDER SEPARATE APPLICATION). REFER TO SHEETS E SERIES FOR BUILDING ELECTRICAL DRAWINGS, NOTES, DETAILS, SCHEDULES AND REQUIREMENTS (FILED UNDER SEPARATE

APPLICATION). REFER TO SHEETS M SERIES FOR HVAC MECHANICAL DRAWINGS, NOTES, DETAILS, SCHEDULES AND REQUIREMENTS (FILED UNDER SEPARATE

APPLICATION). REFER TO SHEETS P SERIES FOR PLUMBING DRAWINGS, NOTES, DETAILS,

SCHEDULES AND REQUIREMENTS.

REFER TO SHEETS S SERIES FOR BUILDING STRUCTURAL DRAWINGS, NOTES, DETAILS, SCHEDULES AND REQUIREMENTS (FILED UNDER SEPARATE APPLICATION).

REFER TO ARCHITECTURAL DRAWINGS FOR ACCESS TO THE SUMP PIT (FILED UNDER SEPARATE APPLICATION).

REFER TO THE PLUMBING SCHEDULES FOR SUMP PUMP INFORMATION. SEE COUGAR SPARTAN OIL LOGIC CONTROL PANEL SUBMITTAL. PANEL TO BE

INTEGRATED WITH SITE BMS. REFER TO GENERAL NOTES ON PLUMBING COVER SHEETS FOR ADDITIONAL

REQUIREMENTS OF WORK. ALL METTALIC PLUMBING AND ACCESSORIES INSTALLED OUTDOORS SHALL BE BONDED TO GROUND. REFER TO ELECTRICAL PLANS AND CONTRACTOR FOR REQUIREMENTS.

PLUMBING KEYNOTES:

SECONDARY CONTAINMENT TO SLOPE TOWARDS THE SUMP PIT. FOR CONTAINMENT DETAILS, SEE STRUCTURAL DRAWINGS:

(FO-180 & FO-335). REFER TO C-301 CIVIL DRAWING FOR PIPING CONTINUATION AND

INVERT ELEVATION. (FILE UNDER SEPARATE APPLICATION) SUMP PUMP DRAIN PIPE TO BE CONNECTED TO CIVIL PIPE INSIDE

THE CONTAINMENT PIT. FOR PUMP INFORMATION, REFER TO SUMP PUMP SCHEDULE.

PIPE SEAL AND PENETRATION SLEEVE TO BE SPECIFIED BY CIVIL AND PROVIDED BY CIVIL. (FILE UNDER SEPARATE APPLICATION)

PIT ACCESS TO BE PROVIDED AND SHOWN ON STRUCTURAL DRAWINGS. (FILE UNDER SEPARATE APPLICATION)

SUMP PUMP DISCHARGE PIPING TO BE INSULATED AND HEAT TRACED UP UNTIL EXITING OF CONTAINMENT FOR FREEZE

PROTECTION.

SUMP PUMPS TO BE CONTROL BY FLOATS. THE PUMP OFF AND LOW LEVEL FLOAT WILL BE LOCATED AT THE MINIMUM SUBMERGENCE LEVEL OF THE PUMP. PUMP 01A ON WILL BE 6 INCHES ABOVE THE MINIMUM SUBMERGENCE. PUMP 01B WILL BE 1 FOOT ABOVE THE MINIMUM SUBMERGENCE.

ISSUED FOR PERMIT



370 7th Avenue **SUITE 1604** New York, NY 10001



25 Mohawk Avenue **Sparta, NJ 07871**

CONFIDENTIAL

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В	FINAL SUBMISSION	JH	SD	12-12-22
Α	INTERIM SUBMISSION	JH	SD	09-13-22
REV	DESCRIPTION	DRW BY	CHK BY	DATE



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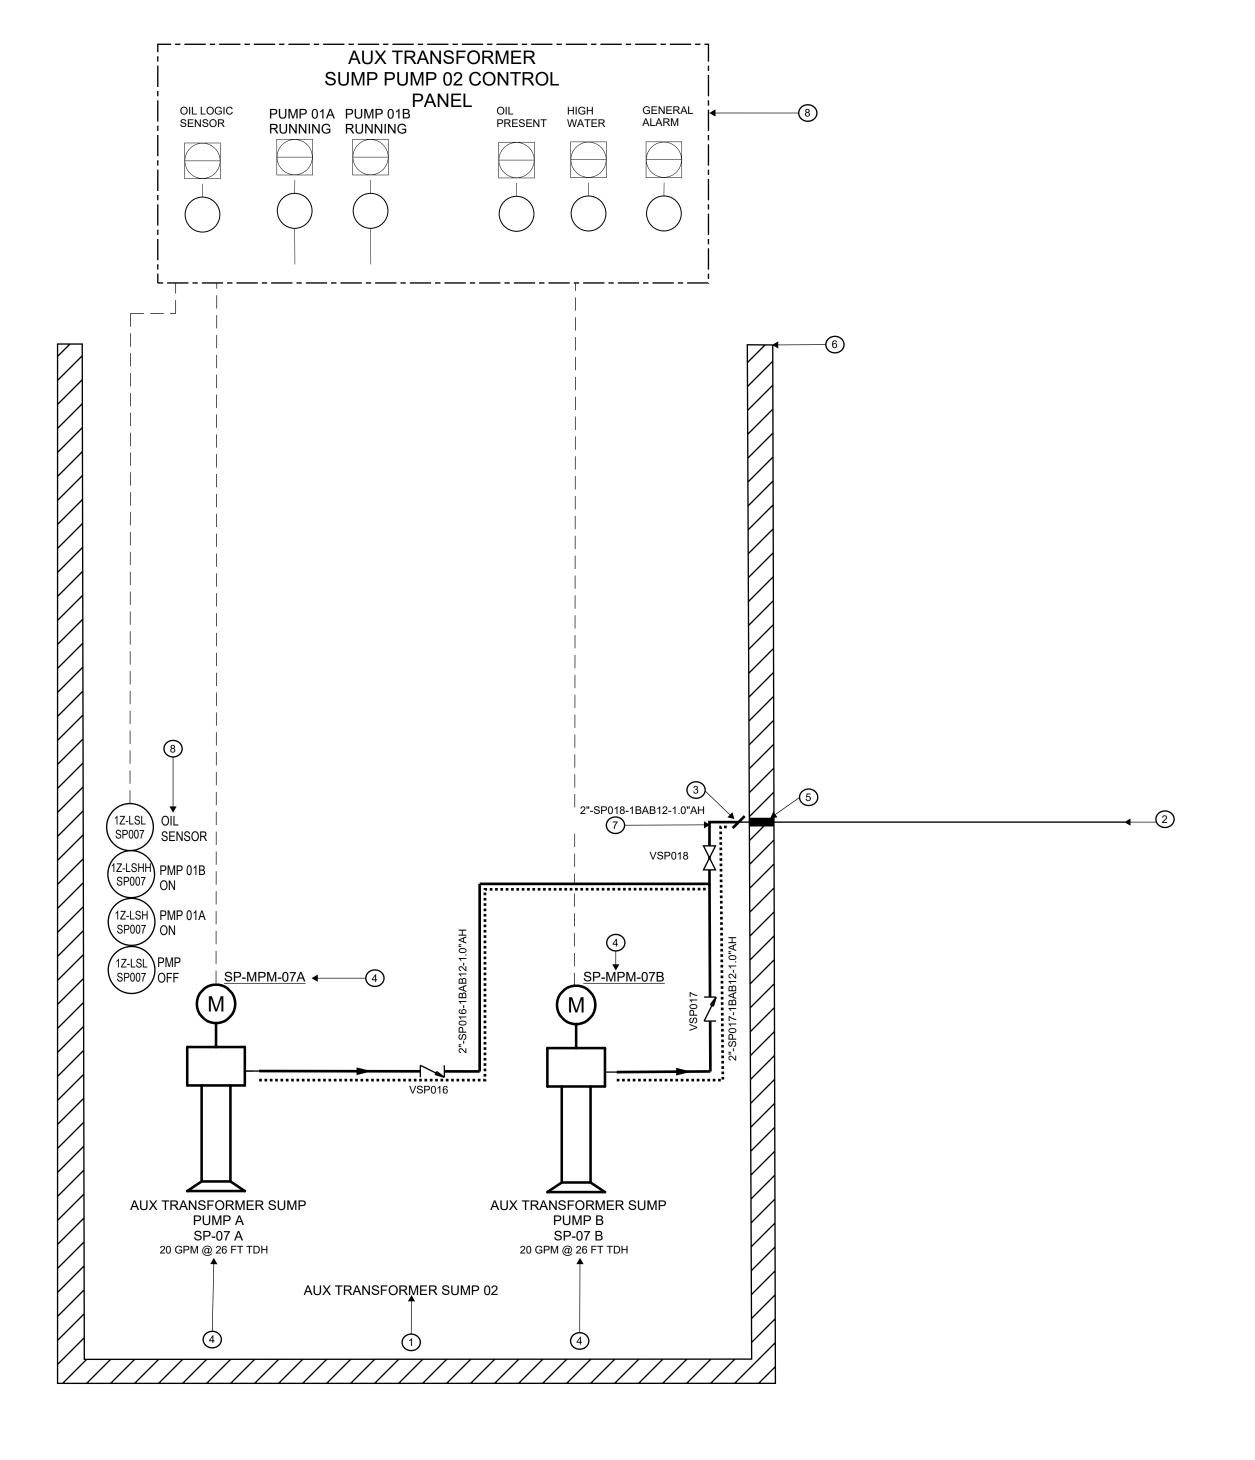
Astoria HVDC Converter Station

31-45 20th Avenue, Astoria, Queens NY 11105 Block #850 - Lot #310 - BIN #4624437

AUXILIARY TRANSFORMER SUMP 01



PROJECT NO CHECKED BY S.DEVADKAR DRAWING NO



1 AUXILIARY TRANSFORMER SUMP PIT 02

P-209 / NTS

SHEET NOTES:

1. REFER TO SHEETS A SERIES FOR ARCHITECTURAL DRAWINGS, NOTES, DETAILS,

- SCHEDULES AND REQUIREMENTS (FILED UNDER SEPARATE APPLICATION).

 2. REFER TO SHEETS E SERIES FOR BUILDING ELECTRICAL DRAWINGS, NOTES, DETAILS, SCHEDULES AND REQUIREMENTS (FILED UNDER SEPARATE
- 3. REFER TO SHEETS M SERIES FOR HVAC MECHANICAL DRAWINGS, NOTES, DETAILS, SCHEDULES AND REQUIREMENTS (FILED UNDER SEPARATE APPLICATION).
- 4. REFER TO SHEETS P SERIES FOR PLUMBING DRAWINGS, NOTES, DETAILS, SCHEDULES AND REQUIREMENTS.
- 5. REFER TO SHEETS S SERIES FOR BUILDING STRUCTURAL DRAWINGS, NOTES, DETAILS, SCHEDULES AND REQUIREMENTS (FILED UNDER SEPARATE APPLICATION).
- 6. REFER TO ARCHITECTURAL DRAWINGS FOR ACCESS TO THE SUMP PIT (FILED UNDER SEPARATE APPLICATION).
- UNDER SEPARATE APPLICATION).

 7. REFER TO THE PLUMBING SCHEDULES FOR SUMP PUMP INFORMATION.

 8. SEE COUGAR SPARTAN OIL LOGIC CONTROL PANEL SUBMITTAL. PANEL TO BE
- INTEGRATED WITH SITE BMS.

 9. REFER TO GENERAL NOTES ON PLUMBING COVER SHEETS FOR ADDITIONAL REQUIREMENTS OF WORK.
- 10. ALL METTALIC PLUMBING AND ACCESSORIES INSTALLED OUTDOORS SHALL BE BONDED TO GROUND. REFER TO ELECTRICAL PLANS AND CONTRACTOR FOR REQUIREMENTS.

PLUMBING KEYNOTES:

- 1. SECONDARY CONTAINMENT TO SLOPE TOWARDS THE SUMP PIT. FOR CONTAINMENT DETAILS, SEE STRUCTURAL DRAWINGS: (FO-180 & FO-335).
- (FO-180 & FO-335).

 REFER TO C-301 CIVIL DRAWING FOR PIPING CONTINUATION AND INVERT ELEVATION. (FILE UNDER SEPARATE APPLICATION)
- 3. SUMP PUMP DRAIN PIPE TO BE CONNECTED TO CIVIL PIPE INSIDE THE CONTAINMENT PIT.
- FOR PUMP INFORMATION, REFER TO SUMP PUMP SCHEDULE.
 PIPE SEAL AND PENETRATION SLEEVE TO BE SPECIFIED BY CIVIL
- AND PROVIDED BY CIVIL. (FILE UNDER SEPARATE APPLICATION)
 PIT ACCESS TO BE PROVIDED AND SHOWN ON STRUCTURAL
- DRAWINGS. (FILE UNDER SEPARATE APPLICATION)

 7. SUMP PUMP DISCHARGE PIPING TO BE INSULATED AND HEAT

 TRACED UP LINE IN THE CONTAINMENT FOR EDEFAR.
- TRACED UP UNTIL EXITING OF CONTAINMENT FOR FREEZE PROTECTION.
- SUMP PUMPS TO BE CONTROL BY FLOATS. THE PUMP OFF AND LOW LEVEL FLOAT WILL BE LOCATED AT THE MINIMUM SUBMERGENCE LEVEL OF THE PUMP. PUMP 01A ON WILL BE 1 FOOT ABOVE THE MINIMUM SUBMERGENCE.

ISSUED FOR PERMIT



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25 Mohawk Avenue Sparta, NJ 07871

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В	FINAL SUBMISSION	JH	SD	12-12-22
Α	INTERIM SUBMISSION	JH	SD	09-13-22
REV	DESCRIPTION	DRW BY	CHK BY	DATE



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901 Main Campus Drive Raleigh, North Carolina 27606

PROJECT



Astoria HVDC Converter Station


31-45 20th Avenue, Astoria, Queens NY 11105 Block #850 - Lot #310 - BIN #4624437

AUXILIARY TRANSFORMER SUMP 02



1	
DATE	12/12/2022
PROJECT NO	105121
DRAWING BY	J.HUTTON
CHECKED BY	S.DEVADKAR
DRAWING NO	

P-209.00

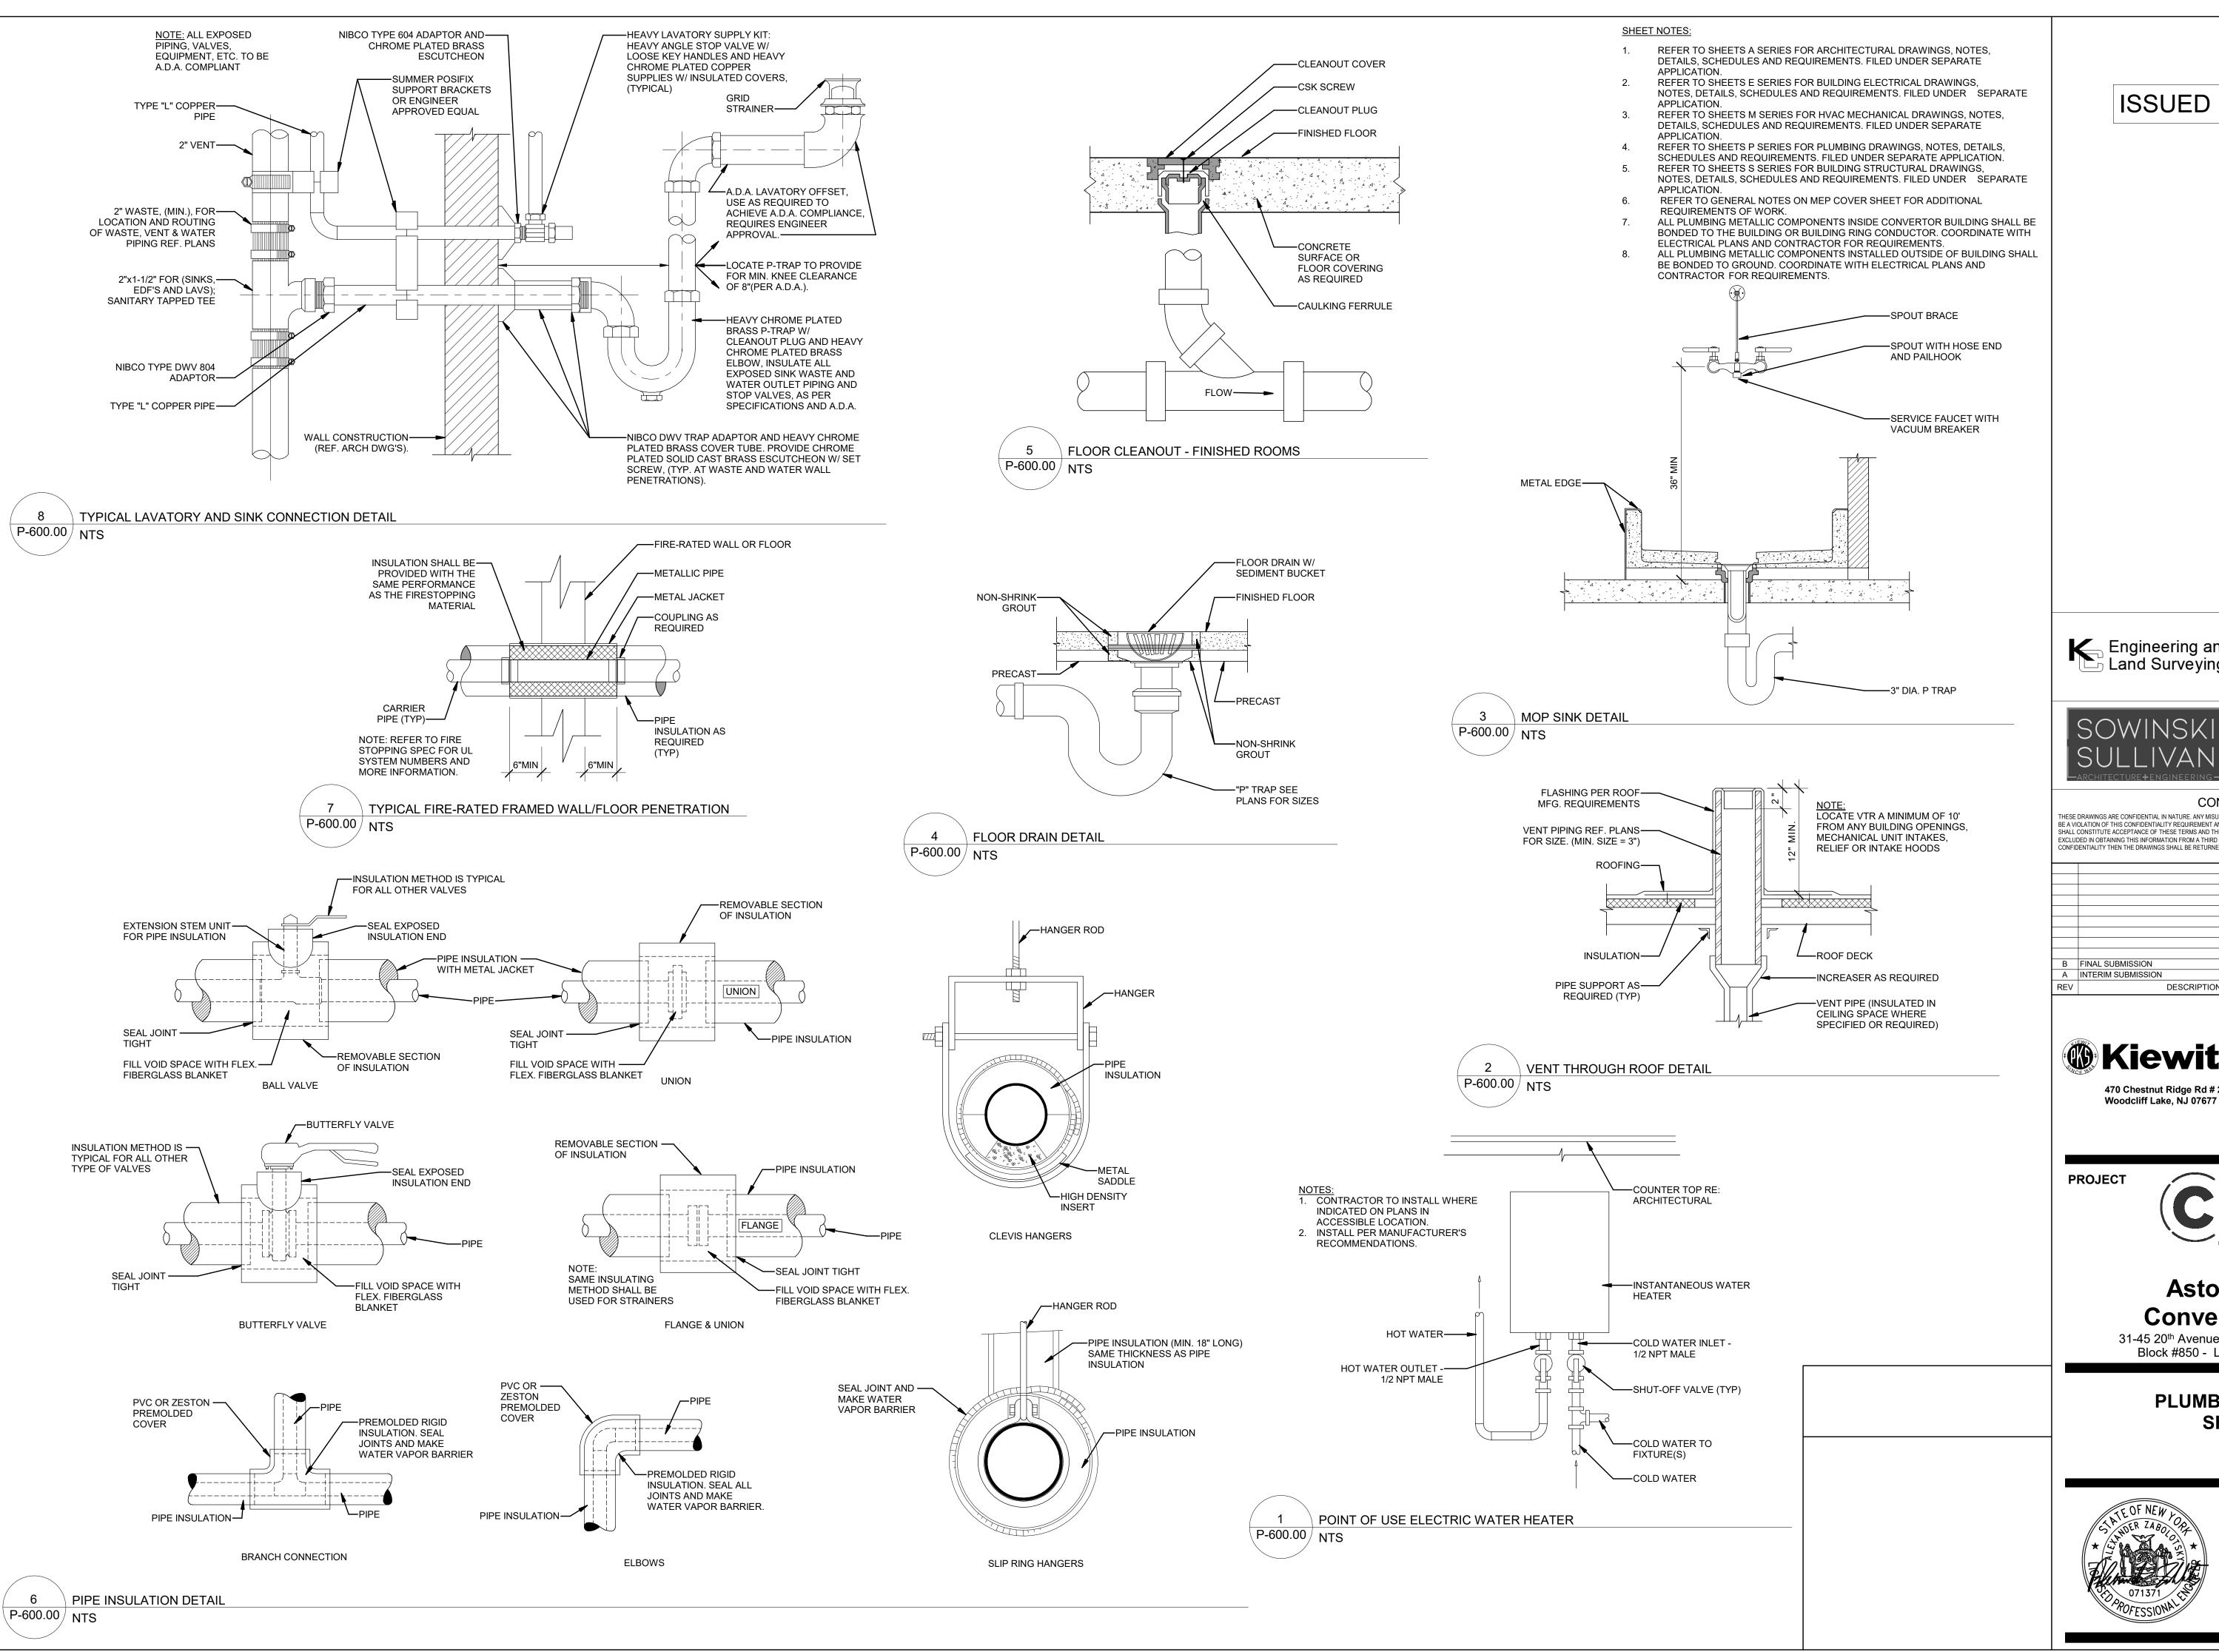





370 7th Avenue **SUITE 1604** New York, NY 10001



25 Mohawk Avenue **Sparta, NJ 07871**

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В	FINAL SUBMISSION	WP	SD	12-12-22
Α	INTERIM SUBMISSION	WP	AZ	09-13-22
REV	DESCRIPTION	DRW BY	CHK BY	DATE

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Raleigh, North Carolina 27606



Astoria HVDC Converter Station

31-45 20th Avenue, Astoria, Queens NY 11105 Block #850 - Lot #310 - BIN #4624437


PLUMBING DETAILS SHEET #1



12/12/2022 PROJECT NO W.PENDLETON CHECKED BY S.DEVADKAR DRAWING NO

DETAILS SHOWN ON THIS DRAWING ARE TO BE USED AS A GUIDE FOR THE SUPPORT OF MECHANICAL EQUIPMENT, PIPING, DUCTWORK, ETC. PROVIDE SEISMIC CALCULATIONS, SIGNED AND SEALED BY A LICENSED PROFESSIONAL ENGINEER WITH A MINIMUM OF FIVE YEARS EXPERIENCE IN SEISMIC DESIGN AND MUST HAVE SEISMIC INSURANCE.


SINGLE ARM BRACE FOR TRAPEZE HUNG PLUMBING PIPING P-601.00 NTS

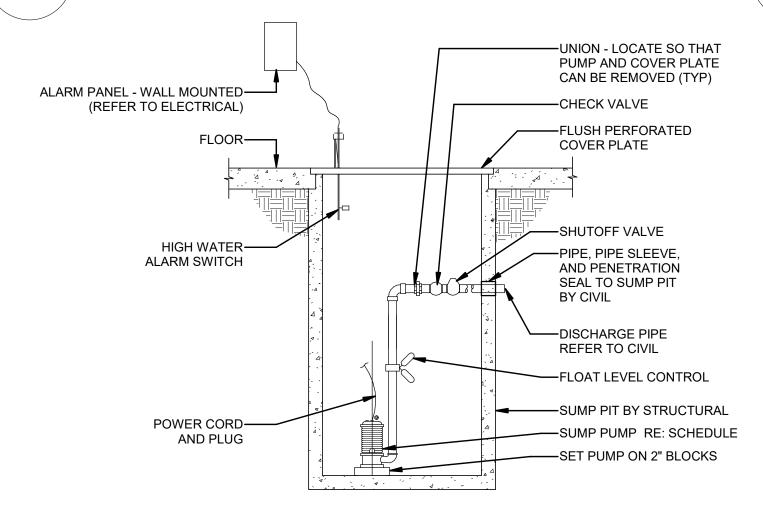



- NOTES:

 1. LEVEL CONTROL IS TYPICALLY A FLOAT.
- 2. DISCHARGE TO STORM FOR TRANSFORMER SUMP PUMP. 3. PROVIDE OIL SENSOR FOR TRANSFORMER SUMP PUMP.
- 4. VENT NORMALLY OMITTED WHEN CONNECTING TO STORM.

SUBMERSIBLE TRANSFORMER SUMP PUMP DETAIL P-601.00 NTS

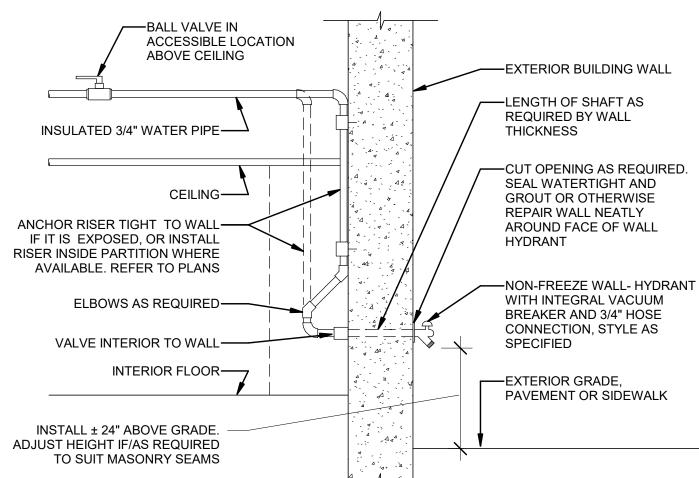

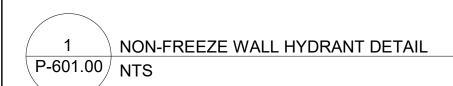

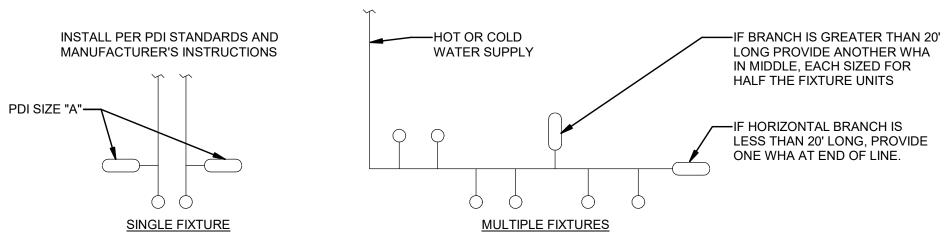



PDI	PIPE	DIDE FIXTURE		WEIGHT IN FIXTURE - UNITS						
SIZE	SIZE	UNIT	FIXTURE	TYPE OF SUPPLY CONTROL		PUBLIC			PRIVATE	
	J.LL	LOAD			TOTAL	C.W.	H.W.	TOTAL	C.W.	H.W.
AA	1/2"	1-3	WATER CLOSET 1.66 GPF	FLUSH VALVE	8	8	-	5	5	-
Α	1/2"	1-11	LAVATORY	FAUCET	2	1.5	1.5	1	1	1
В	3/4"	12-32	SERVICE SINK	FAUCET	3	3	3	-	-	-
С	1"	33-60	ICE MAKER	EQUIPMENT CONNECTION	1	1	-	1	1	-
D	1 1/4"	61-113			1		1			
E	1 1/2"	114-154								

DO NOT PROVIDE AIR CHAMBERS. PROVIDE WATER HAMMER ARRESTERS BY SIOUX CHIEF. PRECISION PLUMBING PRODUCTS, WATTS OR APPROVED EQUIVALENT WITH PISTON AND O-RING CONSTRUCTION, HAVING PDI #WH-201, ASSE # 1010, AND ANSI # A112.26.1M CERTIFICATION. INSTALL IN HORIZONTAL OR VERTICAL POSITION, BUT NEVER UPSIDE DOWN. INSTALL IN LINE WITH WATER FLOW DIRECTION IF POSSIBLE. SIZE THE UNITS PER THE TABLES SHOWN ABOVE, BUT NOT LESS THAN WATER CONNECTION SIZE.


WATER HAMMER ARRESTER DETAIL P-601.00 NTS


F 2" 155-330

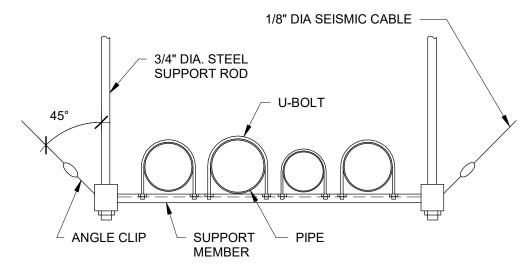


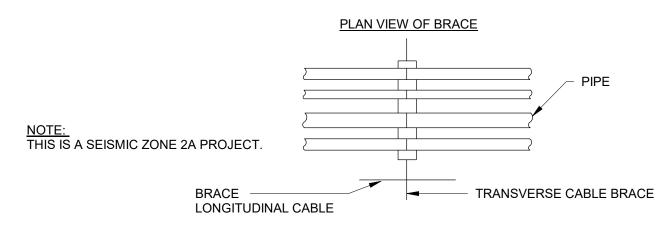

DETAILS SHOWN ON THIS DRAWING ARE TO BE USED AS A GUIDE FOR THE SUPPORT OF MECHANICAL EQUIPMENT, PIPING, DUCTWORK, ETC. PROVIDE SEISMIC CALCULATIONS, SIGNED AND SEALED BY A LICENSED PROFESSIONAL ENGINEER WITH A MINIMUM OF FIVE YEARS

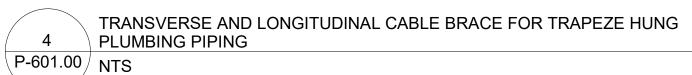

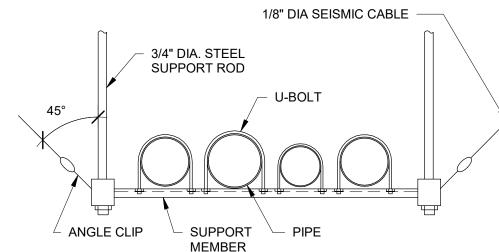

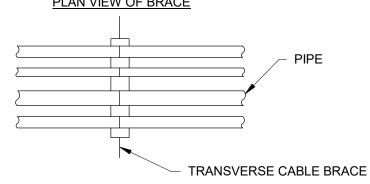

DETAILS SHOWN ON THIS DRAWING ARE TO BE USED AS A GUIDE FOR THE SUPPORT OF MECHANICAL EQUIPMENT, PIPING, DUCTWORK, ETC. PROVIDE SEISMIC CALCULATIONS, SIGNED AND SEALED BY A LICENSED PROFESSIONAL ENGINEER WITH A MINIMUM OF FIVE YEARS EXPERIENCE IN SEISMIC DESIGN AND MUST HAVE SEISMIC INSURANCE.

TRANSVERSE CABLE BRACE FOR TRAPEZE HUNG PLUMBING PIPING P-601.00 / NTS

SHEET NOTES:

- REFER TO SHEETS A SERIES FOR ARCHITECTURAL DRAWINGS, NOTES, DETAILS, SCHEDULES AND REQUIREMENTS. FILED UNDER SEPARATE
- APPLICATION. REFER TO SHEETS E SERIES FOR BUILDING ELECTRICAL DRAWINGS. NOTES, DETAILS, SCHEDULES AND REQUIREMENTS. FILED UNDER SEPARATE
- APPLICATION. REFER TO SHEETS M SERIES FOR HVAC MECHANICAL DRAWINGS, NOTES, DETAILS, SCHEDULES AND REQUIREMENTS. FILED UNDER SEPARATE
- APPLICATION. REFER TO SHEETS P SERIES FOR PLUMBING DRAWINGS, NOTES, DETAILS, SCHEDULES AND REQUIREMENTS. FILED UNDER SEPARATE APPLICATION.
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- REFER TO GENERAL NOTES ON MEP COVER SHEET FOR ADDITIONAL REQUIREMENTS OF WORK.
- ALL PLUMBING METALLIC COMPONENTS INSIDE CONVERTOR BUILDING SHALL BE BONDED TO THE BUILDING OR BUILDING RING CONDUCTOR. COORDINATE WITH ELECTRICAL PLANS AND CONTRACTOR FOR REQUIREMENTS.
- ALL PLUMBING METALLIC COMPONENTS INSTALLED OUTSIDE OF BUILDING SHALL BE BONDED TO GROUND. COORDINATE WITH ELECTRICAL PLANS AND CONTRACTOR FOR REQUIREMENTS.



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25 Mohawk Avenue **Sparta, NJ 07871**

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ISSUED FOR PERMIT

В	FINAL SUBMISSION	WP	SD	12-12-22
Α	INTERIM SUBMISSION	WP	AZ	09-13-22
REV	DESCRIPTION	DRW BY	CHK BY	DATE



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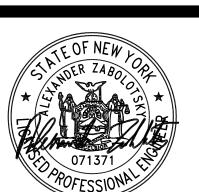
901 Main Campus Drive Raleigh, North Carolina 27606



Astoria HVDC Converter Station

31-45 20th Avenue, Astoria, Queens NY 11105 Block #850 - Lot #310 - BIN #4624437


> **PLUMBING DETAILS** SHEET #2



12/12/2022 PROJECT NO W.PENDLETON CHECKED BY S.DEVADKAR DRAWING NO

P-601.00

CADD FILE NO Autodesk Docs://CHPE Astoria/CHA-KIE-081-00-M3-H-001.rvt

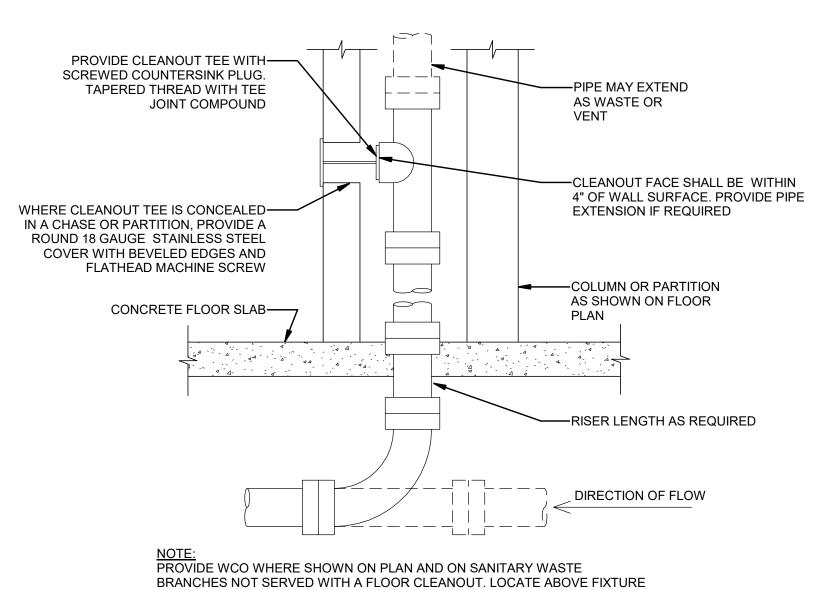



BRANCHES NOT SERVED WITH A FLOOR CLEANOUT. LOCATE ABOVE FIXTURE FLOOD RIM WITHIN FOUR FEET OF FLOOR. CONFORM TO LOCAL CODES FOR OTHER WCO REQUIREMENTS.


WALL CLEANOUT DETAIL P-601.00 NTS


EXPERIENCE IN SEISMIC DESIGN AND MUST HAVE SEISMIC INSURANCE.

PLAN VIEW OF BRACE

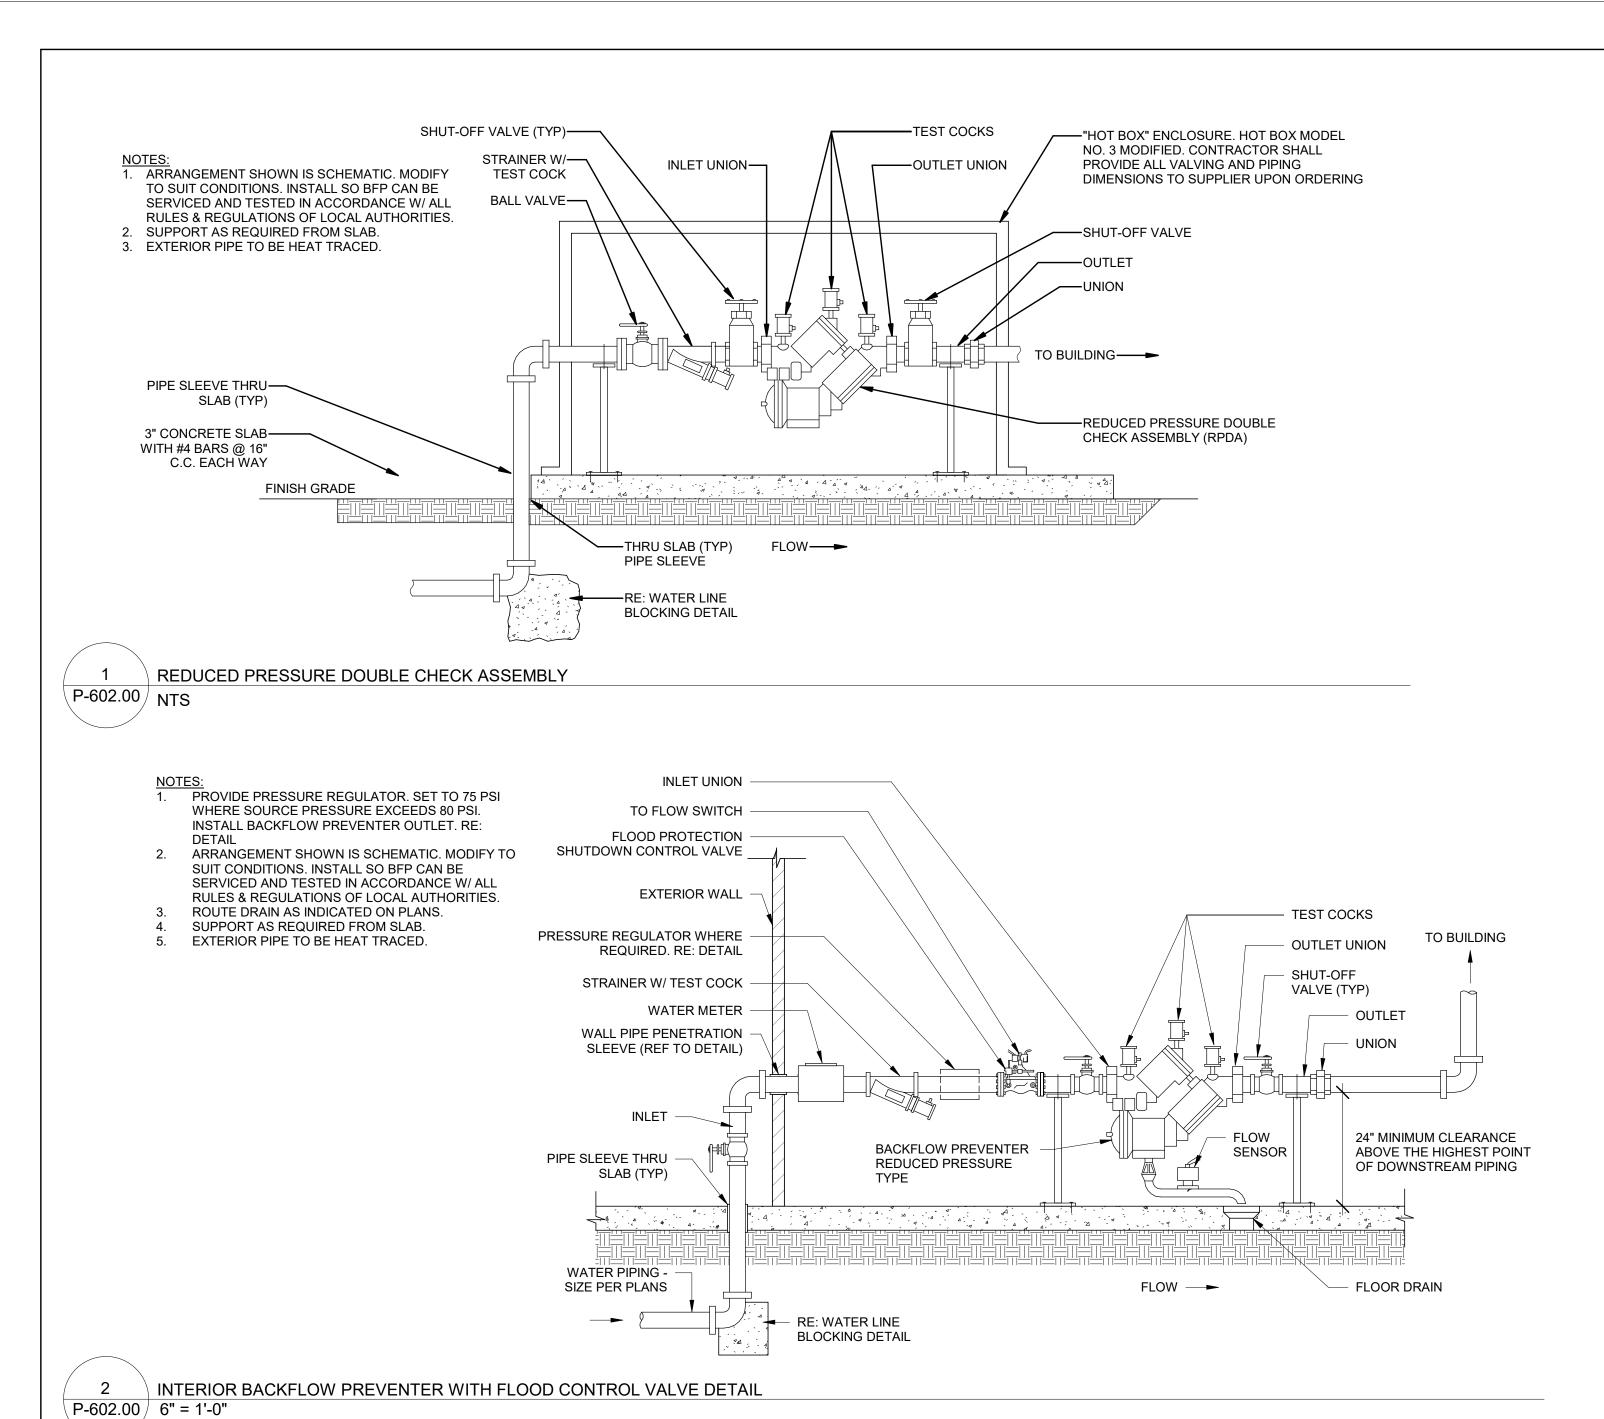

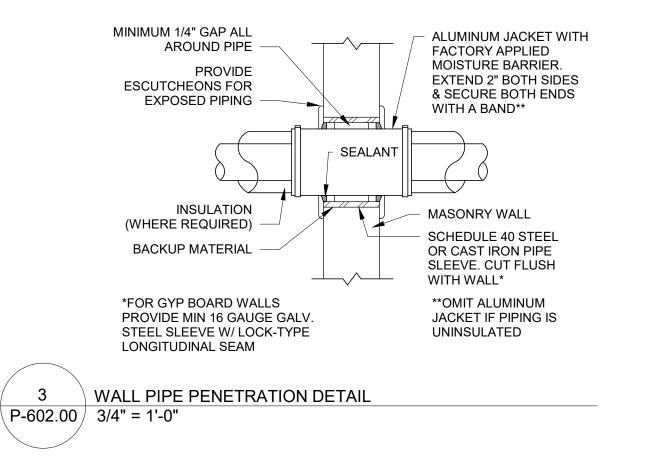

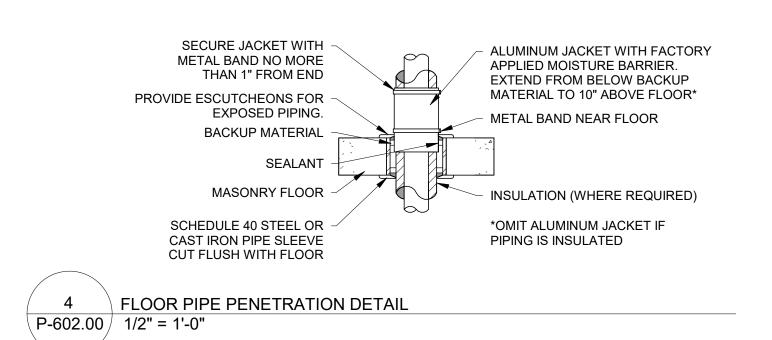

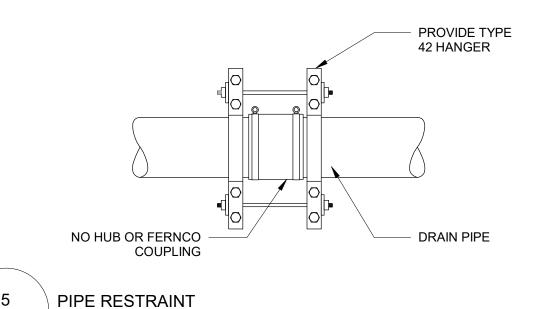


P-602.00 3/4" = 1'-0"


SHEET NOTES:

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- REFER TO SHEETS E SERIES FOR BUILDING ELECTRICAL DRAWINGS,
 NOTES, DETAILS, SCHEDULES AND REQUIREMENTS. FILED UNDER SEPARATE
- APPLICATION. REFER TO SHEETS M SERIES FOR HVAC MECHANICAL DRAWINGS, NOTES,
- DETAILS, SCHEDULES AND REQUIREMENTS. FILED UNDER SEPARATE APPLICATION. REFER TO SHEETS P SERIES FOR PLUMBING DRAWINGS, NOTES, DETAILS,
- SCHEDULES AND REQUIREMENTS. FILED UNDER SEPARATE APPLICATION. REFER TO SHEETS S SERIES FOR BUILDING STRUCTURAL DRAWINGS.
- NOTES, DETAILS, SCHEDULES AND REQUIREMENTS. FILED UNDER SEPARATE APPLICATION.
- REFER TO GENERAL NOTES ON MEP COVER SHEET FOR ADDITIONAL REQUIREMENTS OF WORK.
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- ALL PLUMBING METALLIC COMPONENTS INSTALLED OUTSIDE OF BUILDING SHALL BE BONDED TO GROUND. COORDINATE WITH ELECTRICAL PLANS AND CONTRACTOR FOR REQUIREMENTS.

ISSUED FOR PERMIT

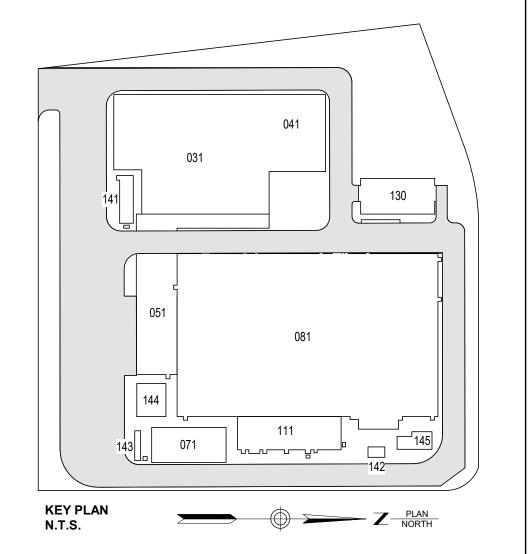


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25 Mohawk Avenue **Sparta, NJ 07871**
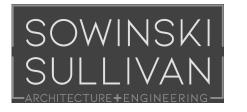
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Woodcliff Lake, NJ 07677

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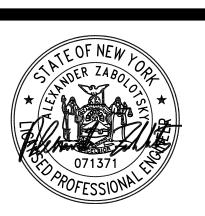
901 Main Campus Drive Raleigh, North Carolina 27606

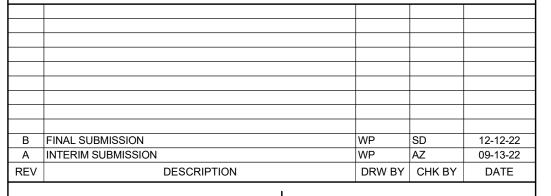

Astoria HVDC Converter Station

31-45 20th Avenue, Astoria, Queens NY 11105 Block #850 - Lot #310 - BIN #4624437

PLUMBING DETAILS SHEET #3



12/12/2022 PROJECT NO 105121 W.PENDLETON CHECKED BY S.DEVADKAR DRAWING NO

P-602.00

DIVISION	SERVICE	LOCATION	SIZE RANGE	PIPING MATERIAL APPLICATION MATERIAL	STANDARD INSULATION MATERIAL	OTHER INSULATION MATERIAL	JACKETING	REMARKS
Biviolott	SERVICE	UNDERGROUND	UP TO 10 INCH	PIPE: SOLID-WALL PVC PIPE, PVC SOCKET FITTINGS, AND SOLVENT-CEMENTED JOINTS: ASTM D 2665, DRAIN, WASTE, AND VENT, SCHEDULE 40. FITTINGS: PVC SOCKET FITTINGS, ASTM D 2665, SOCKET TYPE, MADE TO ASTM D 3311 DRAIN, WASTE, AND VENT PATTERNS.	-	OPTIONS	-	-
22 - PLUMBING	SOIL , WASTE	ABOVE GROUND	UP TO 10 INCH	PIPE: HUBLESS CAST-IRON PIPE AND FITTINGS OR DWV COPPER PIPING WITH HUBLESS FITTINGS OR DWV COPPER PIPE WITH WROUGHT-COPPER DRAINAGE FITTINGS AND SOLDER JOINTS. FITTINGS: ALL HUBLESS CAST-IRON FITTINGS SHALL MEET THE REQUIREMENTS OF ASTM A-888 OR CISPI 301 AS APPLICABLE. COUPLINGS, BOTH AT HORIZONTAL AND VERTICAL JOINTS, SHALL BE CLAMPED AND RESTRAINED WHERE REQUIRED AND IN ACCORDANCE WITH CISPI 301. COPPER DWV TUBE SHALL MEET THE REQUIREMENTS OF ASTM B306.	-		-	-
22 - PLUMBING	VENT	UNDERGROUND	UP TO 4 INCH	PIPE: SOLID-WALL PVC PIPE, PVC SOCKET FITTINGS, AND SOLVENT-CEMENTED JOINTS: ASTM D 2665, DRAIN, WASTE, AND VENT, SCHEDULE 40. FITTINGS: PVC SOCKET FITTINGS, ASTM D 2665, SOCKET TYPE, MADE TO ASTM D 3311 DRAIN, WASTE, AND VENT PATTERNS.	-		-	-
		ABOVE GROUND	UP TO 4 INCH	GALVANIZED STEEL PIPE WITH MALLEABLE IRON FITTINGS OR SERVICE WEIGHT CAST-IRON SOIL PIPE WITH HUBLESS FITTINGS (ASTM A-888 OR CISPI 301), OR DWV COPPER PIPE WITH WROUGHT-COPPER DRAINAGE FITTINGS AN SOLDER JOINTS. COPPER PIPE SHALL MEET ASTM B306 REQUIREMENTS.	1.5" CELLULAR GLASS	GLASS-FIBER, TYPE I MINERAL WOOL, TYPE II	ASJ	1
22 - PLUMBING	CONDENSATE DRAIN	ABOVE GROUND	UP TO 4 INCH	PIPE: SOLID-WALL PVC PIPE, PVC SOCKET FITTINGS, AND SOLVENT-CEMENTED JOINTS: ASTM D 2665, DRAIN, WASTE, AND VENT, SCHEDULE 40. FITTINGS: PVC SOCKET FITTINGS, ASTM D 2665, SOCKET TYPE, MADE TO ASTM D 3311 DRAIN, WASTE, AND VENT PATTERNS. PIPE: SOFT COPPER TUBE, ASTM B 88, TYPE K (ASTM B 88M, TYPE A) FITTINGS: ASME 16.22 & ASTM B75/B75M, WROUGHT-COPPER, SOLDER-JOINT FITTINGS; AND BRAZED JOINTS.	1.5" CELLULAR GLASS	GLASS-FIBER, TYPE I MINERAL WOOL, TYPE II	ASJ	5
22 - PLUMBING	DOMESTIC WATER INDOOR	UNDERGROUND	UP TO 4 INCH	PIPE: SOFT COPPER TUBE, ASTM B 88, TYPE K (ASTM B 88M, TYPE A) FITTINGS: ASME 16.22 & ASTM B75/B75M, WROUGHT-COPPER, SOLDER-JOINT FITTINGS; AND BRAZED JOINTS.	-		-	-
22 - PLUMBING	FIRE / DOMESTIC WATER SERVICE	UNDERGROUND	2-6 INCH	PIPE: AWWA C151, DUCTILE IRON FITTINGS: AWWA C111. MECH JOINTS	-		-	-
22 - PLUMBING	DOMESTIC WATER INDOOR	ABOVE GROUND	UP TO 6 INCH	PIPE: ASTM B88, TYPE L DRAWN TEMPER SEAMLESS COPPER TUBE. FITTINGS: ASME B16.22 WROUGHT COPPER OR ASME B16.18 CAST-COPPER ALLOY. FLANGES: ASME B16.24, CLASS 150 CAST BRONZE FLANGES WITH SOLDER JOINT ENDS. UNIONS: ASME B16.18 CAST-COPPER ALLOY, HEXAGONAL STOCK BODY WITH BALL-AND-SOCKET JOINT, METAL-TO-METAL SEATING SURFACES, AND SOLDER JOINT AND/OR THREADED ENDS.	1.5 INDOORS CELLULAR GLASS 2" OUTDOORS CELLULAR GLASS	FLEXIBLE ELASTOMETRIC GLASS-FIBER, TYPE I MINERAL WOOL, TYPE II PHENOLIC POLYOLEFIN	ASJ	3

REMARKS:

ASJ

PVC

1. INSULATE PLUMBING VENTS WITHIN 6 FEET OF ROOF OUTLET.

2. INSULATE ALL DOMESTION HOT WATER, TEMPERED WATER, AND COLD WATER PIPING.

3. INSULATE CONDENSATE DRAINAGE PIPING.

4. INSULATE HYDRONIC PIPING - CHILLED WATER / HOT WATER.

JACKET MATERIALS:

WHITE, KRAFT-PAPER, FIBERGLASS-REINFORCED SCRIM WITH ALUMINUM-FOIL BACKING; COMPLYING WITH ASTM C 1136, TYPE I.

ALUM ASTM B209, TEMPER H14, MINIMUM THICKNESS OF 0.016 INCH, WITH FACTORY-APPLIED POLYETHYLENE AND KRAFT PAPER MOISTURE BARRIER ON THE INSIDE SURFACE

GLASS PLAIN-WEAVE GLASS CLOTH CONFORMING TO ASTM D579/, STYLE 141, WEIGHING NOT LESS THAN 7.23 OUNCES PER SQUARE YARD BEFORE SIZING. FACTORY APPLY CLOTH WHEREVER POSSIBLE.

PROVIDE 0.010 INCH THICK, FACTORY-PREMOLDED POLYVINYLCHLORIDE, PIPE-BARREL SHEETING VAPOR-BARRIER JACKETING THAT IS SELF-EXTINGUISHING, WITH HIGH-IMPACT STRENGTH AND MODERATE CHEMICAL RESISTANCE.

	PLUMBING BOOSTER PUMP SCHEDULE															
	UNIT DATA			BASIS OF DESIGN							ELECTRIC	AL DATA	4		GEN	IERAL DATA
TAG	LOCATION	FUNCTION	MANUFACTURER	MODEL	QUANTITY	FLUID TYPE	FLOW (GMP)	EXT WPD (FT HD)	HP	RPM	VOLTS	Ø	HZ	AMPS	WEIGHT (LBS)	SCHEDULE NOTES
BP-1	SITE (FIRE SERVICE)	BOOSTER	TIGERFLOW	DVMV-15GF-C-S8-VM-P-VFD-NSF-DOL	2 (DUPLEX)	WATER	525	69	(2) 15	3507	208V	3	60	38	700	ALL

- . PROVIDE INERTIA BASE.
- 2. PROVIDE ALL BRONZE/ STEEL CONSTRUCTION. PROVIDE PUMP MOUNTED CONTROL PANEL AND DISCONNECT.
- 4. PROVIDE WITH BMS INTERFACE.
- 5. PROVIDE NEMA 3R FOR OUTDOOR OR 4X WET LOCATIONS.
- 6. PROVIDE WITH ASSE 1060 STANDARD CLASS ONE SAFE-T-COVER 800D-AL WITH 2000W SERIES HCH HEATER. PROVIDE HEATER WITH CONDIUIT, MOUNTING ACCESSORIES, FITTINGS AND LIQUID TIGHT THERMOSTAT.

	PLUMBING SUMP PUMP SCHEDULE													
	UNIT DATA BASISOF DESIGN				PERFORMANCE DATA									
TAG	LOCATION	MANUFACTURER	MODEL	QUANTITY	PUMP TYPE	FLUID TYPE	FLOW (GMP)	EXT WPD (FT HD)	HP	RPM	VOLTS	Ø	FLA	SCHEDULE NOTES
SP-01 A/B	TRANSFORMER CONTAINMENT	ABS SULZER	SCAVENGER EF 10-2	2 (DUPLEX)	WET PIT SUBMERSIBLE	WATER	50	32	0.5	3450	208	1	7.3	ALL
SP-02 A/B	TRANSFORMER CONTAINMENT	ABS SULZER	SCAVENGER EF 10-2	2 (DUPLEX)	WET PIT SUBMERSIBLE	WATER	50	32	0.5	3450	208	1	7.3	ALL
SP-03 A/B	TRANSFORMER CONTAINMENT	ABS SULZER	SCAVENGER EF 10-2	2 (DUPLEX)	WET PIT SUBMERSIBLE	WATER	50	32	0.5	3450	208	1	7.3	ALL
SP-04 A/B	DRYCOOLER CONTAINMENT	ABS SULZER	SCAVENGER EF 03 W	2 (DUPLEX)	WET PIT SUBMERSIBLE	WATER	100	40	1	3450	460	3	2.9	ALL
SP-05 A/B	SPARE TRANSFORMER	ABS SULZER	SCAVENGER EJ 50D-3	2 (DUPLEX)	WET PIT SUBMERSIBLE	WATER	50	32	0.5	3450	208	1	7.3	ALL
SP-06 A/B	AUX TRANSFORMER 01	ABS SULZER	SCAVENGER EF 03 W	2 (DUPLEX)	WET PIT SUBMERSIBLE	WATER	20	26	0.33	3450	115	1	7.2	ALL
SP-07 A/B	AUX TRANSFORMER 02	ABS SULZER	SCAVENGER EF 03 W	2 (DUPLEX)	WET PIT SUBMERSIBLE	WATER	20	26	0.33	3450	115	1	7.2	ALL
SP-08 A/B	UTILITY/ CABLE TRENCH	ABS SULZER	SCAVENGER EF 03 W	2 (DUPLEX)	WET PIT SUBMERSIBLE	WATER	20	10	0.33	3450	115	1	7.2	ALL

- 1. PROVIDE PUMPS WITH BMS INTERFACE WITH NEMA 4X AND CLASS B INSULATION CONTROL PANEL ENCLOSURE.
- 2. PROVIDE PUMPS WITH 2" MOUNTING PAD AND QUICK REMOVAL RAILS AND CHAINS.
- 3. PROVIDE WITH HIGH-LEVEL ALARM AND FLOAT SWITCH, AND OIL/WATER SWITCH & ALARM.

	BACKFLOW PREVENTER SCHEDULE											
SYMBOL	DESCRIPTION	LOCATION	SYSTEM	MODEL	SIZE (IN)	FLOW (GPM)	PRESSURE DROP (PSI)	SHUT-OFF VALVES	MAX DESIGN TEMP (°F)	MAX WORKING PRESSURE (PSI)	HYDROSTATIC TEST PRESSURE (PSI)	NOTES
RPDA-1	REDUCED PRESSURE DOUBLE DETECTOR ASSEMBLY	FIRE WATER SERVICE	LOW PRESSURE	WATTS (957RPDA)	6"	525	10	GATE	180	175	350	ALL

- 1. MOUNT WITHIN 48" OF FINISHED FLOOR.
- 2. FURNISH AND INSTALL BRONZE OR EPOXY COATED STRAINER UPSTREAM OF EACH UNIT AND ADDITIONAL VALVE UPSTREAM OF EACH STRAINER.
- 3. PROVIDE WITH ASSE 1060 STANDARD CLASS ONE SAFE-T-COVER 800D-AL WITH 2000W SERIES HCH HEATER. PROVIDE HEATER WITH CONDIUIT, MOUNTING ACCESSORIES, FITTINGS AND LIQUID TIGHT THERMOSTAT.

PROVIDE HINGED DOOR FOR DRAIN.

	FIRE WATER TANK SCHEDULE										
UNIT DATA	BASIS OI	DESIGN		CE DATA			HEATER DAT	A			
TAG	EQUIPMENT	TYPE	FLUID	CAPACITY (GALLONS)	DIAMETER	HEIGHT (FT)	TYPE	CAPACITY	VOLTS	Ø	SCHEDULE NOTES
TNK-1	FT-1	FIRE WATER TANK	WATER	205,000	27	50	IMMERSION	15 KW	480	3	ALL
NOTEO											


. TANK AND ALL ASSOCIATED ACCESSORIES SHALL BE IN COMPLY WITH NYC BUILDING CODE.

- 2. PROVIDE FIRE TANK WITH BMS INTERFACE WITH NEMA 4X AND CLASS B INSULATION CONTROL PANEL ENCLOSURE.
- 3. PROVIDE CONTROL PANELS MOUNTED ON FIRE TANK SKID.

ISSUED FOR PERMIT



370 7th Avenue **SUITE 1604** New York, NY 10001

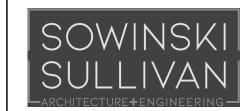

25 Mohawk Avenue **Sparta, NJ 07871**

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В	FINAL SUBMISSION	WP	SD	12-12-22
Α	INTERIM SUBMISSION	WP	AZ	09-13-22
REV	DESCRIPTION	DRW BY	CHK BY	DATE




901 Main Campus Drive Raleigh, North Carolina 27606



Astoria HVDC Converter Station

31-45 20th Avenue, Astoria, Queens NY 11105 Block #850 - Lot #310 - BIN #4624437

SERVICE BUILDING PLUMBING - SCHEDULES

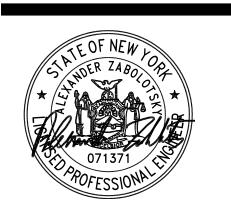

1	
DATE	12/12/2022
PROJECT NO	105121
DRAWING BY	W.PENDLETON
CHECKED BY	S.DEVADKAR
DRAWING NO	

P-701.00