

**APPENDIX C.18**  
**CASE 10-T-0139**  
**SITE PLANS AND CONSTRUCTION DRAWINGS**  
**FIRE PROTECTION DRAWINGS – FIRE ALARM**  
**ASTORIA HVDC CONVERTER STATION**  
**SEGMENT 22**

# ASTORIA HVDC CONVERTER STATION

## FIRE PROTECTION SYSTEMS: FIRE ALARM

SHEET LIST - FA	
SHEET	SHEET NAME
FA-001.00	COVER SHEET
FA-002.00	OVERALL SITE PLAN
FA-003.00	FIRE ALARM GENERAL NOTES AND LEGEND
FA-004.00	INPUT/OUTPUT MATRIX
FA-005.00	FIRE ALARM RISER DIAGRAM
FA-101.00	CONVERTER BUILDING - FIRE ALARM AUDIBILITY PLAN
FA-102.00	CONVERTER BUILDING - FIRE ALARM PLAN
FA-103.00	SERVICE BUILDING - FIRE ALARM PLAN
FA-104.00	SERVICE BUILDING - FIRE ALARM PLAN
FA-105.00	SERVICE BUILDING - FIRE ALARM PLAN
FA-106.00	SERVICE BUILDING - FIRE ALARM PLAN
FA-107.00	TRANSFORMER AREA AND PUMP ENCLOSURE FIRE ALARM AUDIBILITY PLAN
FA-108.00	TRANSFORMER AREA AND PUMP ENCLOSURE FIRE ALARM PLAN
FA-109.00	STORAGE ENCLOSURE - FIRE ALARM PLAN
FA-110.00	RELAY ENCLOSURE - FIRE ALARM PLAN
FA-111.00	MVS ENCLOSURE - FIRE ALARM PLAN
FA-601.00	FIRE ALARM DETAILS

### SCOPE OF WORK

THE FIRE PROTECTION SYSTEMS SCOPE OF WORK INCLUDES FIRE ALARM SYSTEMS IN THE FOLLOWING AREAS AS SUBJECT TO THE REQUIREMENTS AND PERFORMANCE CRITERIA PROVIDED IN THE FIRE PROTECTION DESIGN BASIS DOCUMENT.


1. CONVERTER BUILDING
2. SERVICE BUILDING
3. STORAGE ENCLOSURE
4. RELAY ENCLOSURE
5. MVS ENCLOSURE
6. CONVERTER TRANSFORMERS
7. FIRE PUMP ENCLOSURE
8. FIRE WATER TANK
9. EMERGENCY GENERATOR

### FLOOD ZONE DESIGN CERTIFICATION:

THE EXISTING PROPERTY IS IN THE SPECIAL FLOOD HAZARD AREA (SFHA), ZONE AE PER EFFECTIVE 2015 FLOOD INSURANCE RATE MAP(FIRM). THIS IS TO CONFIRM THAT THE PROPOSED INSTALLATION IS IN COMPLIANCE WITH THE REQUIREMENTS SET FORTH IN APPENDIX Q OF THE NYC BUILDING CODE.


### NYC ENERGY CODE COMPLIANCE:

STATEMENT: TO THE BEST OF MY KNOWLEDGE, BELIEF AND PROFESSIONAL JUDGEMENT, THESE PLANS AND SPECIFICATIONS ARE IN COMPLIANCE WITH THE NEW YORK CITY ENERGY CONSERVATION CODE. PROPOSED WORK MEETS THE GUIDELINES AND INSTRUCTIONS OUTLINED IN THE 2020 NYC ECC CHAPTER 4.

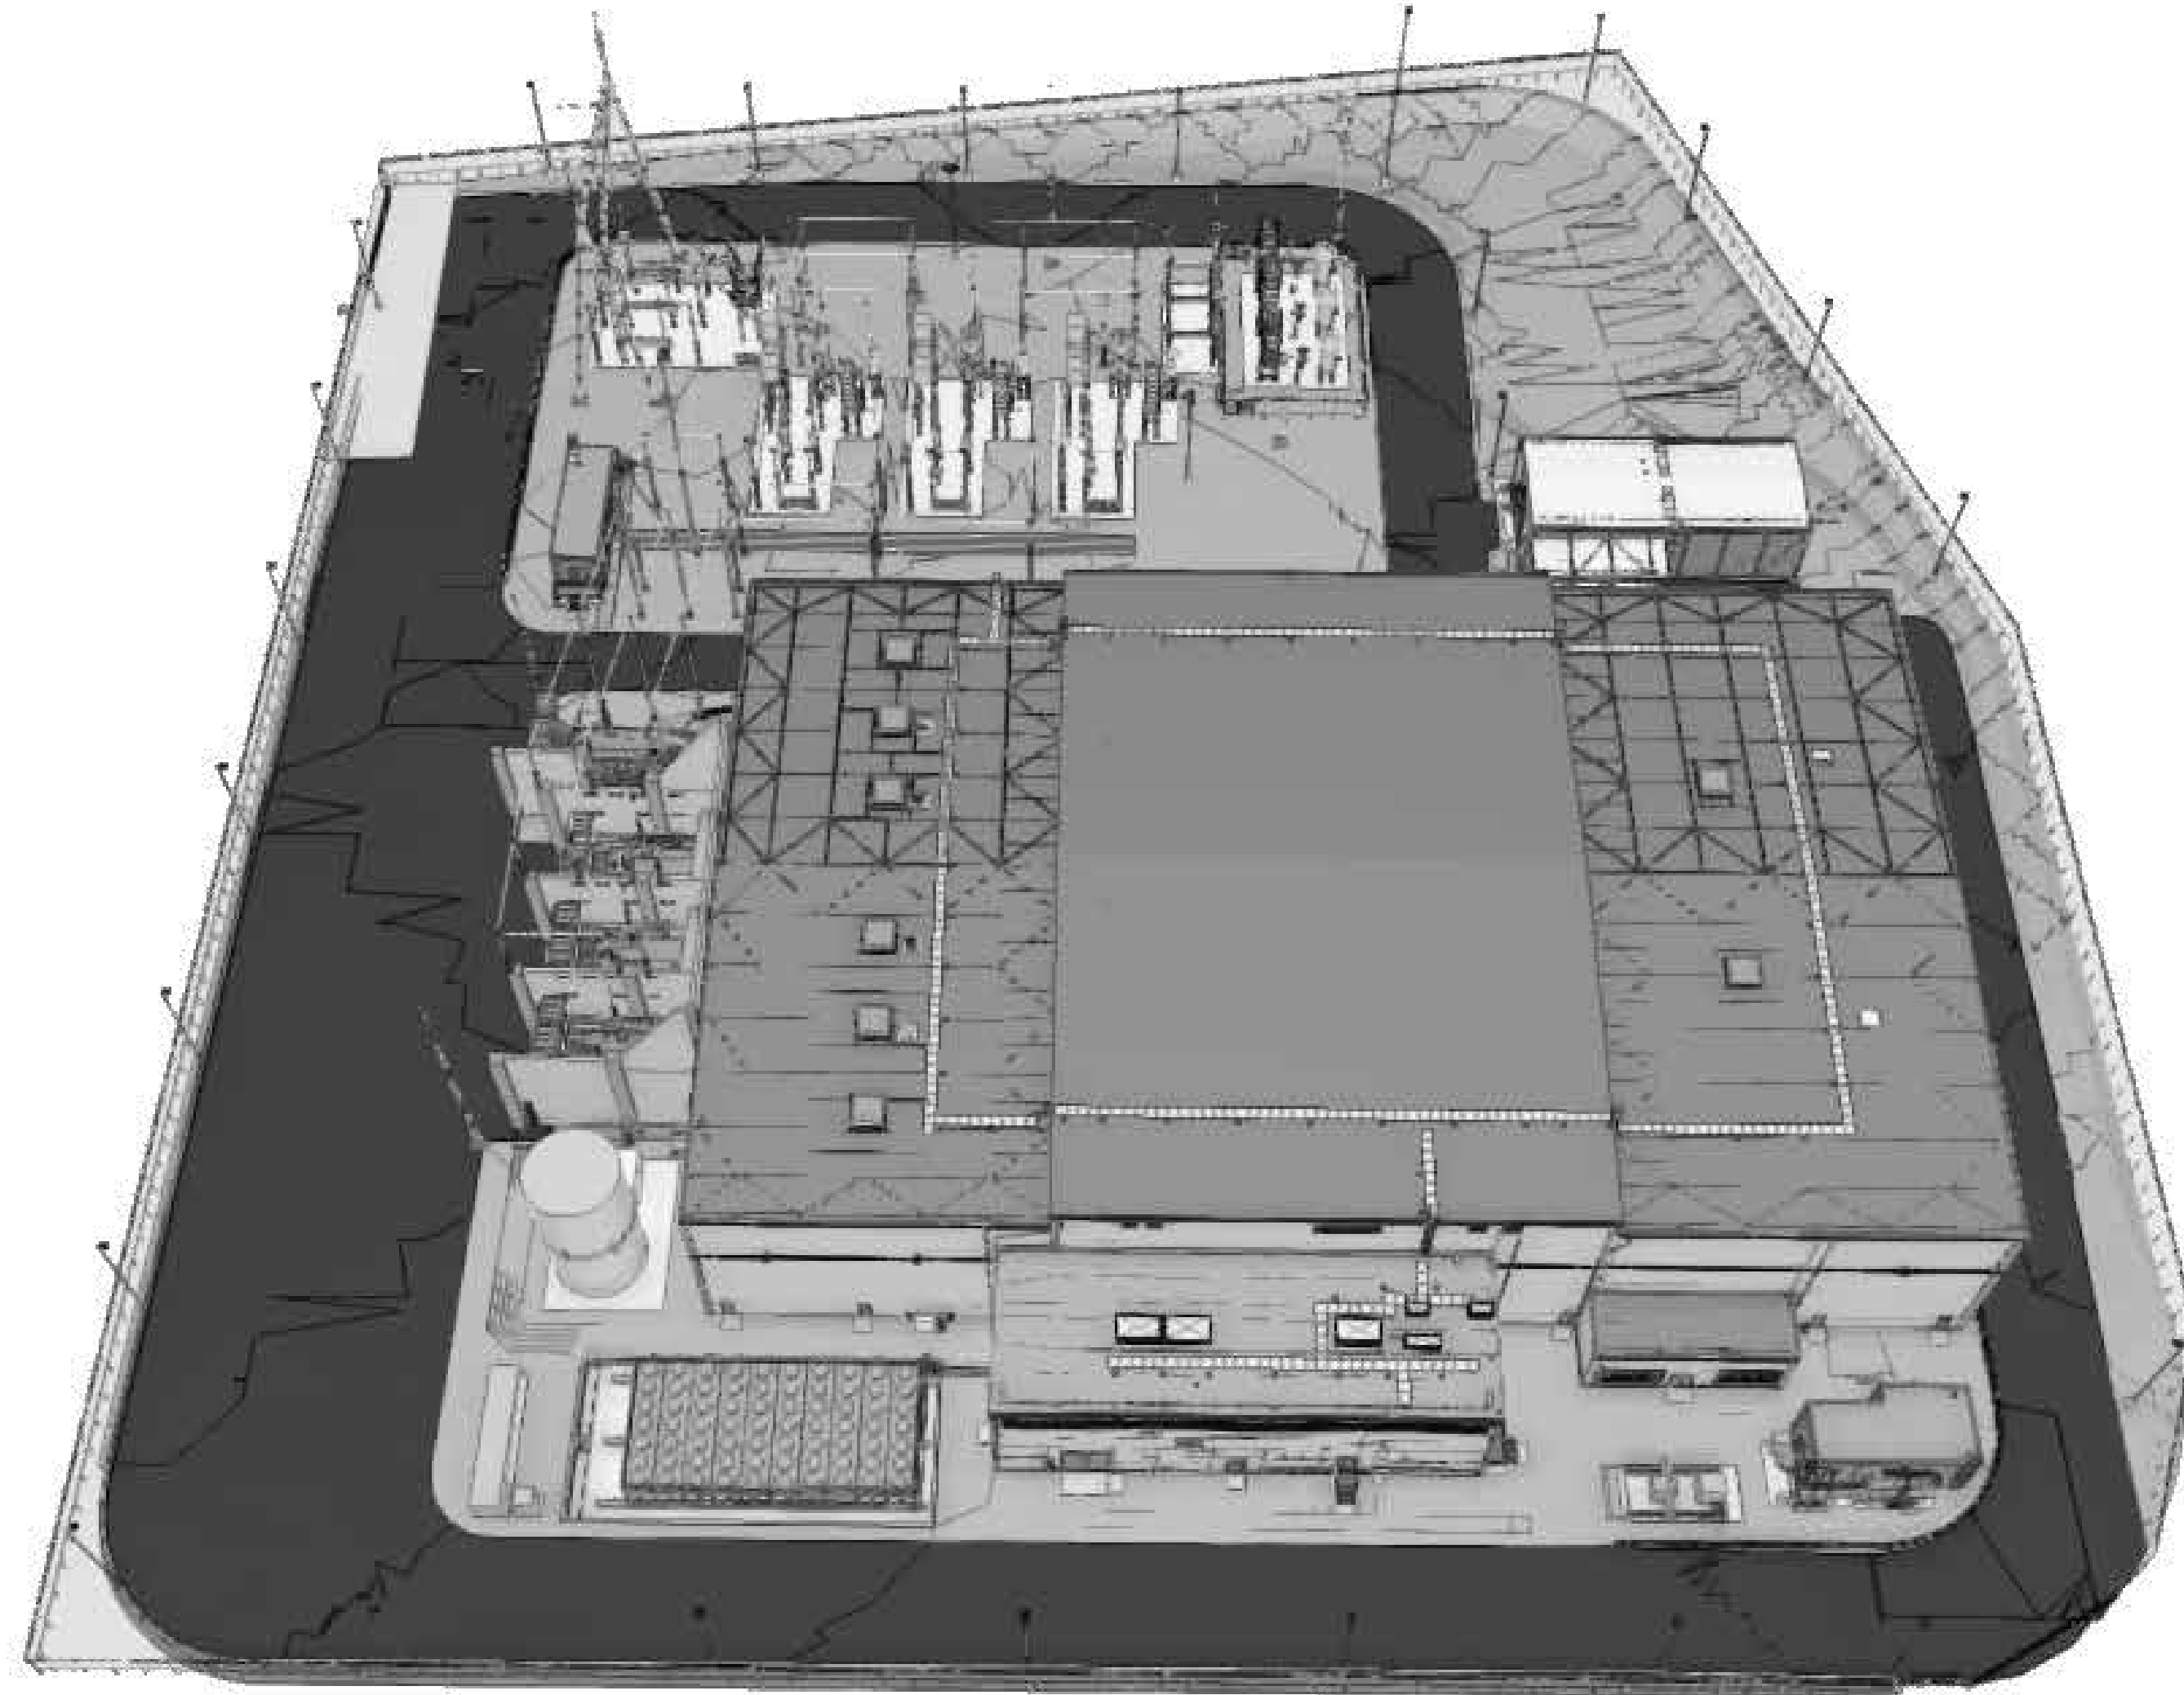

1 OVERALL SITE VIEW  
FA-001.00 N.T.S.

ISSUED FOR PERMIT

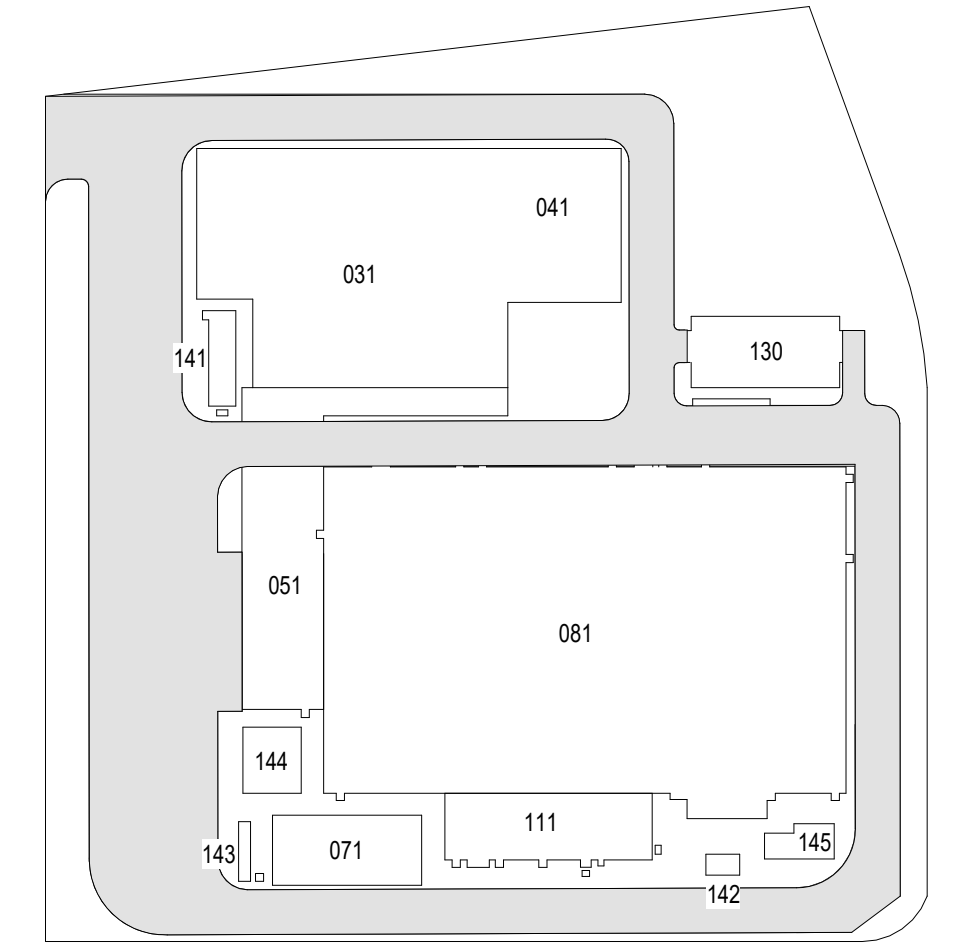

KEY PLAN  
N.T.S.



Poole Fire Protection  
19910 W. 161st Street  
Olathe, KS 66062

19910 W. 161st STREET  
OLATHE, KS. 66062



25 Mohawk Avenue  
Sparta, NJ 07871

#### CONFIDENTIAL

THESE DRAWINGS ARE CONFIDENTIAL IN NATURE. ANY MISUSE OR UNAUTHORIZED DISTRIBUTION OF THE DRAWINGS CONTAINED HEREIN WILL BE A VIOLATION OF THIS CONFIDENTIALITY REQUIREMENT AND SUBJECT THE VIOLATOR TO LIABILITY. REVIEW OF THESE MATERIALS BY RECEIPT SHALL CONSTITUTE ACCEPTANCE OF THESE TERMS AND THE TERMS OF ANY UNDERLYING CONFIDENTIALITY AGREEMENT THEY MAY HAVE. EXCLUDED IN OBTAINING THIS INFORMATION FROM A THIRD PARTY. IF THE RECIPIENT IS NOT IN AGREEMENT WITH THE OBLIGATION OF CONFIDENTIALITY THEN THE DRAWINGS SHALL BE RETURNED TO THE ORIGINATOR.

REV	DESCRIPTION	DRW BY	CHK BY	DATE
B	FINAL SUBMISSION	SAB	AWP	12/12/2022
A	INTERIM SUBMISSION	SAB	AWP	09/13/2022



Kiewit  
470 Chestnut Ridge Rd # 2,  
Woodcliff Lake, NJ 07677

Hitachi Energy

901 Main Campus Drive  
Raleigh, North Carolina 27606


#### PROJECT



### Astoria HVDC Converter Station

31-45 20th Avenue, Astoria, Queens NY 11105  
Block #850 - Lot #310 - BIN #4624437


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DATE	12/12/2022
PROJECT NO	105121
DRAWING BY	S. BRINKMEYER
CHECKED BY	A. POOLE
DRAWING NO	FA-001.00
CADD FILE NO	102980
1 of 18	

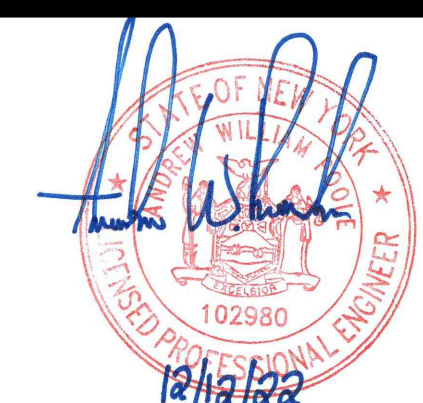


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1  
FA-002.00  
OVERALL SITE PLAN  
1/32" = 1'-0"

Lands Now of Formerly of  
CONSOLIDATED EDISON  
COMPANY OF NEW YORK,  
INC.  
Block 850 Lot 1

ISSUED FOR PERMIT

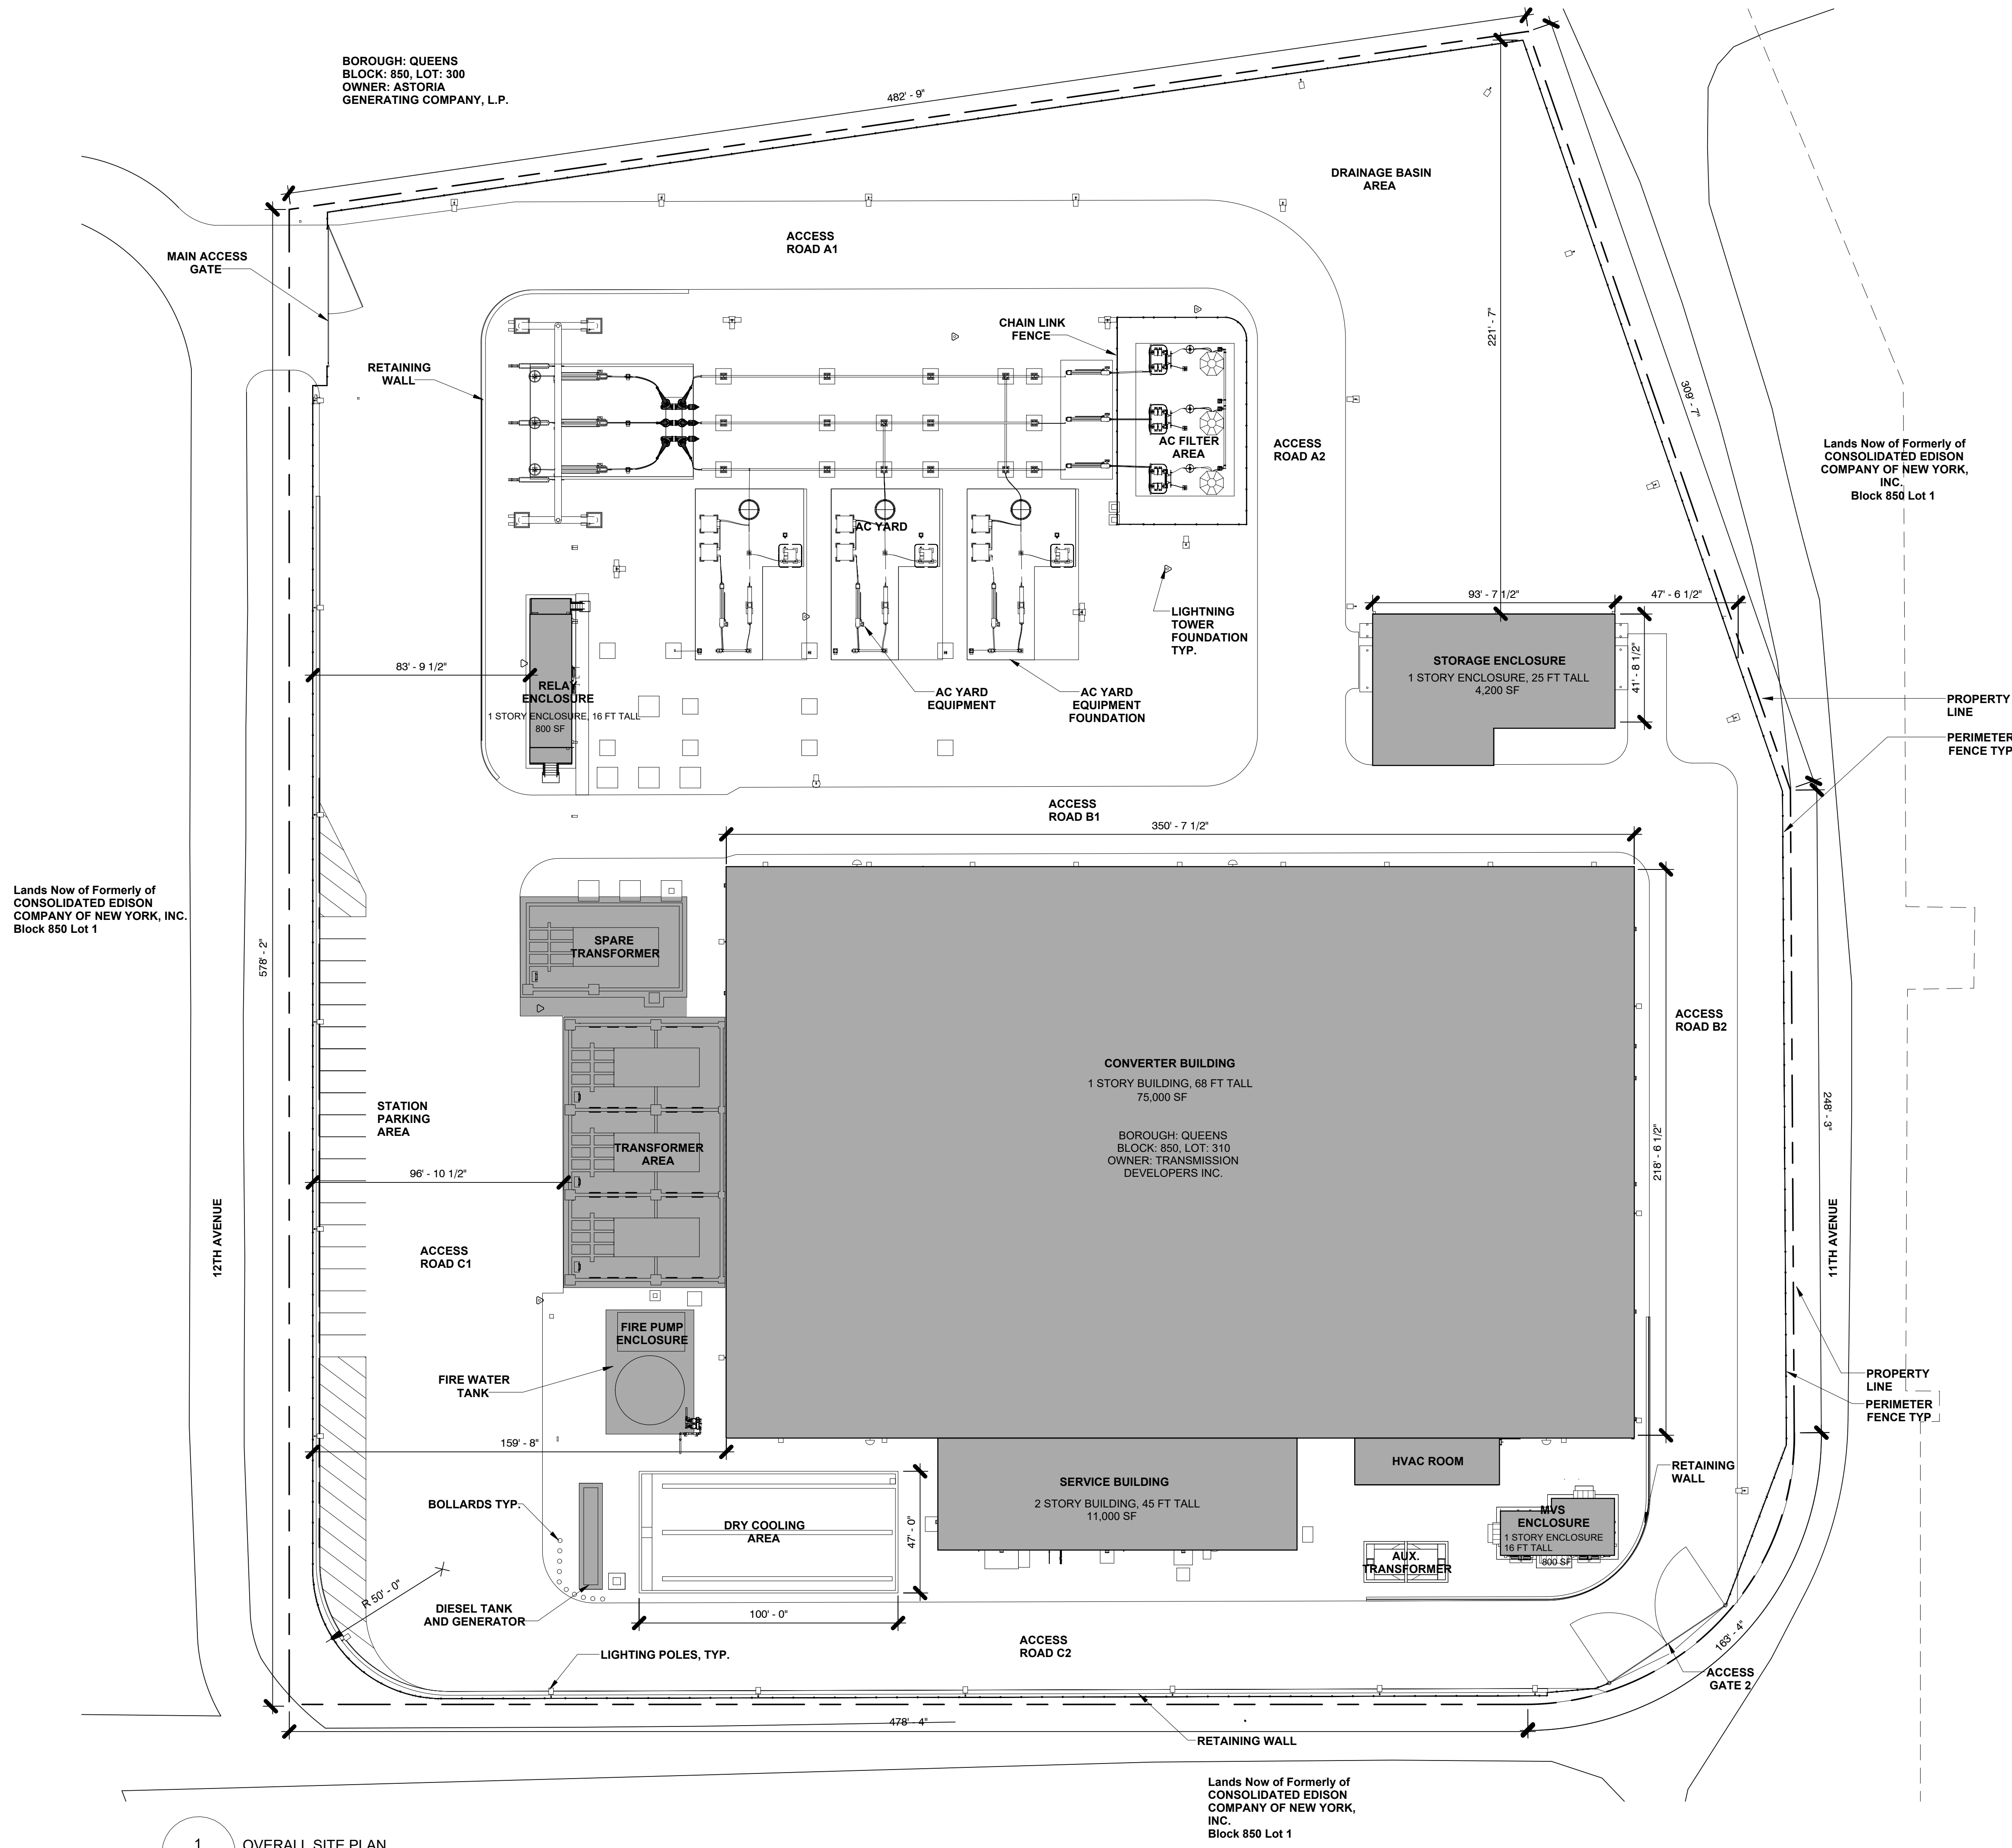

KEY PLAN  
N.T.S.

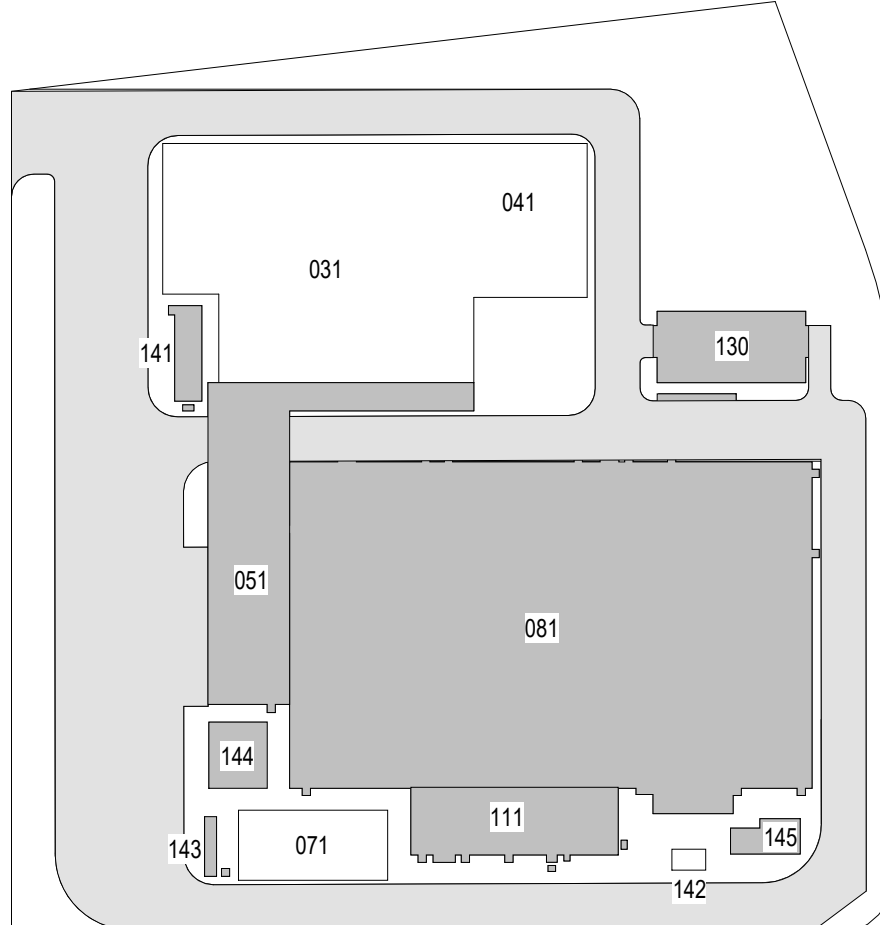

Poole Fire Protection  
19910 W. 161st Street  
Olathe, KS 66062

19910 W. 161st STREET  
OLATHE, KS. 66062



25 Mohawk Avenue  
Sparta, NJ 07871

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A	INTERIM SUBMISSION	SAB	AWP	09/13/2022
REV	DESCRIPTION	DRW BY	CHK BY	DATE



**Kiewit**

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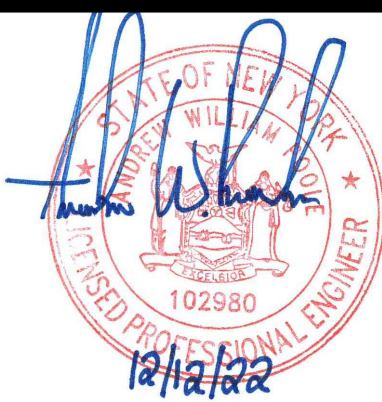
PROJECT

**CHPE**  
Champlain Hudson  
Power Express

**Astoria HVDC  
Converter Station**

31-45 20th Avenue, Astoria, Queens NY 11105  
Block #850 - Lot #310 - BIN #4624437

OVERALL SITE PLAN



DATE 12/12/2022  
PROJECT NO 105121  
DRAWING BY S. BRINKMEYER  
CHECKED BY A. POOLE  
DRAWING NO  
**FA-002.00**  
CADD FILE NO  
AstoriaHVDC-CHPE  
AstoriaCHPE-111-00-M3-FP-001.rvt  
2 of 18



FIRE ALARM GENERAL NOTES

- SYSTEM DESCRIPTION:
- THE SYSTEMS INDICATED HEREIN ARE FOR THE GENERAL FIRE ALARM, DETECTION, AND RELEASING SERVICE SYSTEMS. THESE NOTES ARE APPLICABLE TO ALL FACILITY AREAS OR BUILDINGS PROVIDED WITH A FIRE ALARM, DETECTION AND OR RELEASING SYSTEM. REFER TO THE SPECIFIC AREA OR BUILDING NOTE SECTIONS FOR ADDITIONAL INFORMATION.
- FIRE ALARM SYSTEM GENERAL NOTES:
- THE FIRE ALARM SERIES DRAWINGS MUST BE INTERPRETED IN THEIR ENTIRETY FOR CONSTRUCTION AND INSTALLATION REQUIREMENTS; NO SINGLE FIRE ALARM DRAWING CONTAINS THE TOTALITY OF INFORMATION RELATING TO THE FIRE ALARM SYSTEM DESIGN INTENT OR SPECIFICATION.
  - THESE DRAWINGS ARE DIAGRAMMATIC IN NATURE AND SHOW ONE POTENTIAL METHOD OF CODE COMPLIANCE BASED UPON DESIGNED CONDITIONS. THE WORK THAT IS INDICATED ON THESE DRAWINGS ARE AN OVERVIEW OF THE PROJECT, INTENDED TO ESTABLISH THE SCOPE OF THE PROJECT MINIMUM REQUIREMENTS AS WELL AS THE CONTRACTOR'S RESPONSIBILITIES. DEVICES ARE TO BE COORDINATED AND LOCATED TO AVOID OBSTRUCTIONS AND INTERFERENCES. FINAL FIRE ALARM SYSTEM DEVICE LOCATIONS, QUANTITIES, AND TYPES ARE THE RESPONSIBILITY OF THE FIRE ALARM CONTRACTOR (BASED ON EQUIPMENT SELECTION, FIELD CONDITIONS, OWNER AND CODE REQUIREMENTS, THE 'LOCAL AUTHORITY HAVING JURISDICTION', AND THE SPECIFICATIONS). IT SHALL BE THE RESPONSIBILITY OF THE FIRE ALARM SYSTEM CONTRACTOR TO PROVIDE ALL ITEMS AS REQUIRED FOR A COMPLETE AND OPERATIONAL SYSTEM.
  - THE DESIGN AND INSTALLATION OF THE FIRE ALARM SYSTEMS MUST BE IN ACCORDANCE WITH, BUT NOT LIMITED TO, NYC BUILDING CODE (2022), NYC FIRE CODE (2022), NYC ELECTRICAL CODE (2011), NFPA 72 (2016), AND ALL LOCAL AMENDMENTS.
  - PENETRATION OF FIRE RESISTANCE RATED CONSTRUCTION MUST BE SEALED TO MAINTAIN THE REQUIRED FIRE RESISTANCE RATING TO ORIGINAL SPECIFICATIONS.
  - NOTIFICATION APPLIANCES MUST NOT BE BLOCKED BY SCREENS, TELEVISIONS, FURNITURE OR SIMILAR ITEMS. CONTRACTOR MUST COORDINATE FINAL DEVICE LOCATIONS WITH ACTUAL INSTALLATION CONDITIONS.
  - PROVIDE WIRING IN METALLIC CONDUIT IN ACCORDANCE WITH NYC ELECTRICAL CODE (2011). CONDUIT MUST BE SIZED IN ACCORDANCE WITH MAXIMUM FILL REQUIREMENTS, AND MUST BE NO LESS THAN 3/4 IN.
  - FIRE ALARM CABLE SHALL BE FACTORY PAINTED RED. FIRE ALARM SYSTEM JUNCTION BOXES, ENCLOSURES, CABINETS, AND FIRE ALARM POWER DISCONNECTS SHALL BE PAINTED RED PER NYC ELECTRICAL CODE.
  - ALL CONTROL UNITS AND CABINETS MUST BE PROVIDED WITH METAL TAGS THAT ARE EMBOSSED WITH A CLIENT APPROVED SPECIFIC TAG IDENTIFIER.
  - FIRE ALARM SIGNALS SHALL BE TRANSMITTED TO THE SERVICE BUILDING FIRE ALARM PANEL.
  - FIRE ALARM CONTROL UNITS AND ASPIRATING DETECTORS MUST BE CONNECTED TO PRIMARY POWER CIRCUITS THAT ARE SUPPLEMENTED BY THE FACILITY EMERGENCY GENERATOR.
  - BATTERY SECONDARY POWER MUST BE BASED ON 24 HOURS STANDBY WITH 5 MINUTES OF ALARM PER NFPA 72.
  - ALL INITIATING, SIGNALING LINE AND NETWORK COMMUNICATION CIRCUITS MUST BE CLASS A. ALL NOTIFICATION CIRCUITS MUST BE A MINIMUM OF CLASS B.
  - ALL CIRCUITS ENTERING OR LEAVING A BUILDING MUST BE PROTECTED WITH A SURGE PROTECTION DEVICE. CIRCUITS FOR FIRE ALARM DEVICES DIRECTLY ATTACHED TO THE BUILDING EXTERIOR ARE AN EXCEPTION.
  - ALL ELECTRICAL EQUIPMENT AND METALLIC COMPONENTS SHALL BE BONDED AND GROUNDING ACCORDING TO NEW YORK CITY ELECTRICAL CODE ARTICLE 250, HITACHI GROUNDING GUIDELINES, SPECIFICATIONS, AND DETAILS.
  - CONTRACTOR TO PROVIDE GROUNDING DETAILS ON SHOP DRAWING SUBMITTALS.
- SUPPRESSION SYSTEM RELEASING SYSTEM GENERAL NOTES:
- PROVIDE SURGE PROTECTION DEVICE TO PROTECT POWERED SUPPLY CIRCUITS TO THE FIRE ALARM CONTROL UNIT / AUTONOMOUS CONTROL UNIT AND RELEASING SERVICE FIRE ALARM CONTROL UNIT, INCLUDING SUBPANELS SUCH AS AMPLIFIERS OR NOTIFICATION APPLIANCE CIRCUIT, AND FIRE ALARM CIRCUITS LEAVING OR ENTERING THE BUILDING. DEVICES AND APPLIANCES MOUNTED DIRECTLY ON THE EXTERIOR OF THE BUILDING, SUCH AS WALL MOUNTED EXTERIOR NOTIFICATION APPLIANCES, DO NOT REQUIRE SUPPRESSORS. MOUNT SURGE SUPPRESSORS IN A SEPARATE ENCLOSURE, UNLESS IT IS UL LISTED OR FM APPROVED AND INSTALLED IN THE CONTROL UNIT BY THE FACTORY. WHEN PROTECTING A RELEASING SERVICE FIRE ALARM CONTROL UNIT, RELEASING MODULE, OR MONITOR MODULE INTEGRAL TO RELEASING OR STOPPING OF SUPPRESSION SYSTEMS, PROVIDE SURGE PROTECTION DEVICES MEETING REQUIREMENTS OF UL 1283 AND UL 1449.
- NOTIFICATION DESIGN CRITERIA:
- THE SYSTEM IS DESIGNED TO PROVIDE TOTAL EVACUATION VIA PUBLIC MODE OPERATION.
- VISUAL DESIGN CRITERIA:
- STROBE AND COMBINATION HORN/STROBE APPLIANCES, WHEN WALL MOUNTED, MUST BE LOCATED SUCH THAT THE ENTIRE LENS IS NOT LESS THAN 80 IN. AND NOT GREATER THAN 96 IN. ABOVE THE FINISHED FLOOR.
- INITIATING DEVICE NOTES:
- PROVIDE REMOTE ALARM INDICATORS AND TEST SWITCHES FOR CONCEALED DUCT DETECTORS, OR DUCT DETECTORS LOCATED MORE THAN 15 FT AFF. MOUNT REMOTE ALARM INDICATORS AND TEST SWITCHES AT AN ACCESSIBLE LOCATION ON THE WALL.
  - MOUNT SMOKE DETECTORS ON THE BOTTOM OF THE CEILING/DECK (UNLESS NOTED OTHERWISE ON THE DRAWINGS).
  - LOCATE SMOKE DETECTORS MORE THAN 3 FT FROM AIR SUPPLY DIFFUSERS OR RETURN GRILLES.
  - THE OPERABLE PART OF MANUAL PULL STATIONS MUST NOT BE LESS THAN 42 IN AND NOT MORE THAN 4 FT ABOVE FINISHED FLOOR LEVEL, AND LOCATED WITHIN 5 FT OF EACH EXIT DOORWAY.
- POST-FIRE SMOKE PURGE NOTES:
- PER NYCBC SECTION 917, POST-FIRE SMOKE PURGE IS INTENDED FOR THE TIMELY RESTORATION OF OPERATIONS AND OVERHAUL ACTIVITIES ONCE A FIRE IS EXTINGUISHED. THESE SYSTEMS ARE NOT INTENDED OR DESIGNED AS LIFE SAFETY SYSTEMS AND ARE NOT REQUIRED TO MEET THE PROVISIONS OF NYC BC SECTION 909 (SMOKE CONTROL SYSTEMS).
  - CONTROL OF EACH SYSTEM SHALL BE MANUAL ONLY BY FDNY AND SHALL BE INTEGRAL TO THE SERVICE BUILDING RSFACU.
  - A GRAPHIC INDICATING THE PORTIONS OF THE BUILDING SERVED BY EACH POST-FIRE SMOKE PURGE SYSTEM SHALL BE PROVIDED.
  - SEE INPUT/OUTPUT MATRIX FOR SEQUENCE OF OPERATIONS.
  - SEE MECHANICAL DOCUMENTS, INCLUDED IN SEPARATE SUBMITTAL, FOR ADDITIONAL INFORMATION.

SERVICE BUILDING  
FIRE ALARM NOTES

- SYSTEM DESCRIPTION  
A. THIS SYSTEM CONSISTS OF BUILDING FIRE DETECTION, ALARM, ASPIRATING SMOKE DETECTION, PRE-ACTION SPRINKLER RELEASING SERVICE, AND CLEAN AGENT RELEASING SERVICE. THE RSFACU IS THE MAIN CONTROL AND REPORTING UNIT FOR THE FACILITY UNTO WHICH ALL OTHER CONTROL UNITS REPORT TO AND MUST BE LISTED FOR RELEASING SERVICE. A REMOTE ANNUNCIATOR IS LOCATED AT THE MAIN ENTRANCE. REFER TO PRE-ACTION SPRINKLER AND CLEAN AGENT PLANS INCLUDED IN SEPARATE PERMIT SUBMITTALS.
- REMOTE FIRE ALARM CONTROL UNITS  
A. A REMOTE FIRE ALARM CONTROL UNIT IS LOCATED WITHIN THE FIRE PUMP ENCLOSURE, STORAGE ENCLOSURE, AND THE RELAY ENCLOSURE. PROVIDE NETWORK COMMUNICATIONS TO THESE PANELS.
- INITIATING DEVICES  
A. PROVIDE MANUAL PULL STATIONS AT EACH EXTERIOR EXIT DOOR.  
B. PROVIDE CLEAN AGENT MANUAL RELEASE STATIONS IN PROTECTED SPACES AS INDICATED ON PLANS.  
C. PROVIDE CLEAN AGENT ABORT STATIONS IN PROTECTED SPACES AS INDICATED ON PLANS.  
D. PROVIDE COMPLETE SPOT-TYPE COMBINATION SMOKE/HEAT DETECTION THROUGHOUT INCLUDING ABOVE CEILING AND BELOW RAISED FLOOR AS INDICATED ON PLANS. DETECTORS BELOW FLOORS MUST HAVE THEIR LOCATION LABELED AND BE ACCESSIBLE FOR TESTING AND MAINTENANCE.  
E. PROVIDE A HEAT DETECTOR WITHIN THE BREAKROOM TO REDUCE FALSE ALARMS.  
F. DUCT MOUNTED SMOKE DETECTORS MUST BE PROVIDED AS INDICATED FOR HVAC EQUIPMENT. DUCT SMOKE DETECTORS SHALL BE PROVIDED BY FIRE ALARM CONTRACTOR AND INSTALLED BY THE MECHANICAL CONTRACTOR AT LOCATIONS SHOWN ON MECHANICAL DRAWINGS INCLUDED IN SEPARATE SUBMITTAL.  
G. PROVIDE AIR-SAMPLING SMOKE DETECTION BEHIND THE SECOND FLOOR EXTERIOR WALL AND DC HALL HVAC ROOM HVAC INTAKE LOUVERS AS INDICATED ON THE PLANS.  
H. PROVIDE AIR-SAMPLING SMOKE DETECTION IN HVAC DUCTS AS INDICATED ON THE PLANS. DUCT INSTALLATION SHALL BE IN ACCORDANCE WITH VESDA MANUFACTURERS INSTRUCTION.  
I. PROVIDE PRE-ACTION VALVE RISER AND ASSOCIATED APPURTENANCES MONITORING AS INDICATED ON PLANS.  
J. PROVIDE CLEAN AGENT SYSTEM MONITORING AS INDICATED ON PLANS.
- RELEASING DEVICES  
A. THE PRE-ACTION VALVE MUST BE RELEASED UPON ACTIVATION OF ONE OR MORE SMOKE DETECTORS AND ACTIVATION OF LOW AIR SIGNAL. TWO CONDITIONS MUST BE MET TO ACTIVATE THE PRE-ACTION RELEASE SOLENOID. CLEAN AGENT MUST BE RELEASED UPON ACTIVATION OF TWO OR MORE SMOKE DETECTORS WITHIN THE PROTECTED SPACES OR ACTIVATION OF CLEAN AGENT MANUAL RELEASE STATION.
- NOTIFICATION  
A. GENERAL FIRE ALARM NOTIFICATION  
a. REFER TO FIRE ALARM GENERAL NOTES  
B. CLEAN AGENT NOTIFICATION  
a. REFER TO CLEAN AGENT PLANS INCLUDED IN SEPARATE PERMIT SUBMITTAL FOR LOCATION OF CLEAN AGENT NOTIFICATION APPLIANCES.  
b. CLEAN AGENT NOTIFICATION DEVICES MUST ACTIVATE INDEPENDENTLY FROM GENERAL FIRE ALARM NOTIFICATION DEVICES FOR THE PROTECTED SPACES THEY ARE WITHIN. UPON CLEAN AGENT PRE-DISCHARGE OR DISCHARGE EVENT WITHIN A PROTECTED SPACE, THE GENERAL FIRE ALARM NOTIFICATION DEVICES WITHIN THE PROTECTED SPACE MUST BE DEACTIVATED. UNDER NO CIRCUMSTANCES WILL A FIRE ALARM NOTIFICATION APPLIANCE AND A CLEAN AGENT NOTIFICATION APPLIANCE BE ACTIVE AT THE SAME TIME WITHIN A ROOM PROVIDED WITH A CLEAN AGENT FIRE EXTINGUISHING SYSTEM.
- HAZARDOUS AREA DEVICES  
A. WITHOUT EXCEPTION, ALL INITIATING AND NOTIFICATION DEVICES WITHIN BATTERY ROOMS MUST BE LISTED FOR USE WITHIN CLASS 1 DIVISION 2 HAZARDOUS LOCATIONS.

CONVERTER BUILDING  
FIRE ALARM NOTES

- SYSTEM DESCRIPTION  
A. THIS SYSTEM CONSISTS OF AN ASPIRATING SMOKE DETECTION SYSTEM. THE ASPIRATING SMOKE DETECTION UNITS MUST BE LOCATED AS SHOWN ON THE PLANS AND RISER DIAGRAM TO MINIMIZE SAMPLING PIPE LENGTH TO THE EXTENT POSSIBLE, AND MONITORED BY THE MAIN RSFACU, ALSO IN THE SERVICE BUILDING.
- THE CONVERTER HALLS ARE UNOCCUPIED, UNACCESSIBLE, AND ACCESS CONTROLLED DURING NORMAL FACILITY OPERATIONS.
- NOTIFICATION  
A. AUDIBLE AND VISUAL NOTIFICATION IS NOT PROVIDED WITHIN THE CONVERTER BUILDING.
- ASPIRATING SMOKE DETECTION UNIT AND SAMPLING PIPE  
A. PROVIDE ALL NECESSARY EQUIPMENT AND COMPONENTS TO CREATE A VESDANET NETWORK CONSISTING OF ALL VESDA AIR-SAMPLING DETECTORS WITH CONNECTION TO THE MAIN FIRE ALARM CONTROL PANEL IN THE SERVICE BUILDING.  
B. EACH CONVERTER HALL INDICATED MUST HAVE AT LEAST ONE DEDICATED ASPIRATING SMOKE DETECTION SYSTEM. THE ASPIRATING SMOKE DETECTOR UNIT MUST BE LOCATED OUTSIDE THE CONVERTER HALLS DUE TO ELECTROMAGNETIC INTERFERENCE (EMI).  
C. SAMPLE PIPING SHALL BE LOCATED IN-LINE WITH AND ABOVE ELECTRICAL EQUIPMENT AS INDICATED ON THE PLANS, AND FASTENED TO BOTTOM OF THE STRUCTURE.  
D. EACH DETECTION ZONE MUST HAVE A CONDENSATE DRAIN PHYSICALLY LOCATED OUTSIDE OF THE ASSOCIATED ROOM AND UPSTREAM OF THE ASPIRATING SMOKE DETECTOR UNIT. EACH DETECTION ZONE MUST HAVE A TEST CONNECTION EXTENDED TO THE FLOOR LEVEL WITHIN THE ROOM TO FACILITATE MAINTENANCE AND REQUIRED TESTING DURING FACILITY DOWNTIME.  
E. EACH DETECTION ZONE MUST HAVE AN ADDITIONAL TEST CONNECTION PHYSICALLY LOCATED OUTSIDE OF THE ASSOCIATE ROOM FOR SYSTEM TESTING DURING NORMAL FACILITY OPERATION. A CONDENSATE DRAIN MUST ALSO BE PROVIDED FOR EACH TEST CONNECTION AND PHYSICALLY LOCATED OUTSIDE OF THE ASSOCIATED CONVERTER HALL.  
F. EACH ASPIRATING SMOKE DETECTION UNIT WILL BE MONITORED BY THE MAIN RSFACU LOCATED WITHIN THE SERVICE BUILDING AND UTILIZE THREE DETECTOR THRESHOLDS, AS IDENTIFIED IN THE MATRIX. REFER TO INPUT/OUTPUT MATRIX FOR ACTIONS.  
G. TRANSPORT TIME SHALL NOT EXCEED 120 SECONDS PER NFPA 72, HOWEVER, SAMPLE AND EXHAUST PIPING LENGTHS SHALL BE KEPT TO A MINIMUM TO MINIMIZE TRANSPORT TIME TO THE EXTENT POSSIBLE.

RELAY ENCLOSURE  
FIRE ALARM NOTES

- SYSTEM DESCRIPTION  
A. THE SYSTEM CONSISTS OF BUILDING FIRE DETECTION, ALARM AND CLEAN AGENT RELEASING. A DEDICATED FIRE ALARM CONTROL UNIT MUST BE PROVIDED, NETWORKED TO THE MAIN FIRE ALARM CONTROL UNIT IN THE SERVICE BUILDING, AND LISTED FOR RELEASING SERVICE.
- INITIATING DEVICES  
A. PROVIDE COMPLETE COMBINATION SMOKE/HEAT DETECTION THROUGHOUT INCLUDING BELOW RAISED FLOORS.  
B. PROVIDE CLEAN AGENT SYSTEM MONITORING AS INDICATED ON PLANS. INCLUDED IN SEPARATE SUBMITTAL.
- RELEASING DEVICES  
A. CLEAN AGENT MUST BE RELEASED UPON ACTIVATION OF TWO OR MORE COMBINATION SMOKE/HEAT DETECTORS.
- NOTIFICATION  
A. GENERAL FIRE ALARM NOTIFICATION  
a. REFER TO FIRE ALARM GENERAL NOTES  
B. CLEAN AGENT NOTIFICATION  
a. REFER TO CLEAN AGENT PLANS INCLUDED IN SEPARATE PERMIT SUBMITTAL FOR LOCATION OF CLEAN AGENT NOTIFICATION APPLIANCES.  
b. CLEAN AGENT NOTIFICATION DEVICES MUST ACTIVATE INDEPENDENTLY FROM GENERAL FIRE ALARM NOTIFICATION DEVICES FOR THE PROTECTED SPACES THEY ARE WITHIN. UPON CLEAN AGENT PRE-DISCHARGE OR DISCHARGE EVENT WITHIN A PROTECTED SPACE, THE GENERAL FIRE ALARM NOTIFICATION DEVICES WITHIN THE PROTECTED SPACE MUST BE DEACTIVATED. UNDER NO CIRCUMSTANCES WILL A FIRE ALARM NOTIFICATION APPLIANCE AND A CLEAN AGENT NOTIFICATION APPLIANCE BE ACTIVE AT THE SAME TIME WITHIN A ROOM PROVIDED WITH A CLEAN AGENT FIRE EXTINGUISHING SYSTEM.

STORAGE ENCLOSURE  
FIRE ALARM NOTES

















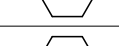
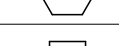
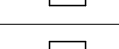
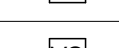
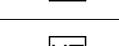
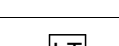
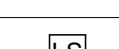
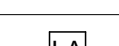
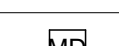
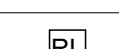



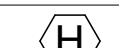

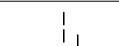





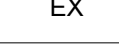
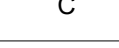
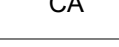
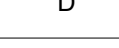
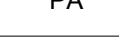
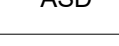
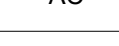
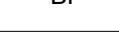
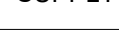

- SYSTEM DESCRIPTION  
A. THE SYSTEM CONSISTS OF BUILDING FIRE DETECTION, ALARM AND WET PIPE SPRINKLER SYSTEM MONITORING. A DEDICATED FIRE ALARM CONTROL UNIT MUST BE PROVIDED AND NETWORKED TO THE MAIN FIRE ALARM CONTROL UNIT IN THE SERVICE BUILDING.
- INITIATING DEVICES  
A. PROVIDE A MANUAL PULL STATION AT EACH EXIT DOOR.  
B. PROVIDE COMPLETE COMBINATION SMOKE/HEAT DETECTION THROUGHOUT.  
C. MONITOR WATERFLOW AND ASSOCIATED TAMPER SWITCHES FOR THE WET PIPE SYSTEM.
- NOTIFICATION  
A. GENERAL FIRE ALARM NOTIFICATION  
a. REFER TO FIRE ALARM GENERAL NOTES

MVS ENCLOSURE  
FIRE ALARM NOTES

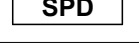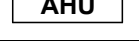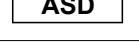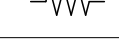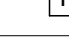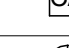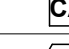
- SYSTEM DESCRIPTION  
A. THE SYSTEM CONSISTS OF BUILDING FIRE DETECTION AND ALARM. FIRE ALARM DEVICES MUST BE CONNECTED TO THE MAIN RSFACU LOCATED WITHIN THE SERVICE BUILDING.
- INITIATING DEVICES  
A. PROVIDE A MANUAL PULL STATION AT EACH EXIT DOOR.  
B. PROVIDE COMPLETE COMBINATION SMOKE/HEAT DETECTION THROUGHOUT.
- NOTIFICATION  
A. GENERAL FIRE ALARM NOTIFICATION  
a. REFER TO FIRE ALARM GENERAL NOTES

FIRE PUMP ENCLOSURE  
FIRE ALARM NOTES

- SYSTEM DESCRIPTION  
A. THE SYSTEM CONSISTS OF BUILDING FIRE DETECTION AND ALARM, FIRE PUMP ENCLOSURE, WET PIPE SPRINKLER SYSTEM MONITORING, FIRE WATER STORAGE TANK MONITORING, TRANSFORMER DELUGE VALVE ACTIVATION, AND FIRE PUMP MONITORING. A DEDICATED FIRE ALARM CONTROL UNIT MUST BE PROVIDED, NETWORKED TO THE MAIN FIRE ALARM CONTROL UNIT IN THE SERVICE BUILDING, AND LISTED FOR RELEASING SERVICE.
- INITIATING DEVICES  
A. PROVIDE A MANUAL PULL STATION AT EACH EXIT DOOR.  
B. MONITOR FIRE PUMP ENCLOSURE FOR LOW TEMPERATURE.  
C. MONITOR WATERFLOW AND ASSOCIATED TAMPER SWITCHES FOR THE WET PIPE SYSTEM SERVING THE FIRE PUMP ENCLOSURE.  
D. MONITOR FIRE WATER STORAGE TANK FOR LOW TEMPERATURE AND LOW WATER LEVEL.  
E. MONITOR TAMPER SWITCHES ASSOCIATED WITH THE FIRE PUMP SUCTION AND DISCHARGE PIPING.  
F. MONITOR FIRE PUMP CONTROLLER SIGNALS AS INDICATED.  
G. TRANSFORMER LINEAR HEAT DETECTION SHALL BE ATTACHED DIRECTLY TO DELUGE SPRINKLER PIPING.
- RELEASING CIRCUITS  
A. PROVIDE RELEASING CIRCUITS FOR THREE DELUGE VALVES SERVING THE TRANSFORMERS.
- NOTIFICATION  
A. REFER TO FIRE ALARM GENERAL NOTES

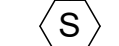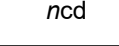FIRE ALARM LEGEND	
	FIRE ALARM CONTROL UNIT
	RELEASING SERVICE FIRE ALARM CONTROL UNIT
	FIRE PUMP CONTROLLER
	JOCKEY PUMP CONTROLLER
	DIGITAL ALARM COMMUNICATOR TRANSMITTER
	FIRE ALARM ANNUNCIATOR
	SURGE PROTECTIVE DEVICE
	AIR HANDLING UNIT
	ASPIRATING SMOKE DETECTION CONTROL UNIT (VESDA)
	END-OF-LINE RESISTOR
	MANUAL PULL STATION
	CLEAN AGENT MANUAL RELEASE STATION
	CLEAN AGENT ABORT STATION
	ADDRESSABLE INPUT MODULE
	ADDRESSABLE OUTPUT MODULE
	CLEAN AGENT ELECTRIC RELEASE ACTUATOR
	DELUGE ELECTRIC RELEASE ACTUATOR
	PRE-ACTION ELECTRIC RELEASE ACTUATOR
	WATERFLOW SWITCH
	PRESSURE SWITCH
	VALVE SUPERVISORY SWITCH
	HEAT TRACE
	LOW TEMPERATURE SWITCH
	HIGH/LOW LEVEL SWITCH
	LOW AIR SWITCH
	MAINTENANCE DISCONNECT SWITCH
	RELAY MODULE
	HORN/STROBE - WALL MOUNT
	HORN/STROBE - CEILING MOUNT
	HEAT DETECTOR - LINE TYPE
	HEAT DETECTOR
	COMBINATION HEAT AND SMOKE DETECTOR - SPOT TYPE
	SMOKE DETECTOR - DUCT TYPE
	FIRE/SMOKE DAMPER
	SPOT ELEVATION - HEIGHT ABOVE FINISHED FLOOR
SYMBOL MODIFIERS	
	CANDELA RATING
	WEATHER PROOF
	EXPLOSION PROOF
	CEILING MOUNT
	CLEAN AGENT
	DELUGE
	PRE-ACTION
	ASPIRATING SMOKE DETECTOR (VESDA)
	ABOVE CEILING
	BELOW FLOOR
	SUPPLY DUCT
	RETURN DUCT

RATED WALL LEGEND


	2 HOUR FIRE BARRIER
NOTE: RATED WALLS ARE REFERENCED FROM ARCHITECTURAL PLANS. INCLUDED IN SEPARATE PERMIT SUBMITTAL.	

ISSUED FOR PERMIT



Poole Fire Protection  
19910 W. 161st Street  
Olathe, KS 66062  
TEL: 913.865.0900 FAX: 913.865.0901

19910 W. 161st STREET  
OLATHE, KS. 66062

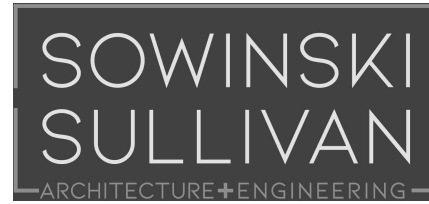

25 Mohawk Avenue  
Sparta, NJ 07871

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B	FINAL SUBMISSION	SAB	AWP	12/12/2022	
A	INTERIM SUBMISSION	SAB	AWP	09/13/2022	
REV	DESCRIPTION	DRW BY	CHK BY	DATE	



470 Chestnut Ridge Rd # 2,  
Woodcliff Lake, NJ 07677

Hitachi Energy

901 Main Campus Drive  
Raleigh, North Carolina 27606

PROJECT

**CHPE**  
Champlain Hudson  
Power Express

Astoria HVDC  
Converter Station

31-45 20<sup>th</sup> Avenue, Astoria, Queens NY 11105  
Block #850 - Lot #310 - BIN #4624437

FIRE ALARM GENERAL  
NOTES AND LEGEND



DATE 12/12/2022  
PROJECT NO 105121  
DRAWING BY S. BRINKMEYER  
CHECKED BY A. POOLE  
DRAWING NO

**FA-003.00**

CADD FILE NO  
Astoria CHA-RE-111-00-M3-FP-001.rvt  
3 of 18







1	INPUT/OUTPUT MATRIX - STORAGE ENCLOSURE FACU
FA-005.00	NONE

SYSTEM INPUTS
<b>ALARMS CONDITIONS</b>
MANUAL PULL STATION
HEAT/SMOKE DETECTOR - SPOT TYPE
WATERFLOW/PRESSURE SWITCH
<b>SUPERVISORY CONDITIONS</b>
CONTROL VALVE SUPERVISORY SWITCH
<b>TROUBLE CONDITIONS</b>
AC POWER FAILURE
LOW BATTERY
OPEN CIRCUIT
GROUND FAULT
NOTIFICATION APPLIANCE CIRCUIT SHORT
REMOTE POWER SUPPLY COMMON TROUBLE
ANY OTHER SYSTEM TROUBLE
<b>AUXILIARY CONDITIONS</b>
POST FIRE SMOKE PURGE ACTIVATION

X PERFORM OPERATION/REPORT DEVICE STATUS

[illegible]

2	INPUT/OUTPUT MATRIX - RELAY ENCLOSURE RSFACU
FA-005.00	NONE

SYSTEM INPUTS	
<b>ALARM CONDITIONS</b>	
1	MANUAL PULL STATION
2	CLEAN AGENT MANUAL RELEASE STATION IN PROTECTED SPACE
3	CLEAN AGENT - ONE HEAT/SMOKE DETECTOR IN PROTECTED SPACE
4	CLEAN AGENT - TWO HEAT/SMOKE DETECTORS IN PROTECTED SPACE
5	CLEAN AGENT - COUNT DOWN TIMER EXPIRED
<b>SUPERVISORY CONDITIONS</b>	
6	CLEAN AGENT MAINTENANCE DISCONNECT SWITCH
7	CLEAN AGENT - DEPRESS ABORT STATION BUTTON
8	CLEAN AGENT - RELEASE ABORT STATION BUTTON
9	CLEAN AGENT - ACTUATOR REMOVED FROM STORAGE CONTAINER
<b>TROUBLE CONDITIONS</b>	
10	AC POWER FAILURE
11	LOW BATTERY
12	OPEN CIRCUIT
13	GROUND FAULT
14	NOTIFICATION APPLIANCE CIRCUIT SHORT
15	REMOTE POWER SUPPLY COMMON TROUBLE
16	ANY OTHER SYSTEM TROUBLE

X PERFORM OPERATION/REPORT DEVICE STATUS

[illegible]

**SHEET NOTES:**

1. REFER TO MECHANICAL DRAWINGS INCLUDED IN SEPARATE SUBMITTAL FOR DETAILED POST-FIRE SMOKE PURGE EQUIPMENT SEQUENCE OF OPERATIONS.

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Sparta, NJ 07871**

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A	INTERIM SUBMISSION	SAB	AWP	09/13/2022
REV	DESCRIPTION	DRW BY	CHK BY	DATE



# Kiewit

470 Chestnut Ridge Rd # 2  
Woodcliff Lake, NJ 07677



901 Main Campus Drive  
Raleigh, North Carolina 27606

## PROJECT



# Astoria HVDC Converter Station

31-45 20<sup>th</sup> Avenue, Astoria, Queens NY 11105  
Block #850 - Lot #310 - BIN #4624437

## INPUT/OUTPUT MATRIX



DATE	12/12/2022
PROJECT NO	105121
DRAWING BY	S. BRINKMEYER
CHECKED BY	A. POOLE

FA-005.00

CADD FILE NO  
Autodesk Docs\CHPIE  
Astoria\CHA-KIE-111-00-M3-FP-001.rvt


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3	INPUT/OUTPUT MATRIX - FIRE PUMP ENCLOSURE FACU
FA-005.00	NONE








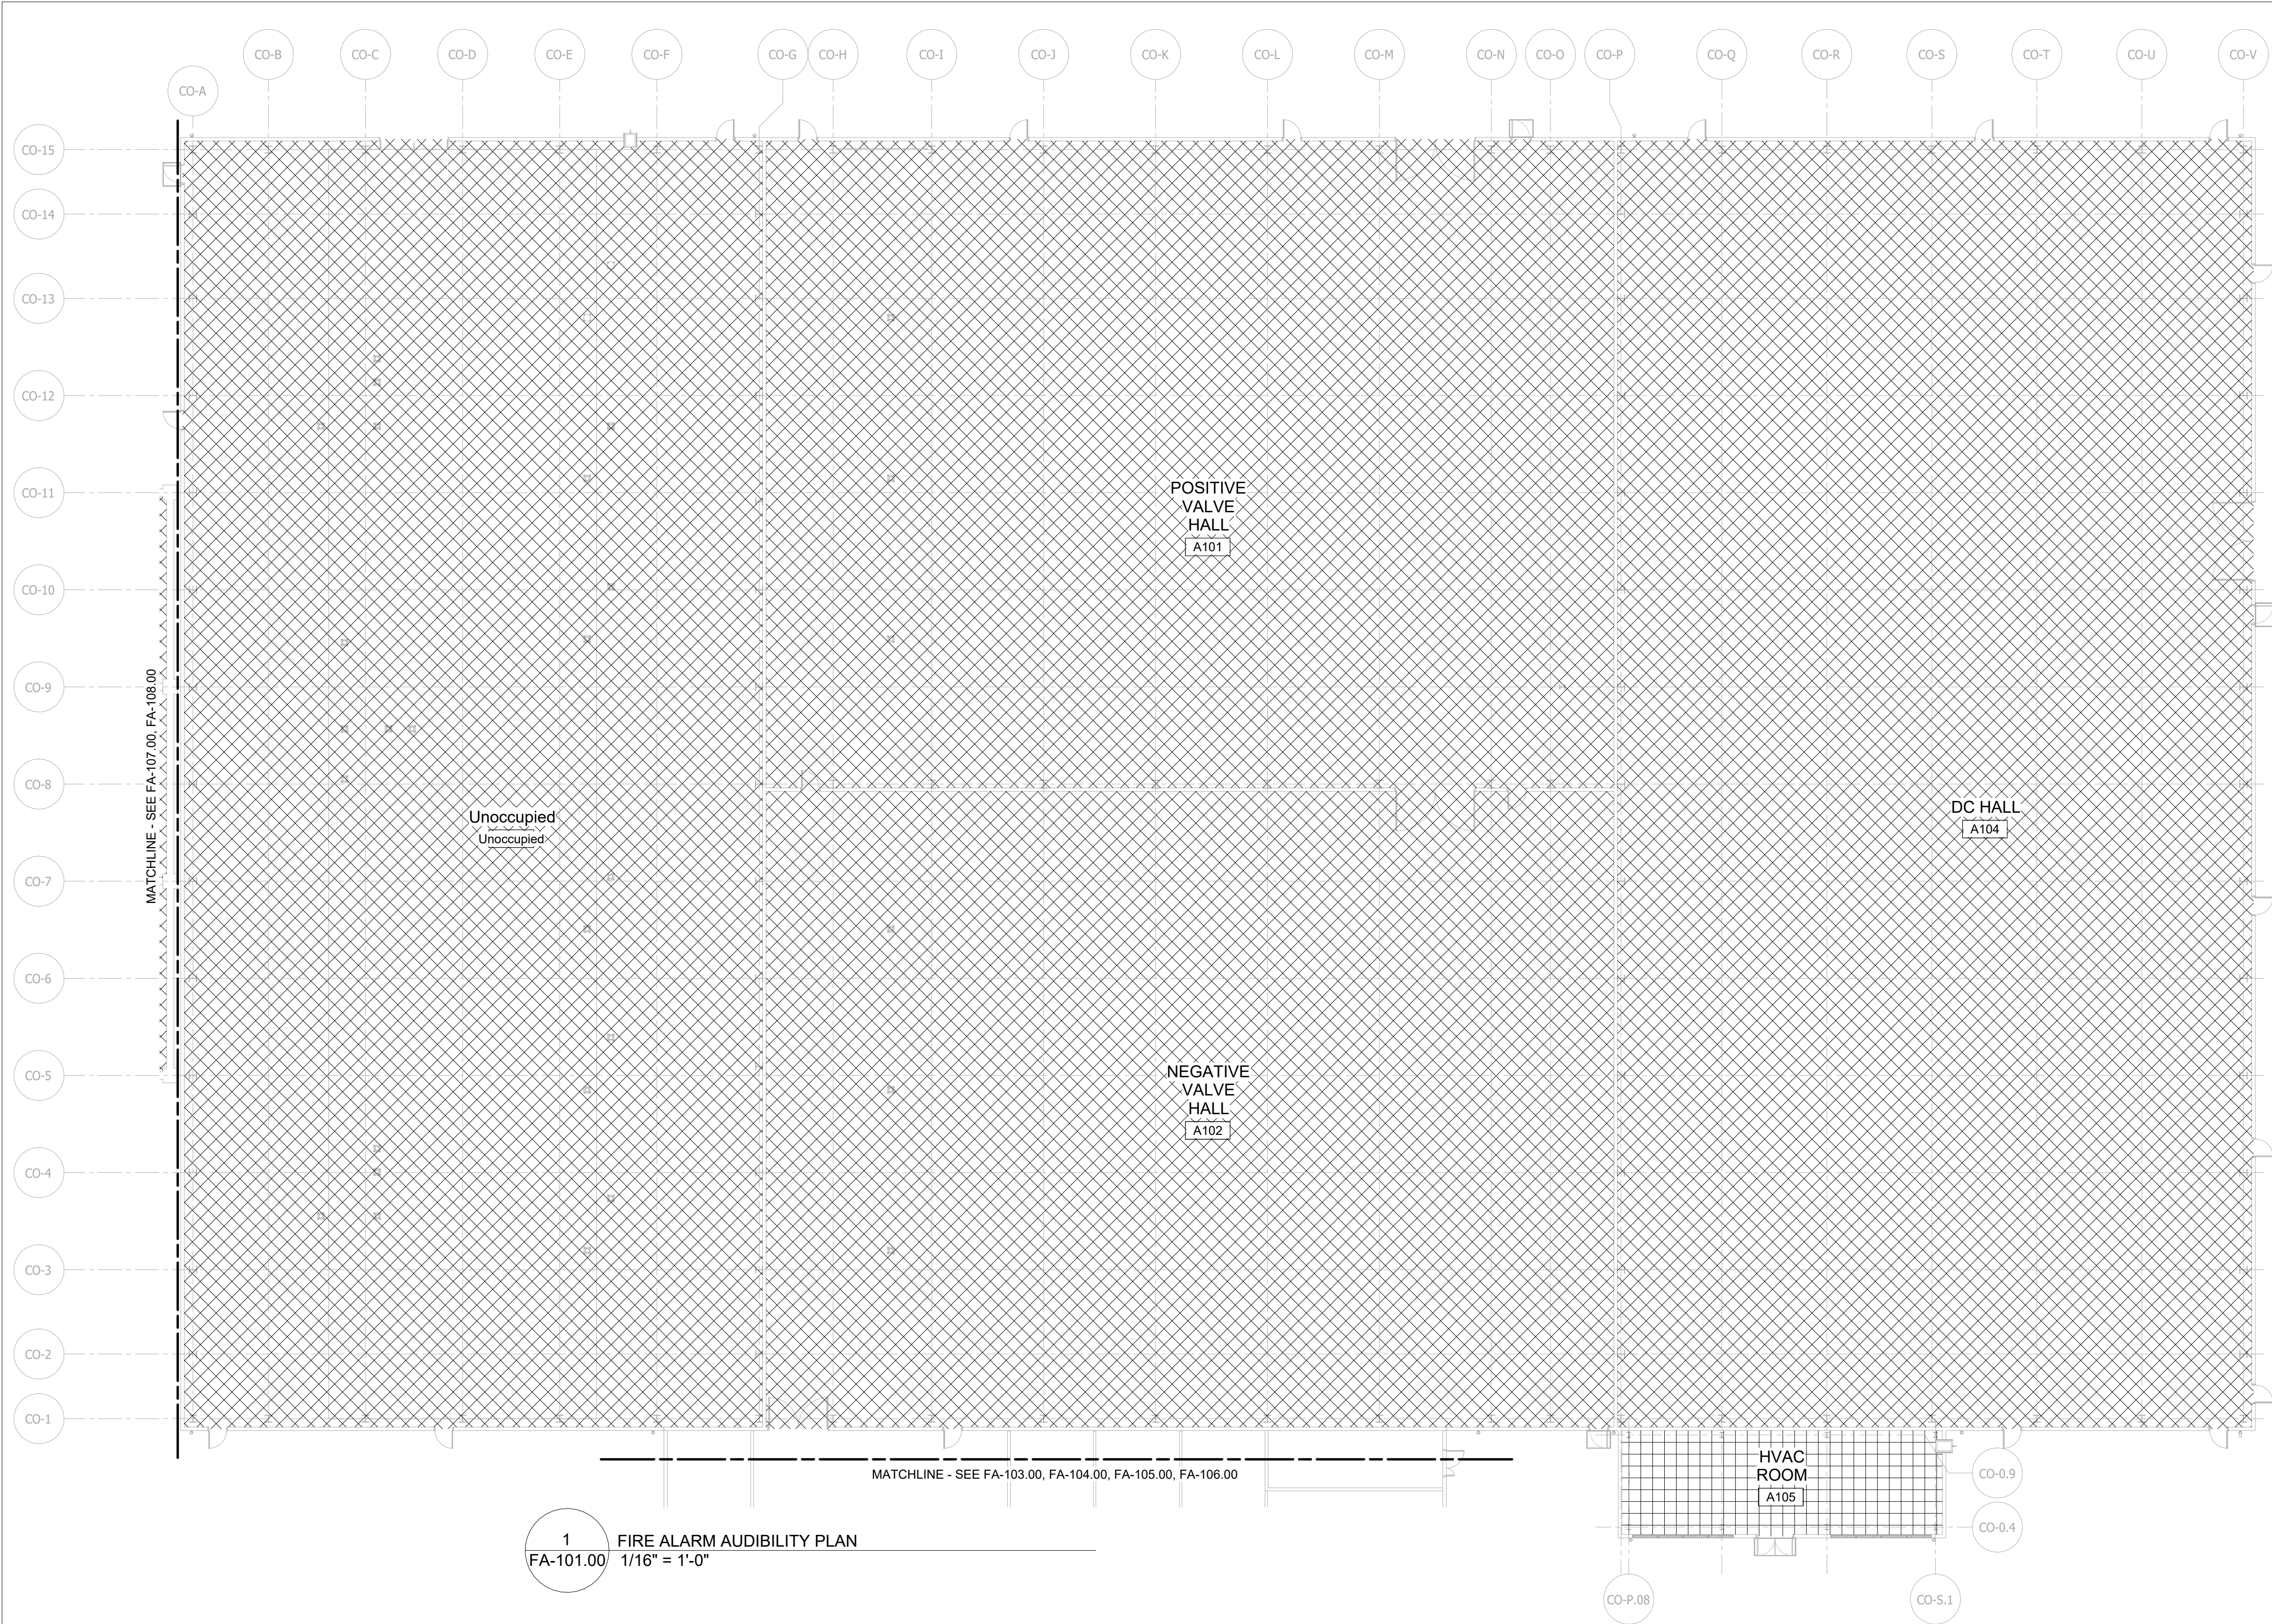

1 FIRE ALARM AUDIBILITY PLAN  
FA-101.00/ 1/16" = 1'-0"

AUDIBILITY HATCH LEGEND	
	FIRE ALARM NOTIFICATION NOT REQUIRED
	91dB AMBIENT SPL 106dB EXPECTED SPL

ISSUED FOR PERMIT

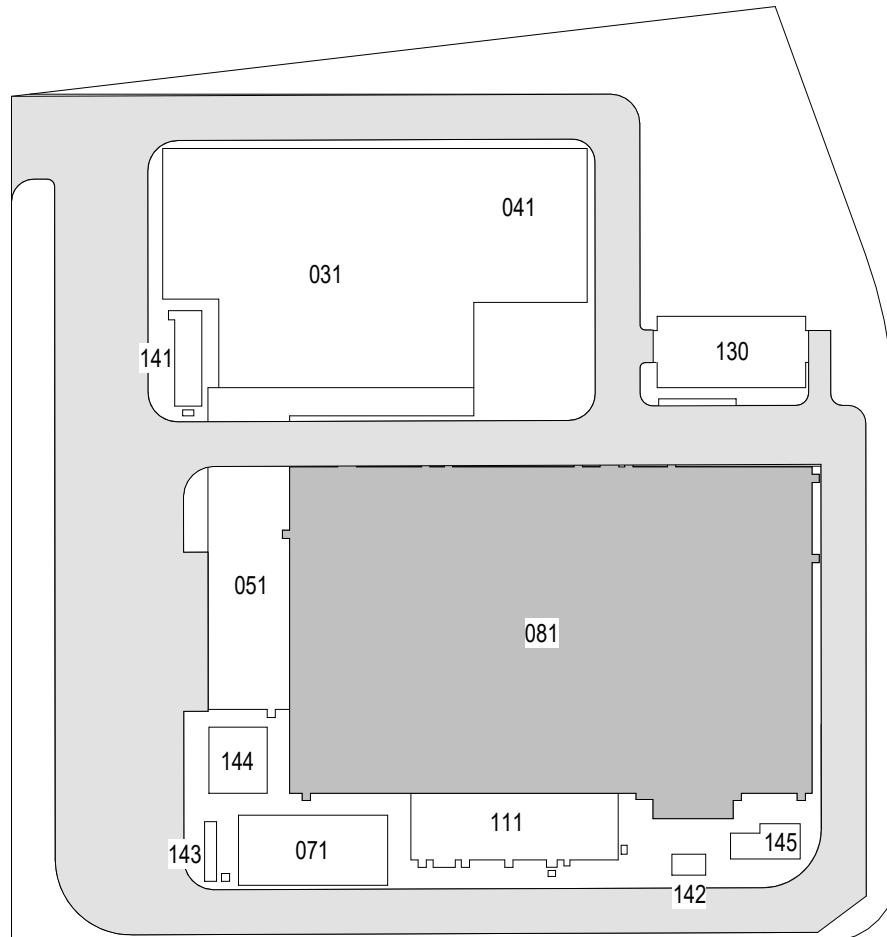


KEY PLAN  
N.T.S.



**Poole Fire Protection**  
19910 W. 161st Street  
Olathe, KS 66062  
TEL: 816.666.0000 FAX: 816.666.0001

19910 W. 161st STREET  
OLATHE, KS. 66062

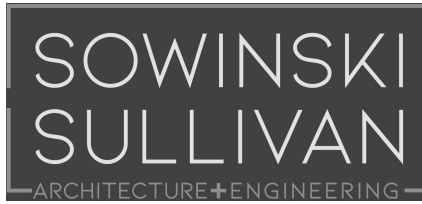

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Sparta, NJ 07871

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REV	DESCRIPTION	DRW BY	CHK BY	DATE



**Kiewit**

470 Chestnut Ridge Rd # 2,  
Woodcliff Lake, NJ 07677

**Hitachi Energy**

901 Main Campus Drive  
Raleigh, North Carolina 27606


PROJECT

**CHPE**  
Champlain Hudson  
Power Express

**Astoria HVDC  
Converter Station**

31-45 20<sup>th</sup> Avenue, Astoria, Queens NY 11105  
Block #850 - Lot #310 - BIN #4624437

**CONVERTER BUILDING -  
FIRE ALARM AUDIBILITY  
PLAN**

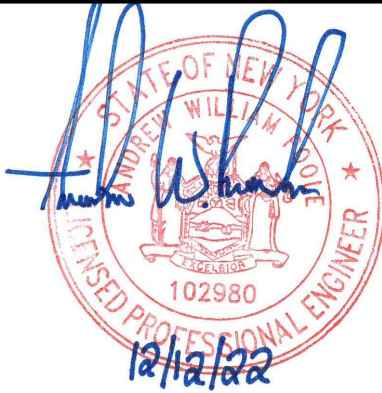

DATE 12/12/2022  
PROJECT NO 105121  
DRAWING BY S. BRINKMEYER  
CHECKED BY A. POOLE

DRAWING NO


**FA-101.00**

CADD FILE NO  
AstoriaHVDC-CHPE  
AstoriaCHPE-081-00-M3-FP-001.rvt

7 of 18



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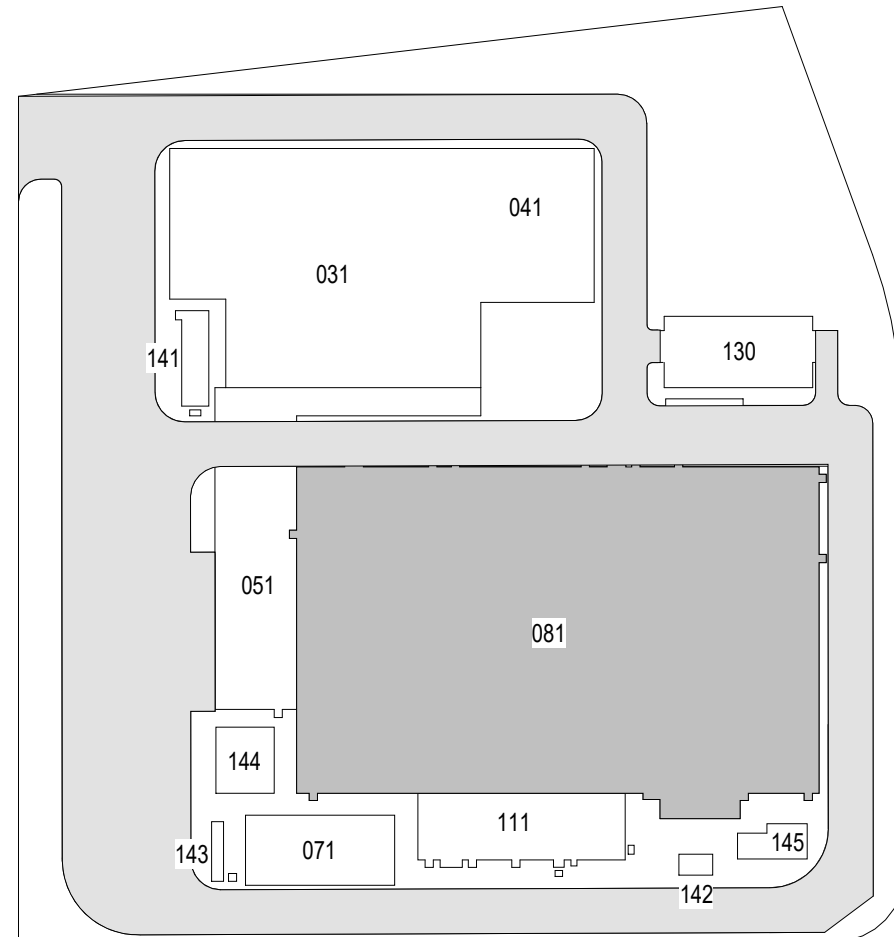


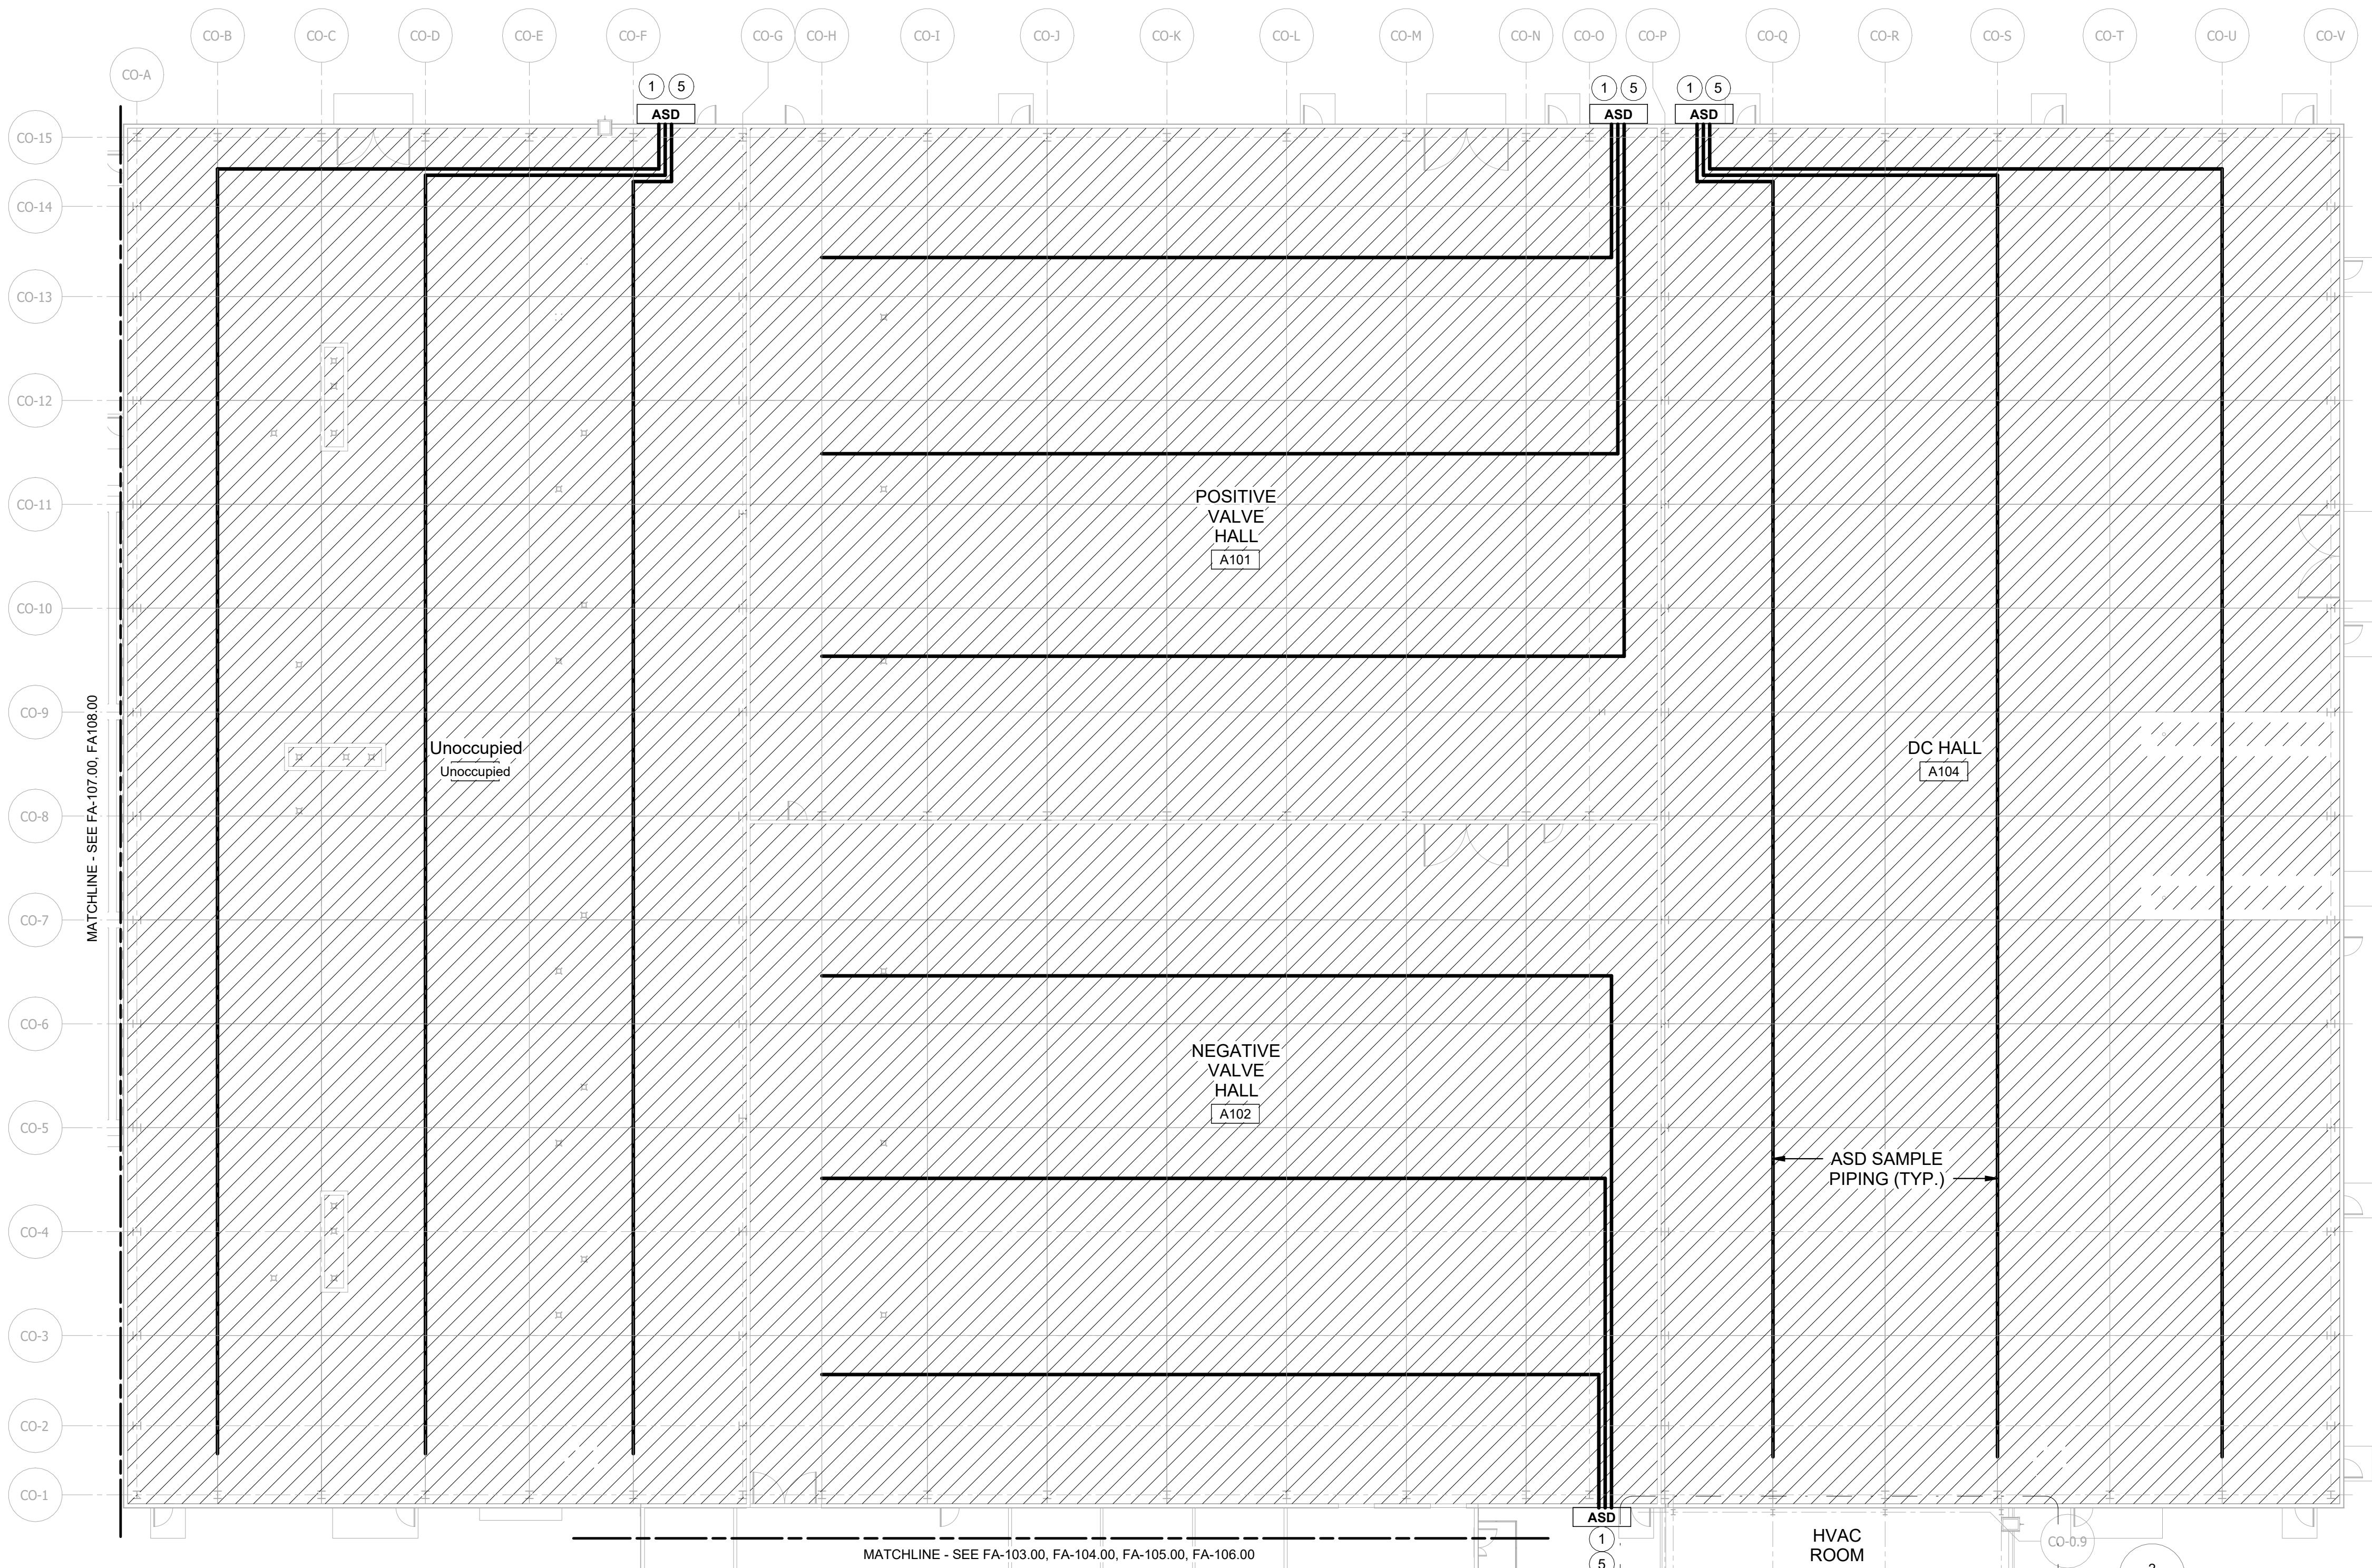FIRE ALARM HATCH LEGEND	
	VESDA ASPIRATING SMOKE DETECTION THROUGHOUT

KEYNOTES

- 1 PROVIDE AIR SAMPLING CONTROL UNIT WITHIN AN OUTDOOR NEMA 4 TEMPERATURE-CONTROLLED CABINET.
- 2 LINEAR HEAT DETECTION CIRCUIT SHALL BE MONITORED BY RSFACU LOCATED WITHIN FIRE PUMP ENCLOSURE. REFER TO MECHANICAL AND ELECTRICAL DRAWINGS INCLUDED IN SEPARATE PERMIT APPLICATION.
- 3 AIR-SAMPLING DETECTOR SHALL ACT AS A REFERENCE DETECTOR TO THE DC HALL AIR-SAMPLING DETECTORS, AND SHALL BE CONNECTED TO THOSE DETECTORS VIA A VESDA-NET CIRCUIT.
- 4 HEAT DETECTORS SHALL BE INSTALLED AT BOTTOM OF ROOF DECK.
- 5 SAMPLING PIPE ROUTING SHOWN IS SCHEMATIC IN NATURE. ACTUAL PIPE ROUTING AND SAMPLE POINTS SHALL BE DETERMINED BASED ON ACTUAL EQUIPMENT LOCATIONS UNIQUE TO EACH CONVERTER HALL. FINAL CONFIGURATION SHALL BE VERIFIED USING MANUFACTURER-SPECIFIC SOFTWARE TO CONFIRM TRANSPORT TIME AND DETECTION THRESHOLD PERFORMANCE CRITERIA.
- 6 SAMPLE PIPING SHOWN TO RUN THROUGH DC HALL TO WARM SAMPLING AIR PRIOR TO ENTERING CONTROL UNIT.

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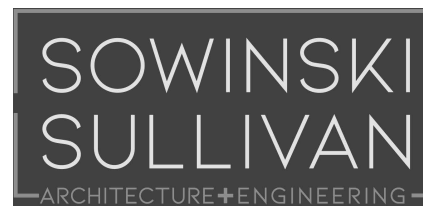


KEY PLAN  
N.T.S.



Poole Fire Protection  
19910 W. 161st Street  
Olathe, KS 66062  
TEL: 913.251.1000 FAX: 913.251.1001

19910 W. 161st STREET  
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470 Chestnut Ridge Rd # 2,  
Woodcliff Lake, NJ 07677

**Hitachi Energy**

901 Main Campus Drive  
Raleigh, North Carolina 27606

PROJECT

**CHPE**  
Champlain Hudson  
Power Express

**Astoria HVDC  
Converter Station**


31-45 20<sup>th</sup> Avenue, Astoria, Queens NY 11105  
Block #850 - Lot #310 - BIN #4624437

**CONVERTER BUILDING -  
FIRE ALARM PLAN**




DATE 12/12/2022  
PROJECT NO 105121  
DRAWING BY S. BRINKMEYER  
CHECKED BY A. POOLE  
DRAWING NO  
**FA-102.00**  
CADD FILE NO  
AstoriaHVDC-CHPE-081-00-M3-FP-001.rvt  
8 of 18



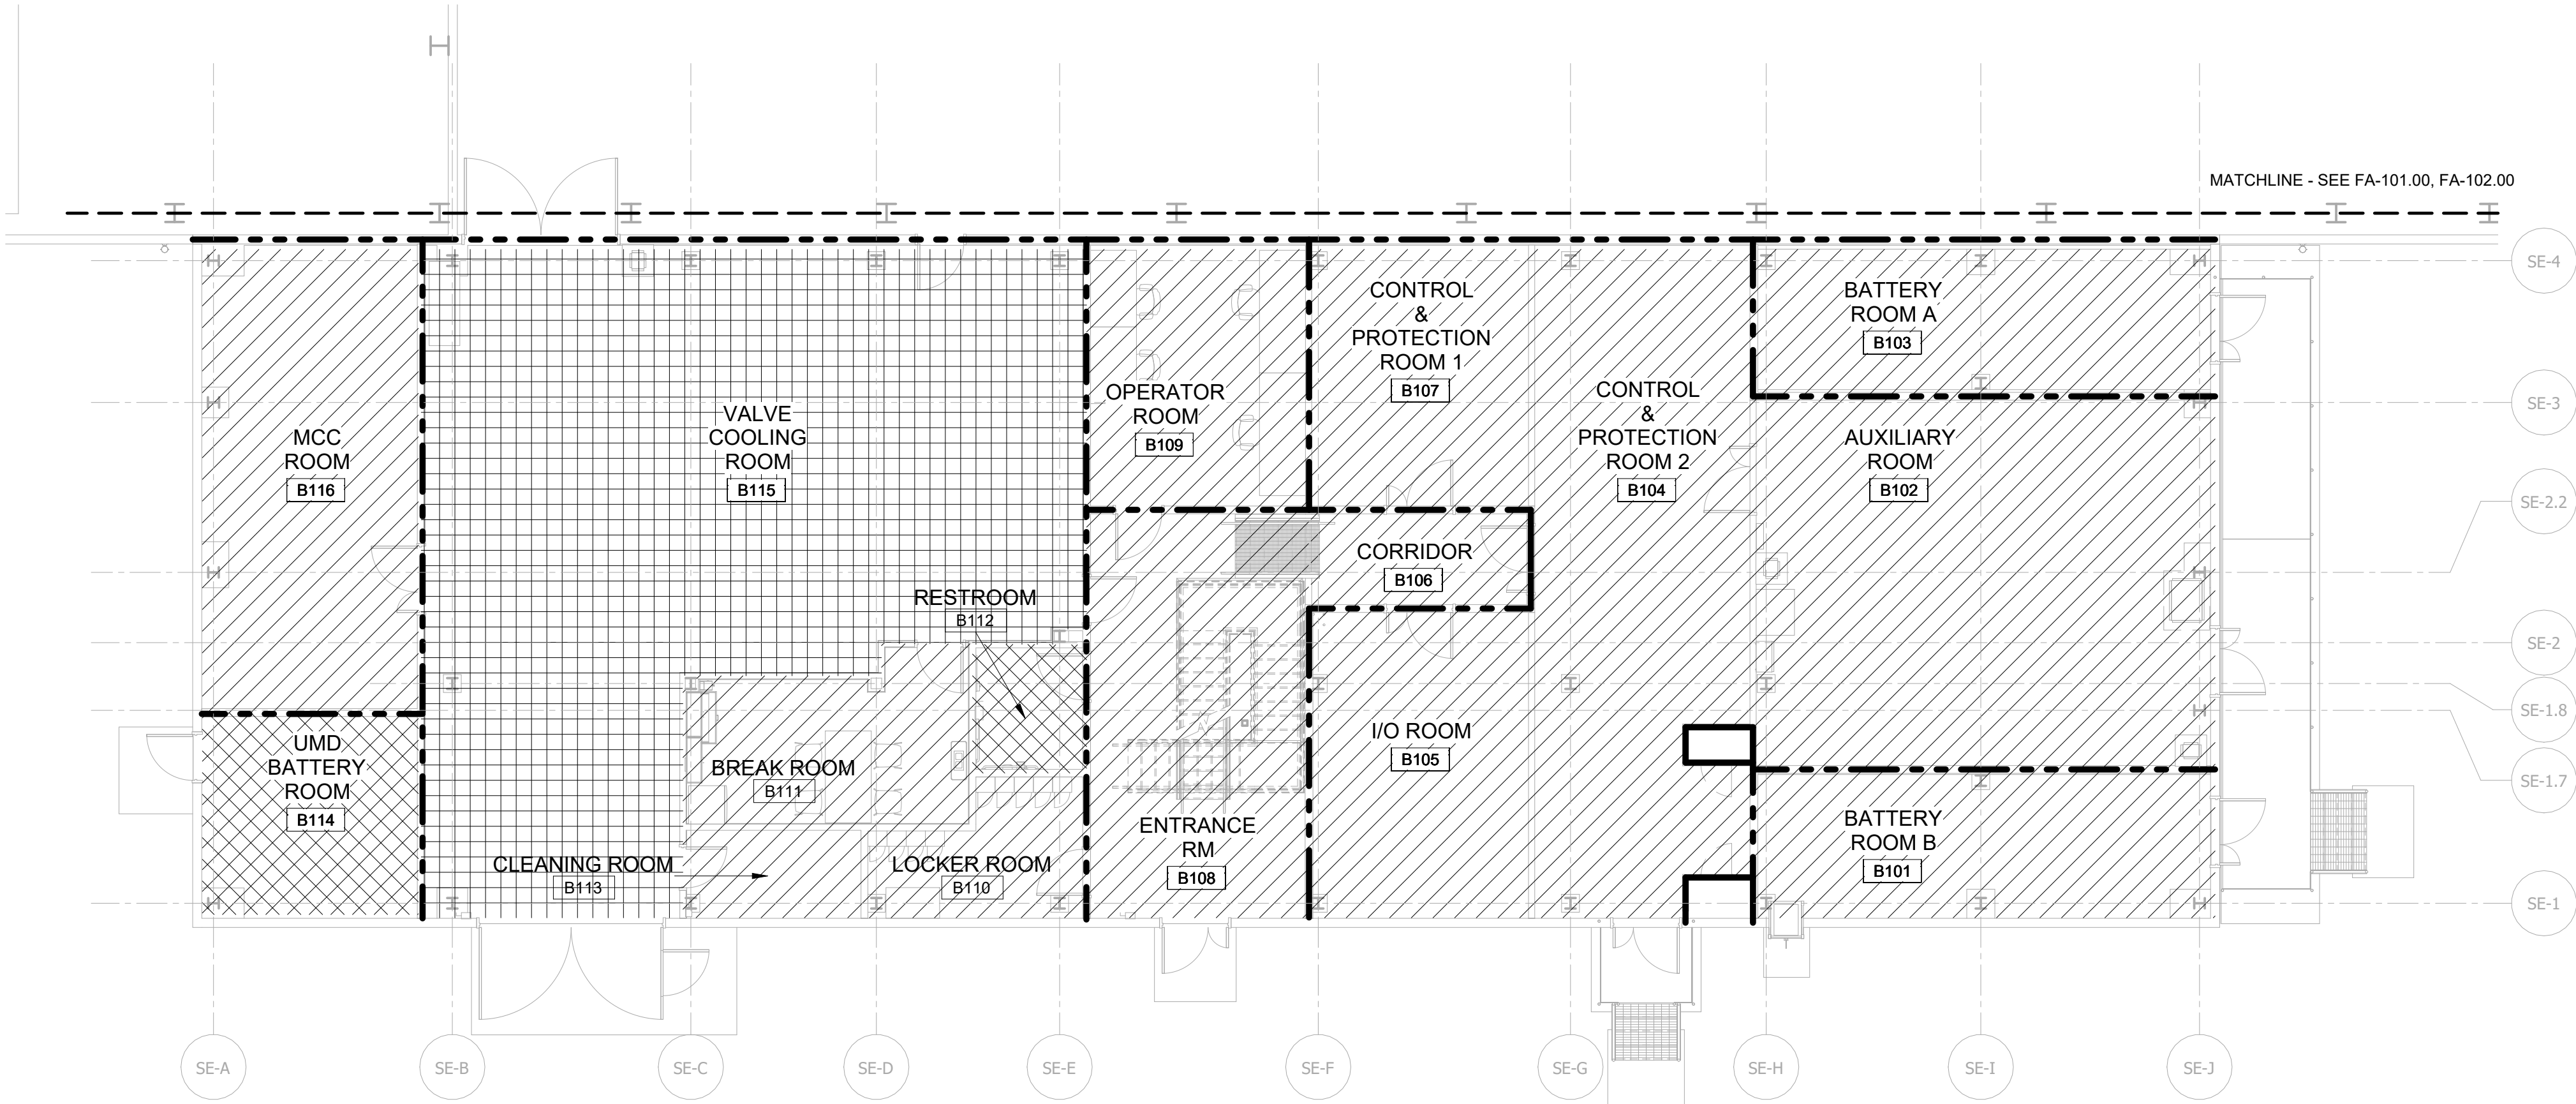

1 AUDIBILITY PLAN - FIRST FLOOR  
FA-103.00 1/8" = 1'-0"

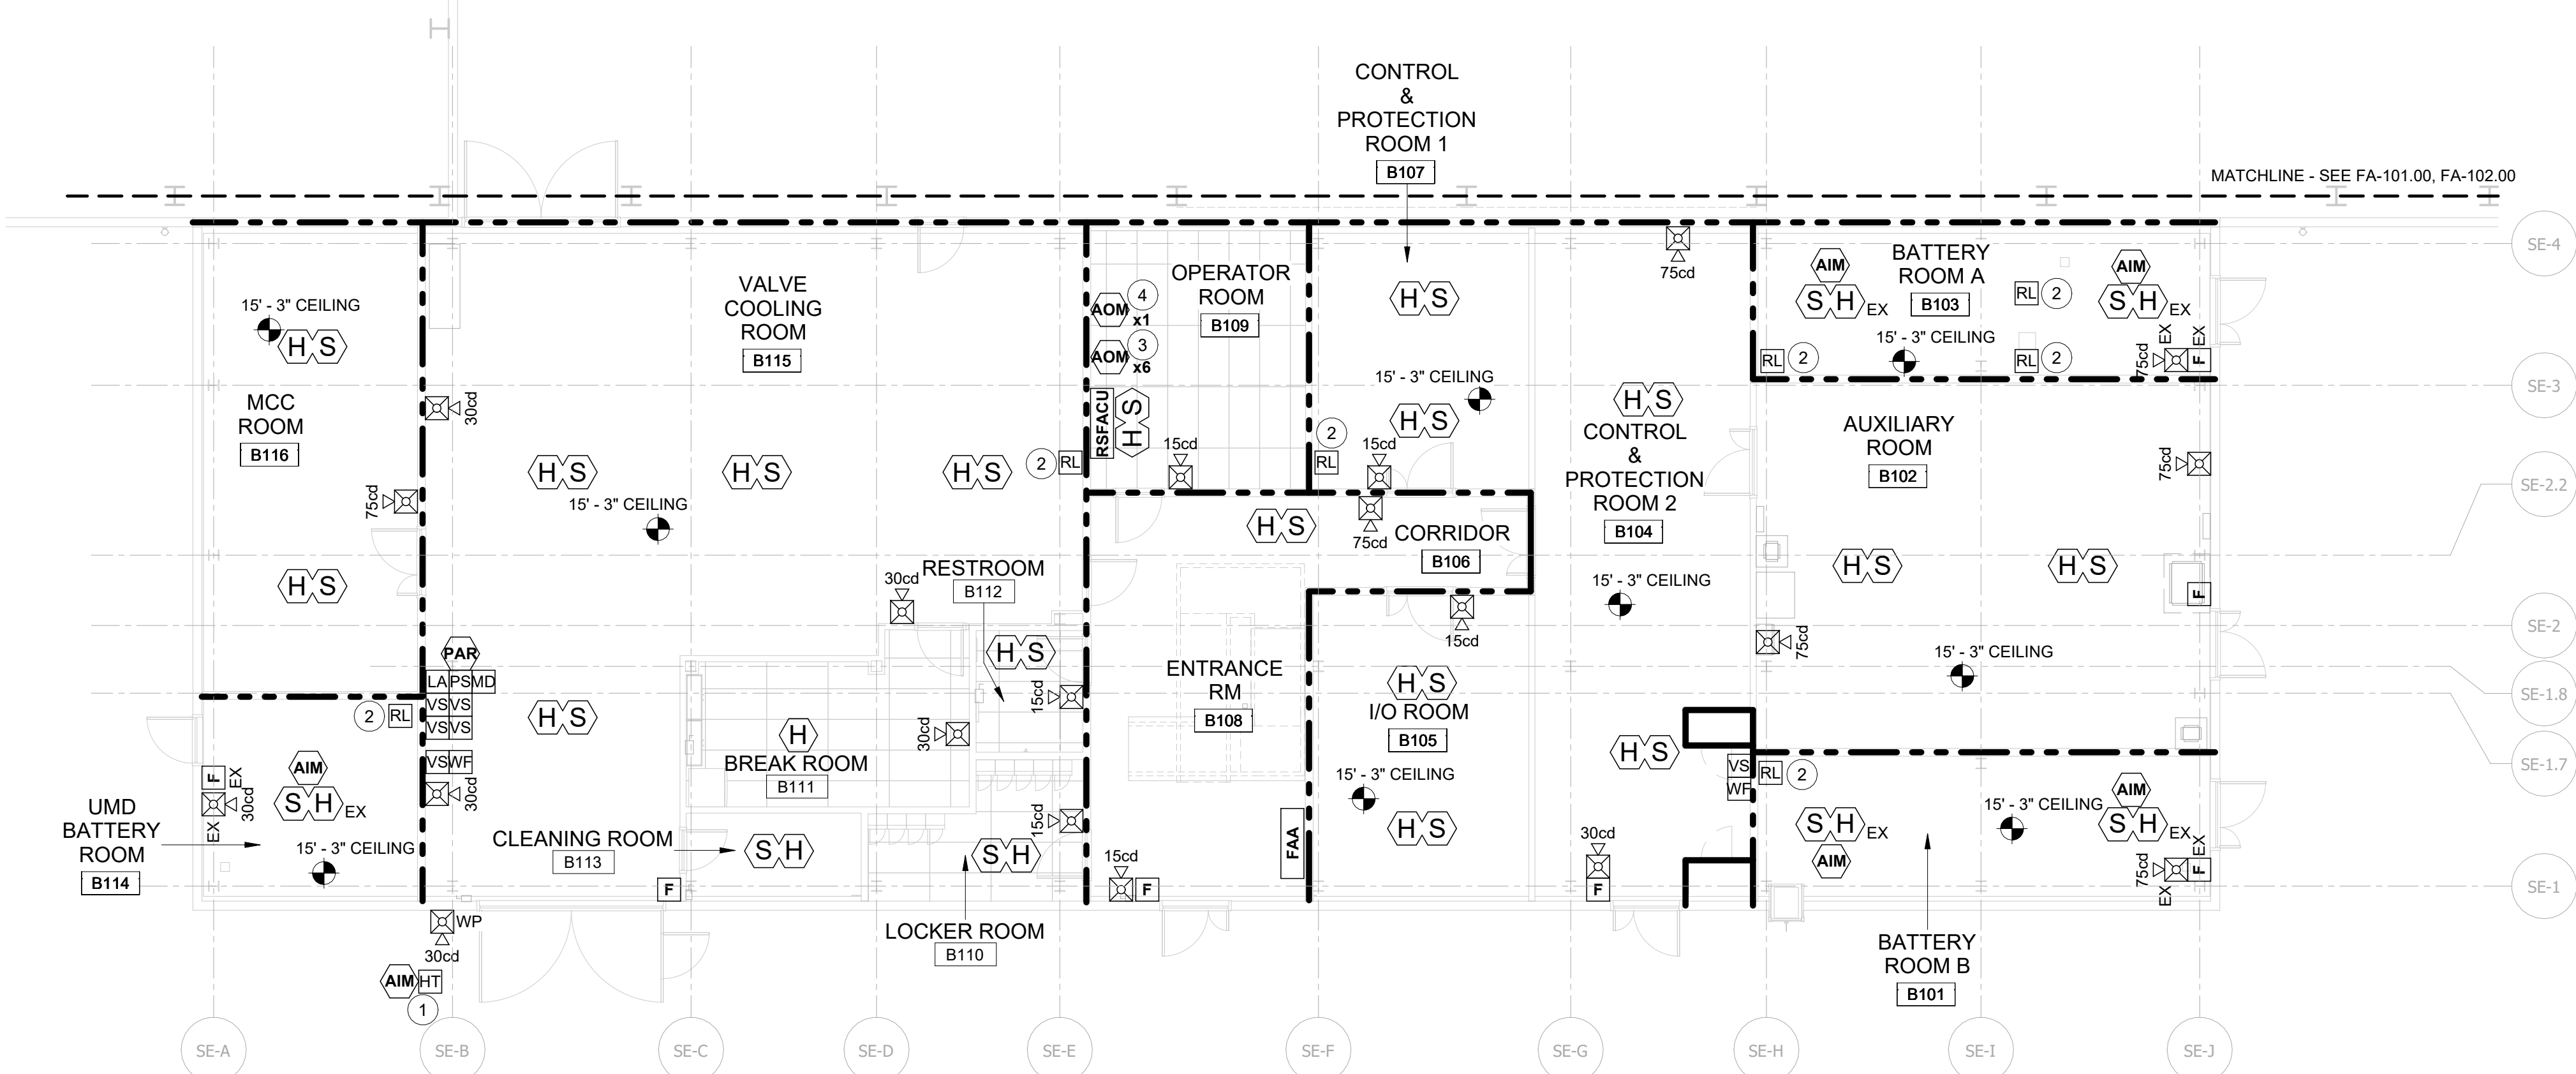


2 FIRE ALARM PLAN - FIRST FLOOR  
FA-103.00 1/8" = 1'-0"

AUDIBILITY HATCH LEGEND	
	30dB AMBIENT SPL
	45dB EXPECTED SPL
	54dB AMBIENT SPL
	69dB EXPECTED SPL
	91dB AMBIENT
	106dB EXPECTED SPL

RATED WALL LEGEND	
	2 HOUR FIRE BARRIER
NOTE: RATED WALLS ARE REFERENCED FROM ARCHITECTURAL PLANS. INCLUDED IN SEPARATE PERMIT SUBMITTAL.	

- KEYNOTES**
- 1 EACH PIPE SHALL BE ON ITS OWN HEAT TRACING CIRCUIT AND INCLUDE ASSOCIATED TANK VALVE(S). REFER TO MECHANICAL DRAWINGS INCLUDED IN SEPARATE PERMIT SUBMITTAL.
  - 2 RELAY MODULE FOR FIRE/SMOKE DAMPER CLOSURE. COORDINATE LOCATION WITH MECHANICAL DRAWINGS INCLUDED IN SEPARATE PERMIT SUBMITTAL.
  - 3 MACH SYSTEM INTERFACE. SEE INPUT/OUTPUT MATRIX.
  - 4 PA SYSTEM OVERRIDE. SEE INPUT/OUTPUT MATRIX.

ISSUED FOR PERMIT

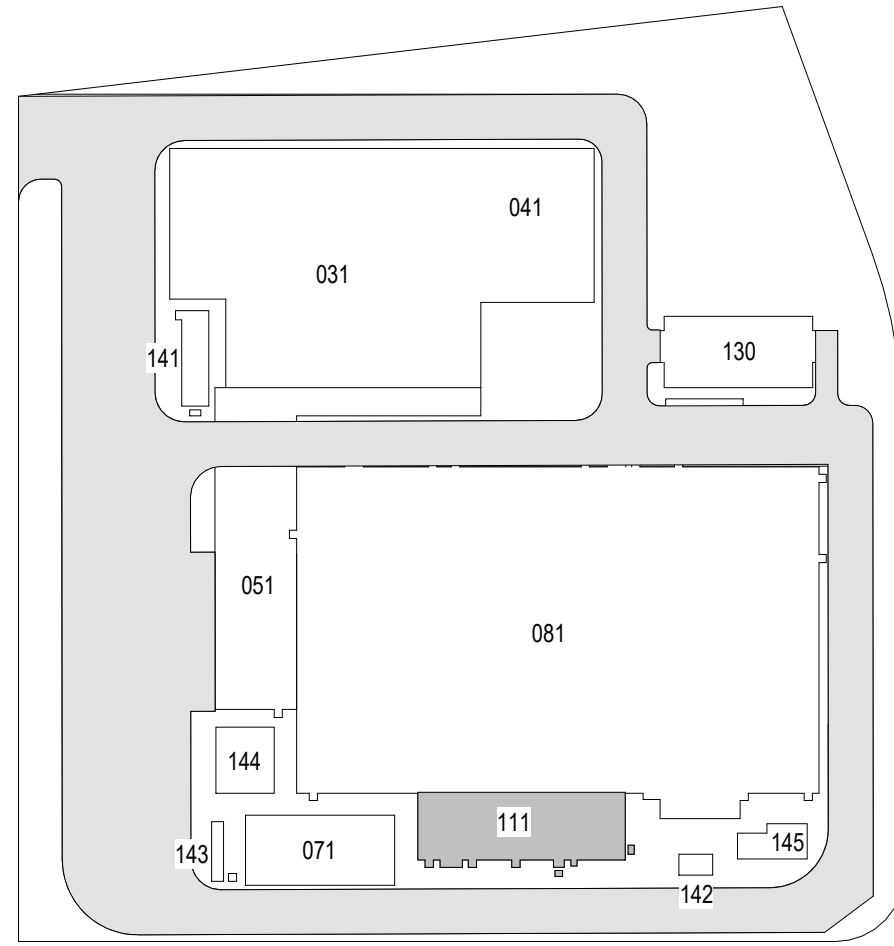

KEY PLAN  
N.T.S.



Poole Fire Protection  
19910 W. 161st Street  
Olathe, KS 66062  
913.426.0000 FAX 913.426.0001

19910 W. 161st STREET  
OLATHE, KS. 66062



25 Mohawk Avenue  
Sparta, NJ 07871

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B	FINAL SUBMISSION	SAB	AWP	12/12/2022
A	INTERIM SUBMISSION	SAB	AWP	09/13/2022
REV	DESCRIPTION	DRW BY	CHK BY	DATE



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Woodcliff Lake, NJ 07677

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Raleigh, North Carolina 27606


PROJECT

**CHPE**  
Champlain Hudson  
Power Express

**Astoria HVDC  
Converter Station**

31-45 20th Avenue, Astoria, Queens NY 11105  
Block #850 - Lot #310 - BIN #4624437


**SERVICE BUILDING - FIRE  
ALARM PLAN**

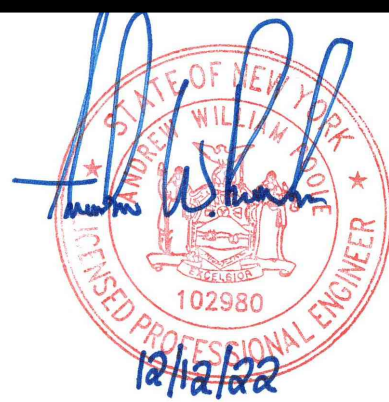

DATE 12/12/2022  
PROJECT NO 105121  
DRAWING BY S. BRINKMEYER  
CHECKED BY A. POOLE  
DRAWING NO  
**FA-103.00**  
CADD FILE NO  
Astoria HVDC CHPE  
Astoria CHA-RE-111-00-M3-FP-001.rvt  
9 of 18



ISSUED FOR PERMIT

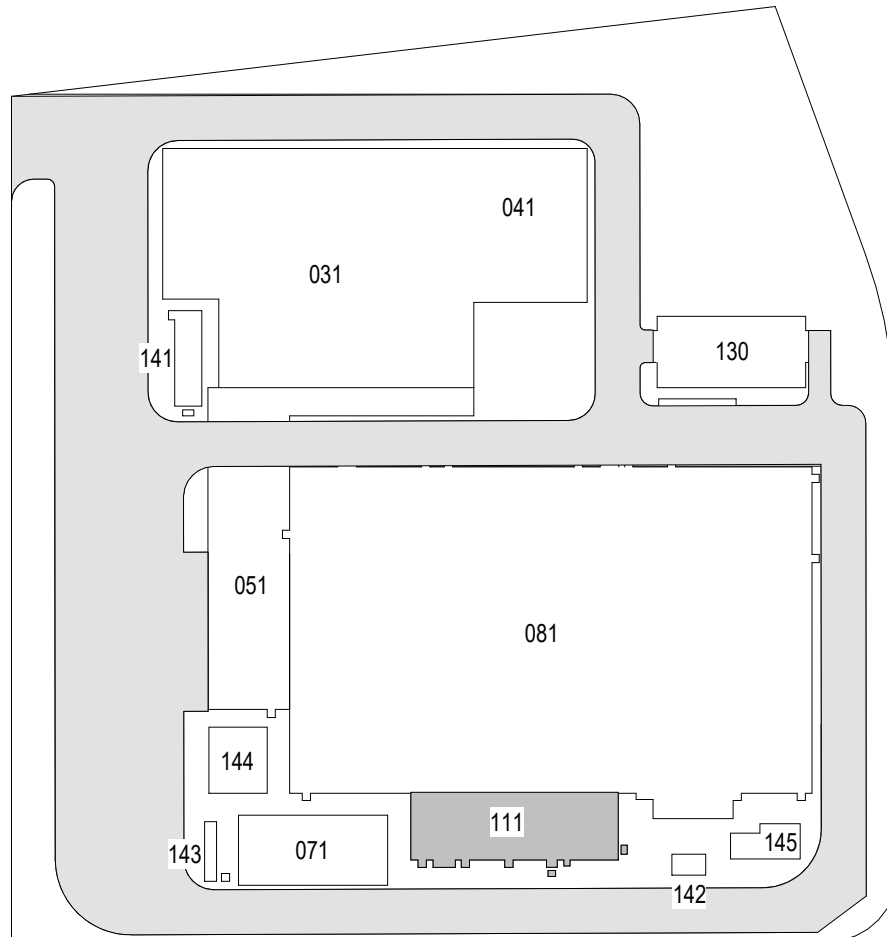

KEY PLAN  
N.T.S.



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Hitachi Energy

901 Main Campus Drive  
Raleigh, North Carolina 27606

PROJECT

**CHPE**  
Champlain Hudson  
Power Express


**Astoria HVDC  
Converter Station**

31-45 20<sup>th</sup> Avenue, Astoria, Queens NY 11105  
Block #850 - Lot #310 - BIN #4624437


**SERVICE BUILDING - FIRE  
ALARM PLAN**




DATE 12/12/2022  
PROJECT NO 105121  
DRAWING BY S. BRINKMEYER  
CHECKED BY A. POOLE  
DRAWING NO  
**FA-104.00**  
CADD FILE NO  
Astoria/CHPE-111-00-M3-FP-001.rvt  
10 of 18

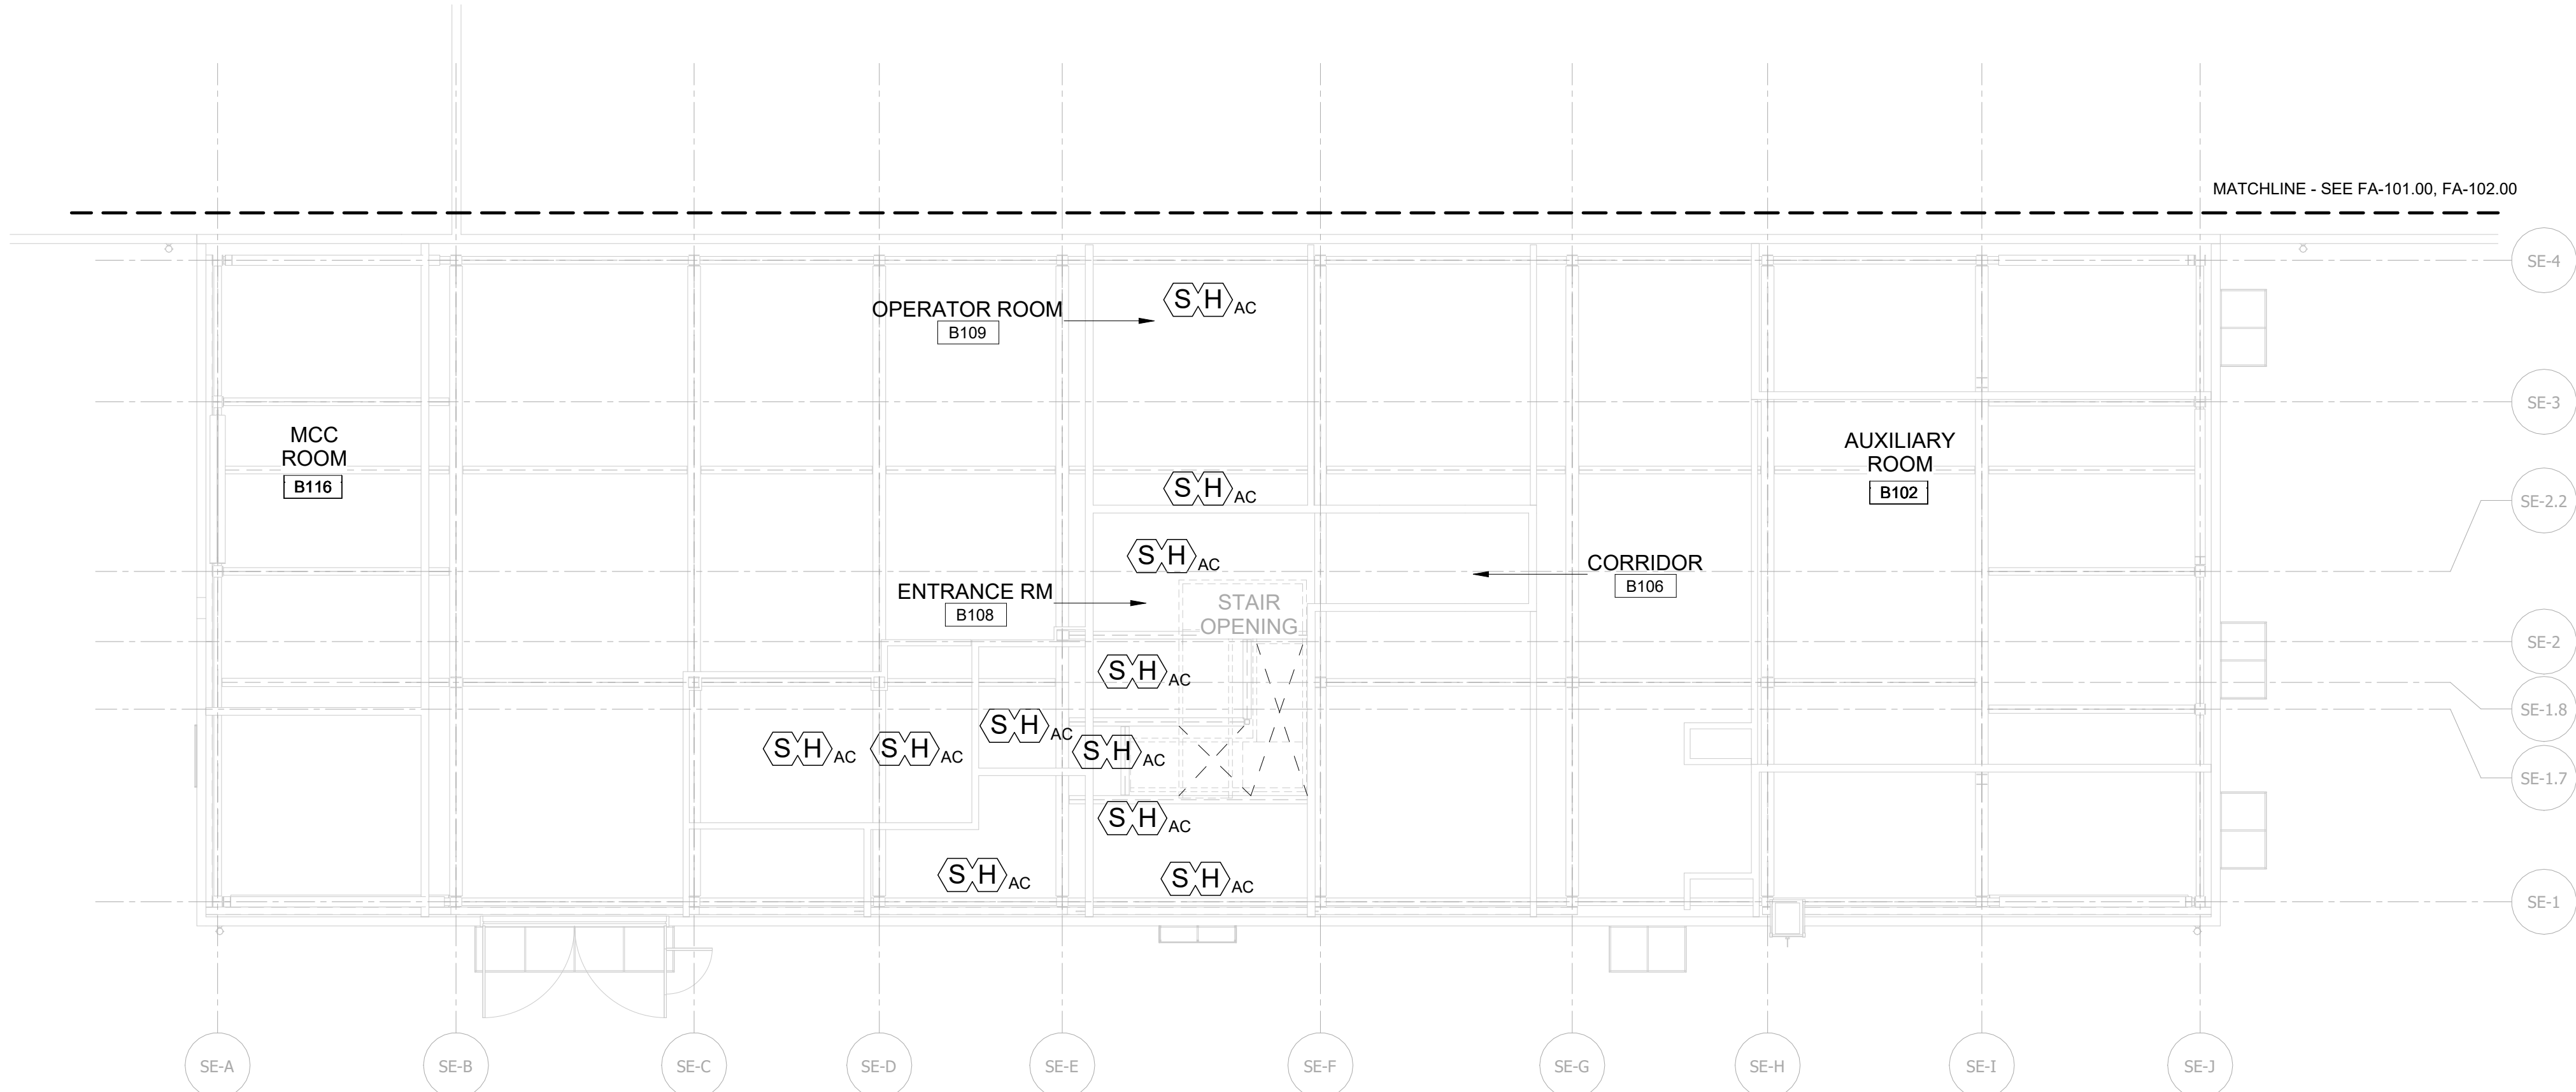


1 FIRE ALARM PLAN - FIRST FLOOR ABOVE CEILING  
FA-104.00 1/8" = 1'-0"

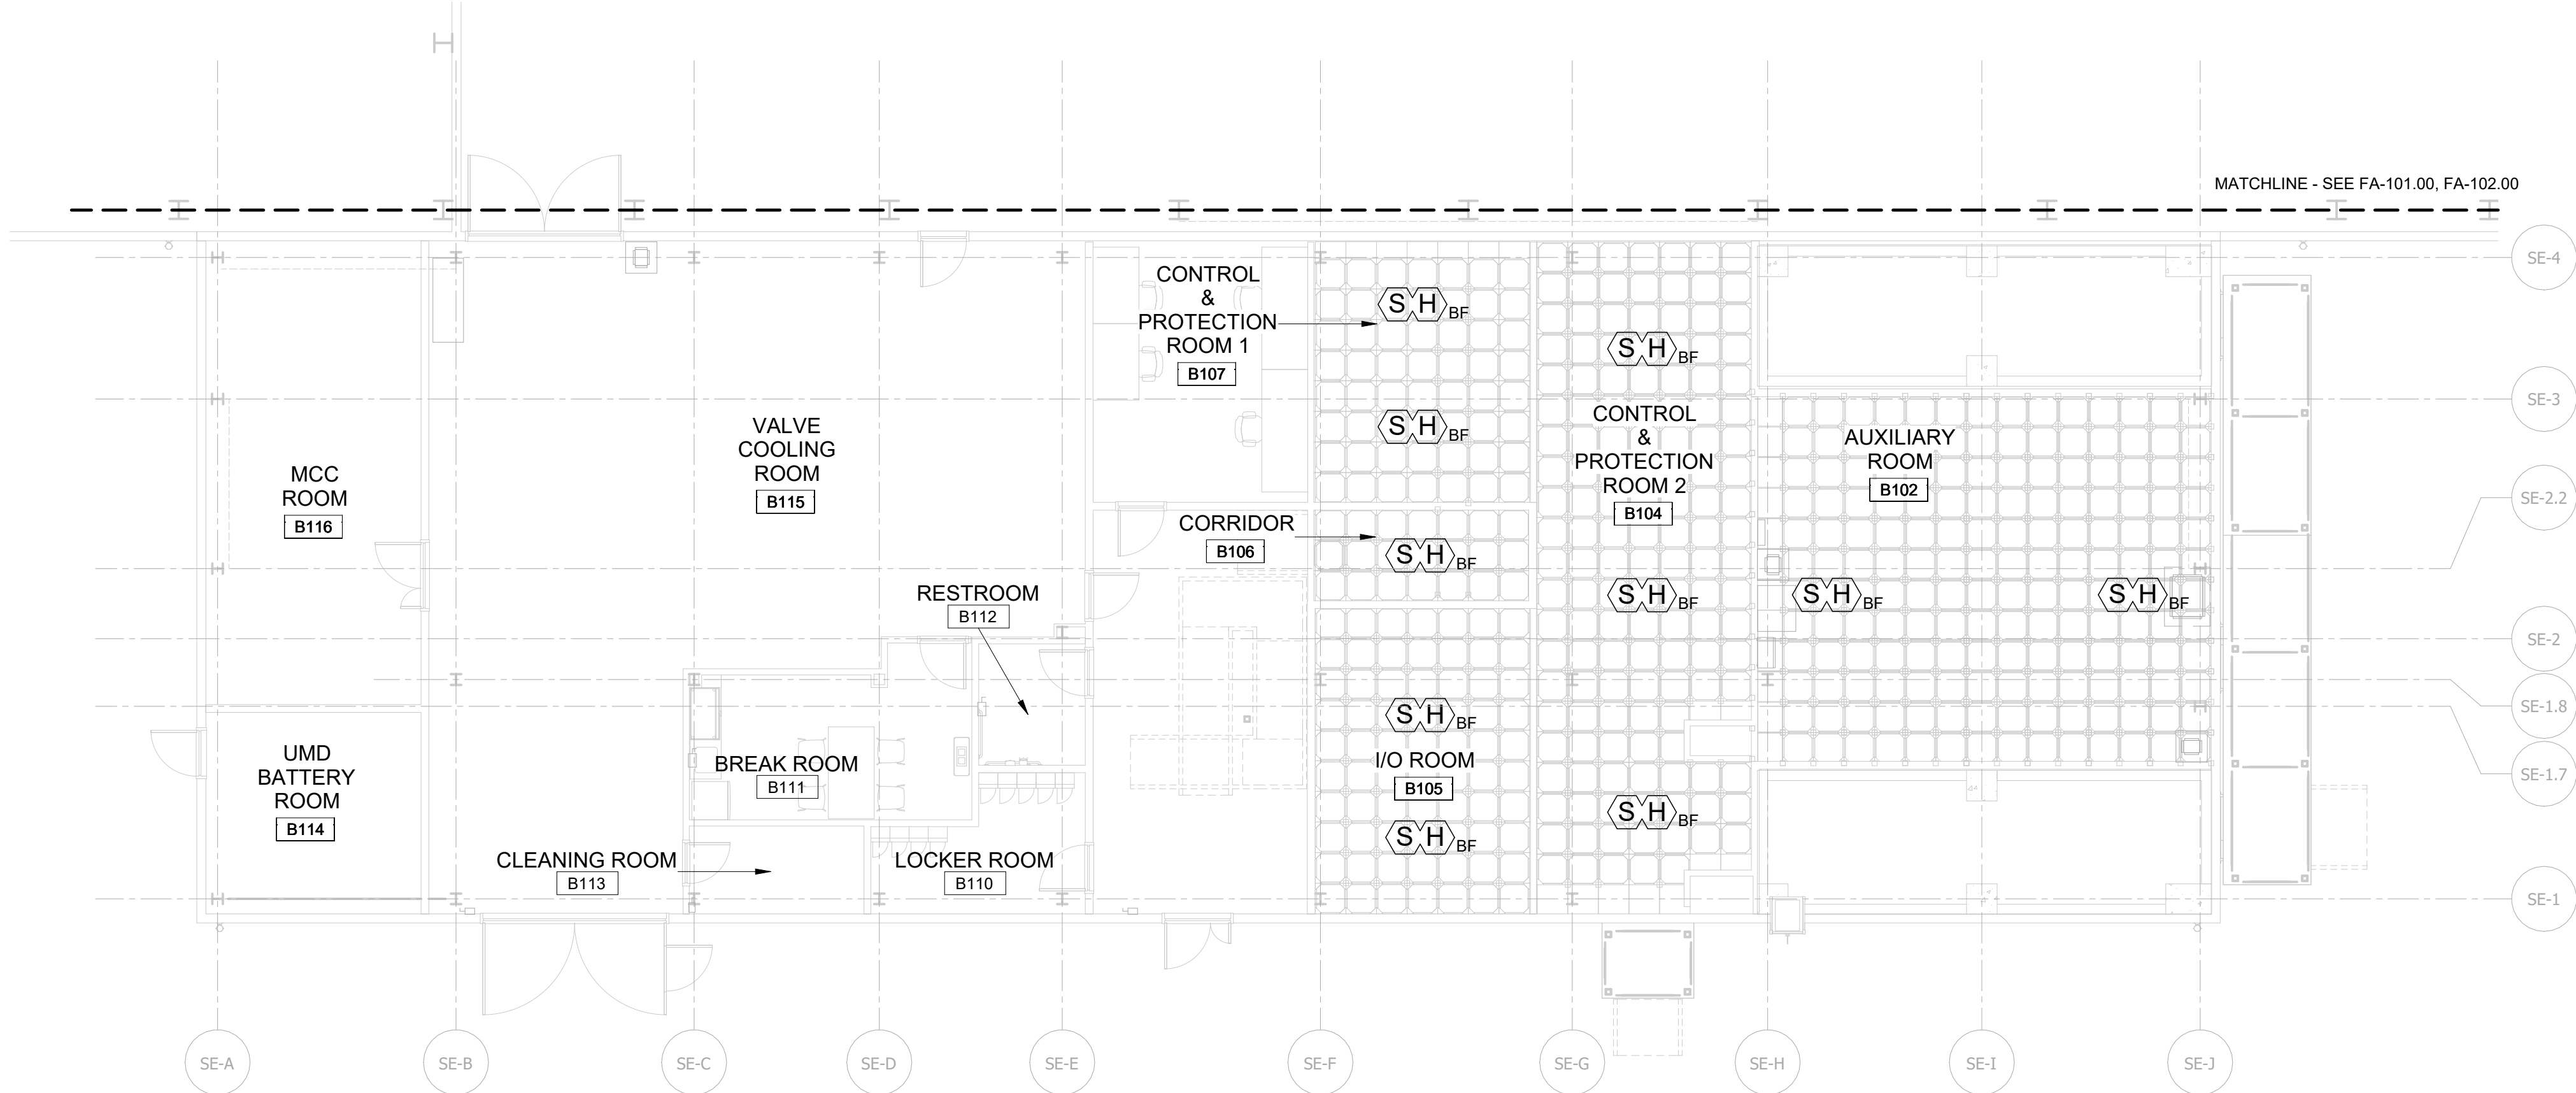


2 FIRE ALARM PLAN - FIRST FLOOR BELOW RAISED FLOOR  
FA-104.00 1/8" = 1'-0"

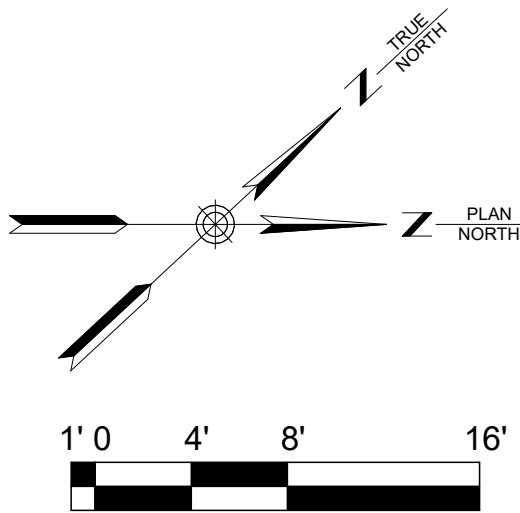



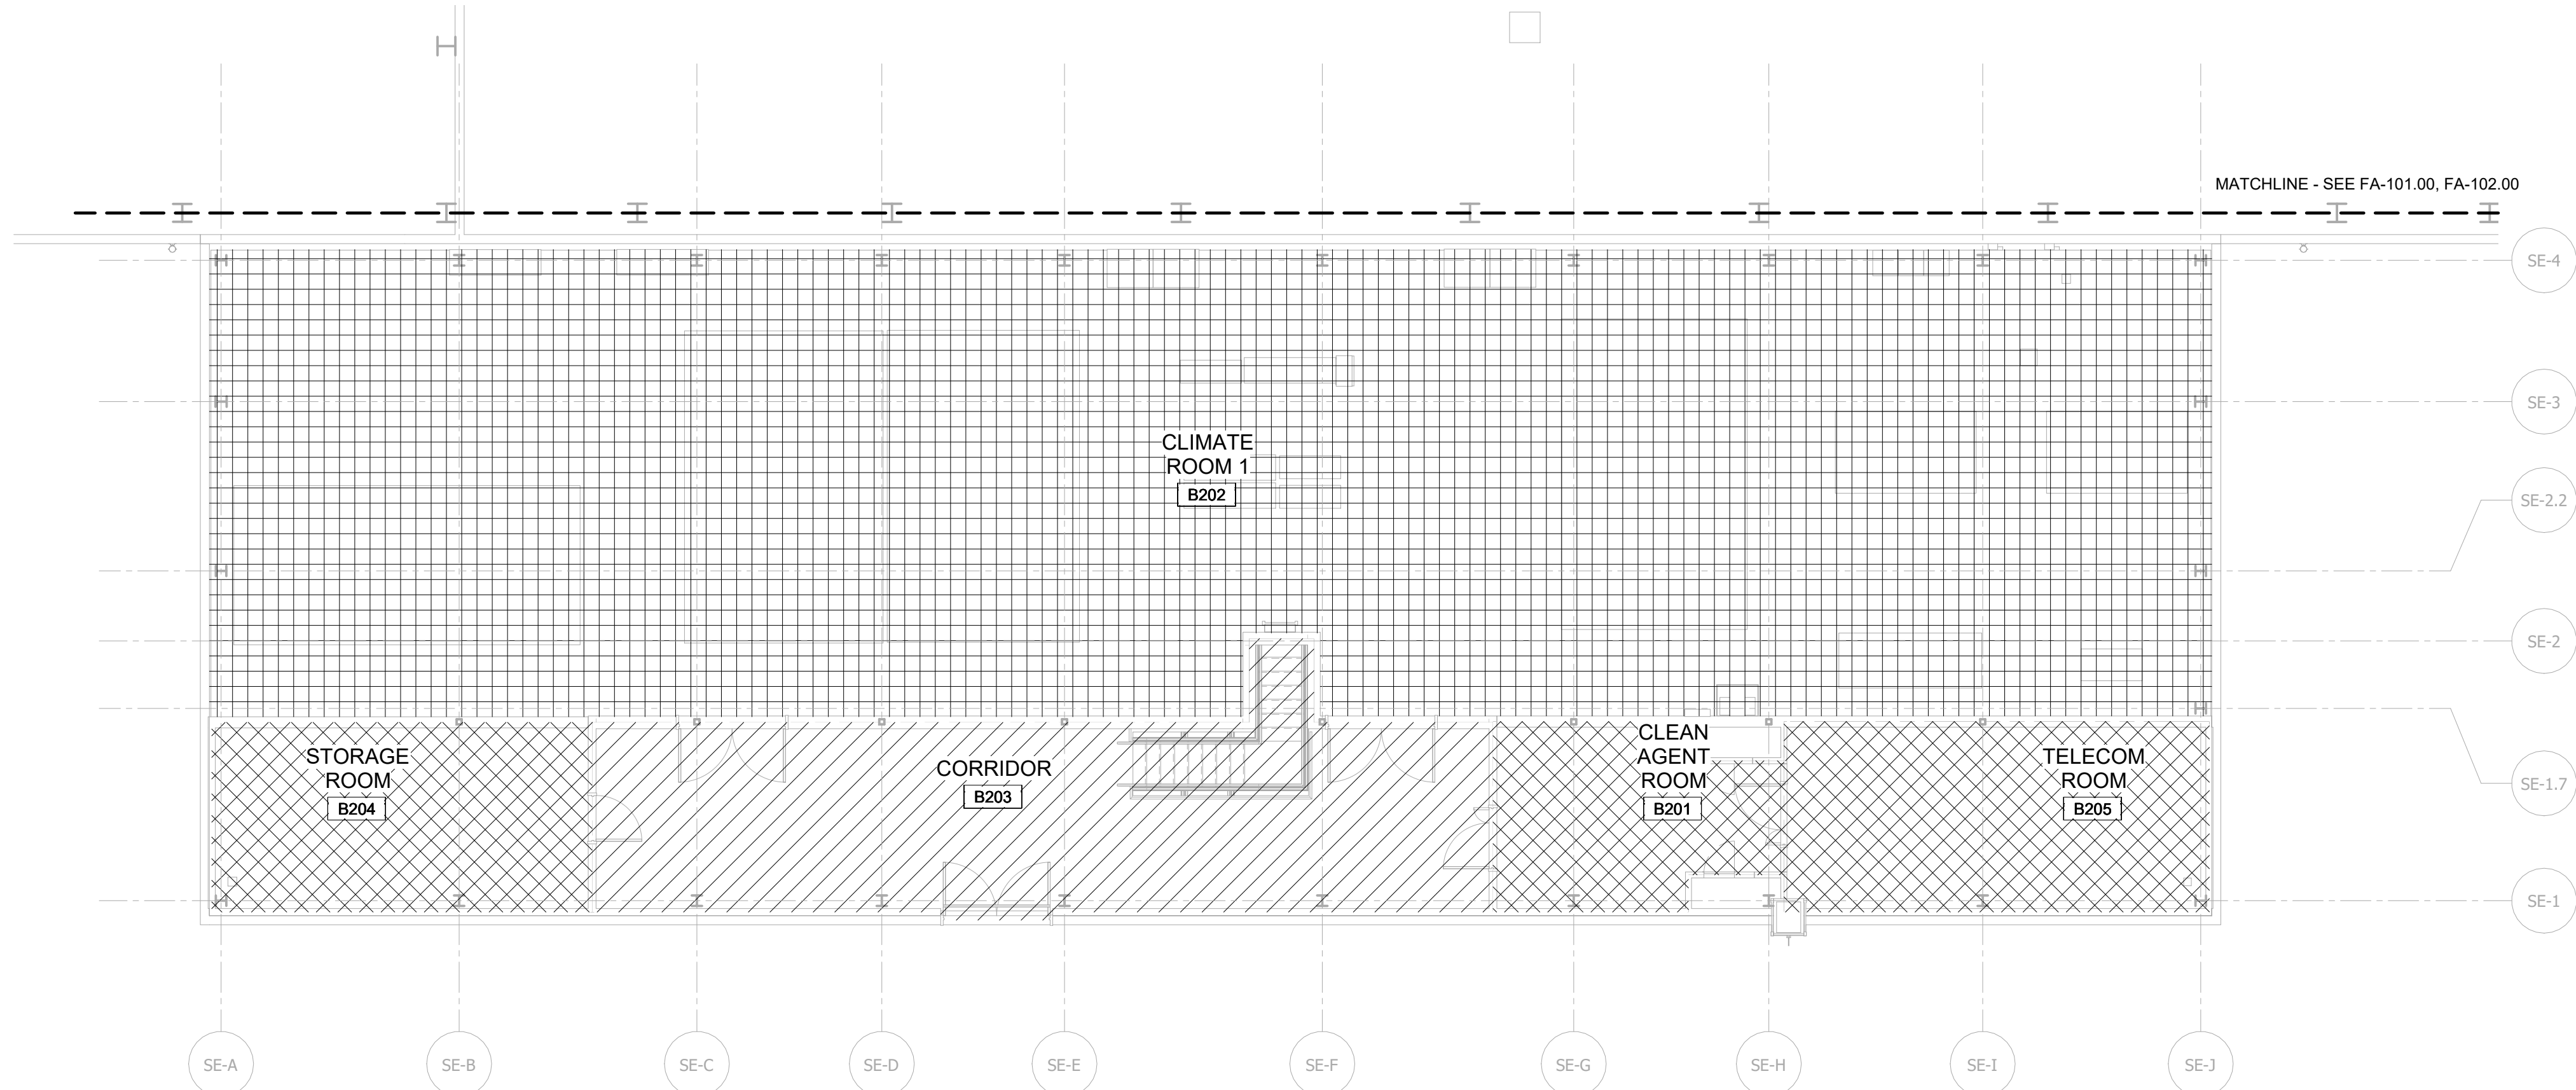

1 AUDIBILITY PLAN - SECOND FLOOR  
FA-105.00 1/8" = 1'-0"

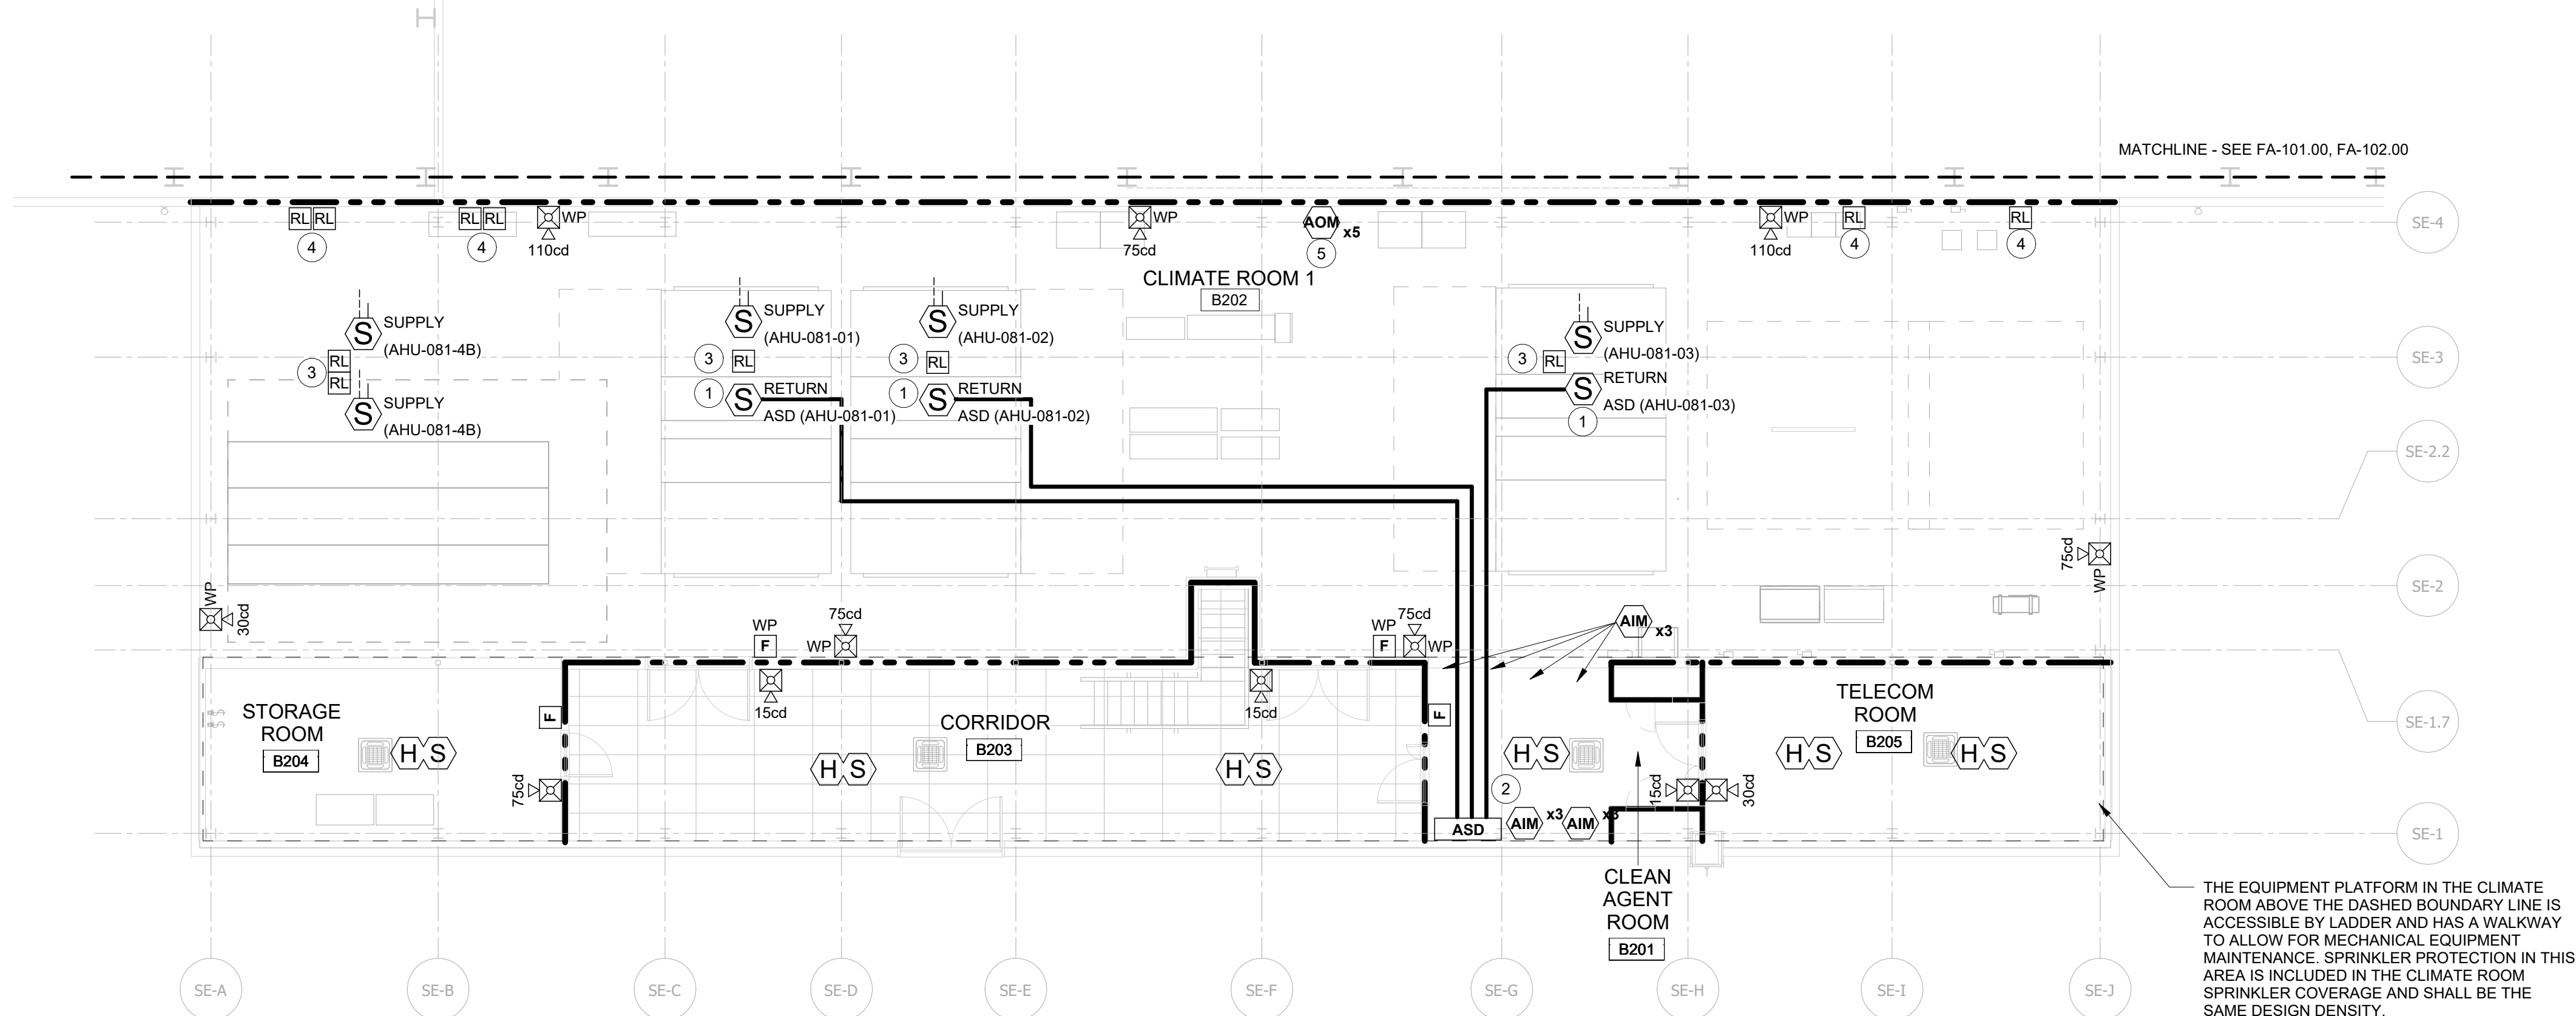


2 FIRE ALARM PLAN - SECOND FLOOR  
FA-105.00 1/8" = 1'-0"

RATED WALL LEGEND	
	2 HOUR FIRE BARRIER
NOTE: RATED WALLS ARE REFERENCED FROM ARCHITECTURAL PLANS. INCLUDED IN SEPARATE PERMIT SUBMITTAL.	
AUDIBILITY HATCH LEGEND	
	30dB AMBIENT SPL 45dB EXPECTED SPL
	54dB AMBIENT SPL 69dB EXPECTED SPL
	91dB AMBIENT 106dB EXPECTED SPL

#### KEYNOTES

1. LOCATE ASPIRATING SMOKE DETECTION SAMPLE PIPING/HEADS IN RETURN DUCT OF VALVE HALL HVAC UNIT DOWNSTREAM OF COMMON RETURN DUCT (SEE MECHANICAL DRAWINGS FOR DETAILS INCLUDED INSEPARATE PERMIT SUBMITTAL). PIPING SHALL BE RUN BACK TO VESDA CONTROL UNIT LOCATED IN THE SERVICE BUILDING CLEAN AGENT ROOM B201.
2. SAMPLING PIPE ROUTING SHOWN IS SCHEMATIC IN NATURE. ACTUAL PIPE ROUTING AND SAMPLE POINTS SHALL BE DETERMINED BASED ON ACTUAL EQUIPMENT LOCATIONS UNIQUE TO EACH CONVERTER HALL. FINAL CONFIGURATION SHALL BE VERIFIED USING MANUFACTURER-SPECIFIC SOFTWARE TO CONFIRM TRANSPORT TIME AND DETECTION THRESHOLD PERFORMANCE CRITERIA.
3. RELAY MODULE FOR HVAC UNIT SHUTDOWN. COORDINATE LOCATION WITH MECHANICAL DRAWINGS INCLUDED IN SEPARATE PERMIT SUBMITTAL.
4. RELAY MODULE FOR FIRE/SMOKE DAMPER CLOSURE. COORDINATE LOCATION WITH MECHANICAL DRAWINGS INCLUDED IN SEPARATE PERMIT SUBMITTAL.
5. POST-FIRE SMOKE PURGE ACTIVATION. SEE INPUT/OUTPUT MATRIX.

ISSUED FOR PERMIT

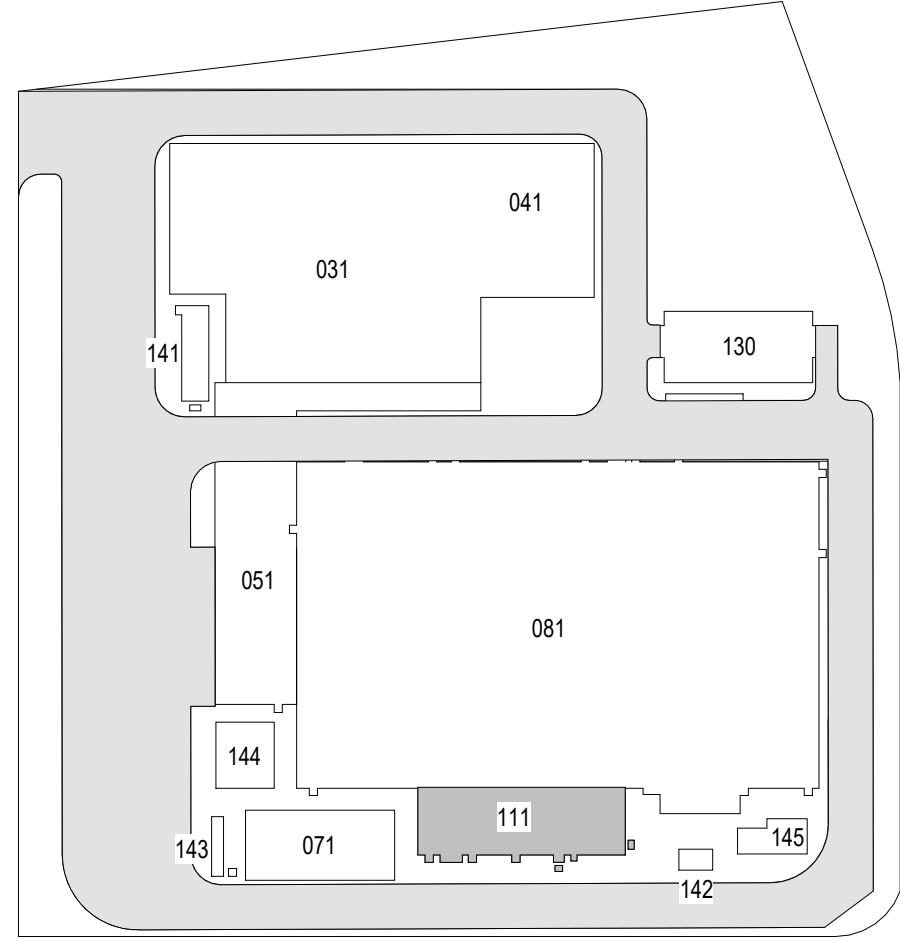

KEY PLAN  
N.T.S.



Poole Fire Protection  
19910 West 161st Street  
Olathe, KS 66062  
913.429.8600 FAX 913.429.8601

19910 W. 161st STREET  
OLATHE, KS. 66062



25 Mohawk Avenue  
Sparta, NJ 07871

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B	FINAL SUBMISSION	SAB	AWP	12/12/2022
A	INTERIM SUBMISSION	SAB	AWP	09/13/2022
REV	DESCRIPTION	DRW BY	CHK BY	DATE



470 Chestnut Ridge Rd # 2,  
Woodcliff Lake, NJ 07677

Hitachi Energy

901 Main Campus Drive  
Raleigh, North Carolina 27606

#### PROJECT

**CHPE**  
Champlain Hudson  
Power Express

**Astoria HVDC  
Converter Station**

31-45 20th Avenue, Astoria, Queens NY 11105  
Block #850 - Lot #310 - BIN #4624437


**SERVICE BUILDING - FIRE  
ALARM PLAN**




DATE 12/12/2022  
PROJECT NO 105121  
DRAWING BY S. BRINKMEYER  
CHECKED BY A. POOLE  
DRAWING NO  
**FA-105.00**  
CADD FILE NO  
AstoriaHVDC-CHPE  
AstoriaCHPE-111-00-M3-FP-001.rvt  
11 of 18



12/20/2022 4:20:40 PM

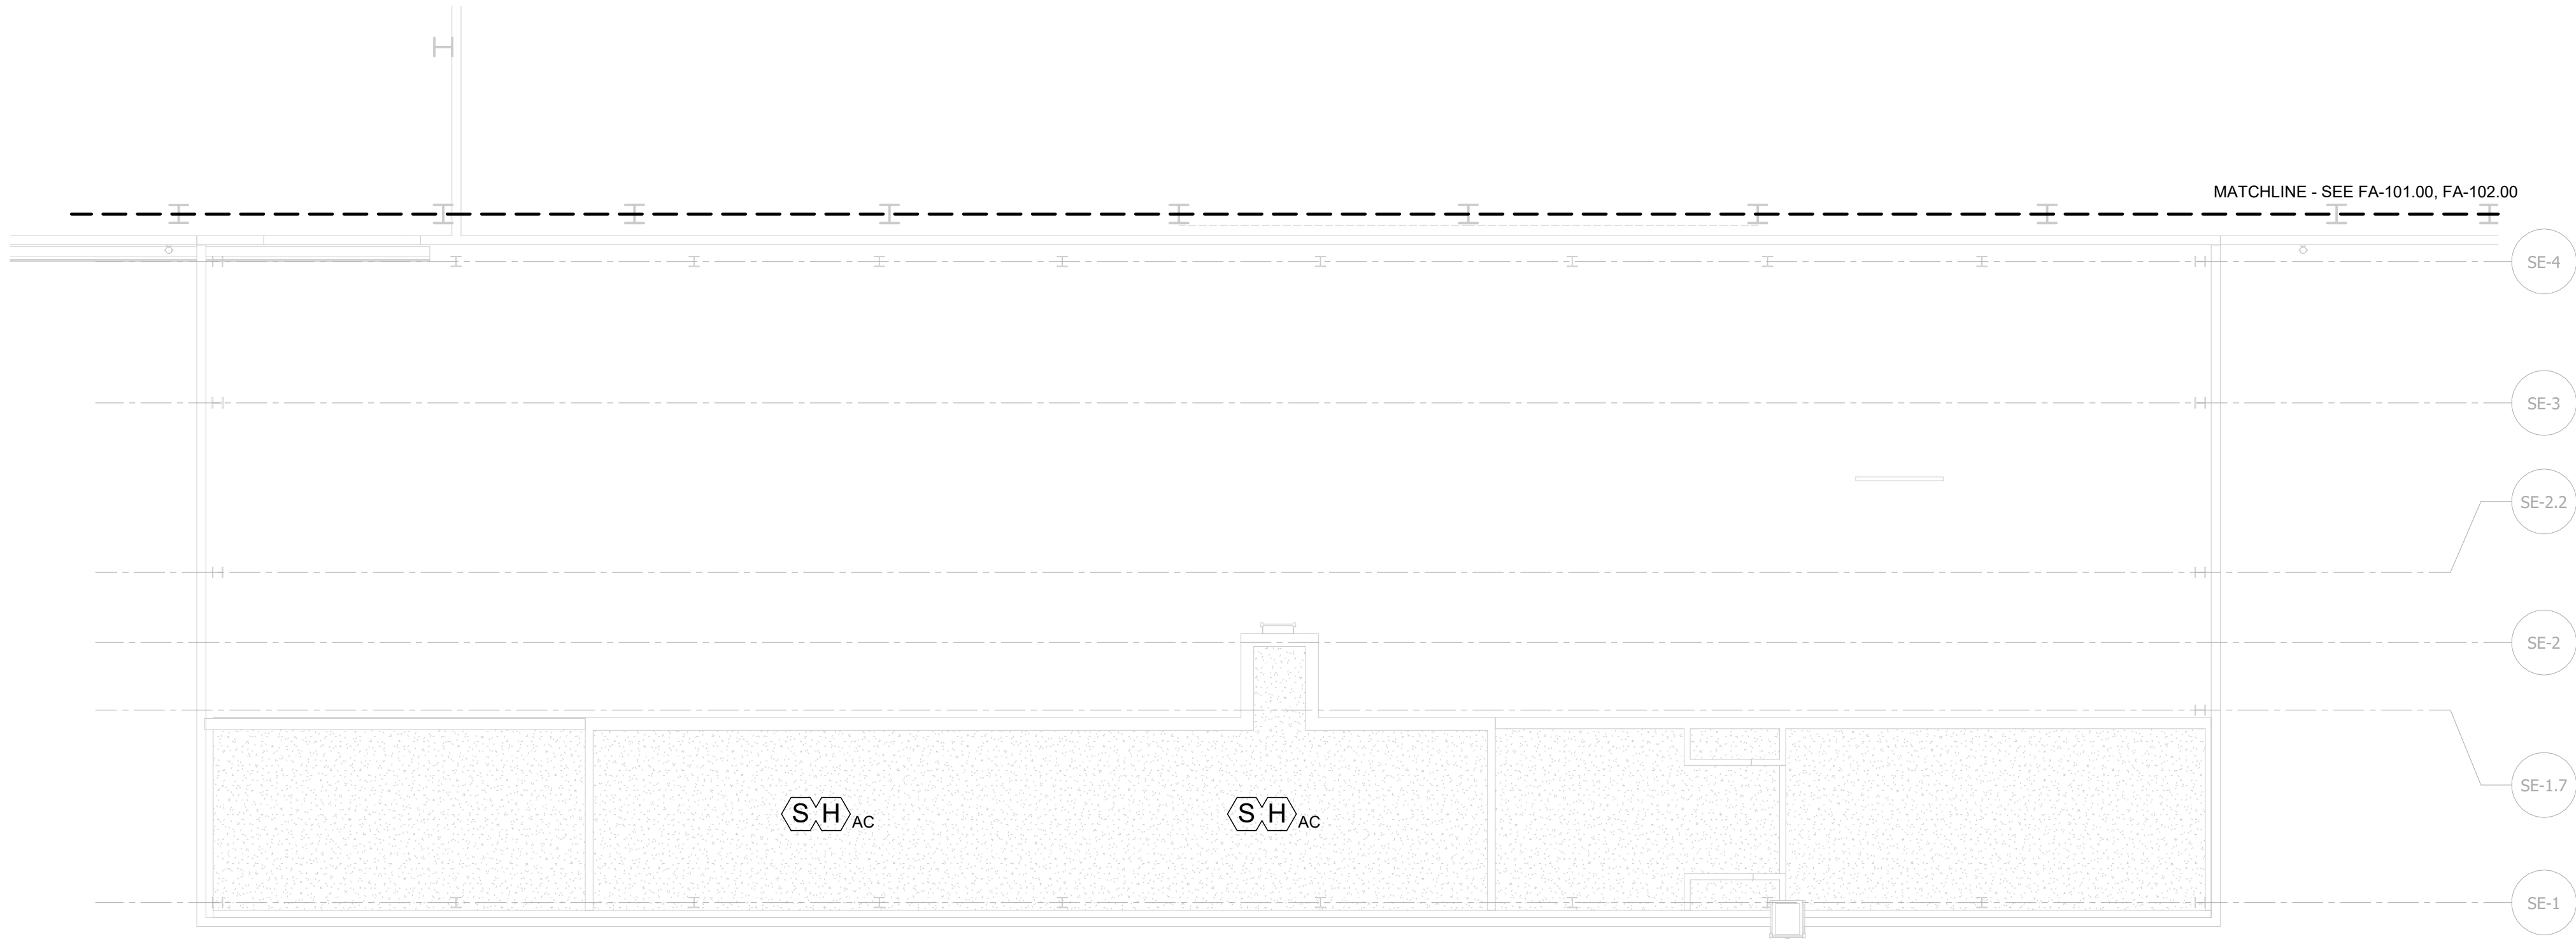

1 FIRE ALARM PLAN - SECOND FLOOR ABOVE CEILING  
FA-106.00 1/8" = 1'-0"

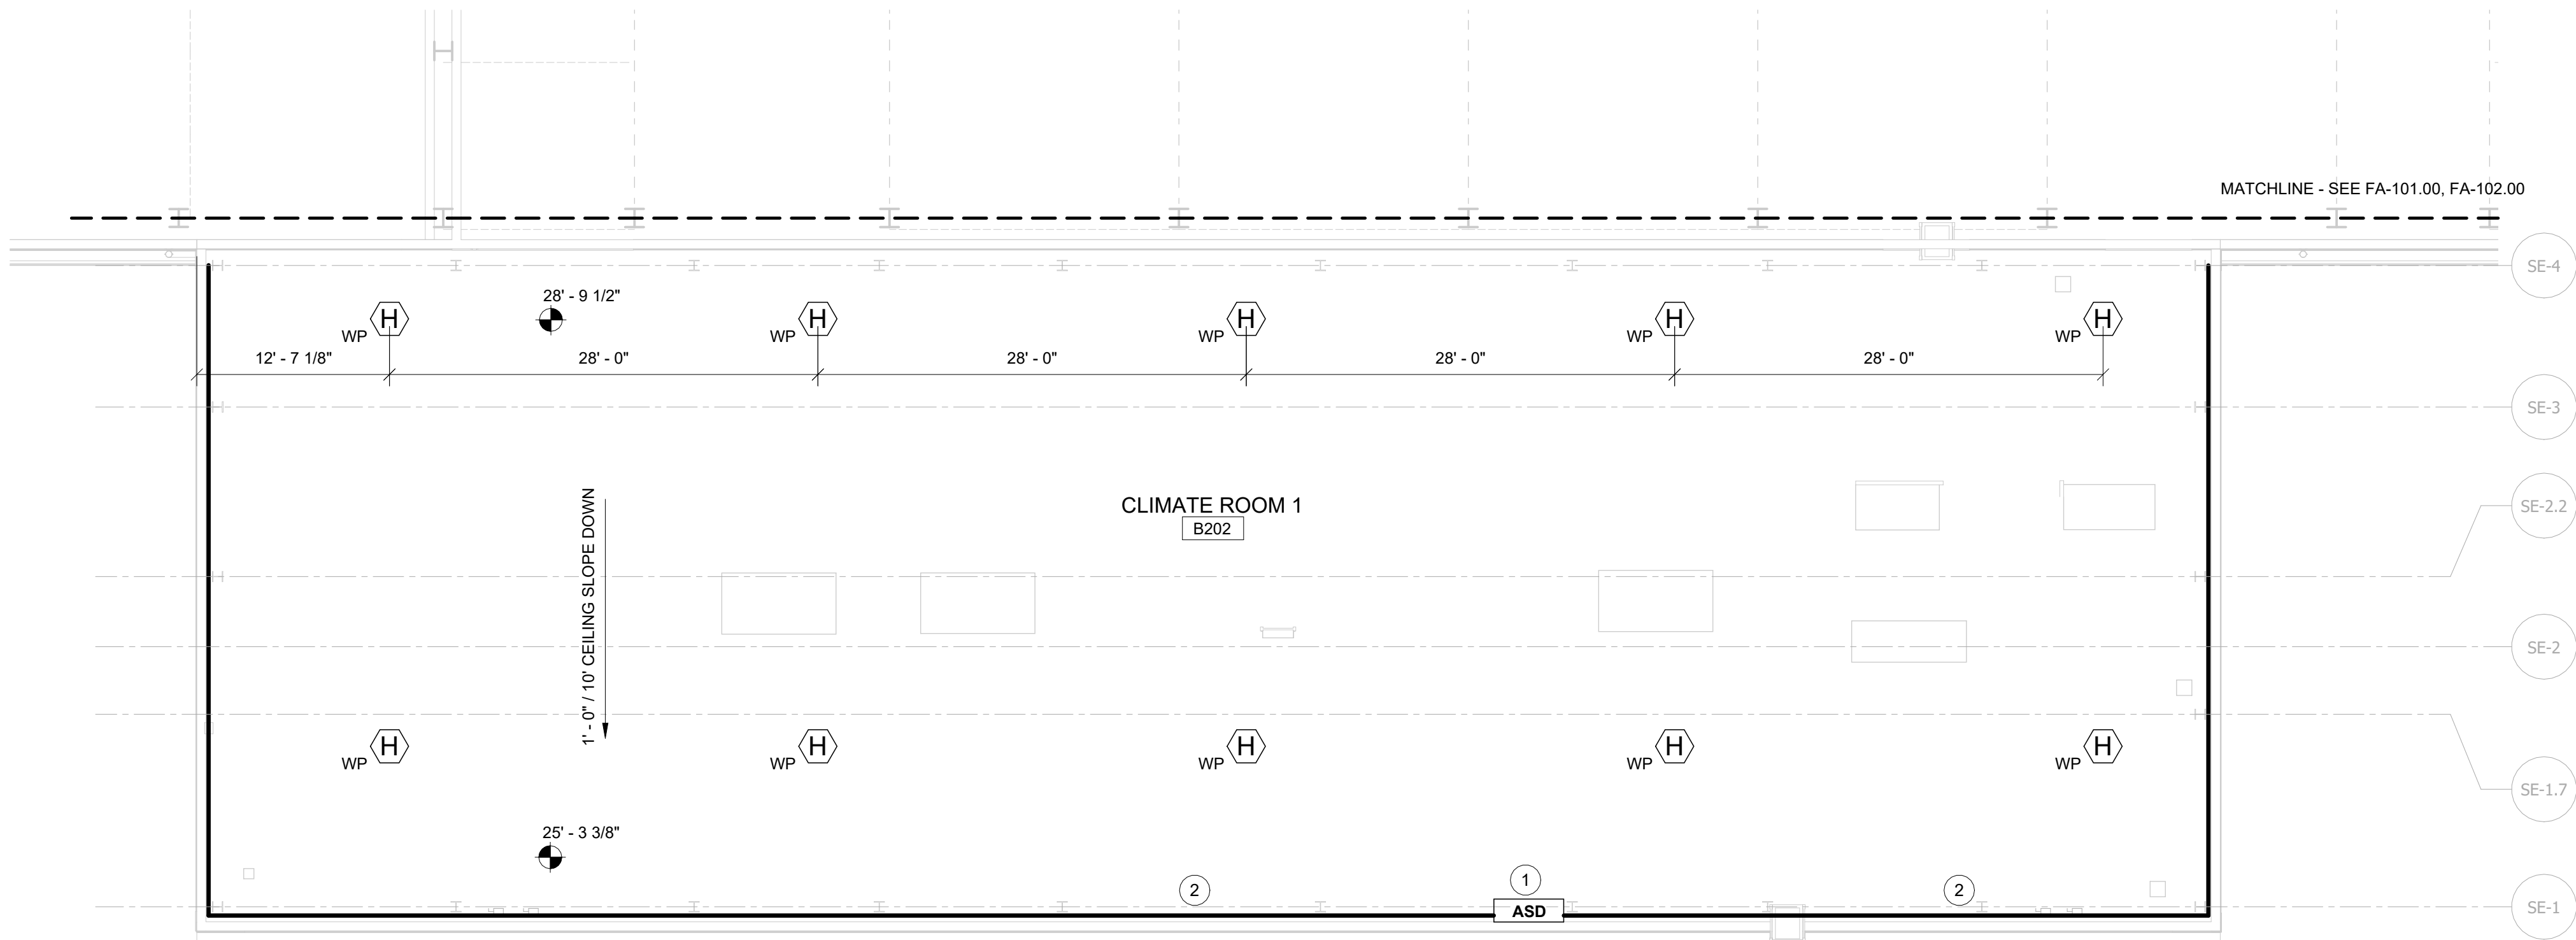


2 FIRE ALARM PLAN - SECOND FLOOR ROP  
FA-106.00 1/8" = 1'-0"

KEYNOTES

- AIR-SAMPLING DETECTOR CONTROL UNIT TO BE LOCATED IN SECOND FLOOR CLEAN AGENT ROOM. DETECTOR SHALL ACT AS A REFERENCE DETECTOR TO THE AIR-SAMPLING DETECTORS SERVING THE CONVERTER HALLS AND VALVE HALL HVAC UNITS, AND SHALL BE CONNECTED TO THOSE DETECTORS VIA A VESDA-NET CIRCUIT.
- SAMPLING PIPE ROUTING SHOWN IS SCHEMATIC IN NATURE. PIPING SHALL BE INSTALLED ALONG INSIDE FACE OF MAKEUP AIR LOUVERS. PIPE ROUTING AND NUMBER OF PIPES ALONG THE FACE OF THE LOUVERS SHALL BE DETERMINED USING MANUFACTURER-SPECIFIC SOFTWARE TO CONFIRM TRANSPORT TIME AND PERFORMANCE CRITERIA. PIPING SHALL BE RUN WITHIN CONDITIONED SPACE ABOVE/WITHIN STORAGE ROOM B204, CORRIDOR B203, CLEAN AGENT ROOM B201, AND TELECOM ROOM B205 AS NEEDED TO ENSURE SAMPLED AIR HAS REACHED REQUIRED TEMPERATURE PRIOR TO ENTERING THE DETECTOR.

ISSUED FOR PERMIT

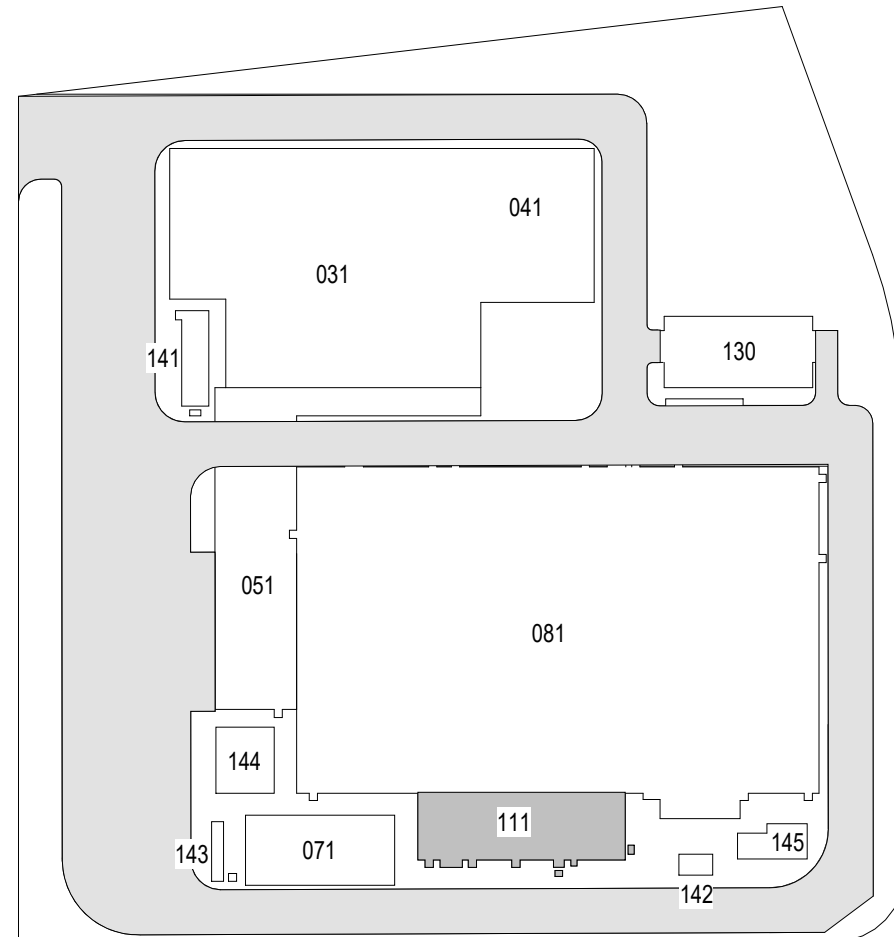

KEY PLAN  
N.T.S.



Poole Fire Protection  
19910 W. 161st Street  
Olathe, KS 66062  
TEL: 816.666.6666 FAX: 816.666.6666

19910 W. 161st STREET  
OLATHE, KS. 66062



25 Mohawk Avenue  
Sparta, NJ 07871

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B	FINAL SUBMISSION	SAB	AWP	12/12/2022
A	INTERIM SUBMISSION	SAB	AWP	09/13/2022



**Kiewit**

470 Chestnut Ridge Rd # 2,  
Woodcliff Lake, NJ 07677

**Hitachi Energy**

901 Main Campus Drive  
Raleigh, North Carolina 27606

PROJECT

**CHPE**  
Champlain Hudson  
Power Express

**Astoria HVDC  
Converter Station**

31-45 20<sup>th</sup> Avenue, Astoria, Queens NY 11105  
Block #850 - Lot #310 - BIN #4624437

**SERVICE BUILDING - FIRE  
ALARM PLAN**




DATE 12/12/2022  
PROJECT NO 105121  
DRAWING BY S. BRINKMEYER  
CHECKED BY A. POOLE  
DRAWING NO

**FA-106.00**

CADD FILE NO  
AstoriaHVDC-CHPE  
AstoriaCHPE-111-00-M3-FP-001.rvt

12 of 18




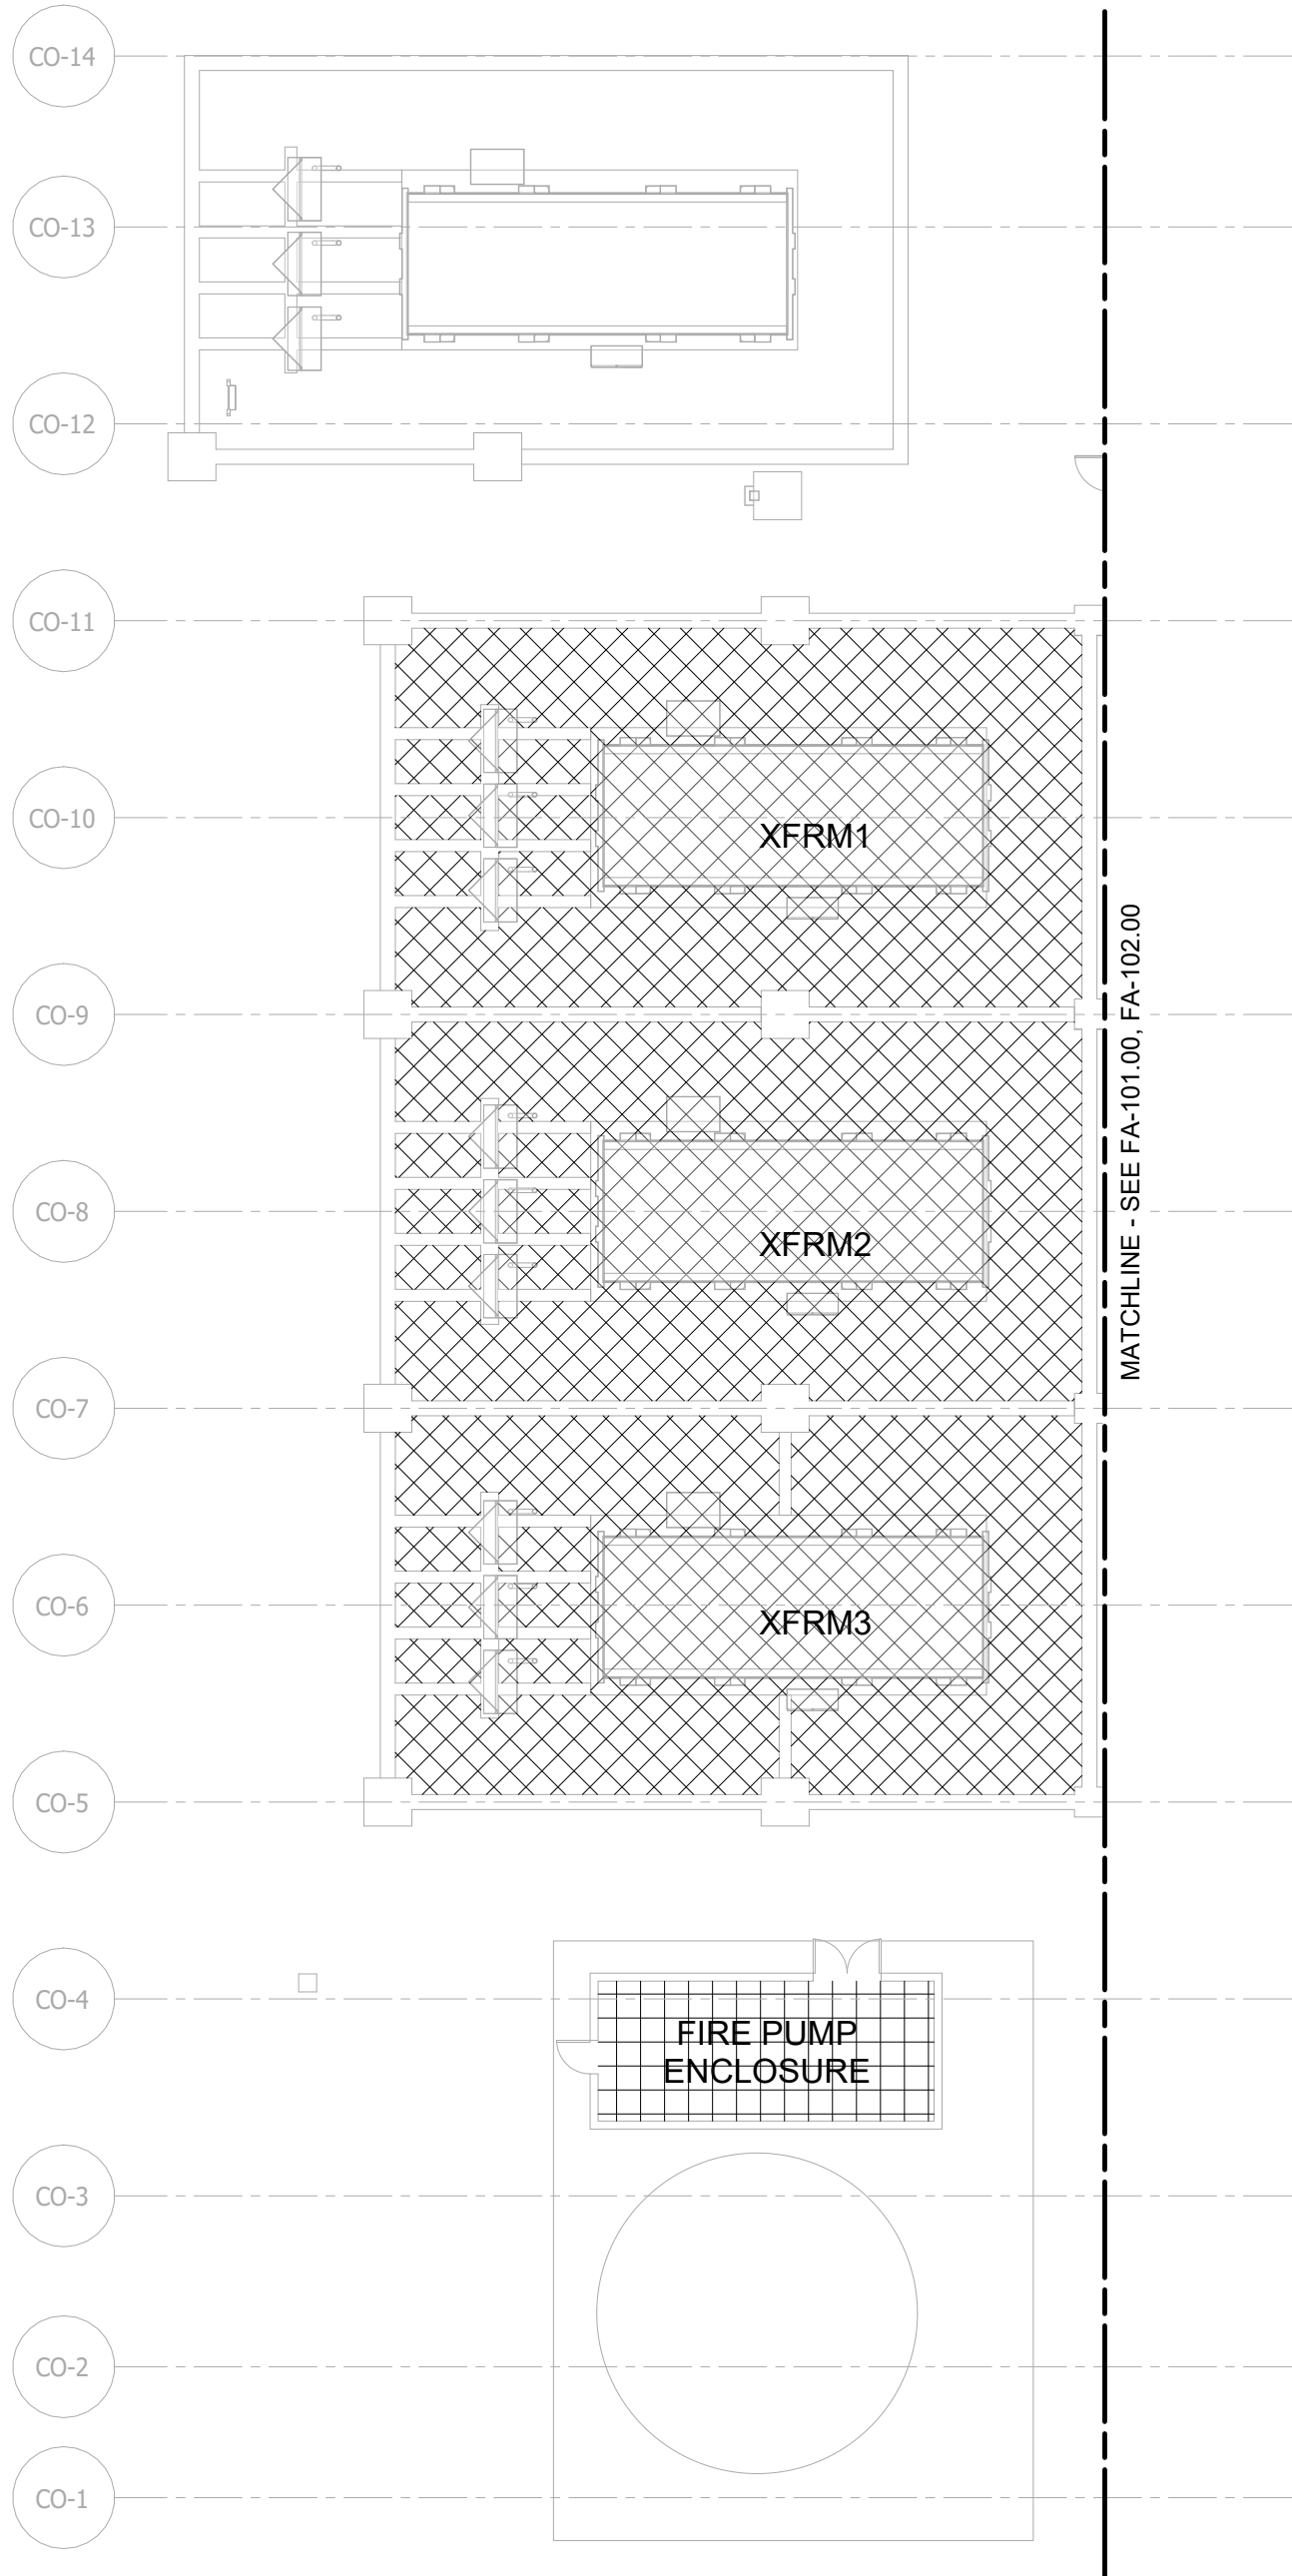

1 FIRE ALARM AUDIBILITY PLAN  
FA-107.00 1/16" = 1'-0"


AUDIBILITY HATCH LEGEND	
	FIRE ALARM NOTIFICATION NOT REQUIRED
	91dB AMBIENT SPL 106dB EXPECTED SPL

ISSUED FOR PERMIT

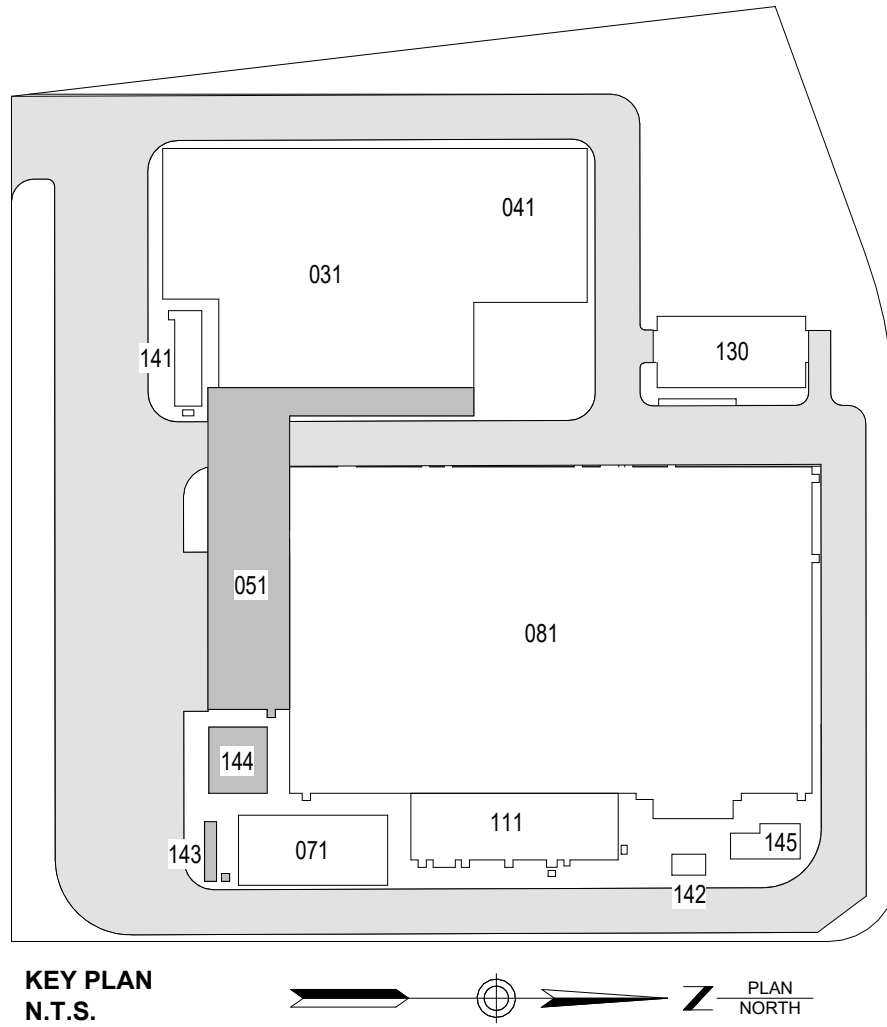

**Poole Fire Protection**  
19910 West 161st Street  
Olathe, KS 66062  
TEL: 816-666-0900 FAX: 816-666-0901

19910 W. 161st STREET  
OLATHE, KS. 66062

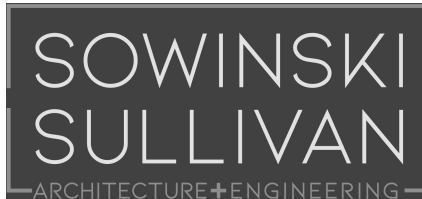

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Sparta, NJ 07871

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470 Chestnut Ridge Rd # 2,  
Woodcliff Lake, NJ 07677



901 Main Campus Drive  
Raleigh, North Carolina 27606


PROJECT



**Astoria HVDC Converter Station**


31-45 20<sup>th</sup> Avenue, Astoria, Queens NY 11105  
Block #850 - Lot #310 - BIN #4624437

**TRANSFORMER AREA AND  
PUMP ENCLOSURE FIRE  
ALARM AUDIBILITY PLAN**

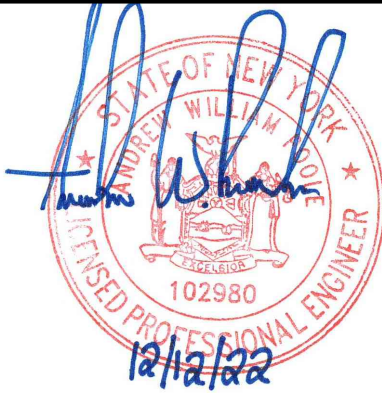


DATE	12/12/2022
PROJECT NO	105121
DRAWING BY	S. BRINKMEYER
CHECKED BY	A. POOLE
DRAWING NO	<b>FA-107.00</b>
CADD FILE NO	13 of 18



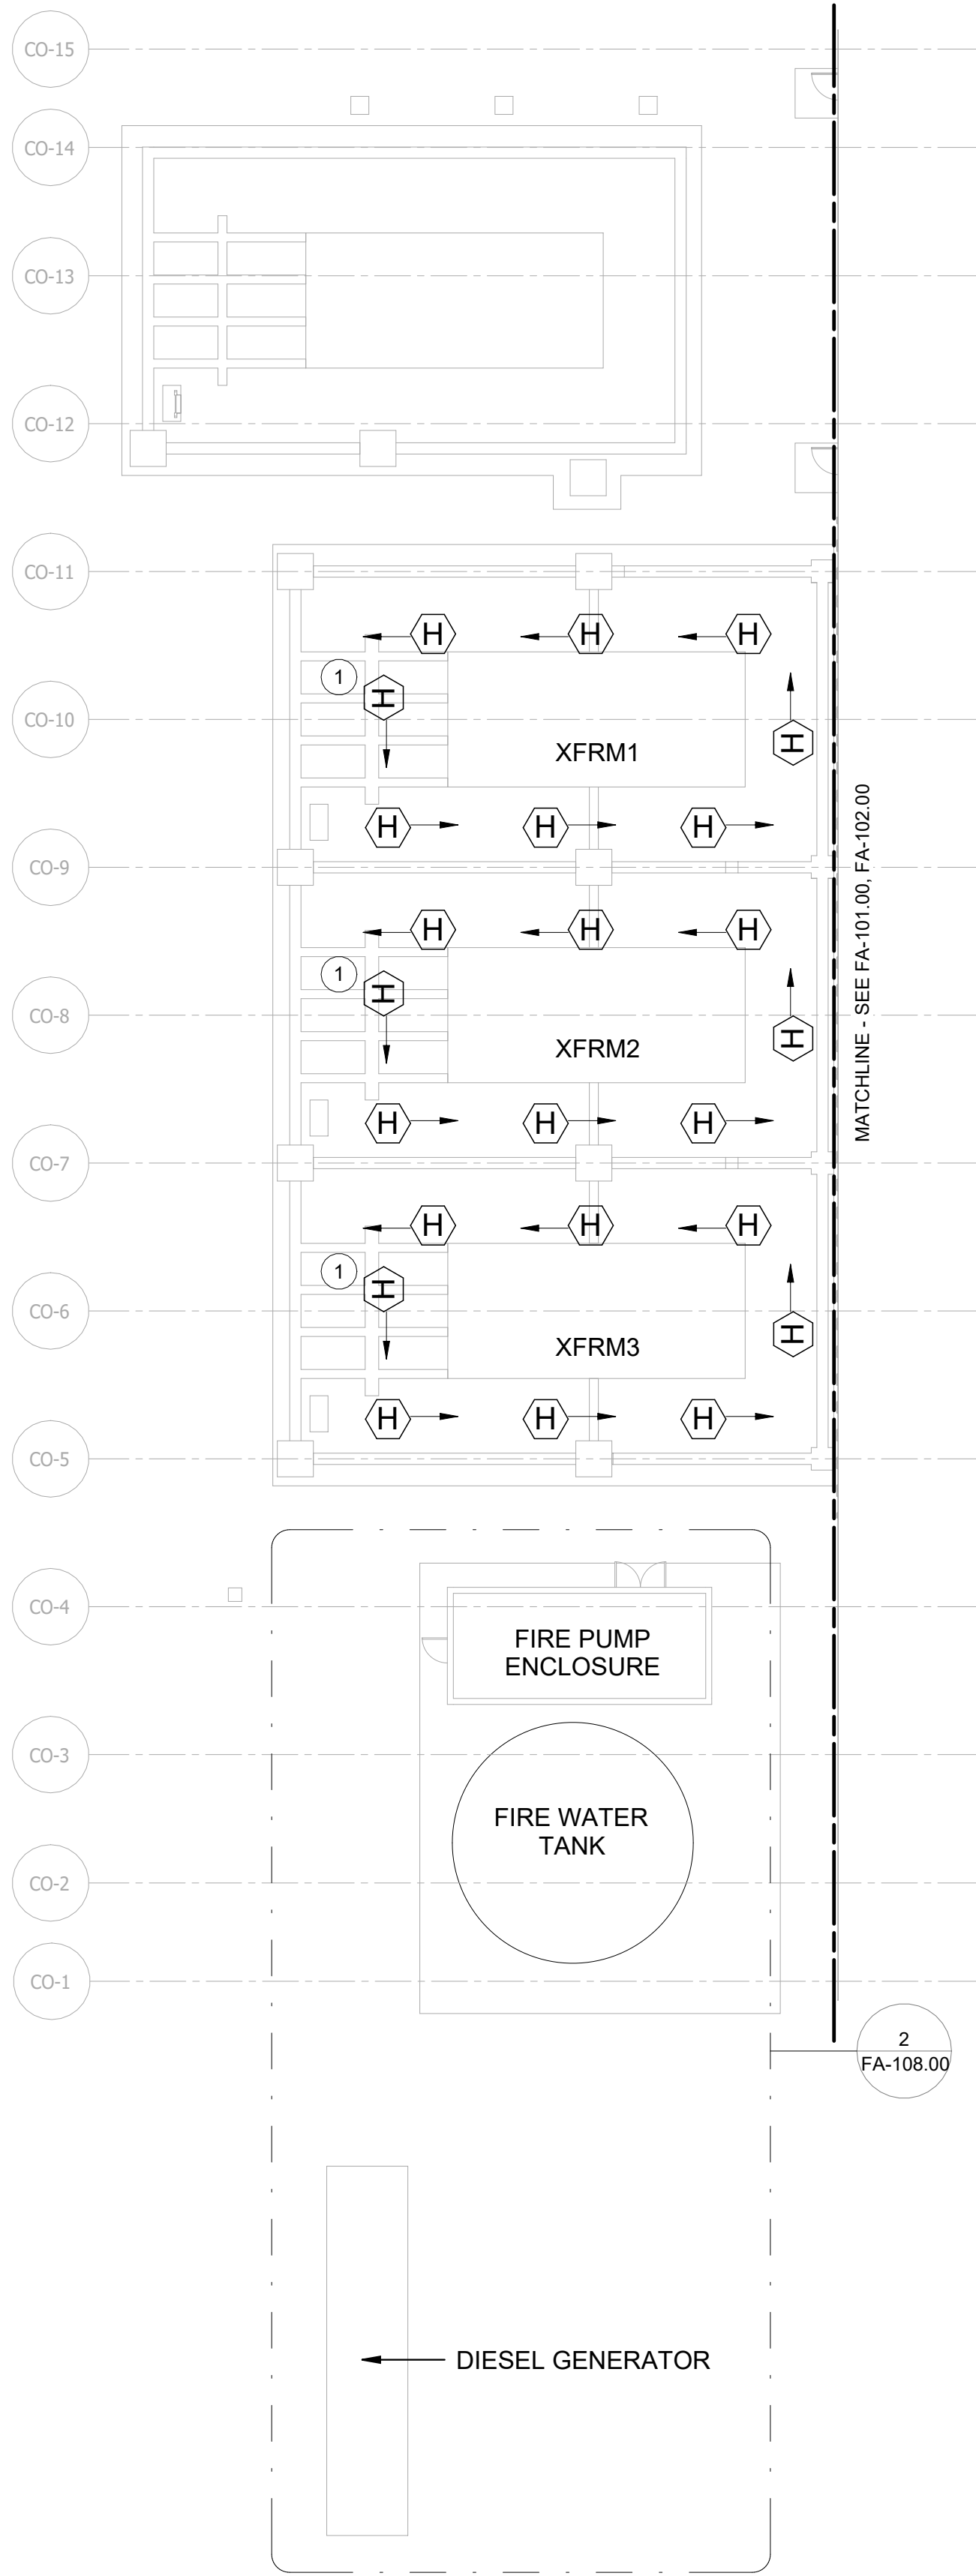

1 FIRE ALARM PLAN  
FA-108.00 1/16" = 1'-0"

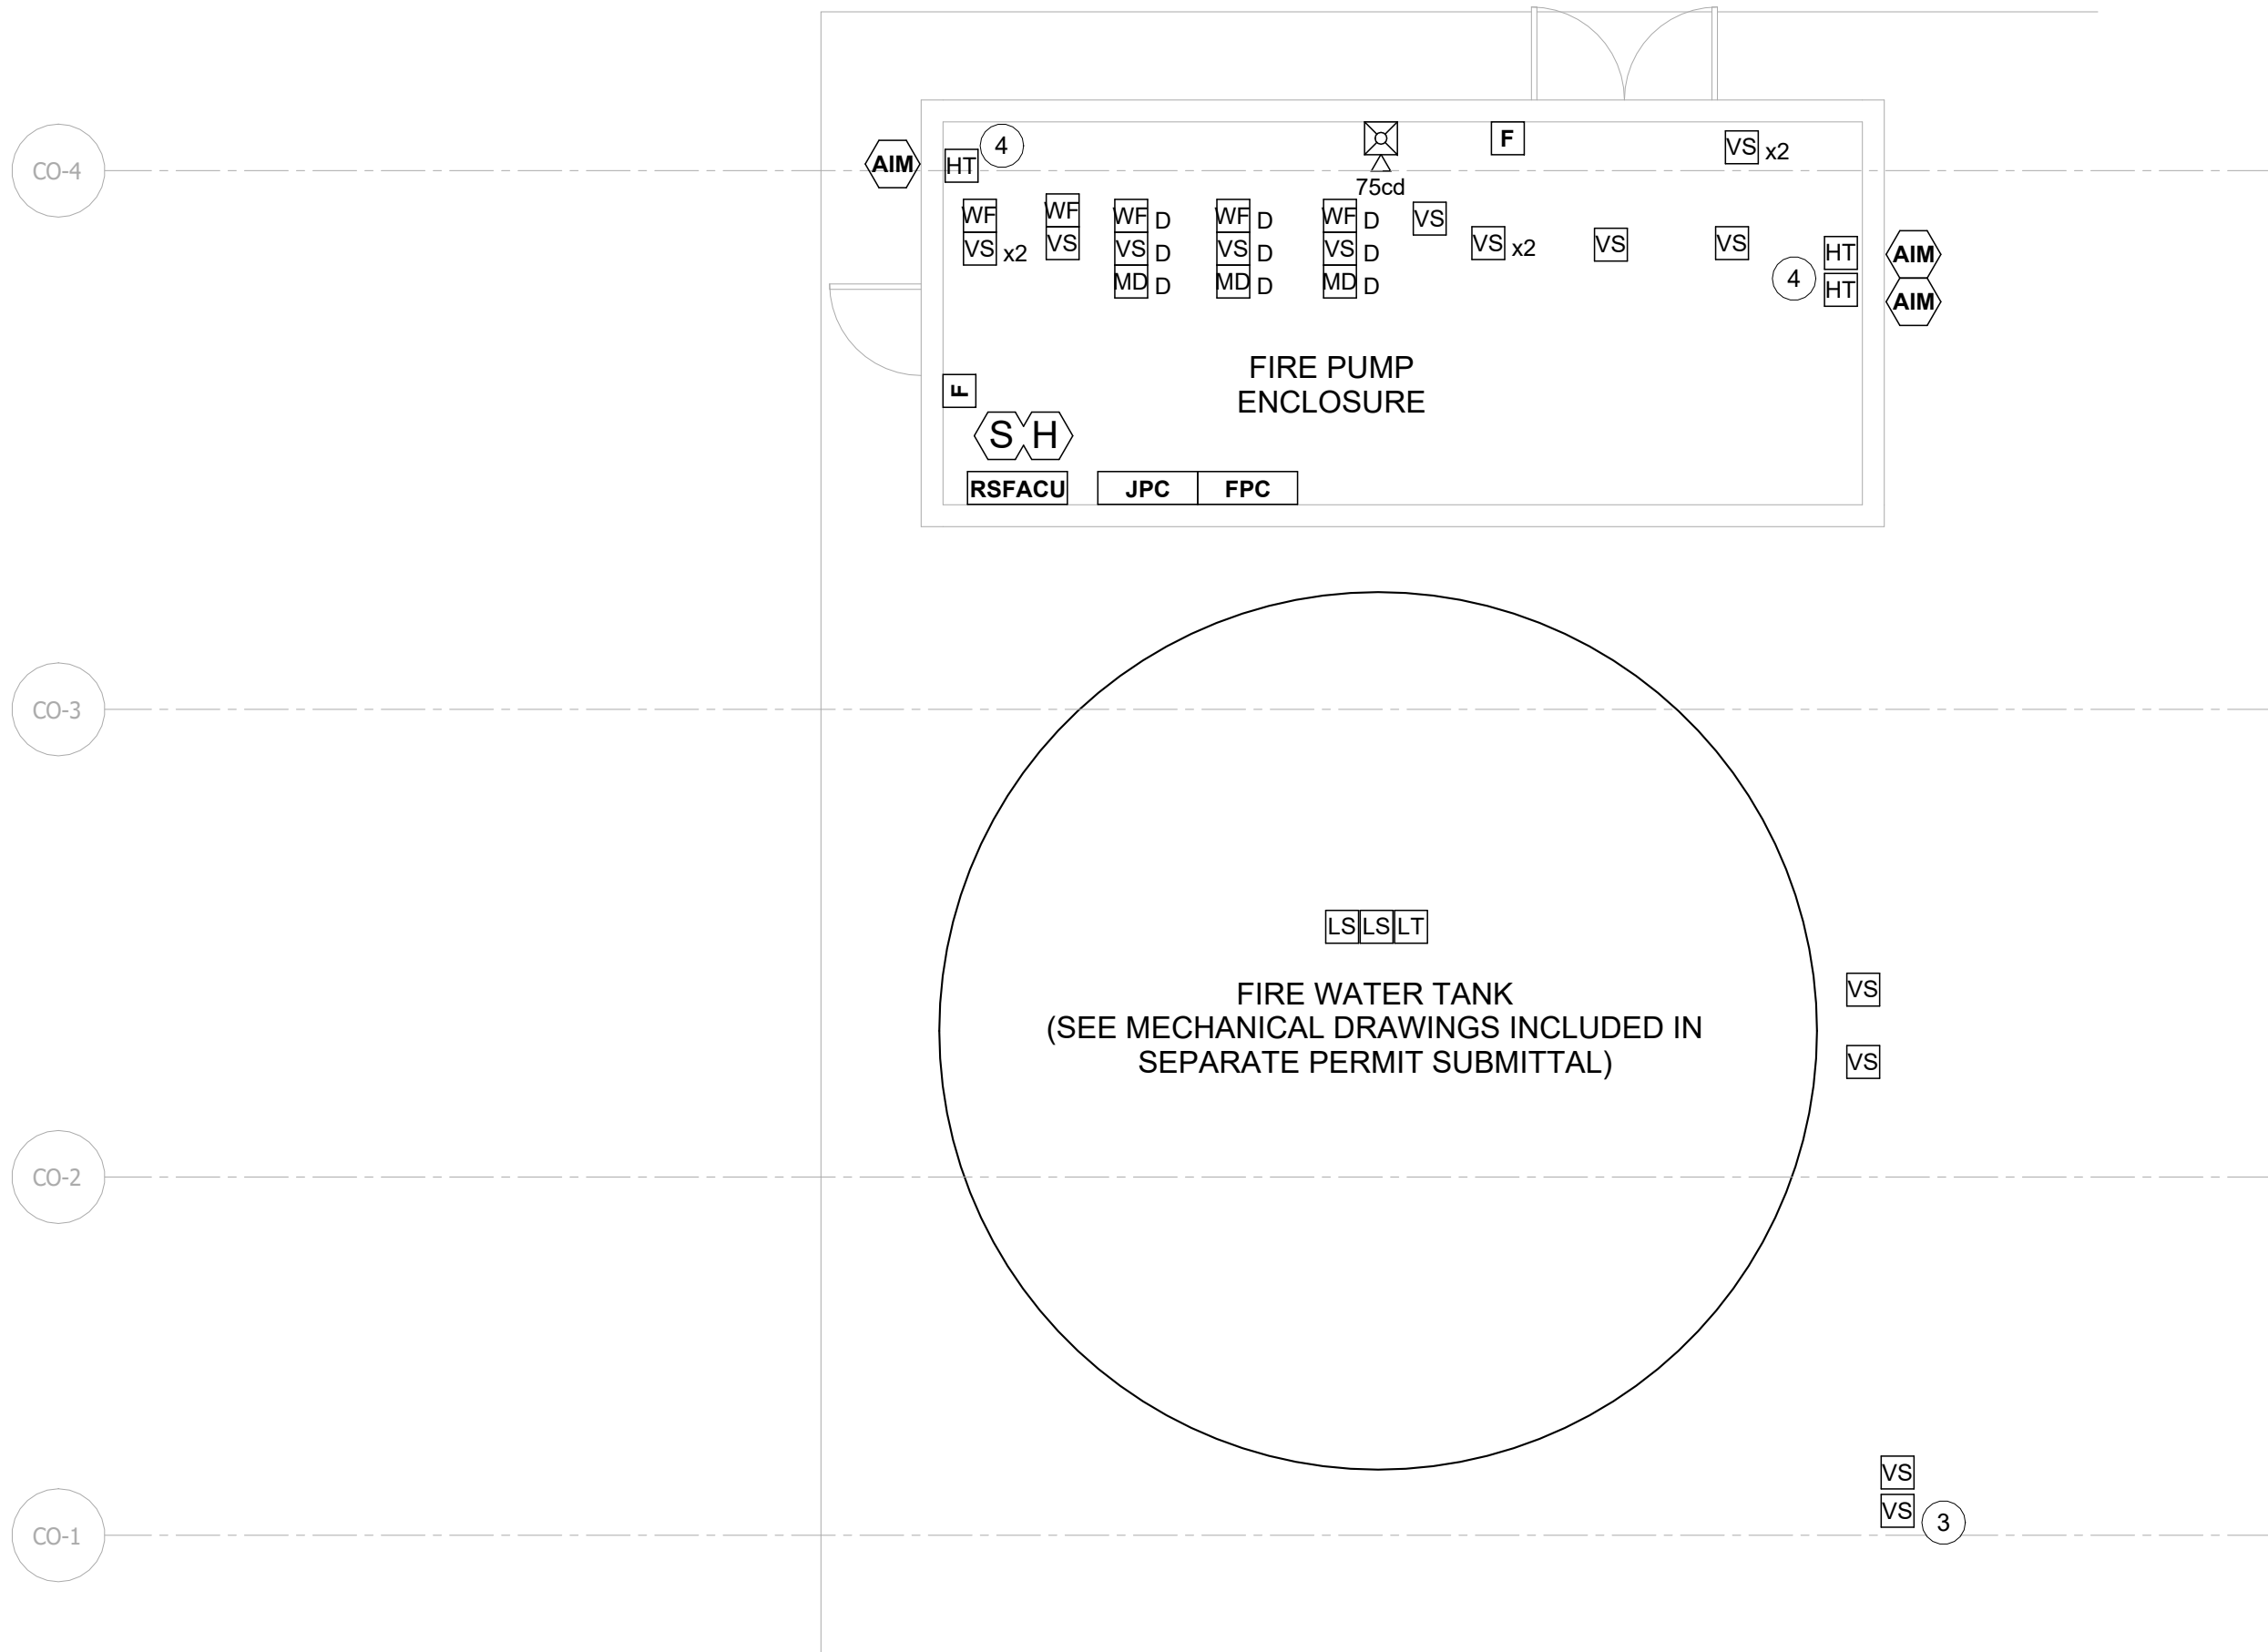


2 FIRE PUMP ENCLOSURE AND WATER TANK ENLARGED FIRE ALARM PLAN  
FA-108.00 3/16" = 1'-0"

#### KEYNOTES

- 1 LINEAR HEAT DETECTION CIRCUIT SHALL BE MONITORED BY RSFACU LOCATED WITHIN FIRE PUMP ENCLOSURE. REFER TO MECHANICAL AND ELECTRICAL DRAWINGS INCLUDED IN SEPARATE PERMIT APPLICATION.
- 2 HEAT DETECTORS WITHIN GENERATOR ENCLOSURE SHALL BE CONNECTED TO THE RSFACU LOCATED WITHIN THE FIRE PUMP ENCLOSURE.
- 3 TAMPER SWITCHES TO MONITOR TANK FILL BOOSTER PUMP VALVES. (SEE MECHANICAL DRAWINGS INCLUDED IN SEPARATE PERMIT SUBMITTAL)
- 4 MONITOR ABOVE GROUND FIRE WATER PIPING HEAT TRACING. HEAT TRACING AND INSULATION PROVIDED BY MECHANICAL IN ACCORDANCE WITH NFPA 20 AND NFPA 13. REFER TO MECHANICAL DRAWINGS INCLUDED IN SEPARATE SUBMITTAL.

ISSUED FOR PERMIT

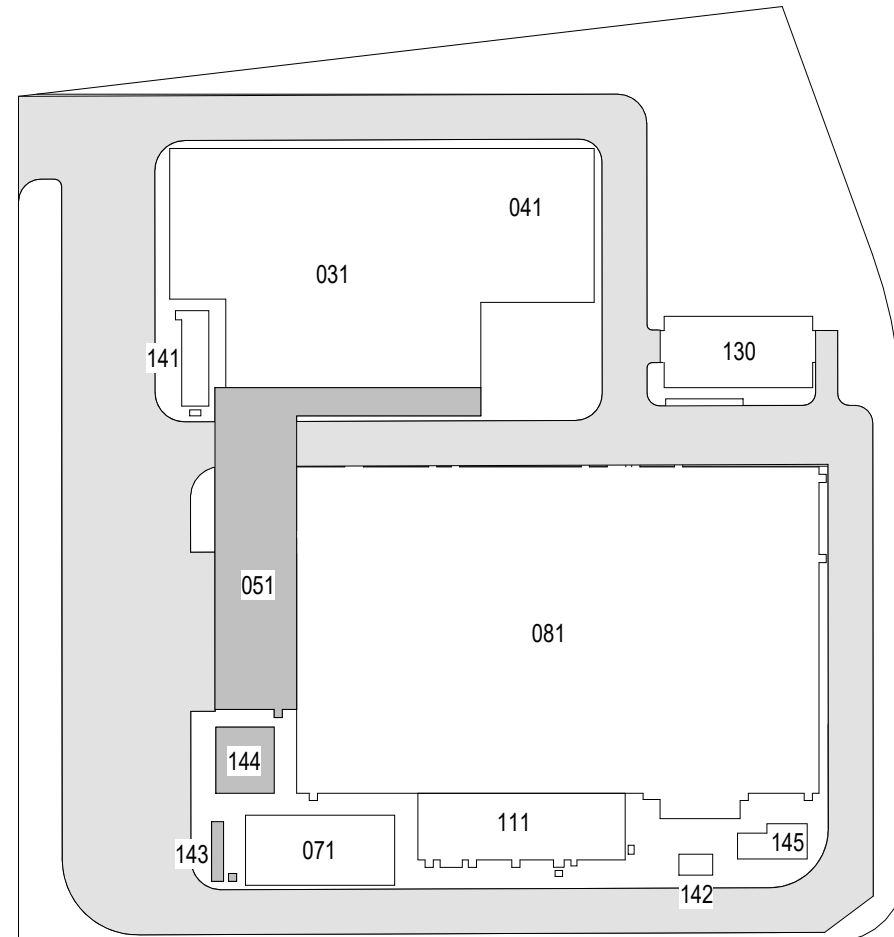

KEY PLAN  
N.T.S.



19910 W. 161st STREET  
OLATHE, KS. 66062



25 Mohawk Avenue  
Sparta, NJ 07871

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470 Chestnut Ridge Rd # 2,  
Woodcliff Lake, NJ 07677



901 Main Campus Drive  
Raleigh, North Carolina 27606

#### PROJECT



### Astoria HVDC Converter Station


31-45 20th Avenue, Astoria, Queens NY 11105  
Block #850 - Lot #310 - BIN #4624437

#### TRANSFORMER AREA AND PUMP ENCLOSURE FIRE ALARM PLAN




DATE 12/12/2022  
PROJECT NO 105121  
DRAWING BY S. BRINKMEYER  
CHECKED BY A. POOLE  
DRAWING NO  
**FA-108.00**  
CADD FILE NO  
AstoriaCHPE-081-00-M3-FP-001.rvt  
14 of 18



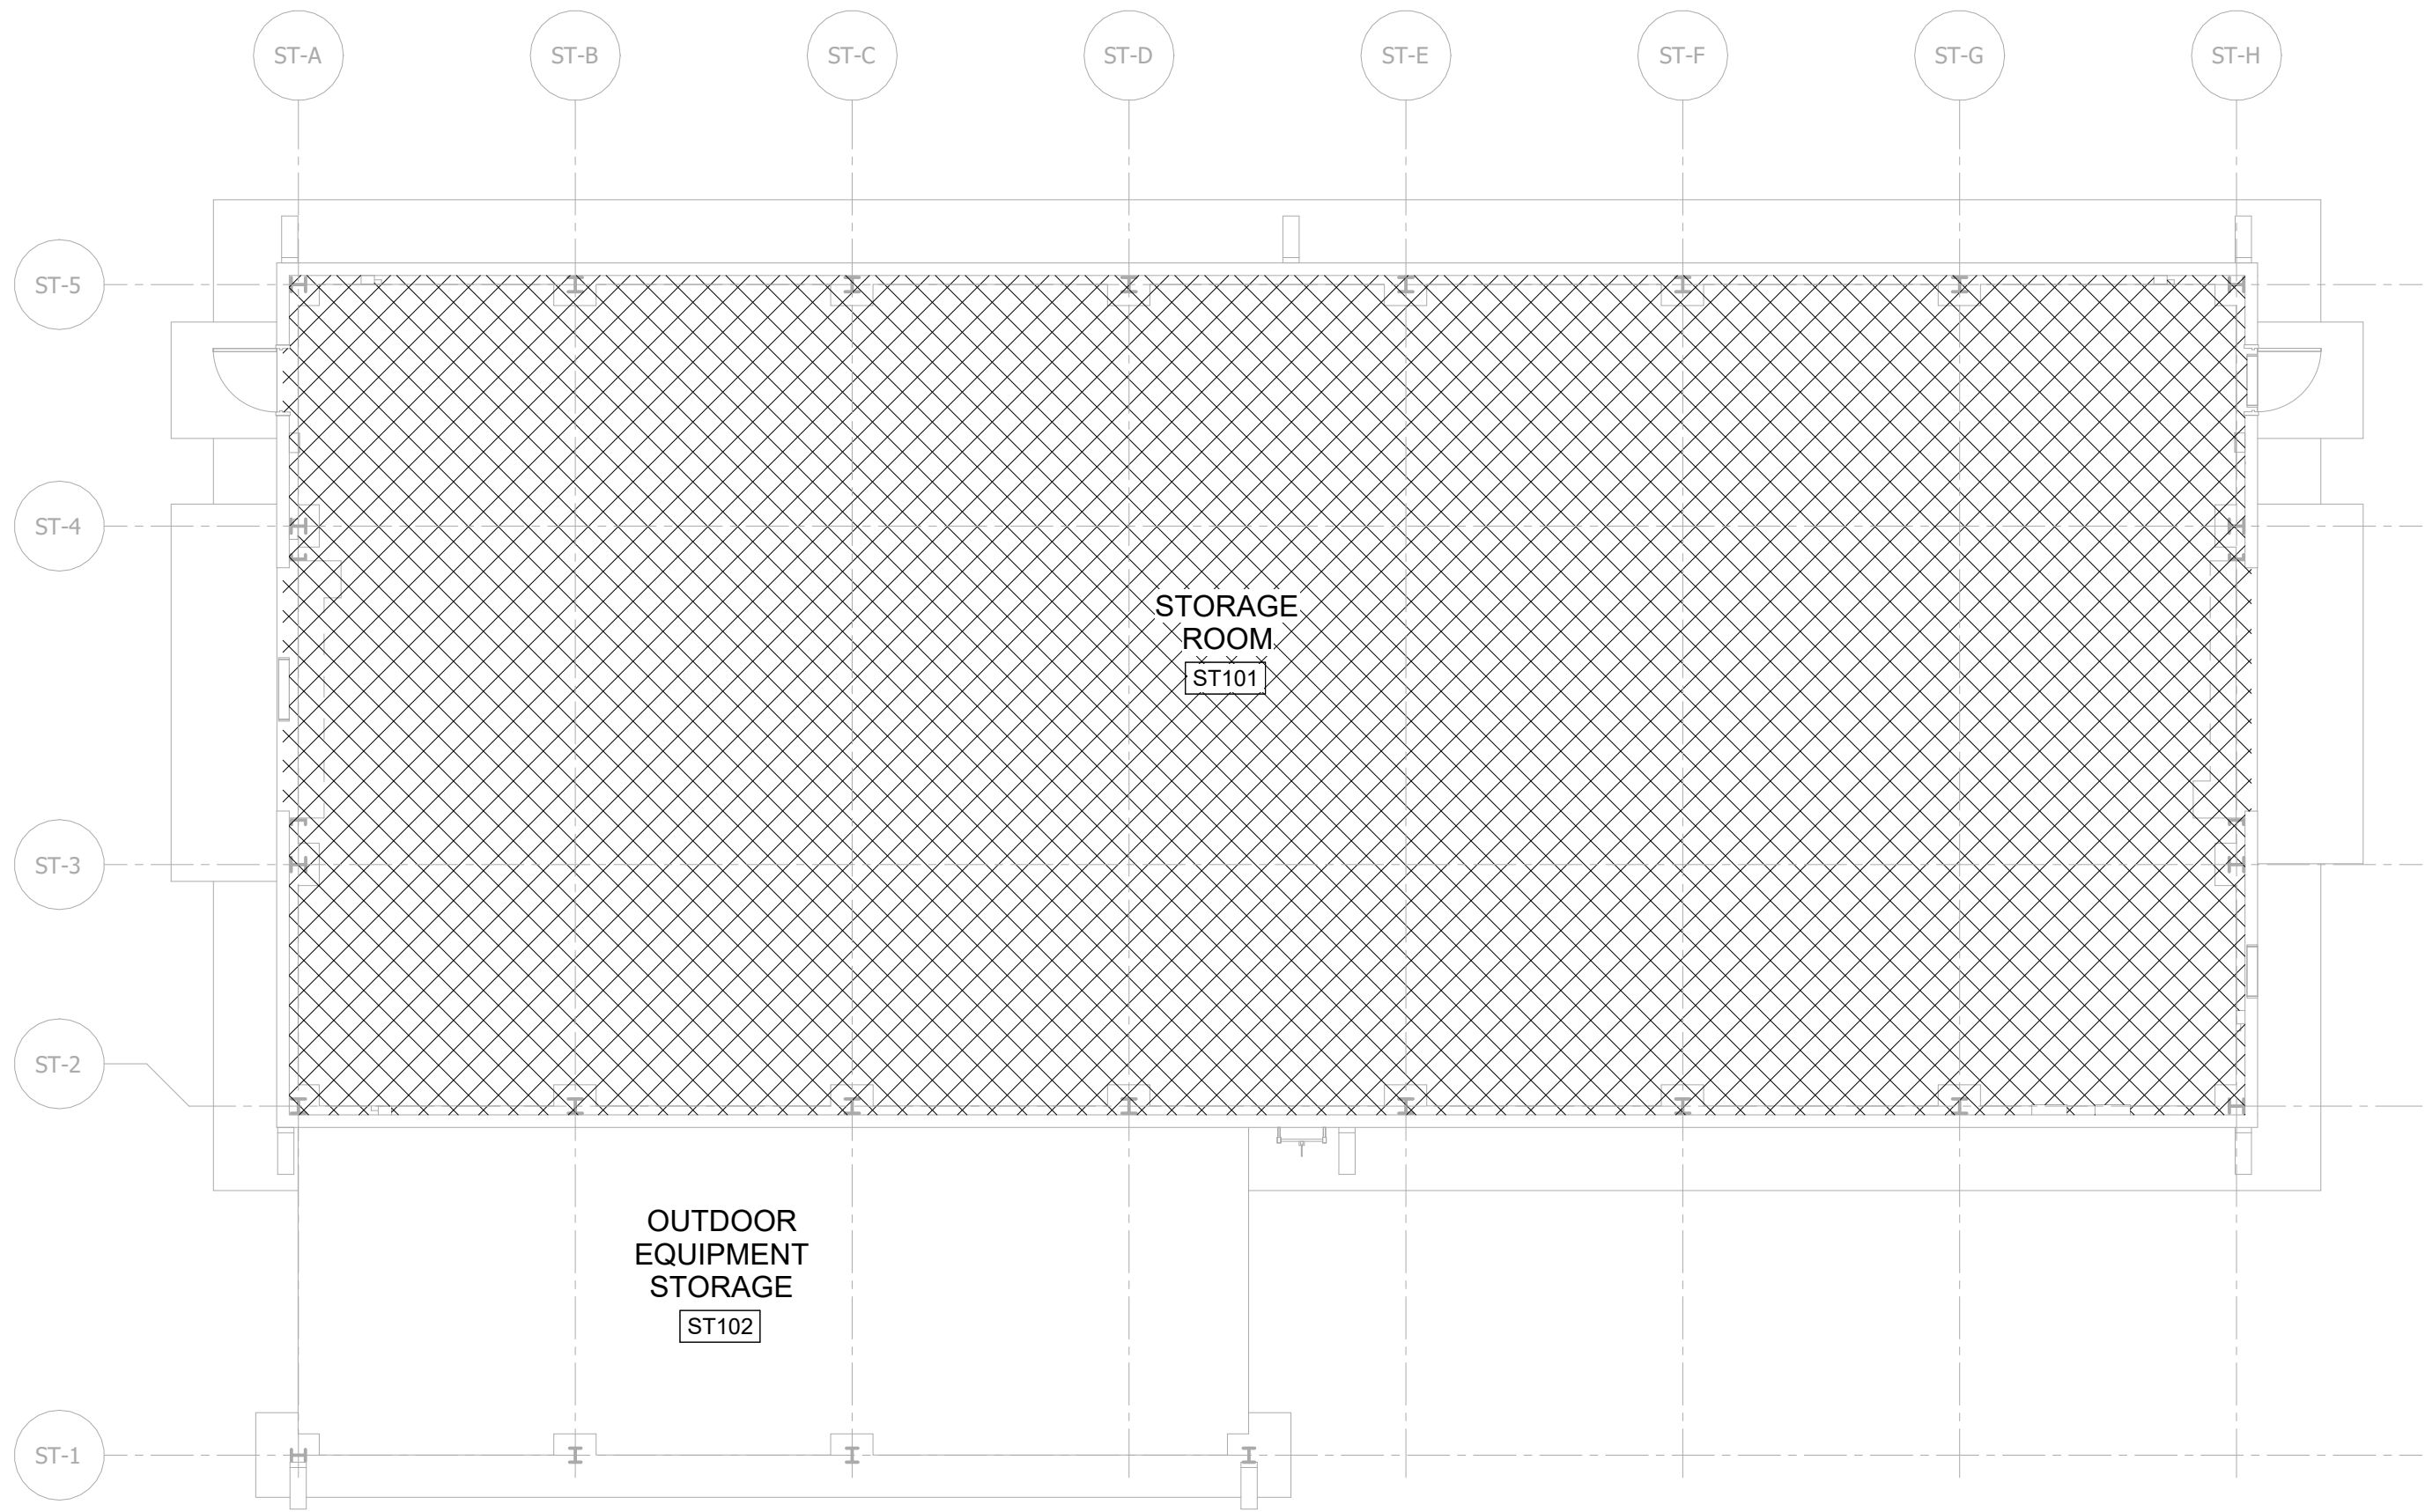

1 FIRE ALARM AUDIBILITY PLAN  
FA-109.00 1/8" = 1'-0"

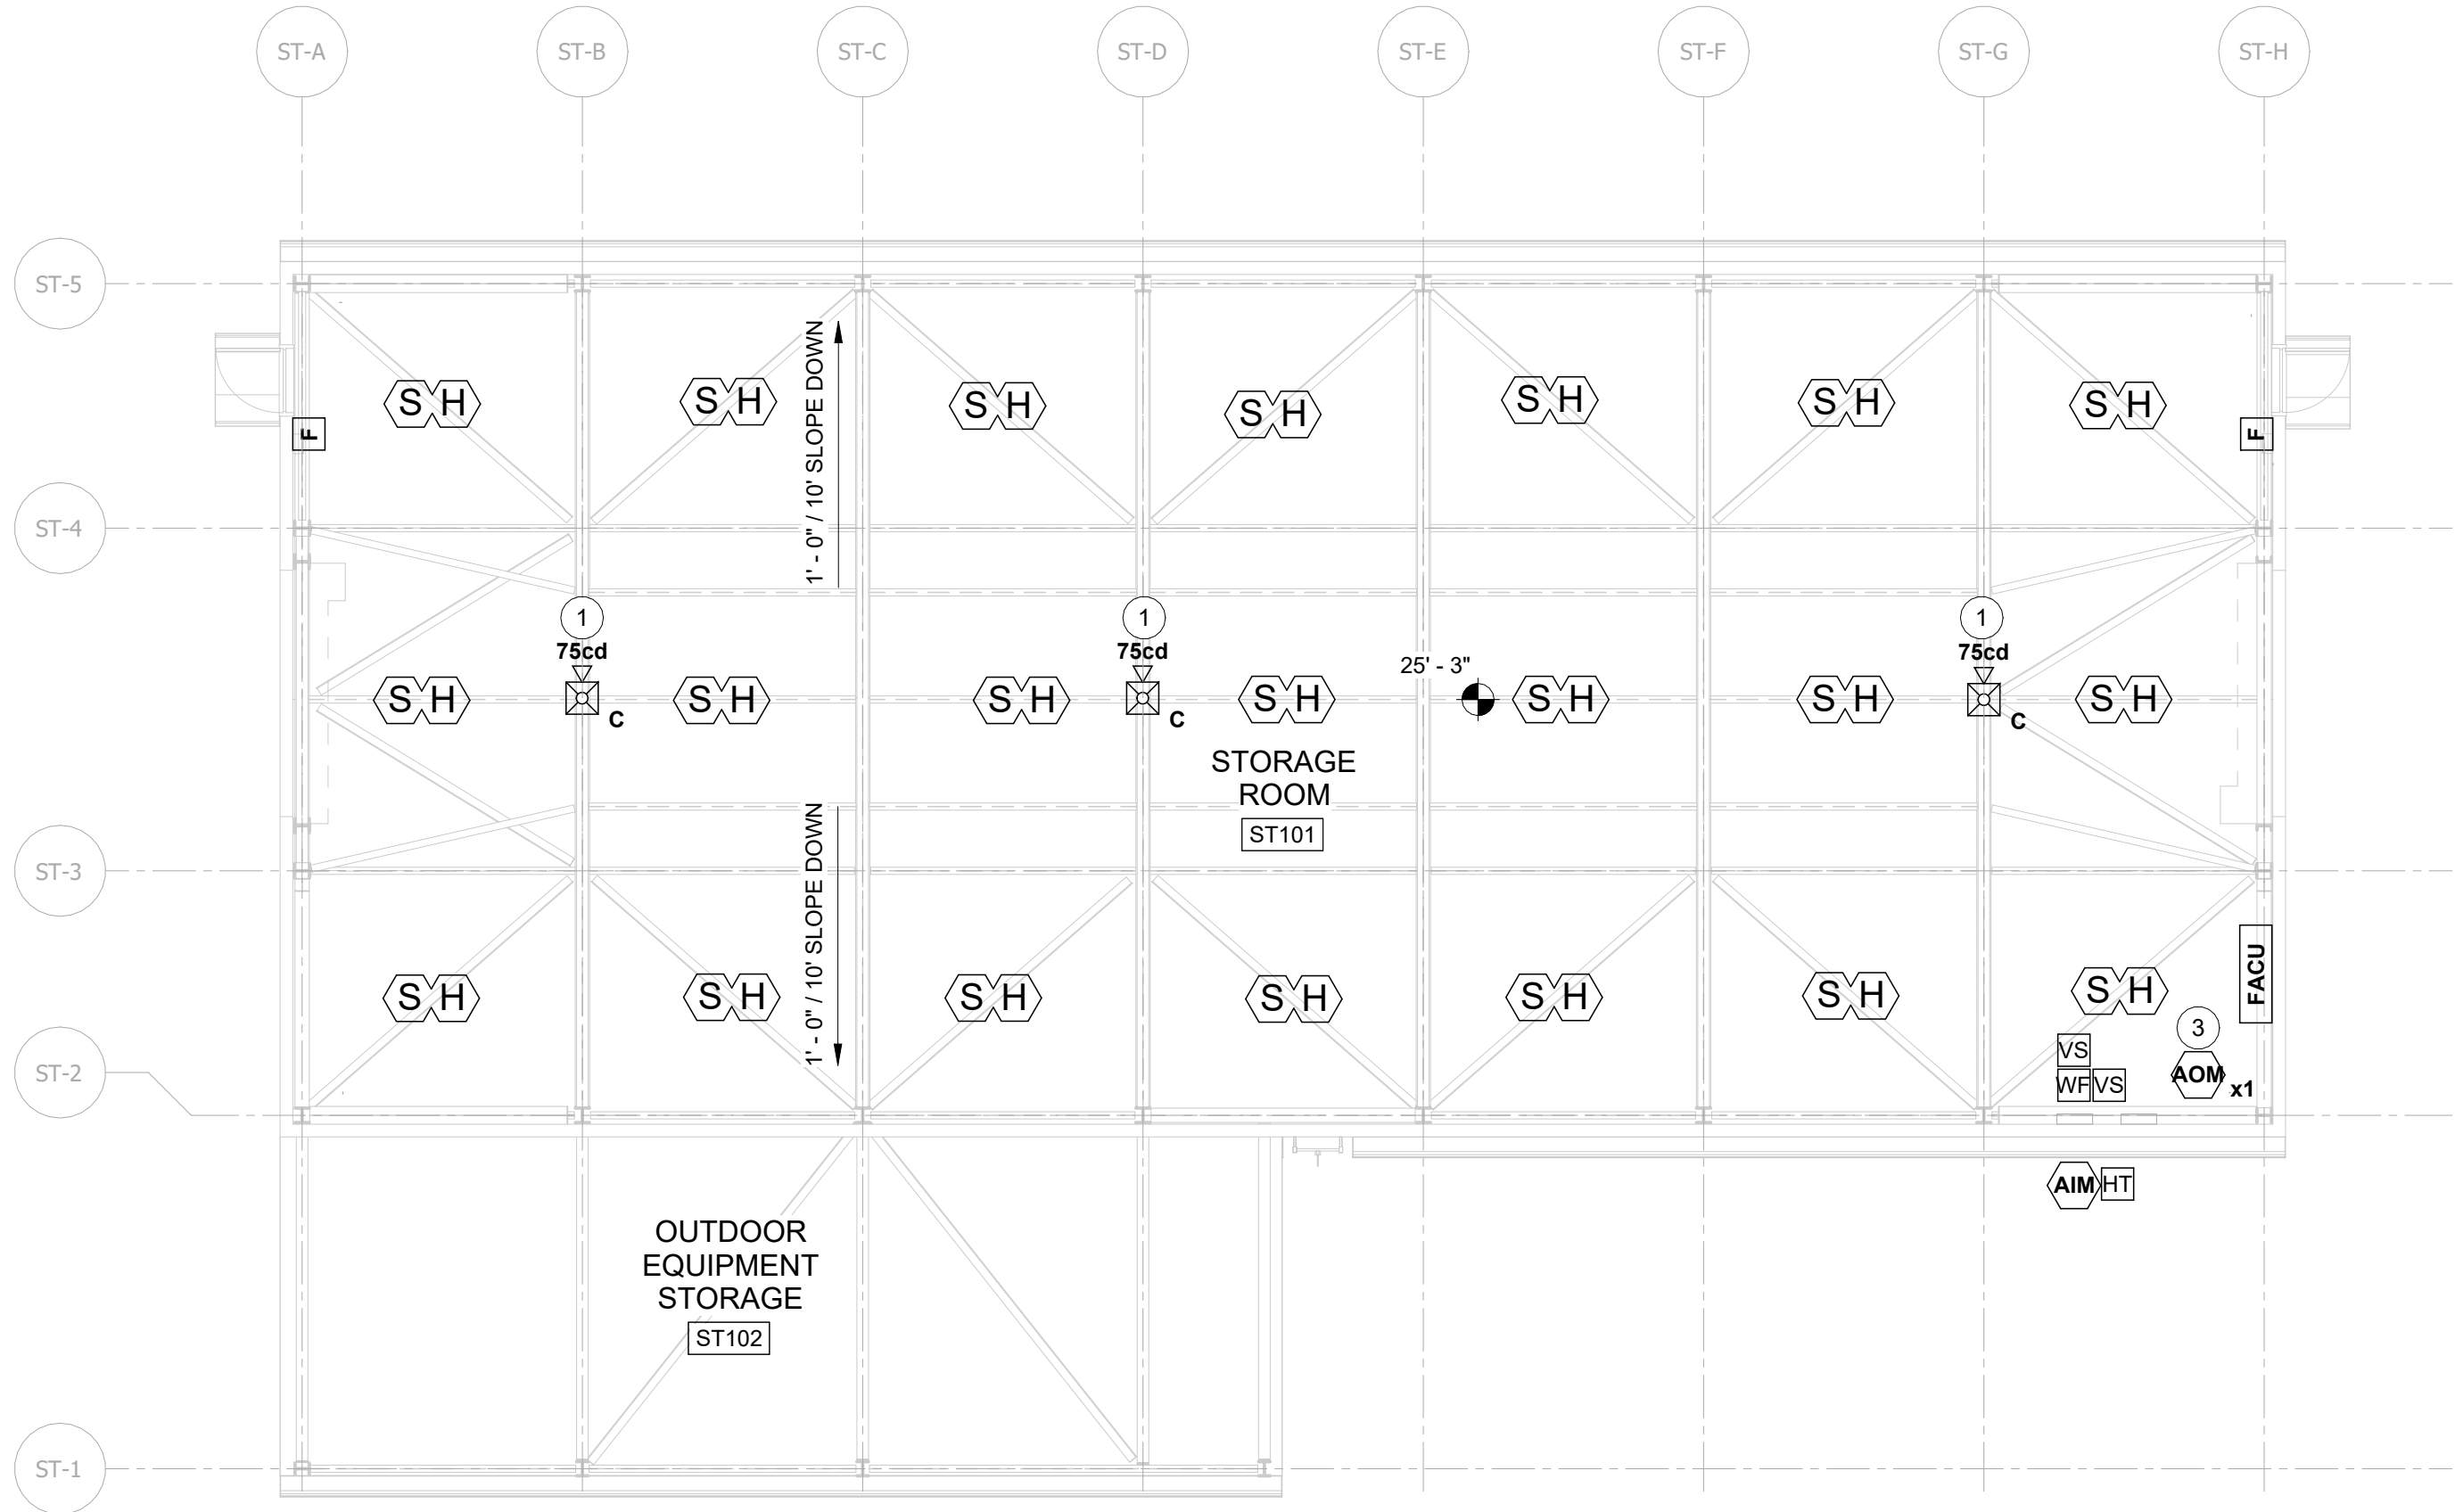

2 FIRE ALARM PLAN  
FA-109.00 1/8" = 1'-0"


KEYNOTES

- 1 DEVICES MOUNTED ON BOTTOM OF STRUCTURE.
- 2 MONITOR FIRE WATER LEAD-IN HEAT TRACING. HEAT TRACING AND INSULATION PROVIDED BY MECHANICAL IN ACCORDANCE WITH NFPA 20 AND NFPA 13. REFER TO MECHANICAL DRAWINGS INCLUDED IN SEPARATE SUBMITTAL.
- 3 POST-FIRE SMOKE PURGE ACTIVATION. SEE INPUT/OUTPUT MATRIX.

AUDIBILITY HATCH  
LEGEND

	30dB AMBIENT SPL
	45dB EXPECTED SPL

ISSUED FOR PERMIT

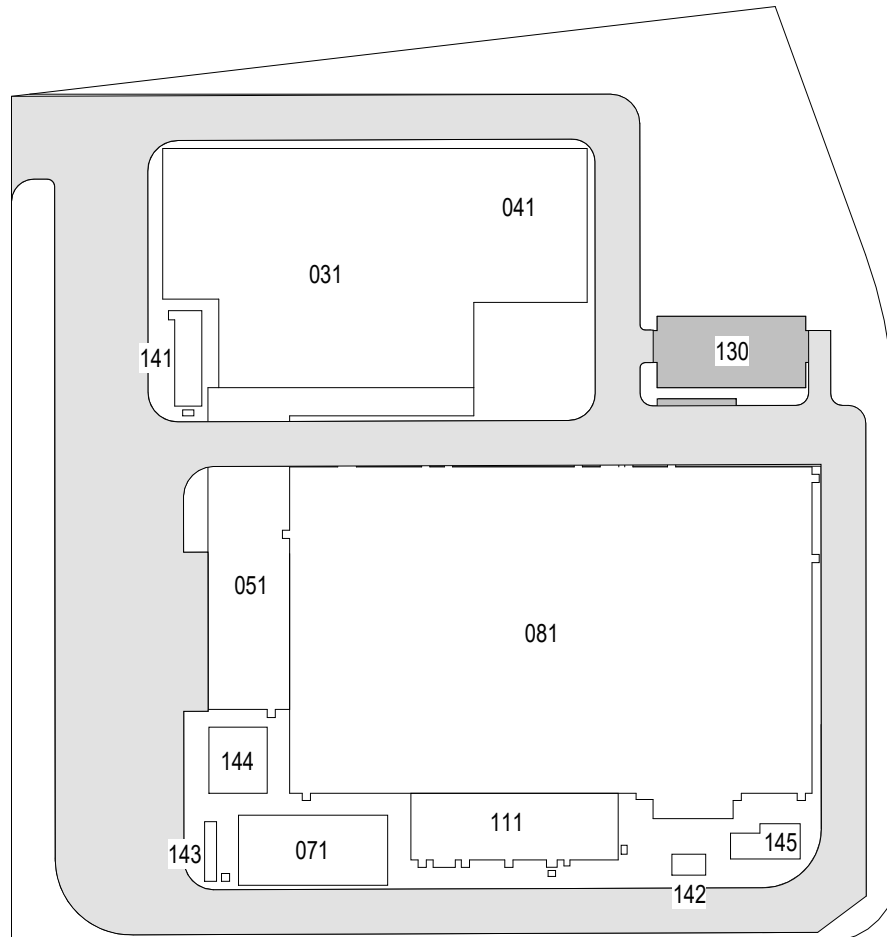


KEY PLAN  
N.T.S.

PLAN  
NORTH



Poole Fire Protection  
19910 W. 161st Street  
Olathe, KS 66062  
913.429.0000 POB 19910 W. 161st Street

19910 W. 161st STREET  
OLATHE, KS. 66062

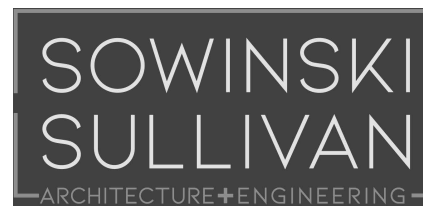

25 Mohawk Avenue  
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A	INTERIM SUBMISSION	AWP	SAB	09/13/2022



**Kiewit**

470 Chestnut Ridge Rd # 2,  
Woodcliff Lake, NJ 07677

**Hitachi Energy**

901 Main Campus Drive  
Raleigh, North Carolina 27606


PROJECT

**CHPE**  
Champlain Hudson  
Power Express

**Astoria HVDC  
Converter Station**

31-45 20<sup>th</sup> Avenue, Astoria, Queens NY 11105  
Block #850 - Lot #310 - BIN #4624437

**STORAGE ENCLOSURE -  
FIRE ALARM PLAN**

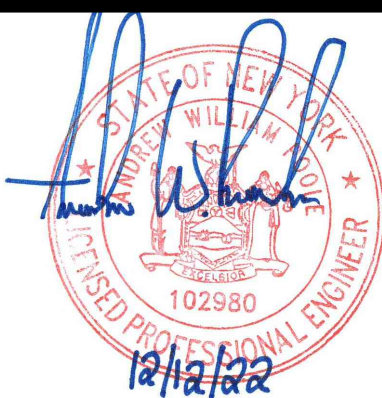

DATE 12/12/2022  
PROJECT NO 105121  
DRAWING BY S. BRINKMEYER  
CHECKED BY A. POOLE  
DRAWING NO

**FA-109.00**

CADD FILE NO  
AstoriaHVDC-CHPE  
AstoriaCHPE-130-00-M3-FP-001.rvt

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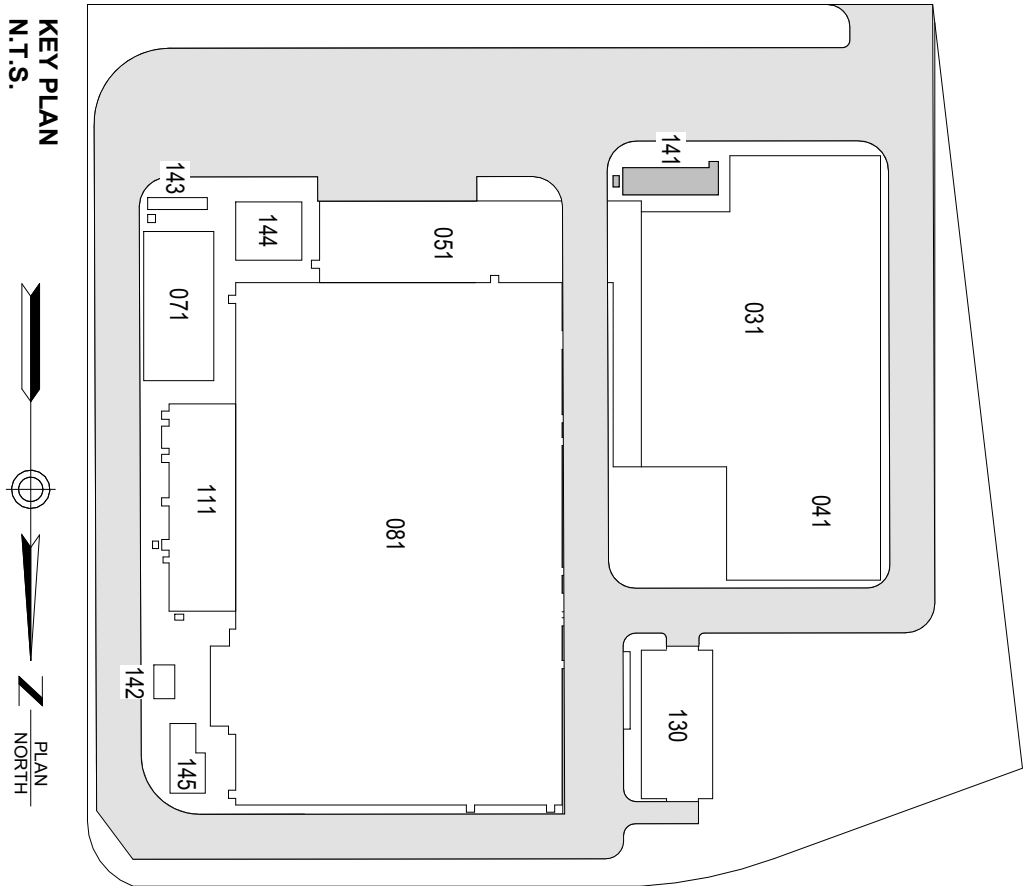


AUDIBILITY HATCH  
LEGEND

30dB AMBIENT SPL

45dB EXPECTED SPL

ISSUED FOR PERMIT



Pool Fire Protection

Contract No. 60662

12/12/2022

19910 W. 161st STREET  
OLATHE, KS. 66062

SOWINSKI SULLIVAN

ARCHITECTURE+ENGINEERING

25 Mohawk Avenue  
Sparta, NJ 07871

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REV	DESCRIPTION	DATE
B	FINAL SUBMISSION	12/12/2022
A	INTERIM SUBMISSION	09/13/2022
REV	DESCRIPTION	DATE
AWP	SAB	12/12/2022
AWP	SAB	09/13/2022
DRW BY	CHK BY	DATE

Kiewit

470 Chestnut Ridge Rd # 2,  
Woodcliff Lake, NJ 07677

Hitachi Energy

901 Main Campus Drive  
Raleigh, North Carolina 27606

PROJECT

CHPE

Champlain Hudson  
Power Express

Astoria HVDC  
Converter Station  
31-45 20th Avenue, Astoria, Queens NY 11105  
Block #830 - Lot #310 - BIN #4624437

RELAY ENCLOSURE - FIRE  
ALARM PLAN

1 FIRE ALARM AUDIBILITY PLAN - RELAY BUILDING  
FA-110.00 1/4" = 1'-0"

2 FIRE ALARM PLAN  
FA-110.00 1/4" = 1'-0"

3 FIRE ALARM PLAN BELOW RAISED FLOOR  
FA-110.00 1/4" = 1'-0"

Professional Engineer


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12/12/2022


FA-110.00

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1 FIRE ALARM AUDIBILITY PLAN  
FA-111.00 3/8" = 1'-0"



2 FIRE ALARM PLAN  
FA-111.00 3/8" = 1'-0"

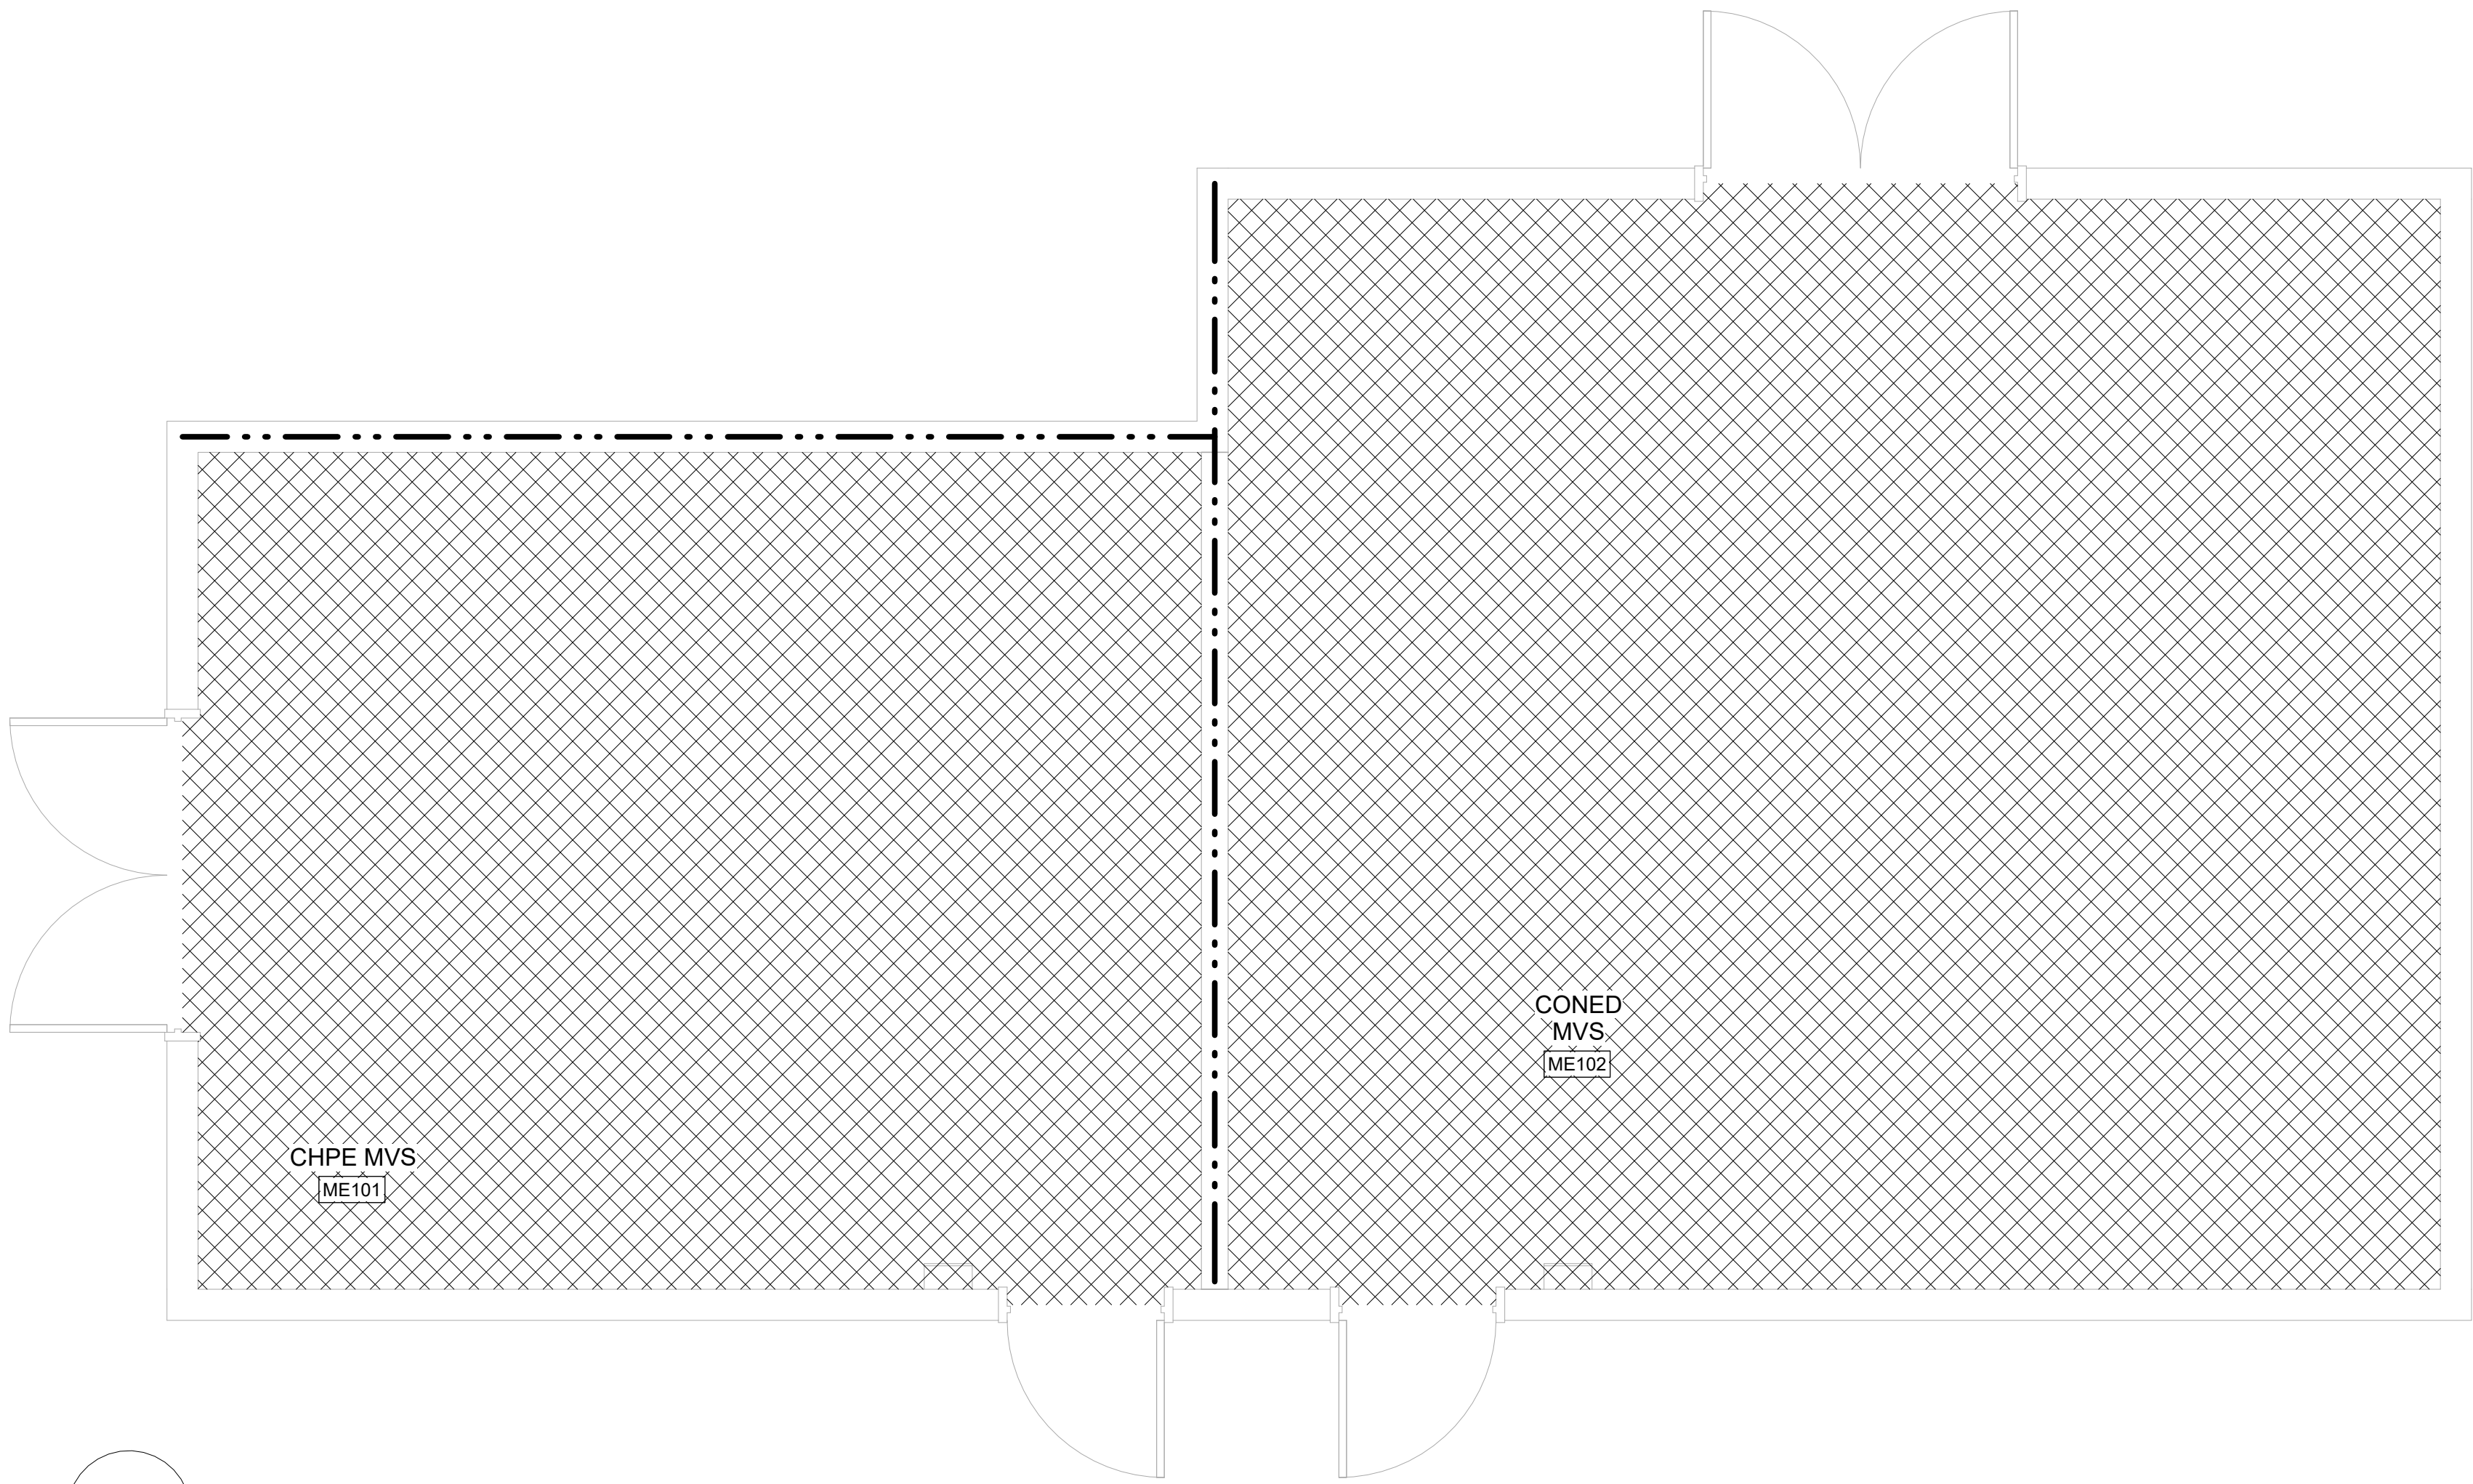AUDIBILITY HATCH  
LEGEND

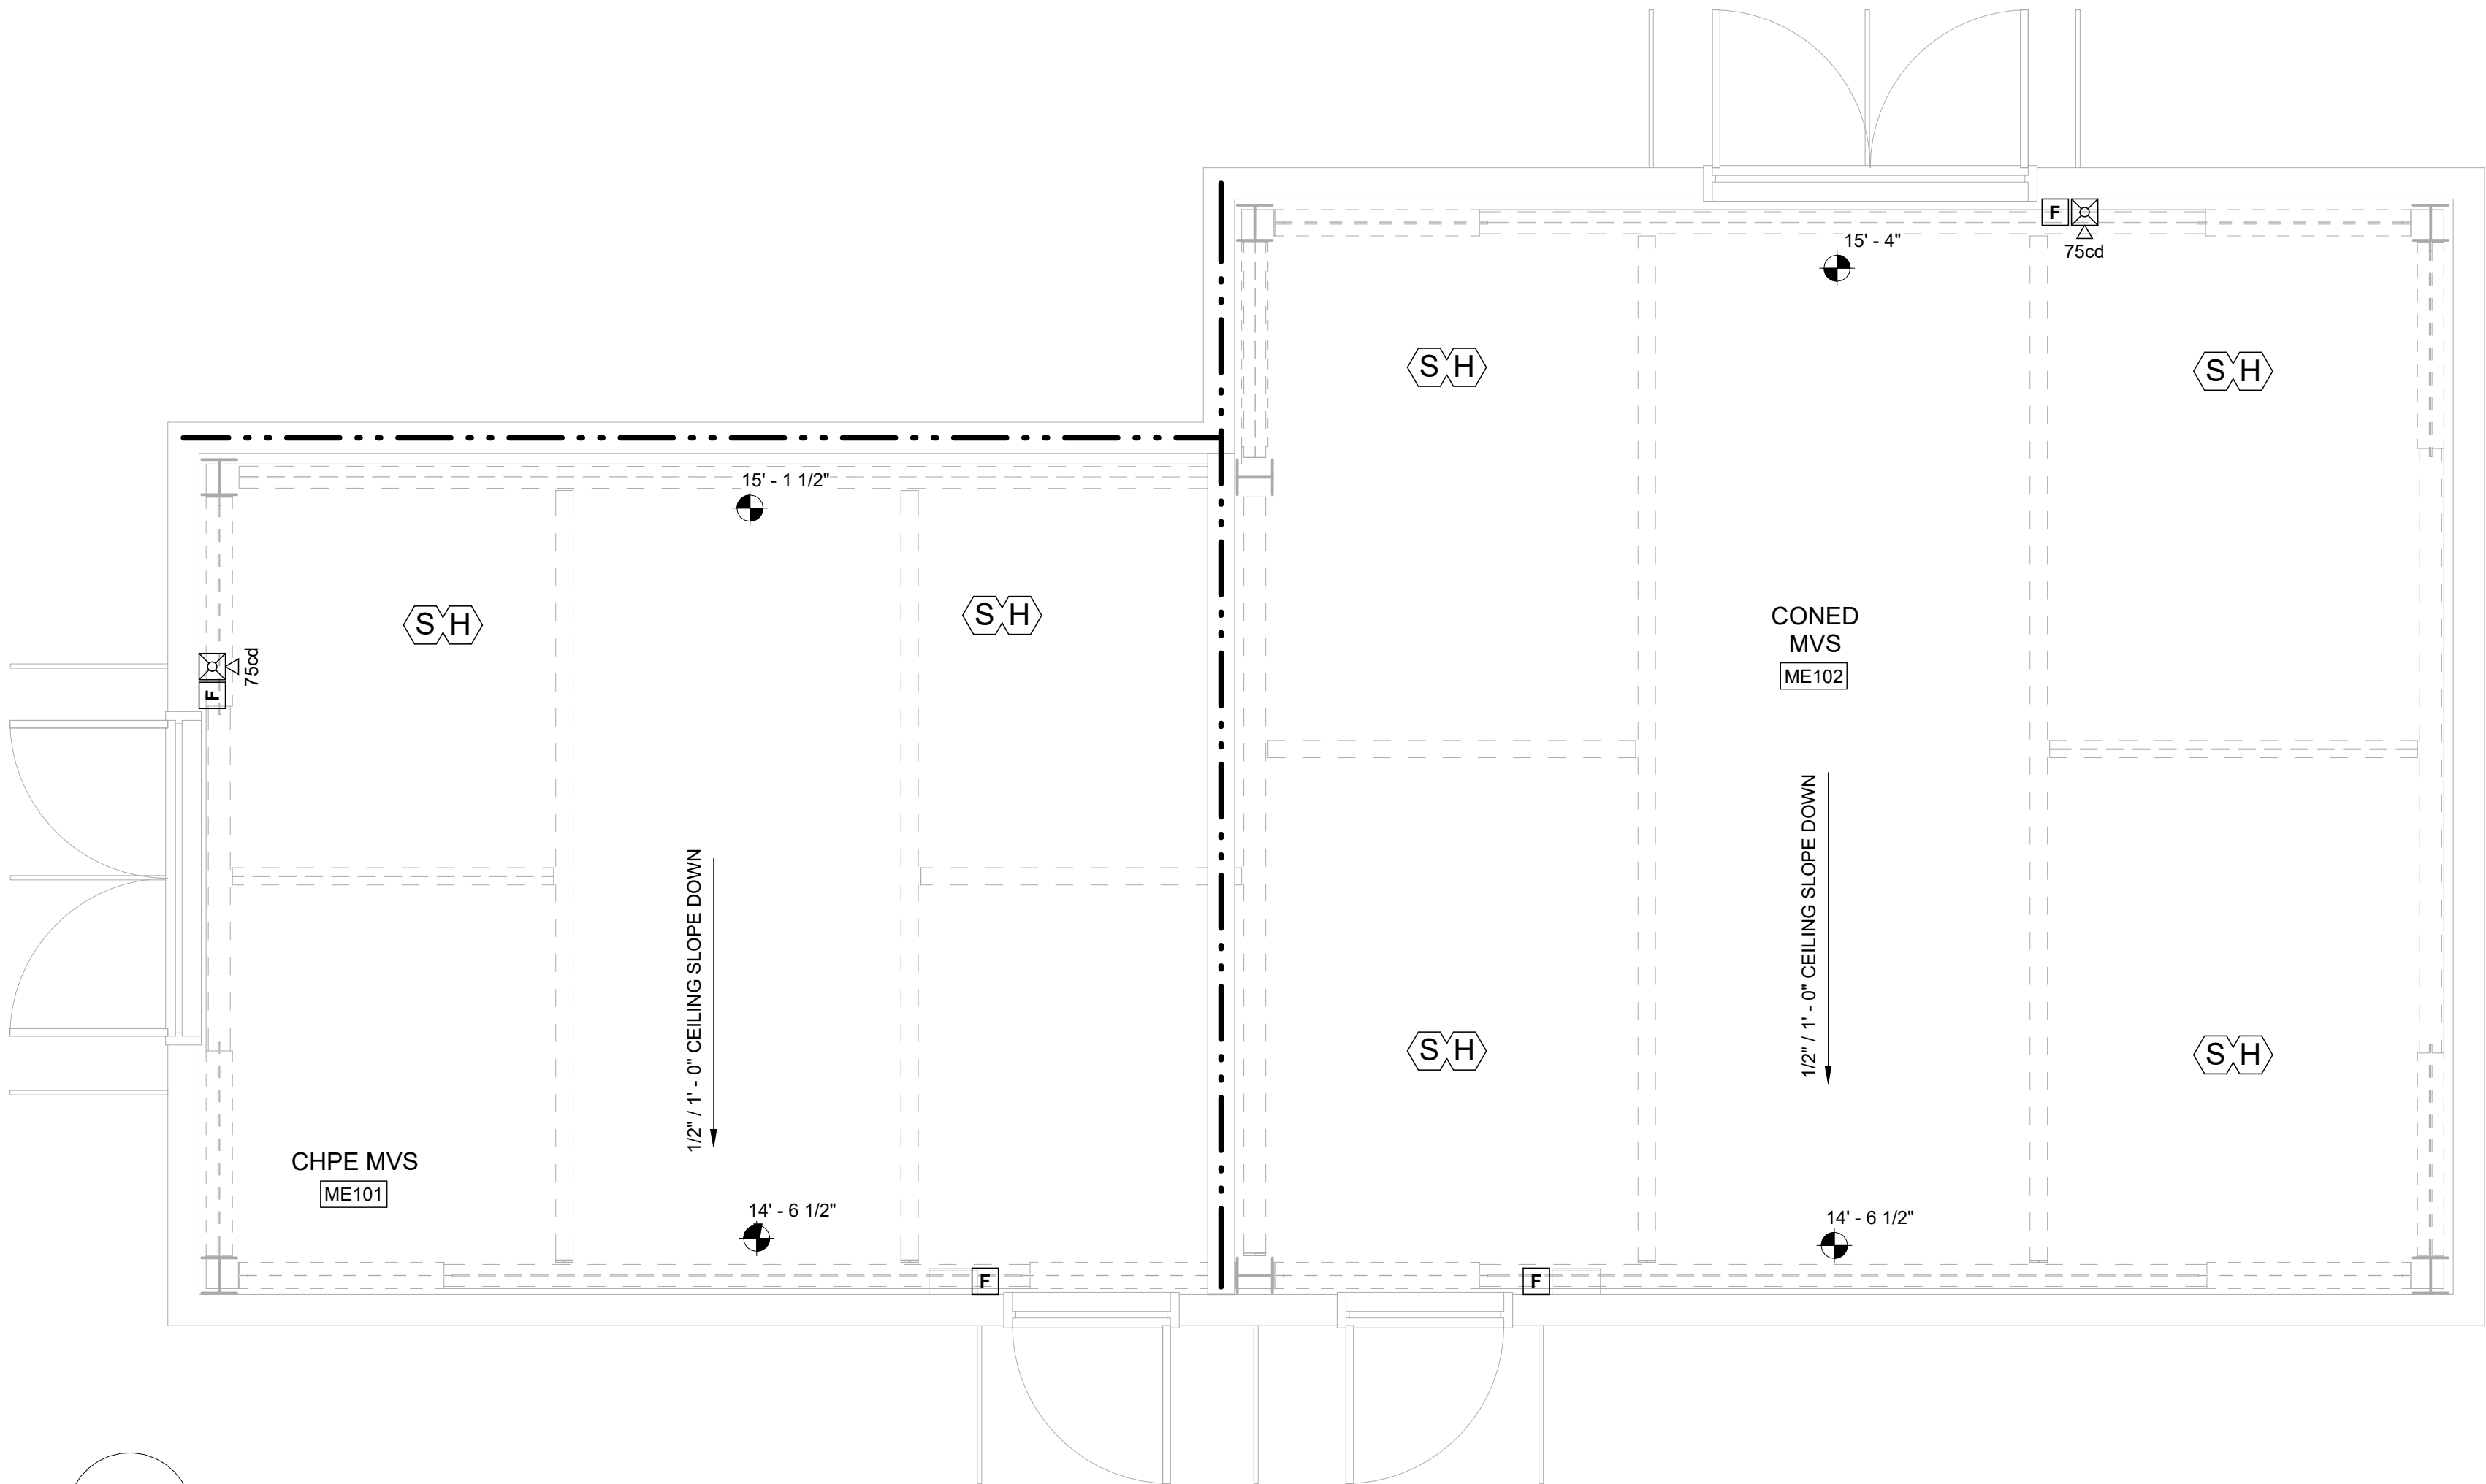
30dB AMBIENT SPL  
45dB EXPECTED SPL

RATED WALL LEGEND

2 HOUR FIRE BARRIER

NOTE: RATED WALLS ARE REFERENCED FROM  
ARCHITECTURAL PLANS. INCLUDED IN SEPARATE PERMIT  
SUBMITTAL.

ISSUED FOR PERMIT

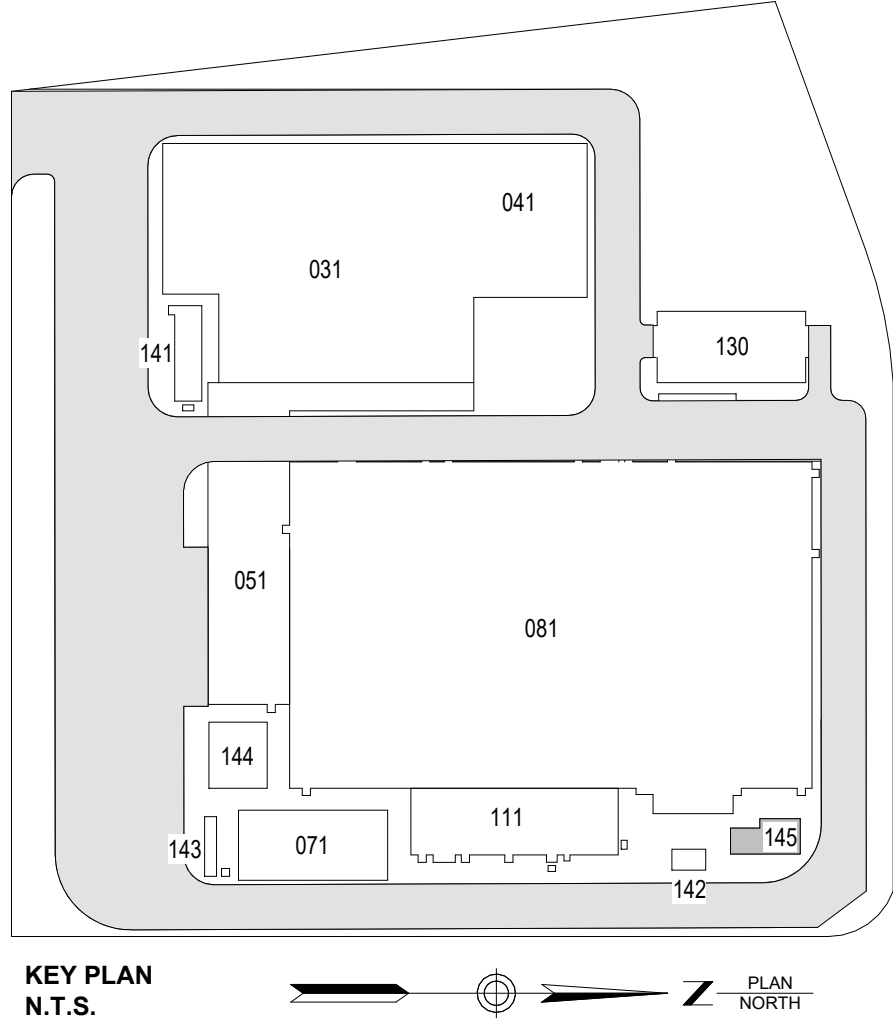

**Poole Fire Protection**  
19910 W. 161st STREET  
OLATHE, KS. 66062

**SOWINSKI SULLIVAN**  
ARCHITECTURE + ENGINEERING  
25 Mohawk Avenue  
Sparta, NJ 07871

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B	FINAL SUBMISSION	AWP	SAB	12/12/2022
A	INTERIM SUBMISSION	AWP	SAB	09/13/2022
REV	DESCRIPTION	DRW BY	CHK BY	DATE

**Kiewit**  
470 Chestnut Ridge Rd # 2,  
Woodcliff Lake, NJ 07677

**Hitachi Energy**  
901 Main Campus Drive  
Raleigh, North Carolina 27606


PROJECT

**CHPE**  
Champlain Hudson  
Power Express

**Astoria HVDC  
Converter Station**  
31-45 20<sup>th</sup> Avenue, Astoria, Queens NY 11105  
Block #850 - Lot #310 - BIN #4624437


**MVS ENCLOSURE - FIRE  
ALARM PLAN**

DATE 12/12/2022  
PROJECT NO 105121  
DRAWING BY S. BRINKMEYER  
CHECKED BY A. POOLE  
DRAWING NO  
**FA-111.00**  
CADD FILE NO  
Astoria/CHA-RE-141-00-M3-FP-001.rvt  
17 of 18

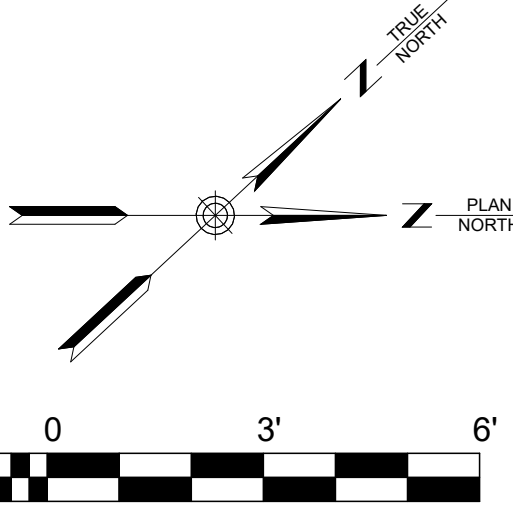




12/20/2022 4:20:41 PM

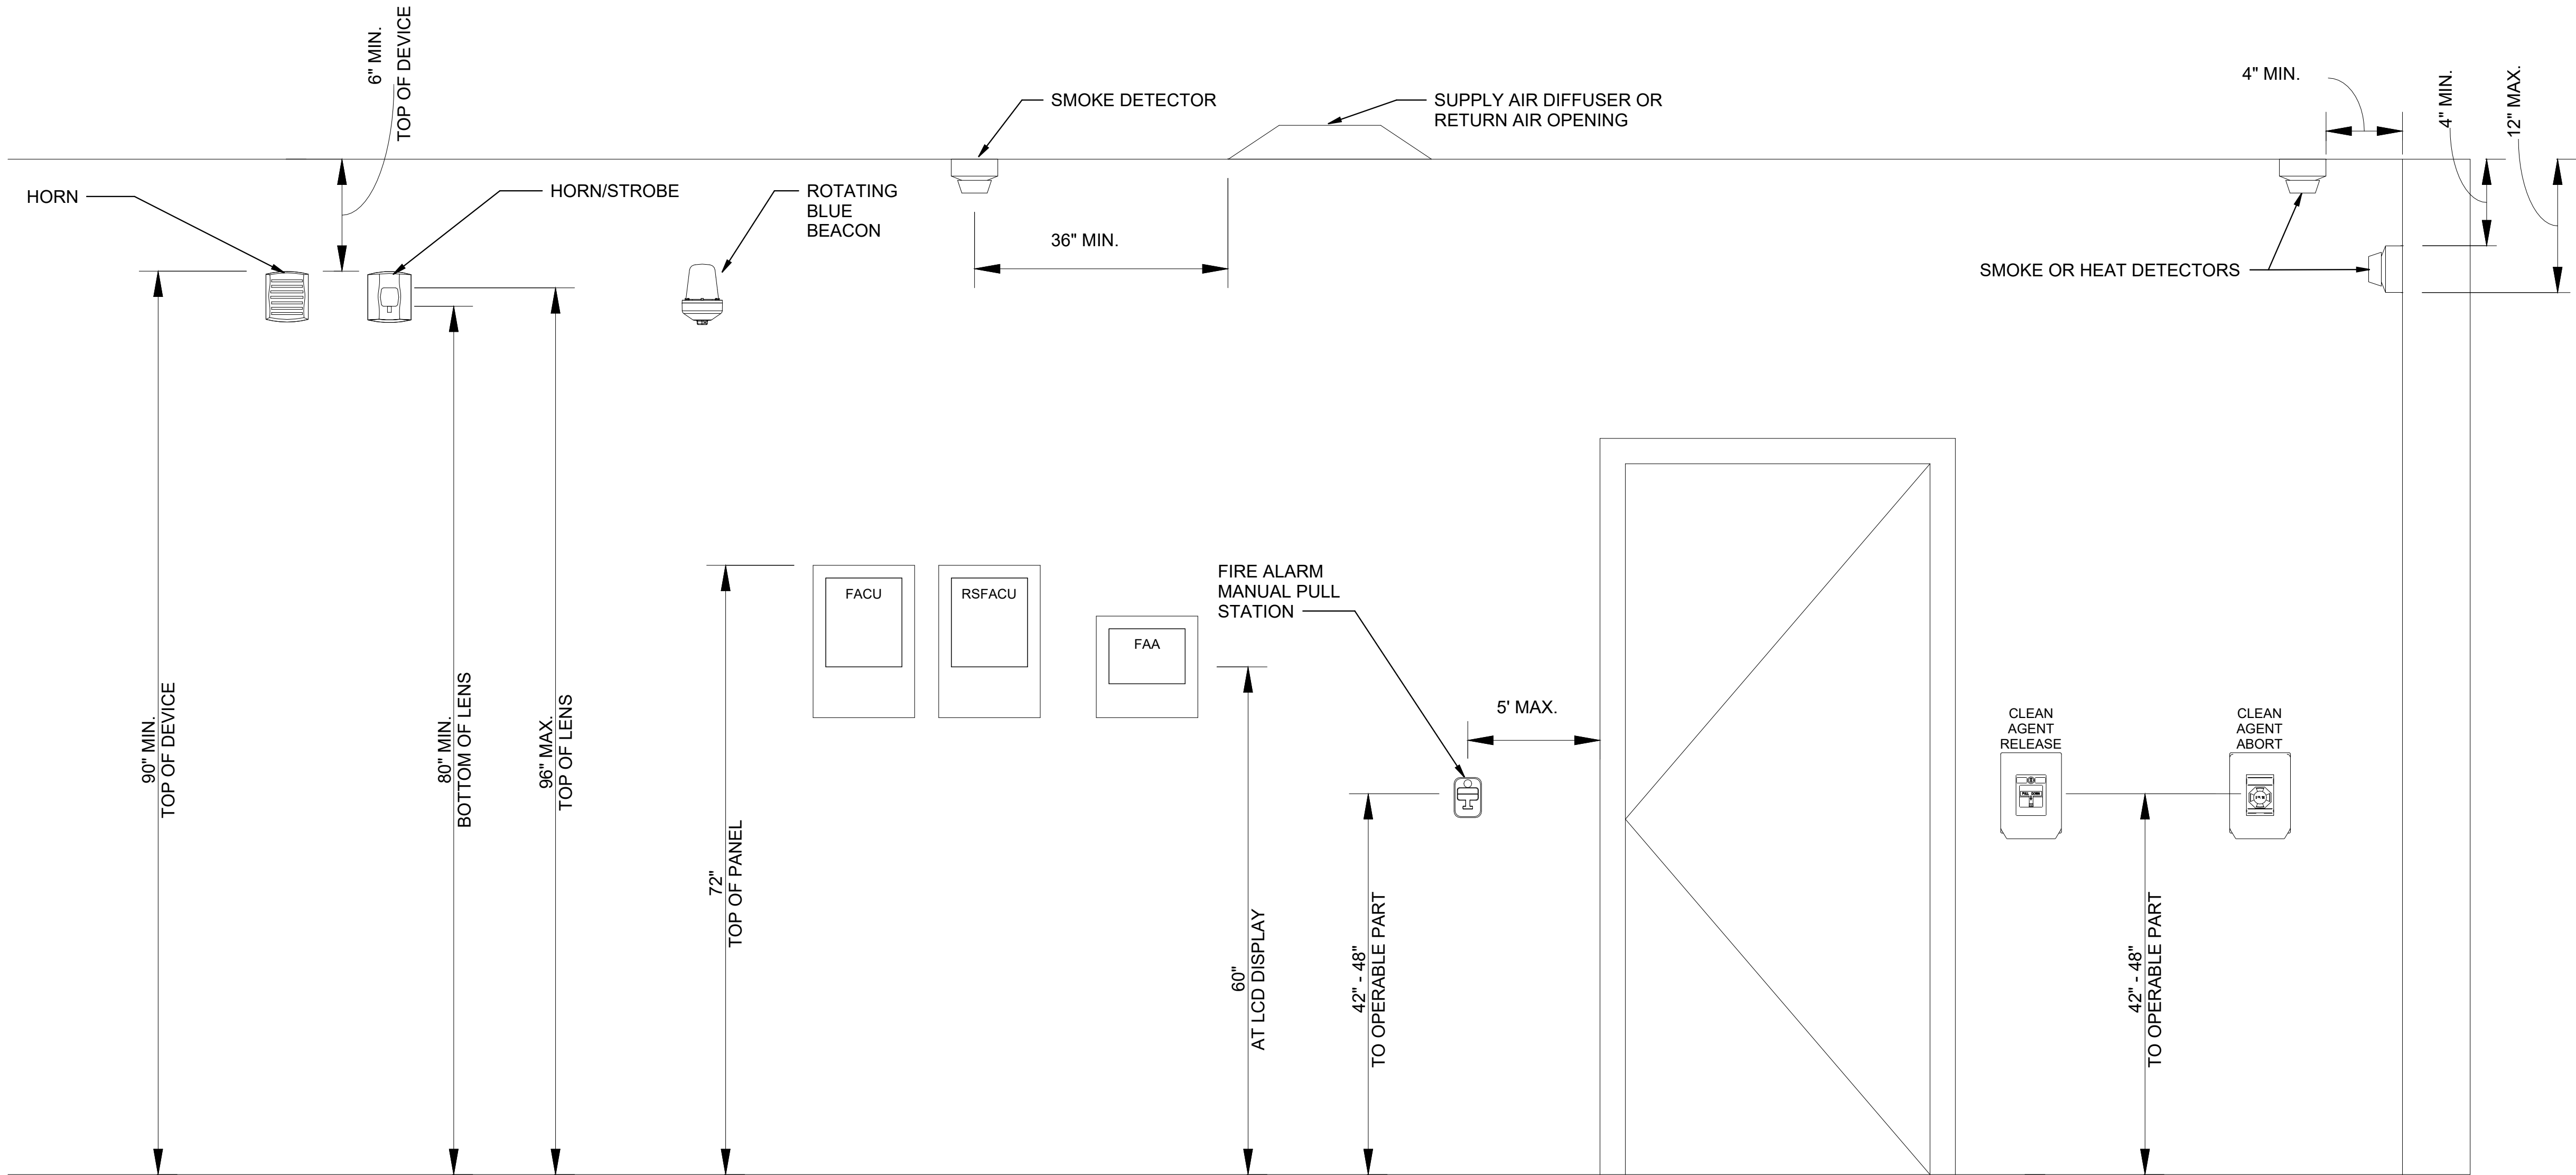

1 TYPICAL FIRE ALARM DEVICE MOUNTING DETAIL  
FA-601.00 NONE

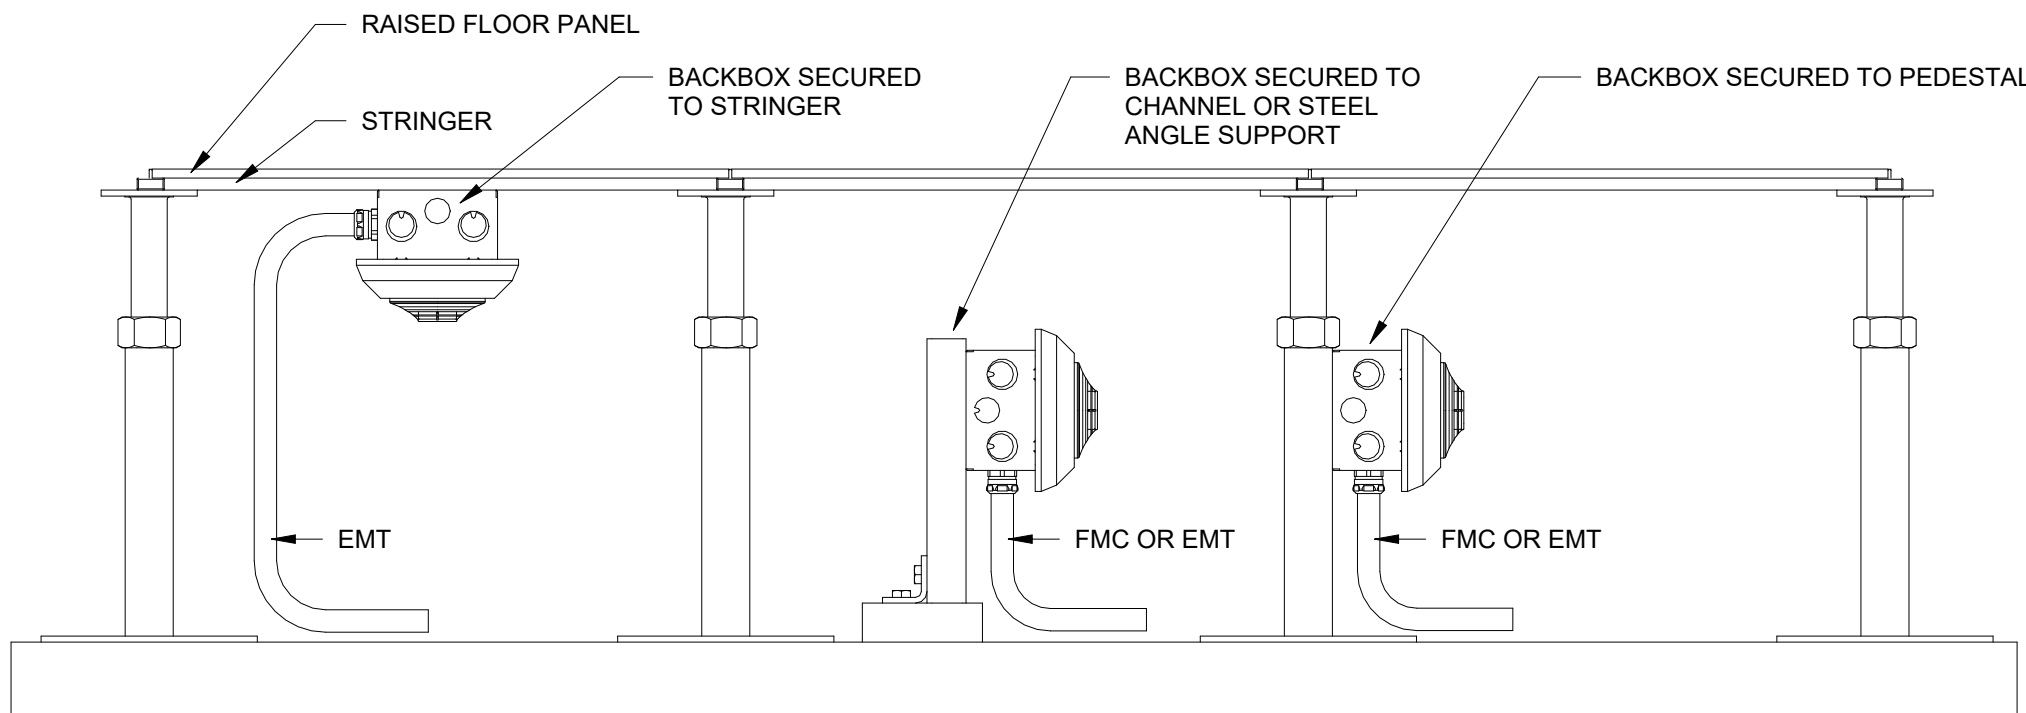


2 BELOW RAISED FLOOR SMOKE DETECTOR MOUNTING DETAIL  
FA-601.00 NONE

ISSUED FOR PERMIT



19910 W. 161st STREET  
OLATHE, KS. 66062

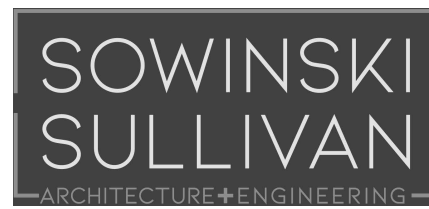

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REV	DESCRIPTION	DRW BY	CHK BY	DATE
B	FINAL SUBMISSION	SAB	AWP	12/12/2022
A	INTERIM SUBMISSION	SAB	AWP	09/13/2022



470 Chestnut Ridge Rd # 2,  
Woodcliff Lake, NJ 07677



901 Main Campus Drive  
Raleigh, North Carolina 27606

PROJECT

**CHPE**  
Champlain Hudson  
Power Express

**Astoria HVDC  
Converter Station**

31-45 20<sup>th</sup> Avenue, Astoria, Queens NY 11105  
Block #850 - Lot #310 - BIN #4624437

FIRE ALARM DETAILS



DATE 12/12/2022  
PROJECT NO 105121  
DRAWING BY S. BRINKMEYER  
CHECKED BY A. POOLE

DRAWING NO  
**FA-601.00**

CADD FILE NO  
AstoriaHVDC-CHPE  
AstoriaCHPE-111-00-M3-FP-001.rvt  
18 of 18