APPENDIX C.17

CASE 10-T-0139

SITE PLANS AND CONSTRUCTION DRAWINGS FIRE PROTECTION DRAWINGS – CLEAN AGENT FIRE EXTINGUISHING ASTORIA HVDC CONVERTER STATION SEGMENT 22



ASTORIA HVDC CONVERTER STATION

FIRE PROTECTION SYSTEMS: CLEAN AGENT FIRE EXTINGUISHING

SCOPE OF WORK

THE FIRE PROTECTION SYSTEMS SCOPE OF WORK INCLUDES CLEAN AGENT FIRE EXTINGUISHING SYSTEMS IN THE FOLLOWING AREAS AS SUBJECT TO THE REQUIREMENTS AND PERFORMANCE CRITERIA PROVIDED IN THE FIRE PROTECTION DESIGN BASIS DOCUMENT.

- 1. SERVICE BUILDING
- 2. RELAY ENCLOSURE

SHEET LIST - F

OVERALL SITE PLAN

SHEET NAME

SERVICE BUILDING - CLEAN AGENT ALARM AND RELEASING

SERVICE BUILDING - ENLARGED CLEAN AGENT ALARM AND


CLEAN AGENT GENERAL NOTES AND CALCULATIONS


FLOOD ZONE DESIGN CERTIFICATION:

THE EXISTING PROPERTY IS IN THE SPECIAL FLOOD HAZARD AREA (SFHA), ZONE AE PER EFFECTIVE 2015 FLOOD INSURANCE RATE MAP(FIRM). THIS IS TO CONFIRM THAT THE PROPOSED INSTALLATION IS IN COMPLIANCE WITH THE REQUIREMENTS SET FORTH IN APPENDIX Q OF THE NYC BUILDING CODE.


NYC ENERGY CODE COMPLIANCE:

STATEMENT: TO THE BEST OF MY KNOWLEDGE, BELIEF AND PROFESSIONAL JUDGEMENT, THESE PLANS AND SPECIFICATIONS ARE IN COMPLIANCE WITH THE NEW YORK CITY ENERGY CONSERVATION CODE. PROPOSED WORK MEETS THE GUIDELINES AND INSTRUCTIONS OUTLINED IN THE 2020 NYC ECC CHAPTER 4.

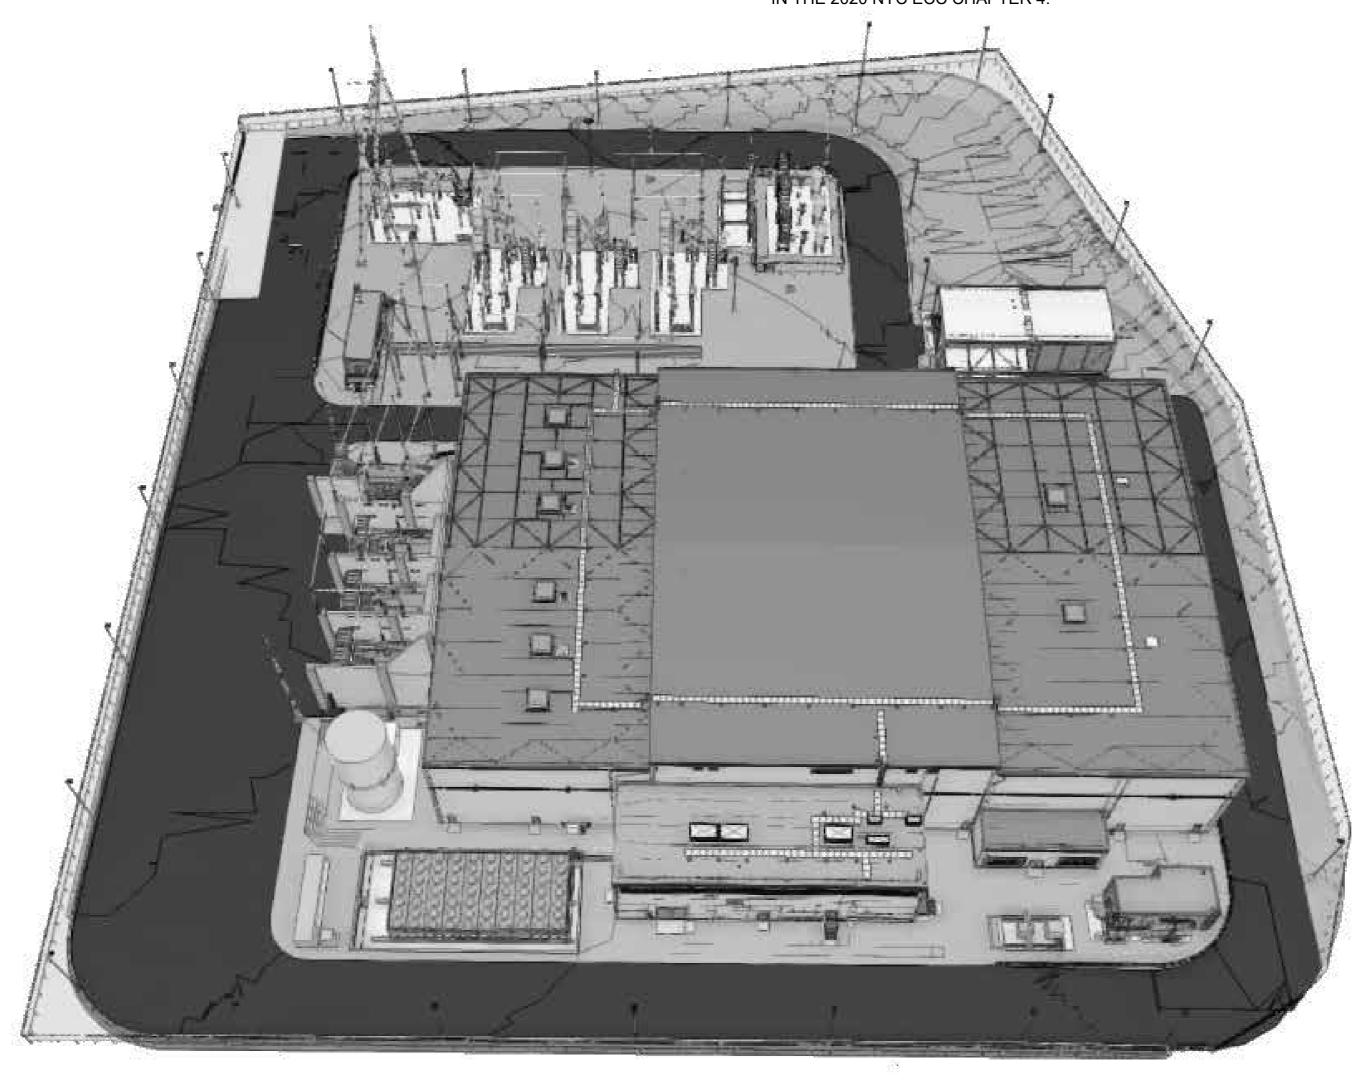

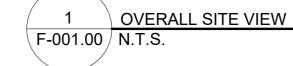



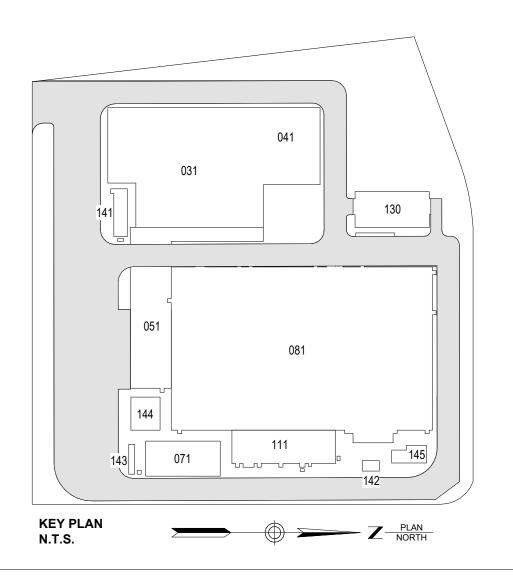



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В	FINAL SUBMISSION	SAB	AWP	12/12/2022
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REV	DESCRIPTION	DRW BY	CHK BY	DATE



901 Main Campus Drive Raleigh, North Carolina 27606

ROJECT



Astoria HVDC Converter Station

31-45 20th Avenue, Astoria, Queens NY 11105 Block #850 - Lot #310 - BIN #4624437

COVER SHEET



DATE 12/12/2022

PROJECT NO 105121


DRAWING BY S. BRINKMEYER

CHECKED BY A. POOLE


DRAWING NO

F-001.00

Autodesk Docs://CHPE Astoria/CHA-KIE-111-00-M3-FP-001.rvt

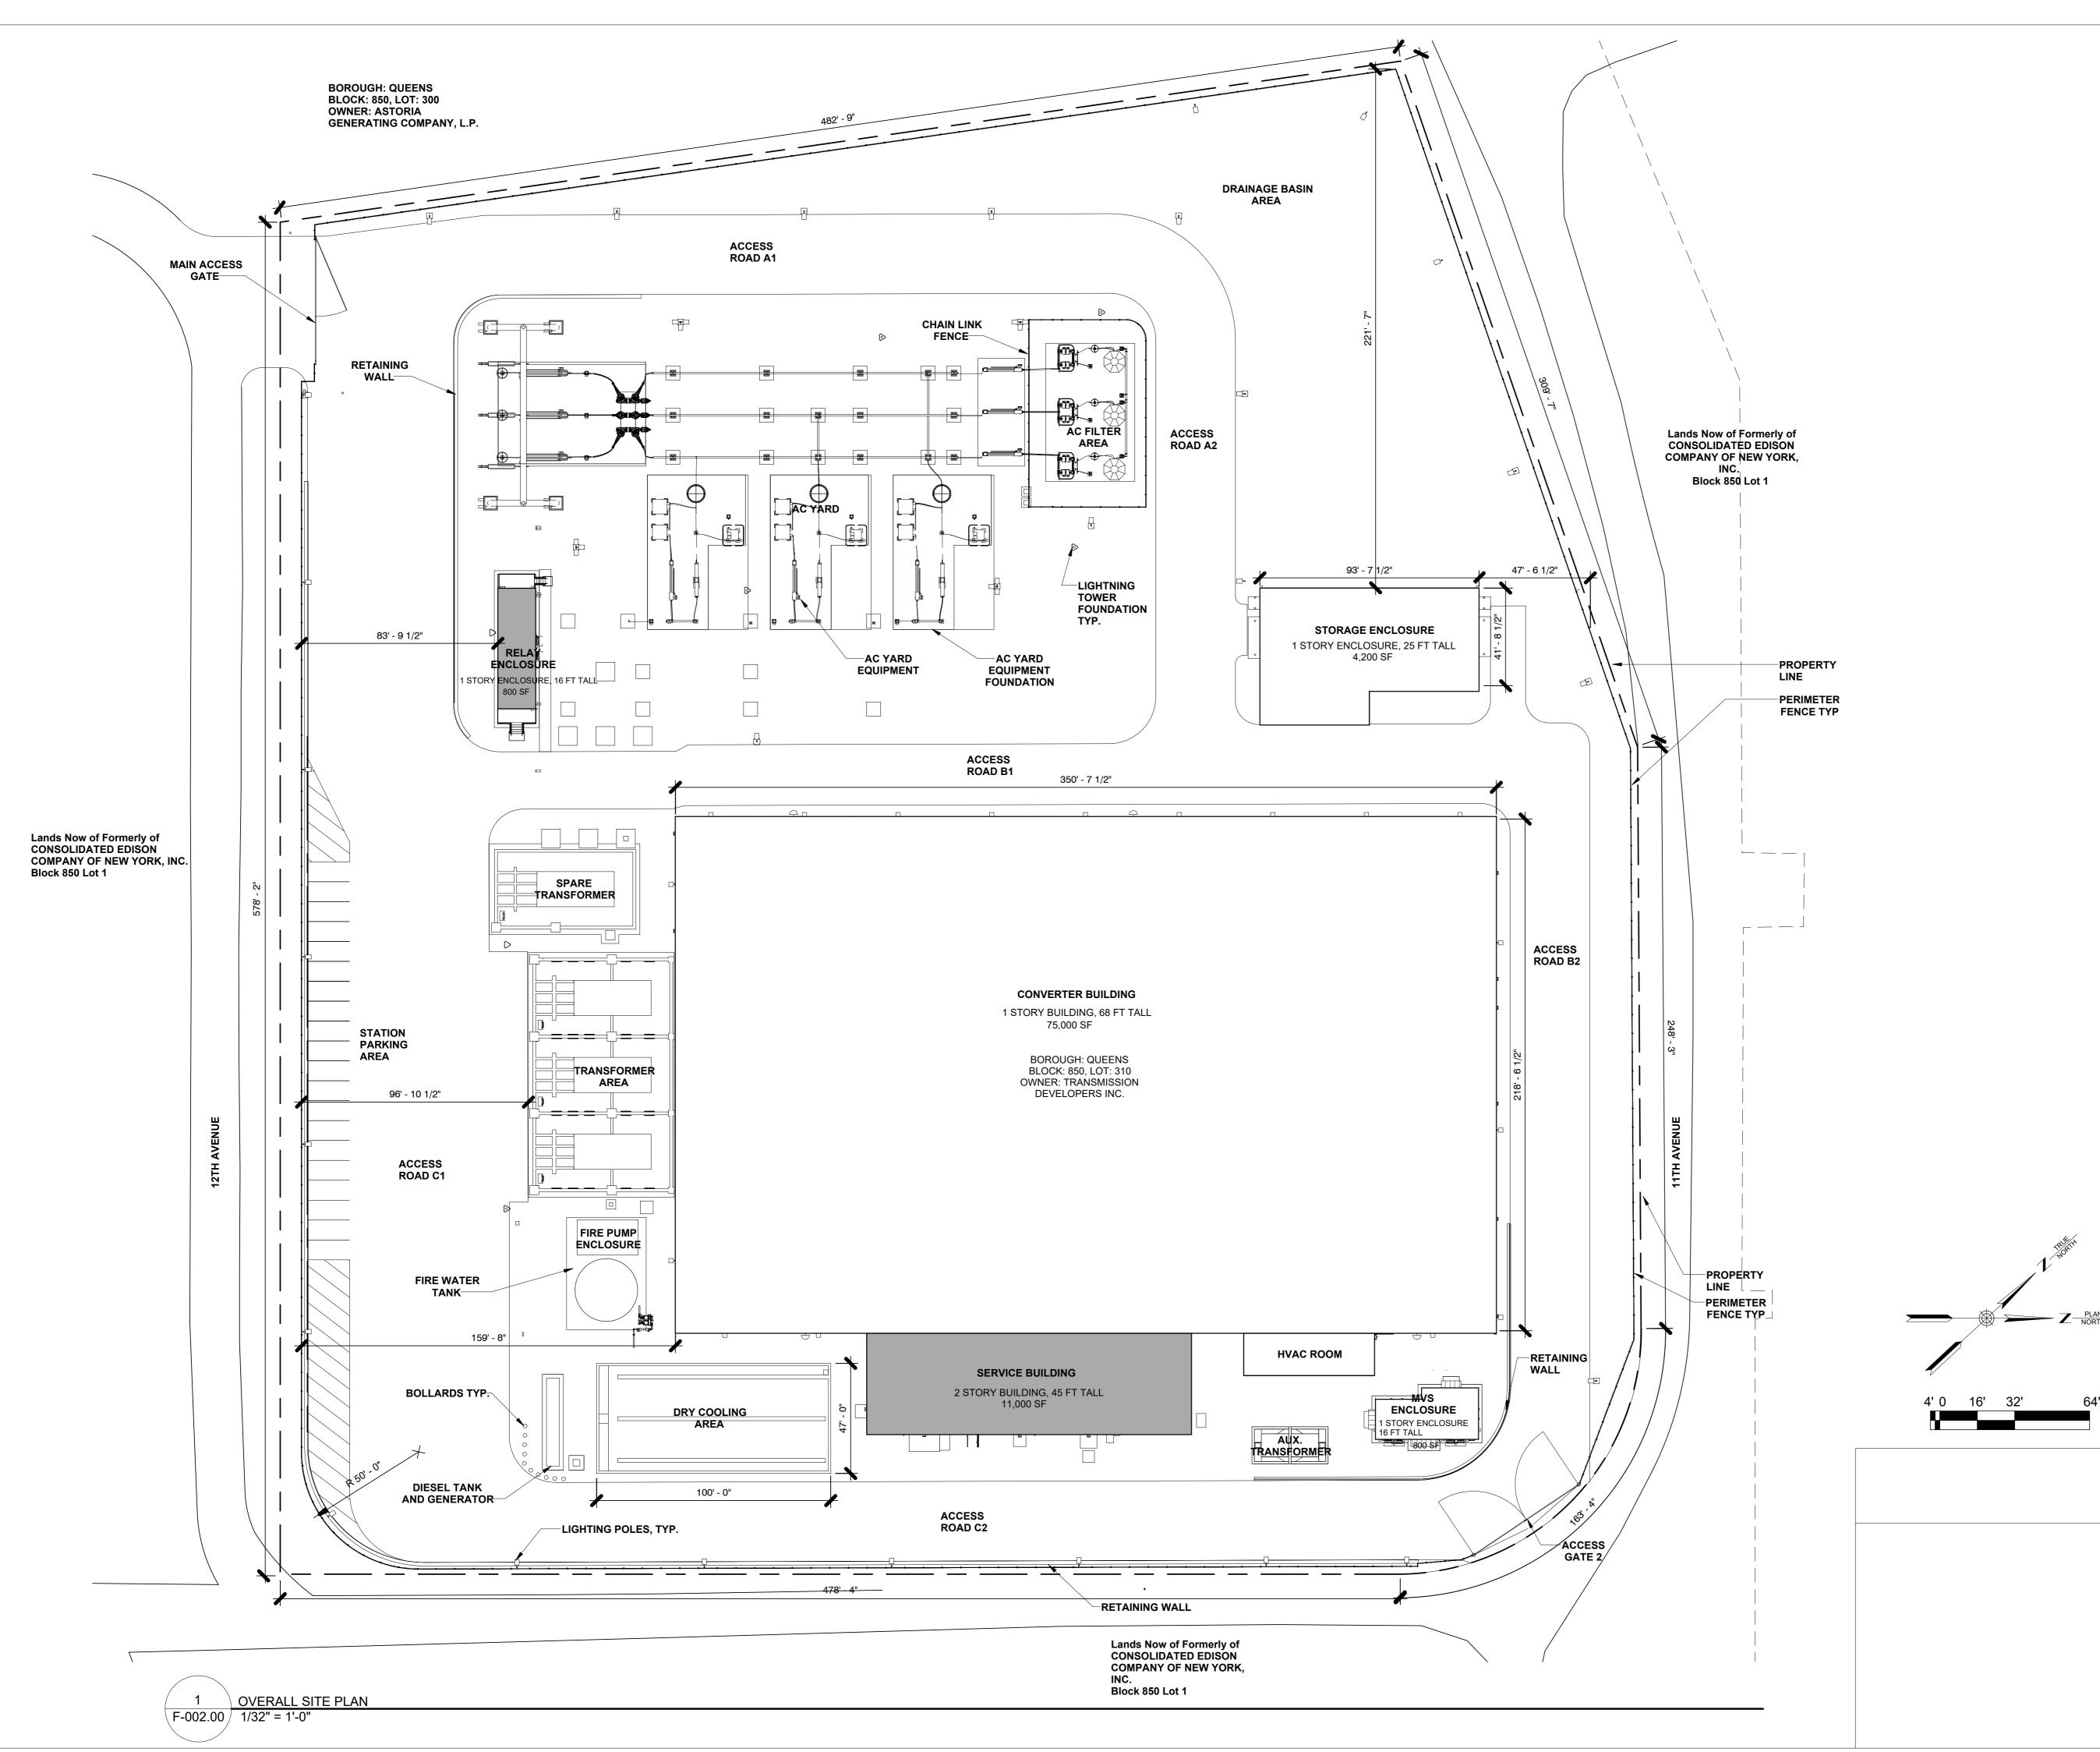

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REV	DESCRIPTION	DRW BY	CHK BY	DATE

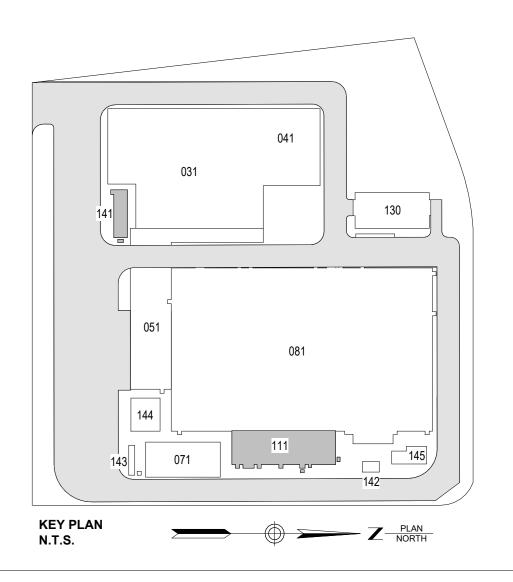

Hitachi Energy901 Main Campus Drive Raleigh, North Carolina 27606

PROJECT



Astoria HVDC Converter Station

31-45 20th Avenue, Astoria, Queens NY 11105 Block #850 - Lot #310 - BIN #4624437

OVERALL SITE PLAN



 DATE
 12/12/2022

 PROJECT NO
 105121

 DRAWING BY
 S. BRINKMEYER

 CHECKED BY
 A. POOLE

 DRAWING NO

F-002.00

CADD FILE NO 2 of Autodesk Docs://CHPE Astoria/CHA-KIE-111-00-M3-FP-001.rvt

PROTECTED SPACE: COMM ROOM (B205)

RAISED FLOOR: NONE

LENGTH(L): 21.48 FT.

WIDTH(W): 11.82 FT.

HEIGHT(H): 10.00 FT.

(V) SPACE VOLUME

V=(L)(W)(H)

V=2539 CU.FT.

W=(V)(C)(A)

W=105 LBS

(W) TOTAL DESIGN QUANTITY:

W=(2539)(0.04289)(1.00)

TOTAL AGENT DESIGN QUANTITY: 105 LBS.

PROTECTED SPACE: MCC ROOM (B116)

RAISED FLOOR: NONE LENGTH(L): 14.1 FT. WIDTH(W): 30.05 FT HEIGHT(H): 15.25 FT (V) SPACE VOLUME V=(L)(W)(H)V=6462 CU.FT.

(W) TOTAL DESIGN QUANTITY: W=(V)(C)(A)W=(6462)(0.04289)(1.00) W=278 LBS

TOTAL AGENT DESIGN QUANTITY: 278 LBS.

PROTECTED SPACE: RELAY ROOM RAISED FLOOR: YES

ABOVE RAISED FLOOR: LENGTH(L): 50.25 FT. WIDTH(W): 15 FT. HEIGHT(H): 11.5 FT (V) ABOVE RAISED FLOOR VOLUME V=(L)(W)(H)V=8668 CU.FT. (W) TOTAL DESIGN QUANTITY: W=(V)(C)(A)W=(8668)(0.04289)(1.00)

W=372 LBS REQUIRED AGENT DESIGN QUANTITY: 372 LBS

BELOW RAISED FLOOR: LENGTH(L): 50.25 FT. WIDTH(W): 15 FT. HEIGHT(H): 2.7917 FT. (V) BELOW RAISED FLOOR VOLUME V=(L)(W)(H)V=2104.244 CU.FT. (W) TOTAL DESIGN QUANTITY: W=(V)(C)(A)W=(1964)(0.04289)(1.00)

W=85 LBS REQUIRED AGENT DESIGN QUANTITY: 85 LBS. TOTAL AGENT DESIGN QUANTITY: 372 LBS+ 85 LBS = 457 LBS. PROTECTED SPACE: CONTROL AND PROTECTION ROOM 1 (B107)

ABOVE RAISED FLOOR: LENGTH(L): 14.09 FT. WIDTH(W): 16.79 FT. HEIGHT(H): 12.4583 FT. (V) ABOVE RAISED FLOOR VOLUME V=(L)(W)(H)V=2948 CU.FT. (W) TOTAL DESIGN QUANTITY: W=(V)(C)(A)W=(2948)(0.04289)(1.00) W=127 LBS REQUIRED AGENT DESIGN QUANTITY: 127 LBS.

BELOW RAISED FLOOR: LENGTH(L): 14.09 FT. WIDTH(W): 16.79 FT. HEIGHT(H): 2.7917 FT.

(V) BELOW RAISED FLOOR VOLUME V=(L)(W)(H)V=661 CU.FT. (W) TOTAL DESIGN QUANTITY W=(V)(C)(A)W=(661)(0.04289)(1.00) W=29 LBS

REQUIRED AGENT DESIGN QUANTITY: 29 LBS. TOTAL AGENT DESIGN QUANTITY: 127 LBS+ 29 LBS = 156 LBS.

PROTECTED SPACE: AUXILIARY ROOM (B102) RAISED FLOOR: YES

ABOVE RAISED FLOOR: LENGTH(L): 29.65 FT. WIDTH(W): 23.93 FT. HEIGHT(H): 12.4583 FT. (V) ABOVE RAISED FLOOR VOLUME V=(L)(W)(H)V=8840 CU.FT. (W) TOTAL DESIGN QUANTITY W=(V)(C)(A)W=(8840)(0.04289)(1.00) W=380 LBS REQUIRED AGENT DESIGN QUANTITY: 380 LBS. BELOW RAISED FLOOR:

LENGTH(L): 29.65 FT. WIDTH(W): 23.93 FT. HEIGHT(H): 2.7917 FT. (V) BELOW RAISED FLOOR VOLUME V=1981 CU.FT. (W) TOTAL DESIGN QUANTITY W=(V)(C)(A)W=(1981)(0.04289)(1.00) W=85 LBS

REQUIRED AGENT DESIGN QUANTITY: 85 LBS.

TOTAL AGENT DESIGN QUANTITY: 380 LBS + 85 LBS = 465 LBS.

PROTECTED SPACE: CONTROL AND PROTECTION ROOM 2 (B104)

ABOVE RAISED FLOOR: LENGTH(L): 43.58 FT. WIDTH(W): 14.10 FT. HEIGHT(H): 12.4583 FT. (V) ABOVE RAISED FLOOR VOLUME V=(L)(W)(H)V=7657 CU.FT (W) TOTAL DESIGN QUANTITY W=(V)(C)(A)W=(7657)(0.04289)(1.00) W=329 LBS REQUIRED AGENT DESIGN QUANTITY: 329 LBS.

BELOW RAISED FLOOR: LENGTH(L): 43.58 FT. WIDTH(W): 14.10 FT. HEIGHT(H): 2.7917 FT. (V) BELOW RAISED FLOOR VOLUME V=(L)(W)(H)V=1716 CU.FT. (W) TOTAL DESIGN QUANTITY: W=(V)(C)(A)W=(1716)(0.04289)(1.00) W=74 LBS

REQUIRED AGENT DESIGN QUANTITY: 74 LBS. TOTAL AGENT DESIGN QUANTITY: 329 LBS+ 74 LBS = 403 LBS.

PROTECTED SPACE: IO ROOM (B105) RAISED FLOOR: YES

ABOVE RAISED FLOOR: LENGTH(L): 14.1 FT. WIDTH(W): 19.97 FT. HEIGHT(H): 12.4583 FT. (V) ABOVE RAISED FLOOR VOLUME V=(L)(W)(H)V=3508 CU.FT. (W) TOTAL DESIGN QUANTITY: W=(V)(C)(A)W=(3508)(0.04289)(1.00) W=151 LBS REQUIRED AGENT DESIGN QUANTITY: 151 LBS.

BELOW RAISED FLOOR: LENGTH(L): 14.1 FT. WIDTH(W): 19.97 FT. HEIGHT(H): 2.7917 FT. (V) BELOW RAISED FLOOR VOLUME V=787 CU.FT. (W) TOTAL DESIGN QUANTITY: W=(V)(C)(A)W=(787)(0.04289)(1.00)

W=34 LBS REQUIRED AGENT DESIGN QUANTITY: 34 LBS. TOTAL AGENT DESIGN QUANTITY: 151 LBS+ 34 LBS = 185 LBS. **CLEAN AGENT SUPPRESSION GENERAL NOTES**

THE CLEAN AGENT SYSTEM SHALL BE MONITORED AND CONTROLLED BY THE SERVICE BUILDING FIRE ALARM/RELEASING PANEL AND ASSOCIATED SMOKE DETECTION. SEE FA-SERIES FIRE ALARM DRAWINGS INCLUDED IN SEPARATE PERMIT SUBMITTAL

B. FINAL PIPE ROUTING AND NOZZLE LOCATION TO BE DETERMINED BY AGENT MANUFACTURER QUALIFIED DESIGNER/INSTALLER.

CLEAN AGENT SYSTEMS ARE PROVIDED IN THE SELECT LOCATIONS INDICATED ON THE PLANS TO PROTECT SENSITIVE ELECTRICAL EQUIPMENT IN ADDITION TO AUTOMATIC SPRINKLER PROTECTION REQUIRED BY THE NYC BUILDING CODE. ALL SYSTEMS ARE TOTAL-FLOODING PER THE NYC FIRE CODE.

THE CLEAN AGENT SYSTEM SHALL MEET THE APPLICATION, INSTALLATION, PERFORMANCE REQUIREMENTS IN ACCORDANCE WITH NFPA 2001 (2015), THE NYC BUILDING CODE (2022), NYC FIRE CODE (2022) AND LOCAL AMENDMENTS. PER CONTRACT REQUIREMENTS, WHERE THE 2022 EDITION OF NFPA 2001 HAS MORE STRINGENT REQUIREMENTS, THE 2022 EDITION SHALL BE FOLLOWED. IN ADDITION, ANY SPECIALLY LISTED MATERIALS OR DEVICES SHALL BE INSTALLED IN ACCORDANCE WITH THEIR LISTING.

LOCATION AND INSTALLATION OF PIPE SUPPORTS SHALL MEET THE REQUIREMENTS OF NFPA 2001 AND THE MANUFACTURERS INSTRUCTIONS.

CONTRACTOR TO PROVIDE GROUNDING DETAIL ON SHOP DRAWING SUBMITTALS. APPLICABLE UL CONSTRUCTION DETAILS SHALL BE USED WHERE RATED ASSEMBLIES ARE PENETRATED BY CLEAN AGENT SYSTEM PIPING.

ALL ELECTRICAL EQUIPMENT AND METALLIC COMPONENTS SHALL BE BONDED AND GROUNDED ACCORDING TO NEW YORK CITY ELECTRICAL CODE ARTICLE 250, HITACHI GROUNDING GUIDELINES, SPECIFICATIONS, AND DETAILS.

PROVIDE A SEPARATE AUDIBLE/VISUAL NOTIFICATION APPLIANCE. THE

NOTIFICATION DEVICE MUST UTILIZE A FACEPLATE WHICH INDICATES "AGENT". CLEAN AGENT NOTIFICATION DEVICES MUST ACTIVATE INDEPENDENTLY FROM GENERAL FIRE ALARM NOTIFICATION DEVICES. UPON CLEAN AGENT PRE-DISCHARGE OR DISCHARGE EVENT, THE GENERAL FIRE ALARM NOTIFICATION DEVICES MUST BE DEACTIVATED. UNDER NO CIRCUMSTANCES WILL A FIRE ALARM NOTIFICATION APPLIANCE AND A CLEAN AGENT NOTIFICATION APPLIANCE BE ACTIVE AT THE SAME TIME.

STORAGE CYLINDERS CYLINDERS ARE LOCATED IN A DEDICATED AREA OUTSIDE OF THE PROTECTED

CYLINDERS MUST BE LOCATED AND MOUNTED WHERE THEY WILL NOT BE ACCIDENTALLY DAMAGED OR MOVED. INSTALL SUITABLE PROTECTION TO

PREVENT THE CYLINDERS FROM DAMAGE OR MOVEMENT. POSITION THE CYLINDERS IN THE DESIGNATED LOCATION AND SECURE THEM IN PLACE WITH CYLINDER STRAPS AND ATTACHING HARDWARE AS RECOMMENDED BY THE MANUFACTURER.

DISCHARGE NOZZLES NOZZLE PLACEMENT MUST BE SUCH THAT THE DESIGN CONCENTRATION WILL BE ESTABLISHED IN ALL PARTS OF THE HAZARD INCLUDING BELOW RAISED FLOORS. NOZZLES MUST BE MOUNTED PERPENDICULAR TO THE CEILING AND ORIENTED

NFTWORK NOZZLES MUST BE INSTALLED SO THAT THE ORIFICES ARE LOCATED AT DISTANCES BELOW THE CEILING AND AWAY FROM WALLS ACCORDING TO

MANUFACTURERS RECOMMENDATIONS. NOZZLES MUST BE LOCATED ACCORDING TO MANUFACTURERS RECOMMENDED CLEARANCE FROM WALLS AND/OR SIGNIFICANT OBSTRUCTIONS TO ALLOW FLUID DISCHARGE TO FULLY ATOMIZE.

WITH THE ORIFICES RADIATING SYMMETRICALLY OUTWARD FROM THE PIPE

PROTECTED SPACE WHERE PROVIDED, THE PROTECTED SPACE SHALL INCLUDE AREAS BELOW

RAISED FLOORS AND ABOVE SUSPENDED CEILINGS.

UNCLOSABLE OPENING MUST BE KEPT TO A MINIMUM. ANY OPENINGS IN THE WALLS, CEILING, AND FLOOR MUST BE PERMANENTLY SEALED OR PROVIDED WITH AUTOMATIC CLOSURE. SEE ARCHITECTURAL SPECIFICATIONS INCLUDED IN SEPARATE PERMIT SUBMITTAL FOR SEALING REQUIREMENTS AND MATERIALS.

IF CONFINEMENT OF AGENT IS NOT PRACTICABLE, PROTECTION MUST BE

EXTENDED TO INCLUDE THE ADJACENT AREAS.

AND AGENT QUANTITIES INCREASED TO ACCOUNT FOR VENTING.

FORCED-AIR VENTILATING SYSTEMS, EXCLUDING SELF-CONTAINED AIR-RECIRCULATION SYSTEMS. MUST BE SHUT DOWN OR CLOSED AUTOMATICALLY. THE PROTECTED SPACE MUST HAVE THE STRUCTURAL STRENGTH AND INTEGRITY NECESSARY TO CONTAIN THE AGENT DISCHARGE. IF THE DEVELOPED PRESSURES PRESENT A THREAT TO THE STRUCTURAL STRENGTH OF THE ENCLOSURE, VENTING MUST BE PROVIDED TO PREVENT EXCESSIVE PRESSURES

PIPE AND FITTINGS BLACK STEEL OR GALVANIZED STEEL PIPE MUST BE EITHER ASTM A-53 SEAMLES: OR ELECTRIC RESISTANCE WELDED, GRADE A OR B, OR ASTM A-106, GRADE A, B,

ASTM B-120 AND ORDINARY CAST IRON PIPE MUST NOT BE USED.

FITTINGS MUST CONFORM TO THE REQUIREMENTS OF NFPA 2001

CLASS 150 AND CAST IRON FITTINGS MUST NOT BE USED. CLASS 300 MALLEABLE OR DUCTILE IRON FITTINGS IN SIZES 3-INCH AND SMALLER, OR 1000 LB. DUCTILE IRON OR FORGED STEEL FITTINGS IN SIZES GREATER THAN

CLASS 300 FLANGED JOINTS ARE ACCEPTABLE FOR USE IN ALL SIZES

GASKETS FOR FLANGED FITTINGS MUST BE PER MANUFACTURER'S

APPROVED AND HAVE A MINIMUM RATED WORKING PRESSURE EQUAL TO OR GREATER THAN THE MINIMUM PIPING DESIGN PRESSURE.

CONCENTRIC BELL REDUCERS ARE THE ONLY MEANS FOR REDUCING PIPE SIZE PIPE SIZE REDUCTIONS MAY BE MADE AFTER A TEE OR AFTER A UNION. WHERE REDUCERS ARE USED AT TEES, THE REDUCERS MUST BE DOWNSTREAL

N DIRECTION (TEE SPLIT) IS LOCATED A MINIMUM OF 10 NOMINAL PIPE DIAMETERS

DOWNSTREAM OF THE CONCENTRIC BELL REDUCER. PIPING MUST BE SECURELY BRACED TO ACCOUNT FOR DISCHARGE REACTION FORCES AND THERMAL EXPANSION/CONTRACTION. CARE MUST BE TAKEN TO ENSURE THE PIPING IS NOT SUBJECTED TO VIBRATION, MECHANICAL OR

ALL PIPE HANGERS MUST BE UL LISTED, CONFORM TO GENERAL INDUSTRY STANDARDS FOR PIPE HANGERS, AND CONFORM TO ANSI B-31.1. REFER TO ANSI

B-31.1 FOR ADDITIONAL BRACING REQUIREMENTS. SEISMIC DESIGN CATEGORY "C". REFER TO STRUCTURAL DRAWINGS INCLUDED IN SEPARATE PERMIT SUBMITTAL FOR ADDITIONAL INFORMATION.

FIRE SUPPRESSION SYSTEM

MAINTENANCE SWITCH

TO OPERATE TURN KEY TROUBLE WILL

OCCUR AT PANEL NOVEC 1230 SYSTEM

RELEASE CIRCUIT WILL BE DISABLED

CLEAN AGENT LEGEND CLEAN AGENT STORAGE CONTAINER CLEAN AGENT MANUAL RELEASE STATION CLEAN AGENT ABORT STATION ADDRESSABLE INPUT MODULE ADDRESSABLE OUTPUT MODULE CLEAN AGENT ELECTRIC RELEASE ACTUATOR PRESSURE SWITCH MAINTENANCE DISCONNECT SWITCH AGENT DISCHARGE BEACON HORN - WALL MOUNT STROBE - WALL MOUNT HORN/STROBE - WALL MOUNT SYMBOL MODIFIERS CANDELA RATING ncd WATT TAP CLEAN AGENT

RATED WALL LEGEND

2 HOUR FIRE BARRIER

NOTE: RATED WALLS ARE REFERENCED FROM ARCHITECTURAL PLANS. INCLUDED IN SEPARATE PERMIT SUBMITTAL

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Astoria HVDC Converter Station

31-45 20th Avenue, Astoria, Queens NY 11105 Block #850 - Lot #310 - BIN #4624437

CLEAN AGENT GENERAL NOTES AND CALCULATIONS



12/12/2022 PROJECT NO S. BRINKMEYER CHECKED BY


F-003.00 Autodesk Docs://CHPE Astoria/CHA-KIE-111-00-M3-FP-001.rvt

FIRE SUPPRESSION MANUAL RELEASE

PUSH

PULL

FIRE SUPPRESSION ABORT PUSH BUTTON AND HOLD

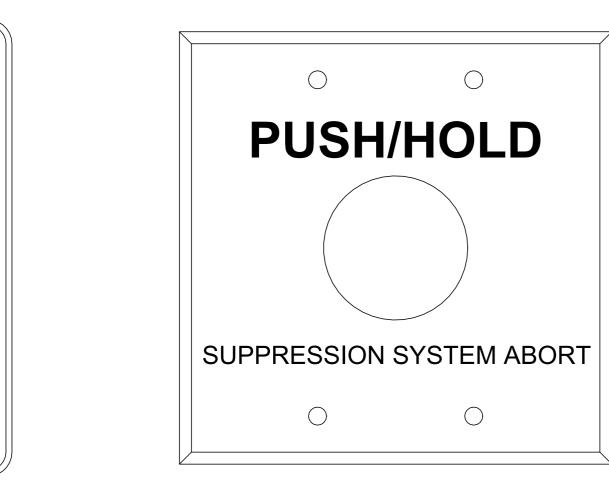


FIRE SUPPRESSION SYSTEM DISCHARGE LIGHT

DISCHARGED

CLEAN AGENT SIGNAGE

WHEN LIGHT IS FLASHING DO NOT ENTER. NOVEC 1230 SYSTEM HAS

F-003.00 NONE

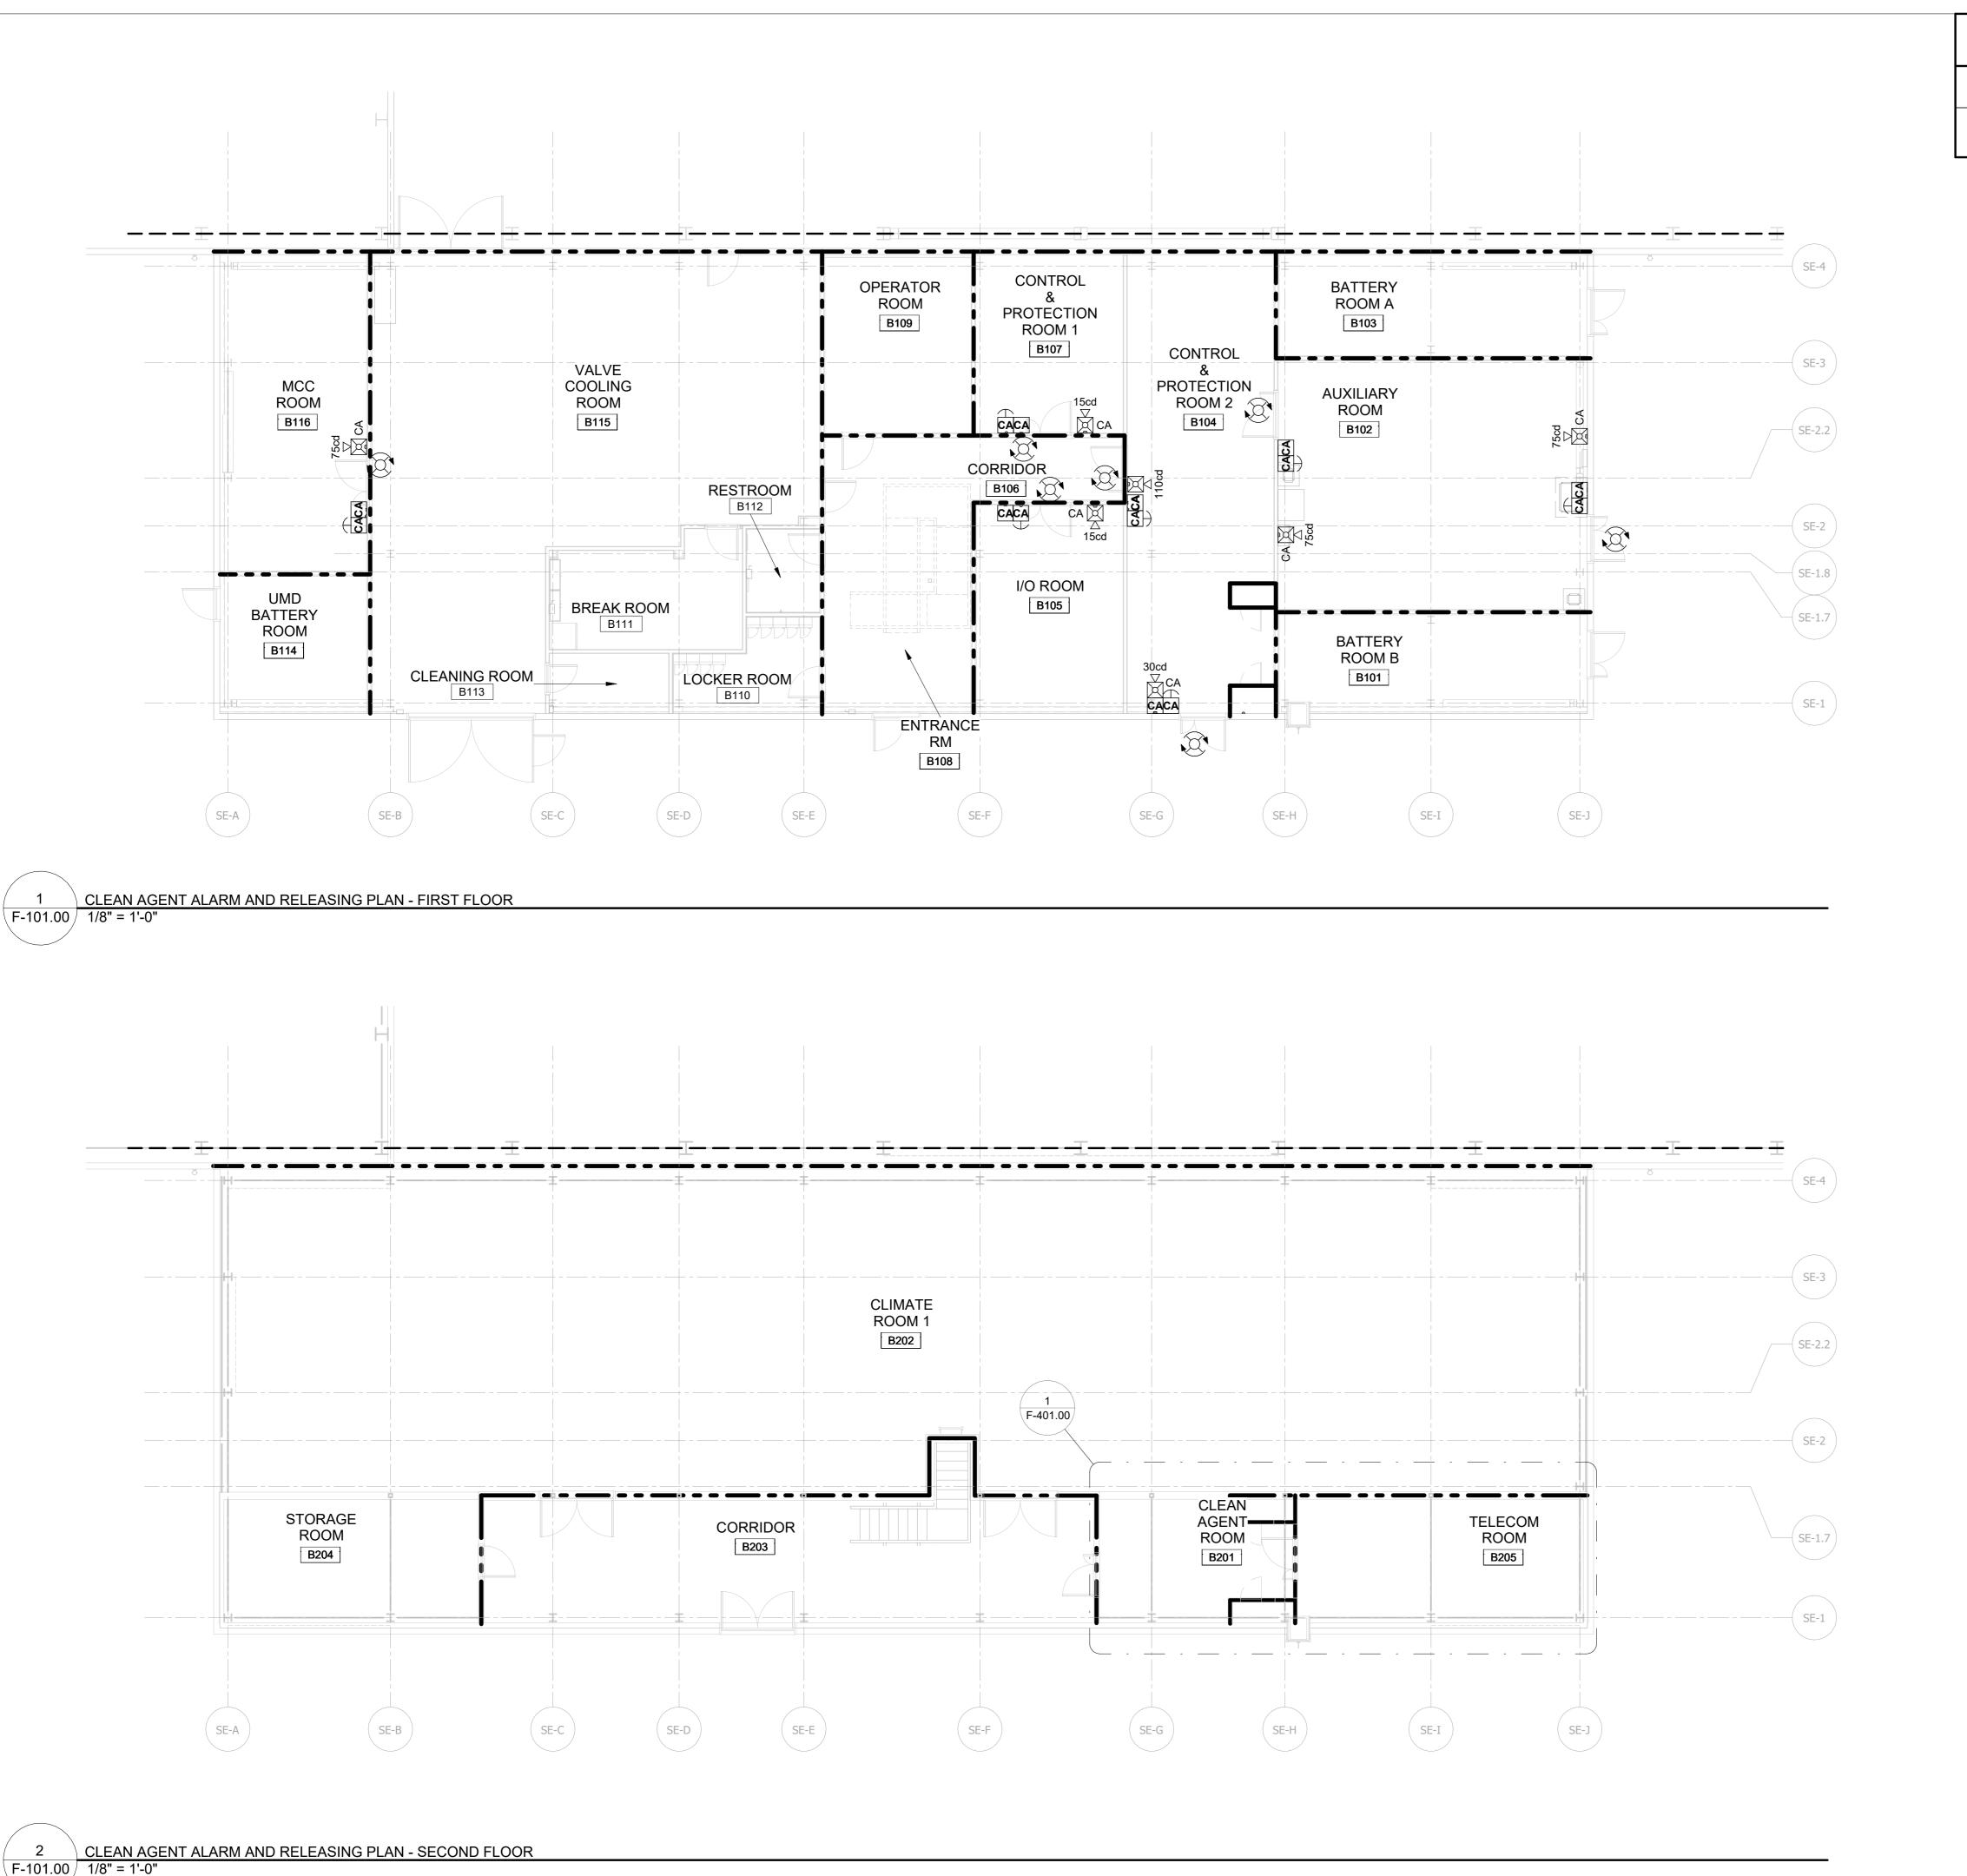


RATED WALL LEGEND

2 HOUR FIRE BARRIER

NOTE: RATED WALLS ARE REFERENCED FROM ARCHITECTURAL PLANS. INCLUDED IN SEPARATE PERMIT SUBMITTAL.

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PROJECT

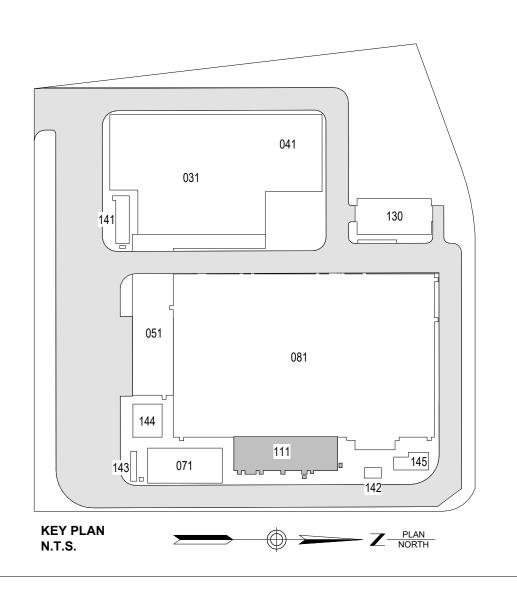

Astoria HVDC Converter Station


31-45 20th Avenue, Astoria, Queens NY 11105 Block #850 - Lot #310 - BIN #4624437

SERVICE BUILDING -CLEAN AGENT ALARM


AND RELEASING PLAN



DATE	12/12/2022
	105101
PROJECT NO	105121
RAWING BY	S. BRINKMEYER
CHECKED BY	A. POOLE
JILUNED DI	A. FOOLE
DRAWING NO	
F-1	01.00

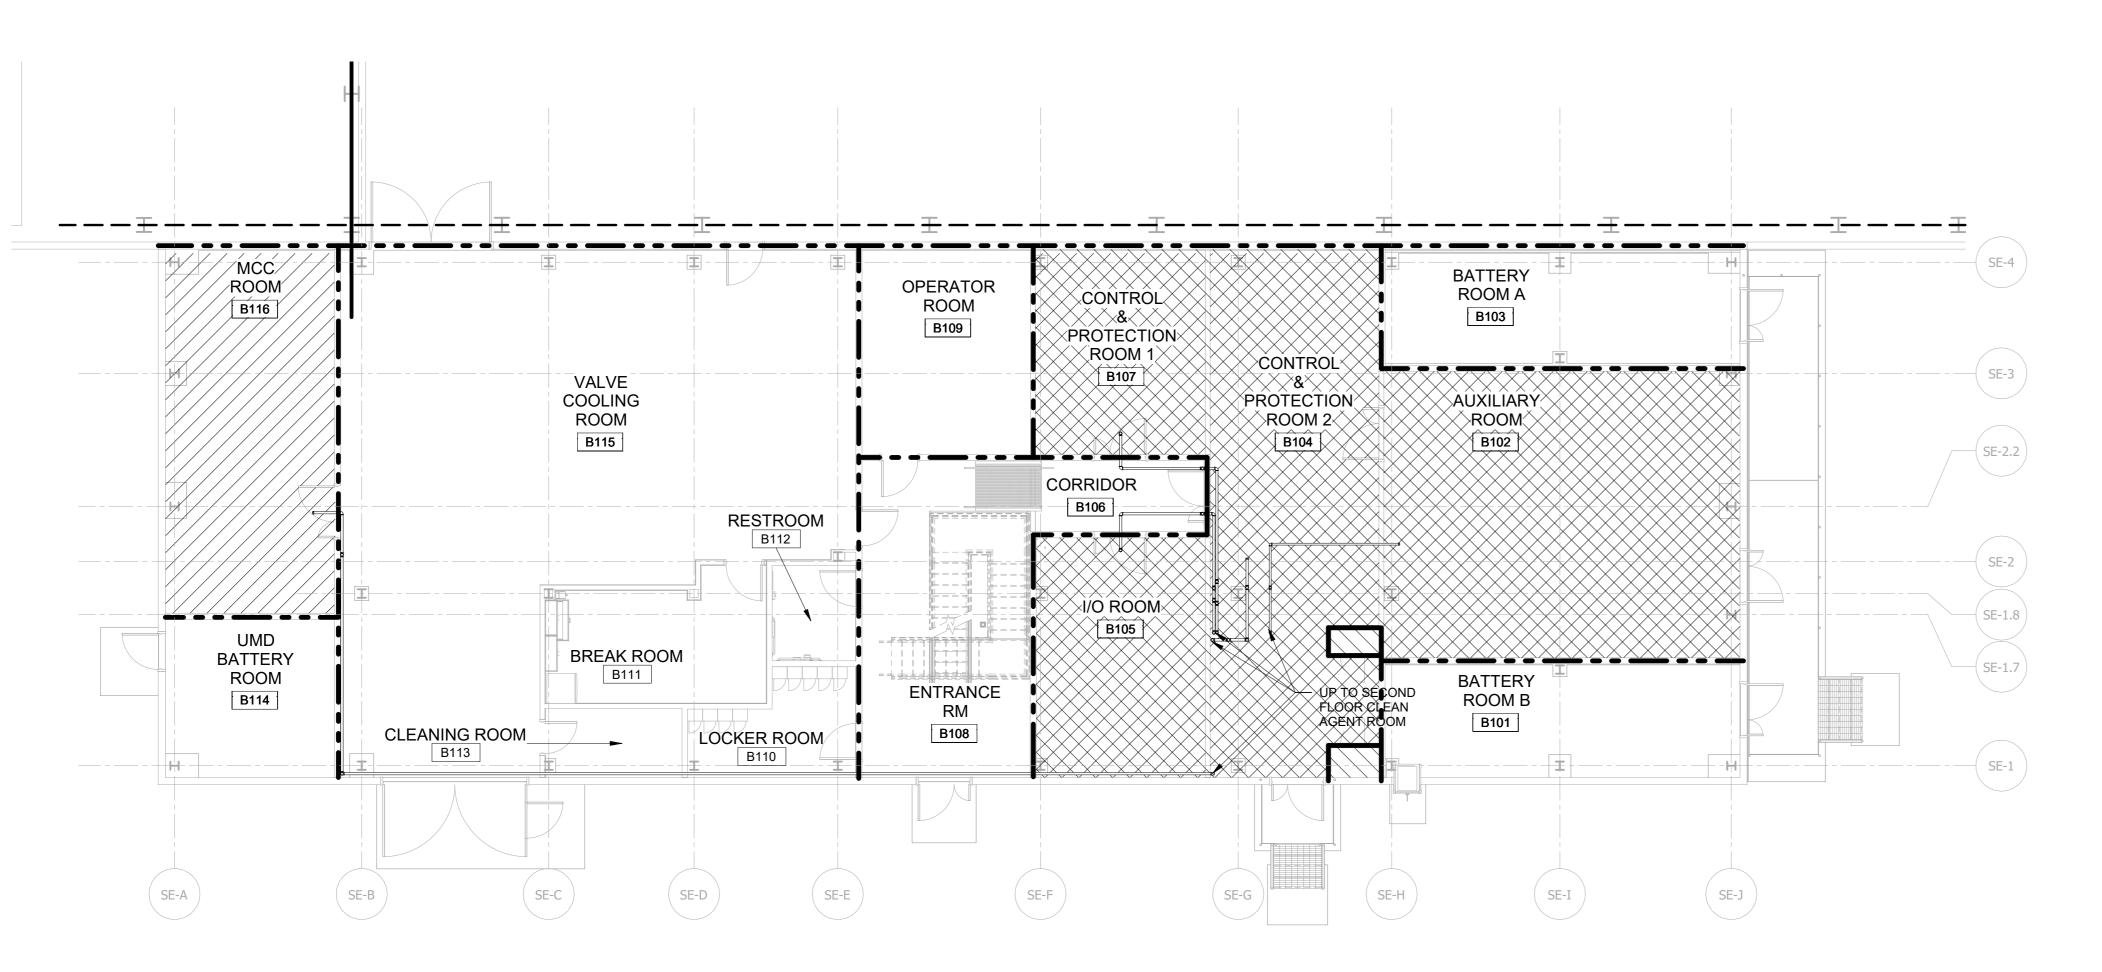

CLEAN AGENT SUPPRESSION PLAN - FIRST FLOOR F-102.00 1/8" = 1'-0"

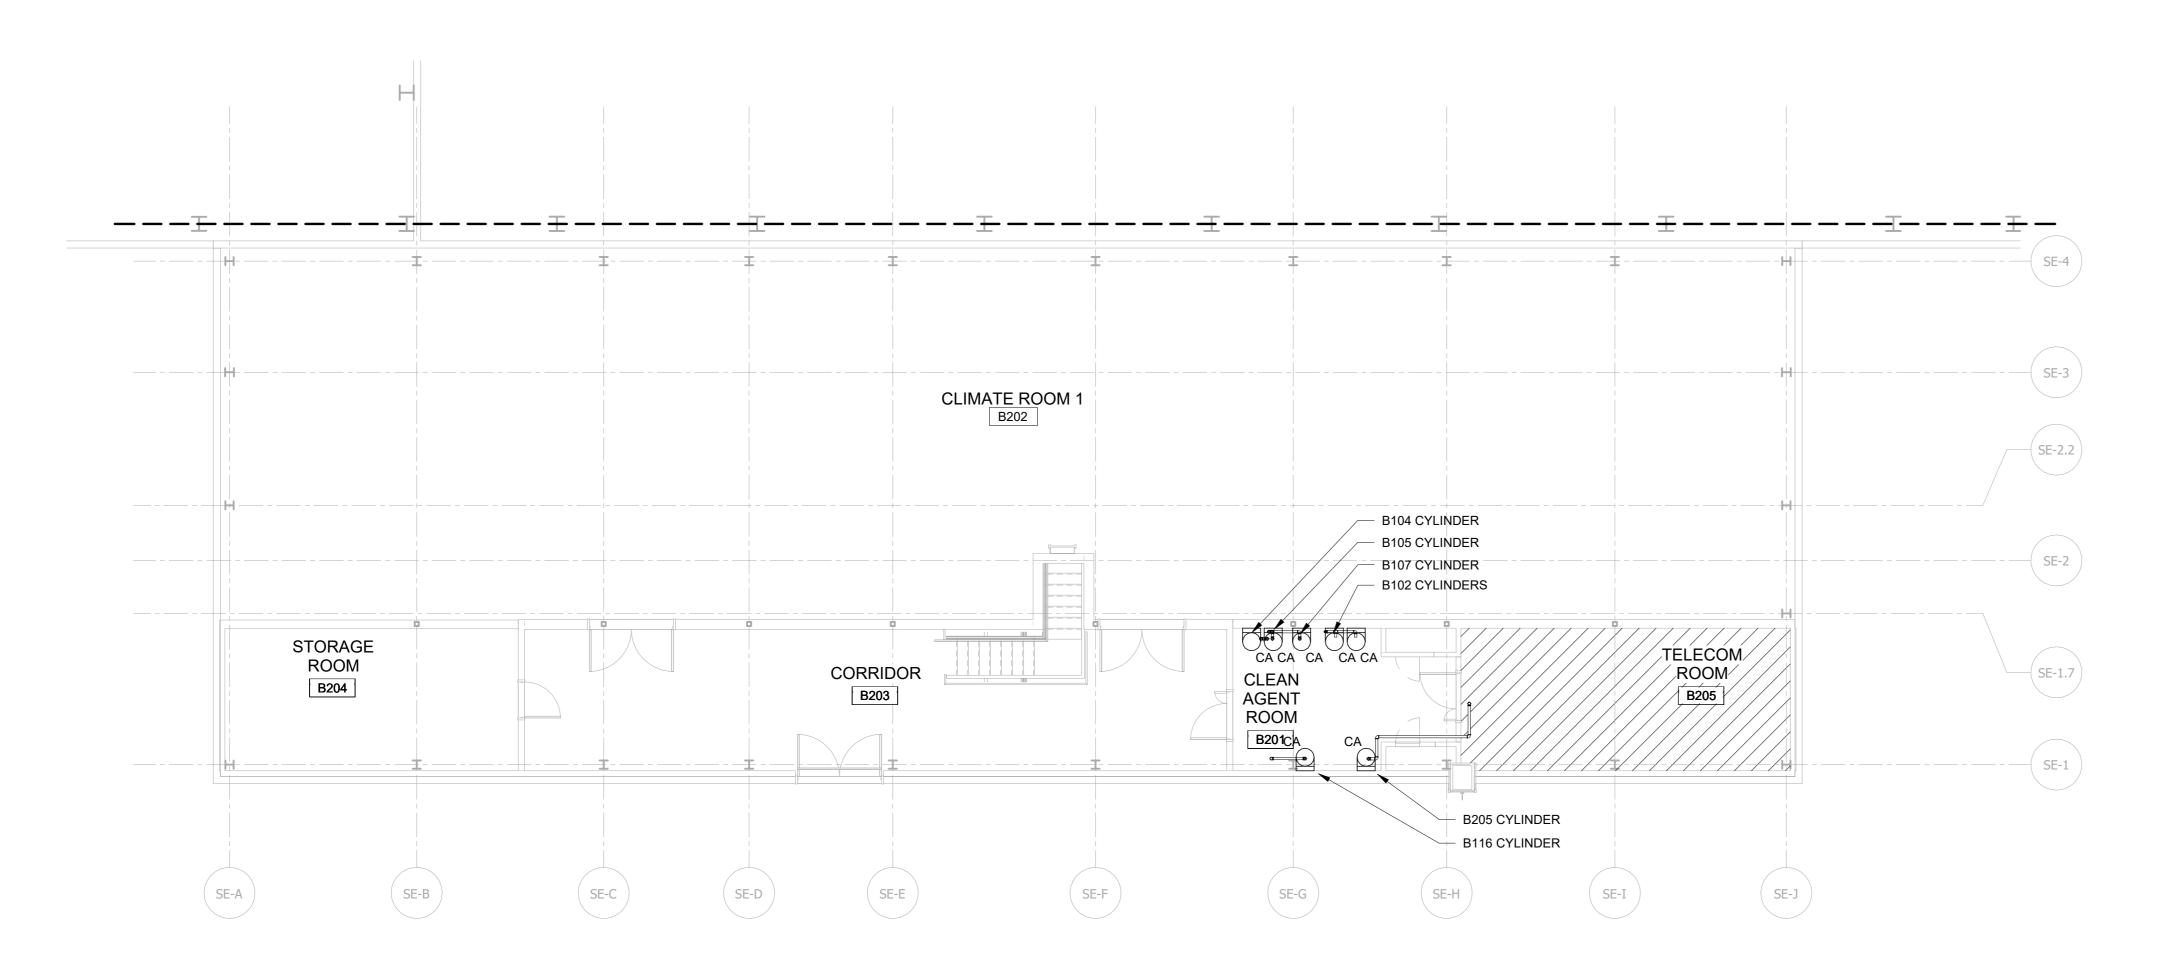

CLEAN AGENT SUPPRESSION PLAN - SECOND FLOOR

F-102.00 1/8" = 1'-0"

RATED WALL LEGEND

2 HOUR FIRE BARRIER


NOTE: RATED WALLS ARE REFERENCED FROM ARCHITECTURAL PLANS. INCLUDED IN SEPARATE PERMIT SUBMITTAL

CLEAN AGENT HATCH LEGEND

INCLUDING BELOW RAISED FLOOR

NOVEC 1230 - TOTAL FLOODING, NO RAISED FLOOR NOVEC 1230 - TOTAL FLOODING

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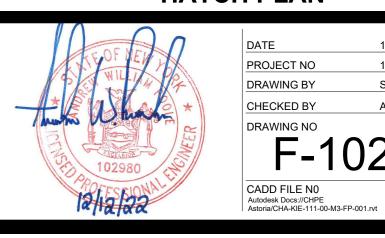
@Hitachi Energy 901 Main Campus Drive Raleigh, North Carolina 27606

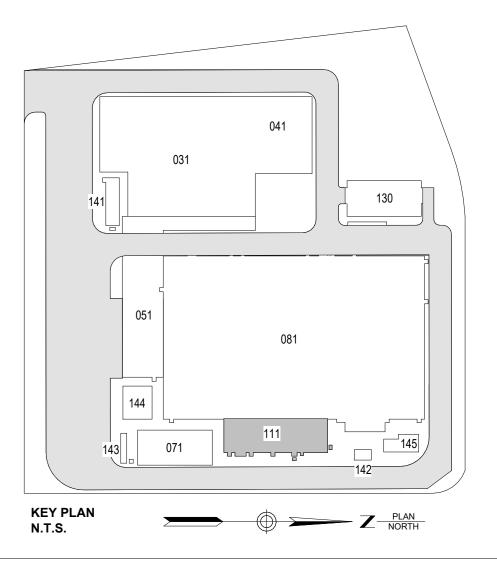


Astoria HVDC Converter Station


31-45 20th Avenue, Astoria, Queens NY 11105 Block #850 - Lot #310 - BIN #4624437

SERVICE BUILDING -CLEAN AGENT SUPPRESSION SYSTEM HATCH PLAN



12/12/2022 PROJECT NO 105121 S. BRINKMEYER CHECKED BY A. POOLE

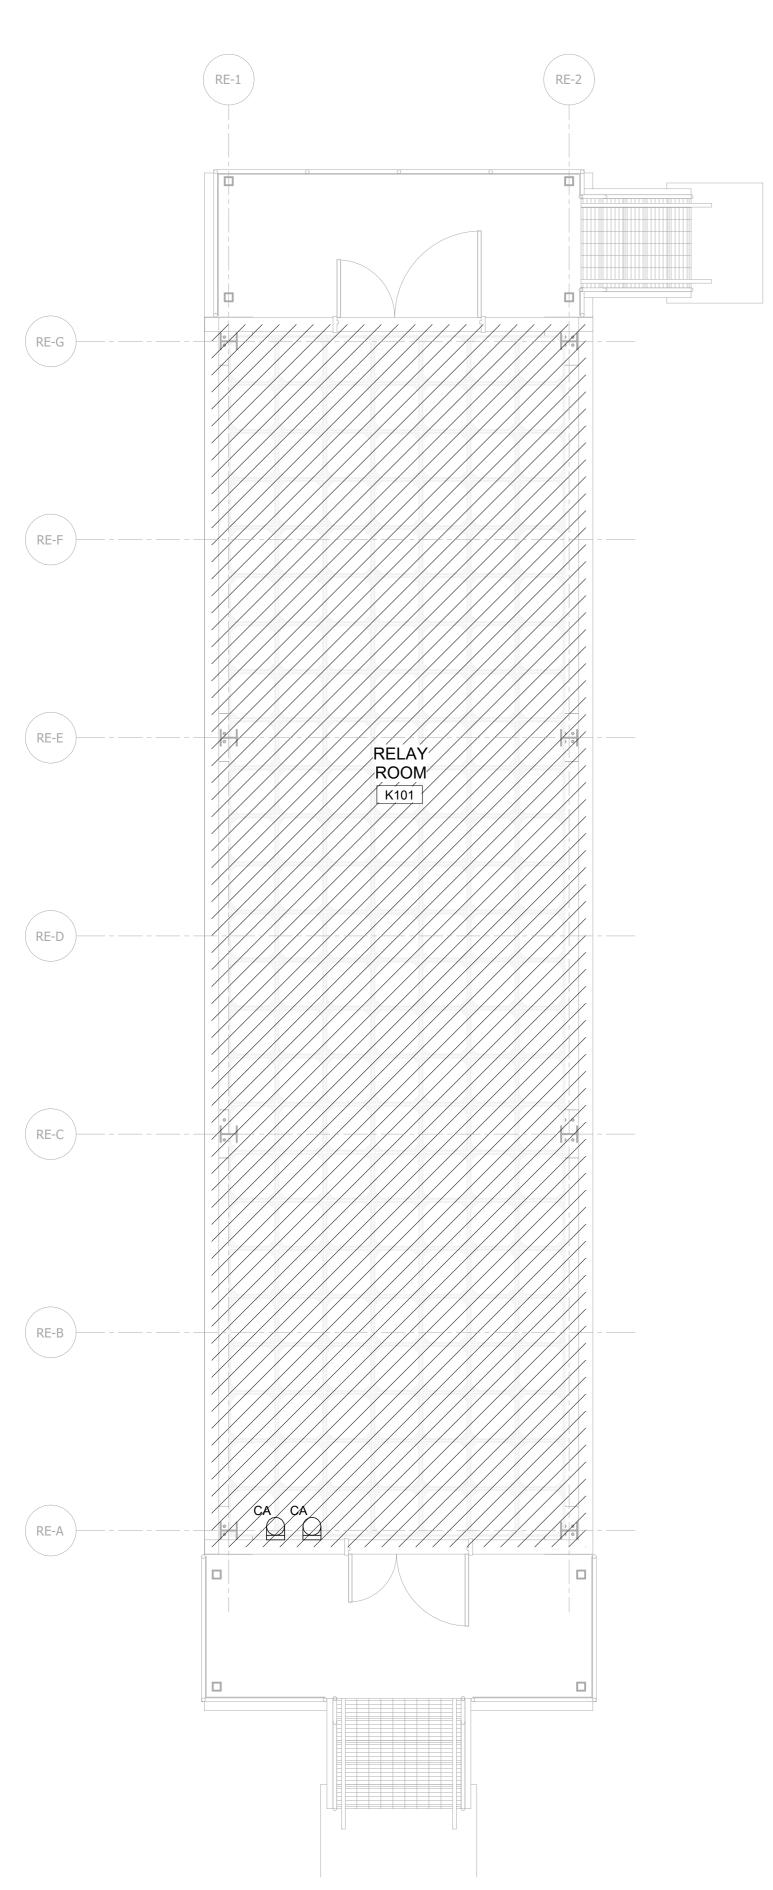

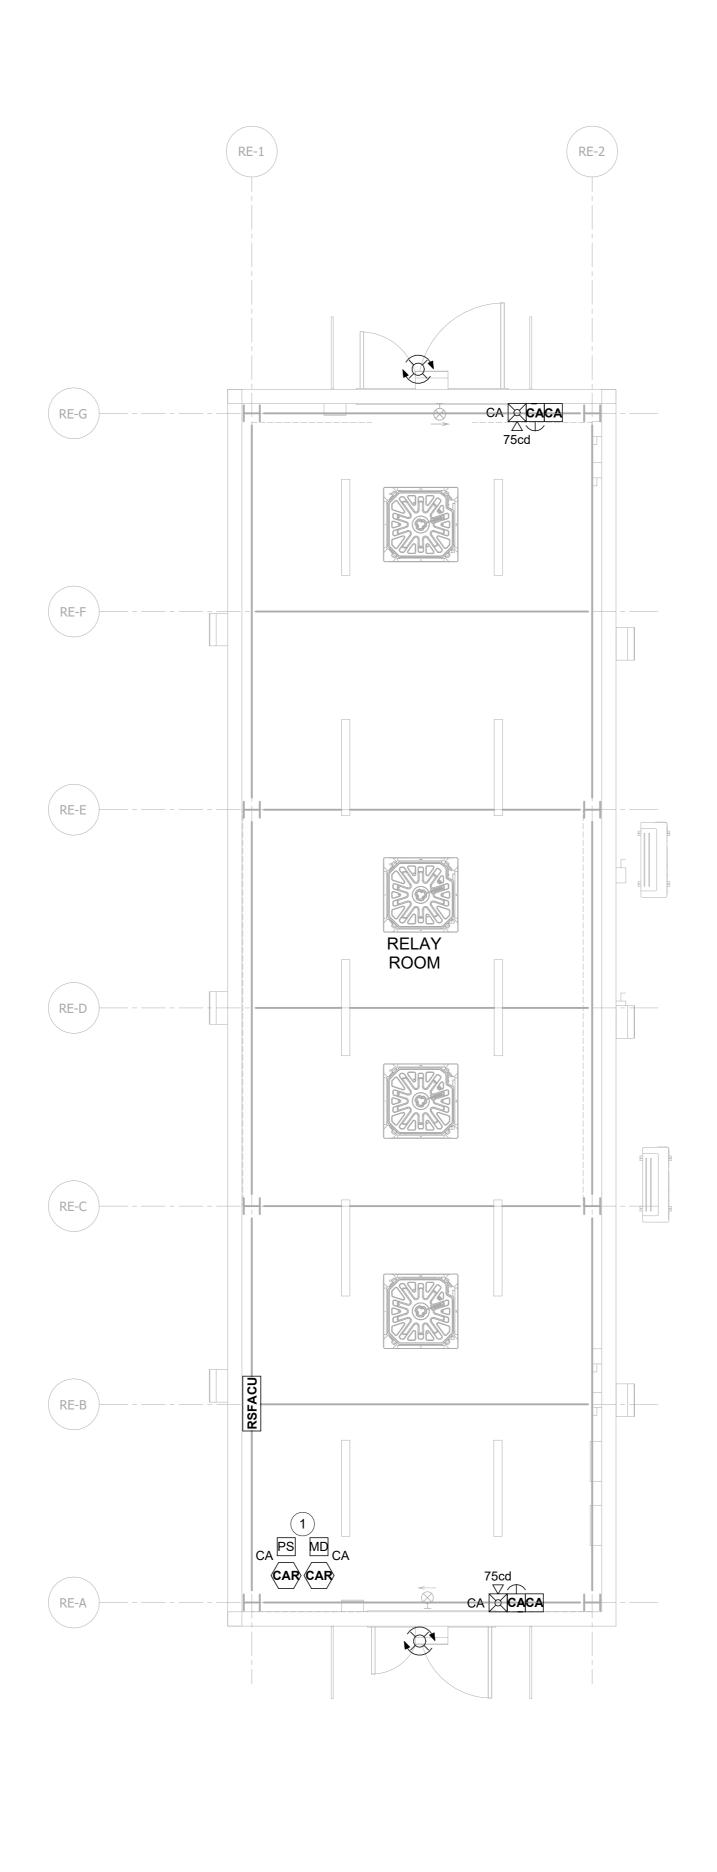




FIRE SUPPRESSION LEGEND

NOVEC 1230 - TOTAL FLOOD INCLUDING BELOW RAISED FLOOR

KEYNOTES

1 CLEAN AGENT MAINTENANCE DISCONNECTS, RELEASE
ACTUATORS, AND PRESSURE SWITCHES SHALL BE
CONTROLLED/MONITORED BY THE FIRE ALARM/RELEASING
PANEL WITHIN OPERATOR ROOM B109. SEE FIRE ALARM PLANS
INCLUDED IN SEPARATE SUBMITTAL.

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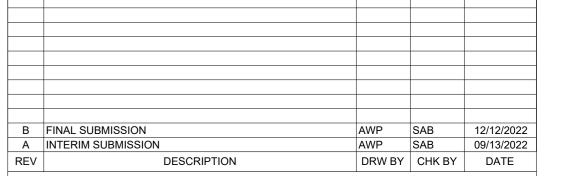
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Hitachi Energy901 Main Campus Drive Raleigh, North Carolina 27606

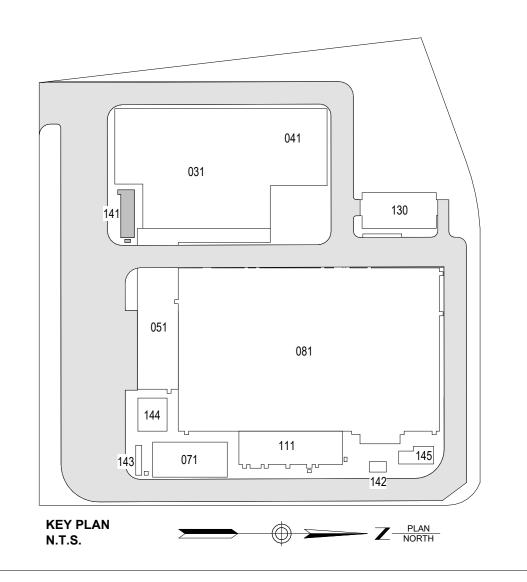PROJECT



Astoria HVDC Converter Station

31-45 20th Avenue, Astoria, Queens NY 11105 Block #850 - Lot #310 - BIN #4624437

RELAY ENCLOSURE -CLEAN AGENT SUPPRESSION SYSTEM




DATE 12/12/2022
PROJECT NO 105121
DRAWING BY S. BRINKMEYER
CHECKED BY A. POOLE
DRAWING NO

F-103.00

CADD FILE NO
Autodesk Docs://CHPE
Astoria/CHA-KIE-141-00-M3-FP-001.rvt


1 CLEAN AGENT SUPPRESSION SYSTEM HATCH PLAN F-103.00 1/4" = 1'-0"

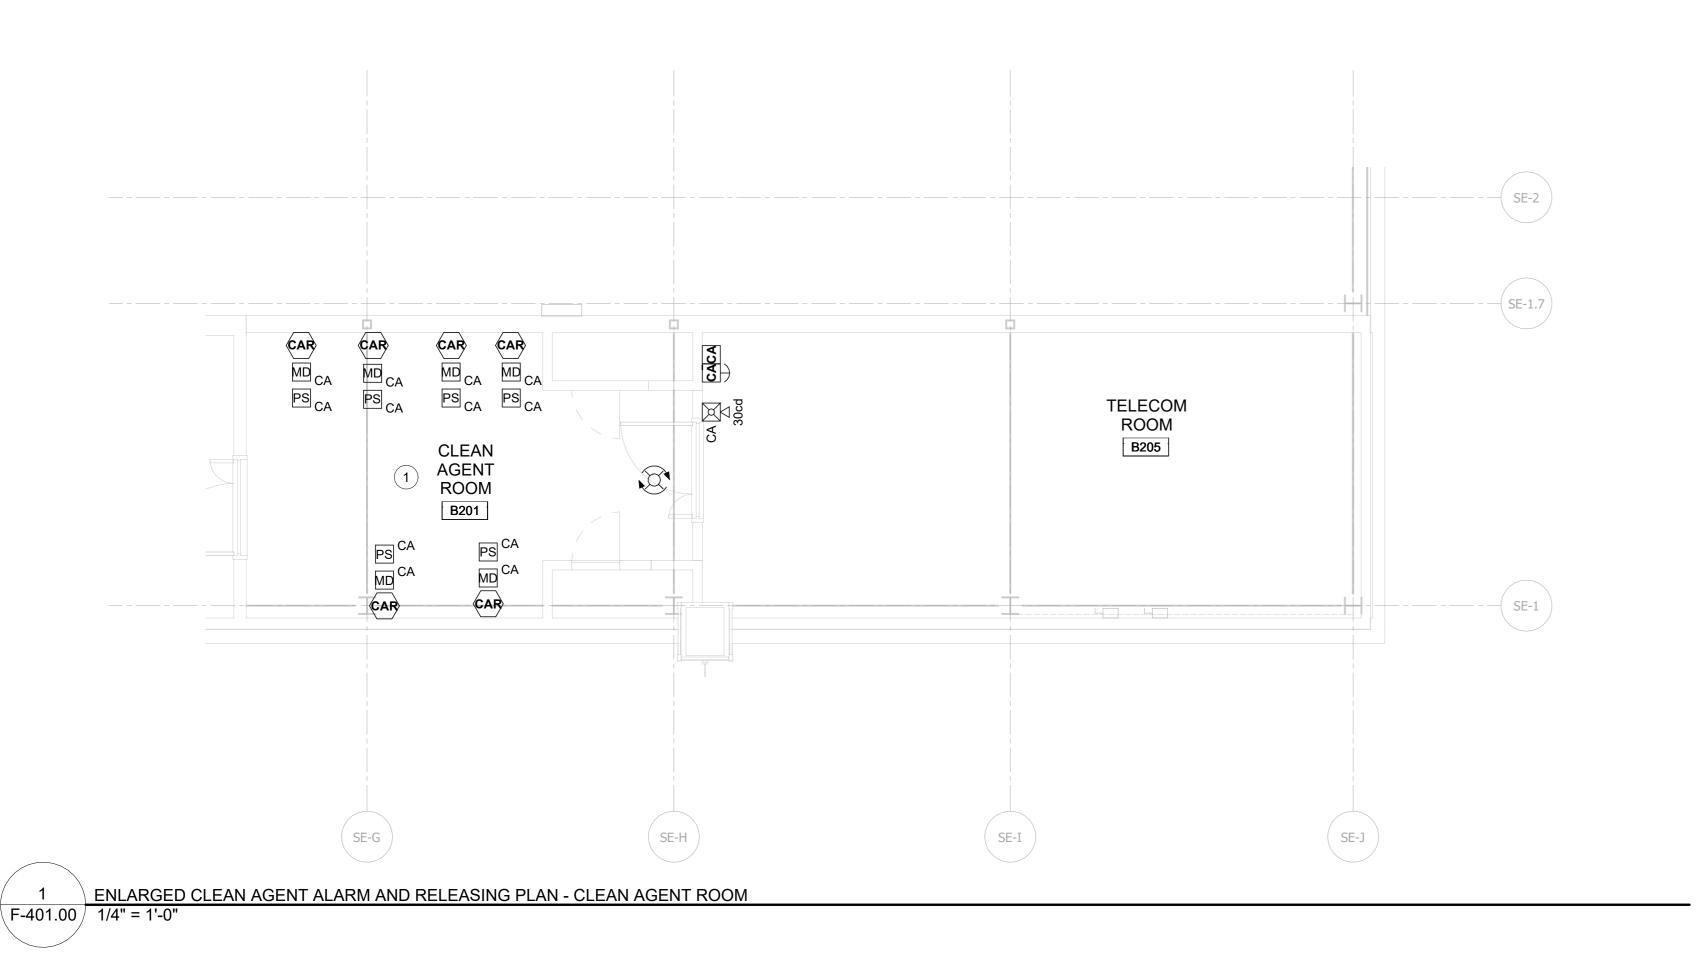

KEYNOTES

1 CLEAN AGENT MAINTENANCE DISCONNECTS, RELEASE ACTUATORS, AND PRESSURE SWITCHES SHALL BE CONTROLLED/MONITORED BY THE FIRE ALARM/RELEASING PANEL WITHIN OPERATOR ROOM B109. SEE FIRE ALARM PLANS INCLUDED IN SEPARATE SUBMITTAL.

ISSUED FOR PERMIT

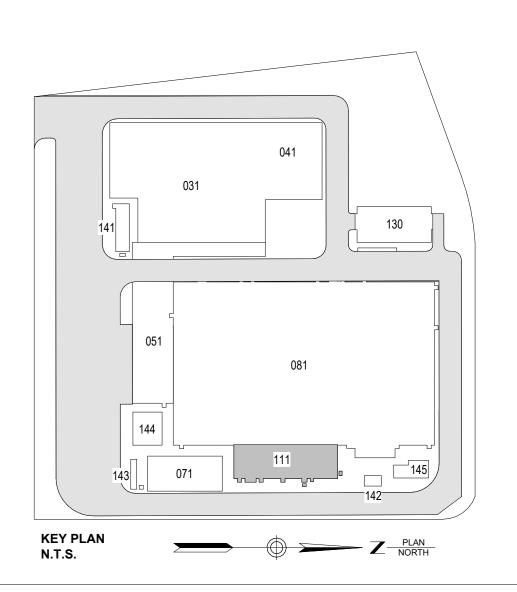



19910 W. 161st STREET **OLATHE, KS. 66062**

25 Mohawk Avenue



Sparta, NJ 07871

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В	FINAL SUBMISSION	SAB	AWP	12/12/2022
Α	INTERIM SUBMISSION	SAB	AWP	09/13/2022
REV	DESCRIPTION	DRW BY	CHK BY	DATE



@Hitachi Energy 901 Main Campus Drive Raleigh, North Carolina 27606

> 105121 S. BRINKMEYER



Astoria HVDC Converter Station

31-45 20th Avenue, Astoria, Queens NY 11105 Block #850 - Lot #310 - BIN #4624437

SERVICE BUILDING -ENLARGED CLEAN AGENT

ALARM AND RELEASING

