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Land Surveying, P.C.

370 7th Avenue
SUITE 1604
New York, NY 10001

SOWINSKI
SULLIVAN
ARCHITECTURE+ENGINEERING

25 Mohawk Avenue
Sparta, NJ 07871

| | | | | |
|-----|--------------------|--------|--------|------------|
| B | FINAL SUBMISSION | RAC | ZH | 12/12/2022 |
| A | INTERIM SUBMISSION | RAC | ZH | 09/13/2022 |
| REV | DESCRIPTION | DRW BY | CHK BY | DATE |

Kiewit
470 Chestnut Ridge Rd # 2,
Woodcliff Lake, NJ 07677

Hitachi Energy
901 Main Campus Drive
Raleigh, North Carolina 27606

PROJECT

CHPE
Champlain Hudson
Power Express


Astoria HVDC
Converter Station

31-45 20th Avenue, Astoria, Queens NY 11105
Block #850 - Lot #310 - BIN #4624437

CONVERTER BLDG.
ENLARGED SECTION DC
HALL




DATE 12/12/22
PROJECT NO 105121
DRAWING BY Author
CHECKED BY Designer
DRAWING NO
A-310.00
CADD FILE NO
Astoria-HVDC-CHPE
Astoria-CHPE-111-ZZ-M3-A-001.rvt

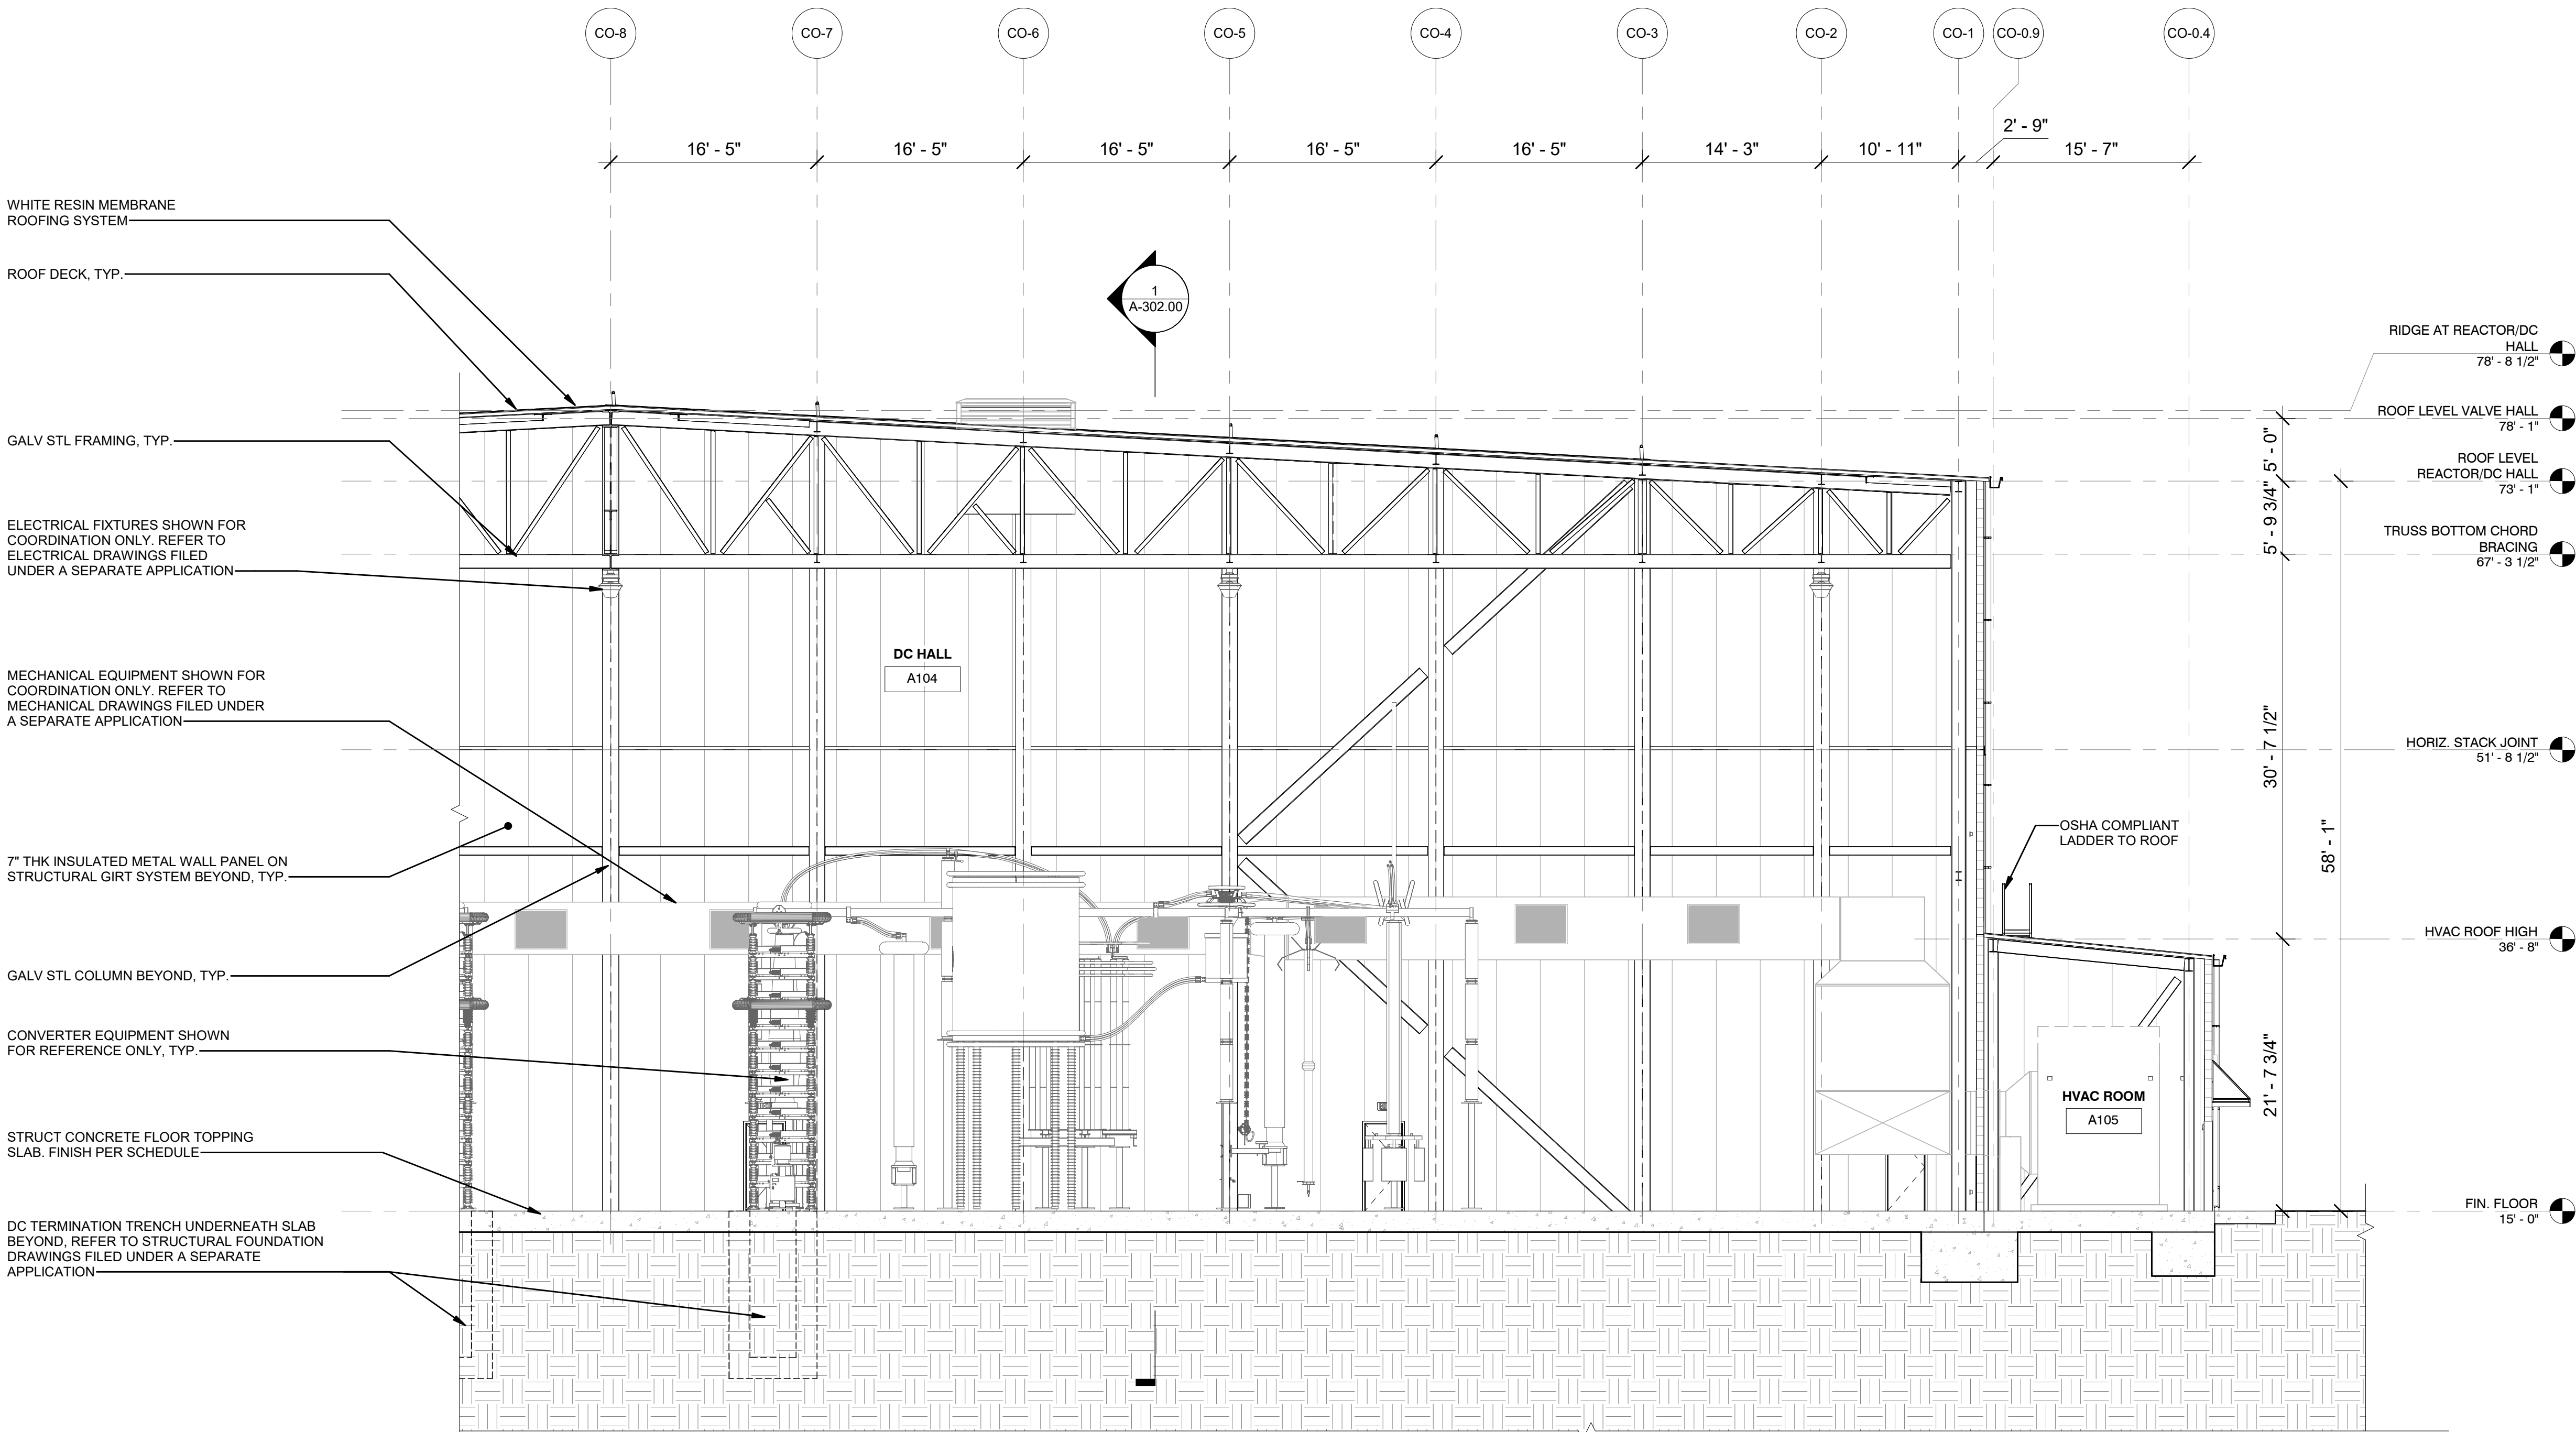


1
A-301.00 ENLARGED SECTION DC HALL 4
1/8" = 1'-0"

1' 0 4' 8' 16'

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1
A-301.00 ENLARGED SECTION - REACTOR HALL
1/8" = 1'-0"

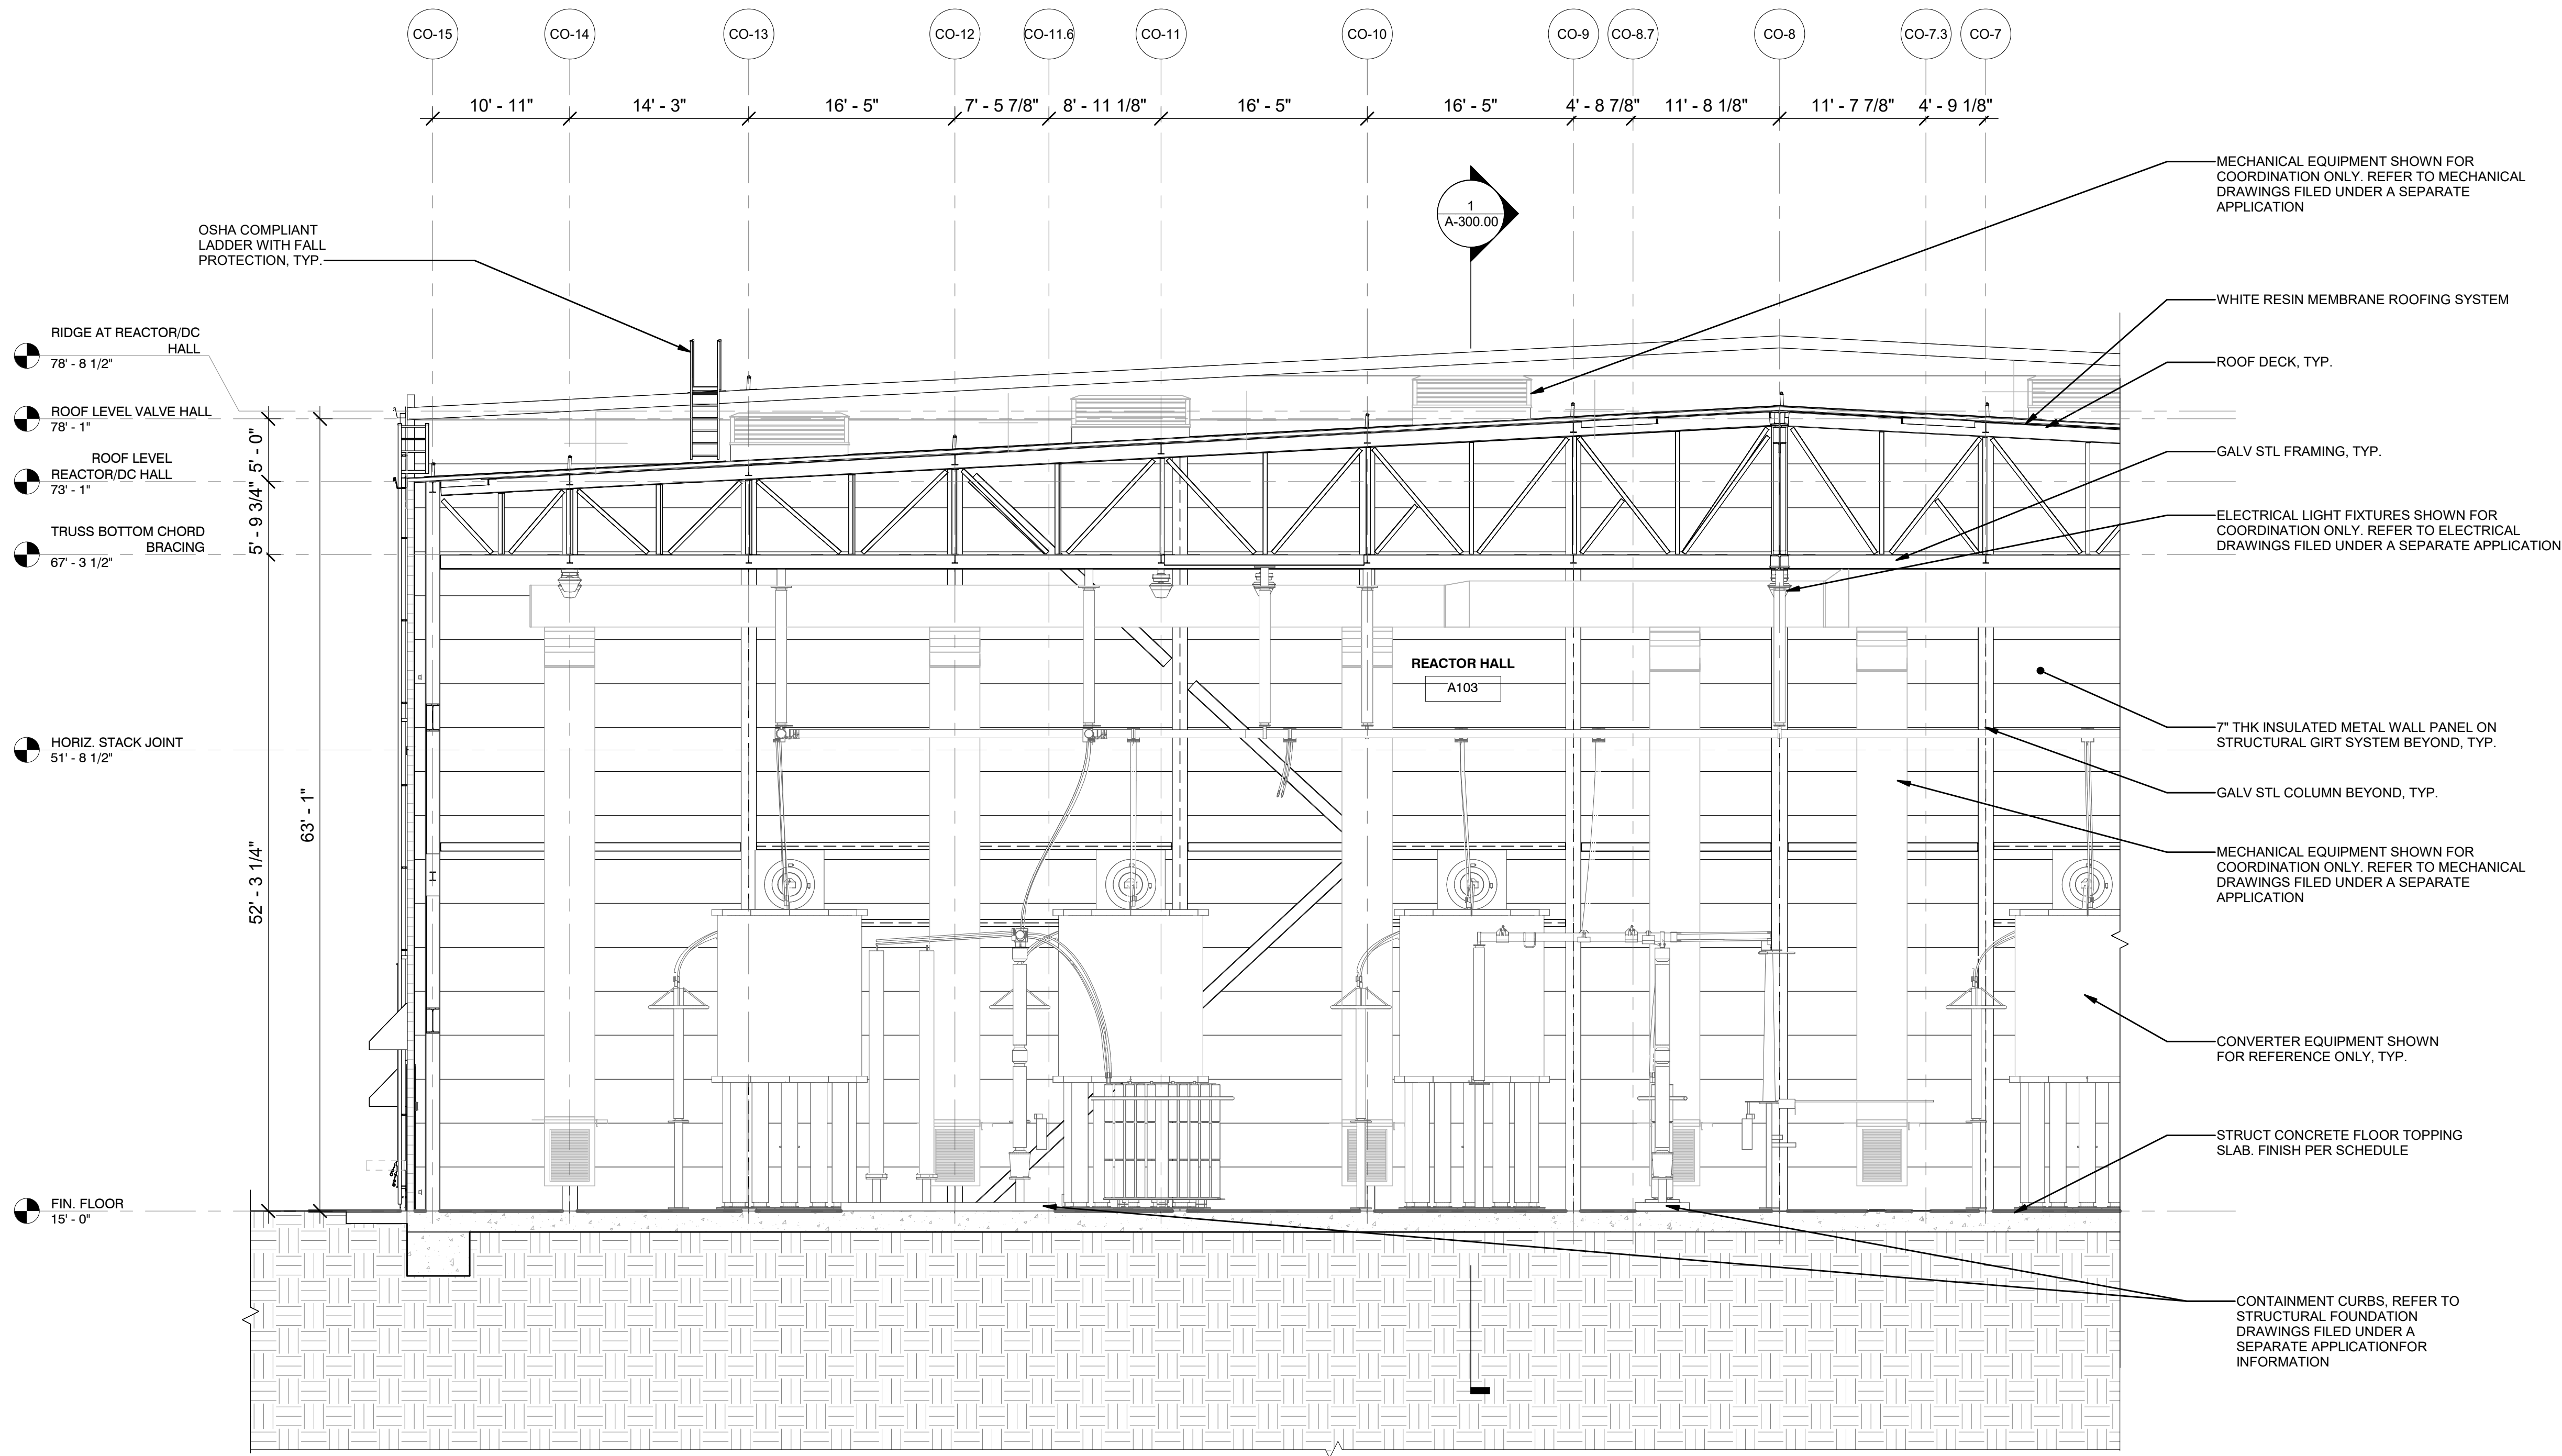

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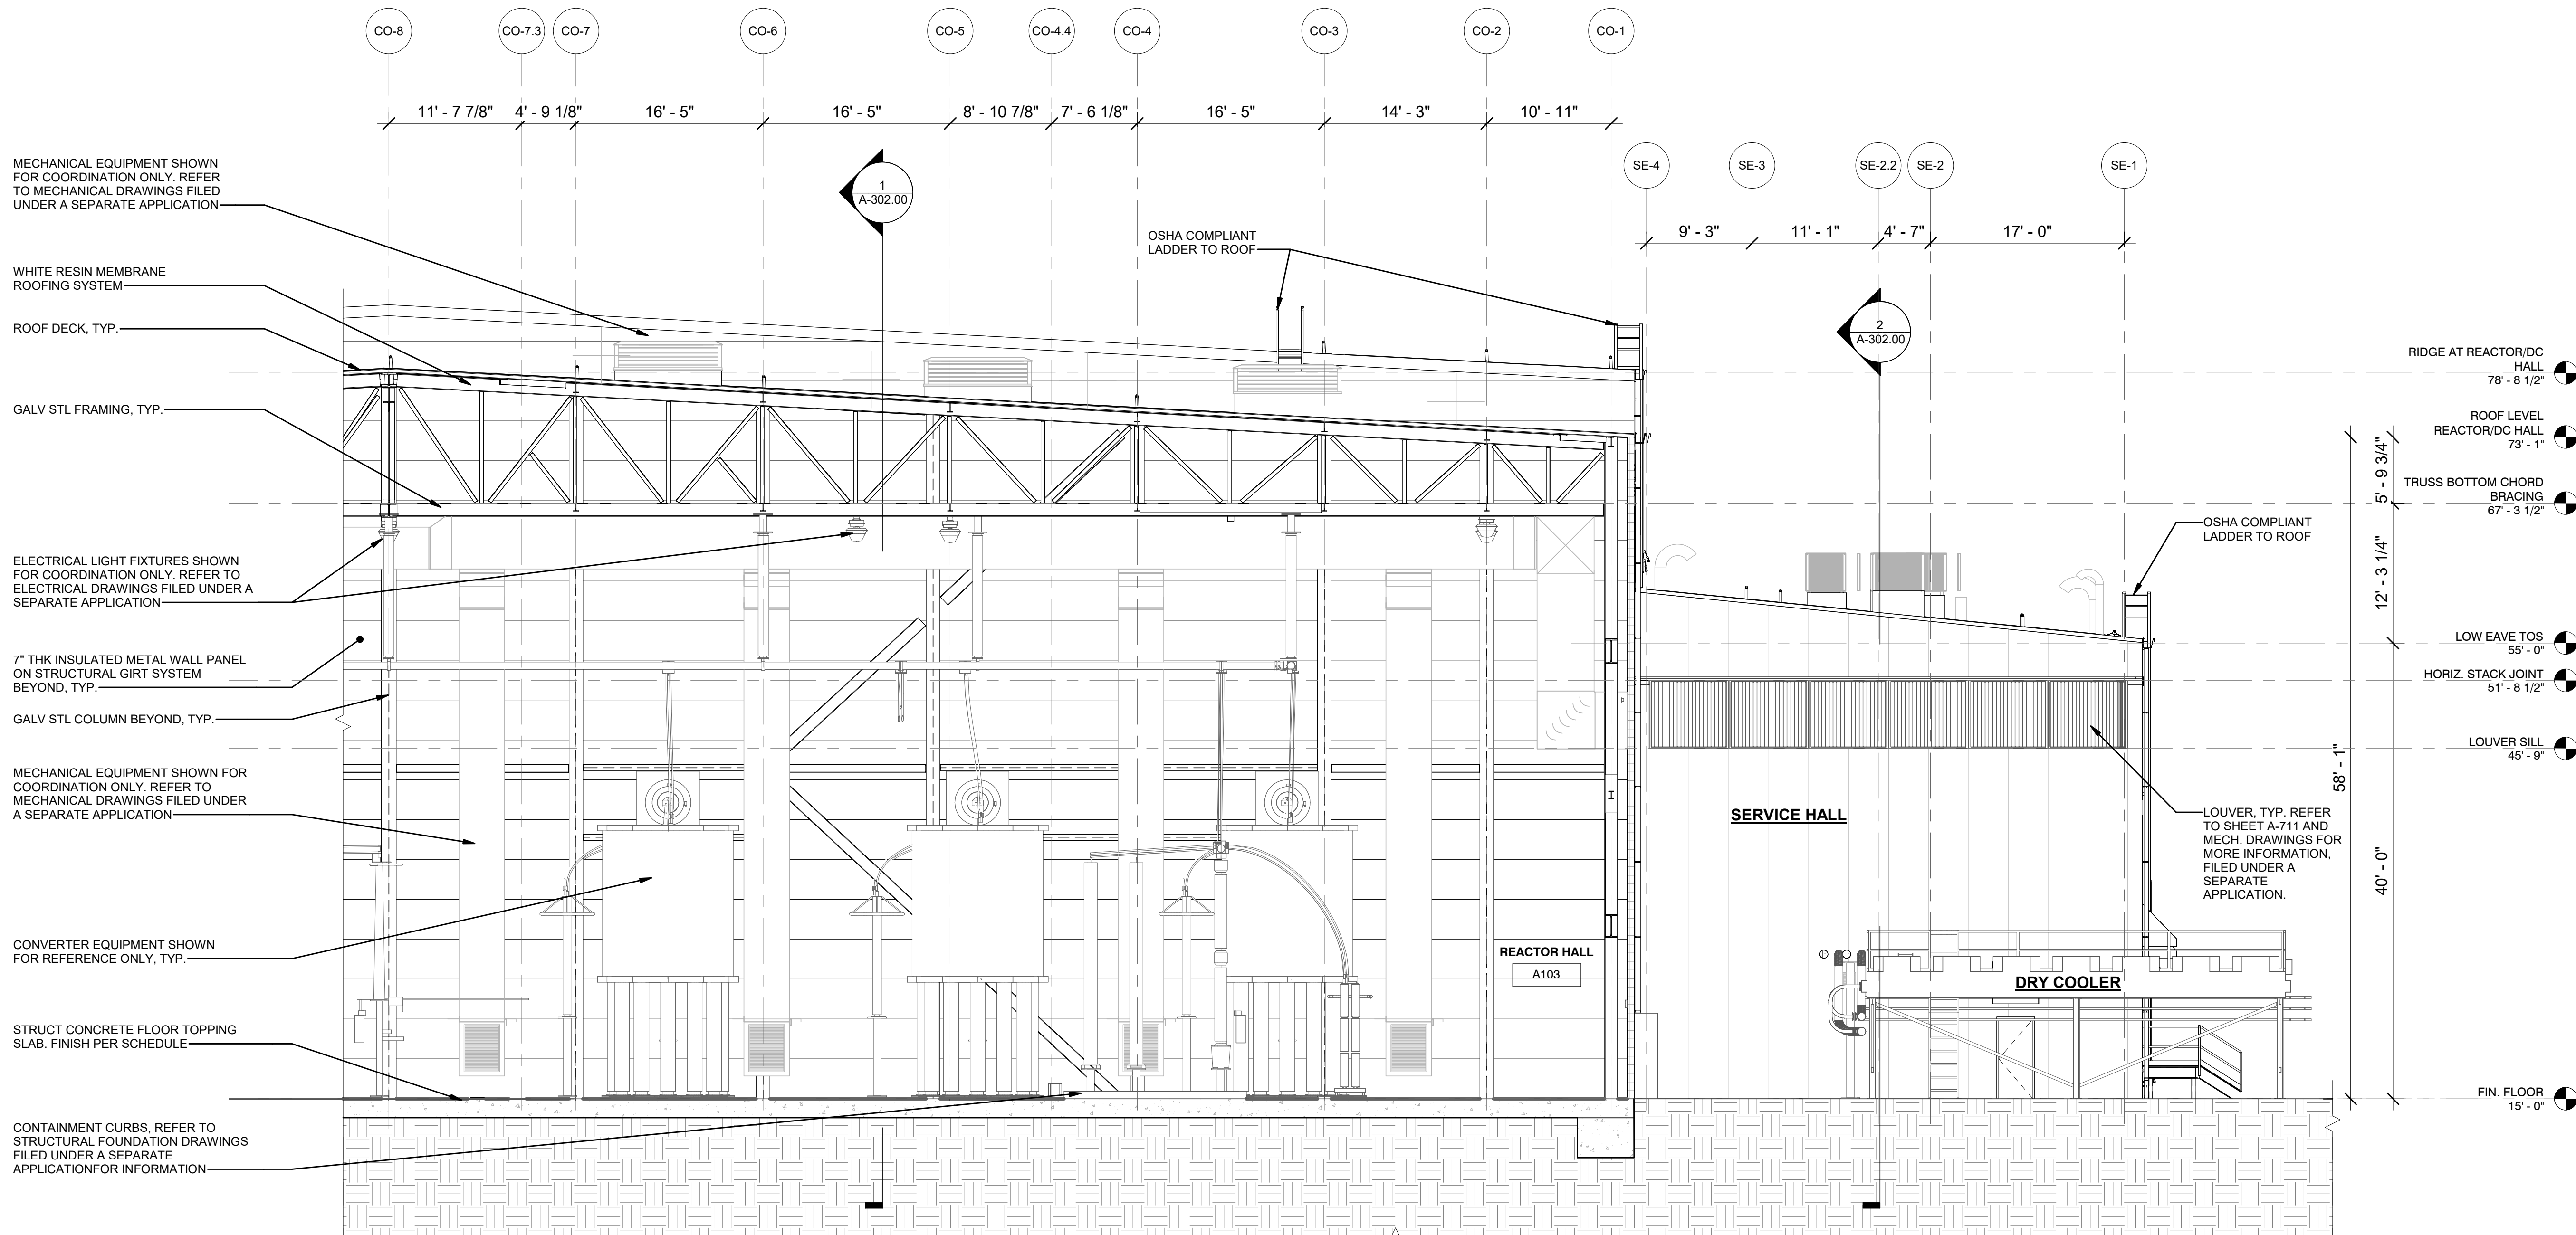
Astoria HVDC Converter Station
31-45 20th Avenue, Astoria, Queens NY 11105
Block #850 - Lot #310 - BIN #4624437

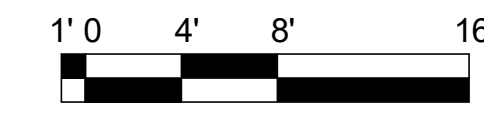**CONVERTER BLDG.
ENLARGED SECTION
REACTOR HALL**

REGISTERED ARCHITECT
SUZANNE SOWINSKI
STATE OF NEW YORK
026049

DATE 12/12/22
PROJECT NO 105121
DRAWING BY Author
CHECKED BY Designer
DRAWING NO
A-311.00
CADD FILE NO
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**Astoria HVDC
Converter Station**


31-45 20th Avenue, Astoria, Queens NY 11105
Block #850 - Lot #310 - BIN #4624437

**CONVERTER BLDG.
ENLARGED SECTION
REACTOR HALL 2**



DATE 12/12/22
PROJECT NO 105121
DRAWING BY Author
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DRAWING NO
A-312.00
CADD FILE NO
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Astoria-CHPE-111-ZZ-M3-A-001.rvt


12/8/2022 11:20:11 AM

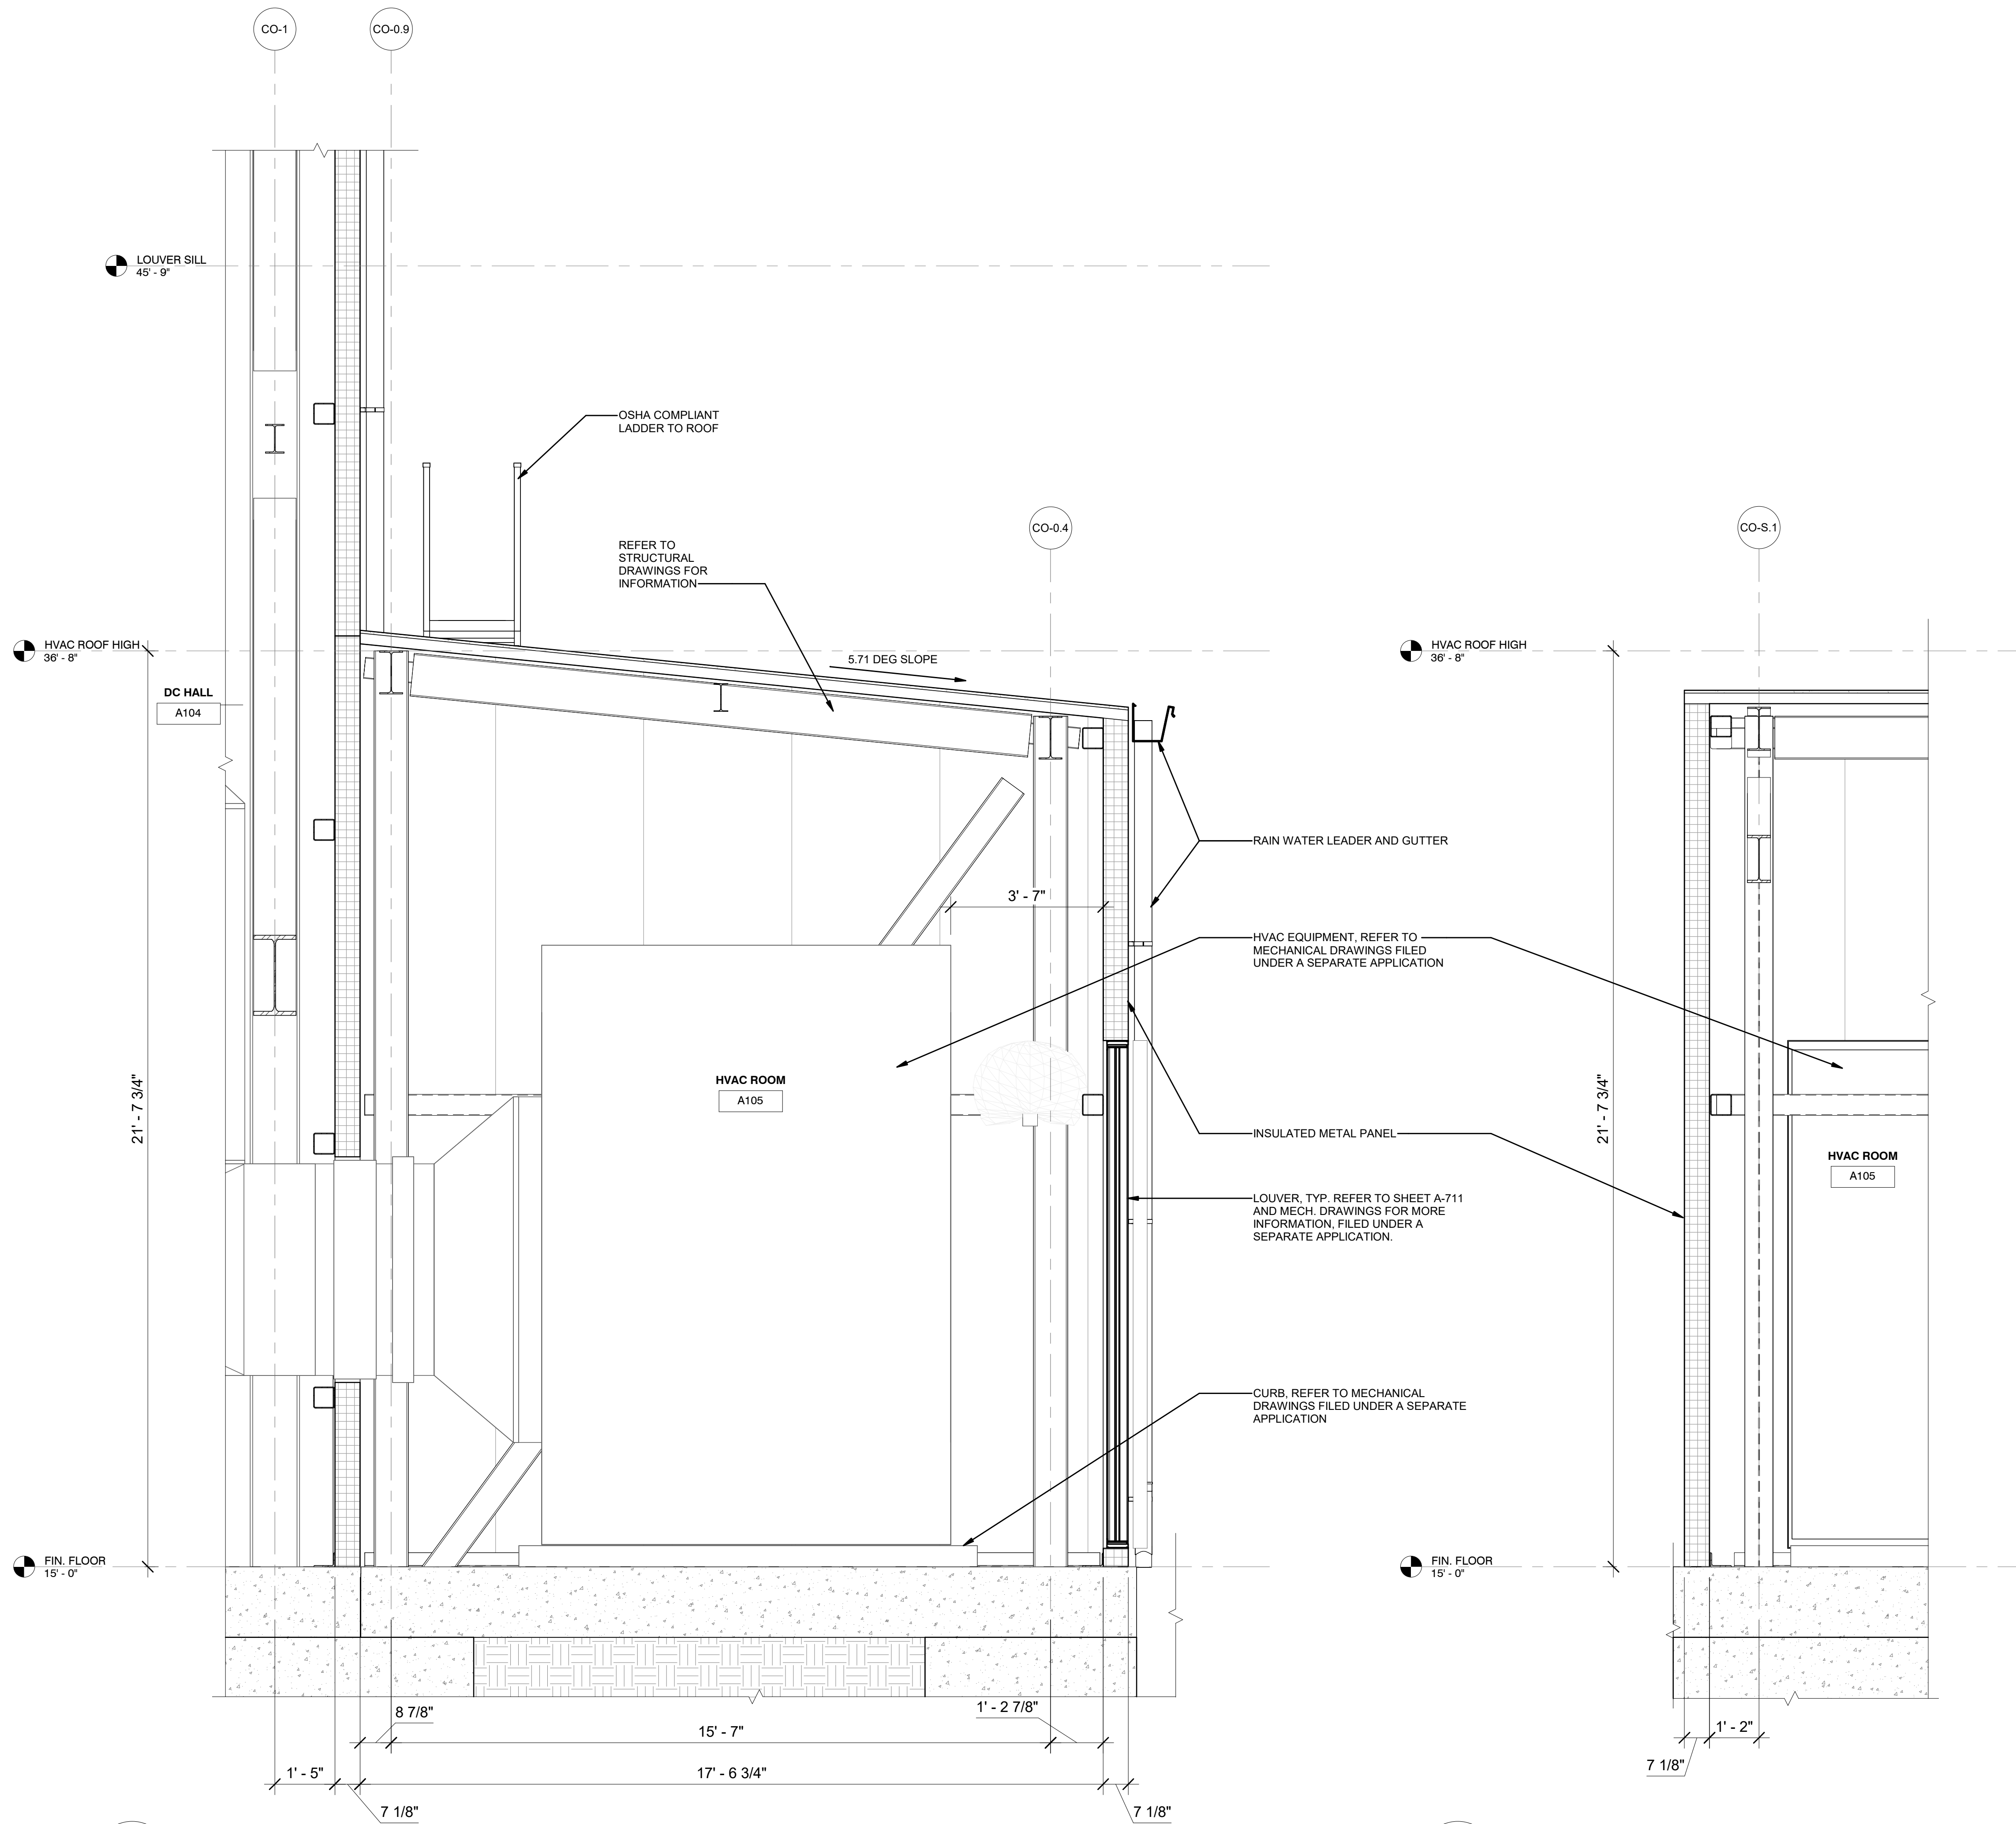

1
A-106.00 SECTION - HVAC ROOM
1/2" = 1'-0"

2
A-106.00 WALL SECTION - HVAC ROOM
1/2" = 1'-0"

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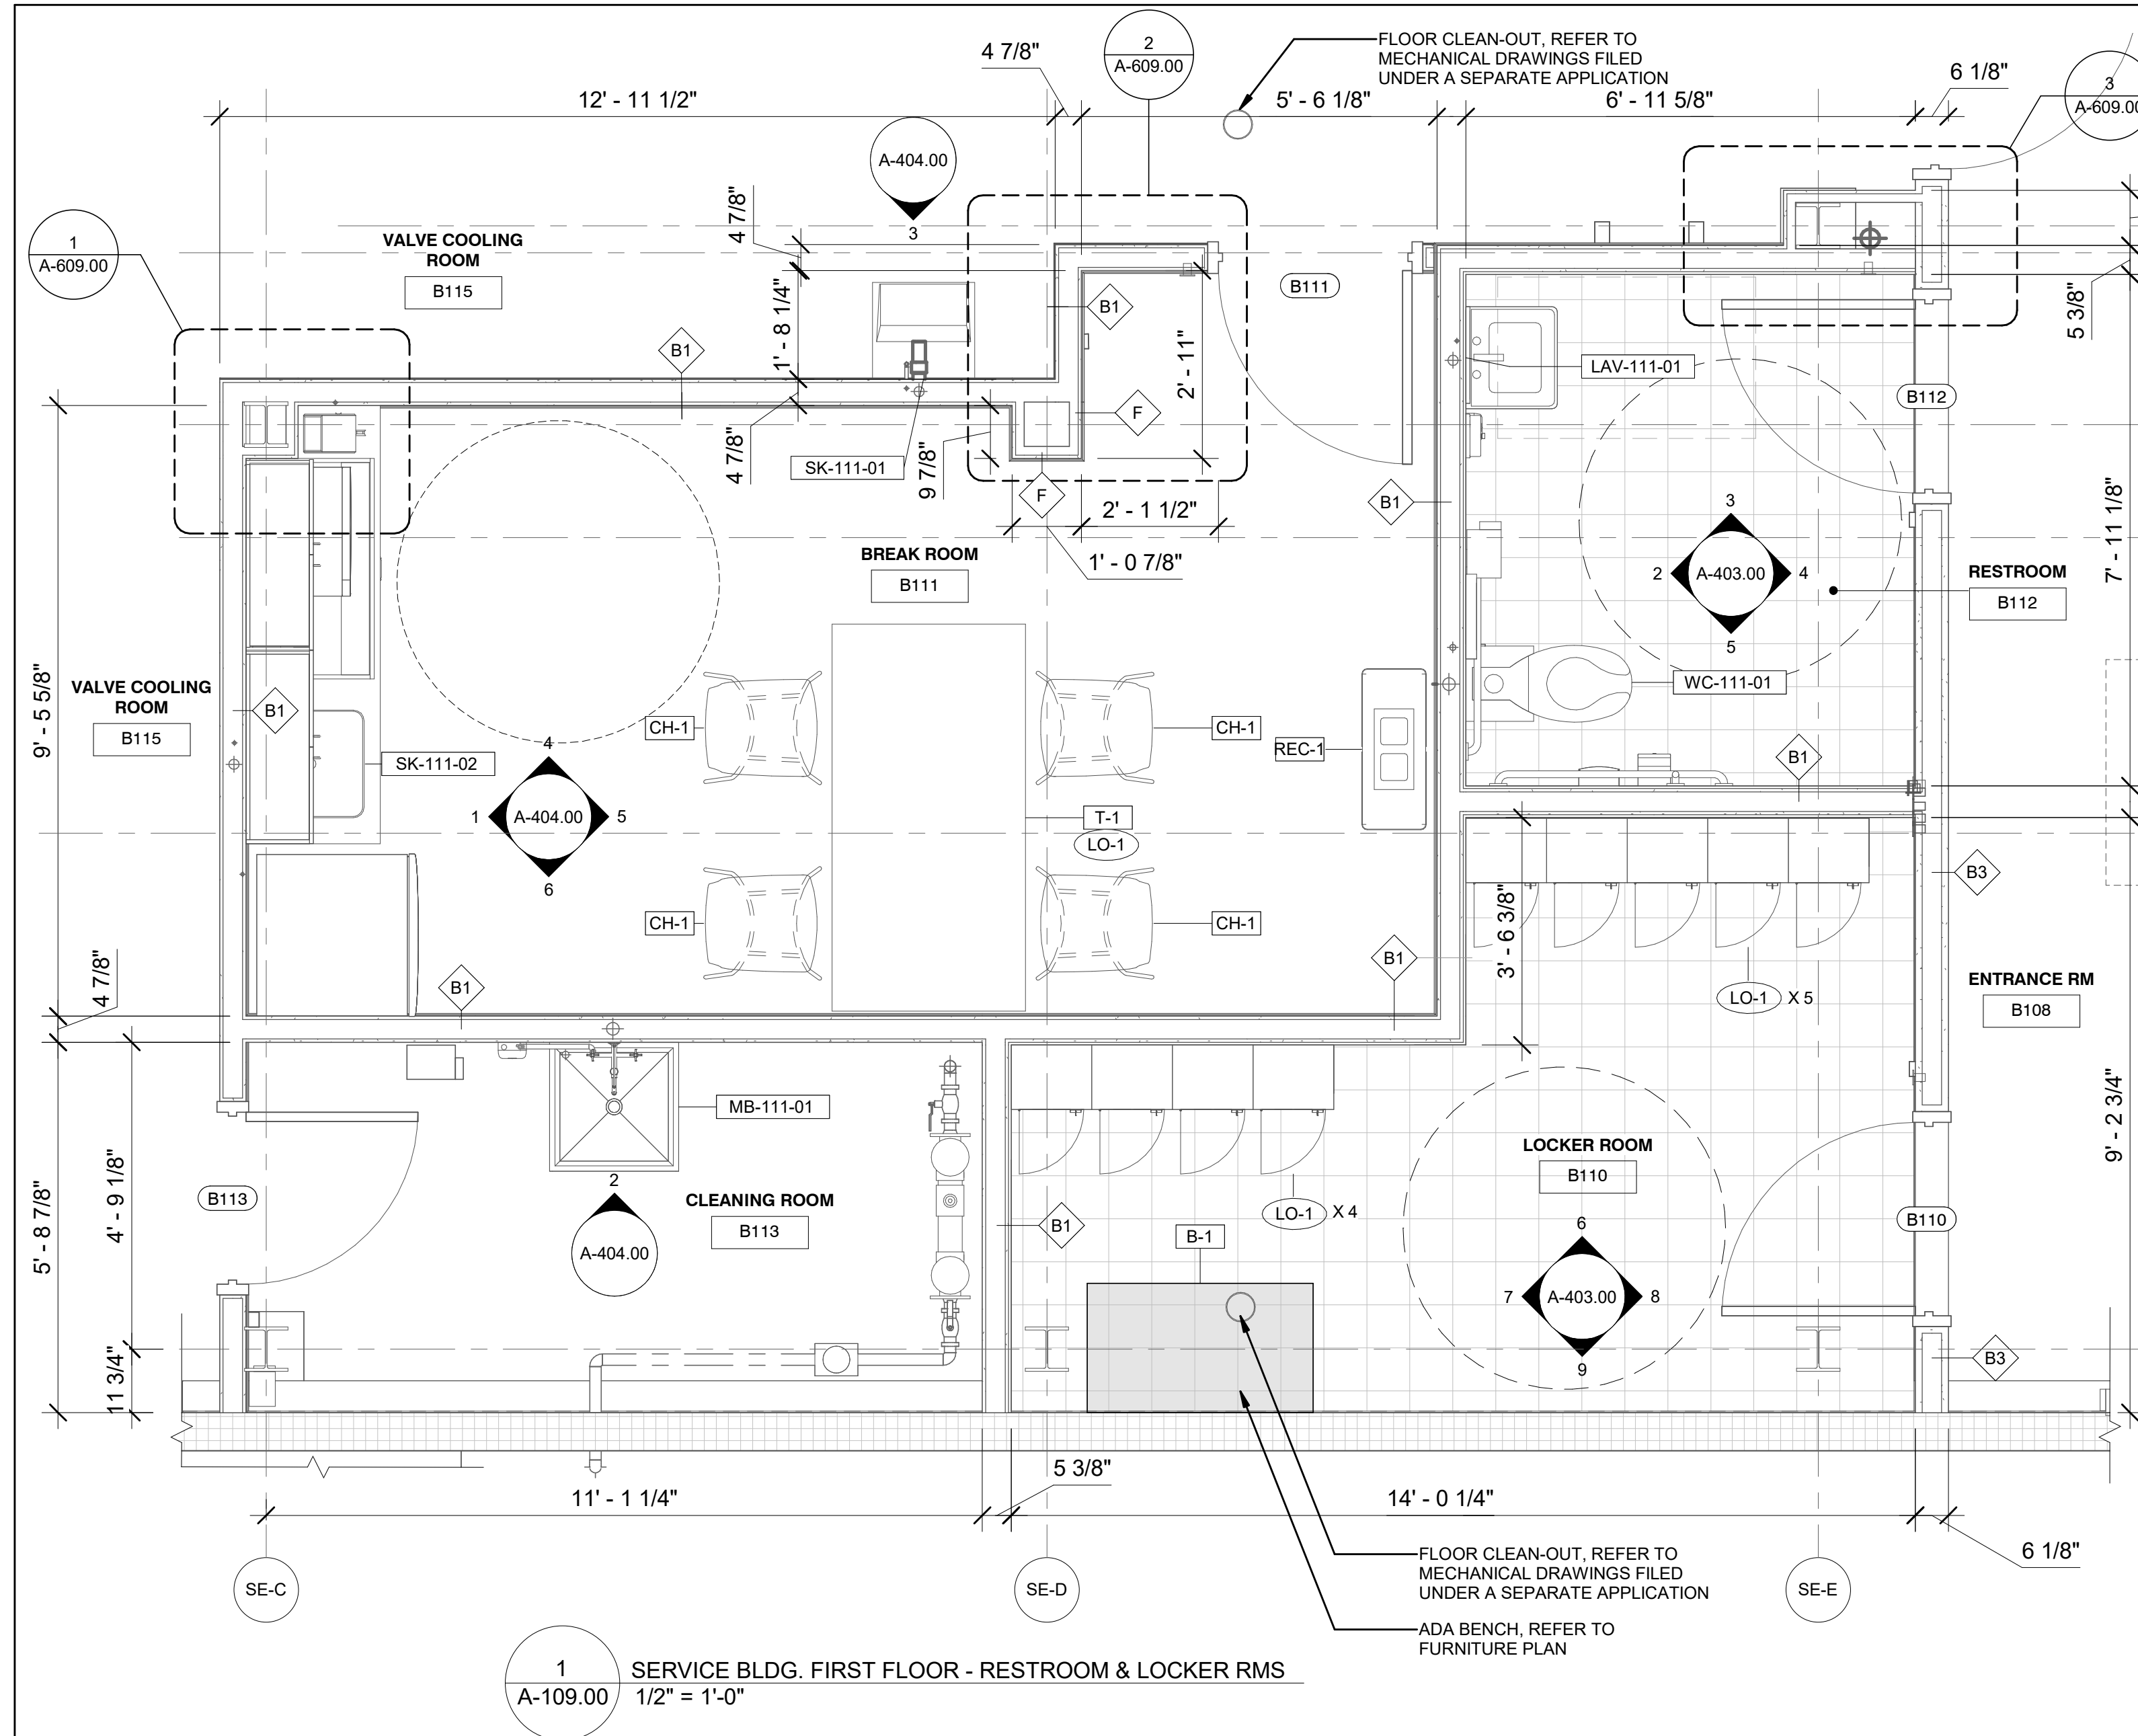
31-45 20th Avenue, Astoria, Queens NY 11105
Block #850 - Lot #310 - BIN #4624437

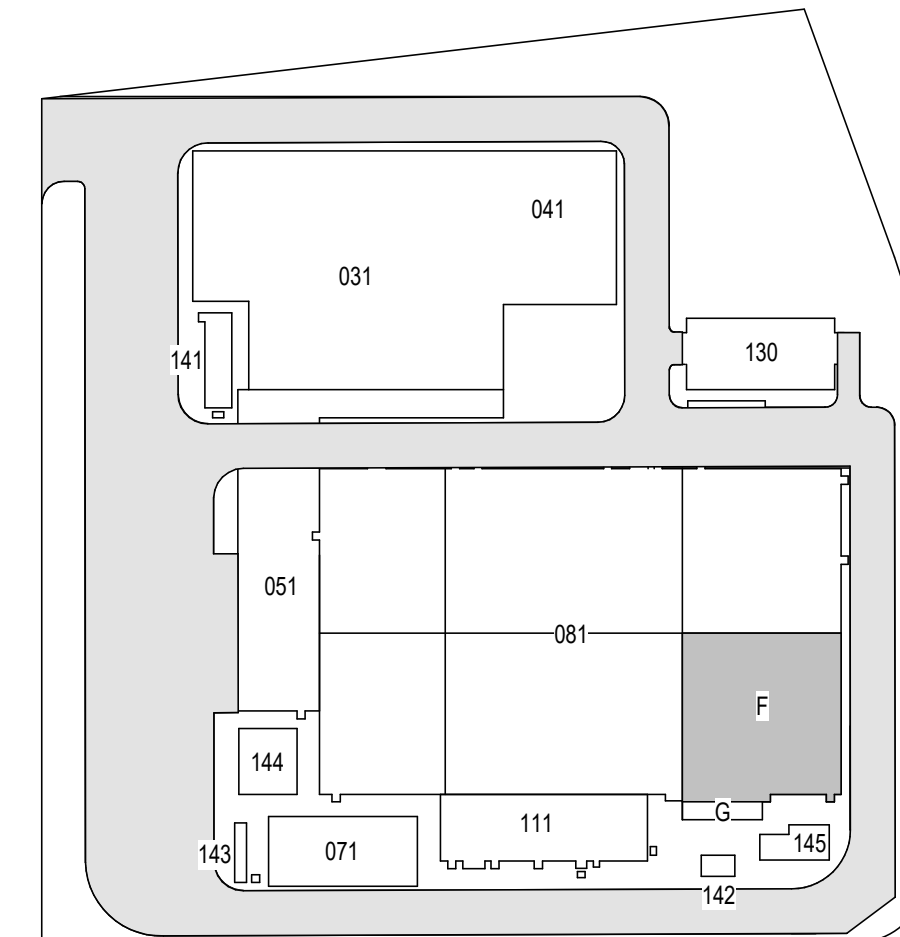HVAC ROOM SECTIONS




DATE 12/12/22
PROJECT NO 105121
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CHECKED BY Designer
DRAWING NO
A-319.00
CADD FILE NO
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Astoria-CHPE-111-ZZ-M3-A-001.rvt


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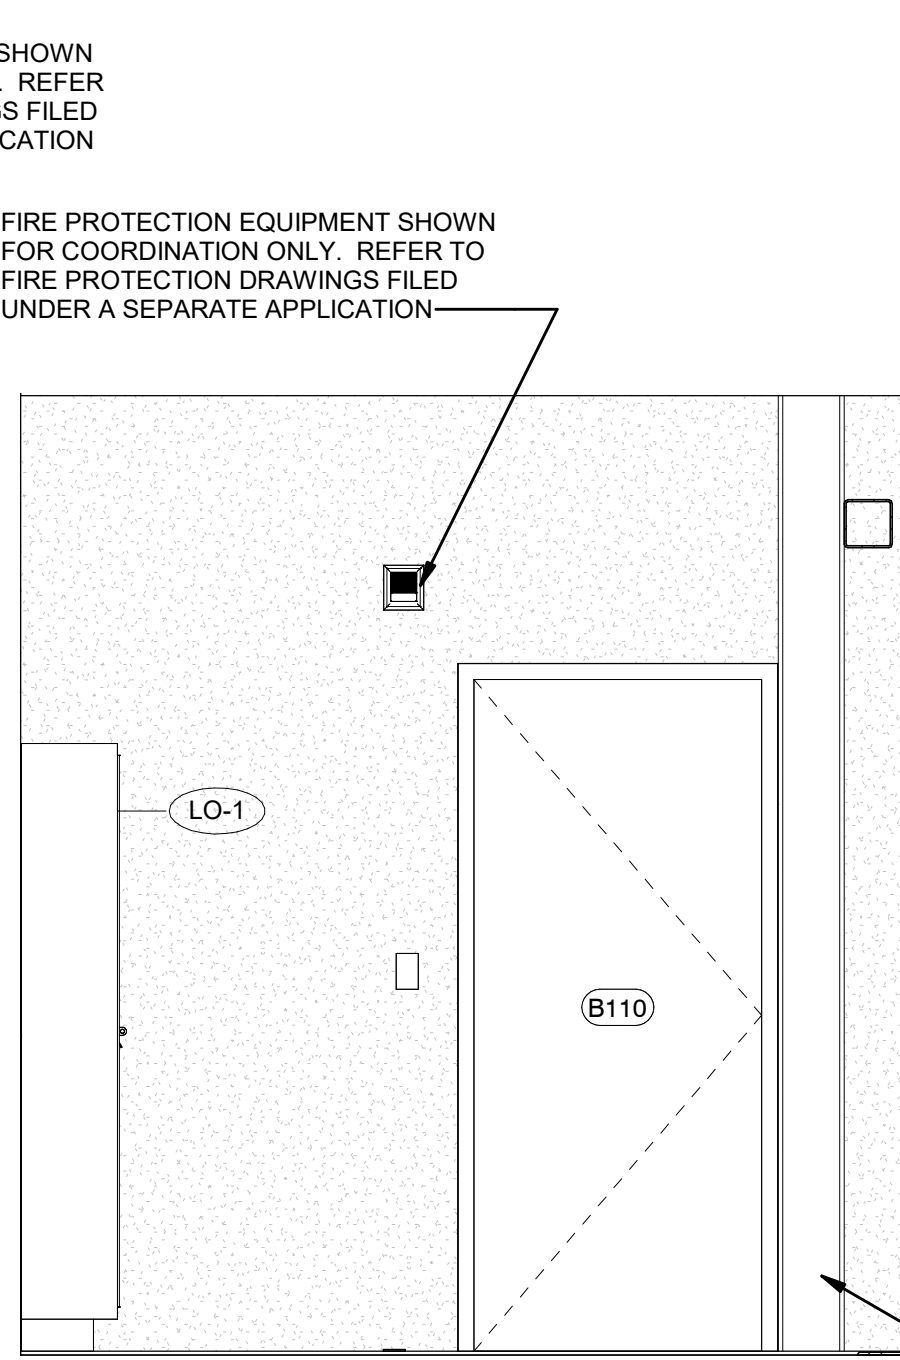
1 SERVICE BLDG. FIRST FLOOR - RESTROOM & LOCKER RMS
A-109.00 1/2" = 1'-0"




6 ELEVATION - LOCKER ROOM 3
A-403.00 1/2" = 1'-0"

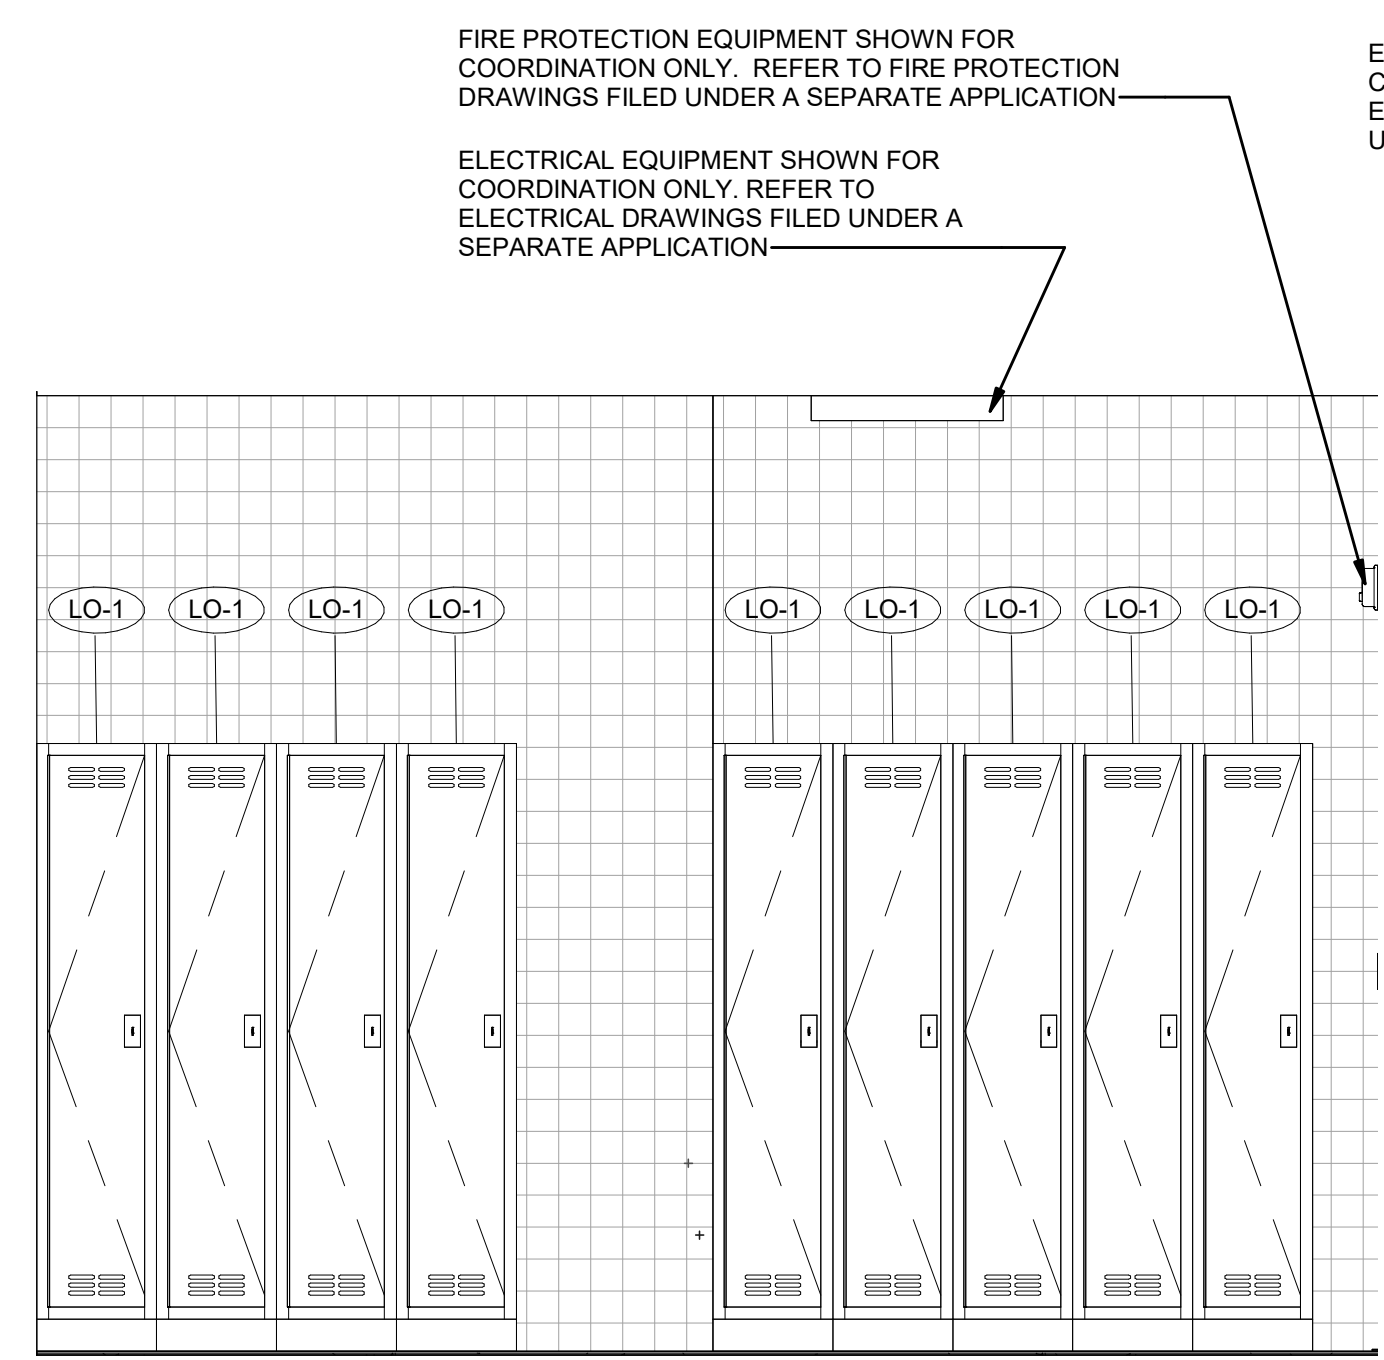


7 ELEVATION - LOCKER ROOM 4
A-403.00 1/2" = 1'-0"

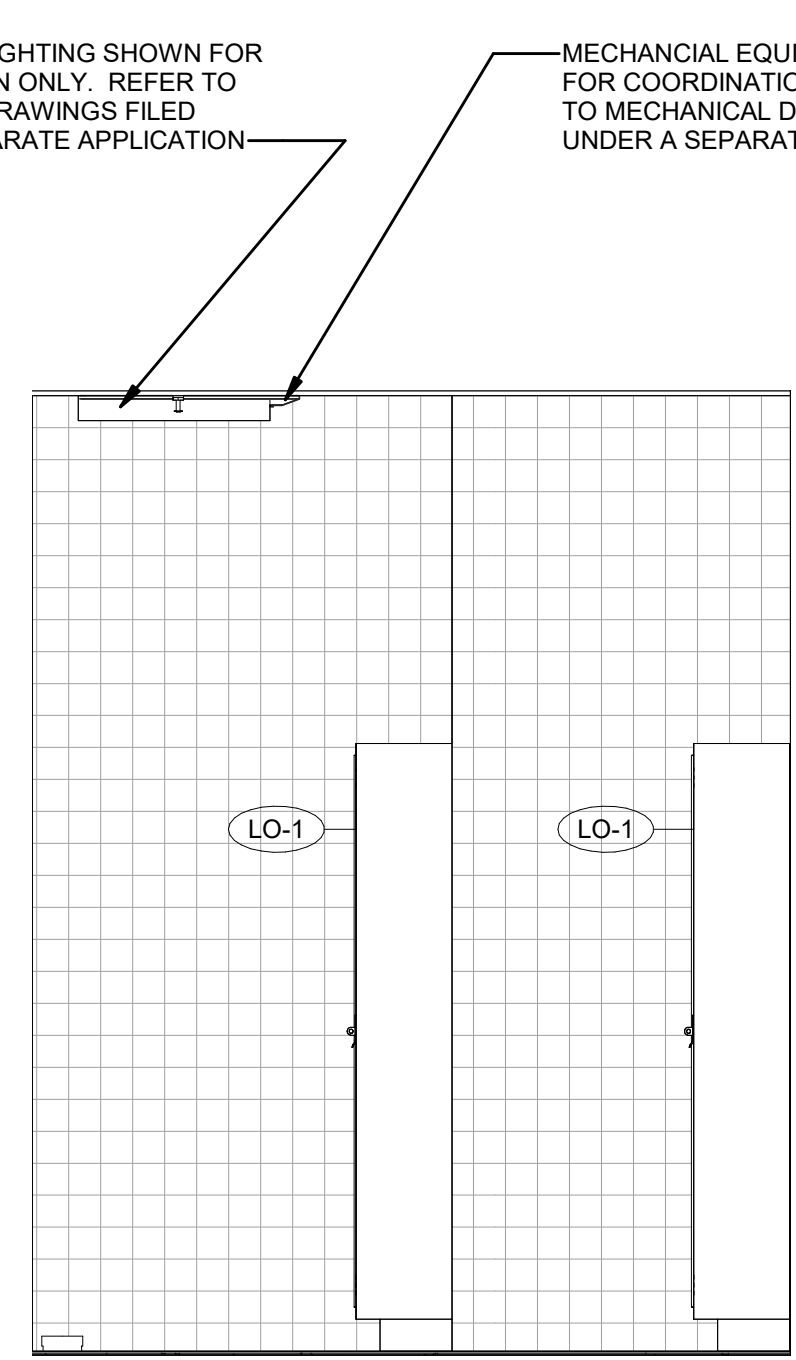

8 ELEVATION - LOCKER ROOM 2
A-403.00 1/2" = 1'-0"

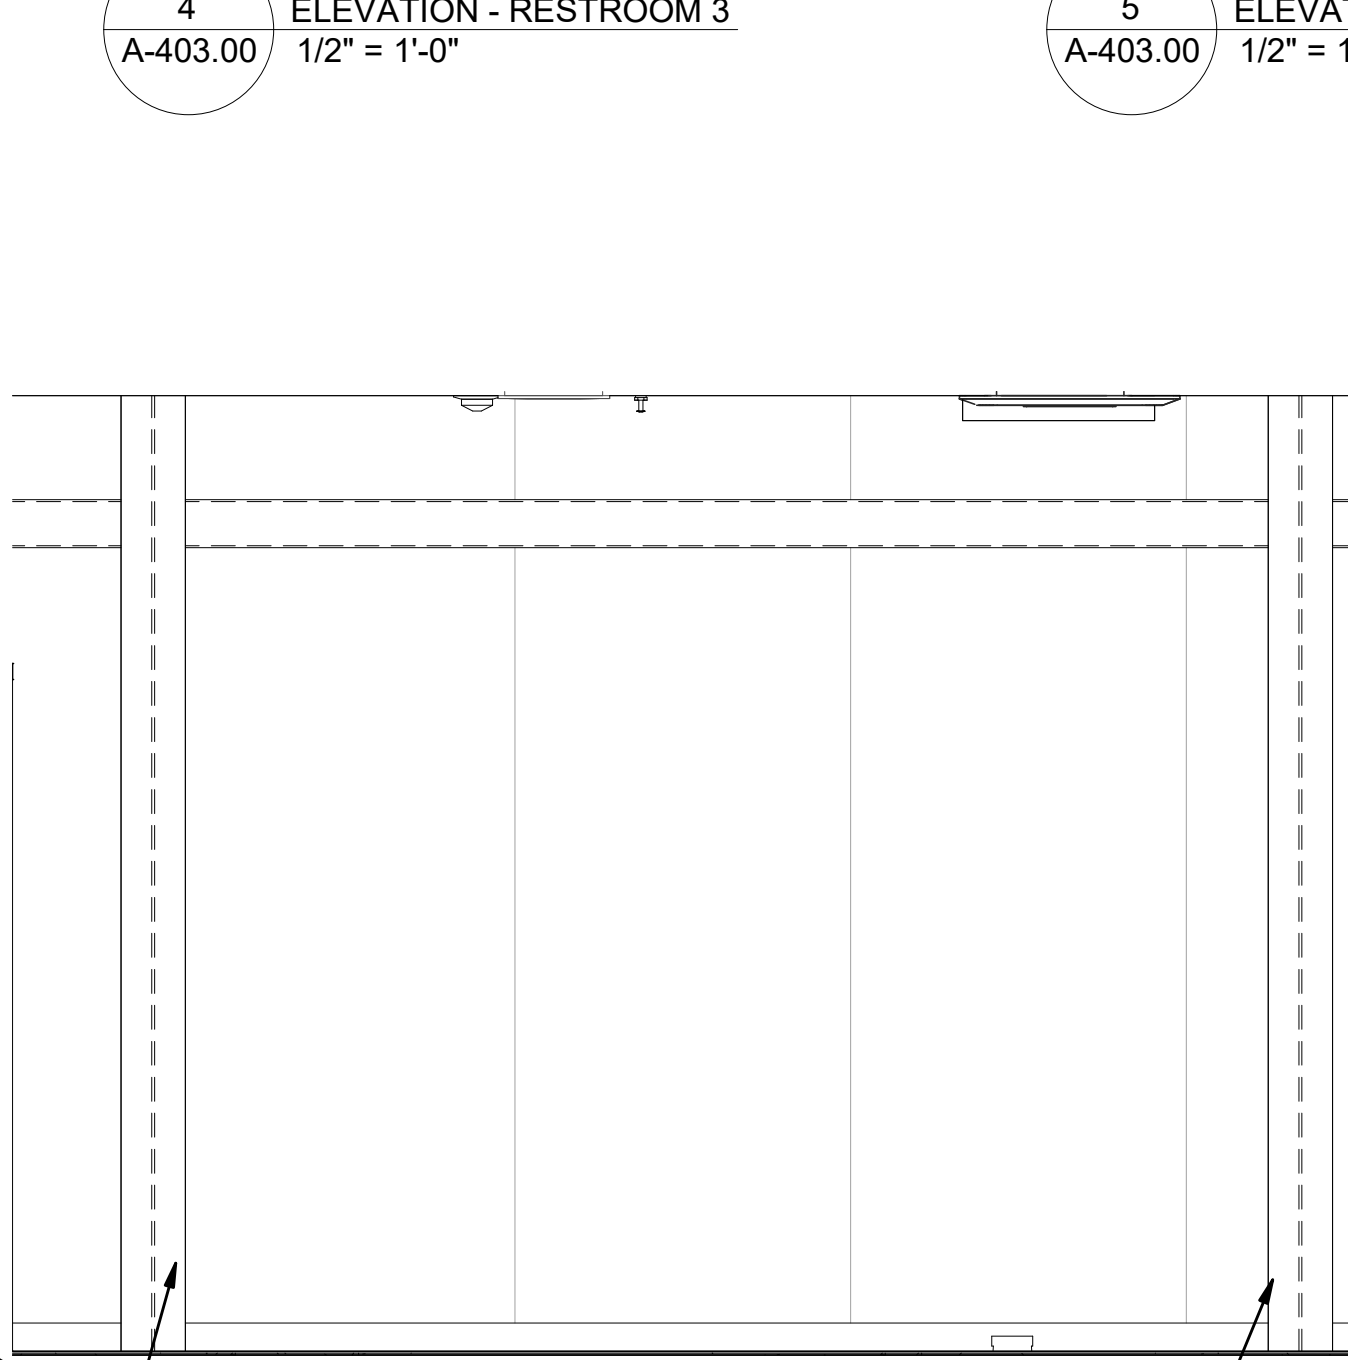


9 ELEVATION - LOCKER ROOM 1
A-403.00 1/2" = 1'-0"

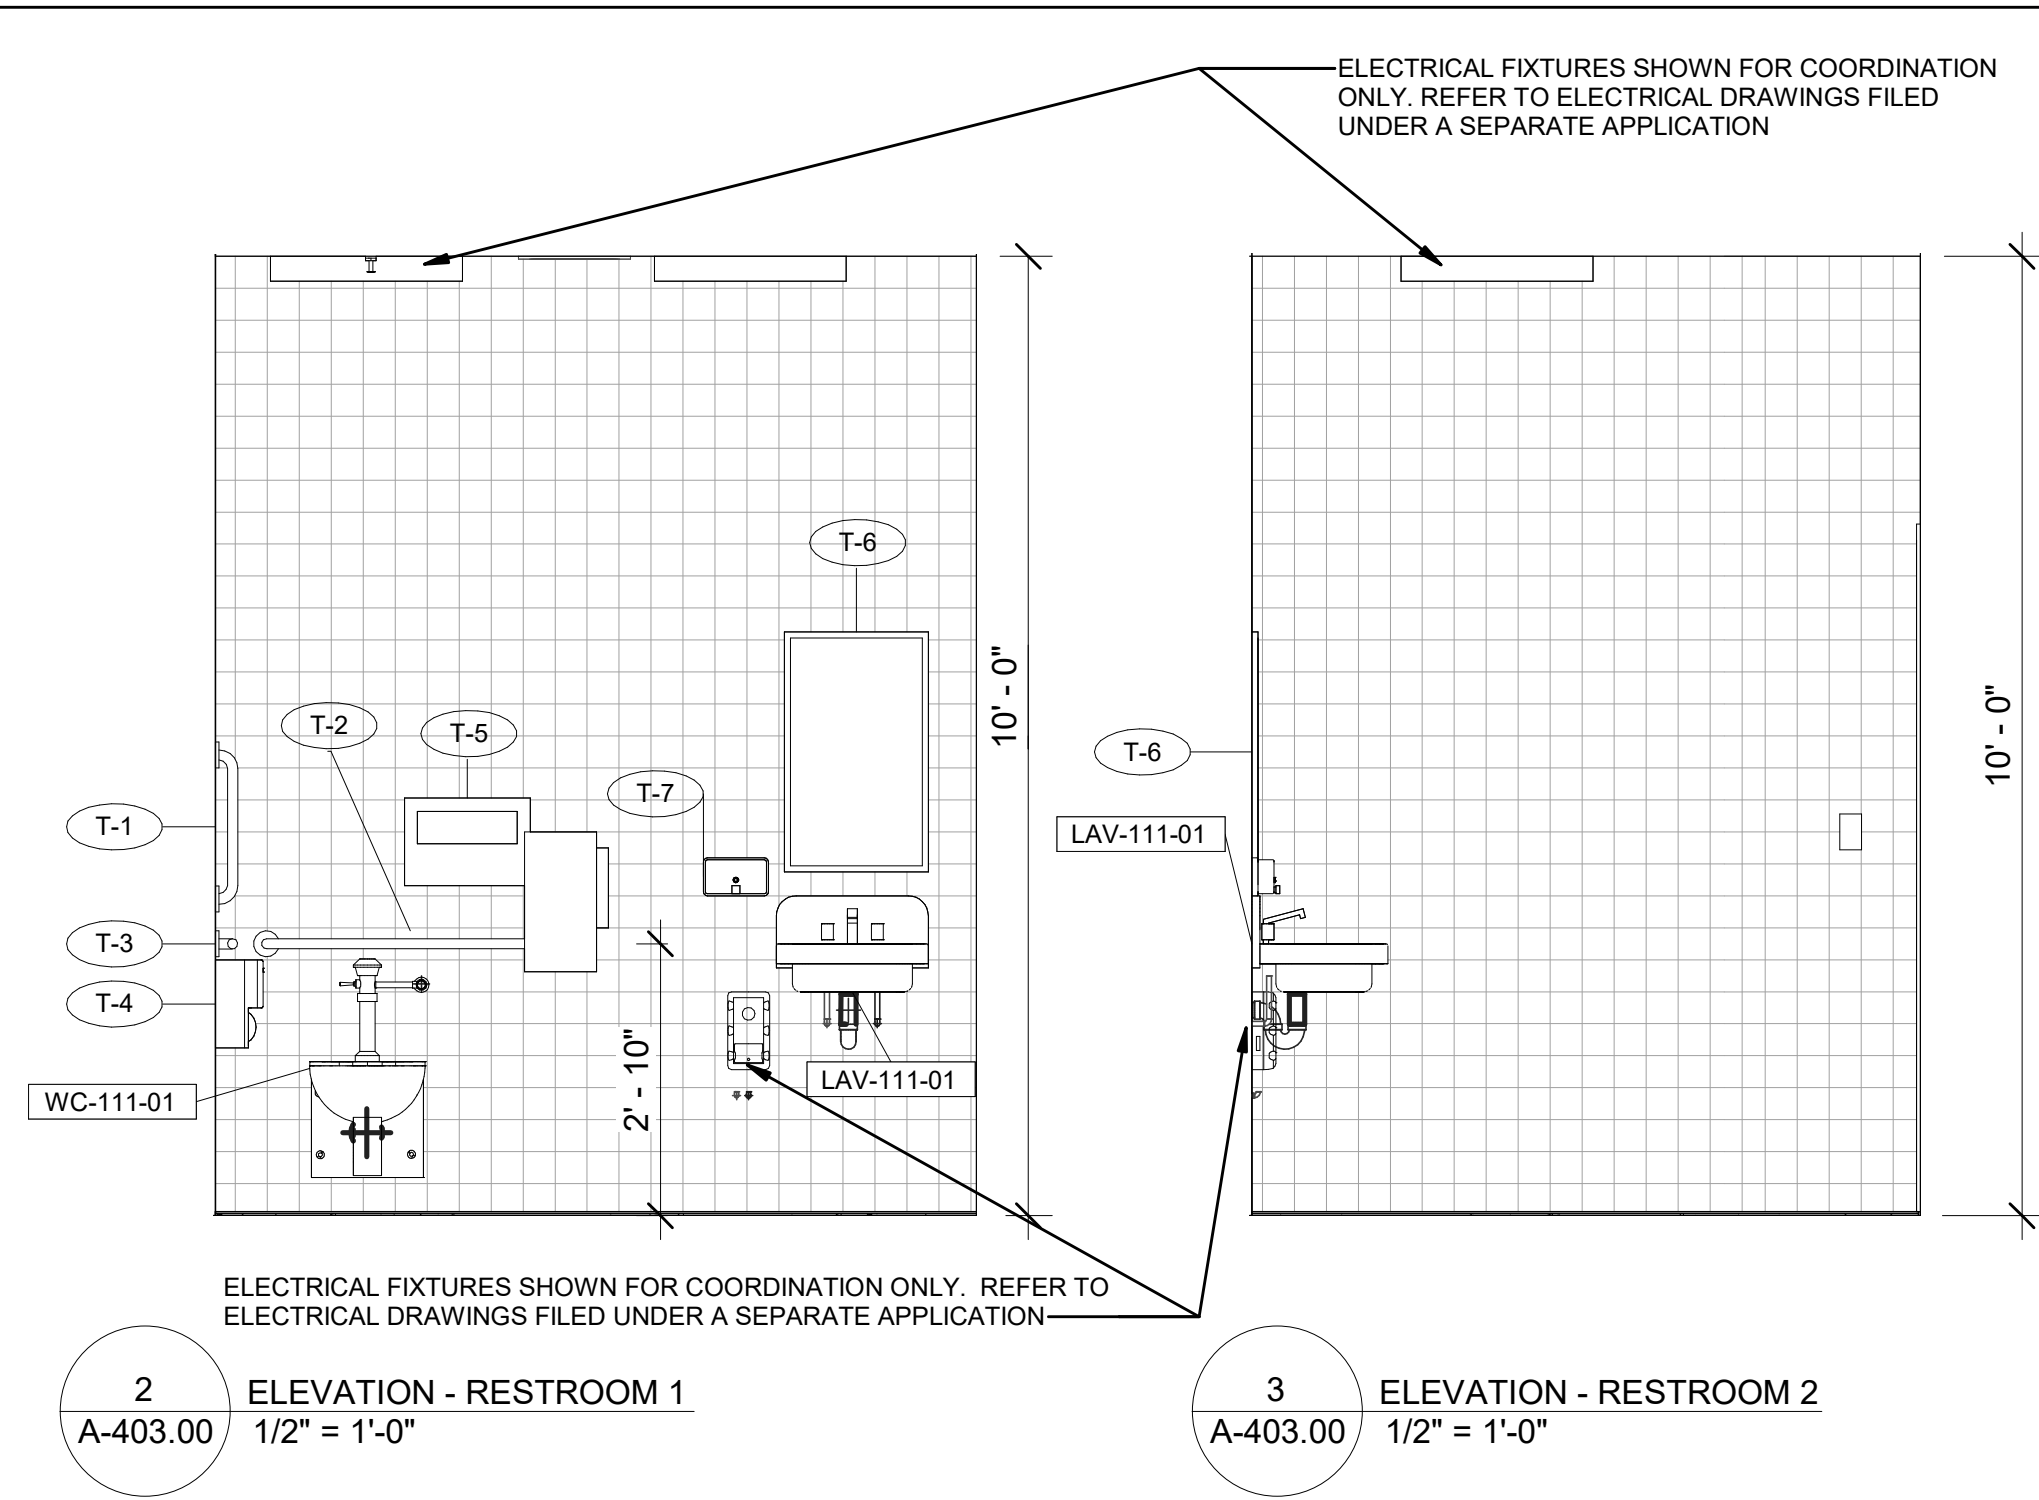


2 ELEVATION - RESTROOM 1
A-403.00 1/2" = 1'-0"

3 ELEVATION - RESTROOM 2
A-403.00 1/2" = 1'-0"

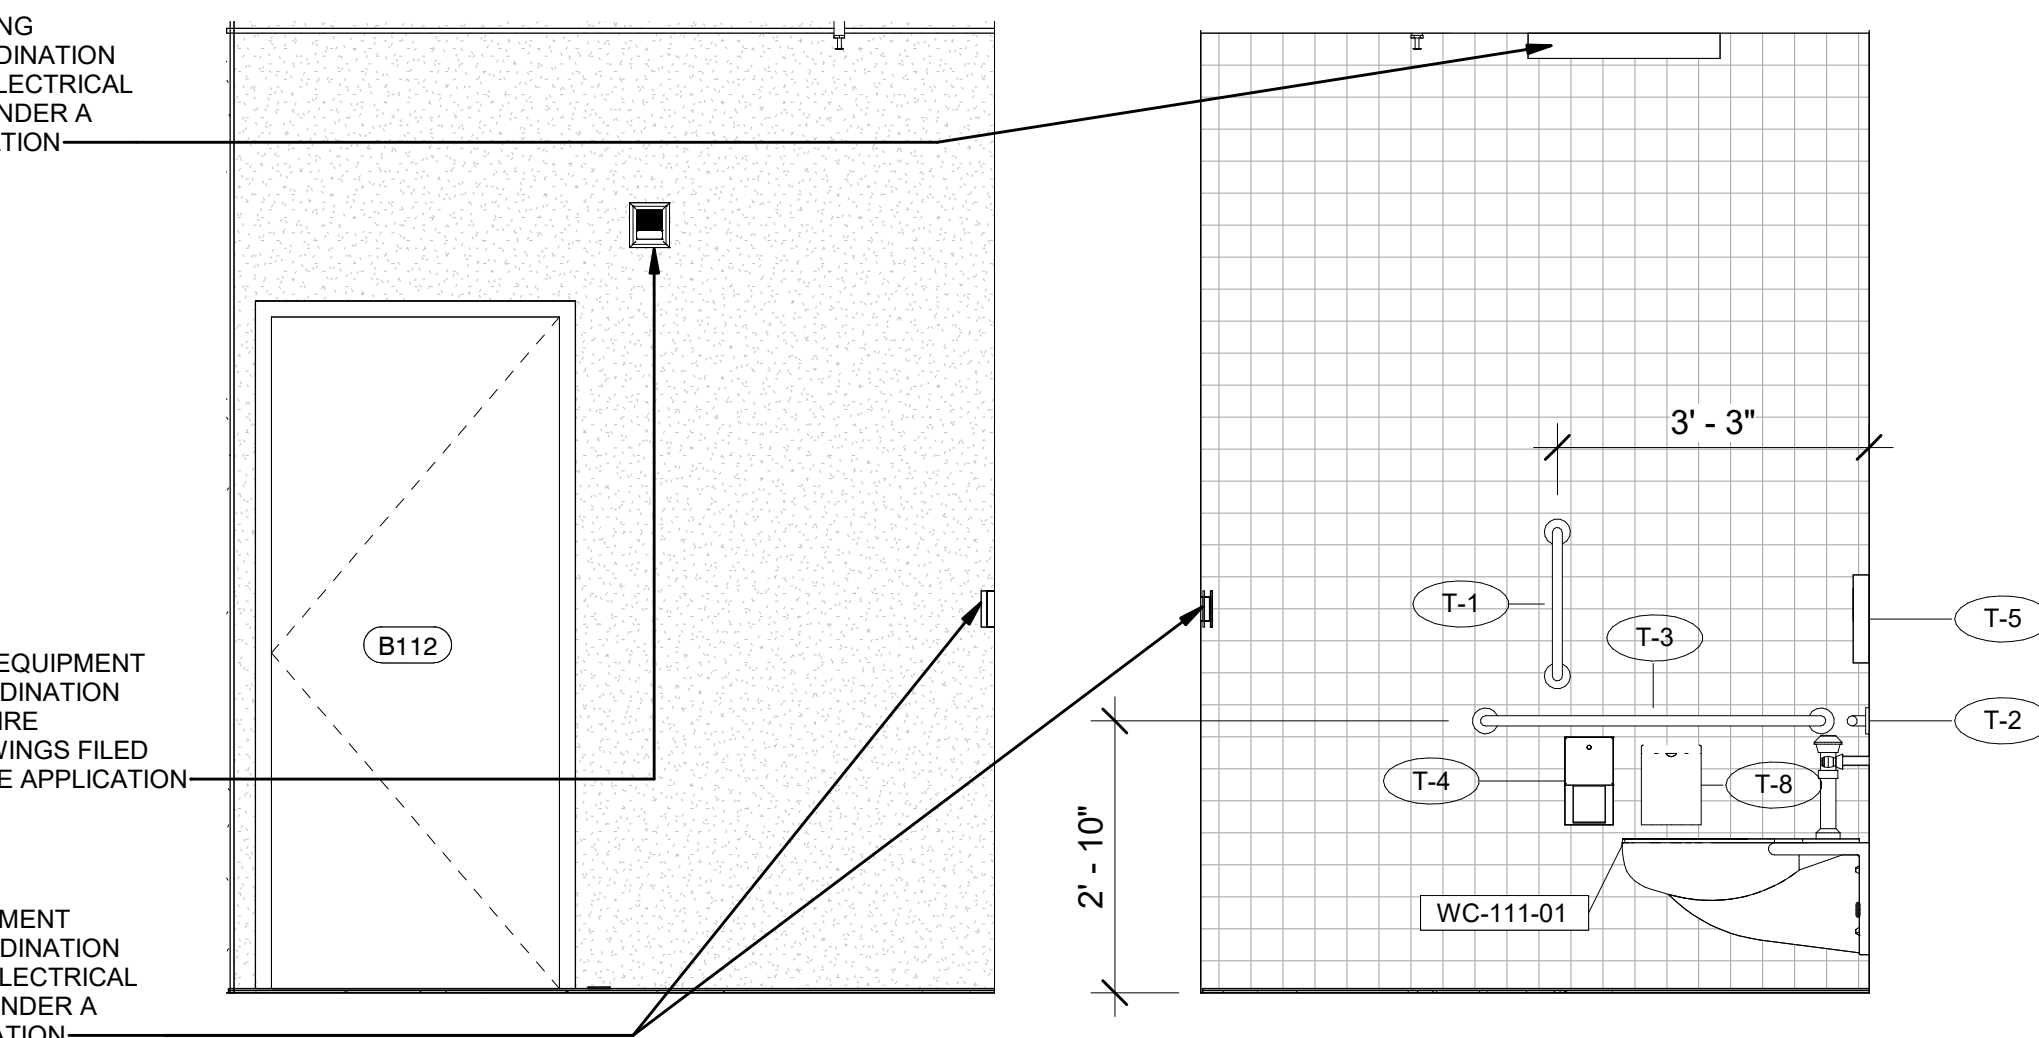

4 ELEVATION - RESTROOM 3
A-403.00 1/2" = 1'-0"

5 ELEVATION - RESTROOM 4
A-403.00 1/2" = 1'-0"

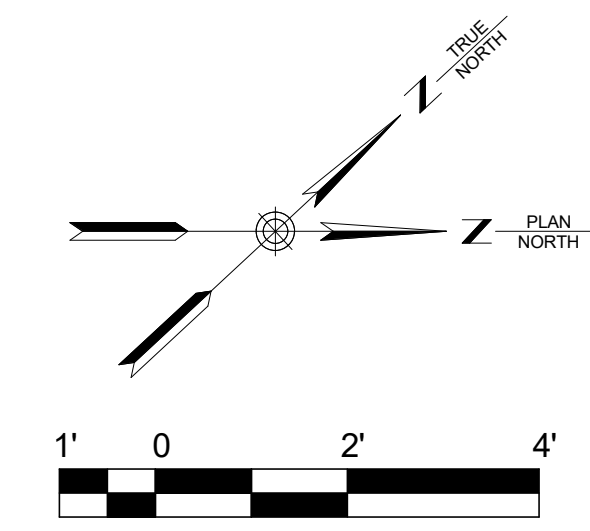

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Hitachi Energy

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PROJECT

CHPE
Champlain Hudson
Power Express

Astoria HVDC
Converter Station

31-45 20th Avenue, Astoria, Queens NY 11105
Block #850 - Lot #310 - BIN #4624437


ENLARGED TOILET ROOM
PLANS AND ELEVATIONS

REGISTERED ARCHITECT
SUZANNE SOWINSKI
STATE OF NEW YORK
026049

DATE 12/12/22
PROJECT NO 105121
DRAWING BY R. COLES
CHECKED BY Z. HARR
DRAWING NO
A-403.00
CADD FILE NO
Astoria-HVDC-CHPE
Astoria-CHV-KIE-111-ZZ-M3-A-001.rvt

12/8/2022 11:20:43 AM


12/8/2022 11:21:06 AM

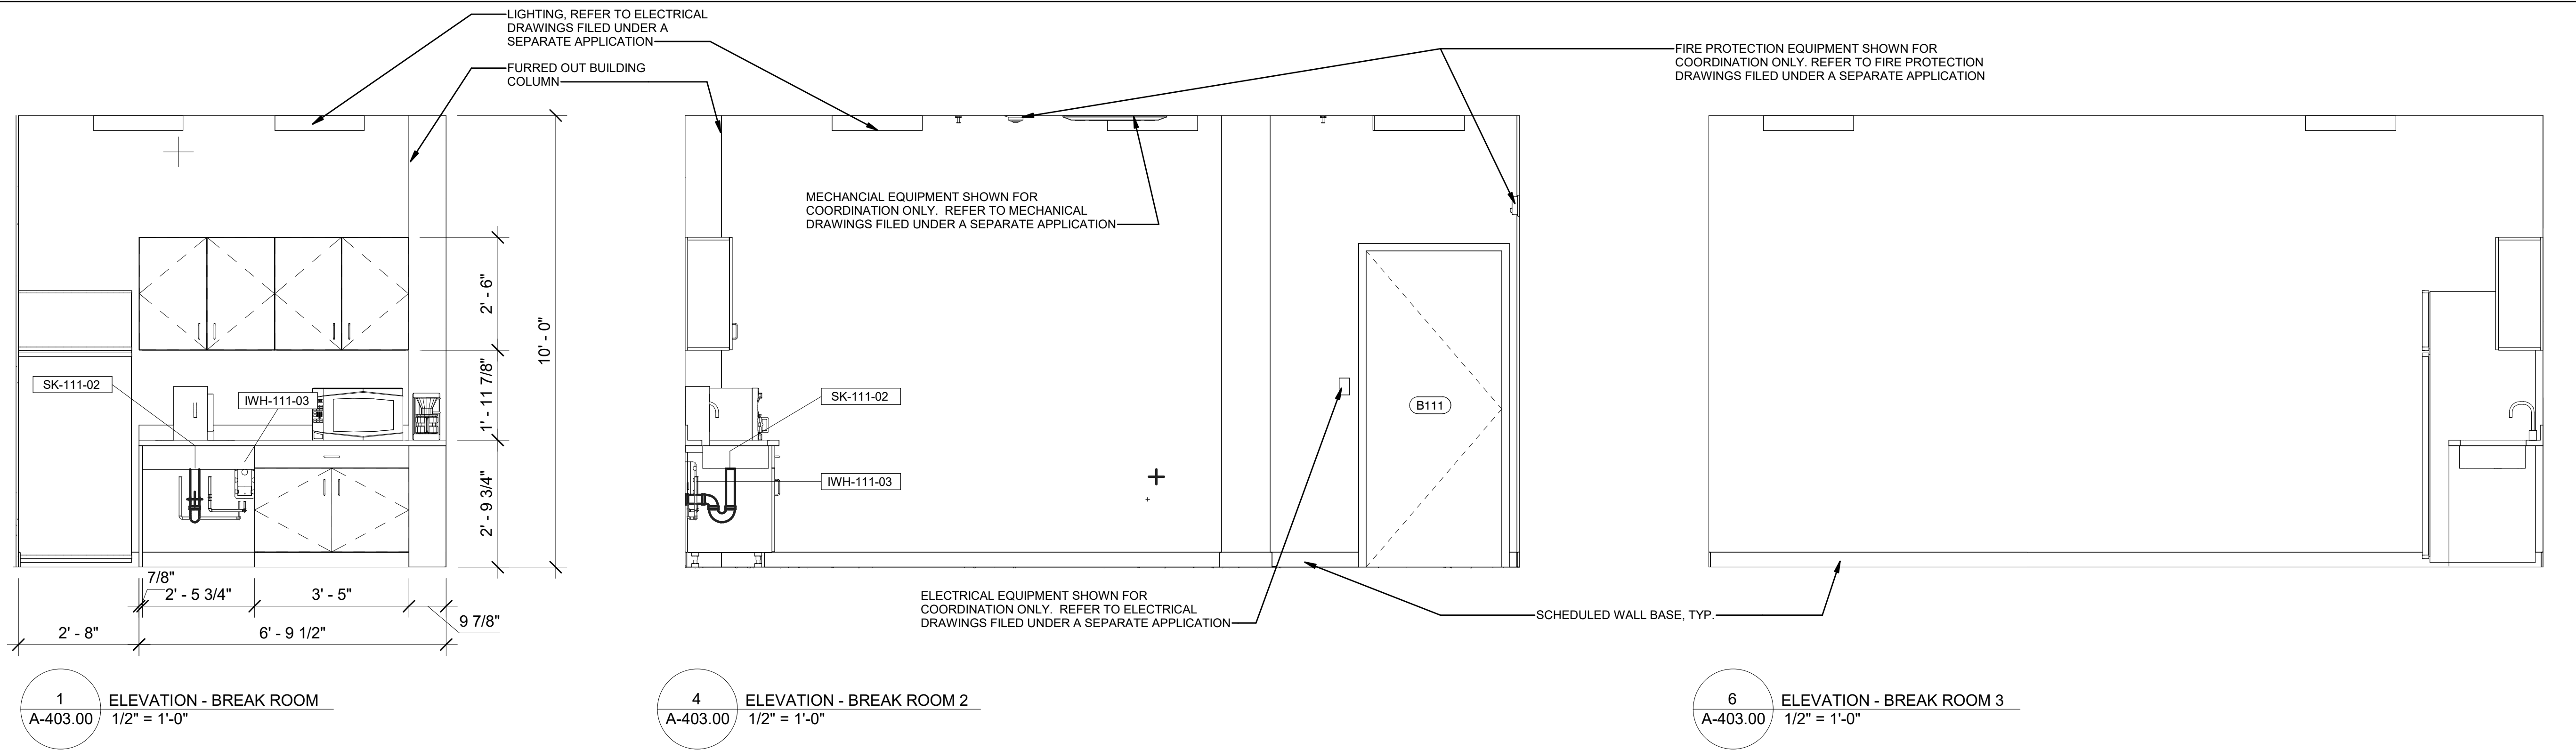

1 ELEVATION - BREAK ROOM
A-403.00 1/2" = 1'-0"

4 ELEVATION - BREAK ROOM 2
A-403.00 1/2" = 1'-0"

6 ELEVATION - BREAK ROOM 3
A-403.00 1/2" = 1'-0"

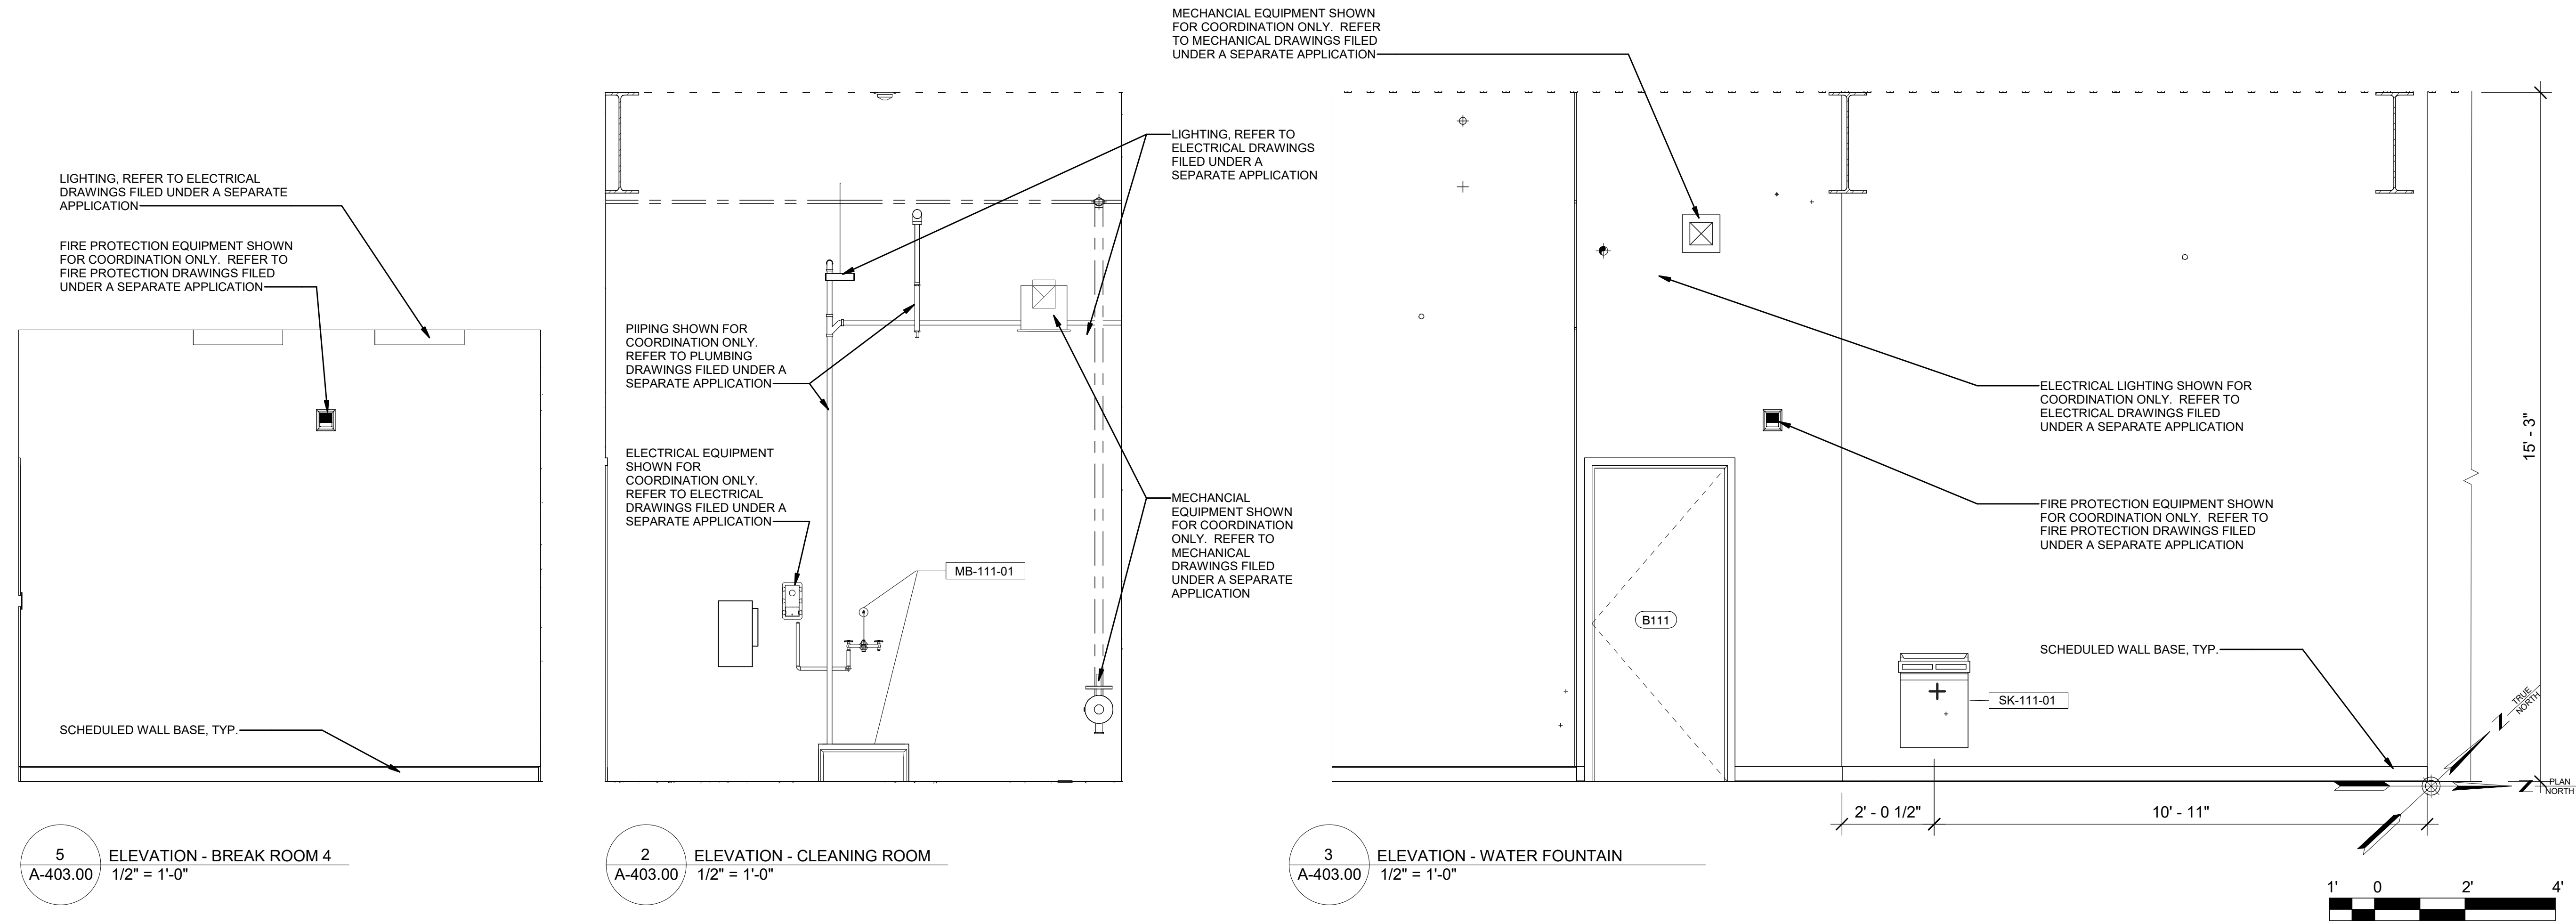

5 ELEVATION - BREAK ROOM 4
A-403.00 1/2" = 1'-0"

2 ELEVATION - CLEANING ROOM
A-403.00 1/2" = 1'-0"

3 ELEVATION - WATER FOUNTAIN
A-403.00 1/2" = 1'-0"

| TOILET ACCESSORIES SCHEDULE | | | | |
|-----------------------------|--------------------------|----------|-------------|----------------|
| TAG | DESCRIPTION | HEIGHT | WIDTH | SPECIFICATIONS |
| LO-1 | LOCKERS | 6" - 0" | 1' - 3" | 105100 |
| T-1 | 18" LONG GRAB BAR | | | 102800 |
| T-2 | 36" GRAB BAR | | | 102800 |
| T-3 | 42" LONG GRAB BAR | | | 102800 |
| T-4 | TOILET TISSUE DISPENSER | 0' - 11" | 0' - 6" | 102800 |
| T-5 | SEAT COVER DISPENSER | 0' - 11" | 1' - 4" | 102800 |
| T-6 | TEMPERED GLASS MIRROR | 2' - 6" | 1' - 6" | 102800 |
| T-7 | SOAP DISPENSER | 0' - 5" | 0' - 8" | 102800 |
| T-8 | SANITARY NAPKIN DISPOSAL | 0' - 10" | 0' - 7 1/2" | 102800 |

| PLUMBING TAG SCHEDULE - SEE PLUMBING DRAWINGS | |
|---|--|
| PLUMBING TAG | DESCRIPTION |
| EEW-111-01 | EYEWASH, SEE SPECIFICATIONS |
| LAV-111-01 | LAVATORY, SEE PLUMBING DWGS. & SPECS |
| MB-111-01 | MOP SERVICE BASIN, SEE PLUMBING DWGS. & SPECS |
| SK-111-01 | WATER FOUNTAIN, BARRIER FREE, SEE PLUMBING DWGS. & SPECS |
| SK-111-02 | UNDERMOUNT SINK, SEE PLUMBING DRAWINGS & SPECS |
| WC-111-01 | WATER CLOSET, SEE PLUMBING DWGS. & SPECS |

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Hitachi Energy

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Raleigh, North Carolina 27606

PROJECT

CHPE


Champlain Hudson
Power Express

Astoria HVDC
Converter Station

31-45 20th Avenue, Astoria, Queens NY 11105
Block #850 - Lot #310 - BIN #4624437

ENLARGED TOILET ROOM
PLANS AND ELEVATIONS


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| DATE | 12/12/22 |
| PROJECT NO | 105121 |
| DRAWING BY | R. COLES |
| CHECKED BY | Z. HARR |
| DRAWING NO | A-404.00 |
| CADD FILE NO | AstoriaHVDC-CHPE |
| AstoriaHVDC-CHPE | AstoriaHVDC-CHPE-111-ZZ-M3-A-001.rvt |

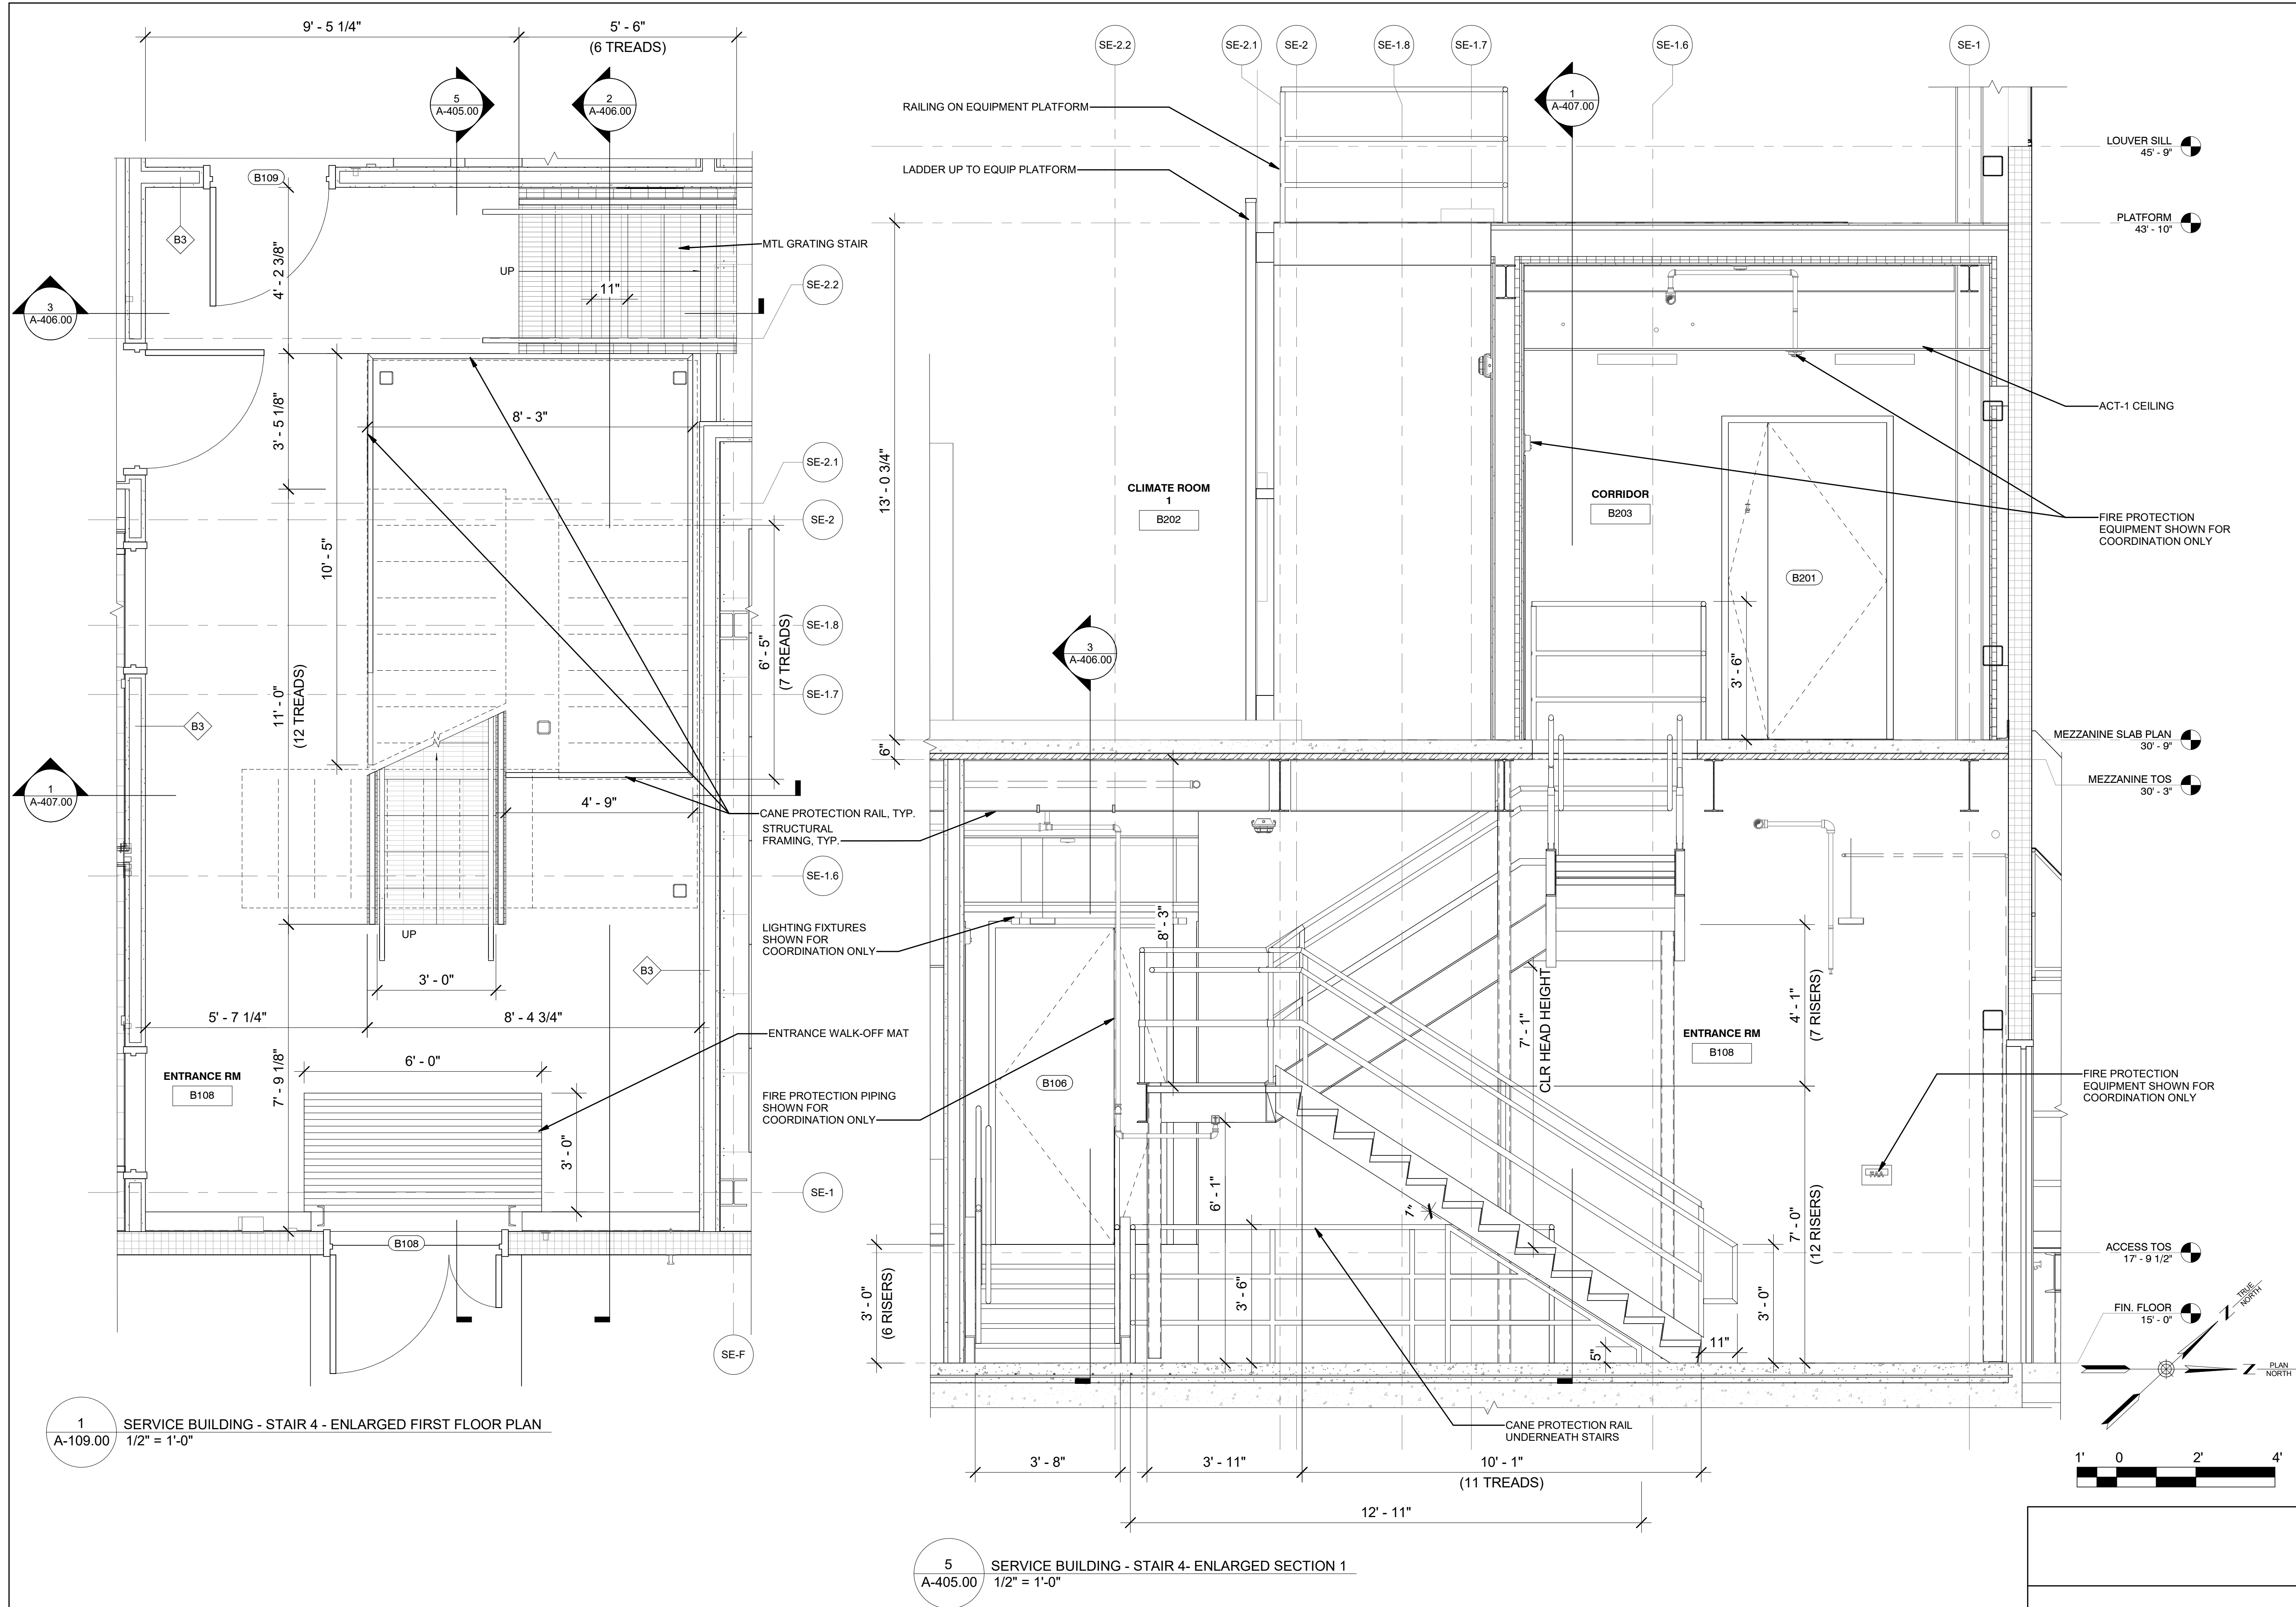

1 SERVICE BUILDING - STAIR 4 - ENLARGED FIRST FLOOR PLAN
1/2" = 1'-0"

5 SERVICE BUILDING - STAIR 4- ENLARGED SECTION 1
1/2" = 1'-0"

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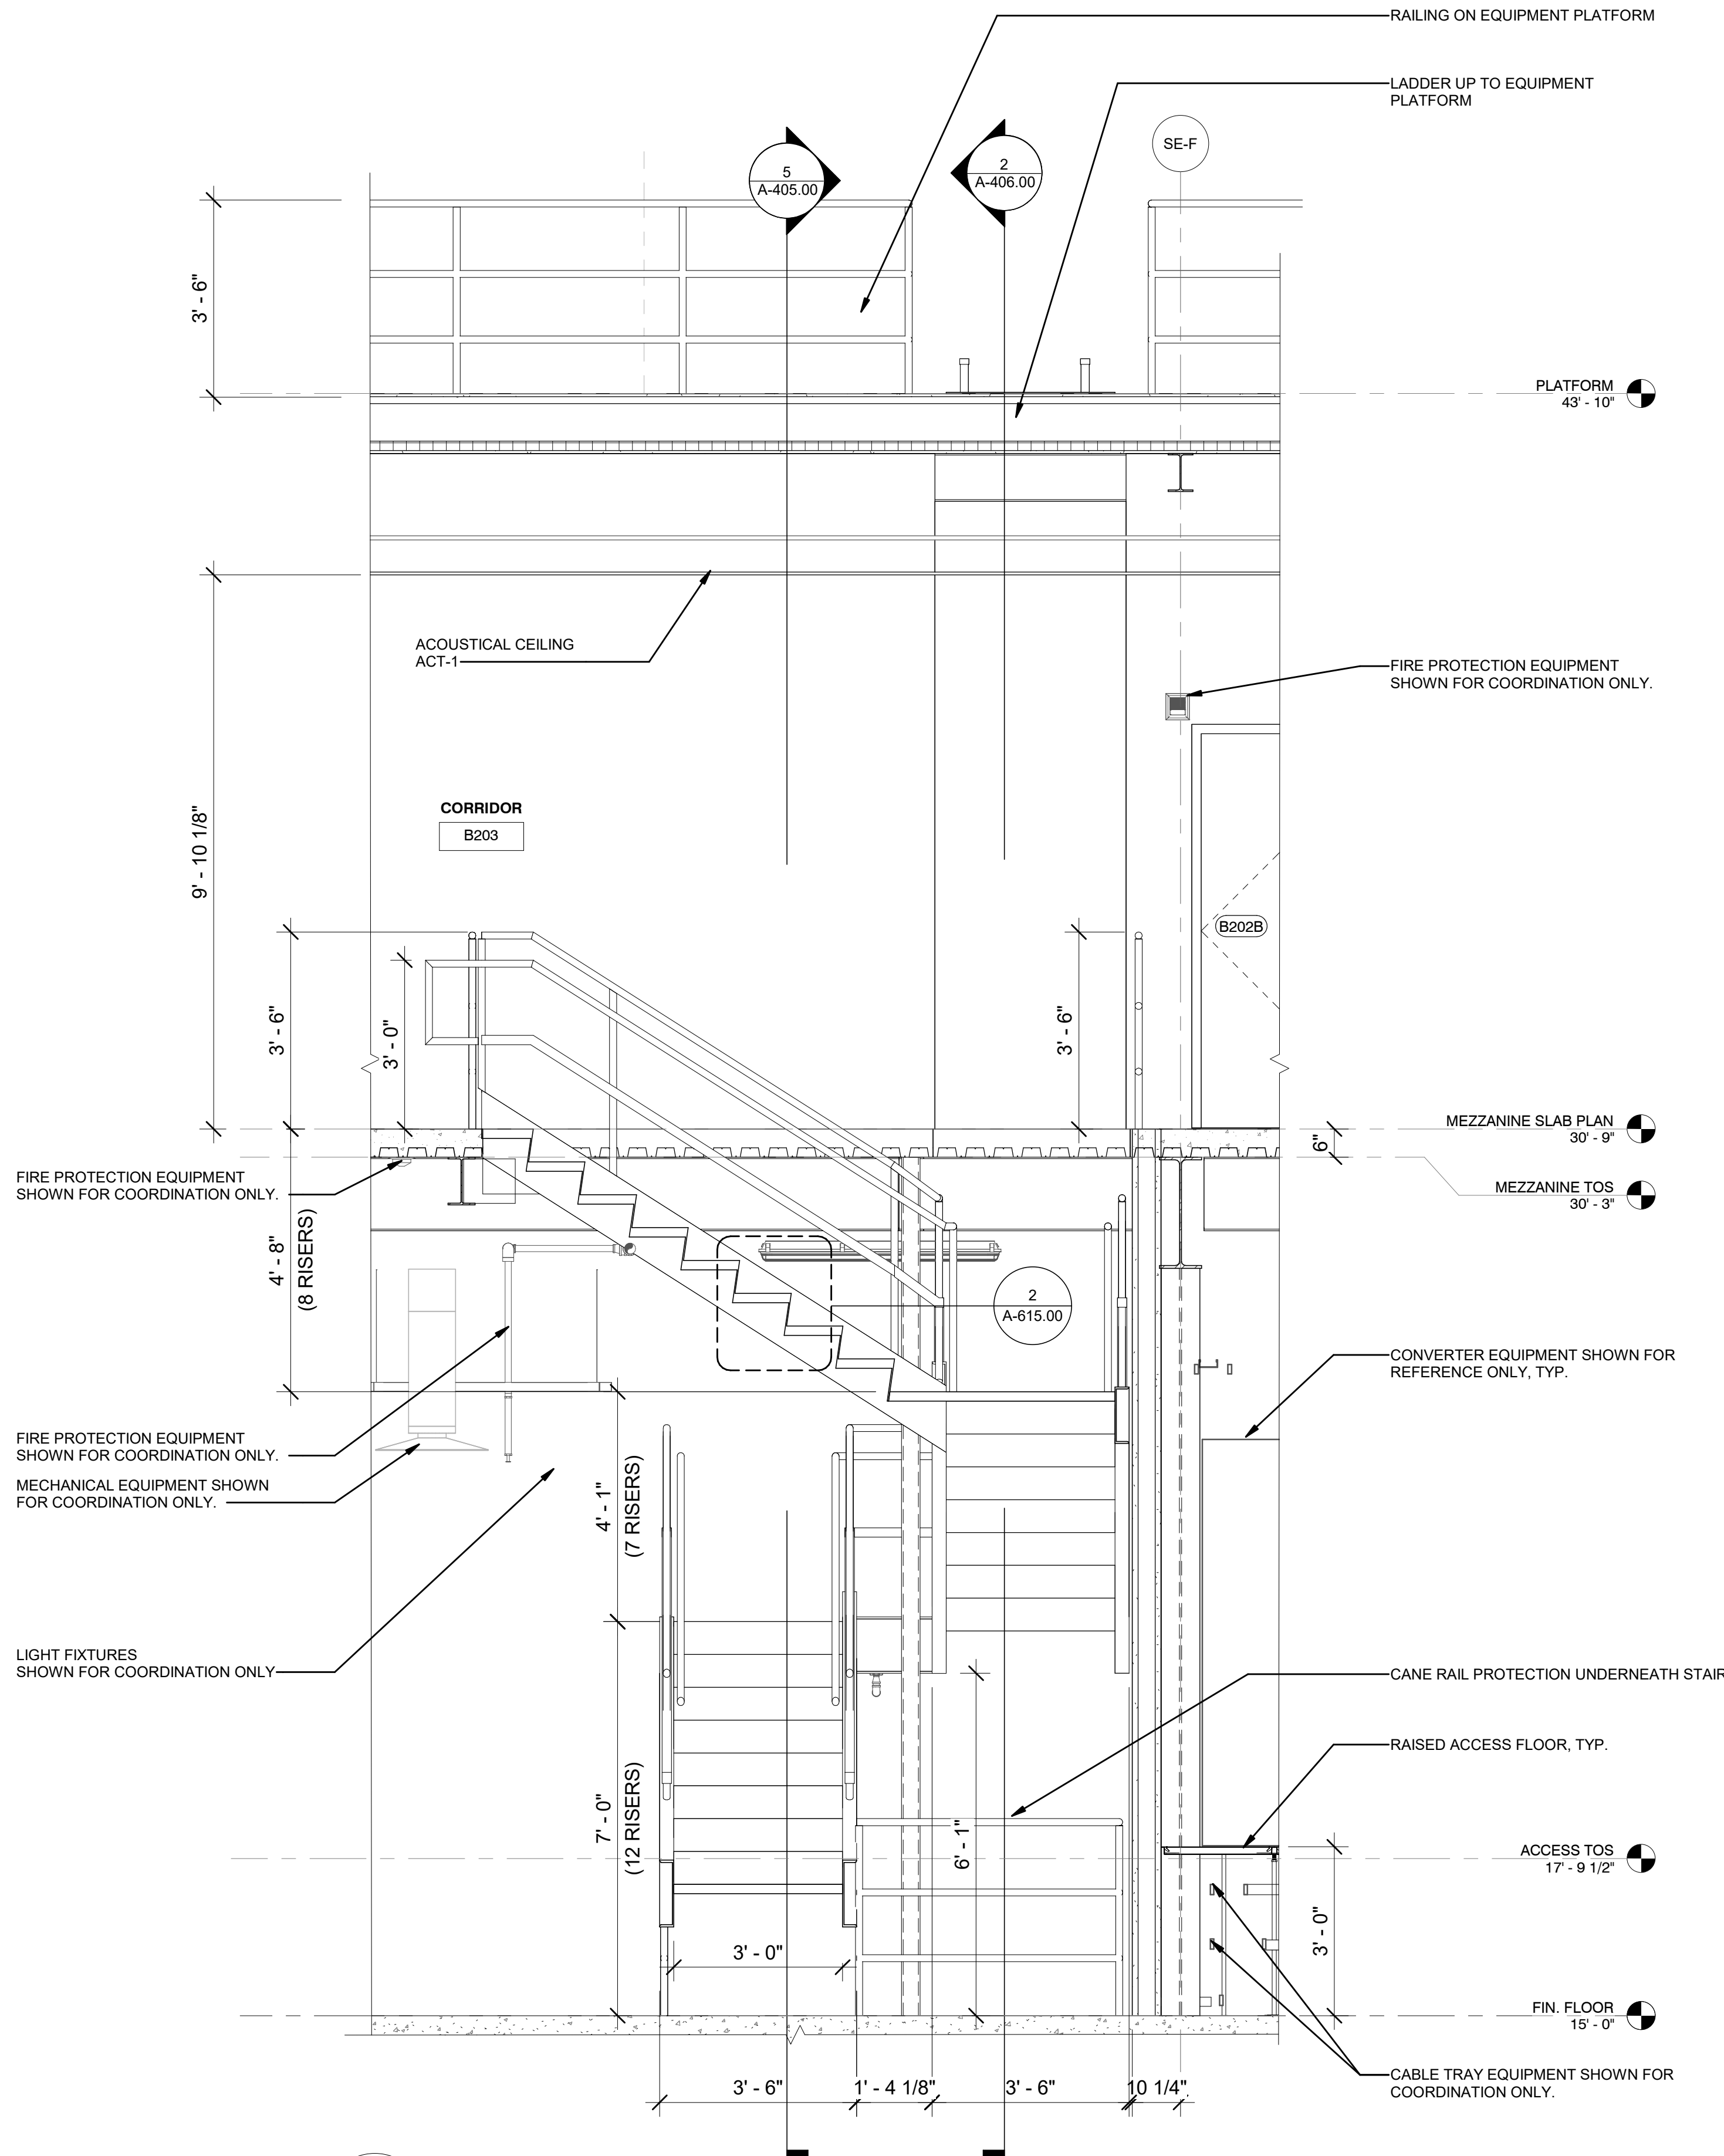
**Astoria HVDC
Converter Station**

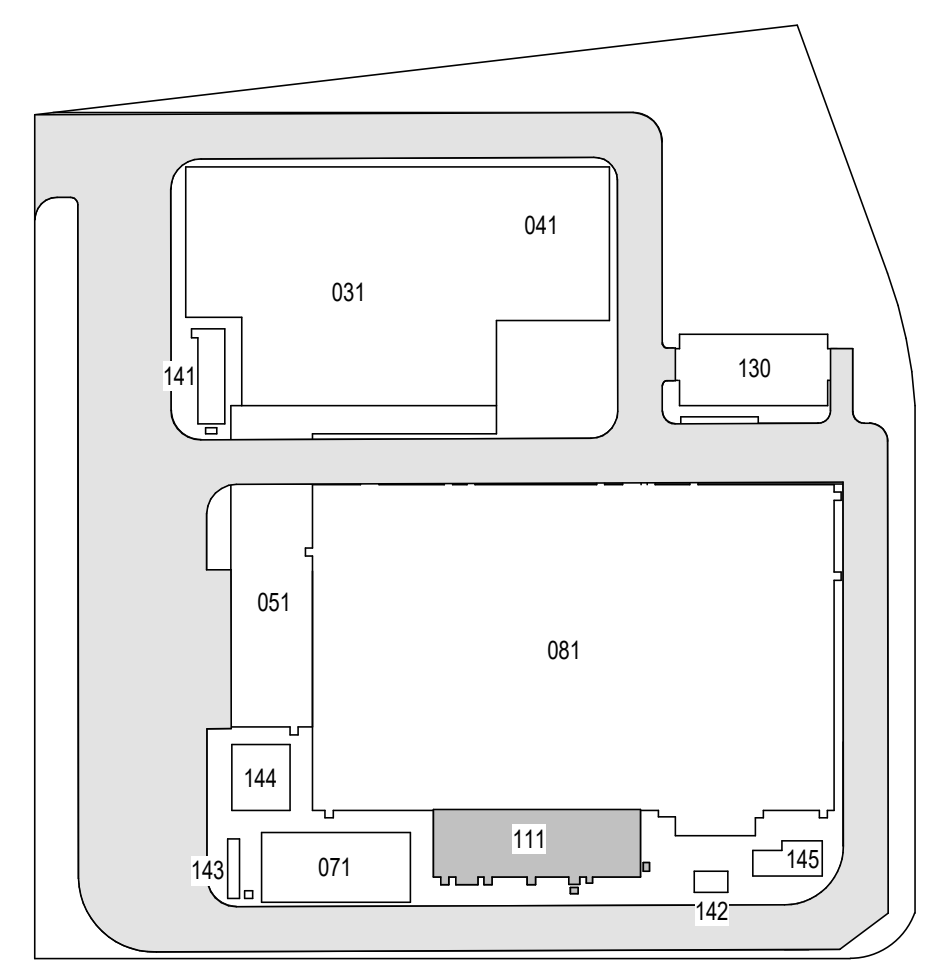31-45 20th Avenue, Astoria, Queens NY 11105
Block #850 - Lot #310 - BIN #4624437

**ENLARGED STAIR PLANS
AND SECTIONS 1**




DATE 12/12/22
PROJECT NO 105121
DRAWING BY R. COLES
CHECKED BY Z. HARR
DRAWING NO
A-405.00
CADD FILE NO
Astoria-HVDC-CHPE
Astoria-CHPE-111-ZZ-M3-A-001.rvt




1
A-405.00

SERVICE BUILDING - STAIR 4 - ENLARGED SECTION 3
1/2" = 1'-0"

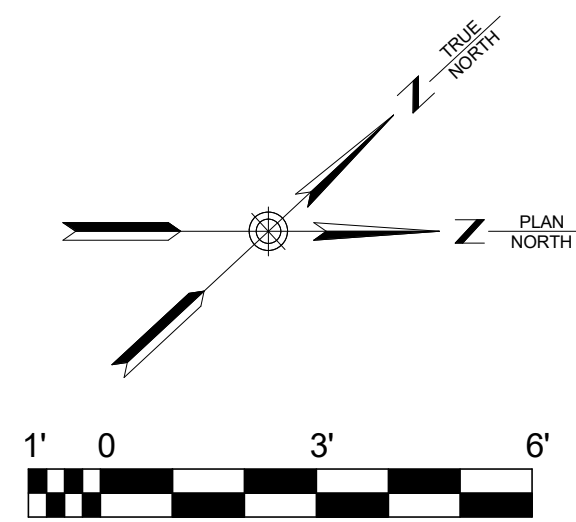

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**ENLARGED STAIR PLANS
AND SECTIONS 3**

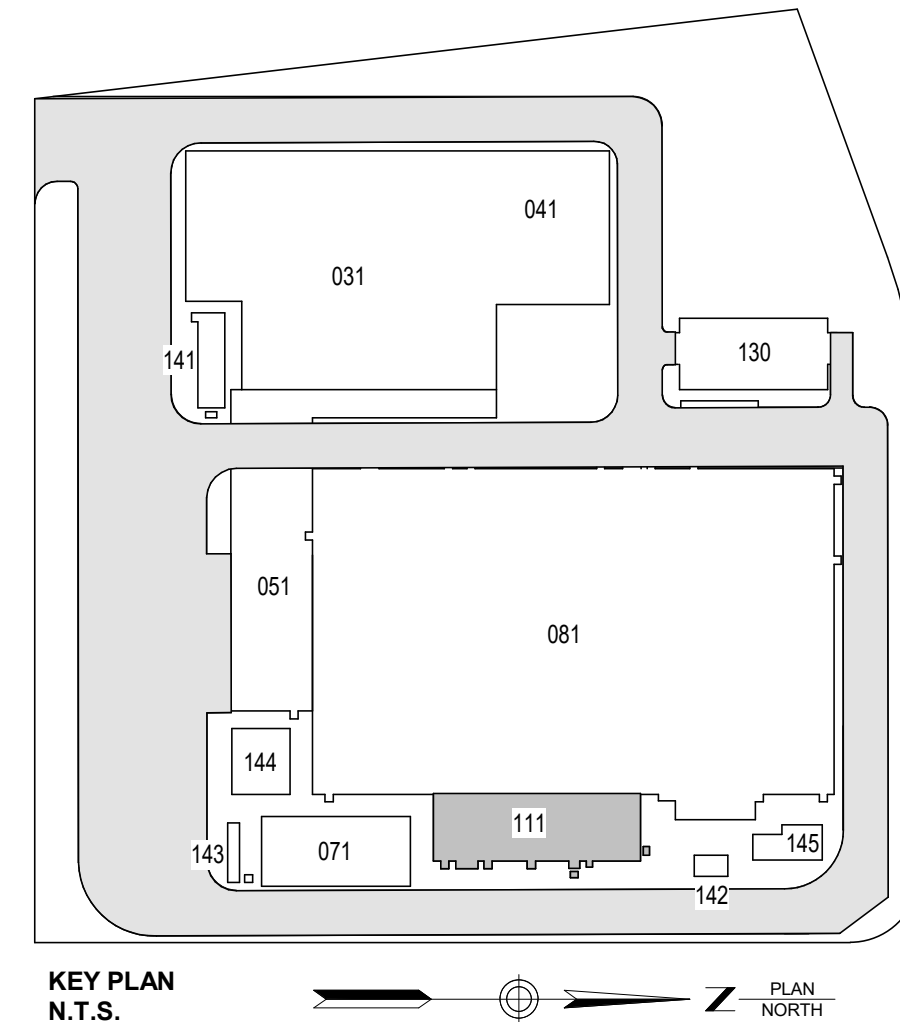

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Astoria-CHA-KIE-111-ZZ-M3-A-001.rvt

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Astoria HVDC Converter Station

31-45 20th Avenue, Astoria, Queens NY 11105
Block #850 - Lot #310 - BIN #4624437

ENLARGED ACCESS FLOOR PLANS



| | |
|------------|----------|
| DATE | 12/12/22 |
| PROJECT NO | 105121 |
| DRAWING BY | Author |
| CHECKED BY | Designer |
| DRAWING NO | |

A-409.00

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| CADD FILE NO Autodesk Docs:\CHPE Astoria\CHA-KIE-111-ZZ-M3-A-001.rvt | |
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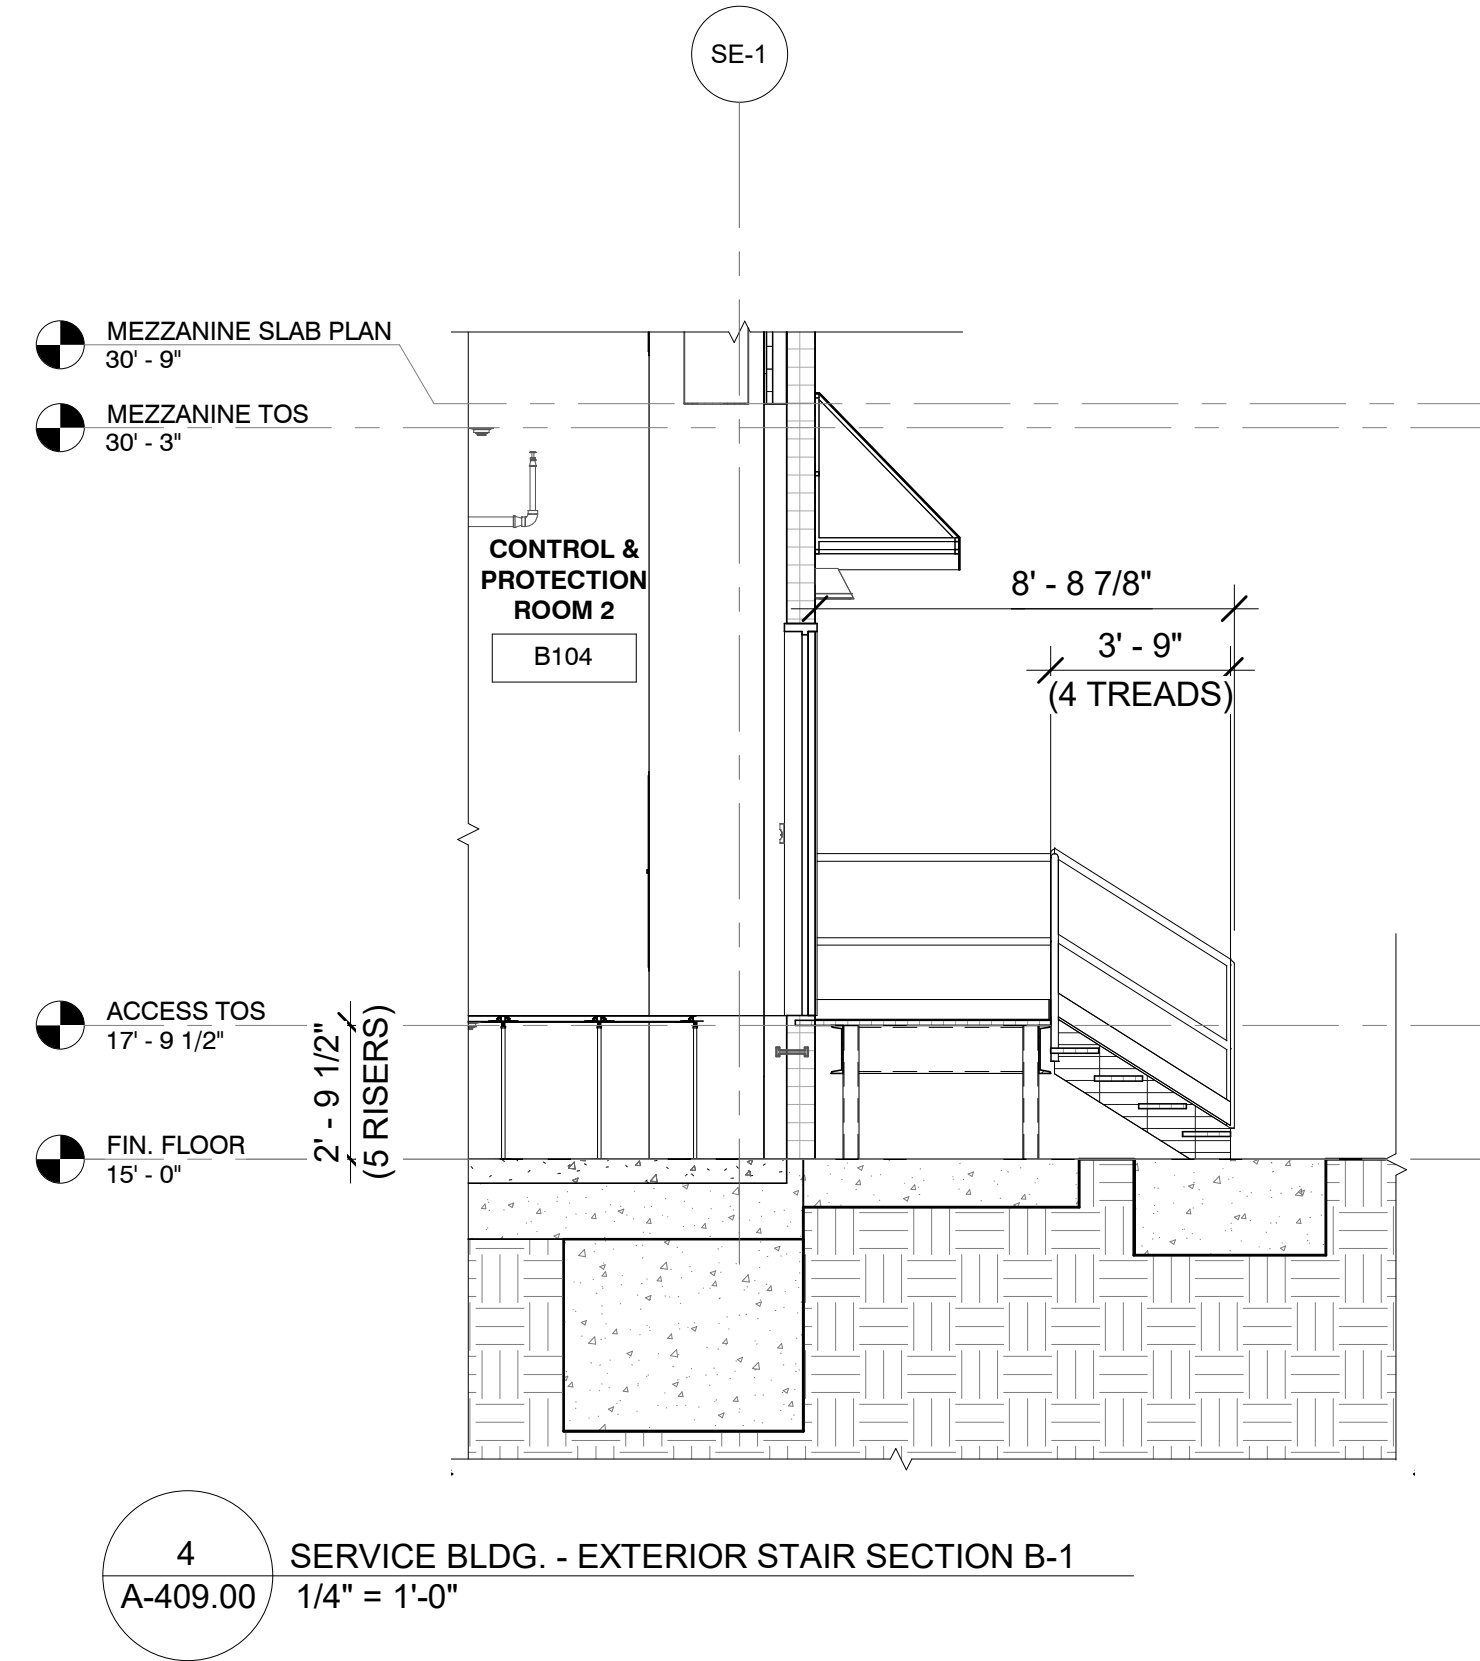
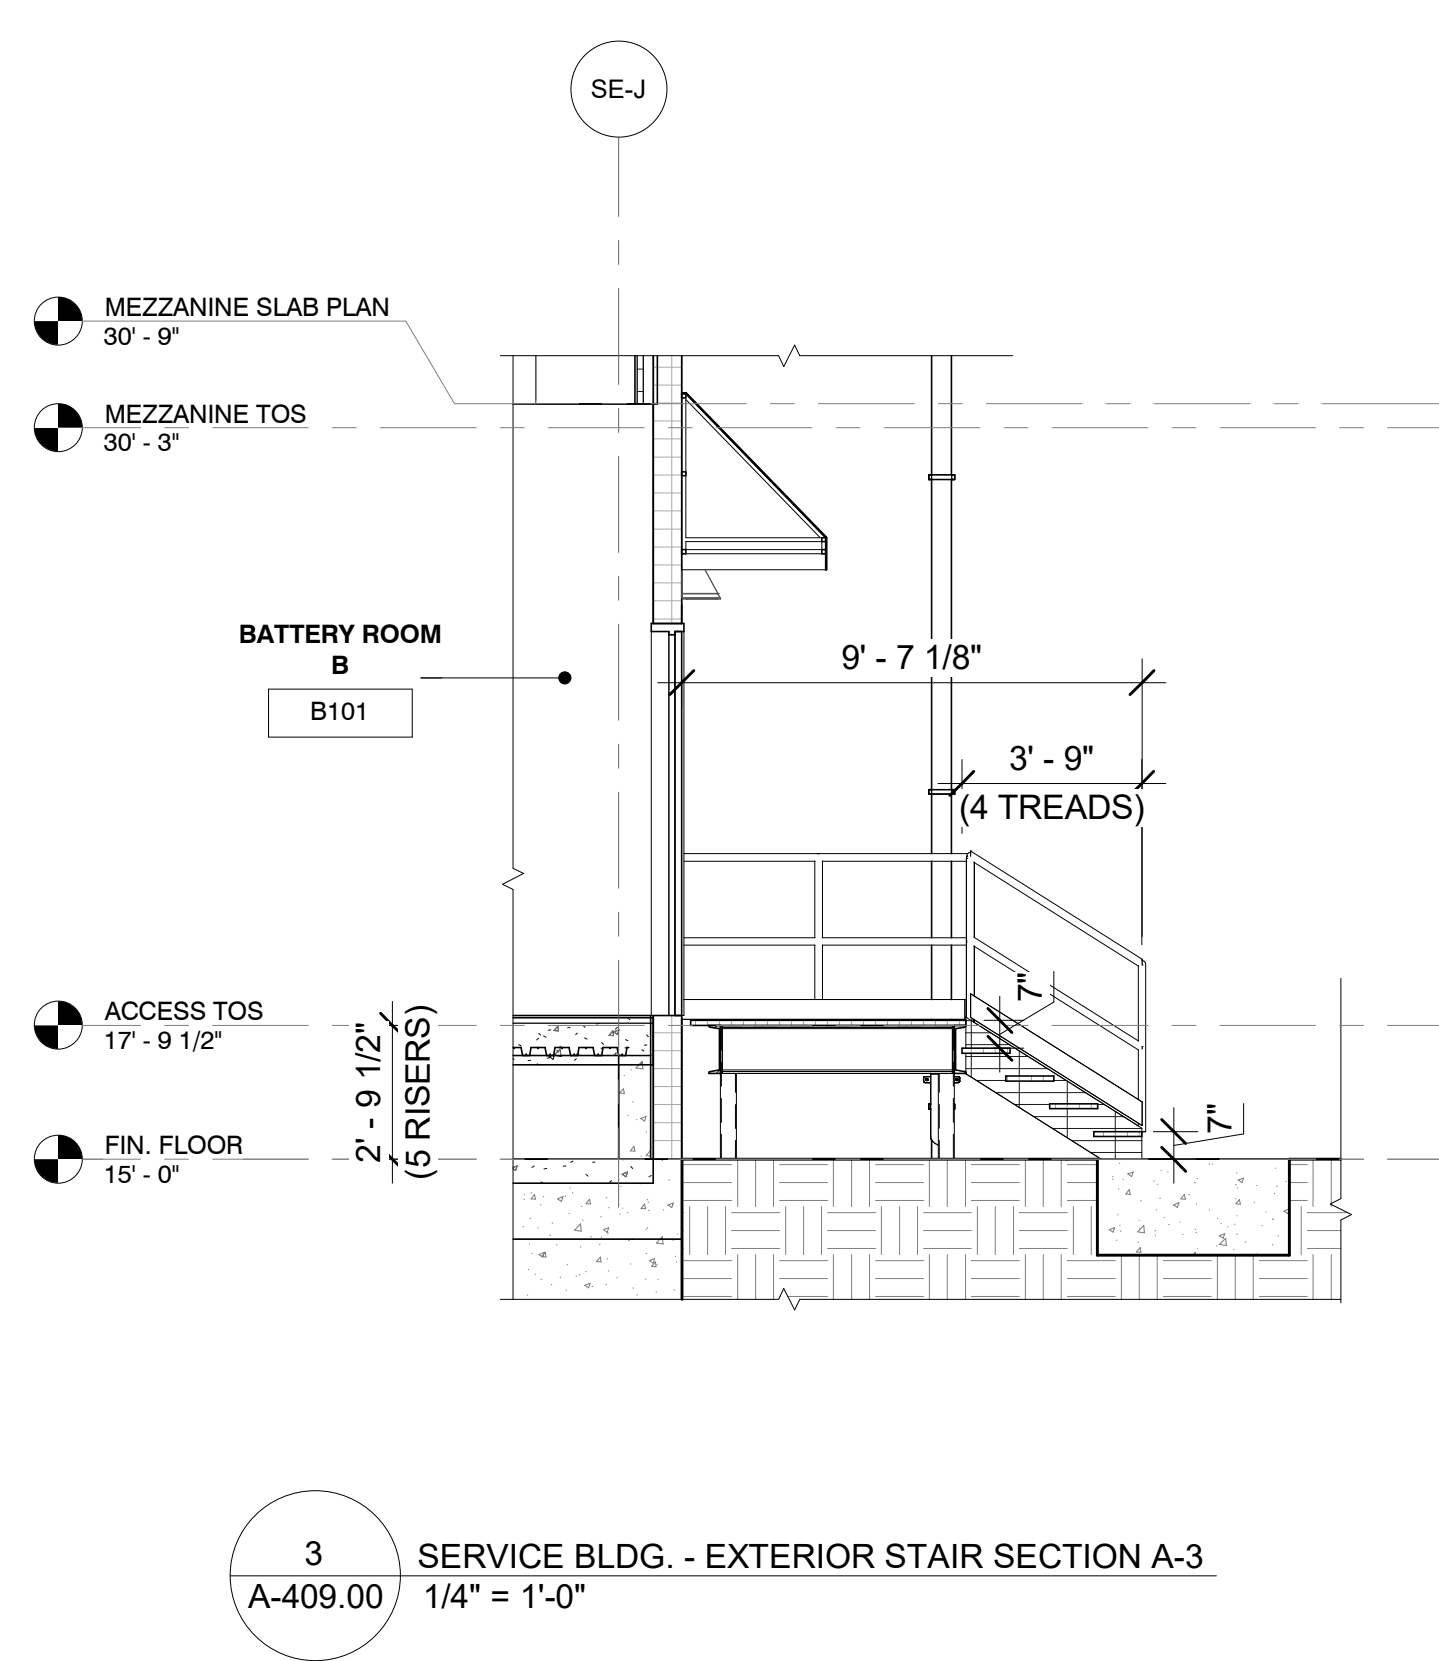
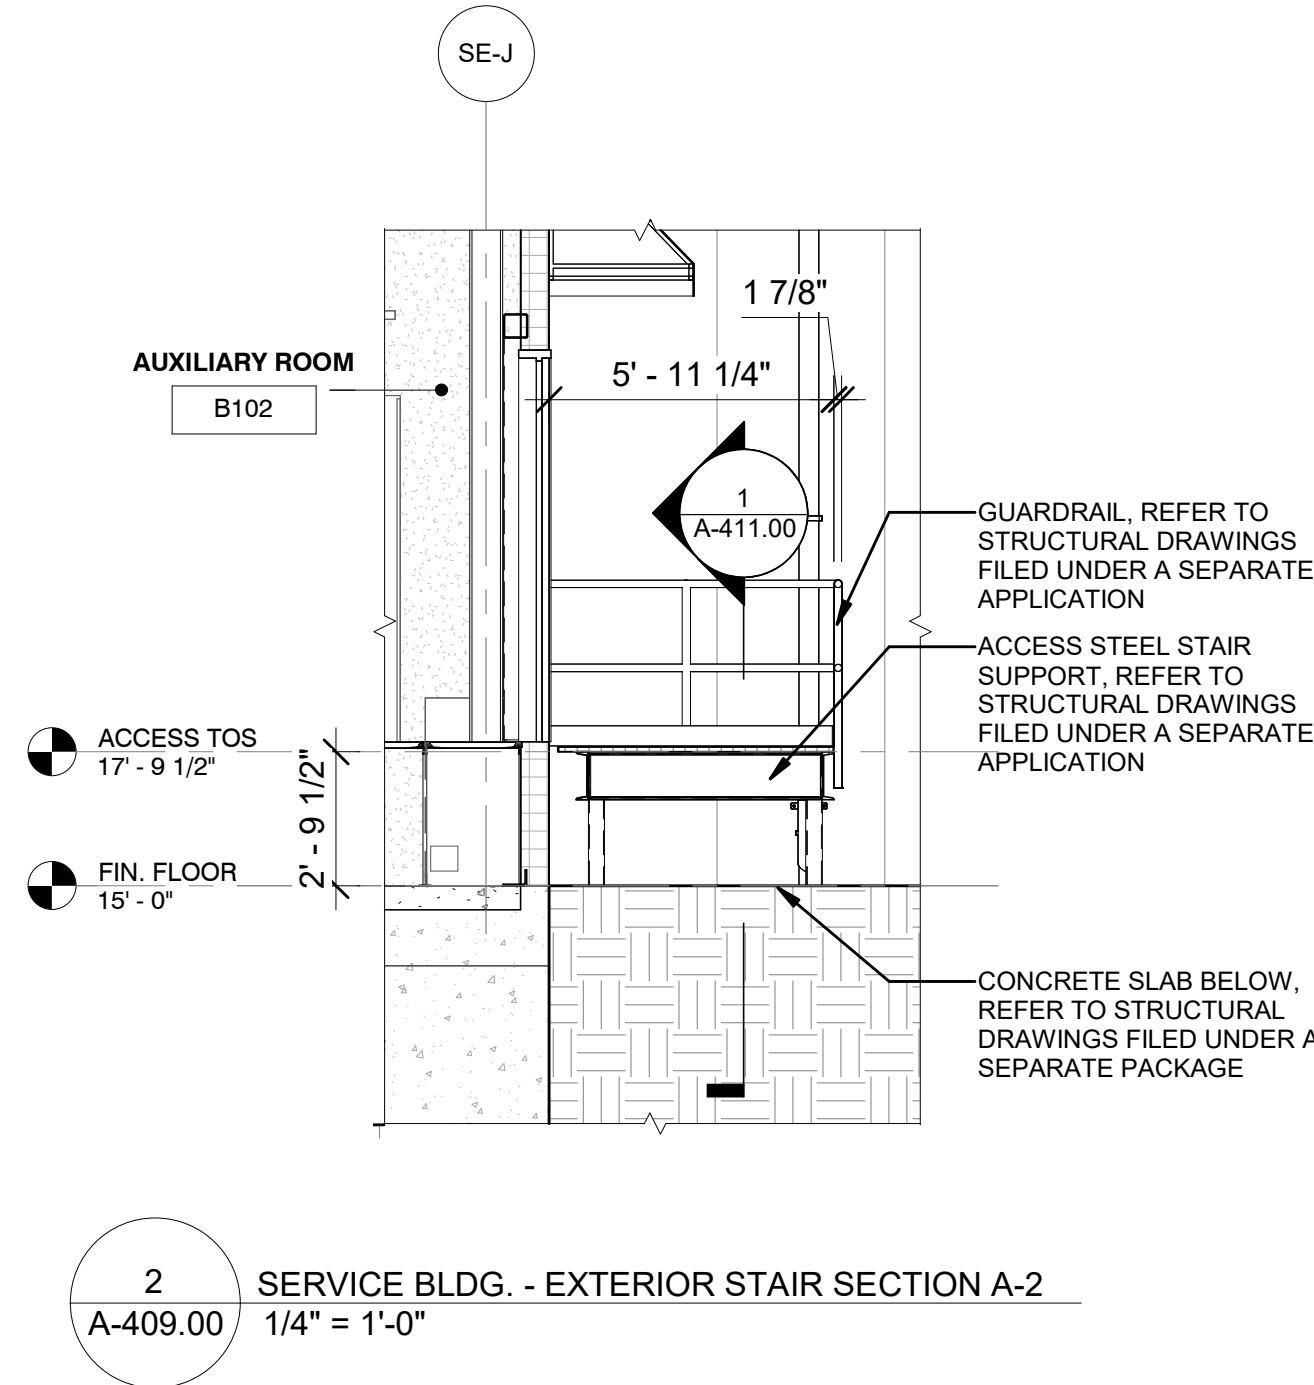
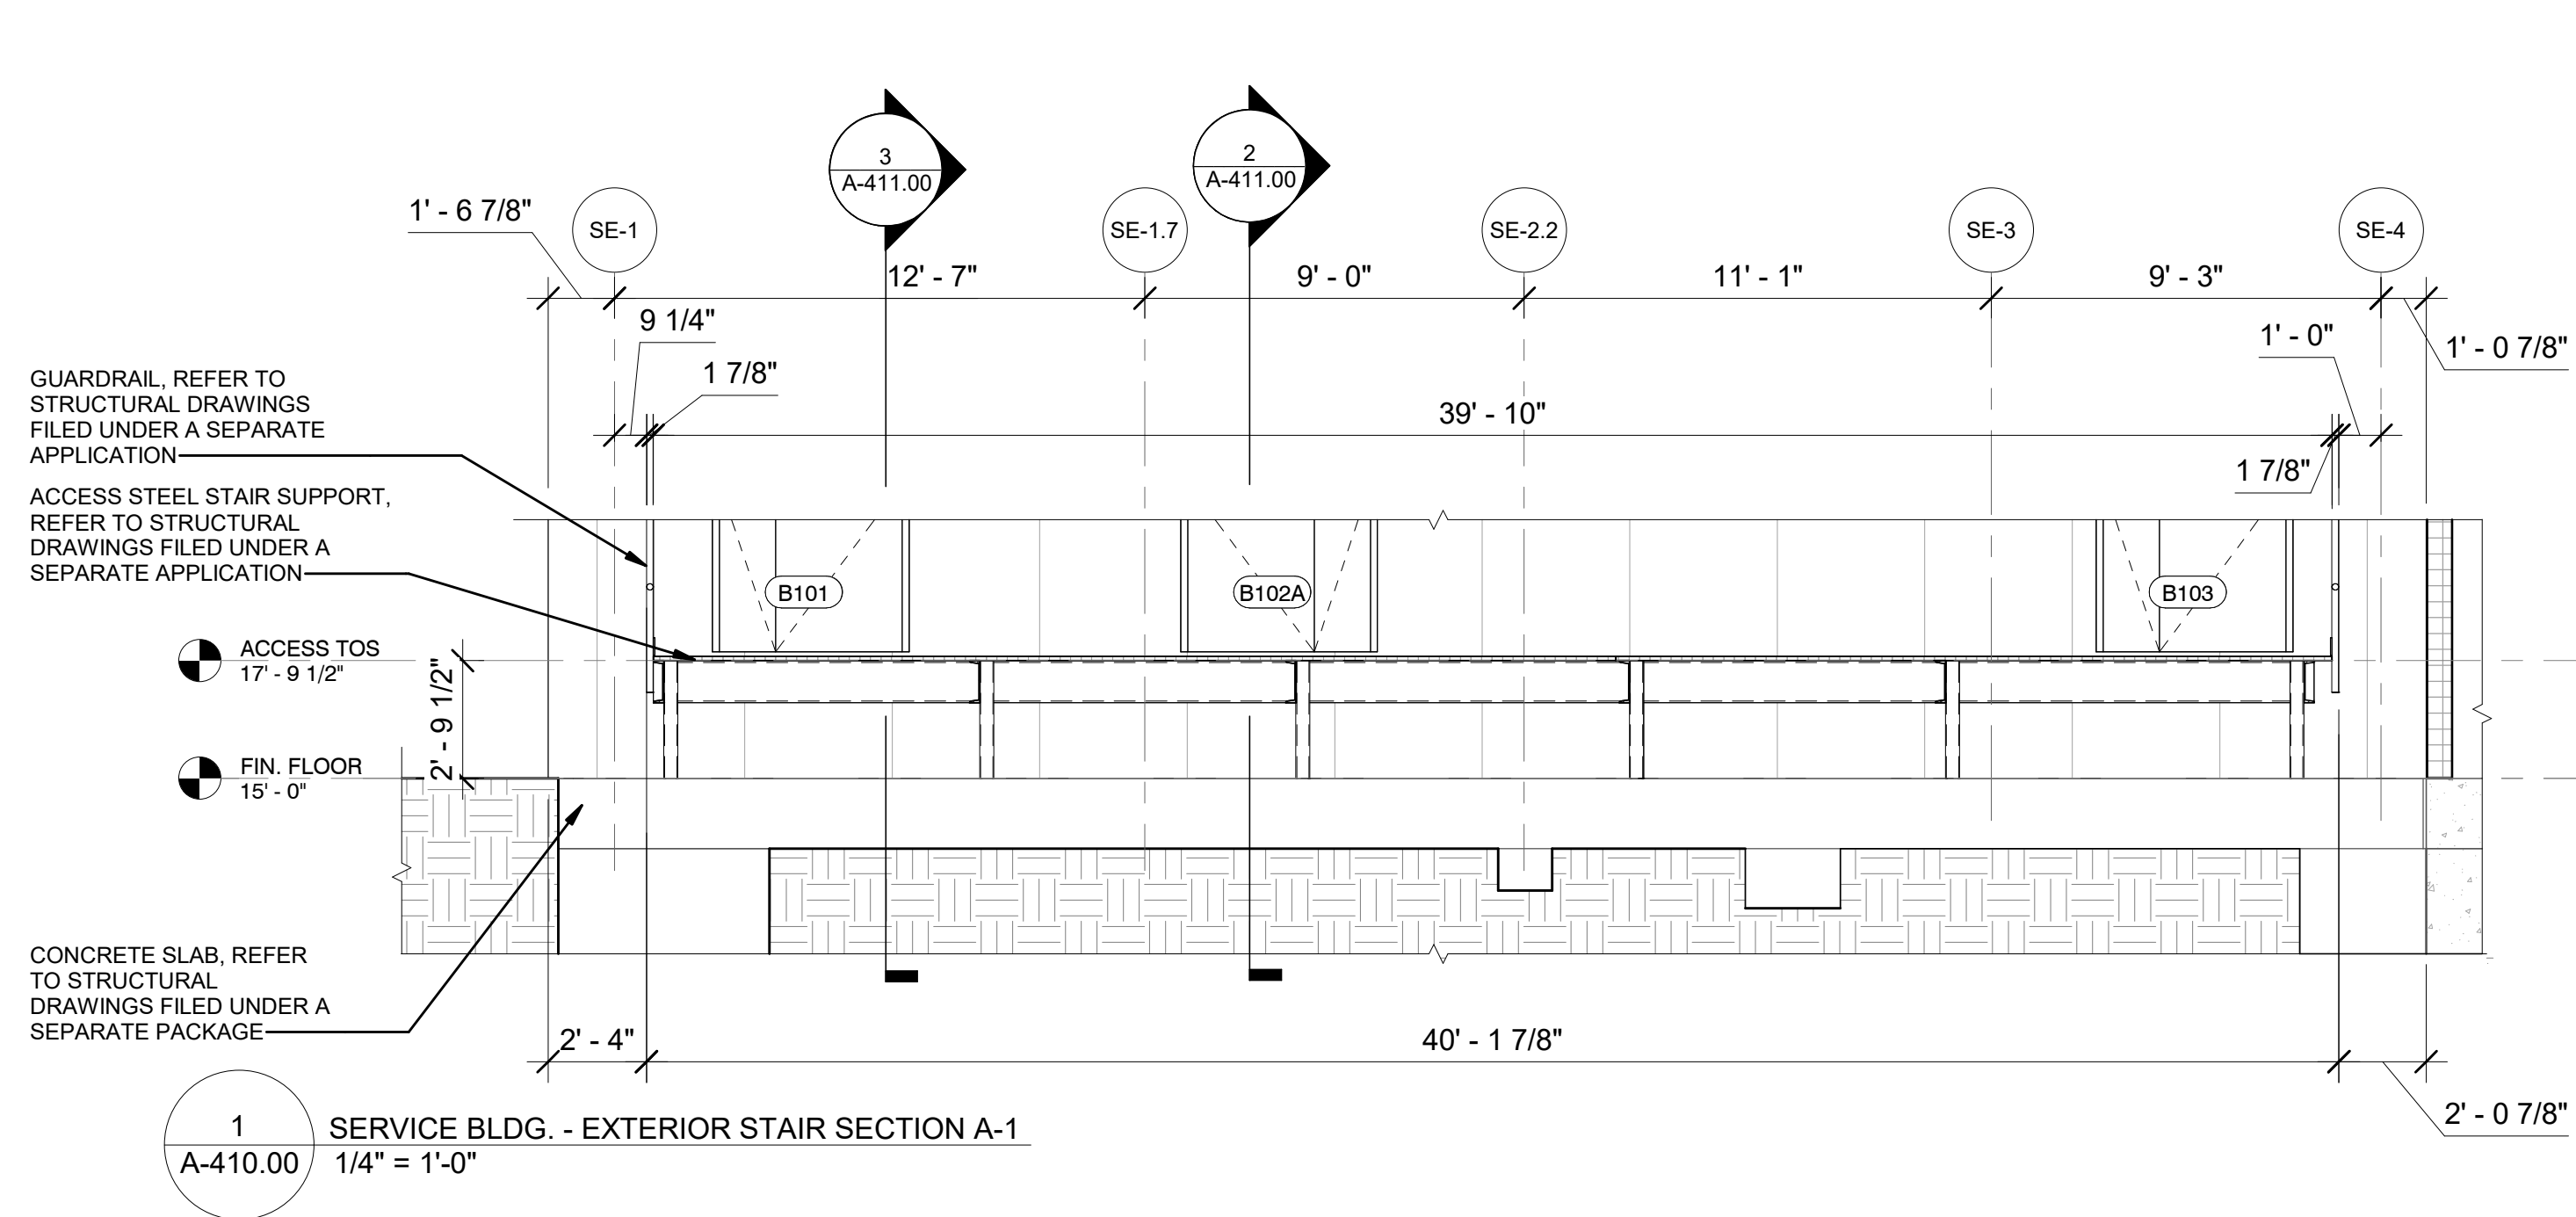


CHPE
Champlain Hudson
Power Express


31-45 20th Avenue, Astoria, Queens NY 11105
Block #850 - Lot #310 - BIN #4624437

A-410.00

CADD FILE N0
Autodesk Docs:\CHPE
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| REV | DESCRIPTION | DRW BY | CHK BY | DATE |
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| 0 | FINAL SUBMISSION | RAC | ZH | 12/12/2022 |

Kiewit 470 Chestnut Ridge Rd # 2, Woodcliff Lake, NJ 07677

Hitachi Energy 901 Main Campus Drive Raleigh, North Carolina 27606

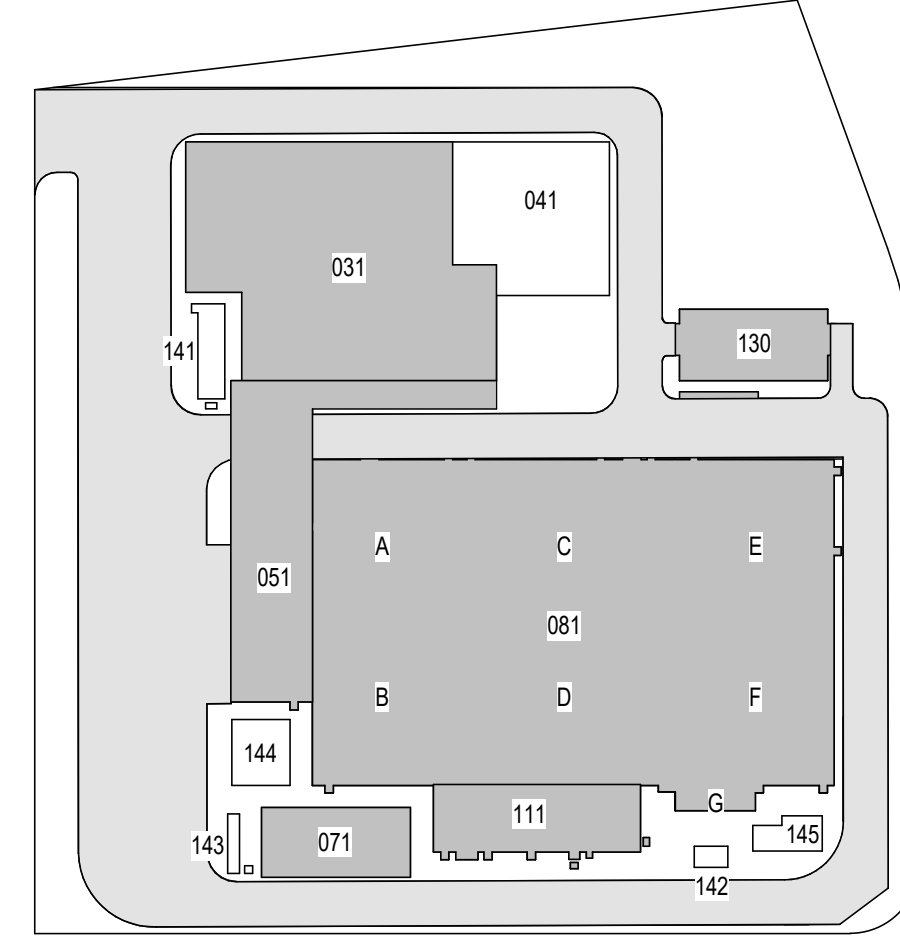PROJECT

CHPE Champlain Hudson Power Express

Astoria HVDC Converter Station

31-45 20th Avenue, Astoria, Queens NY 11105
Block #850 - Lot #310 - BIN #4624437

SERVICE BLDG. EXTERIOR STAIR SECTIONS

REGISTERED ARCHITECT SUZANNE SOWINSKI SULLIVAN STATE OF NEW YORK 026049

DATE 12/12/22

PROJECT NO 105121

DRAWING BY Author


CHECKED BY Designer

DRAWING NO A-411.00


CADD FILE NO Astoria-HVDC-CHPE

Astoria-CHPE-111-ZZ-M3-A-001.rvt

12/8/2022 11:22:42 AM

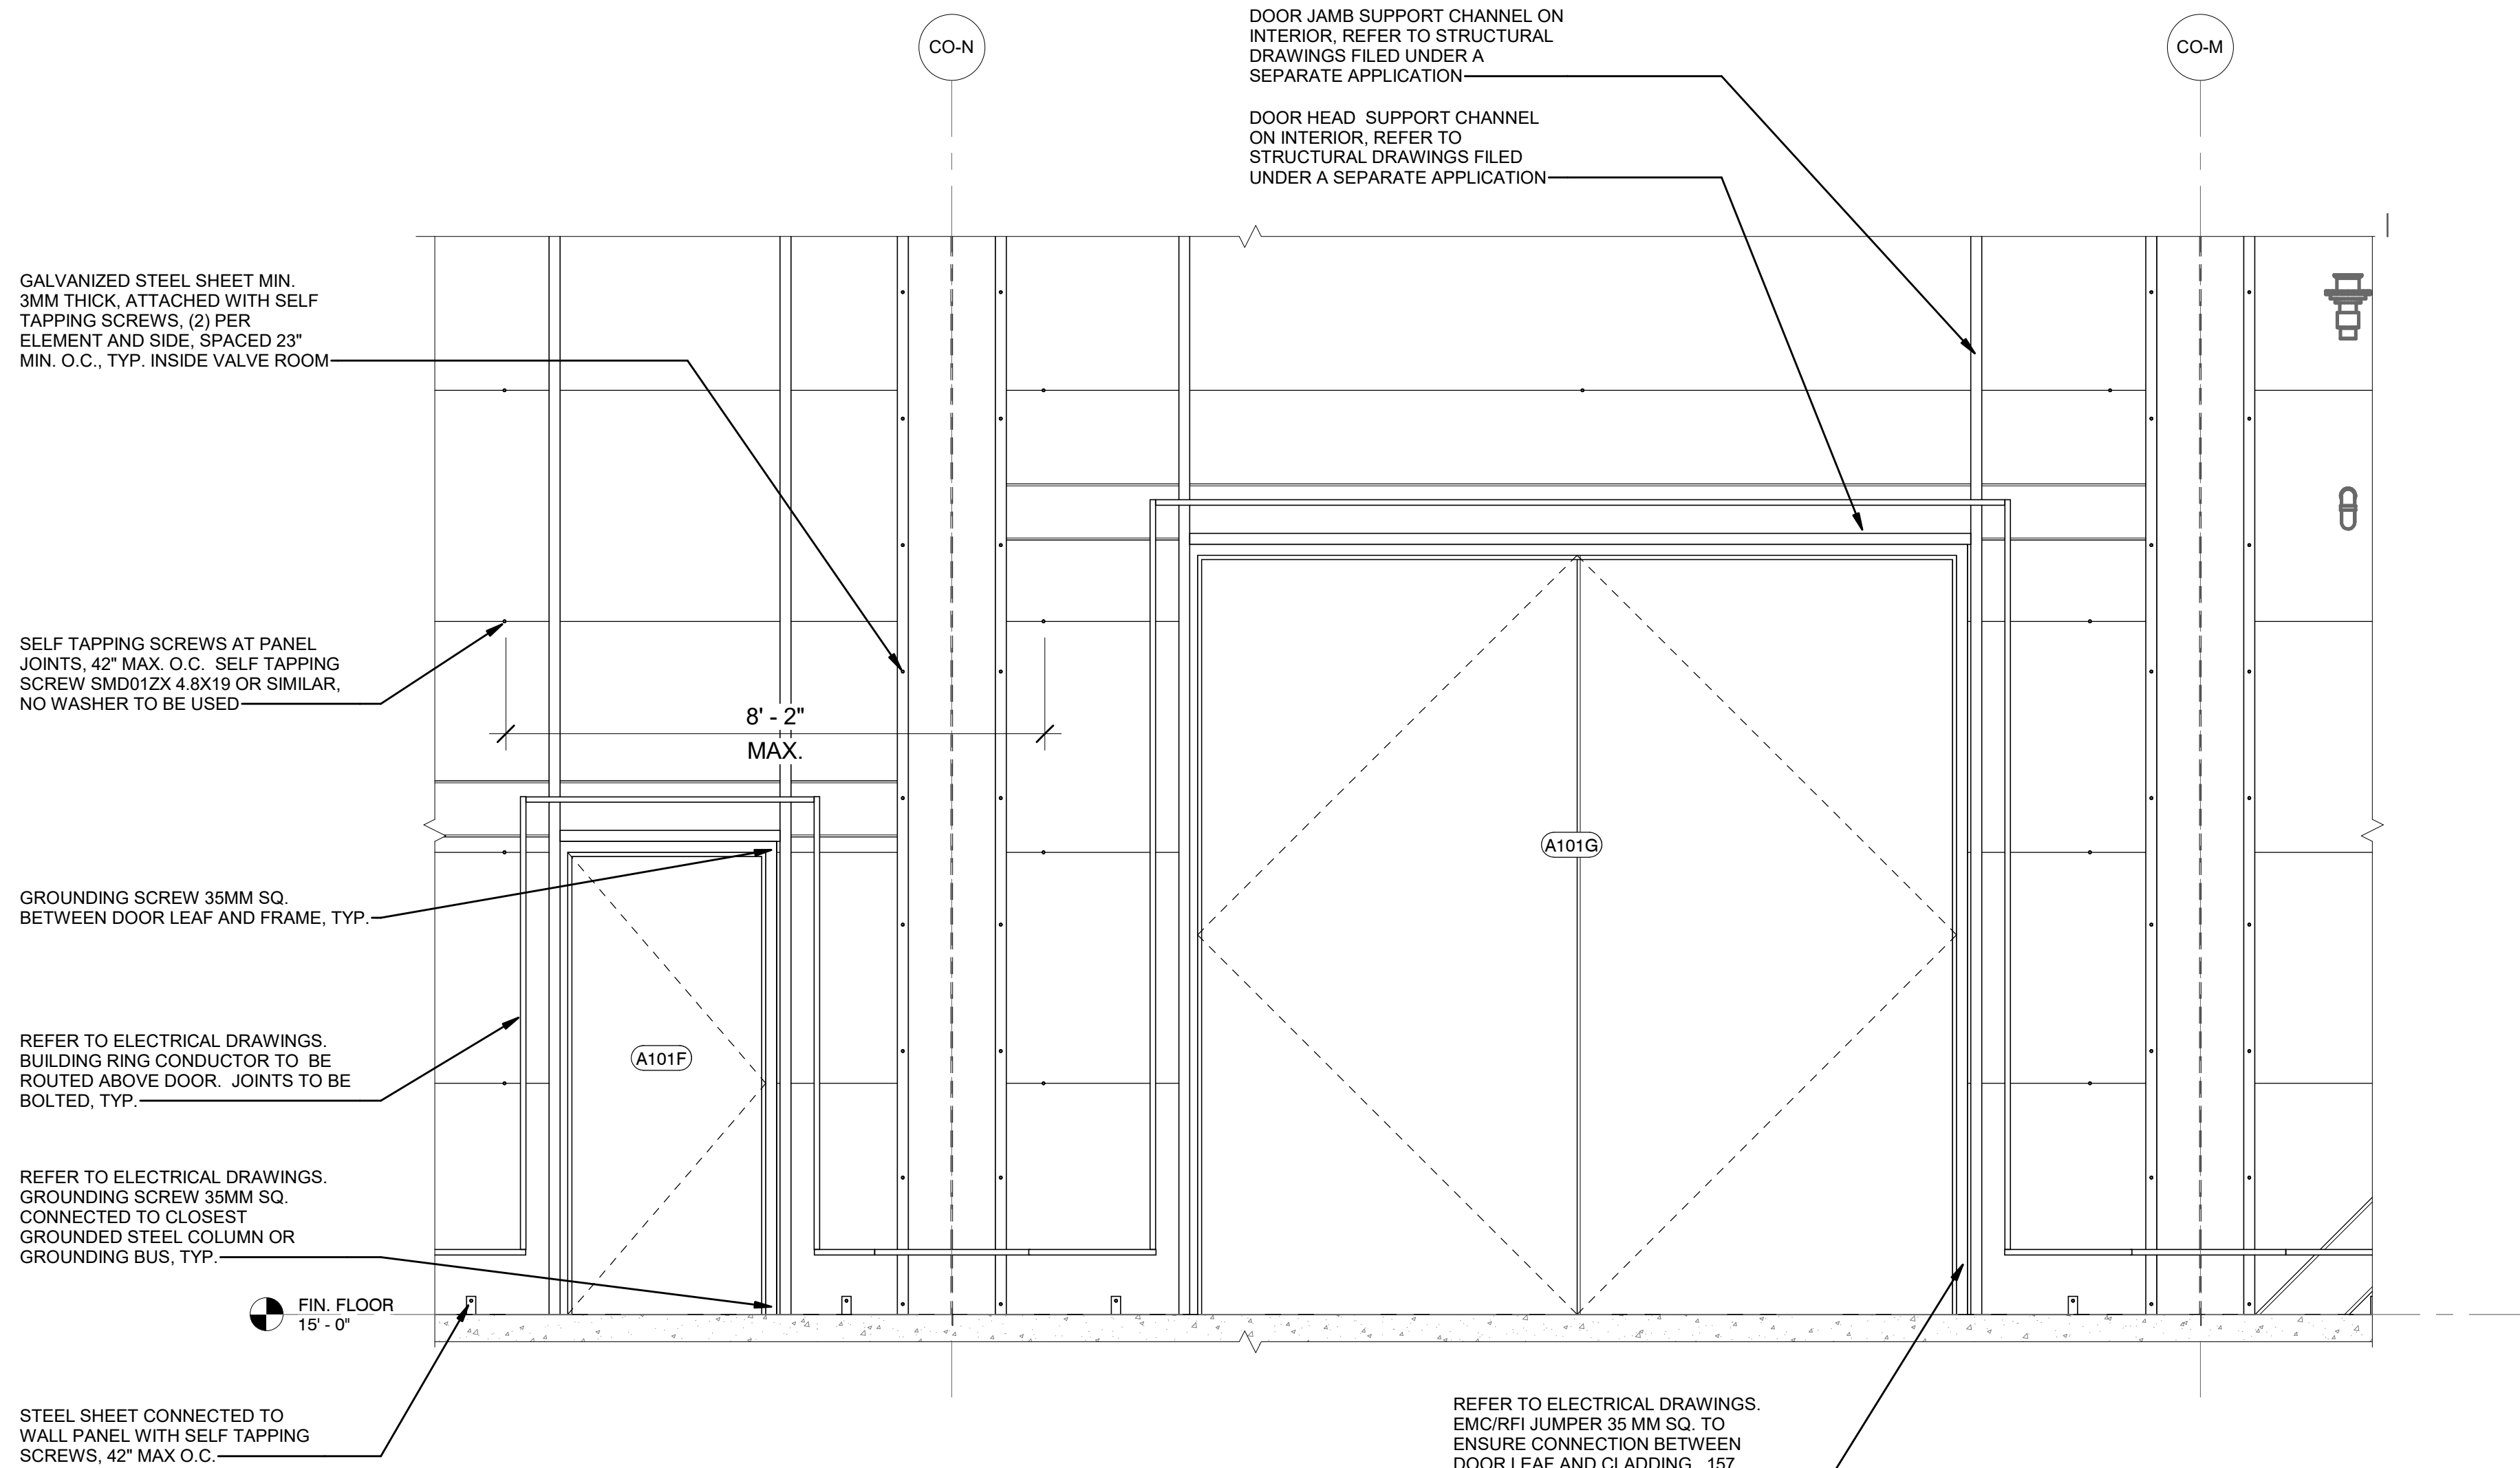


1 ENLARGED SECTION - VALVE HALL 1- DETAIL
A-305.00 1/2" = 1'-0"

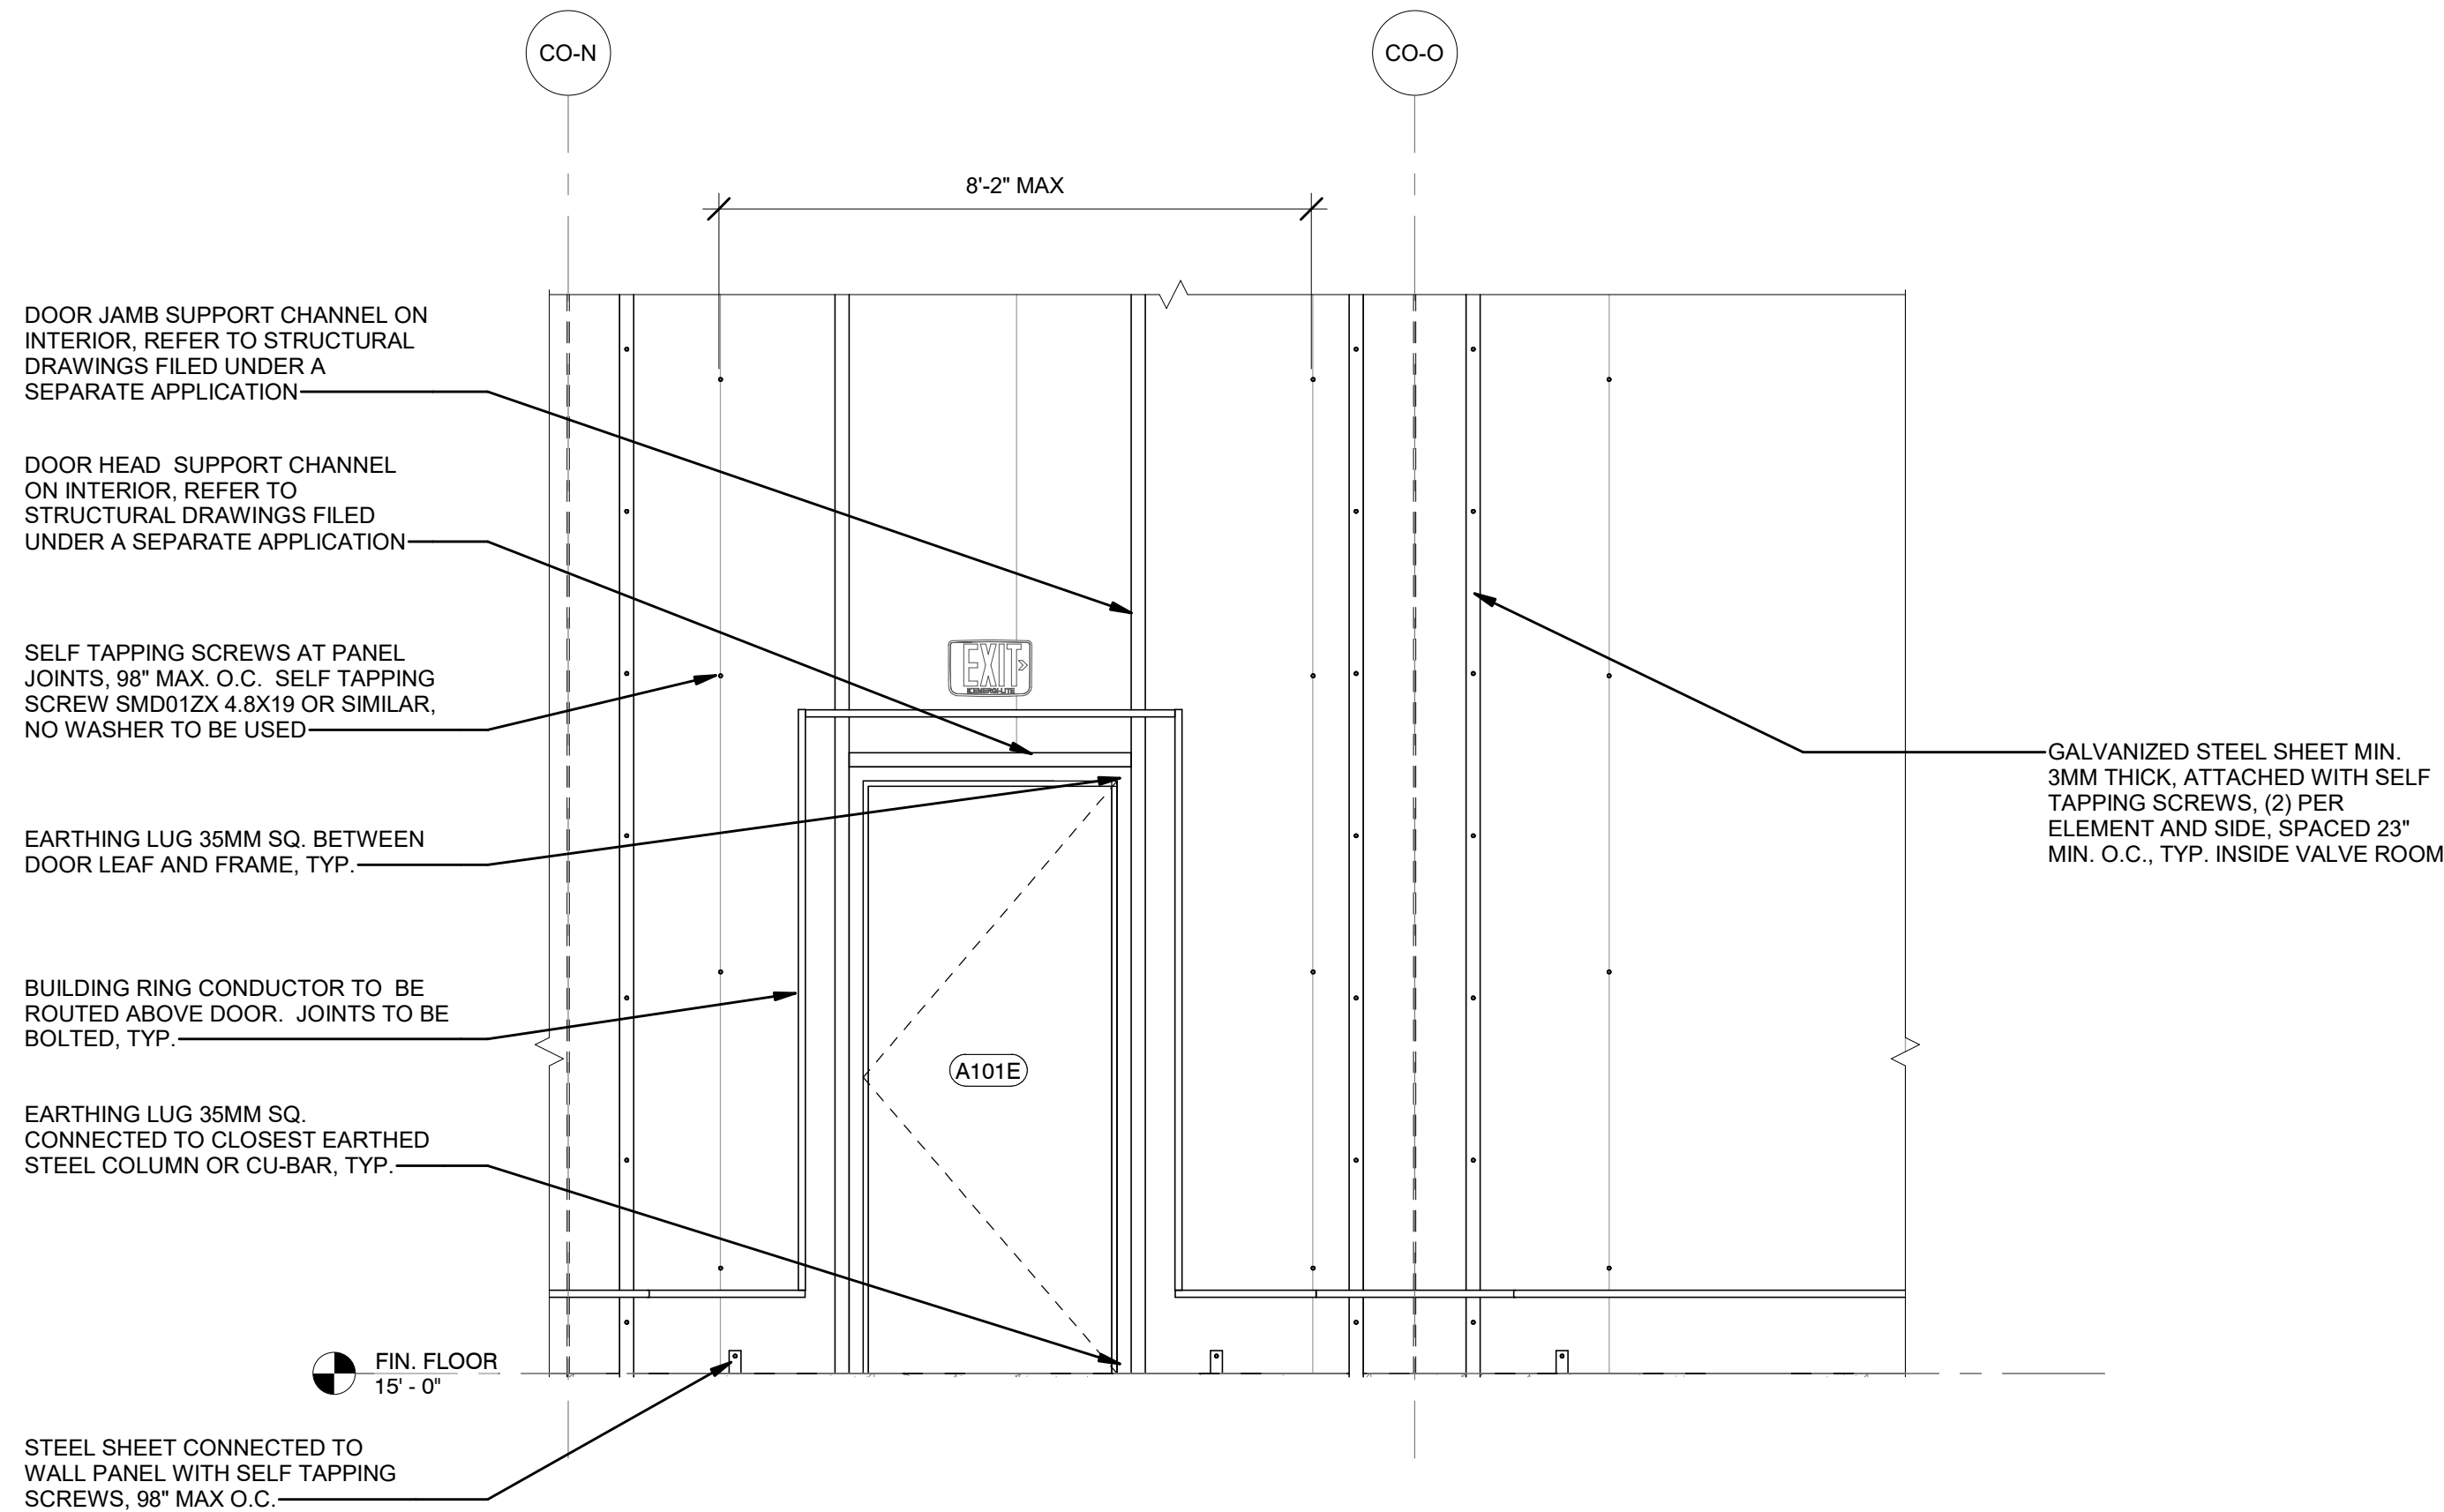


2 ENLARGED ELEVATION DETAIL - VALVE HALL 1
A-103.00 1/2" = 1'-0"



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KEY PLAN
N.T.S.

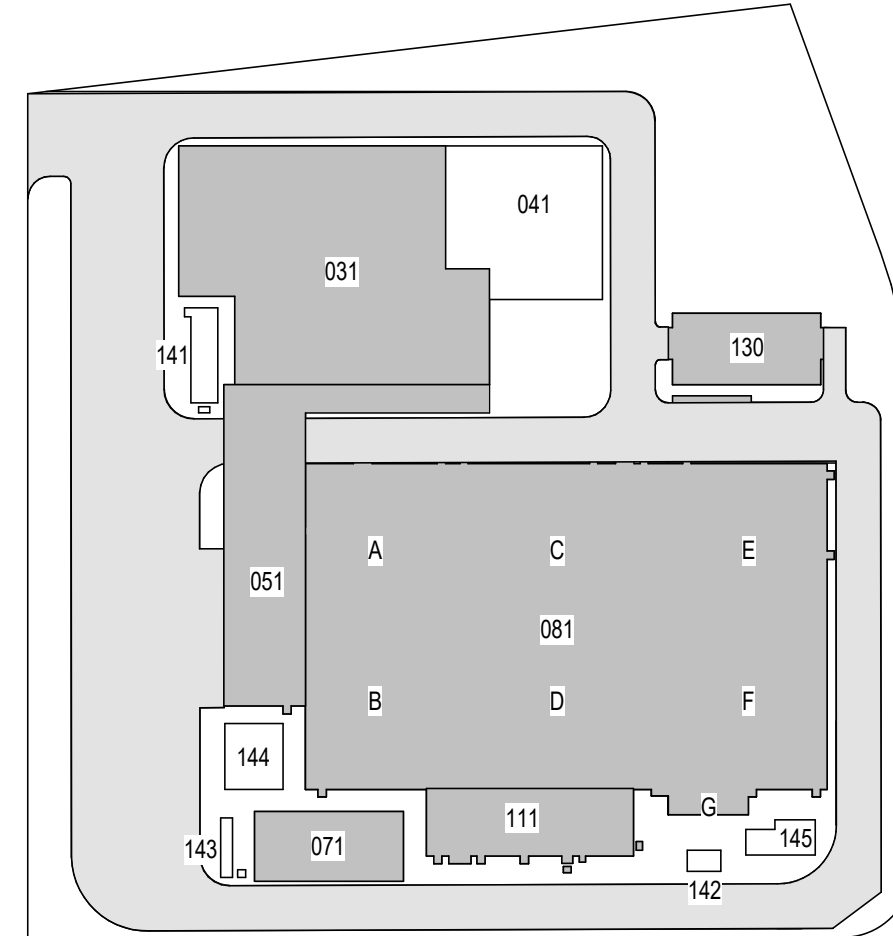

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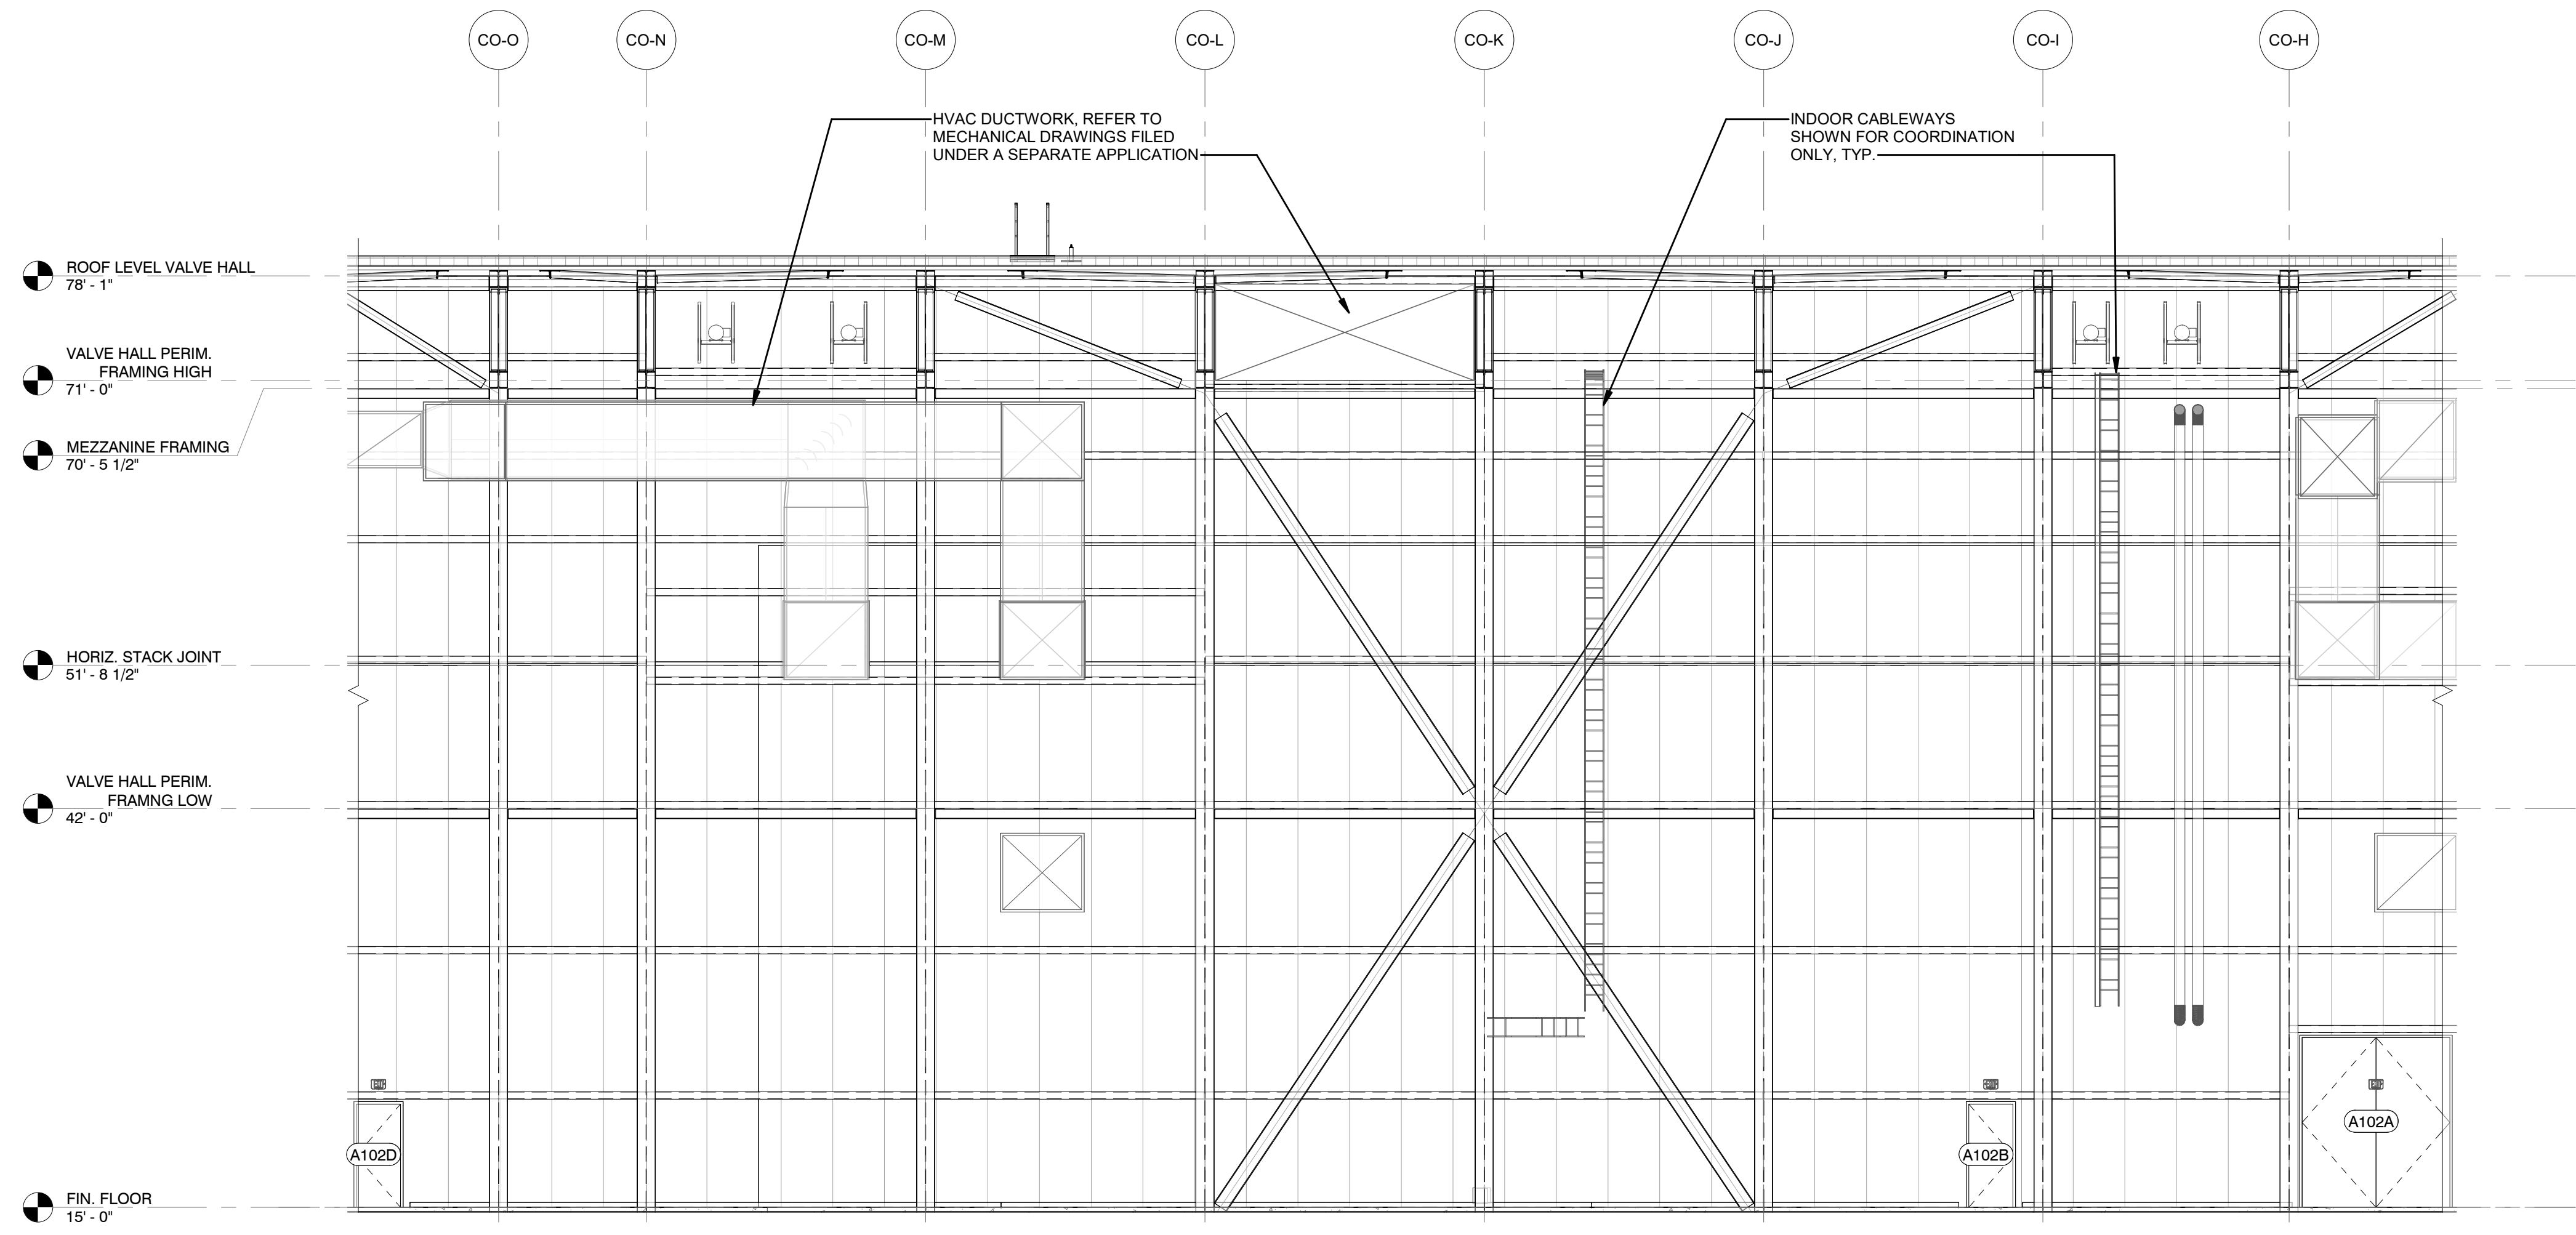
**Astoria HVDC
Converter Station**

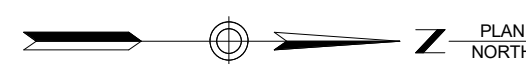31-45 20th Avenue, Astoria, Queens NY 11105
Block #850 - Lot #310 - BIN #4624437

**CONVERTER BLDG.
ENLARGED INTERIOR
ELEVATIONS**




DATE 12/12/22
PROJECT NO 105121
DRAWING BY Author
CHECKED BY Designer
DRAWING NO
A-415.00
CADD FILE NO
Astoria-HVDC-CHPE
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1 VALVE HALL 2 - INTERIOR SOUTH ELEVATION
XA-108.00 1/8" = 1'-0"



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| B | FINAL SUBMISSION | RAC | ZH | 12/12/2022 |
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PROJECT


CHPE
Champlain Hudson
Power Express

Astoria HVDC Converter Station
31-45 20th Avenue, Astoria, Queens NY 11105
Block #850 - Lot #310 - BIN #4624437

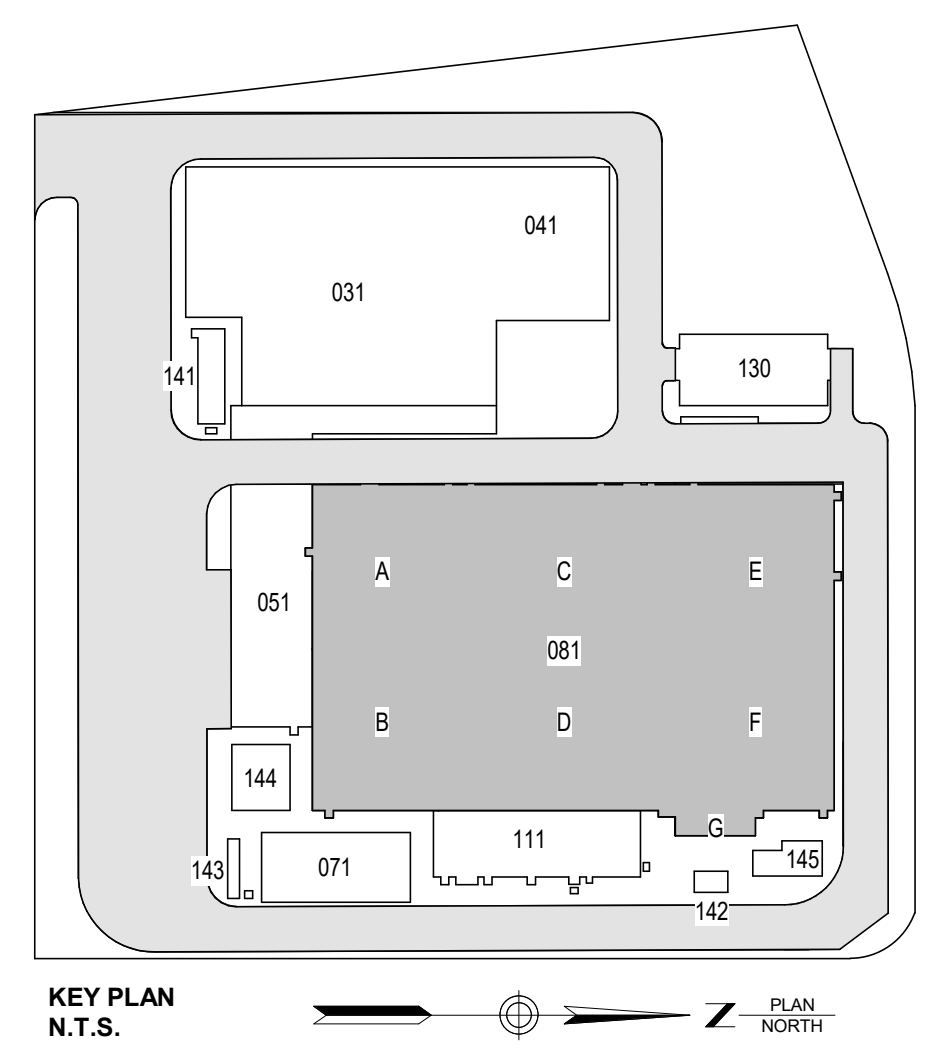
**CONVERTER BLDG.
ENLARGED INTERIOR
ELEVATIONS**

REGISTERED ARCHITECT
SUZANNA SOWINSKI
STATE OF NEW YORK
026049


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| DATE | 12/12/22 |
| PROJECT NO | 105121 |
| DRAWING BY | Author |
| CHECKED BY | Designer |
| DRAWING NO | A-416.00 |
| CADD FILE NO | AstoriaHVDC-CHPE-111-22-M3-A-001.rvt |

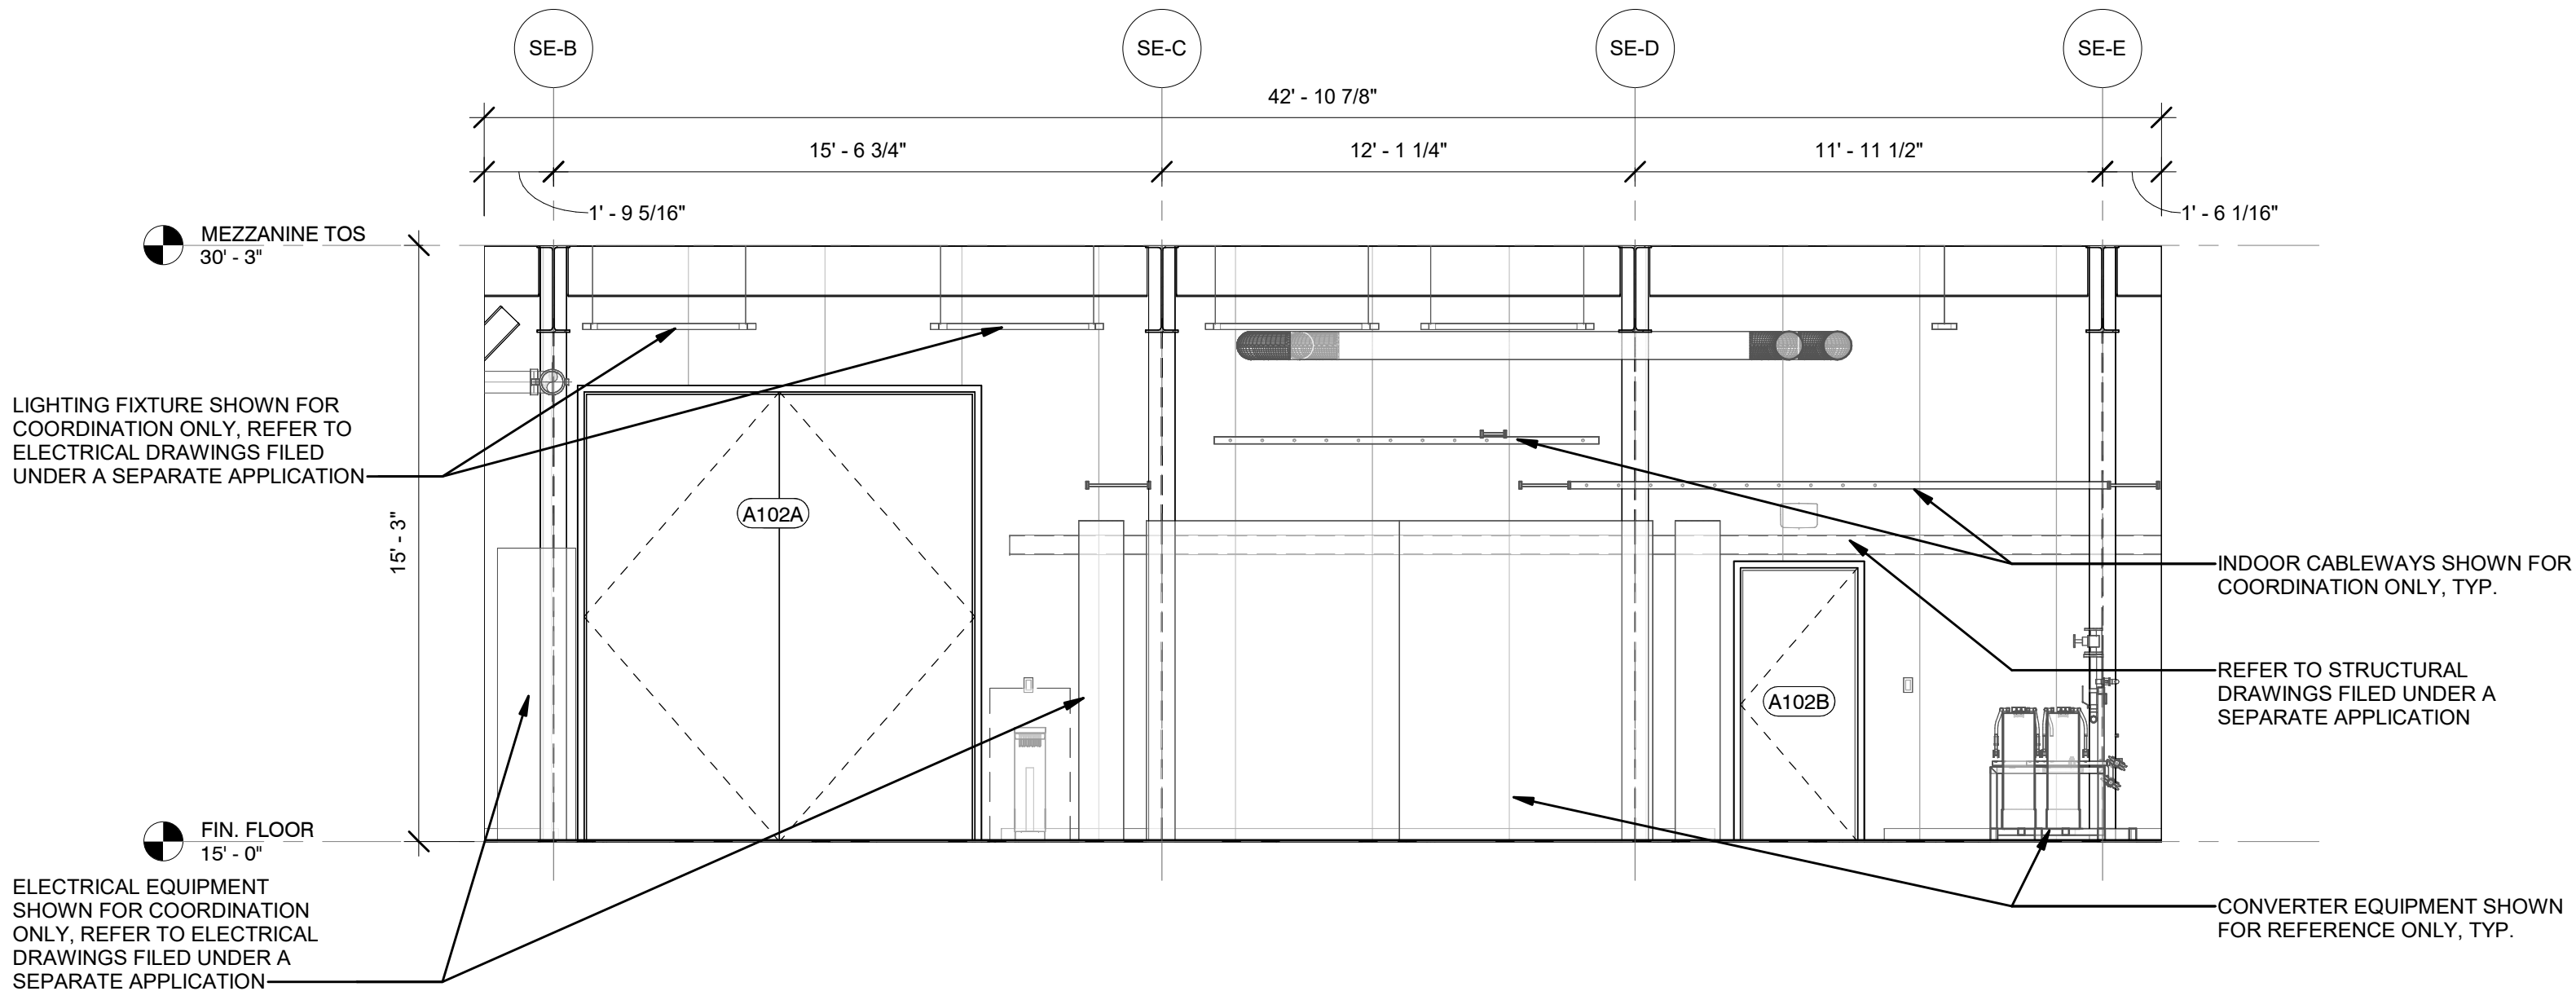

1 ELEVATION - SERVICE BLDG. VALVE RM. COOLING B115
XA-108.00 1/4" = 1'-0"

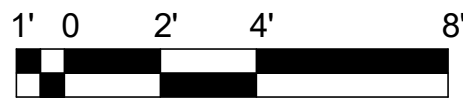

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**Astoria HVDC
Converter Station**

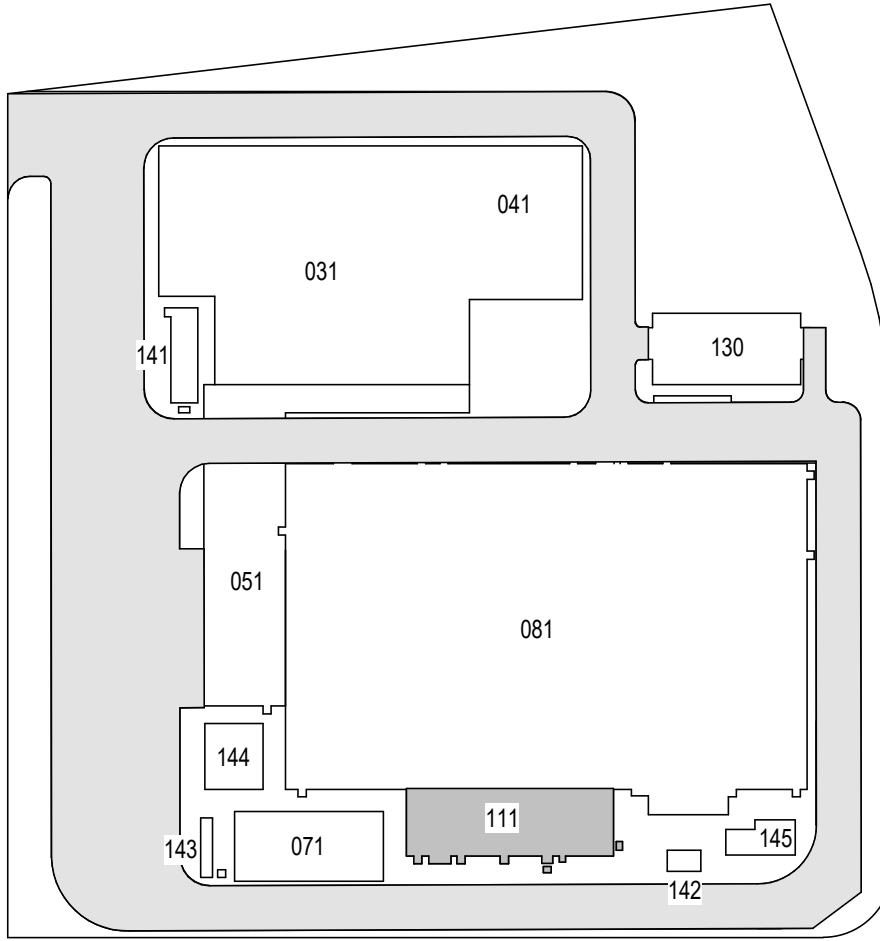31-45 20th Avenue, Astoria, Queens NY 11105
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**SERVICE BLDG. INTERIOR
ELEVATIONS**



DATE 12/12/22
PROJECT NO 105121
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DRAWING NO
A-417.00
CADD FILE NO
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Architectural section drawing showing three levels of a building facade, with structural details and room labels.

- Top Level:** ROOF LEVEL VALVE HALL, 78' - 1".
- Middle Level:** MEZZANINE SLAB PLAN, 30' - 9".
- Bottom Level:** ACCESS TOS, 17' - 9 1/2".
- Fin. Floor:** 15' - 0".

Room labels and elevations:


- 1 A-600.00
- 2 A-600.00
- 3 A-600.00
- NEGATIVE VALVE HALL A102
- CONTROL & PROTECTION ROOM 2 B104

Elevation markers: SE-4, CO-1.


3 WALL SECTION AT CONVERTER AND SERVICE BUILDINGS

A-300.00 1/4" = 1'-0"


| | |
|--------------|---|
| DATE | 12/12/22 |
| PROJECT NO | 105121 |
| DRAWING BY | R. COLES |
| CHECKED BY | Z. HARR |
| DRAWING NO | A-500.00 |
| CADD FILE NO | Autodesk Docs://CHPE Astoria/CHA-KIE-111-ZZ-M3-A-001.rvt |

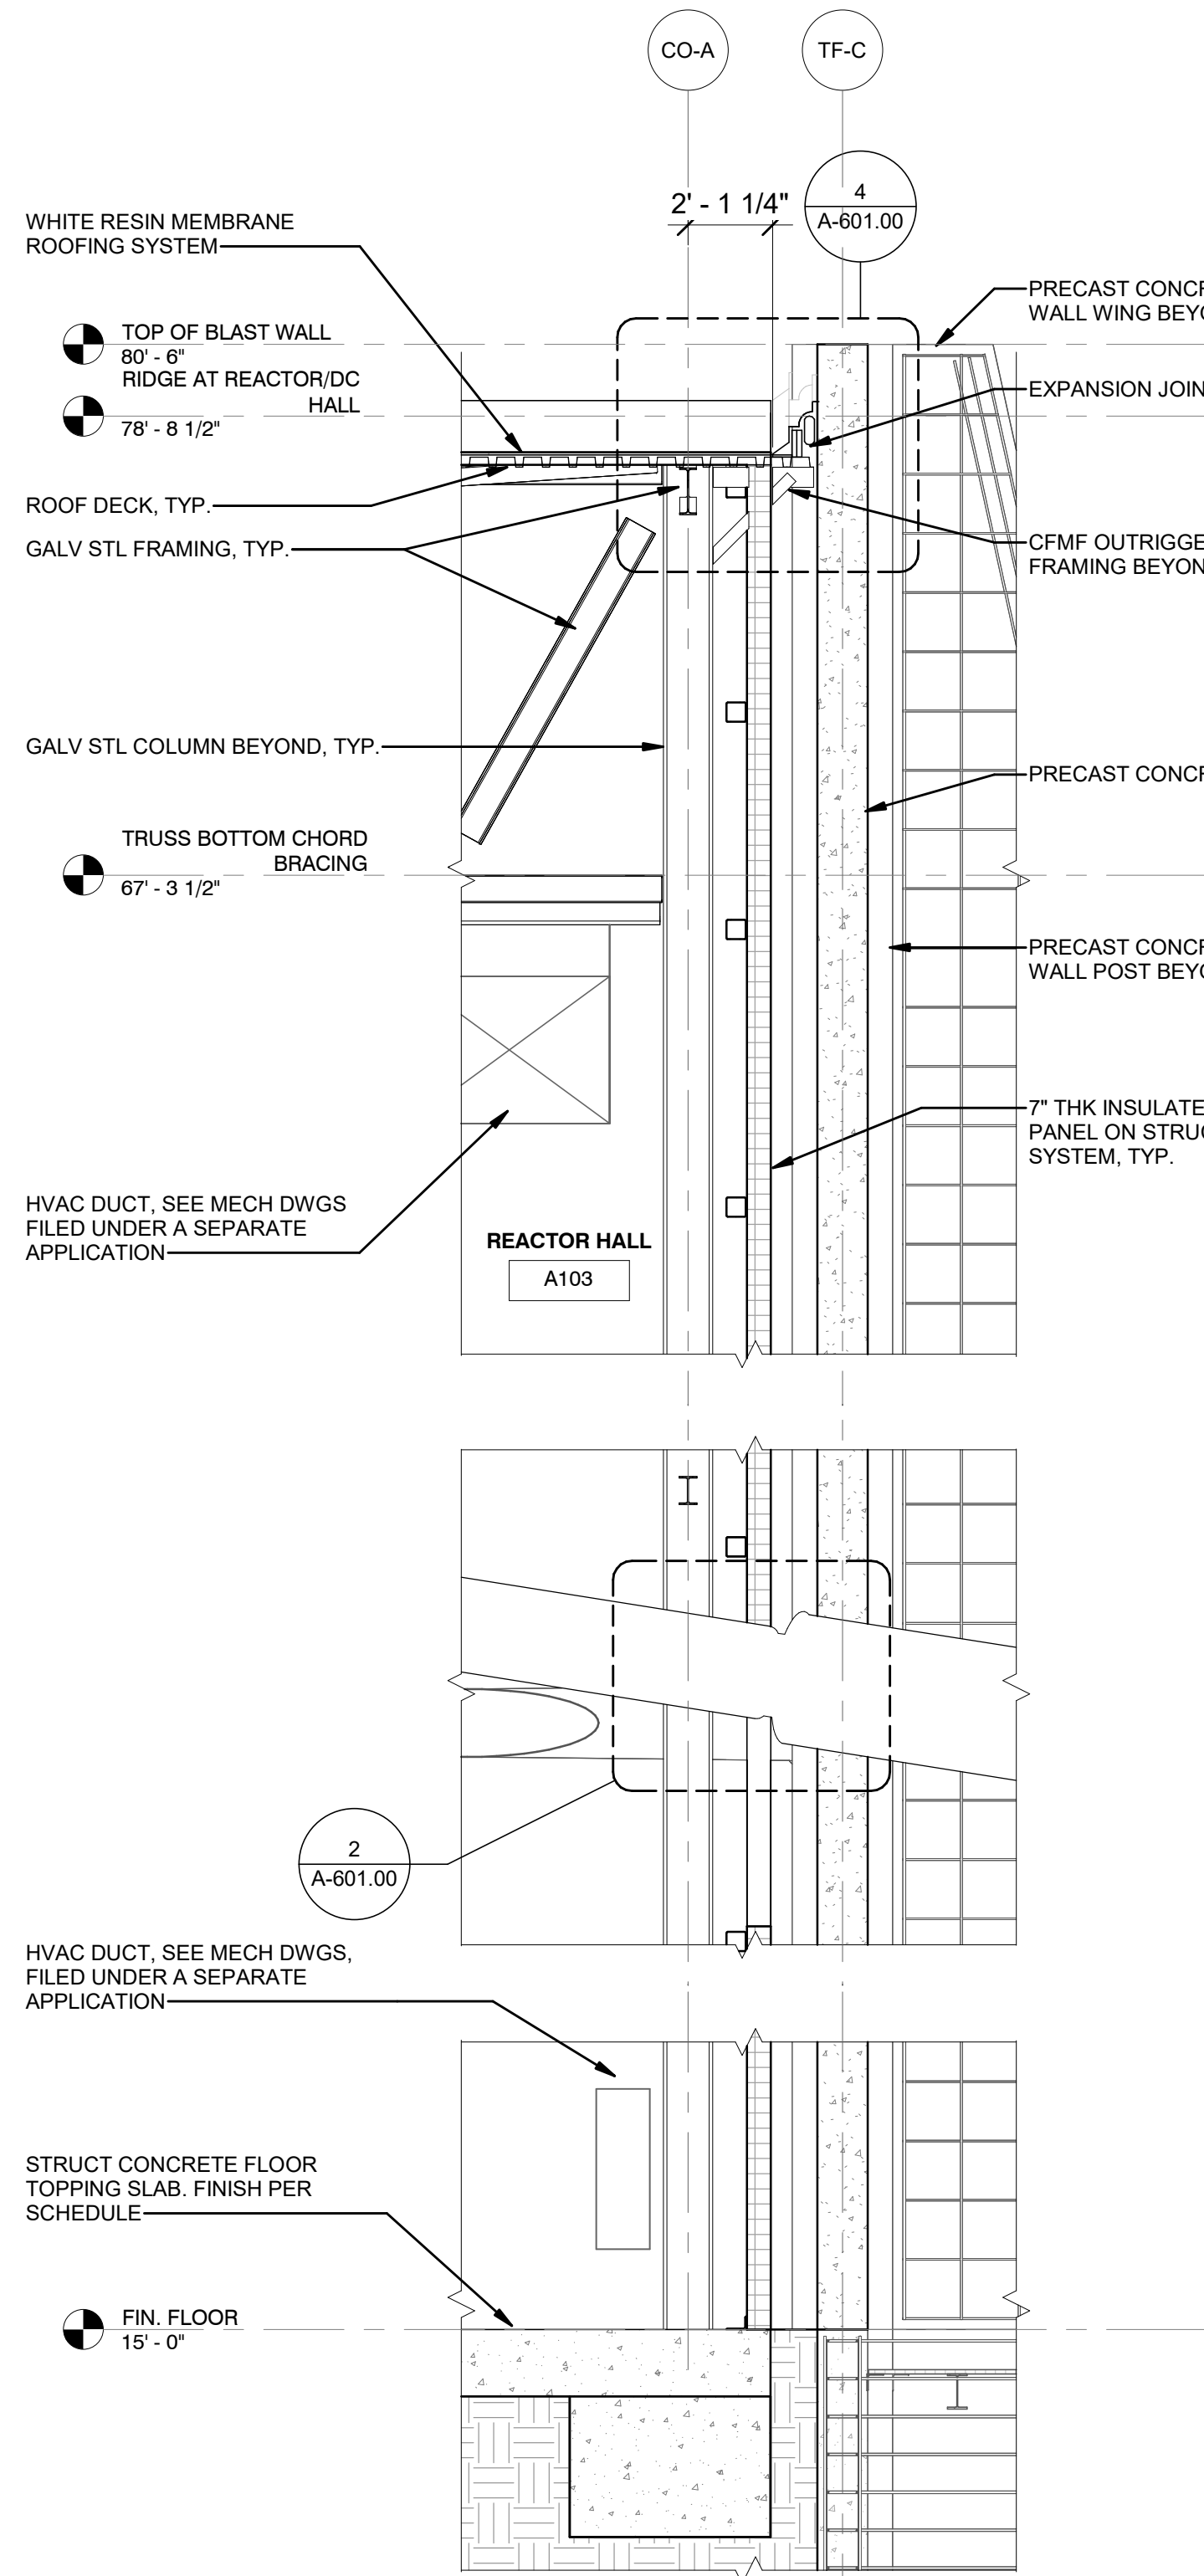

3 WALL SECTION AT REACTOR HALL & TRANSFORMER BAYS
1/4" = 1'-0"

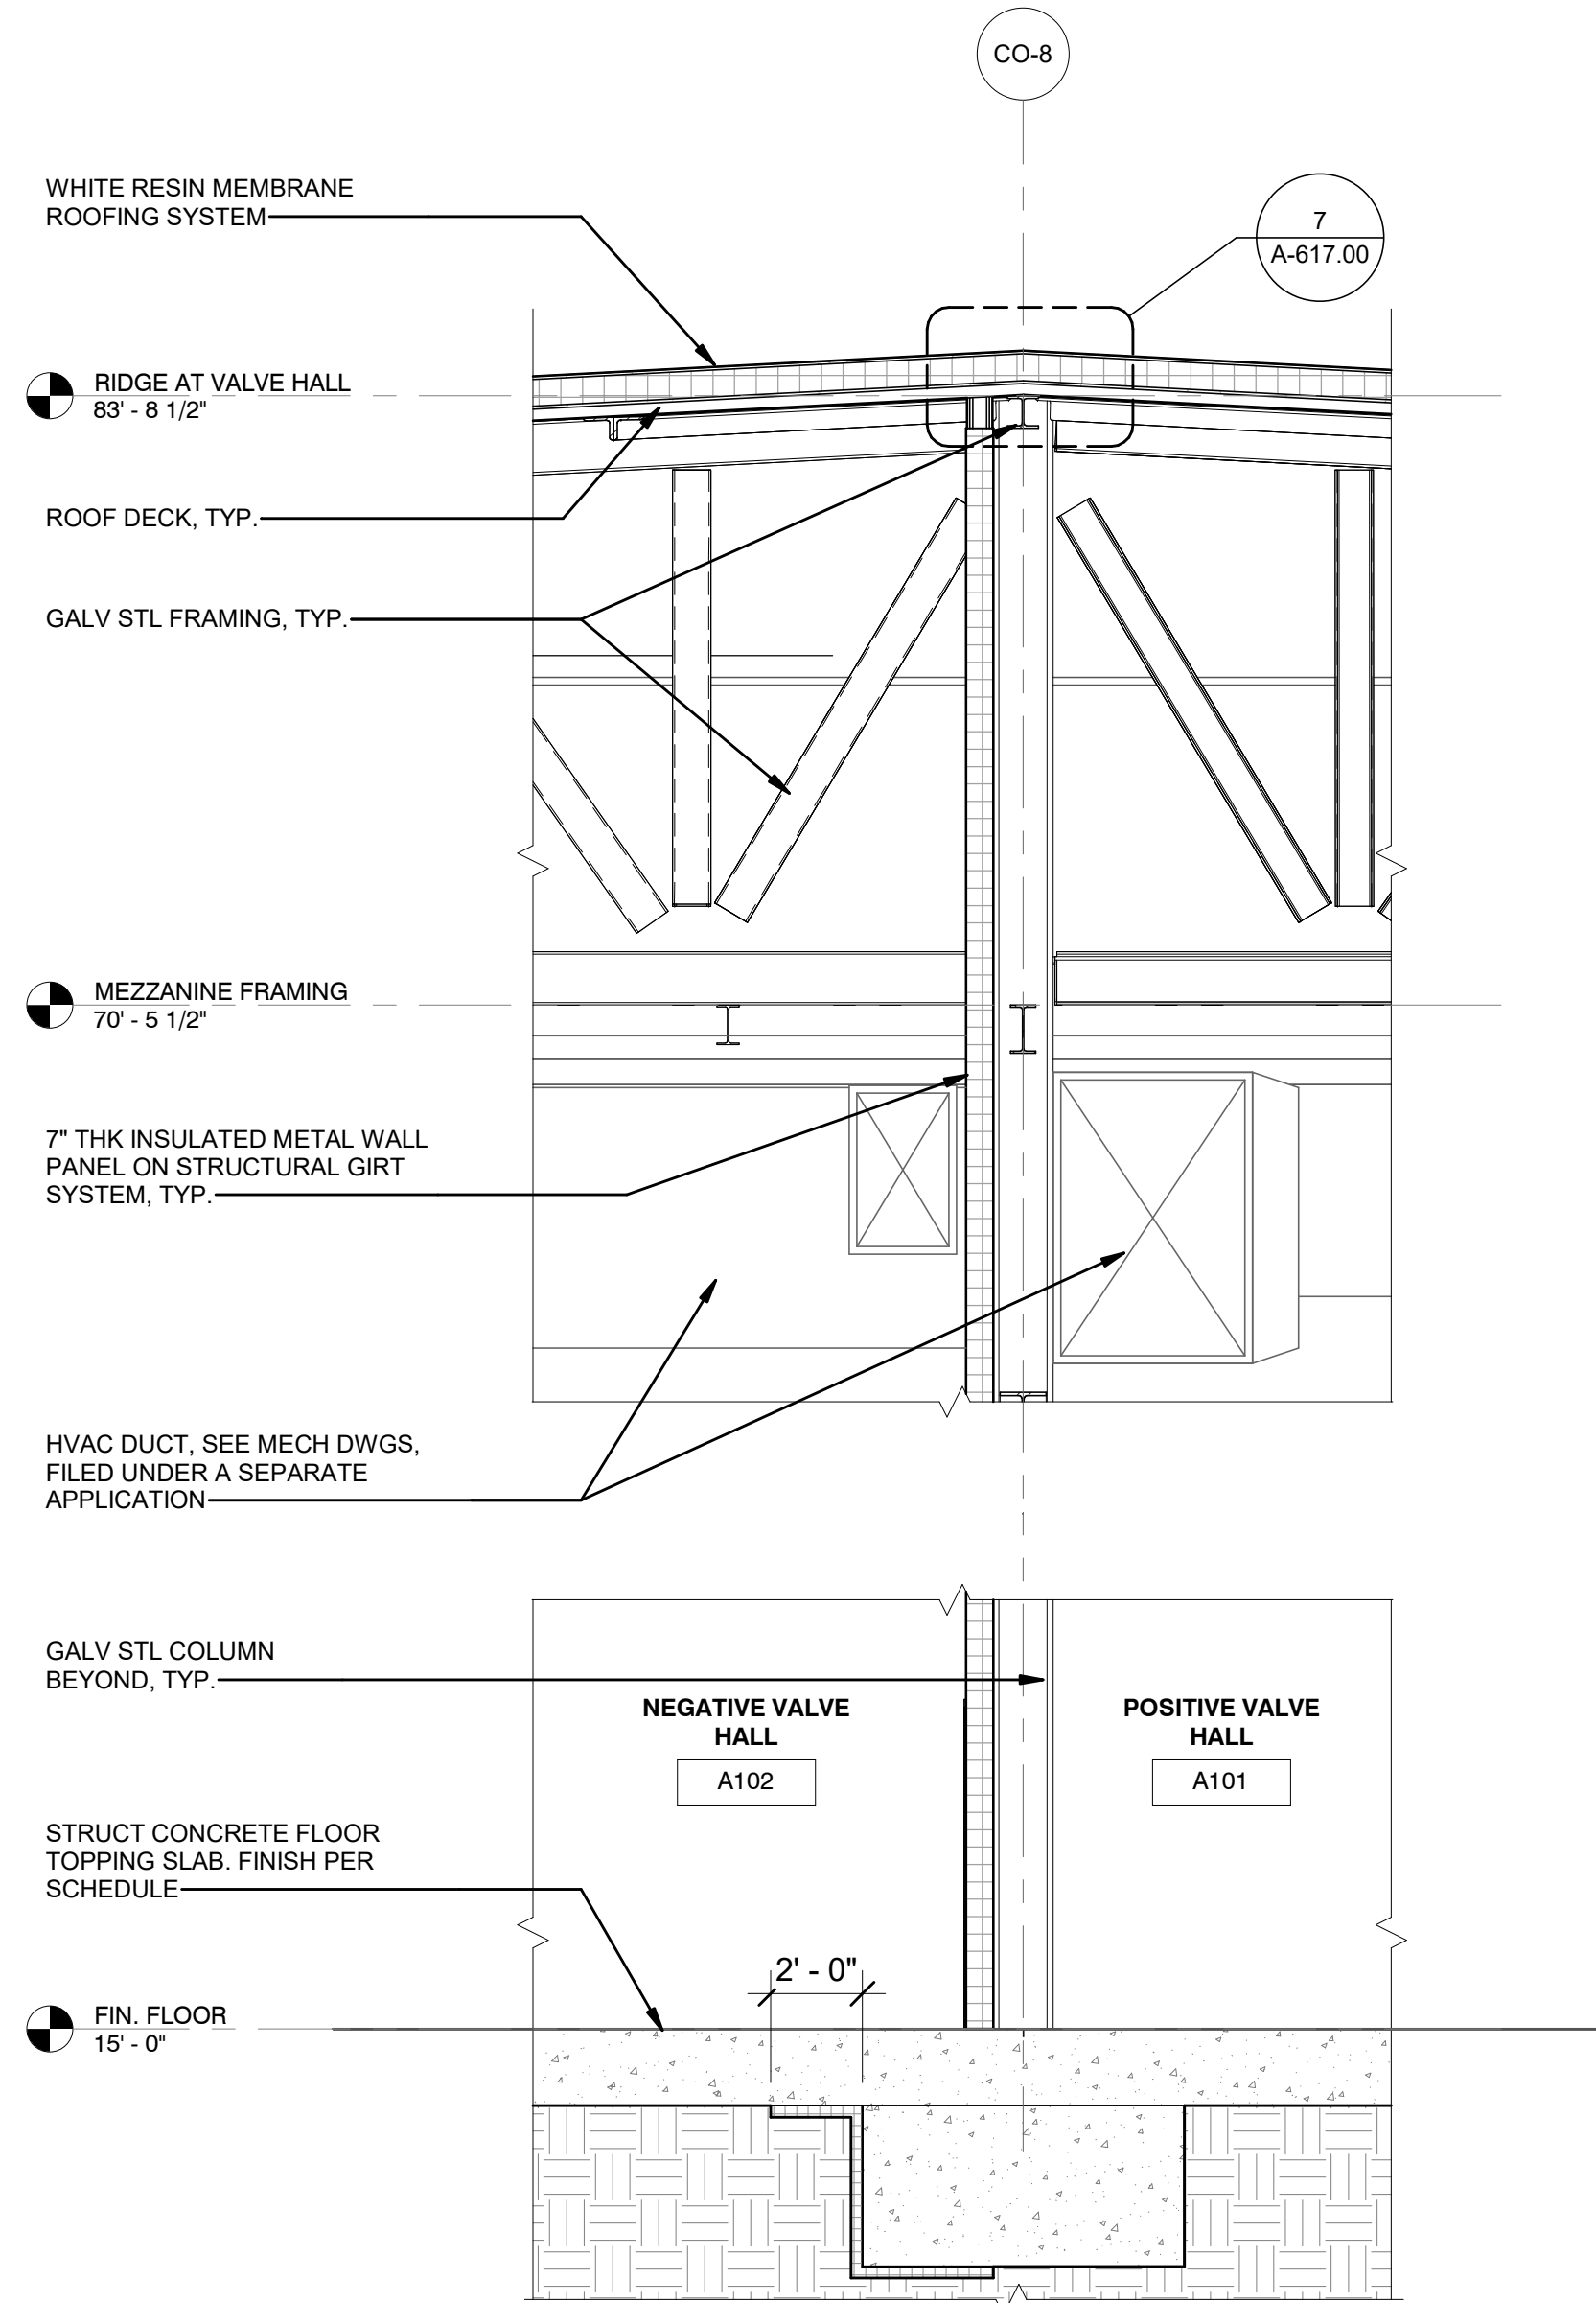

1 SECTION - VALVE HALLS 1 & 2
1/4" = 1'-0"

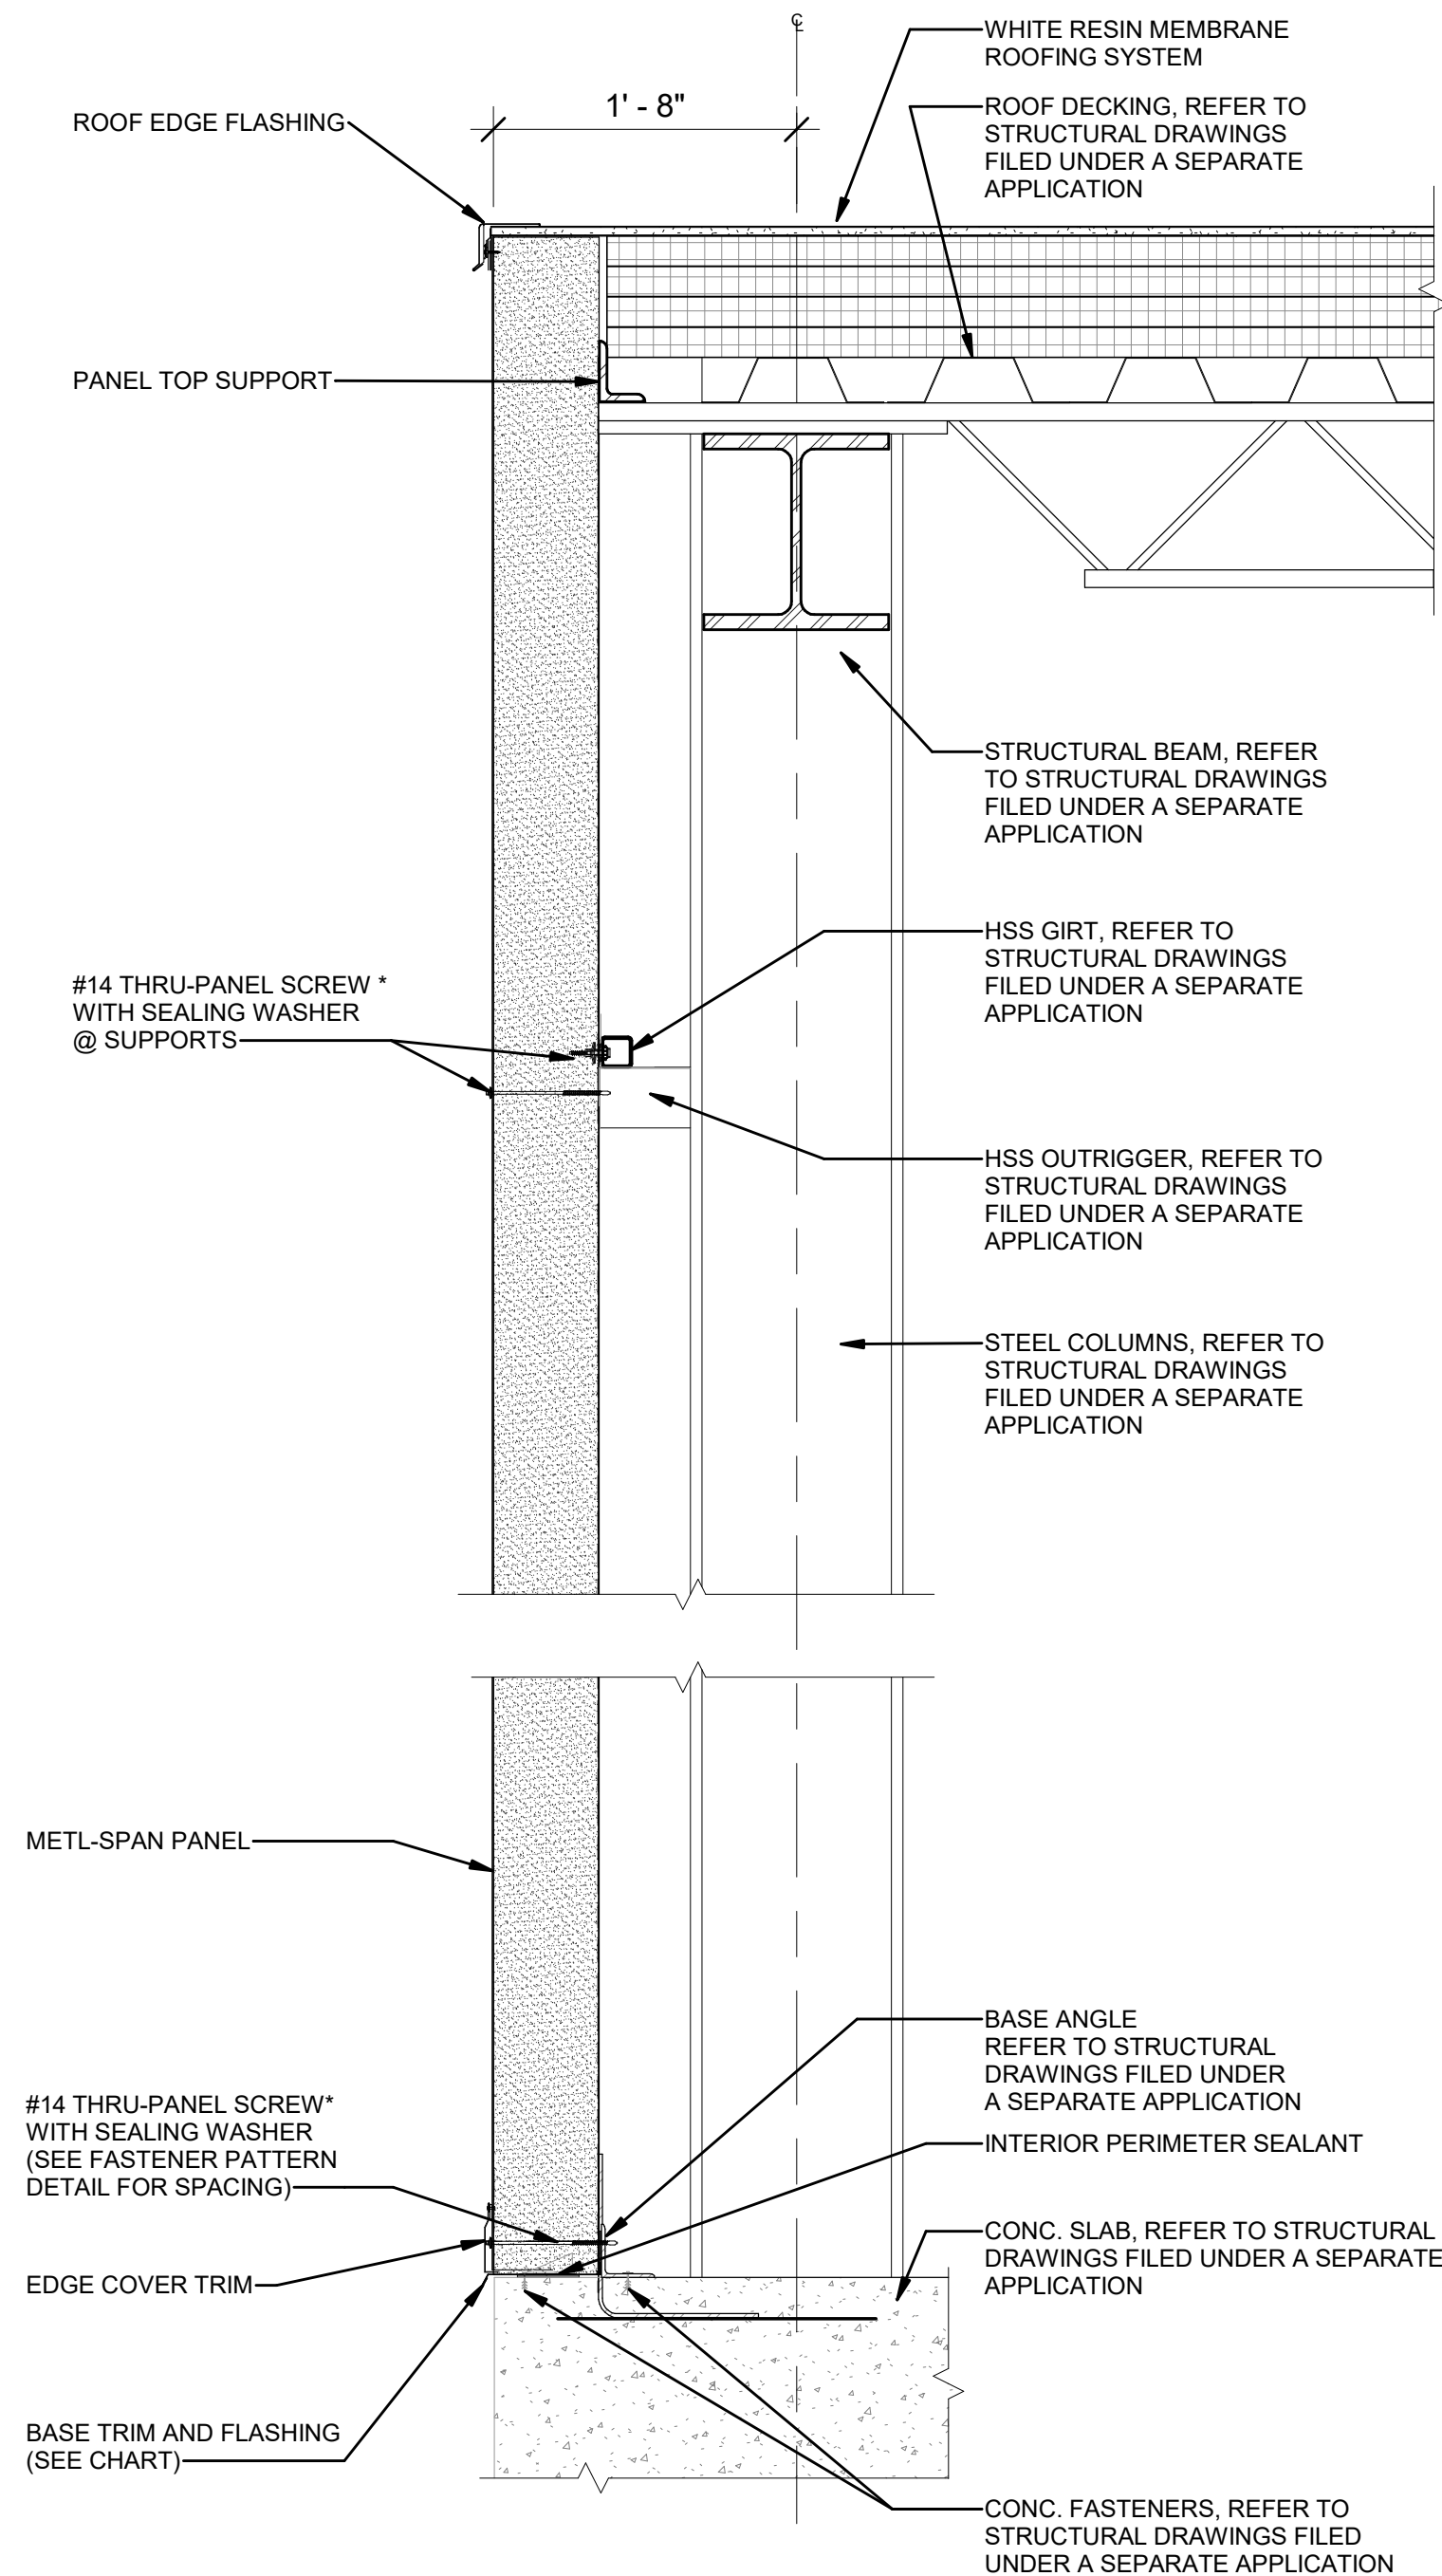

2 TYPICAL EXTERIOR WALL SECTION - CONVERTER BLDG.
1" = 1'-0"



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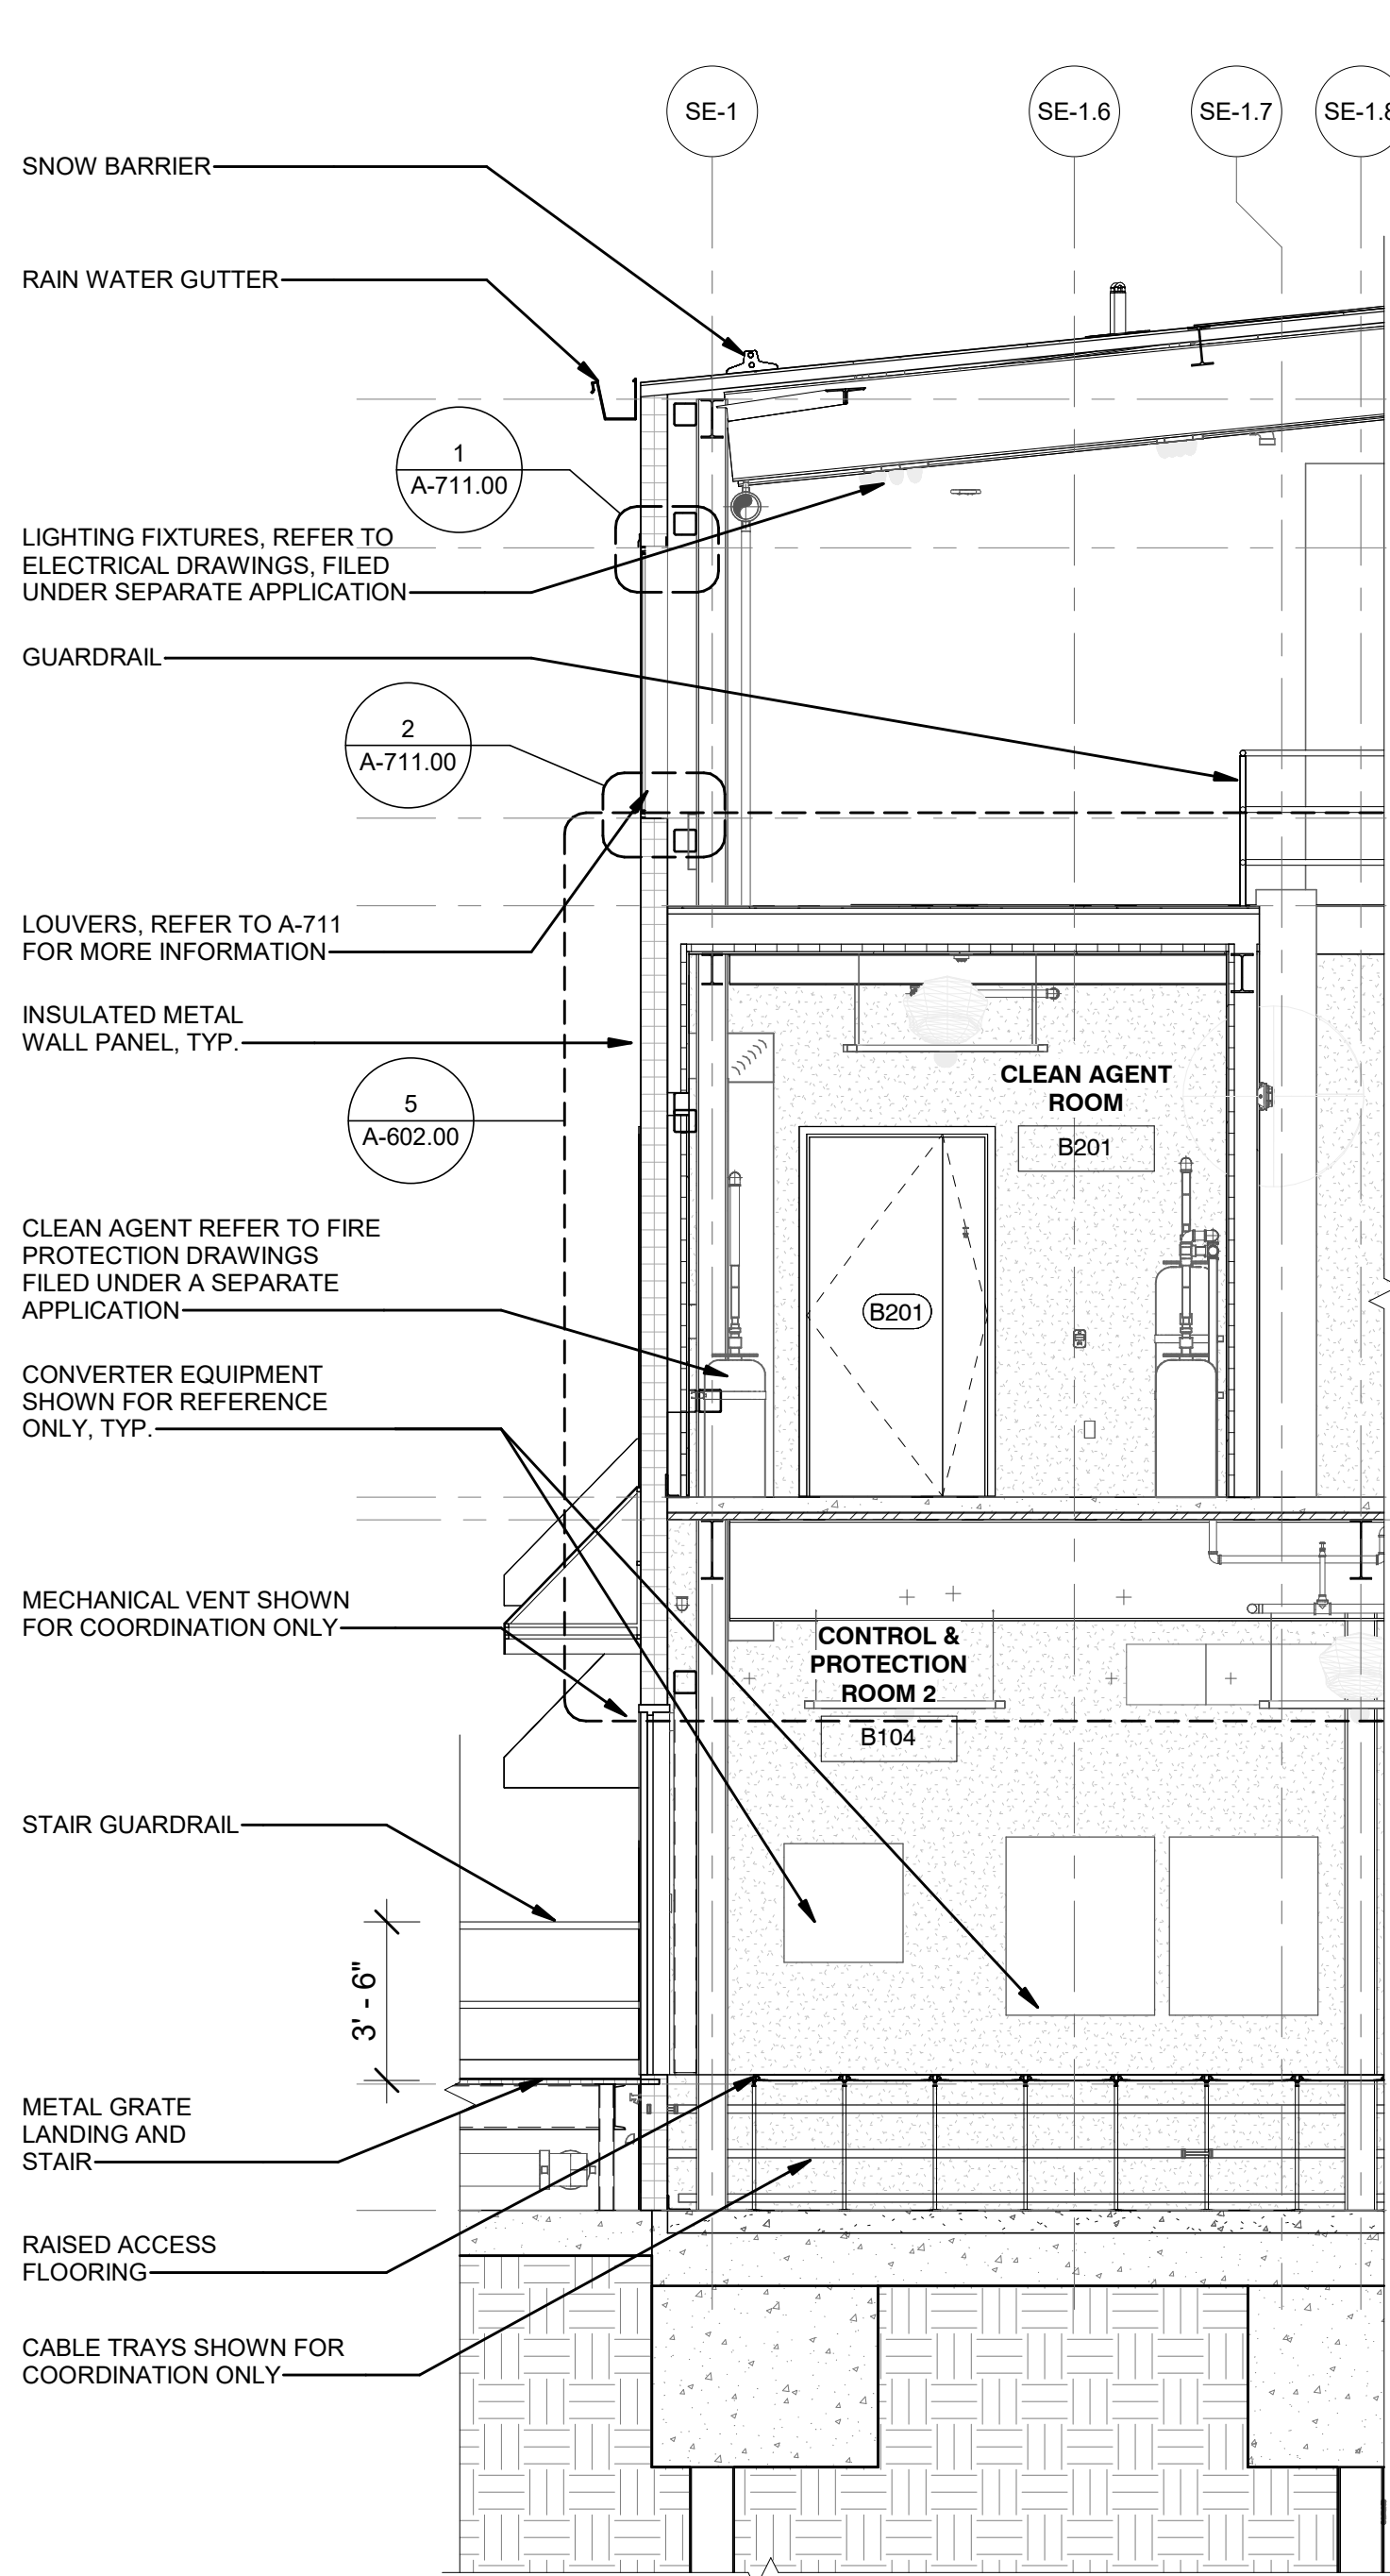
PROJECT
CHPE
Champlain Hudson
Power Express
Astoria HVDC Converter Station
31-45 20th Avenue, Astoria, Queens NY 11105
Block #850 - Lot #310 - BIN #4624437

CONVERTER BLDG. WALL
SECTIONS 2


REGISTERED ARCHITECT
SUZANNE SOWINSKI SULLIVAN
STATE OF NEW YORK
026049

DATE: 12/12/22
PROJECT NO: 105121
DRAWING BY: R. COLES
CHECKED BY: Z. HARR
DRAWING NO:
A-501.00
CADD FILE NO:
Astoria-HVDC-CHPE
Astoria-CHPE-111-ZZ-M3-A-001.rvt


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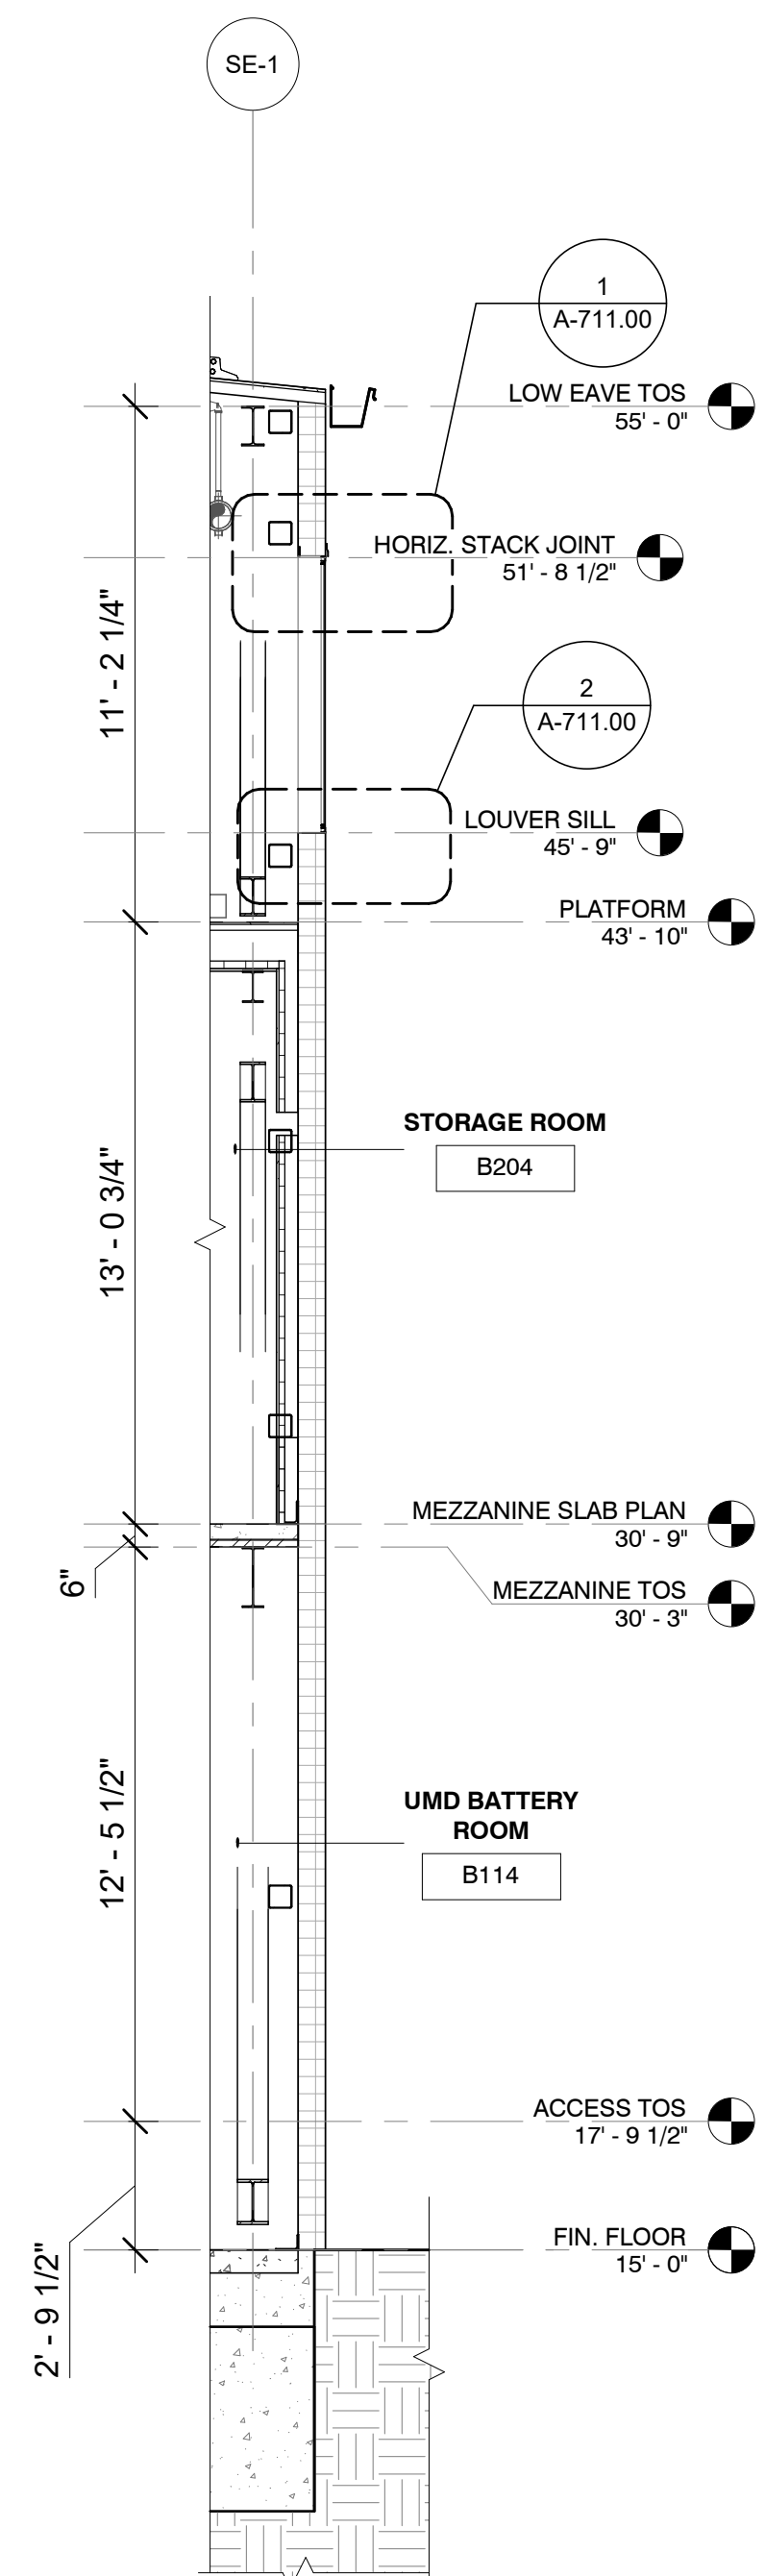
1 SERVICE BUILDING WALL SECTION
A-300.00 1/4" = 1'-0"




2 SERVICE BUILDING CORRIDOR WALL SECTION
A-160.00 1/4" = 1'-0"

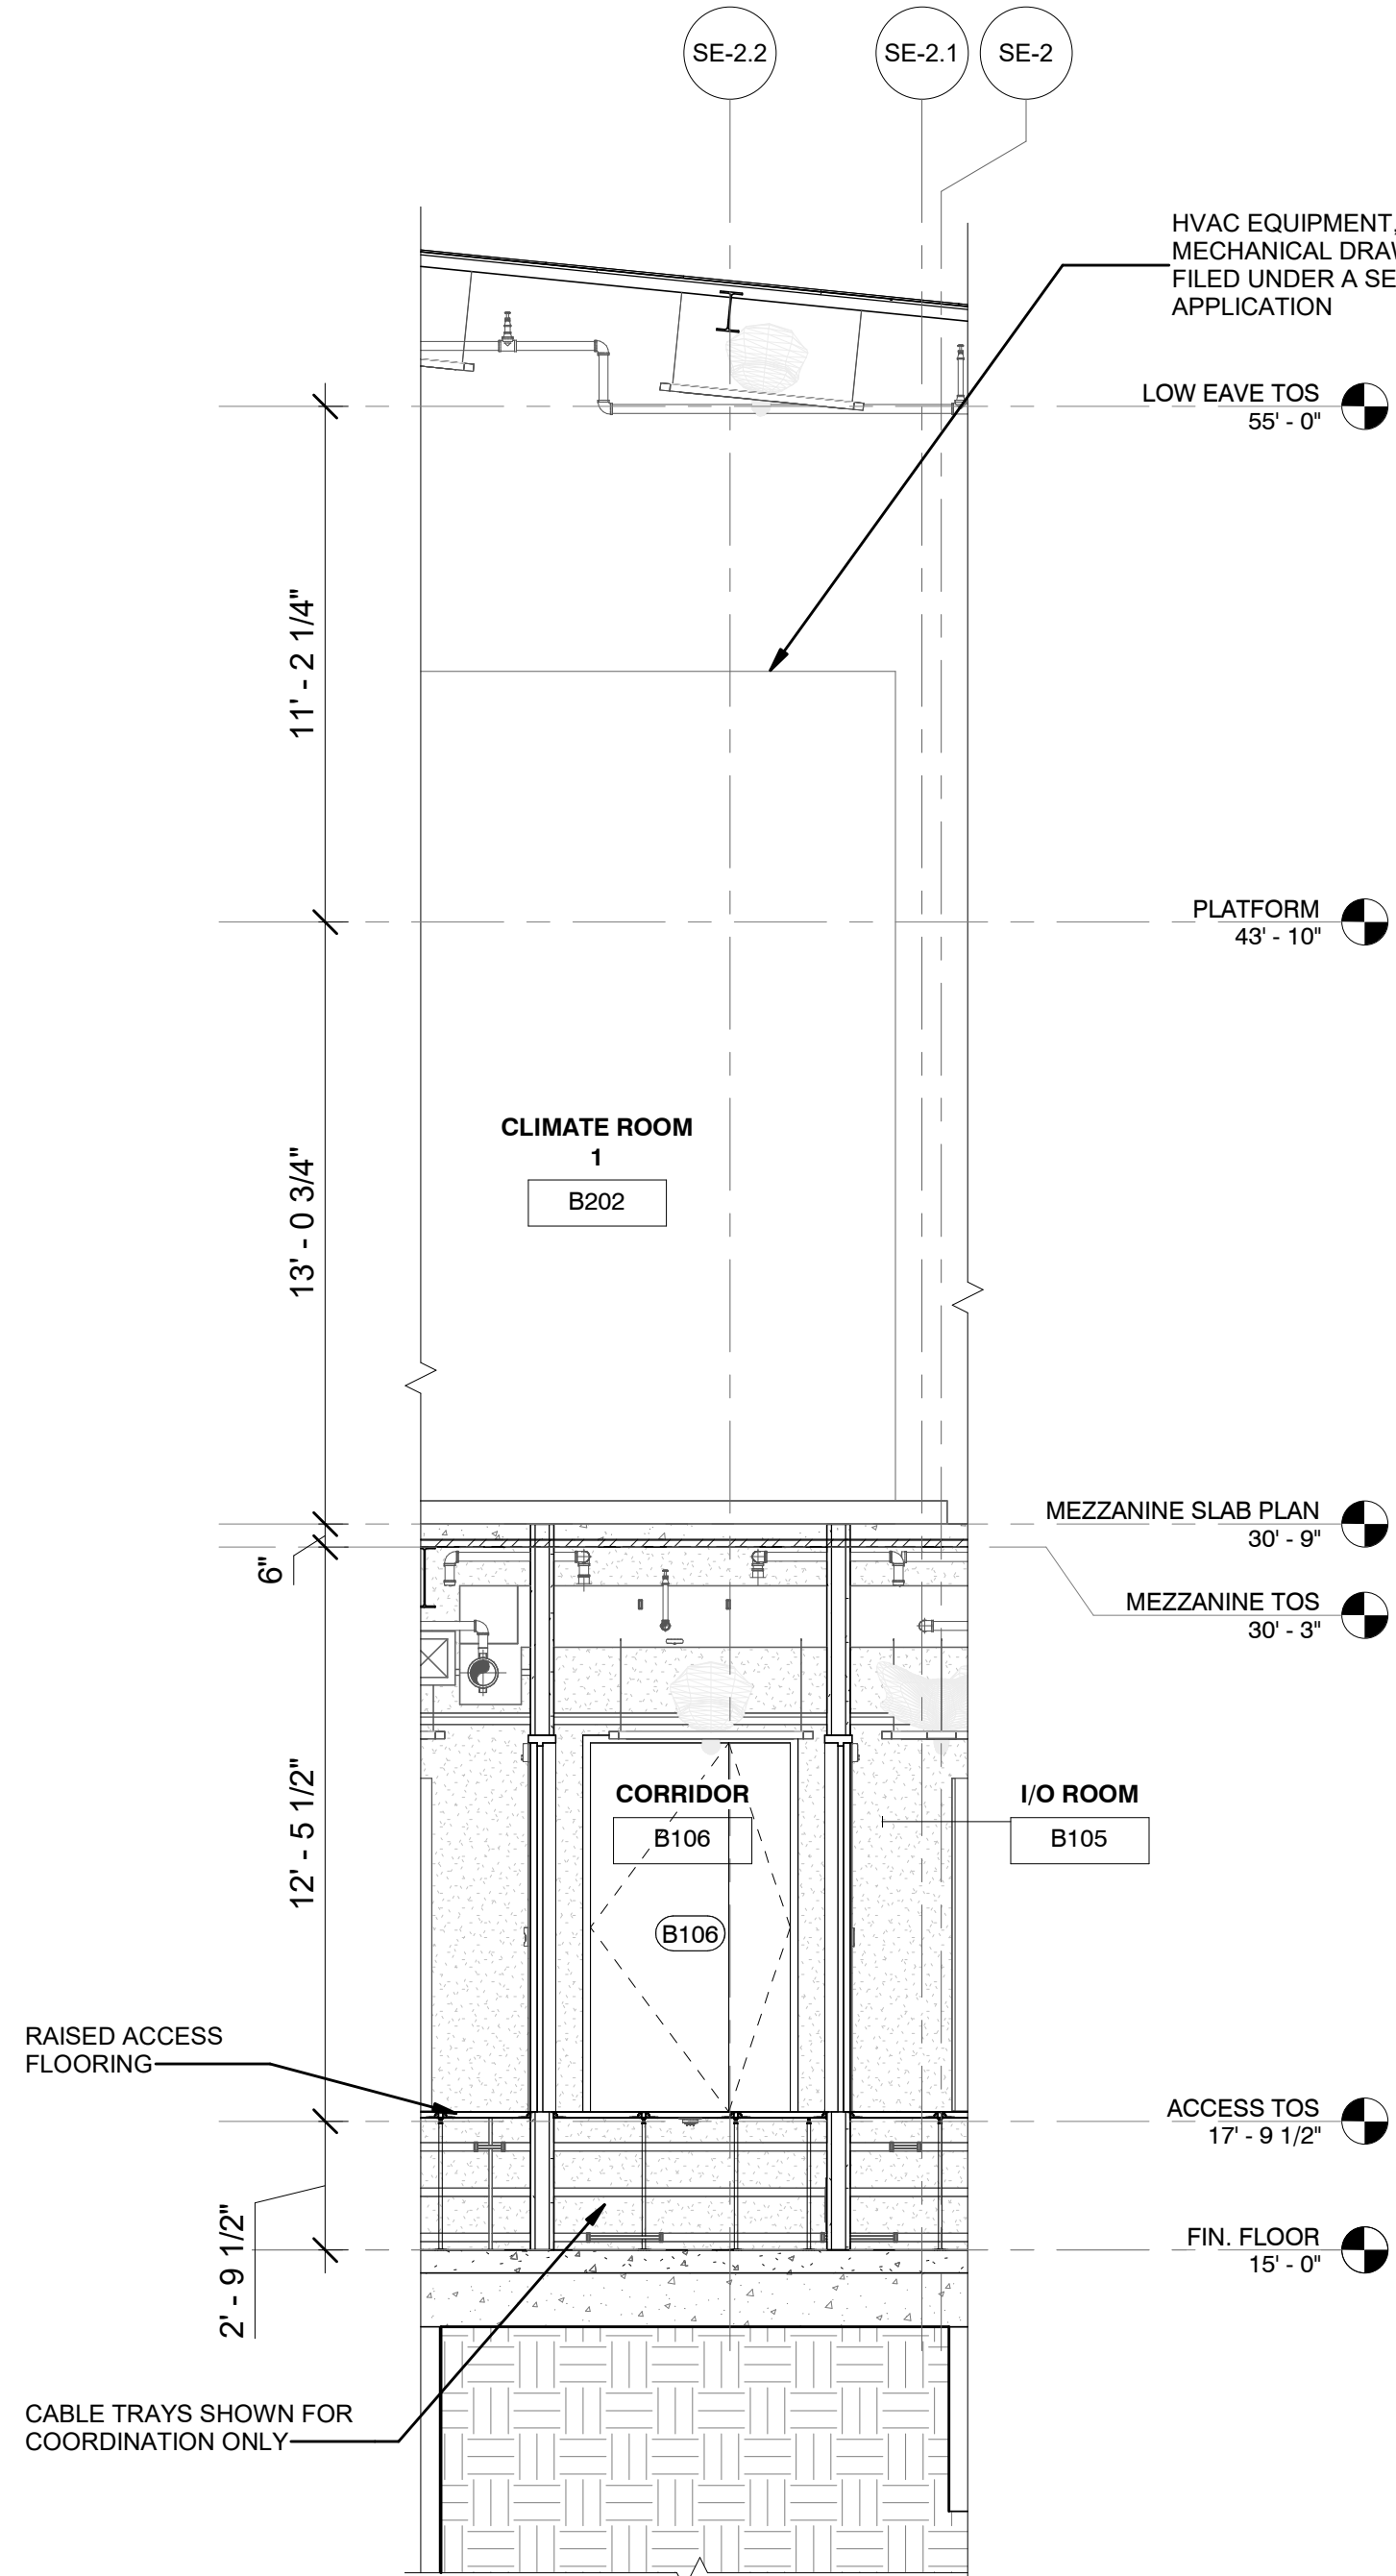

3 SERVICE BUILDING SIDE WALL SECTION
A-109.00 1/4" = 1'-0"

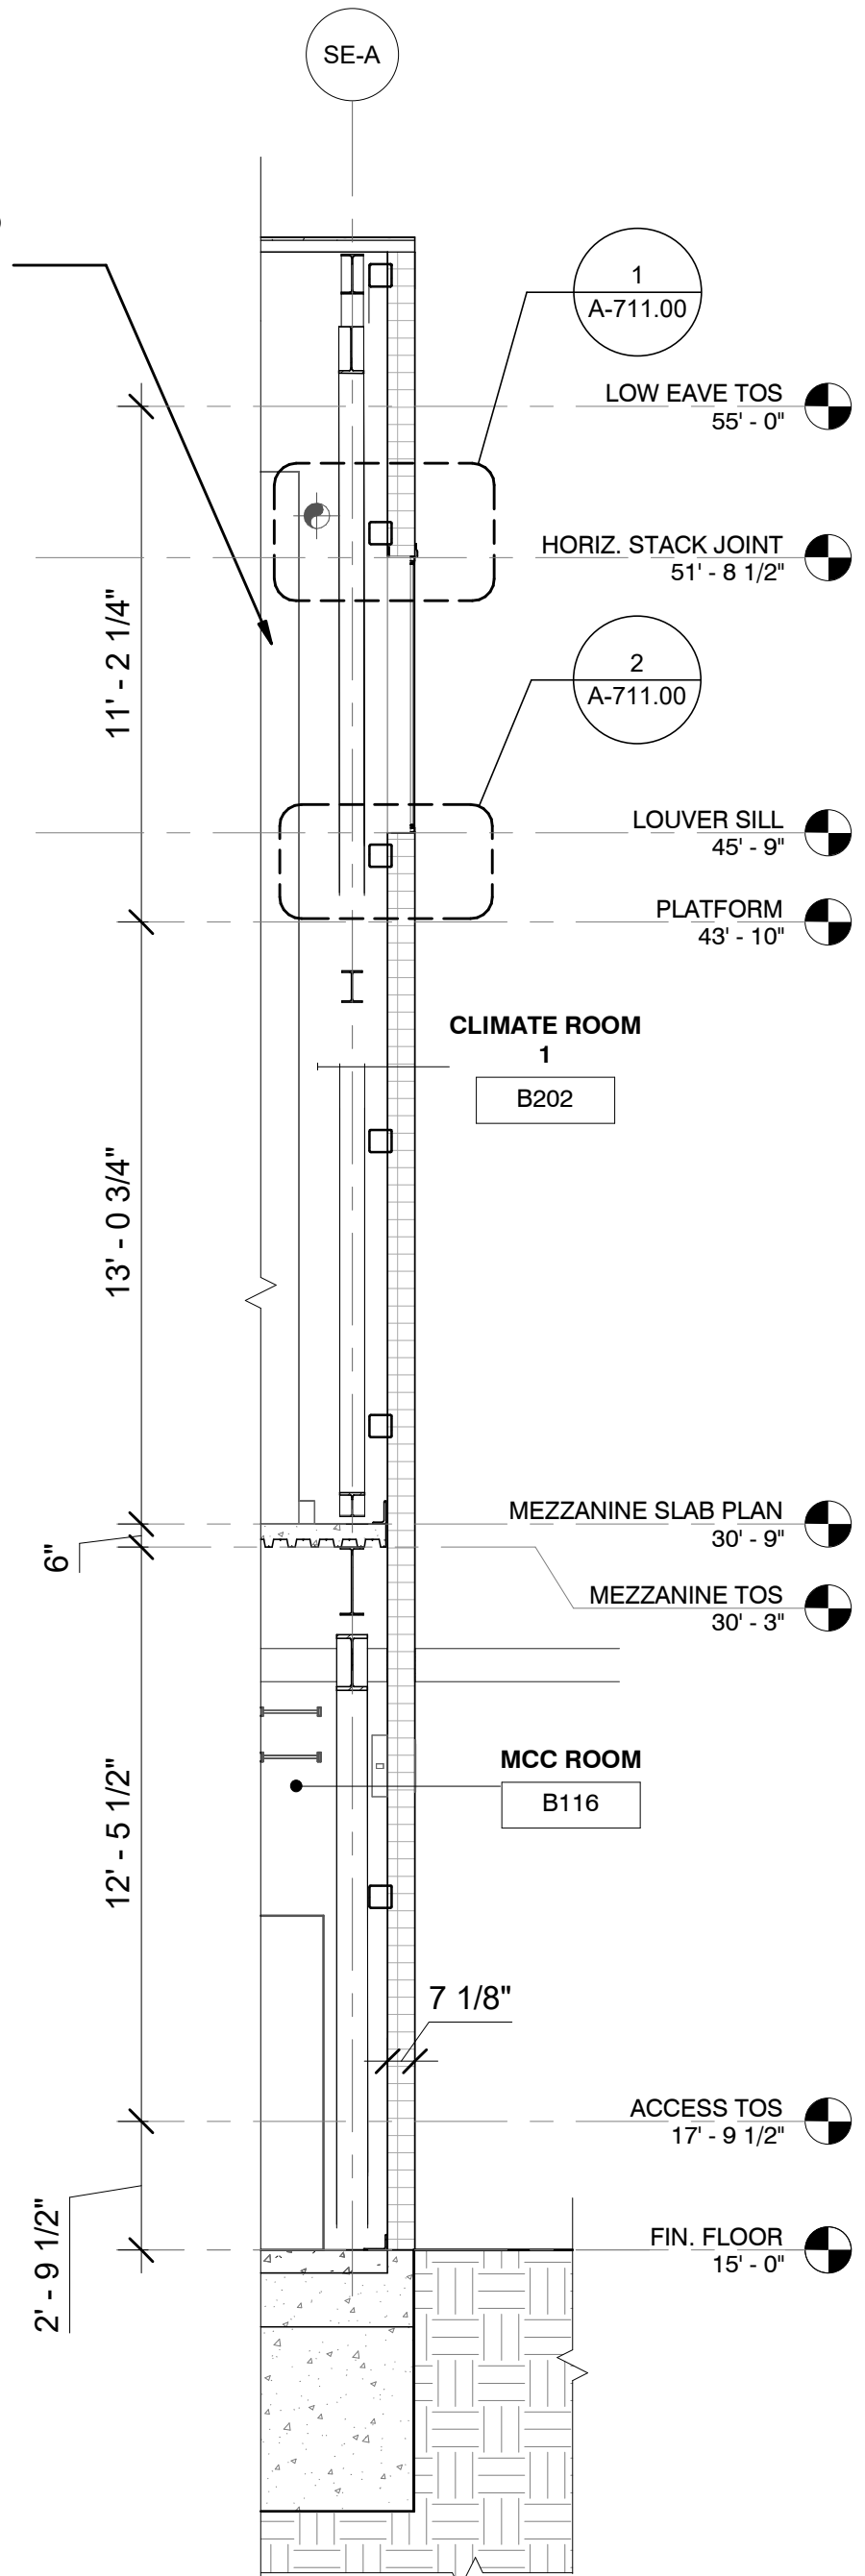

4 UMD BATTERY ROOM SECTION
A-109.00 1/4" = 1'-0"

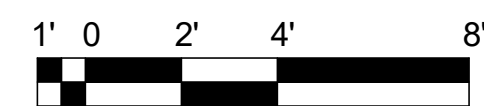

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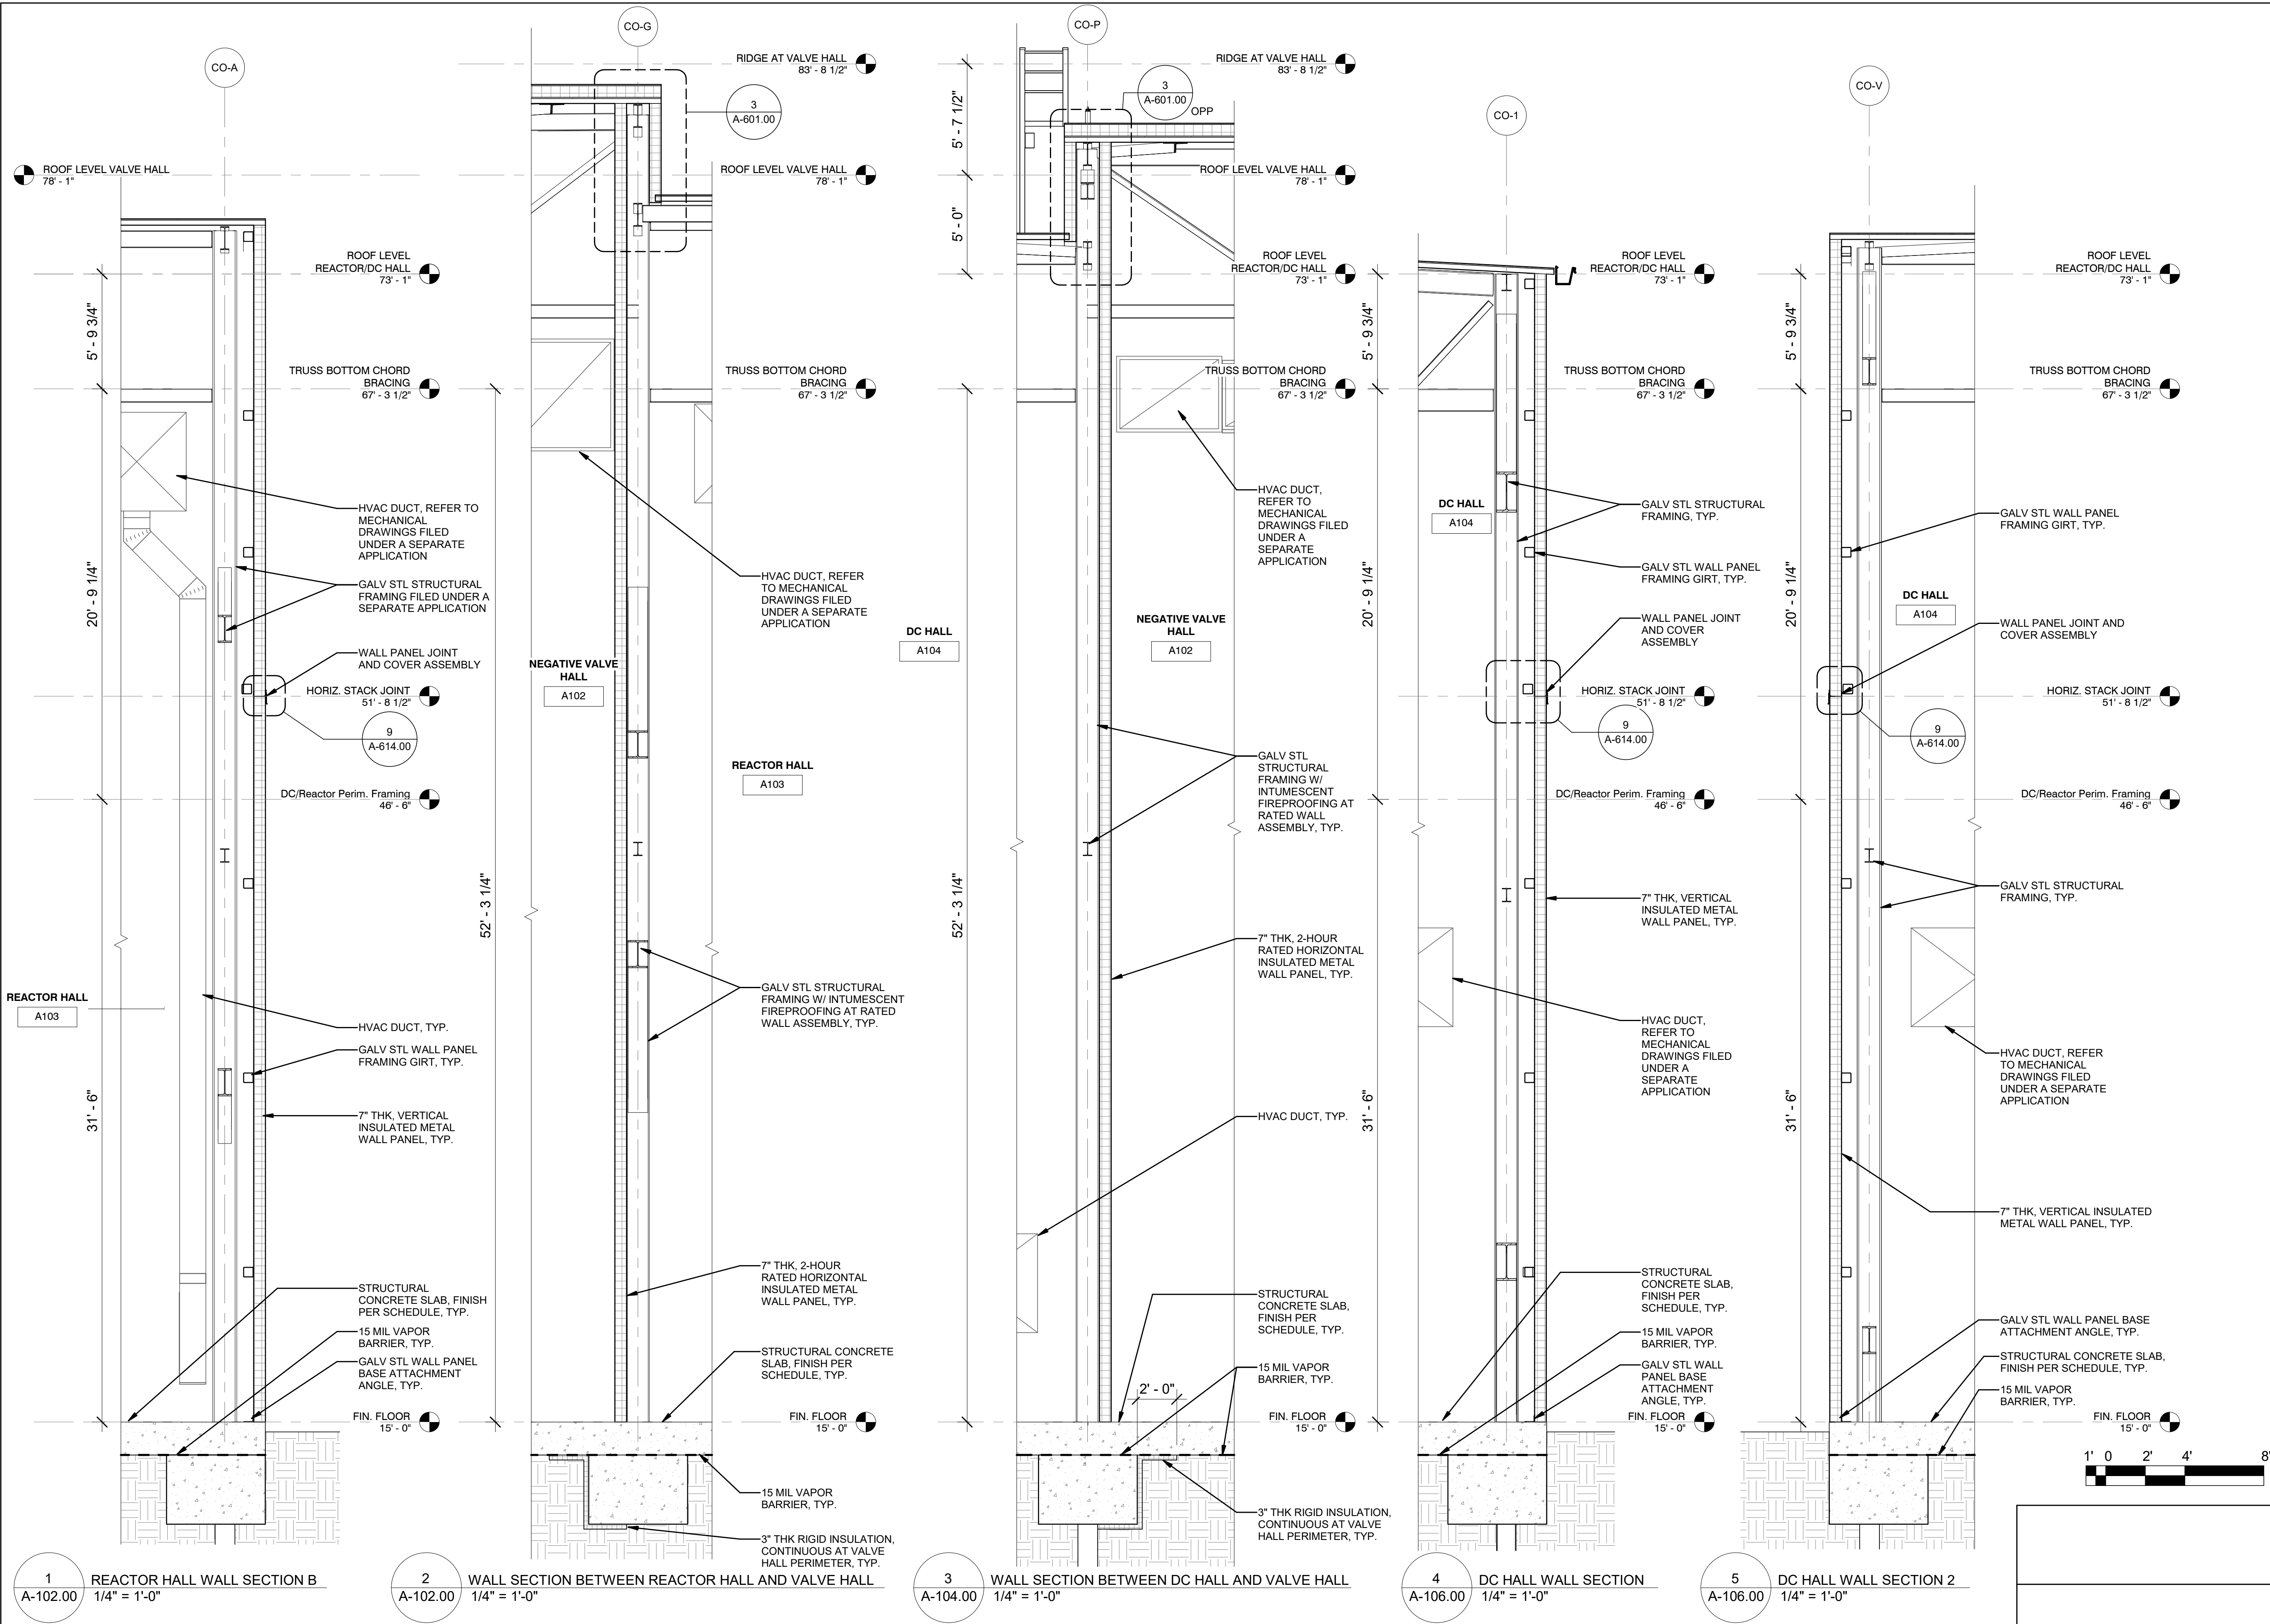
Astoria HVDC
Converter Station

31-45 20th Avenue, Astoria, Queens NY 11105
Block #850 - Lot #310 - BIN #4624437

SERVICE BLDG. - WALL
SECTIONS



DATE 12/12/22
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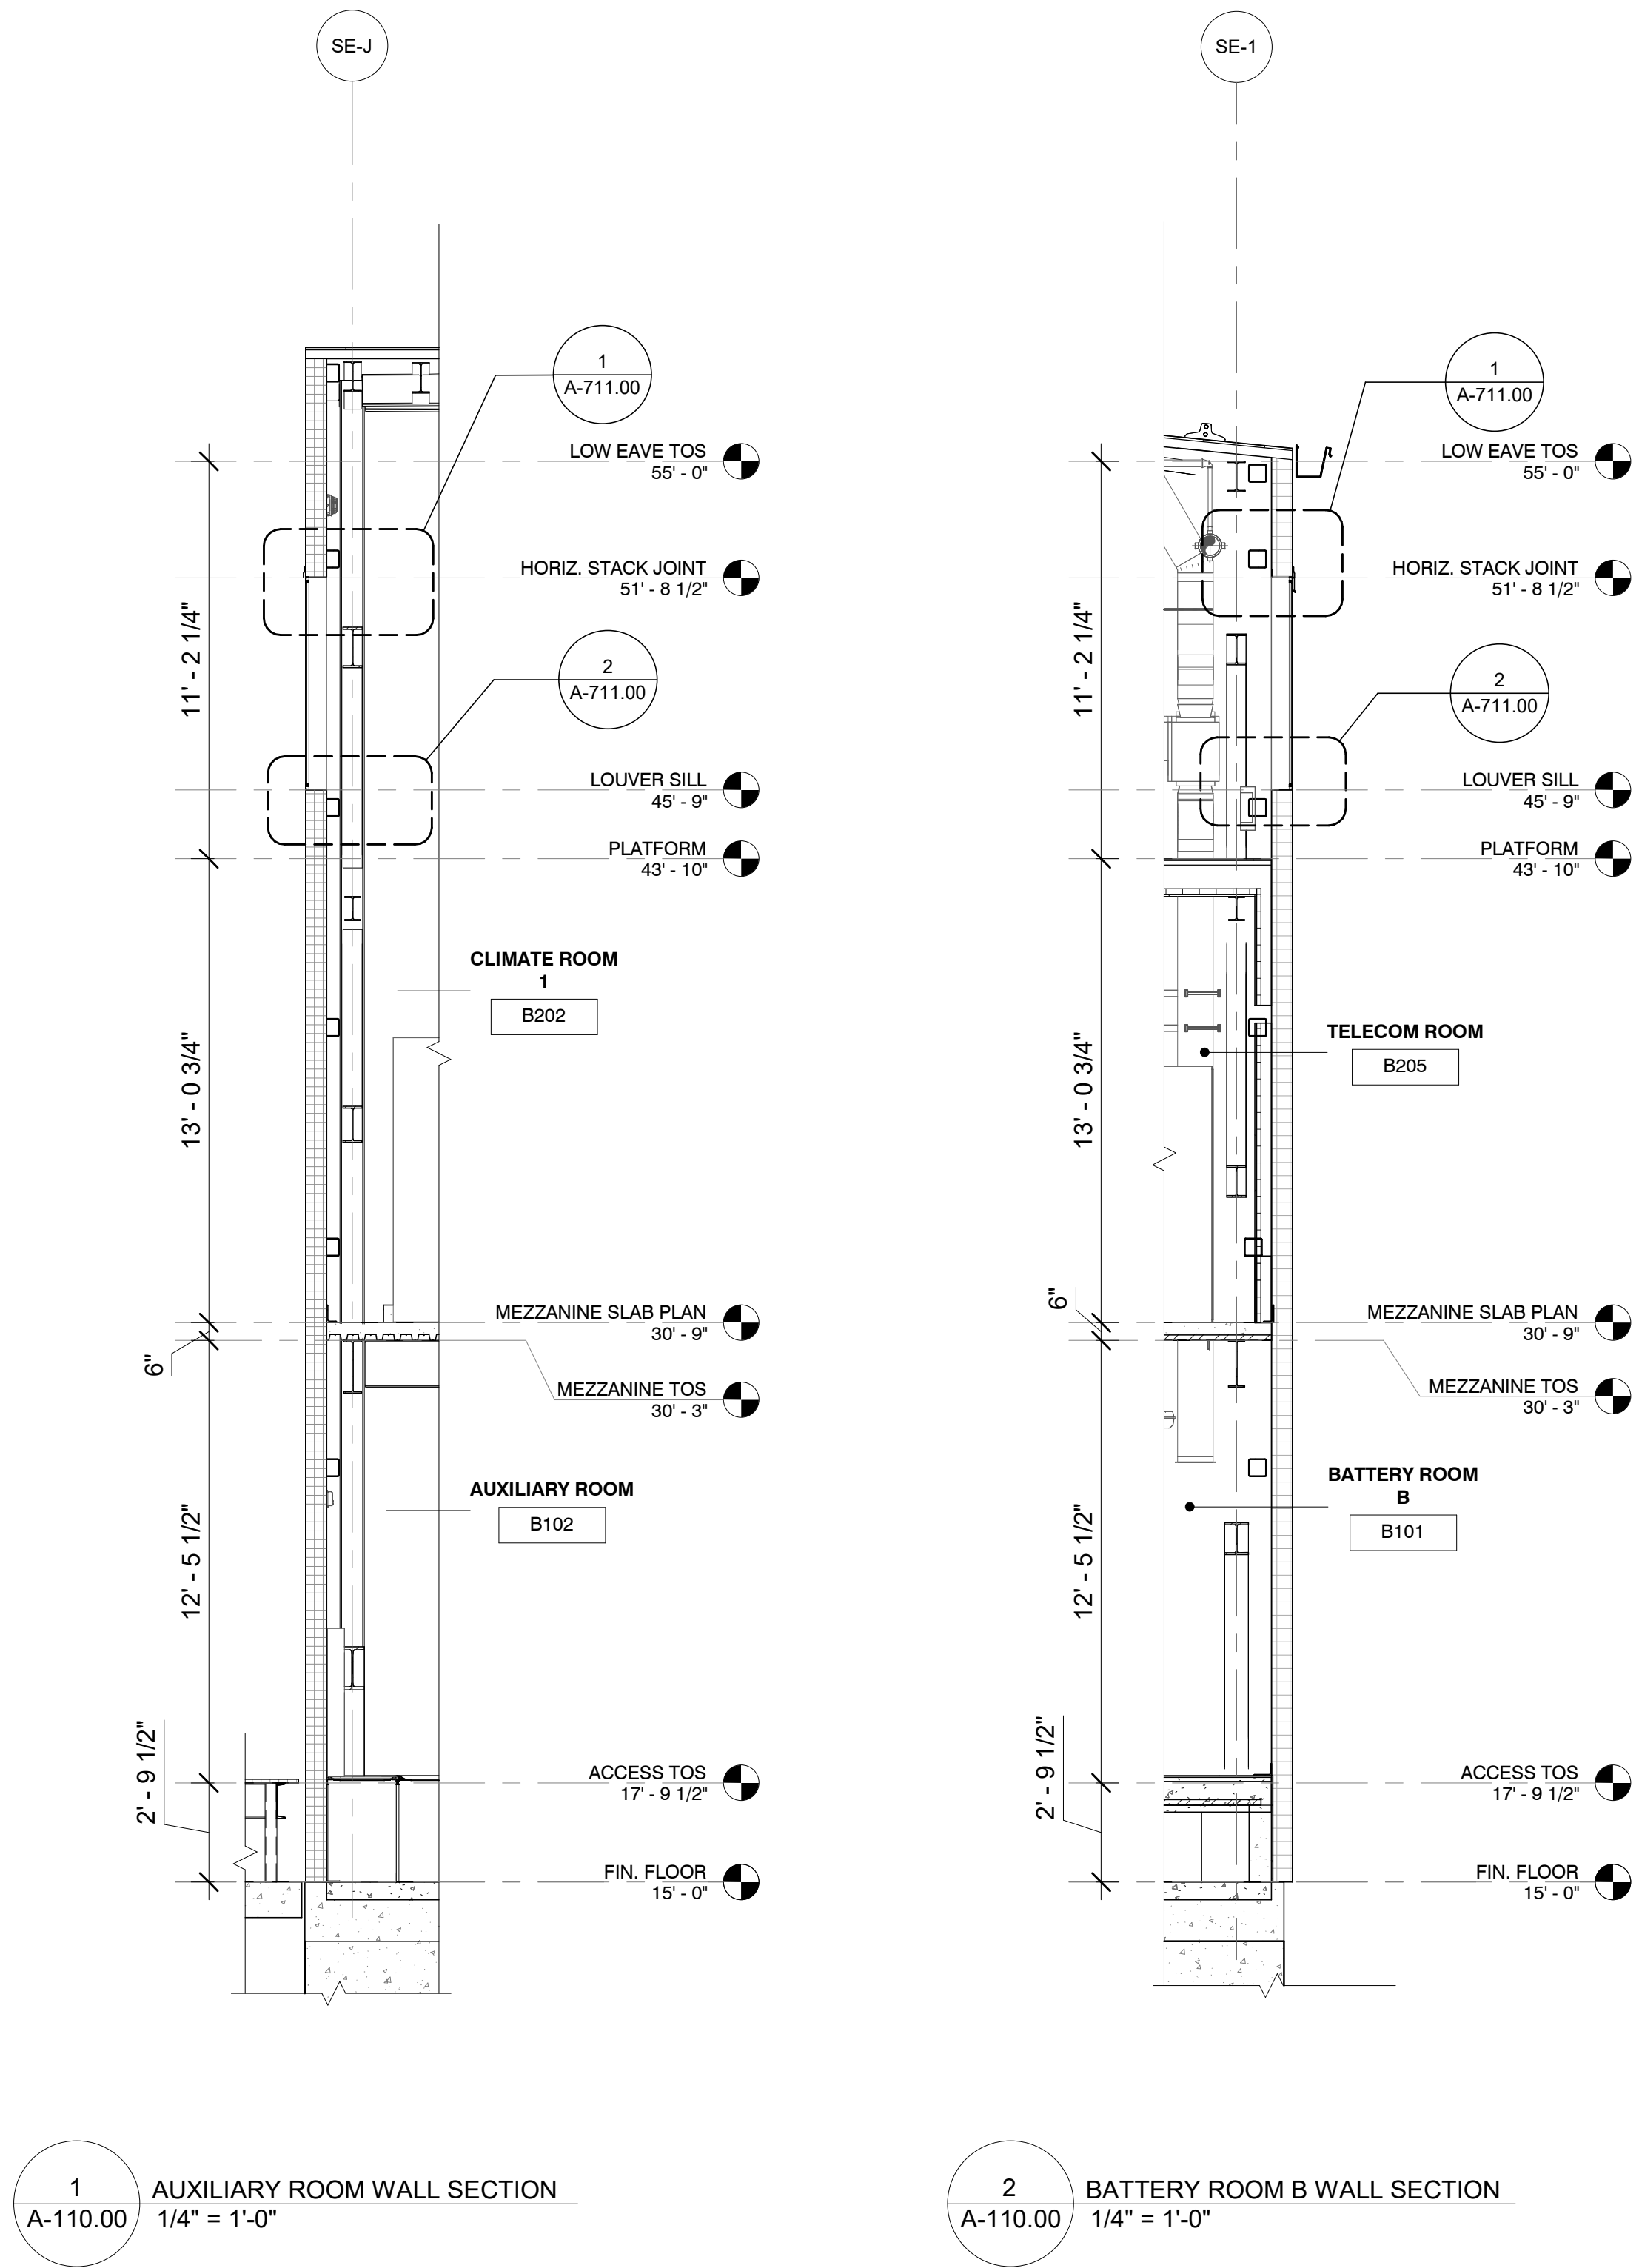
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PROJECT
CHPE
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Power Express
**Astoria HVDC
Converter Station**
31-45 20th Avenue, Astoria, Queens NY 11105
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CONVERTER BLDG. WALL
SECTIONS 3

REGISTERED ARCHITECT
SUZANNE SOWINSKI SULLIVAN
STATE OF NEW YORK
026049
DATE 12/12/22
PROJECT NO 105121
DRAWING BY R. COLES
CHECKED BY Z. HARR
DRAWING NO
A-509.00
CADD FILE NO
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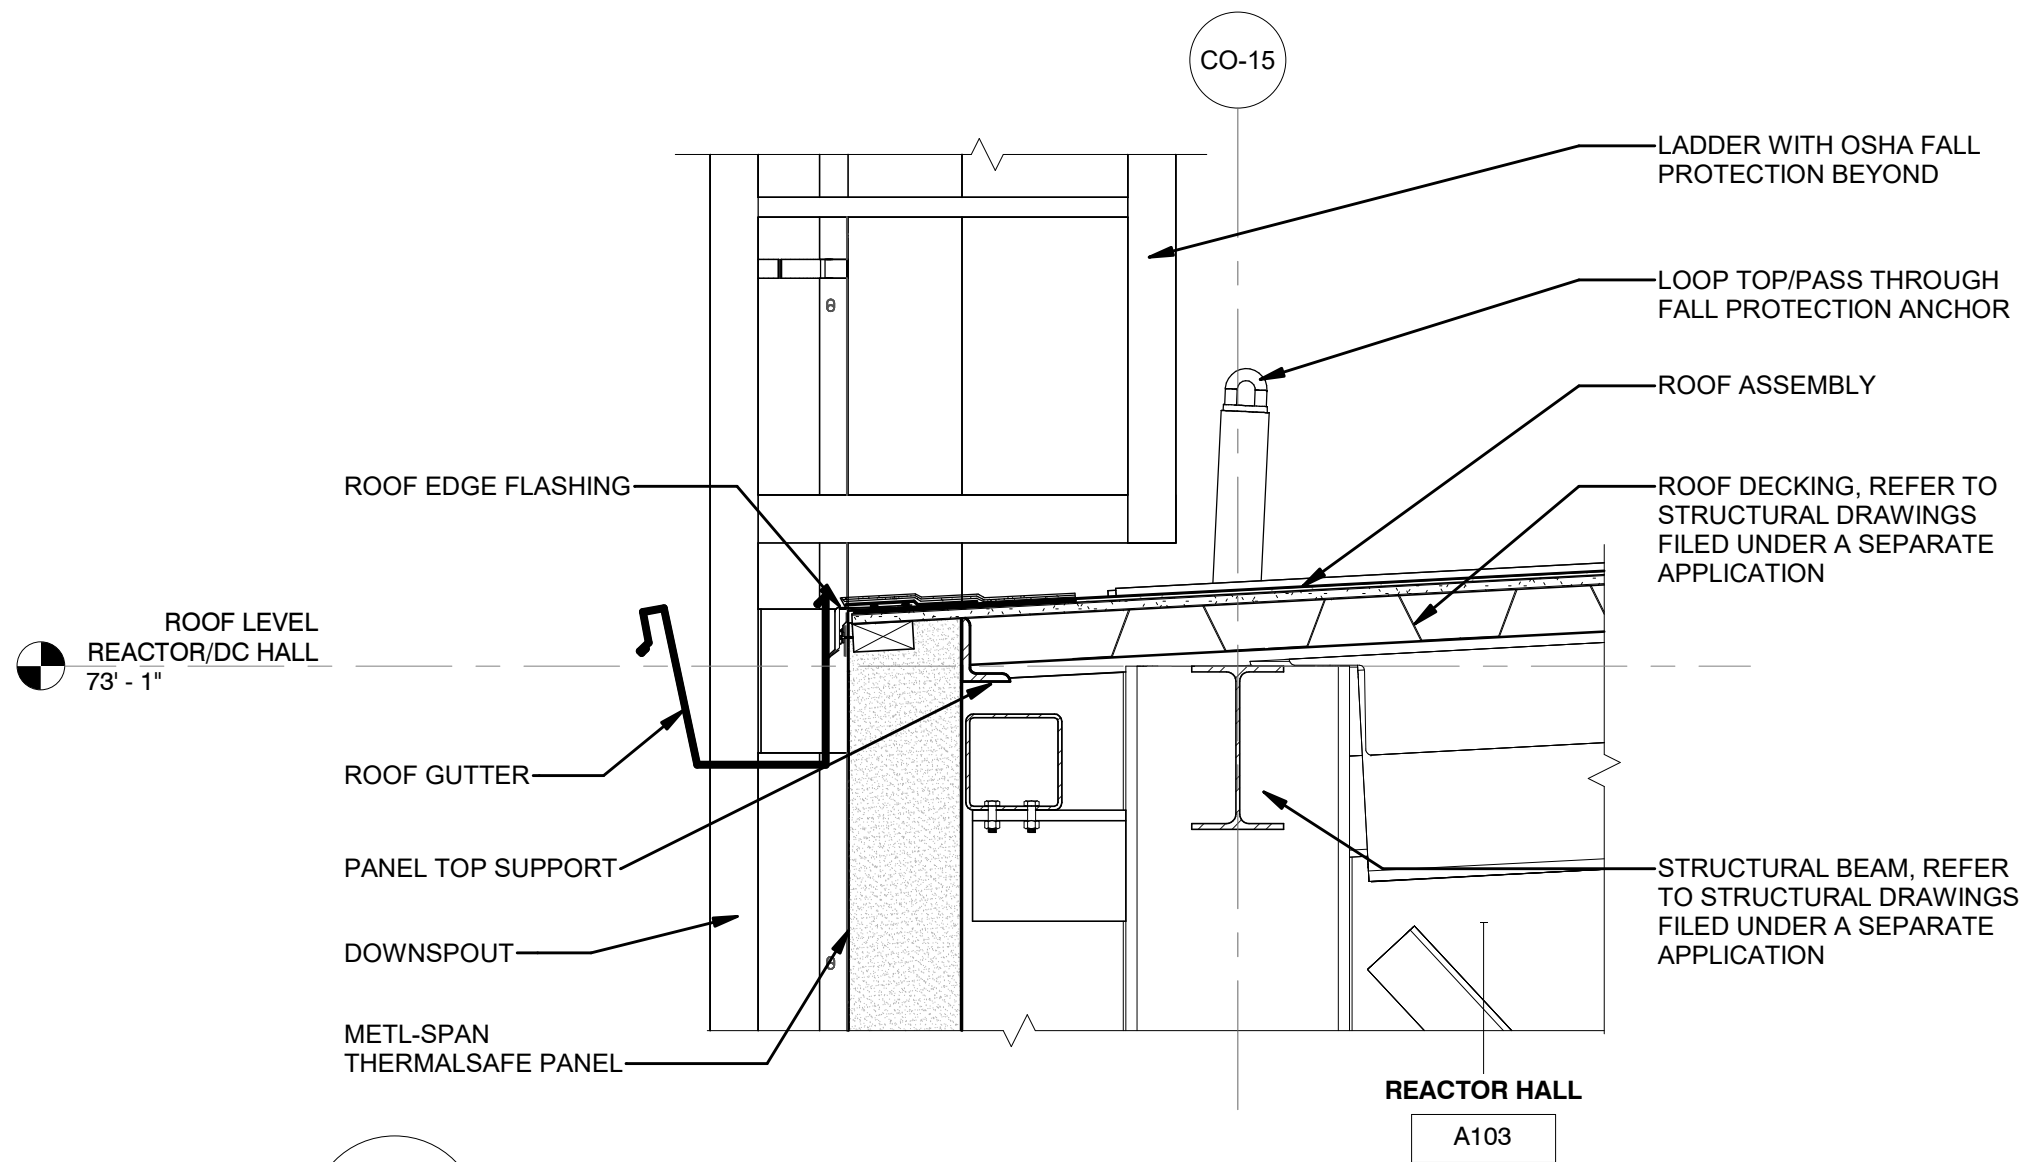
**Astoria HVDC
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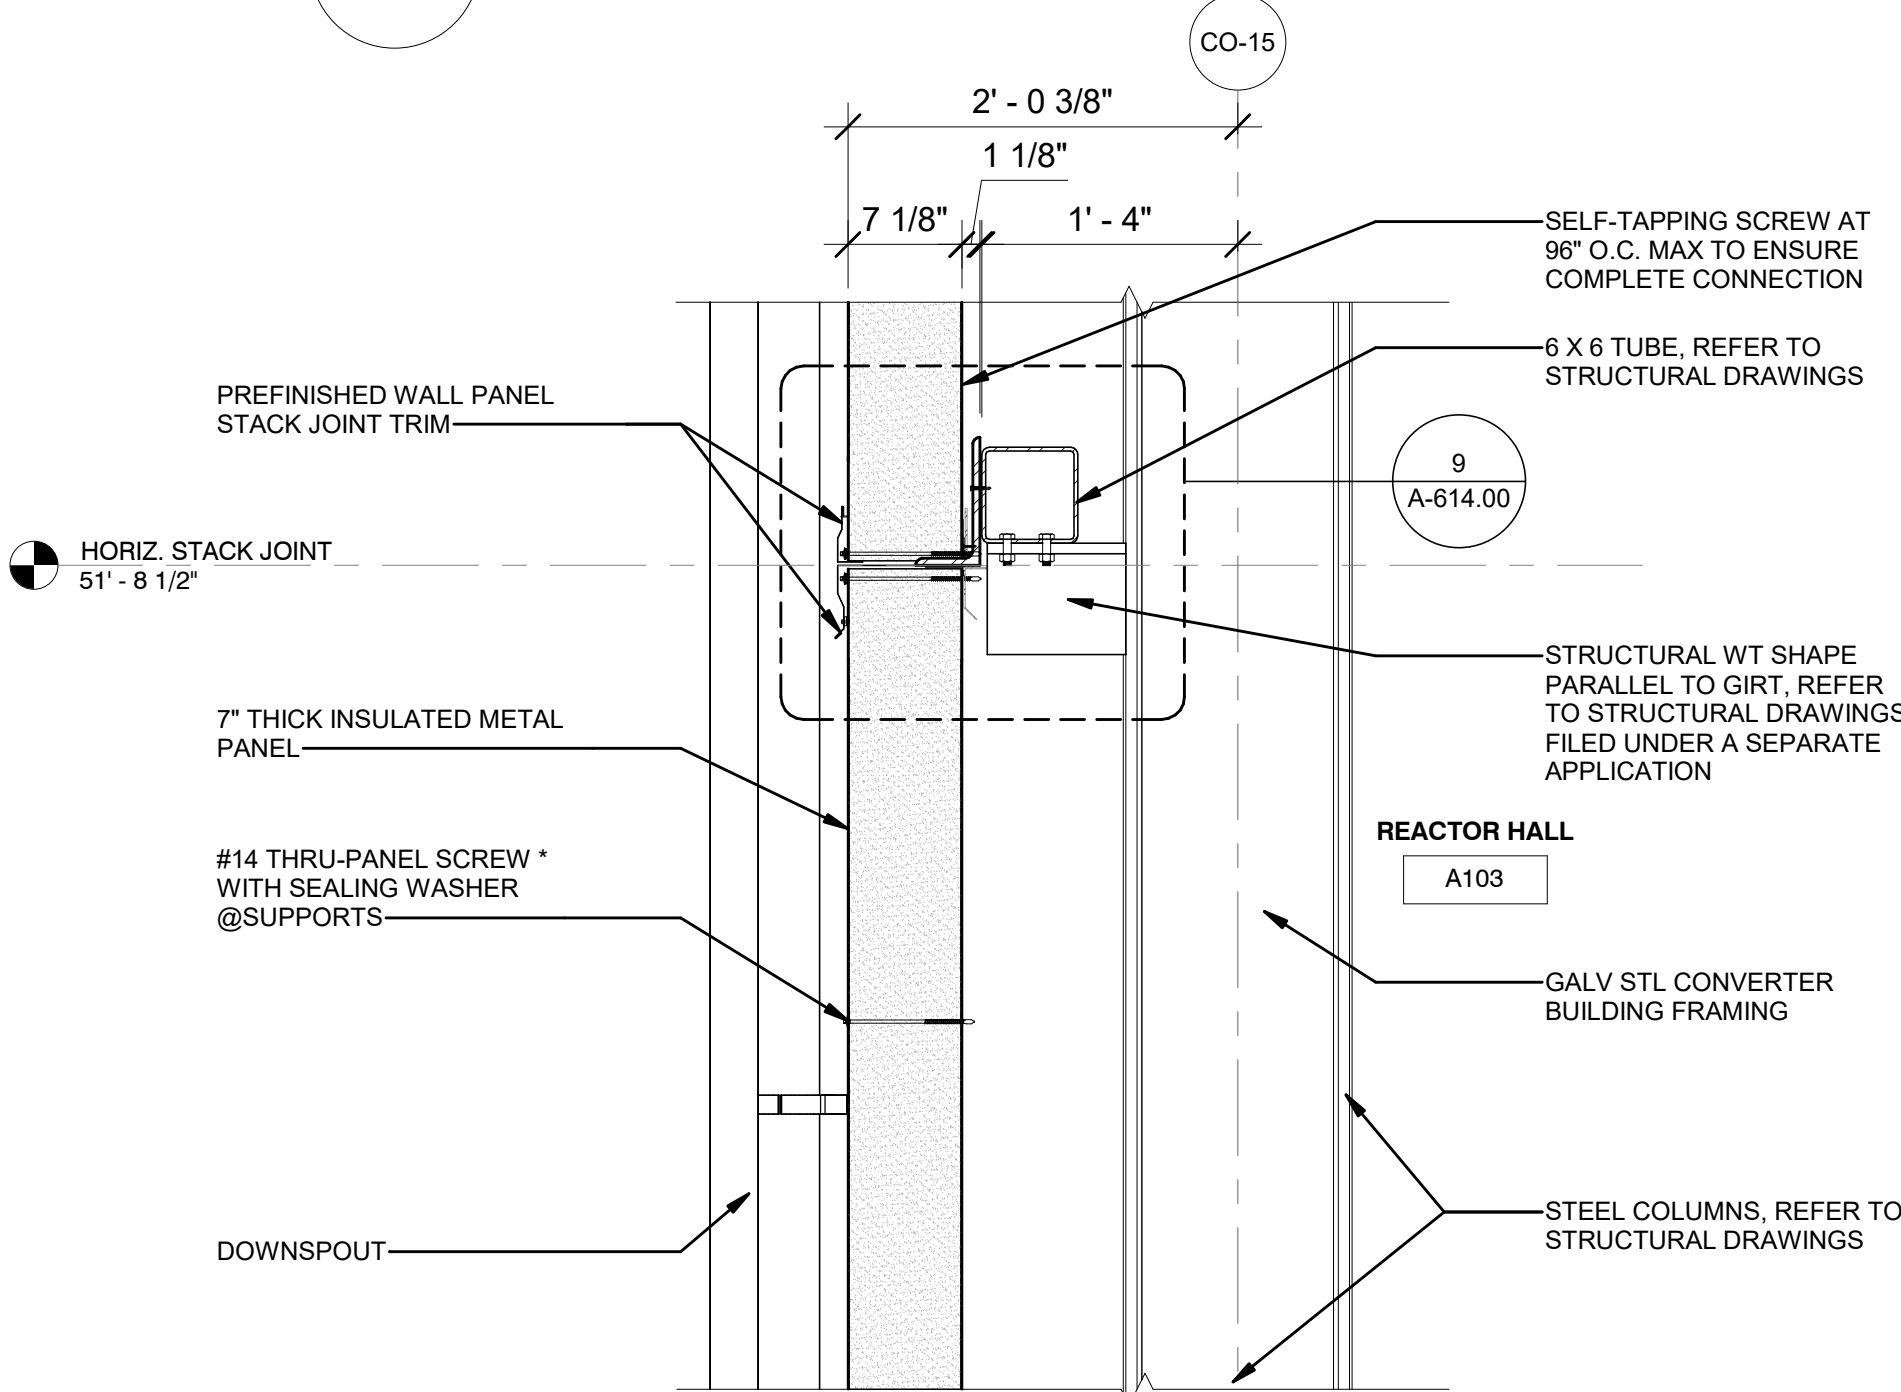
**SERVICE BLDG. - WALL
SECTIONS 2**




DATE 12/12/22
PROJECT NO 105121
DRAWING BY R. COLES
CHECKED BY Z. HARR
DRAWING NO
A-510.00
CADD FILE NO
Astoria-HVDC-CHPE
Astoria-CHPE-111-ZZ-M3-A-001.rvt




4 SECTION - REACTOR HALL - ROOF DETAIL
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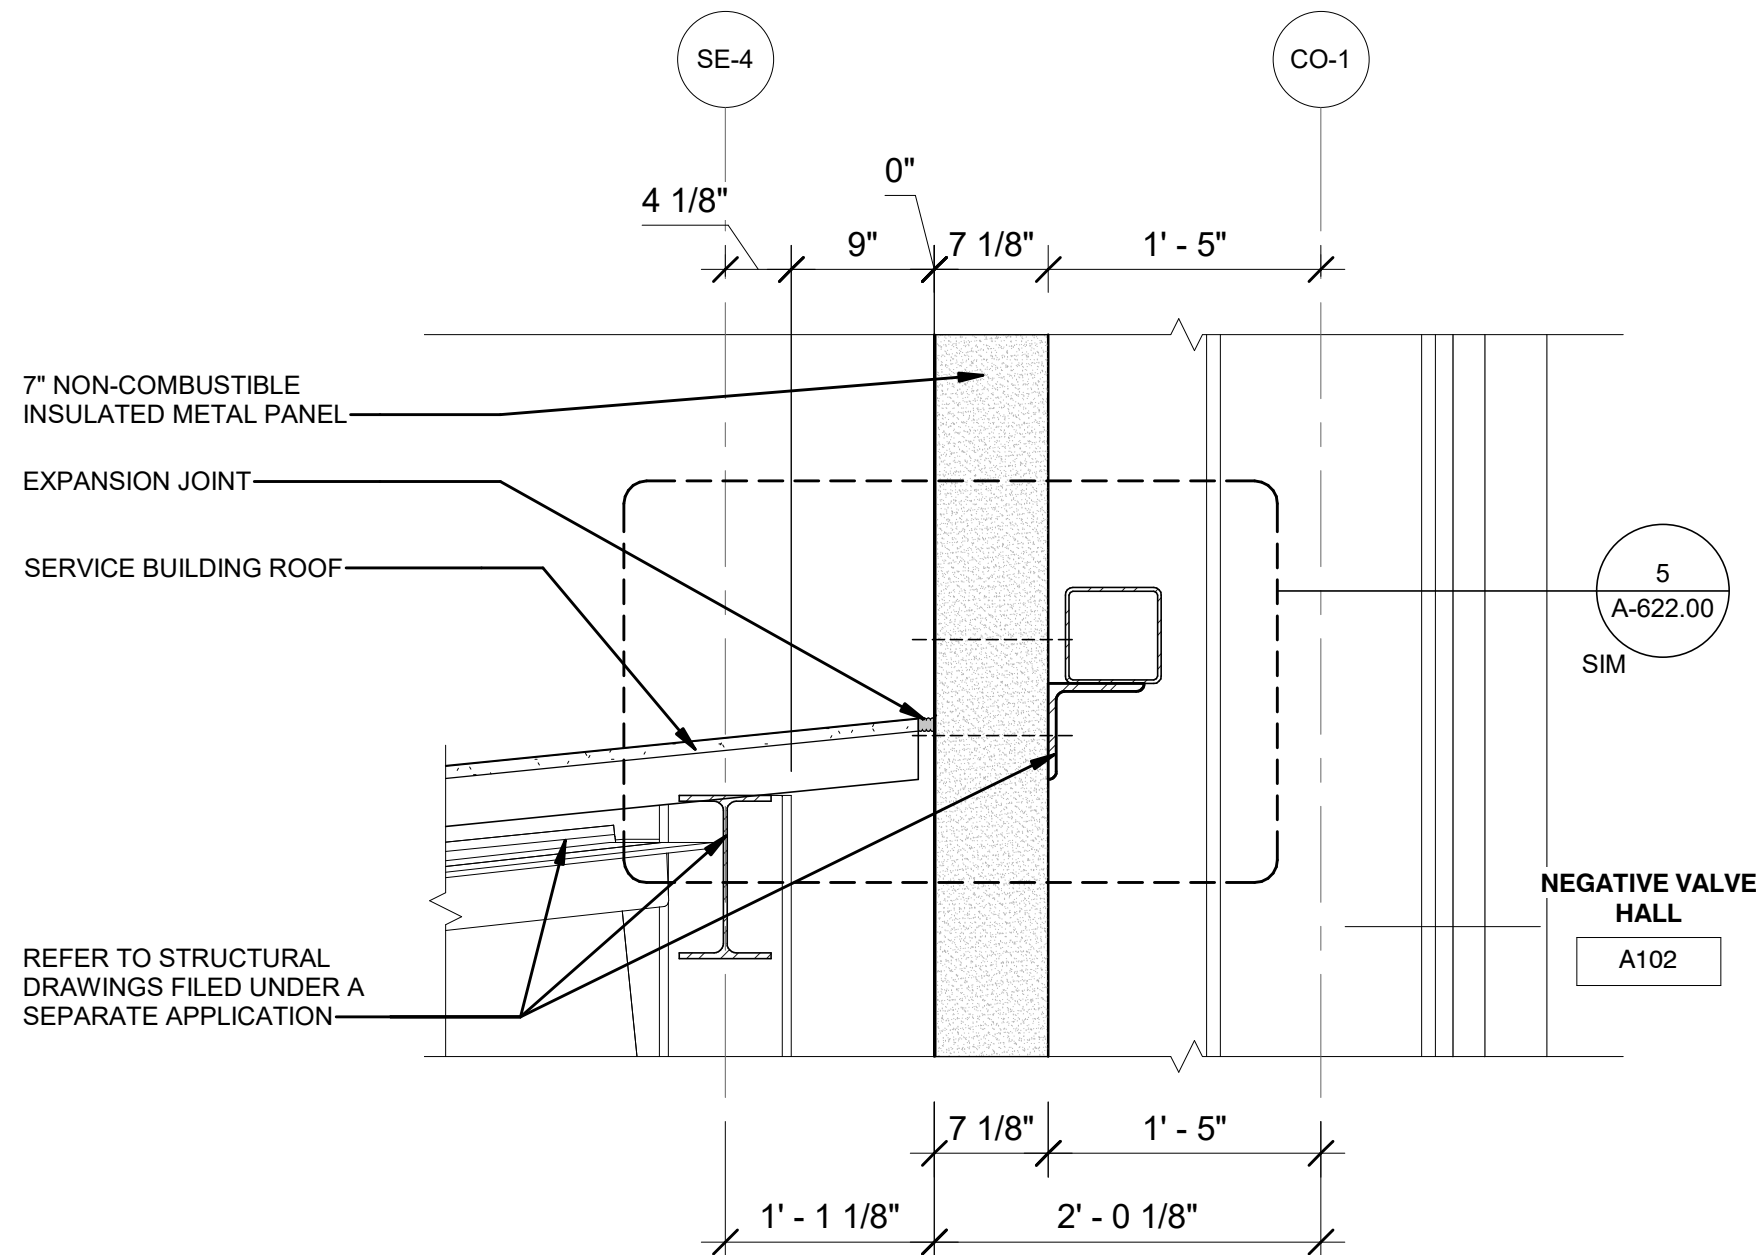
6 SECTION - REACTOR HALL - DETAIL
1" = 1'-0"




5 SECTION - REACTOR HALL - BASE DETAIL
1" = 1'-0"

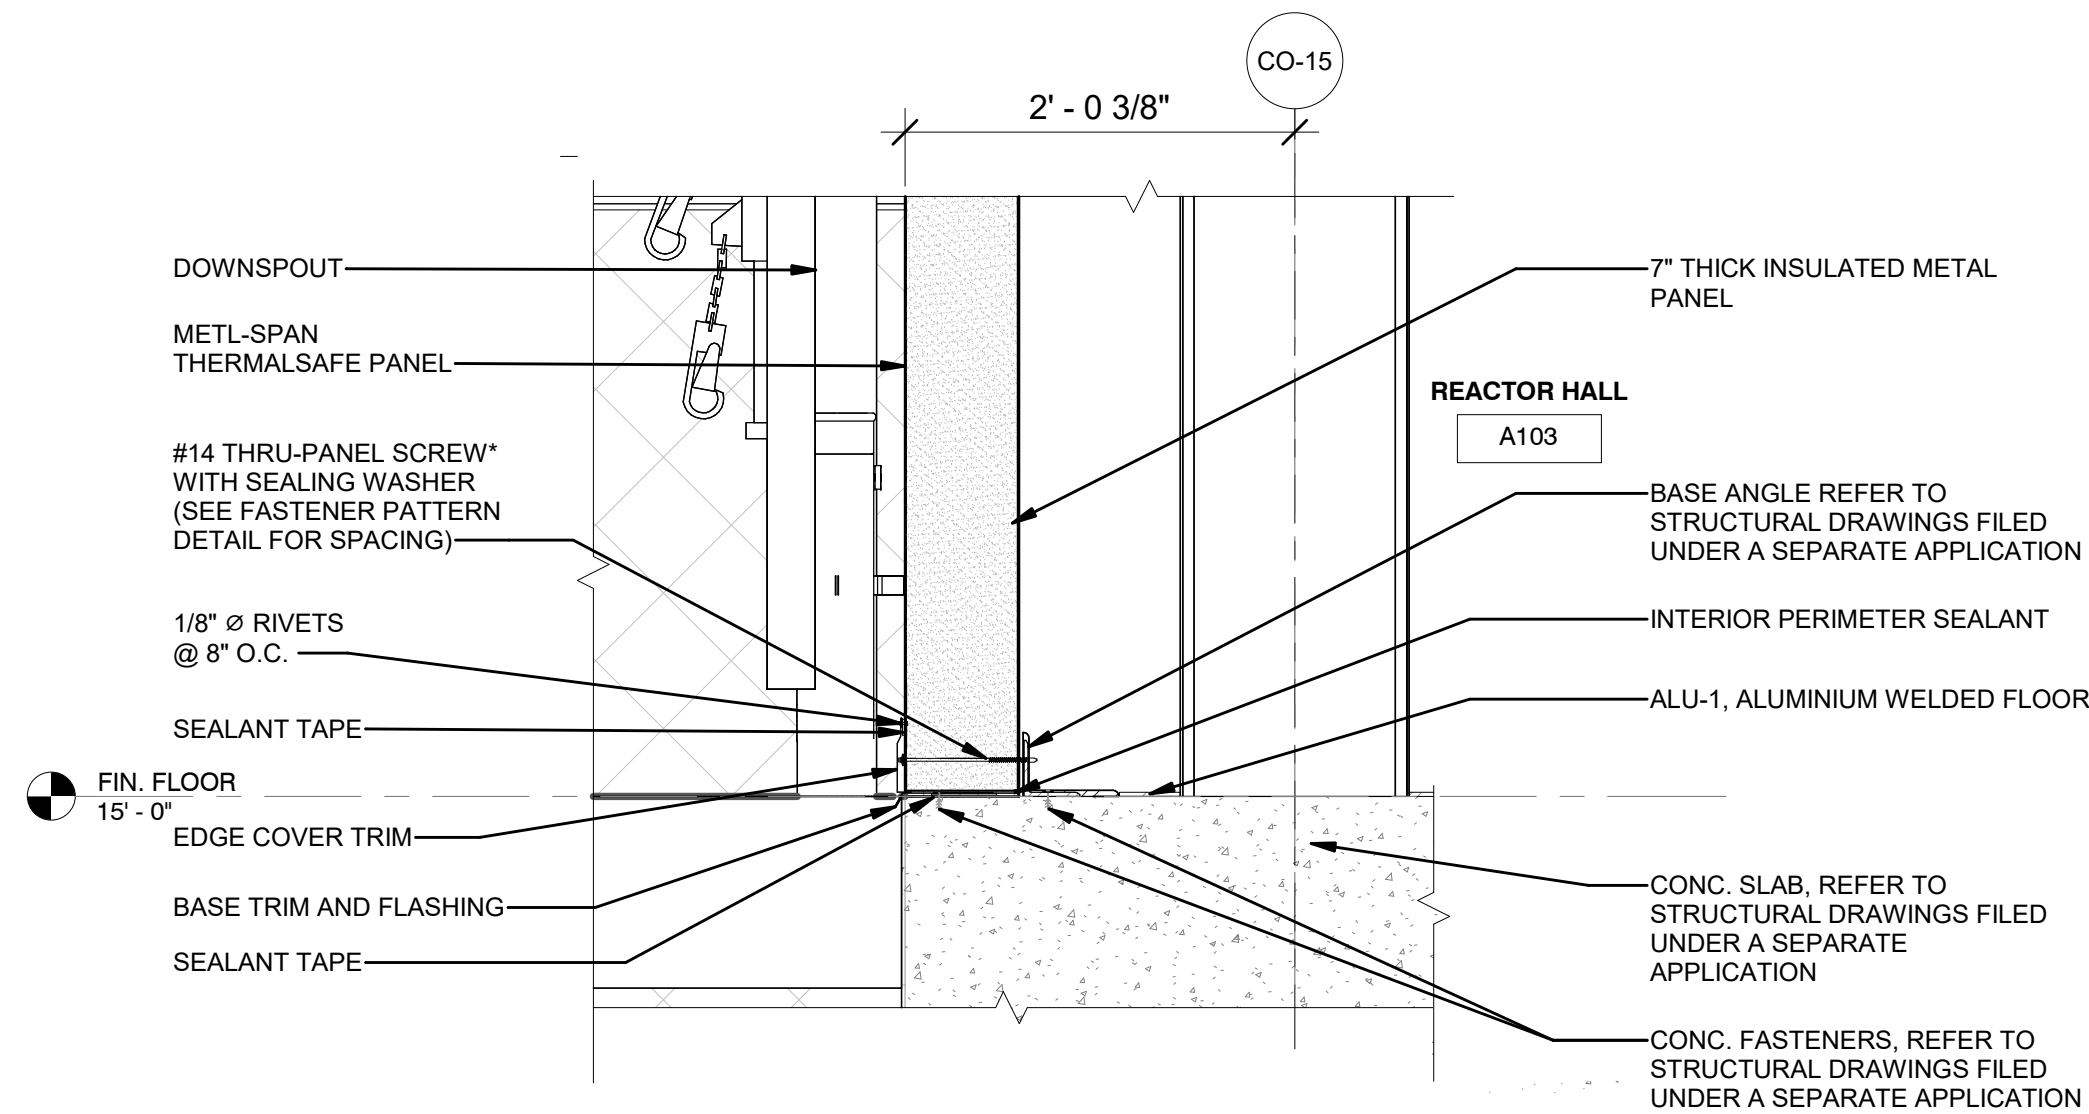

1 SECTION - VALVE HALLS & SERVICE BLDG
1" = 1'-0"

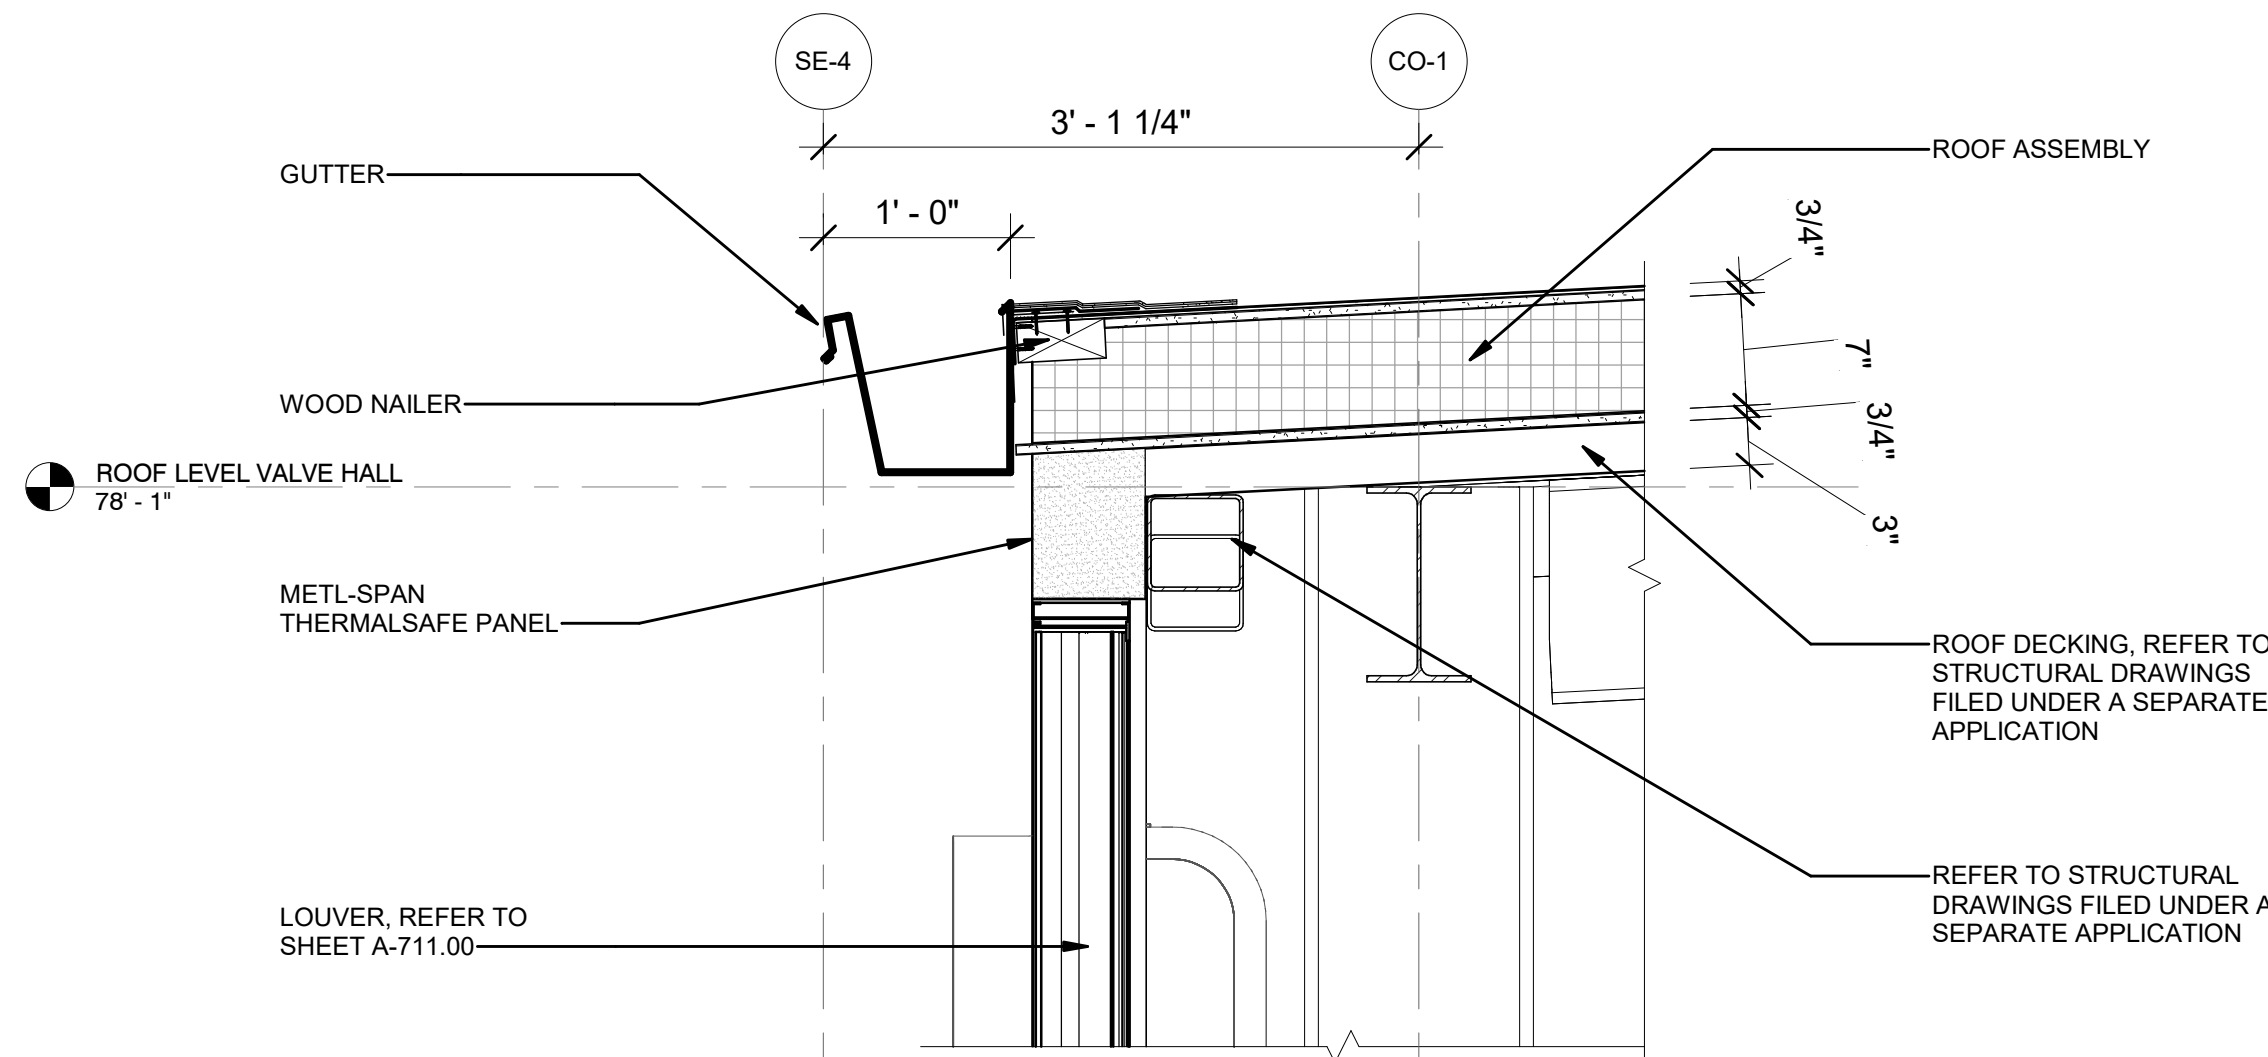

2 SECTION - VALVE HALLS & SERVICE BLDG - DETAIL
1" = 1'-0"

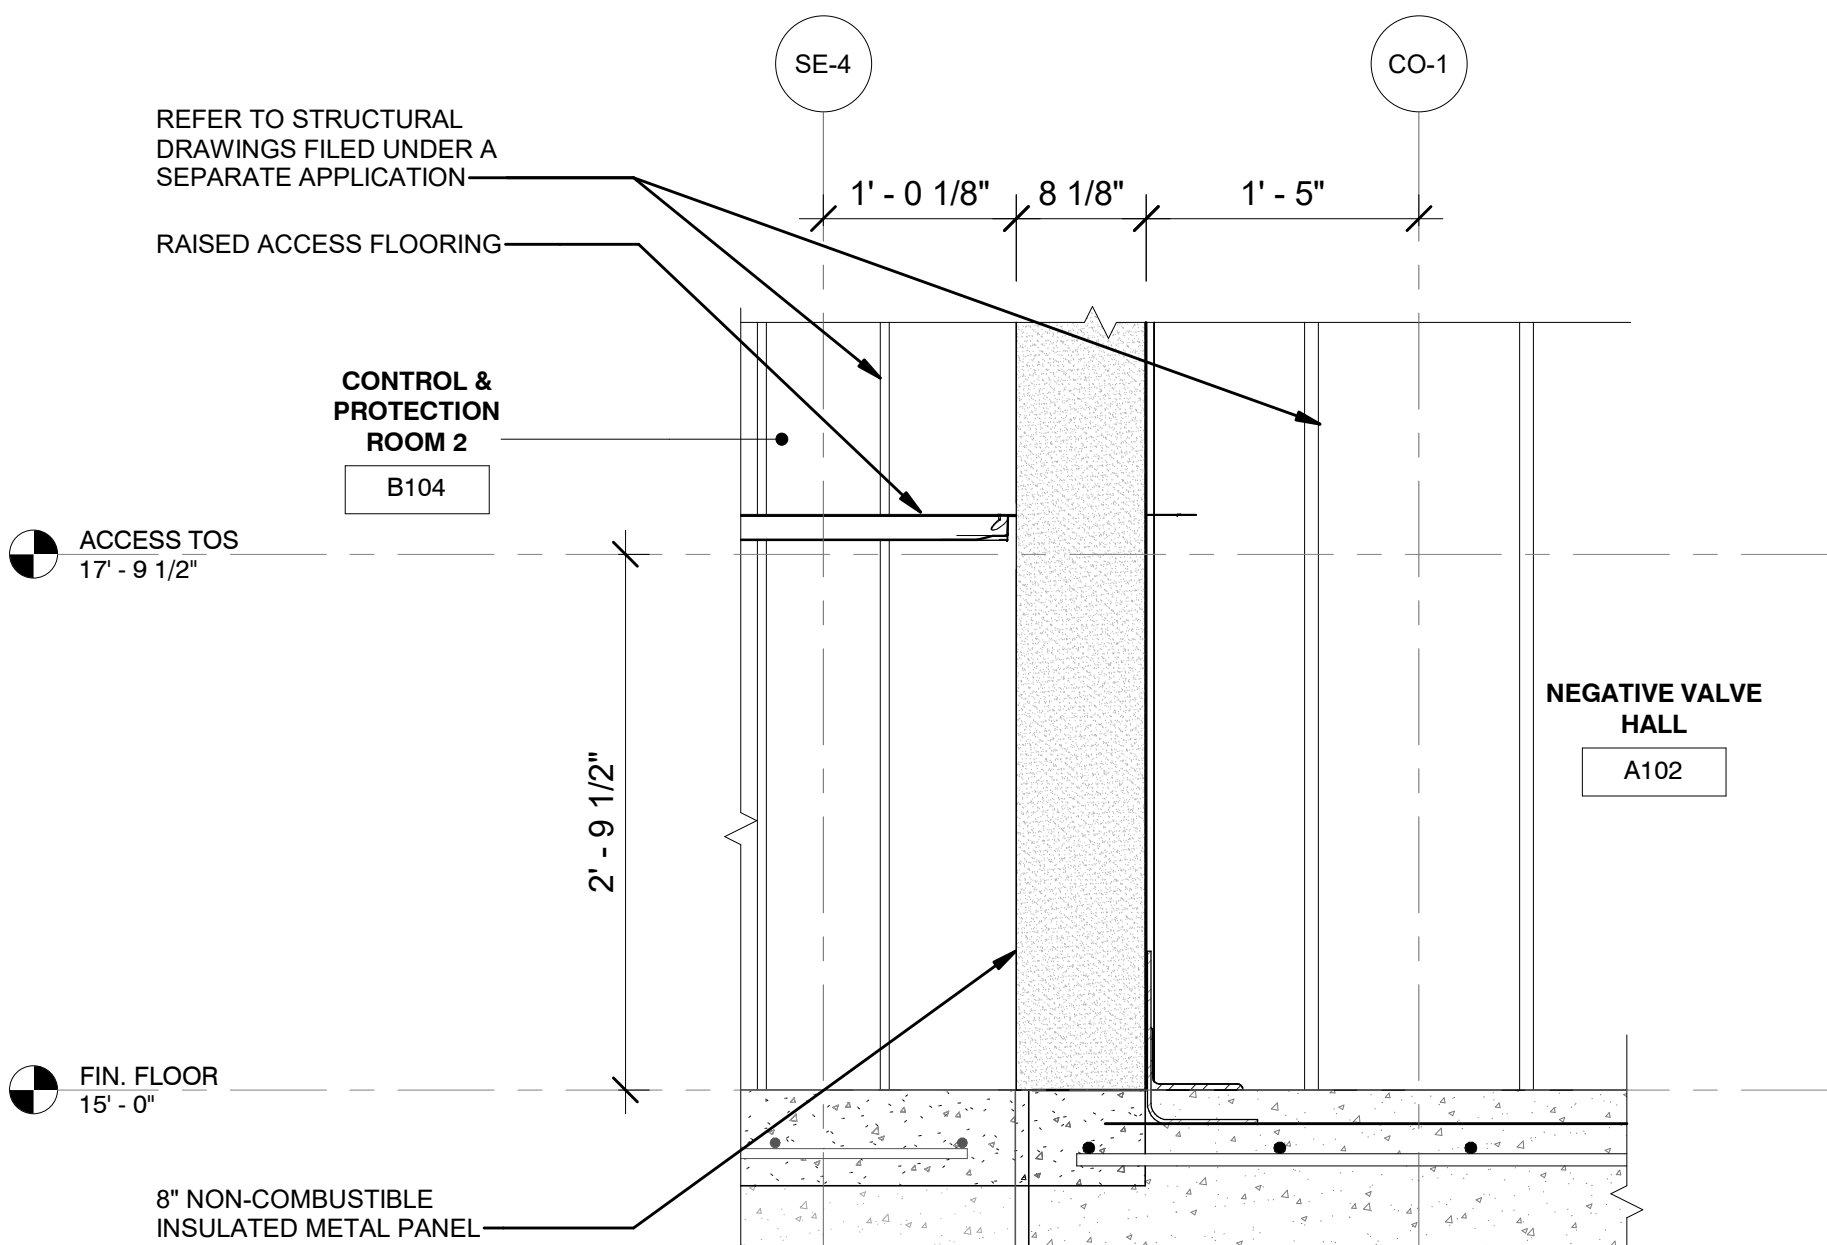

3 SECTION - VALVE HALLS & SERVICE BLDG - DETAIL II
1" = 1'-0"



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PROJECT

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Champlain Hudson
Power Express

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Converter Station


31-45 20th Avenue, Astoria, Queens NY 11105
Block #850 - Lot #310 - BIN #4624437

SECTION DETAILS 1




DATE 12/12/22
PROJECT NO 105121
DRAWING BY R. COLES
CHECKED BY Z. HARR
DRAWING NO
A-600.00
CADD FILE NO
Astoria/HVDC/CHPE
Astoria/CHV-KIE-111-ZZ-M3-A-001.rvt


12/12/2022 9:35:58 AM

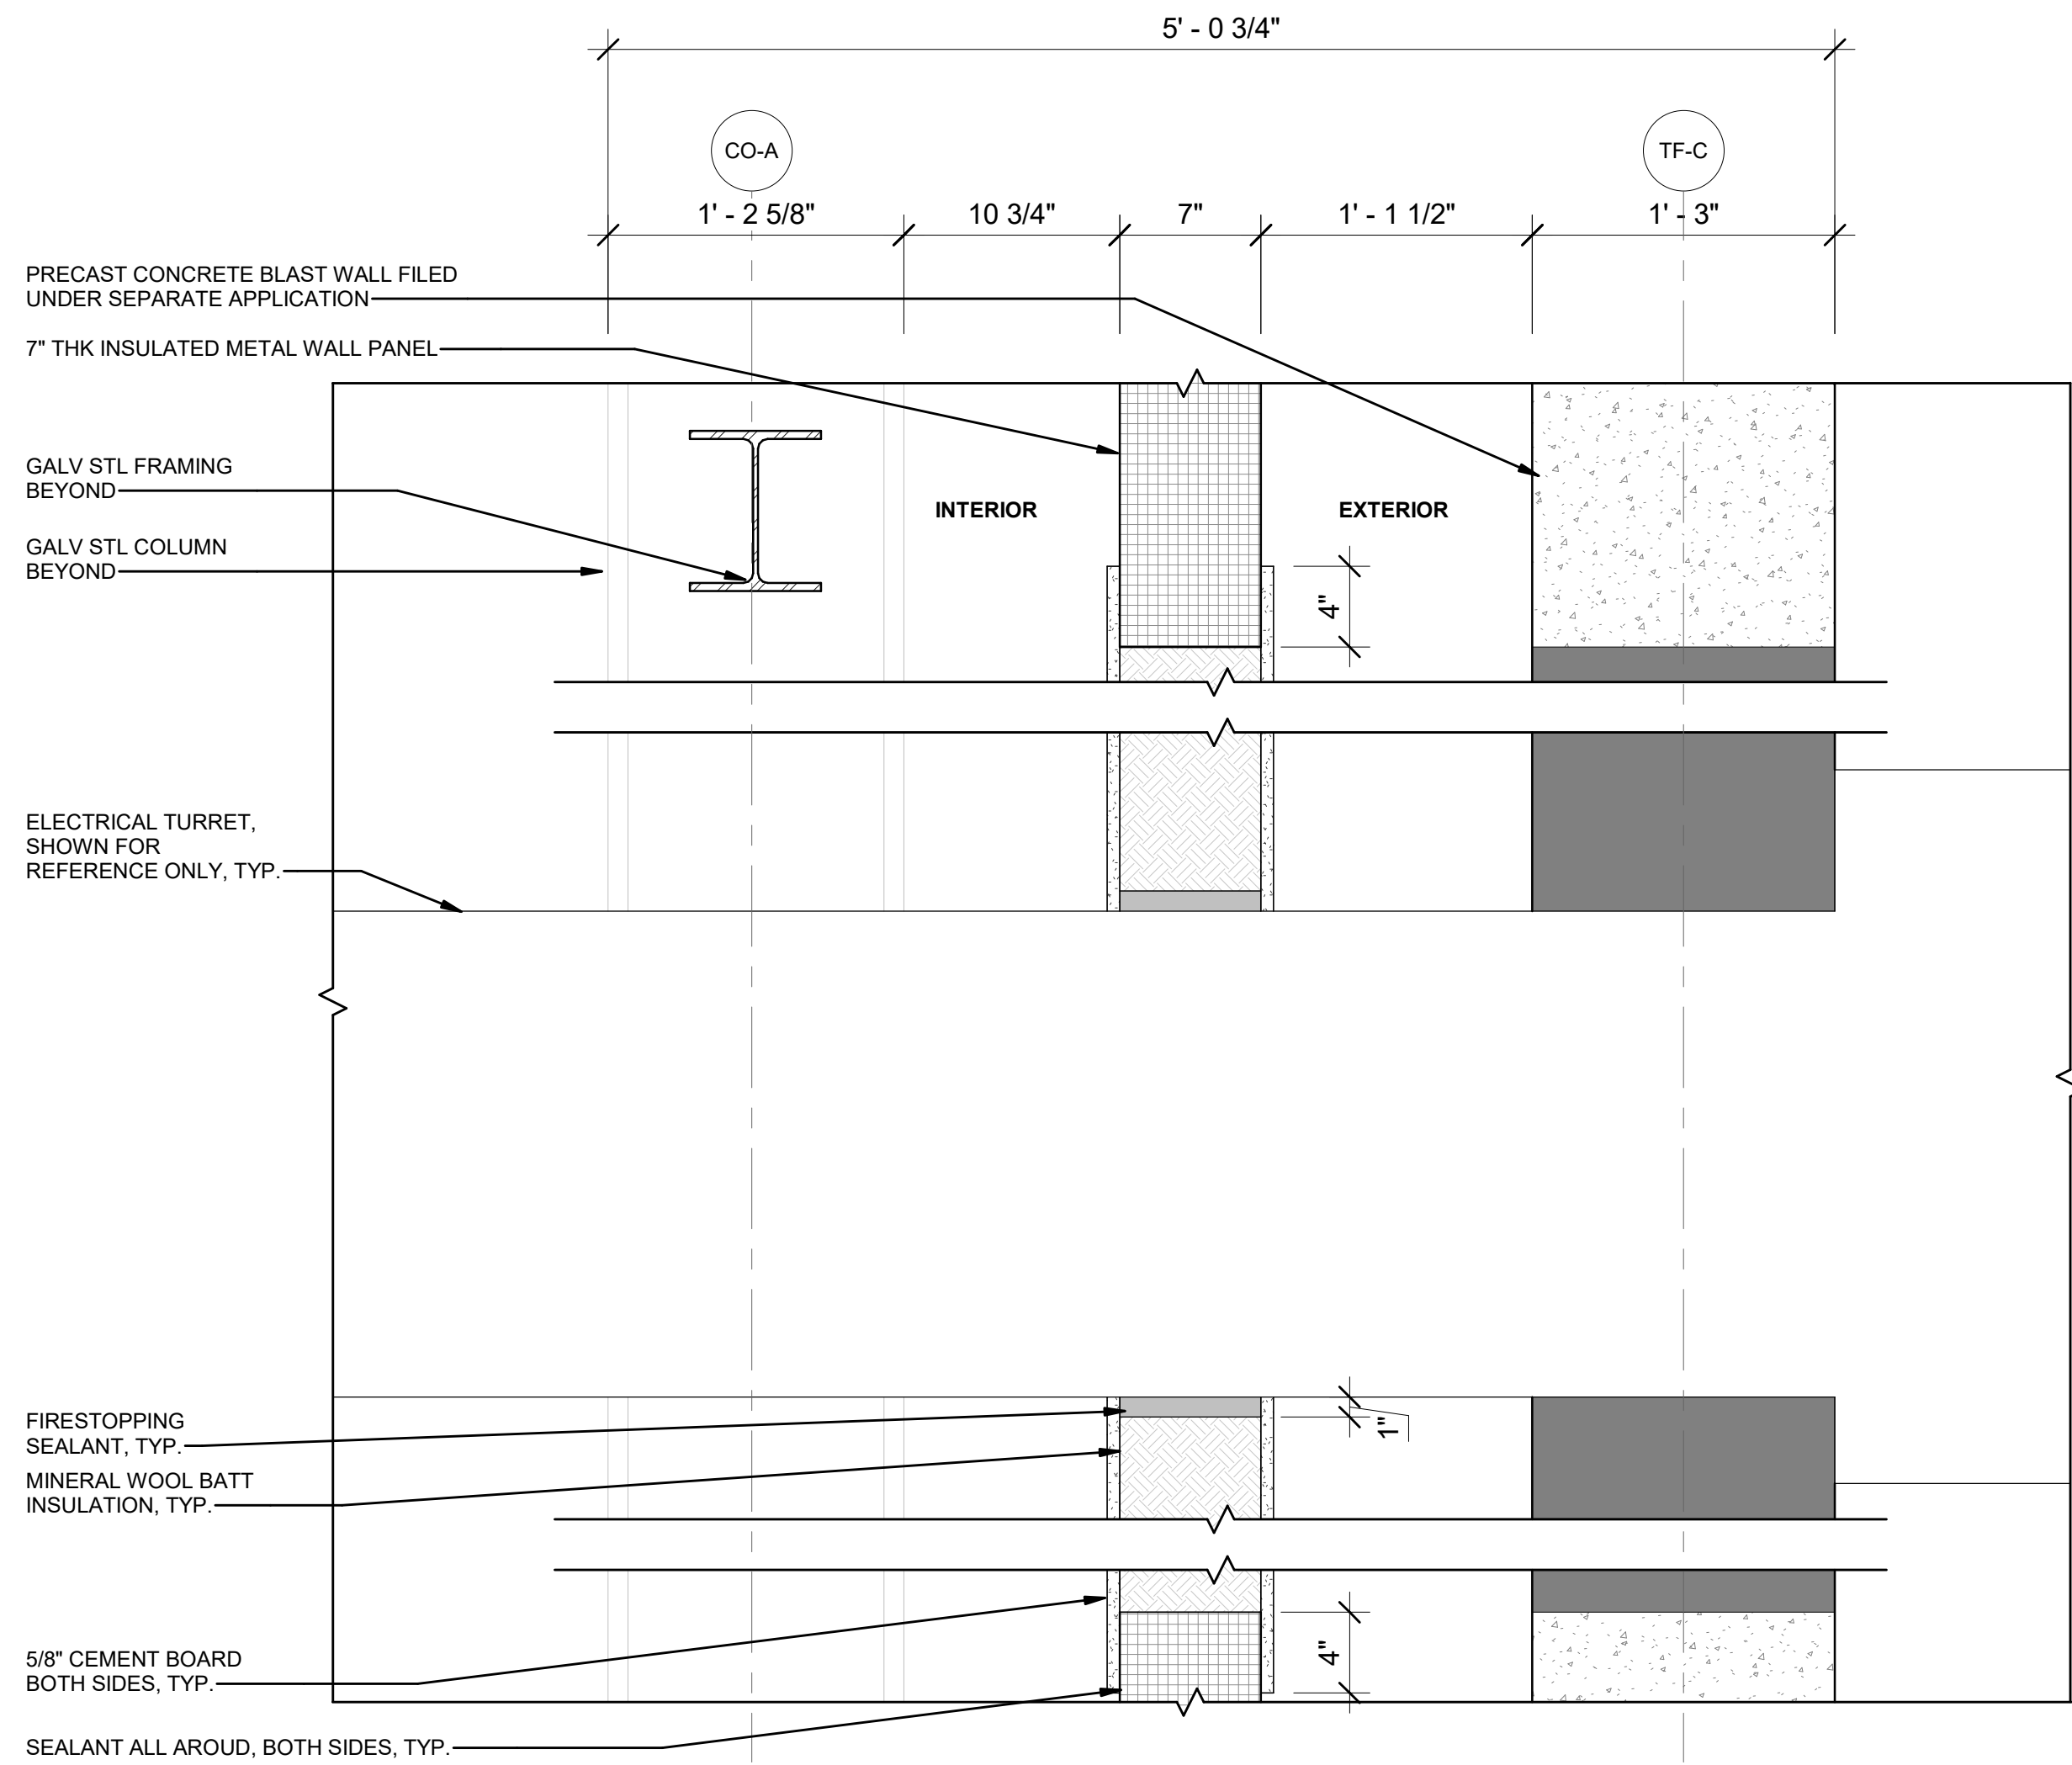

2 TURRET PENETRATION SECTION DETAIL
A-501.00 1 1/2" = 1'-0"

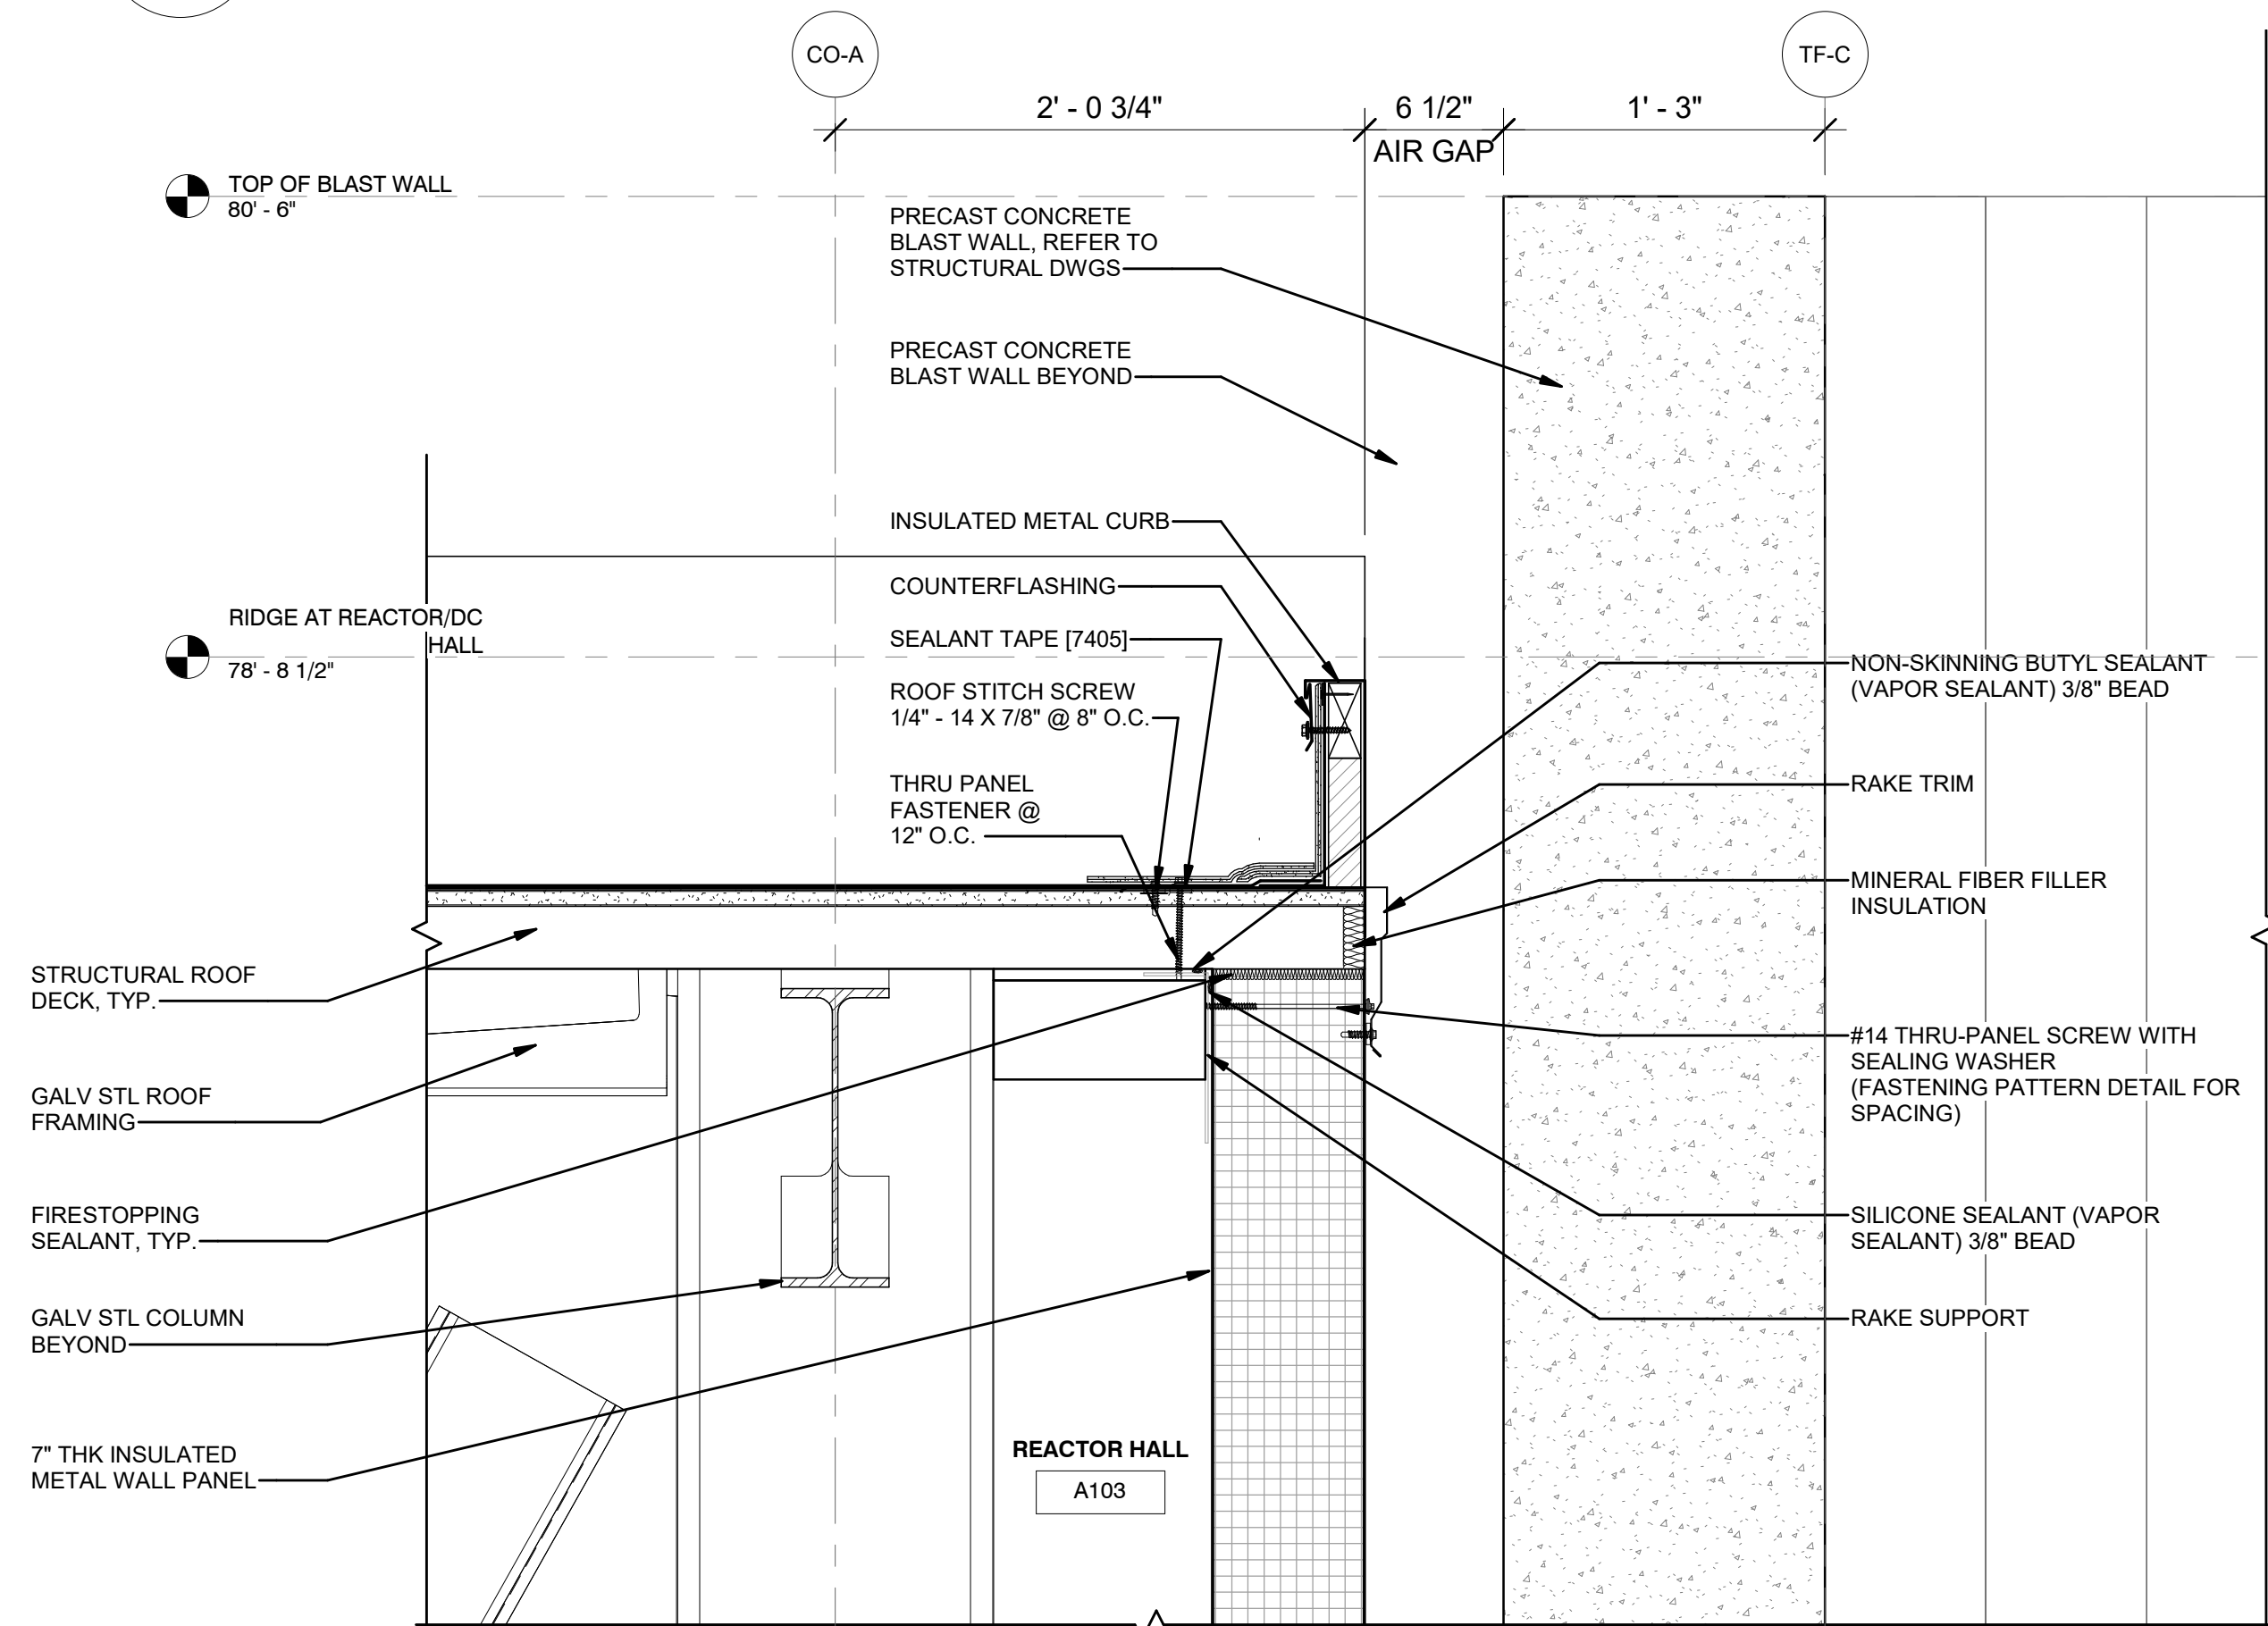

4 BLAST WALL EXPANSION - JOINT DETAIL
A-501.00 1 1/2" = 1'-0"

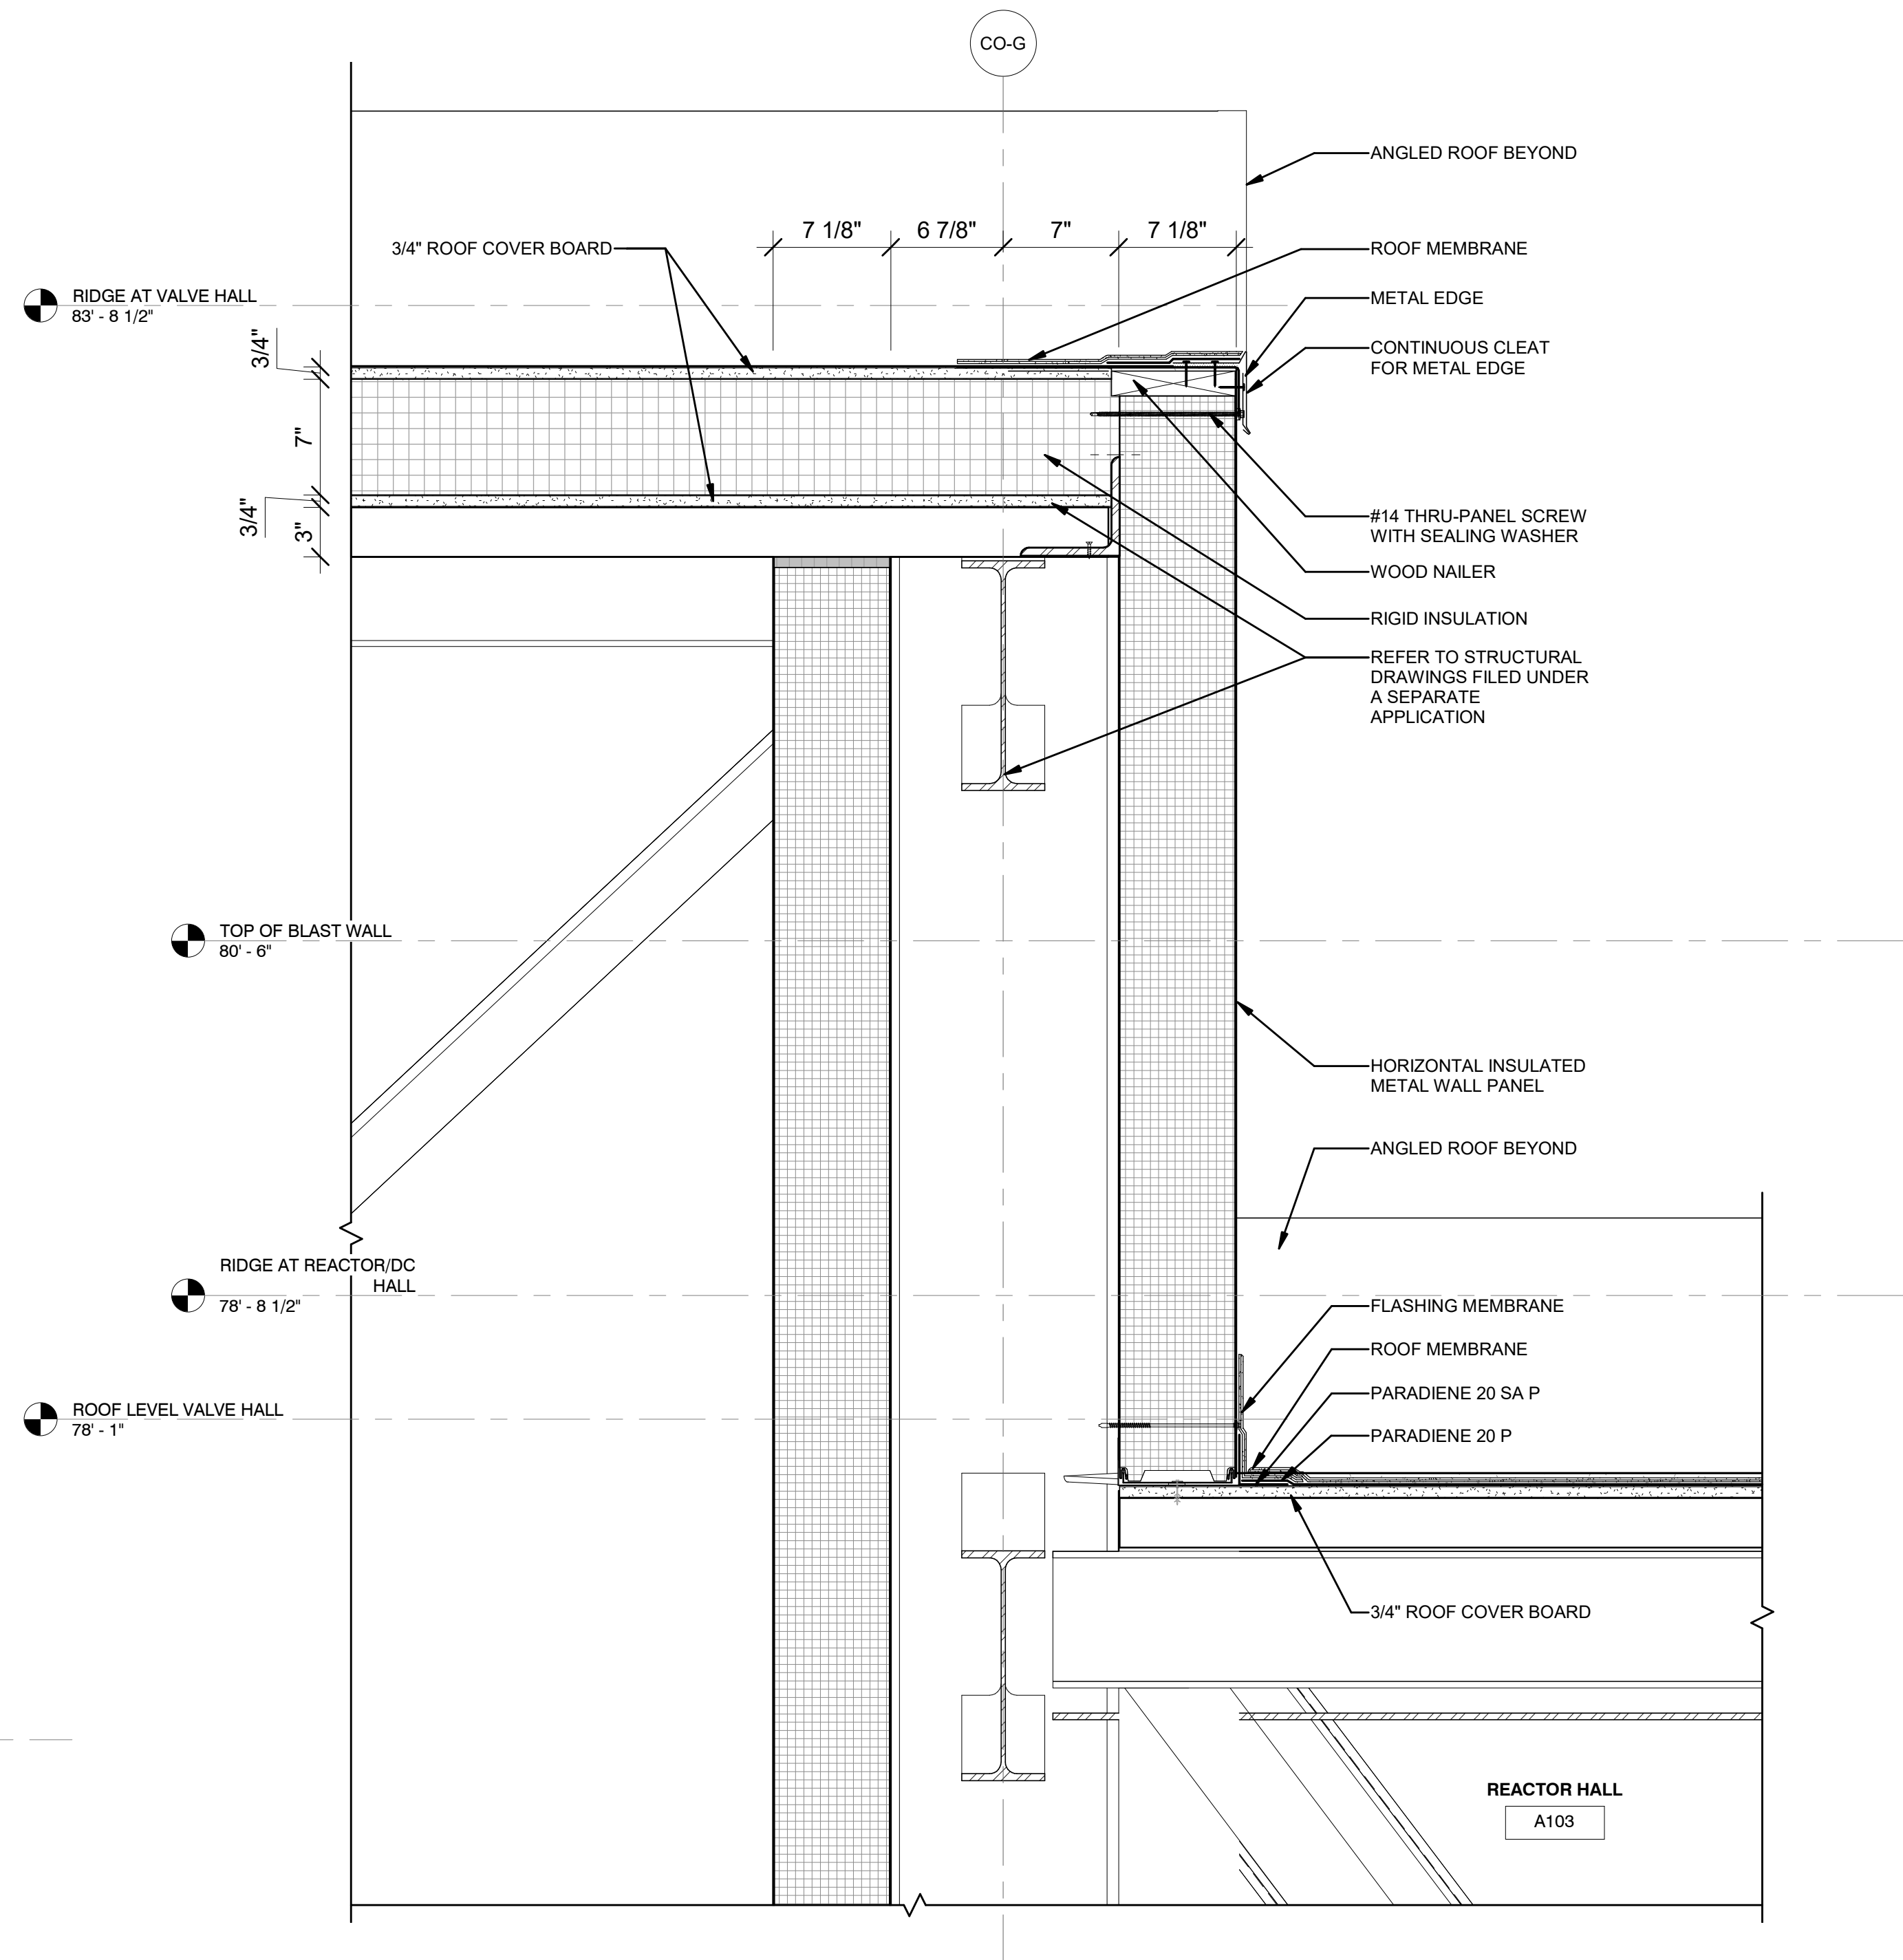

3 CONVERTER BLDG. SIDEWALL DETAIL
A-300.00 1 1/2" = 1'-0"



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Raleigh, North Carolina 27606

PROJECT

CHPE
Champlain Hudson
Power Express


**Astoria HVDC
Converter Station**

31-45 20th Avenue, Astoria, Queens NY 11105
Block #850 - Lot #310 - BIN #4624437


SECTION DETAILS 2




DATE 12/12/22
PROJECT NO 105121
DRAWING BY R. COLES
CHECKED BY Z. HARR
DRAWING NO
A-601.00
CADD FILE NO
Astoria-HVDC-CHPE
Astoria-CHPE-111-ZZ-M3-A-001.rvt

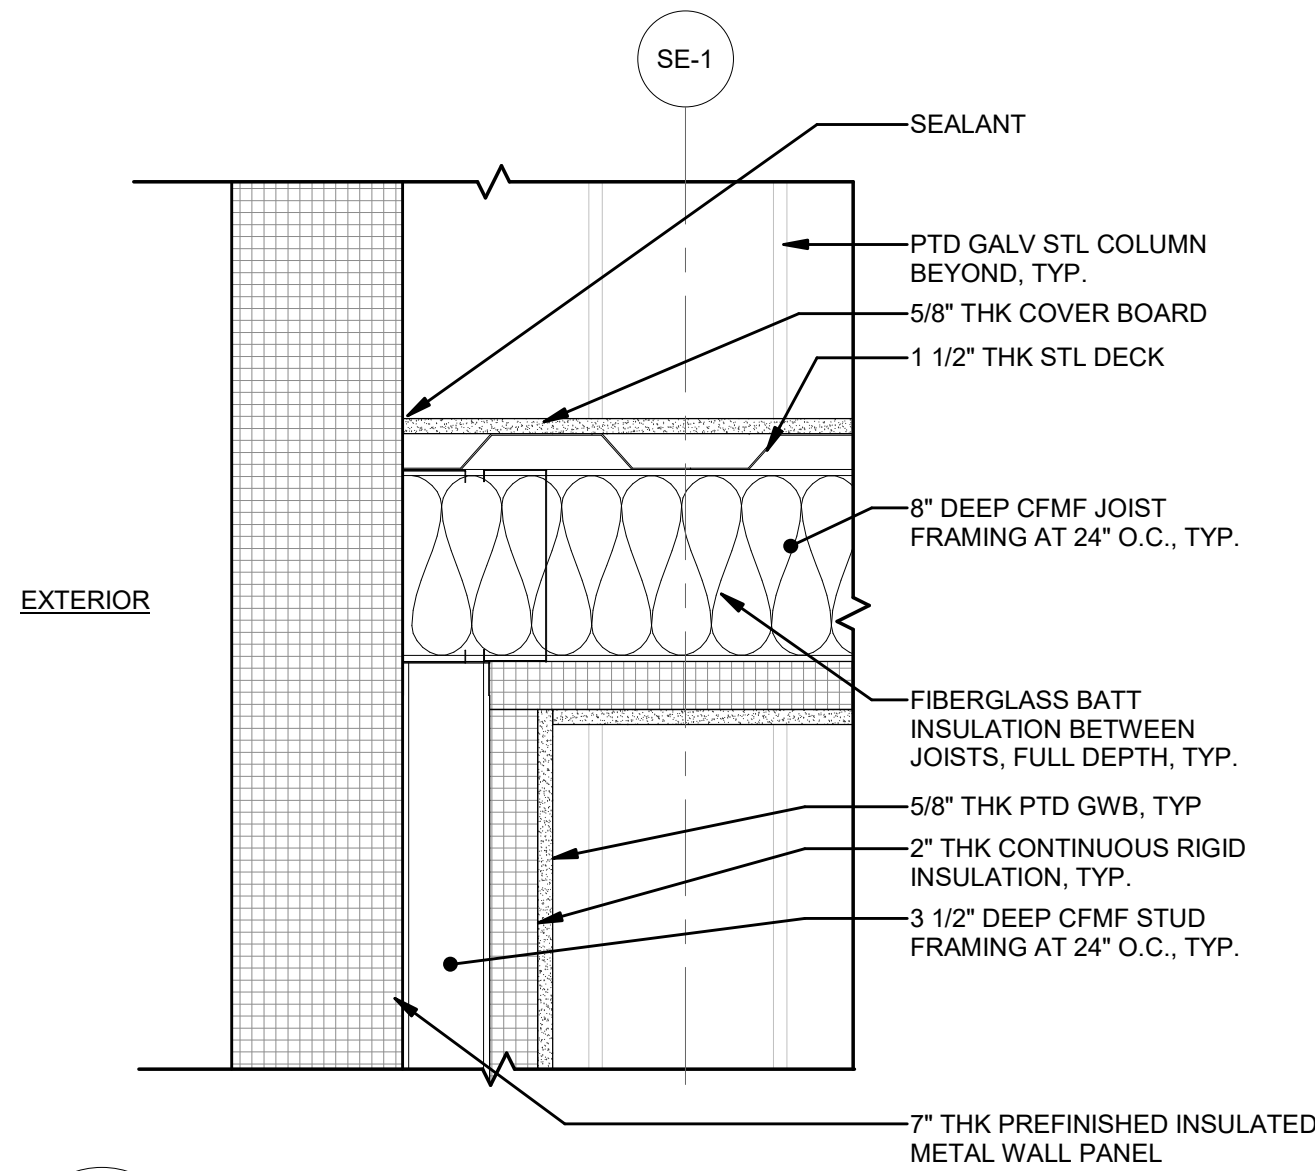


2 SECOND FLOOR CEILING DETAIL 1
1 1/2" = 1'-0"

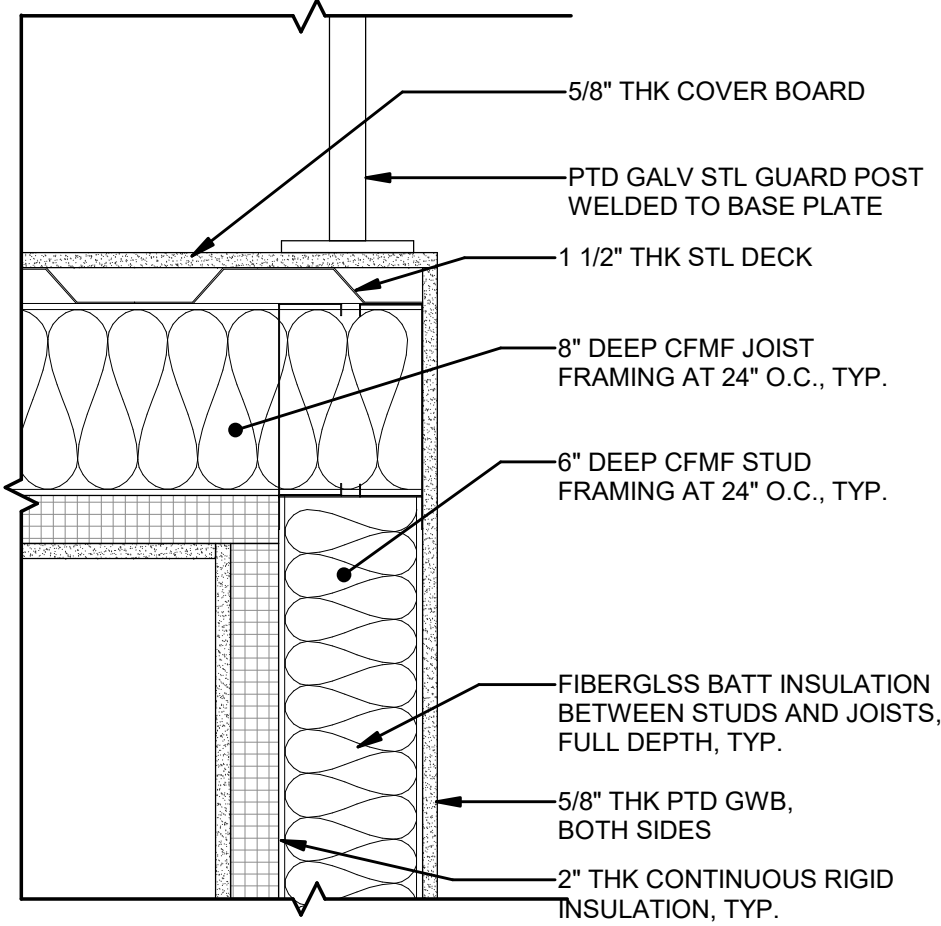

3 SECOND FLOOR CEILING DETAIL 2
1 1/2" = 1'-0"

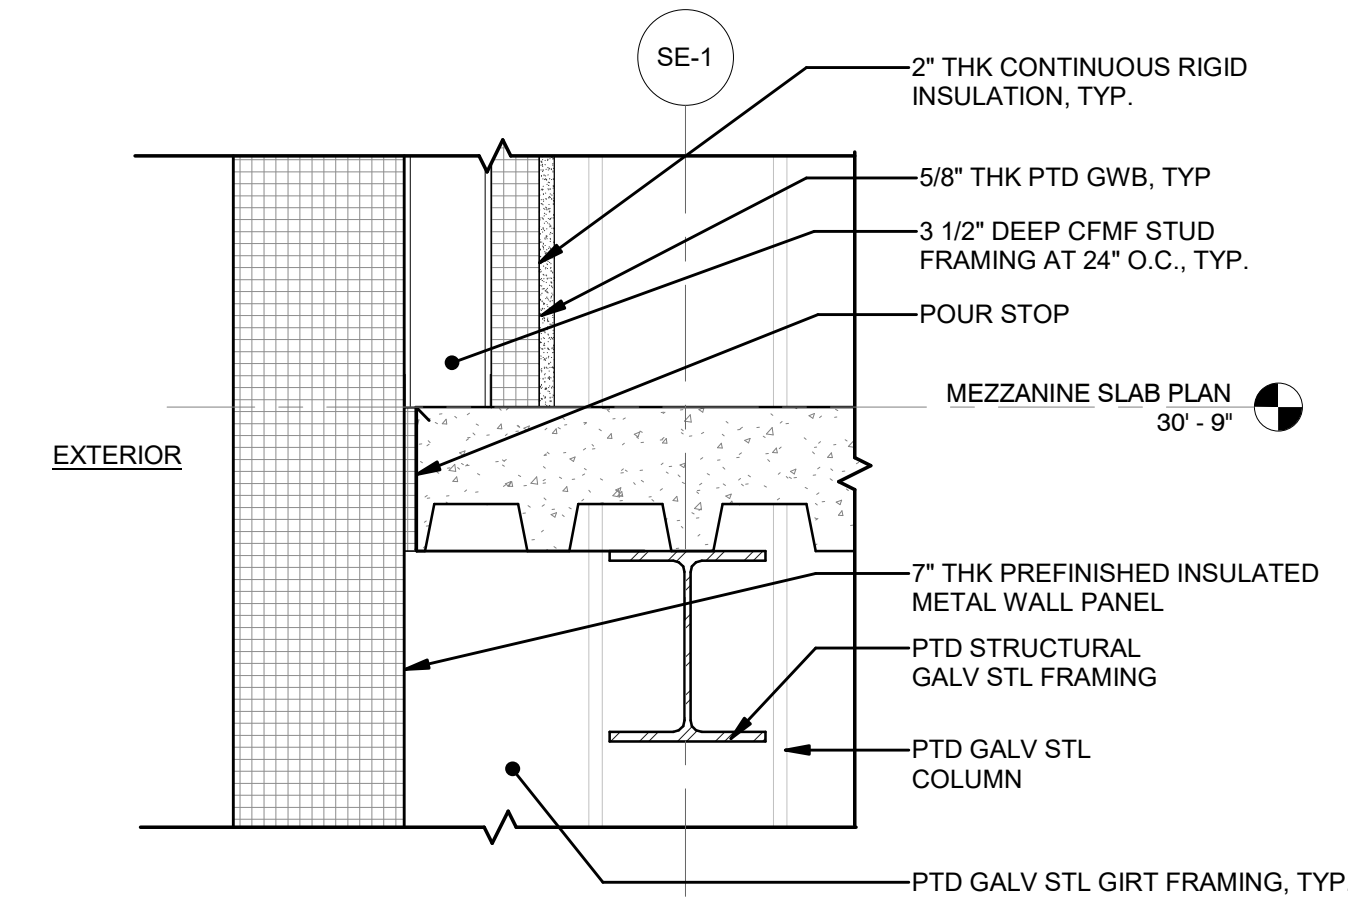

4 SECOND FLOOR WALL DETAIL 1
1 1/2" = 1'-0"

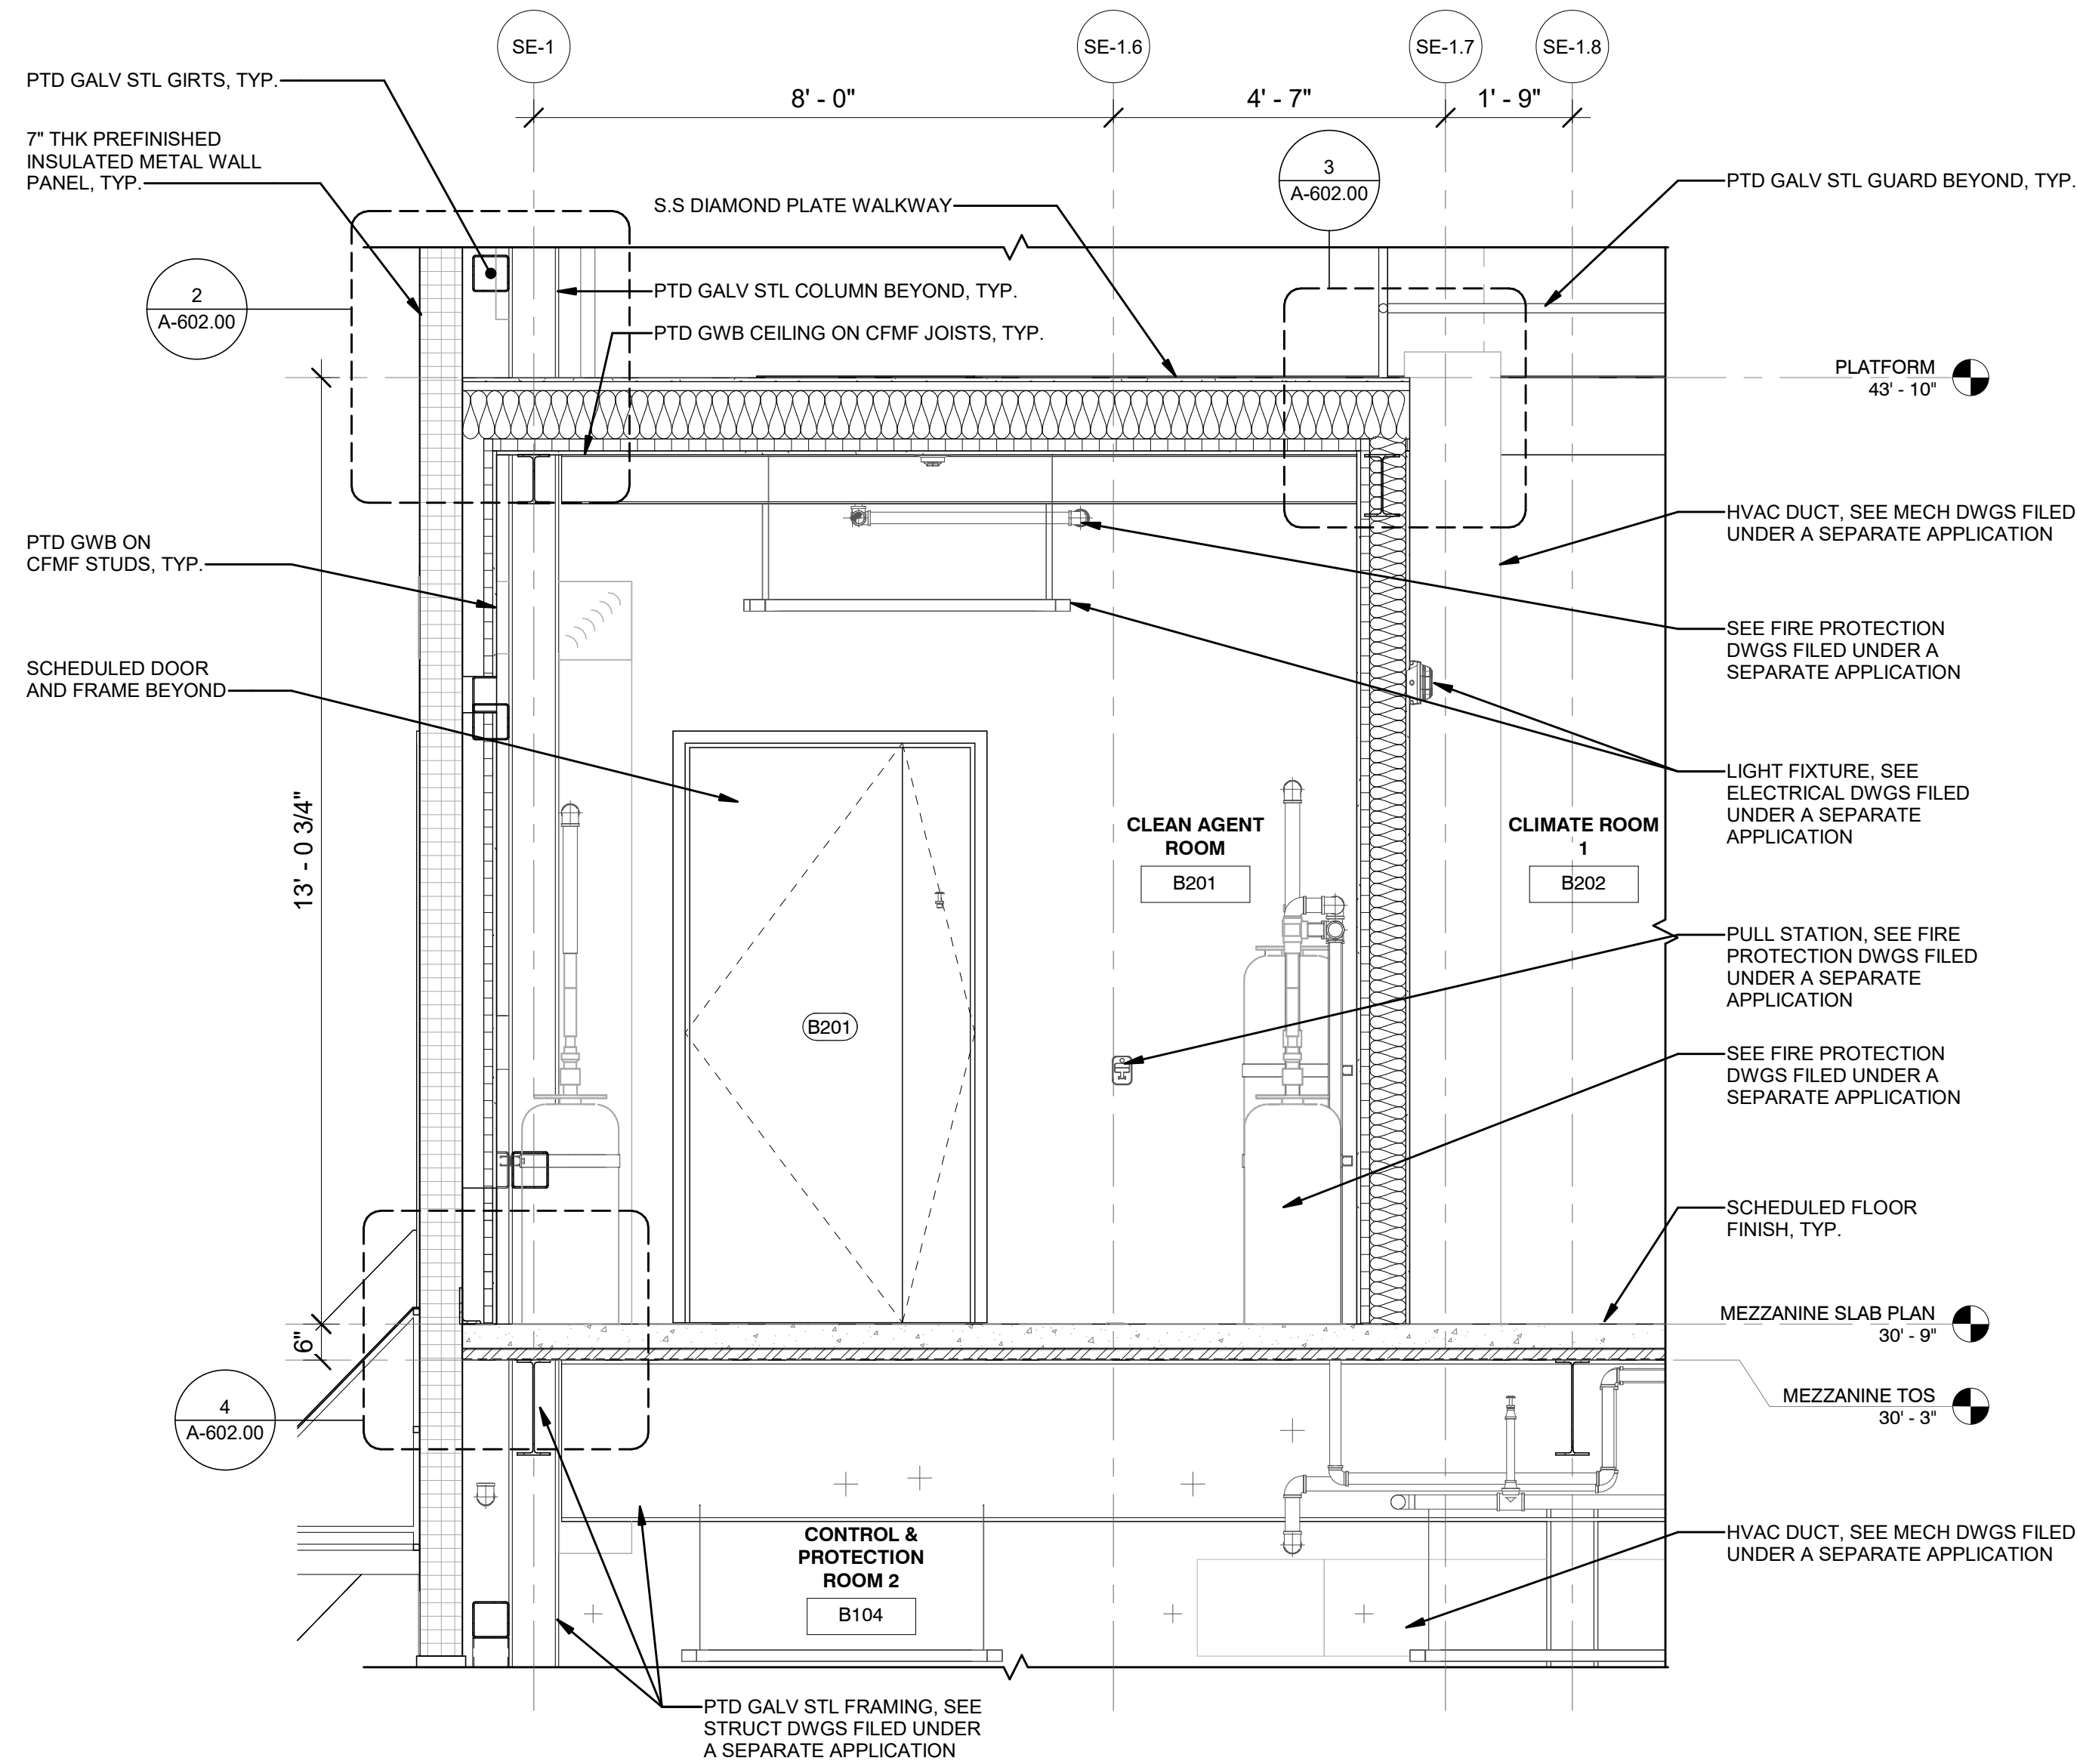

5 SERVICE BUILDING - ENLARGED SECTION THROUGH CLEAN AGENT RM
1/2" = 1'-0"



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New York, NY 10001

**SOWINSKI
SULLIVAN** 25 Mohawk Avenue
Sparta, NJ 07871

| | | | | |
|-----|--------------------|--------|--------|------------|
| B | FINAL SUBMISSION | RAC | ZH | 12/12/2022 |
| A | INTERIM SUBMISSION | RAC | ZH | 09/13/2022 |
| REV | DESCRIPTION | DRW BY | CHK BY | DATE |

Kiewit
470 Chestnut Ridge Rd # 2,
Woodcliff Lake, NJ 07677

Hitachi Energy
901 Main Campus Drive
Raleigh, North Carolina 27606

PROJECT
CHPE
Champlain Hudson
Power Express
**Astoria HVDC
Converter Station**
31-45 20th Avenue, Astoria, Queens NY 11105
Block #850 - Lot #310 - BIN #4624437


SECTION DETAILS 3

REGISTERED ARCHITECT
SUZANNE SOWINSKI
STATE OF NEW YORK
026049

DATE 12/12/22
PROJECT NO 105121
DRAWING BY R. COLES
CHECKED BY Z. HARR
DRAWING NO
A-602.00
CADD FILE NO
Astoria-HVDC-CHPE
Astoria-CHA-KIE-111-ZZ-M3-A-001.rvt


12/12/2022 9:43:00 AM

1 SERVICE BLDG. - ENLARGED SECTION THROUGH CHASES
A-303.00 1/2" = 1'-0"

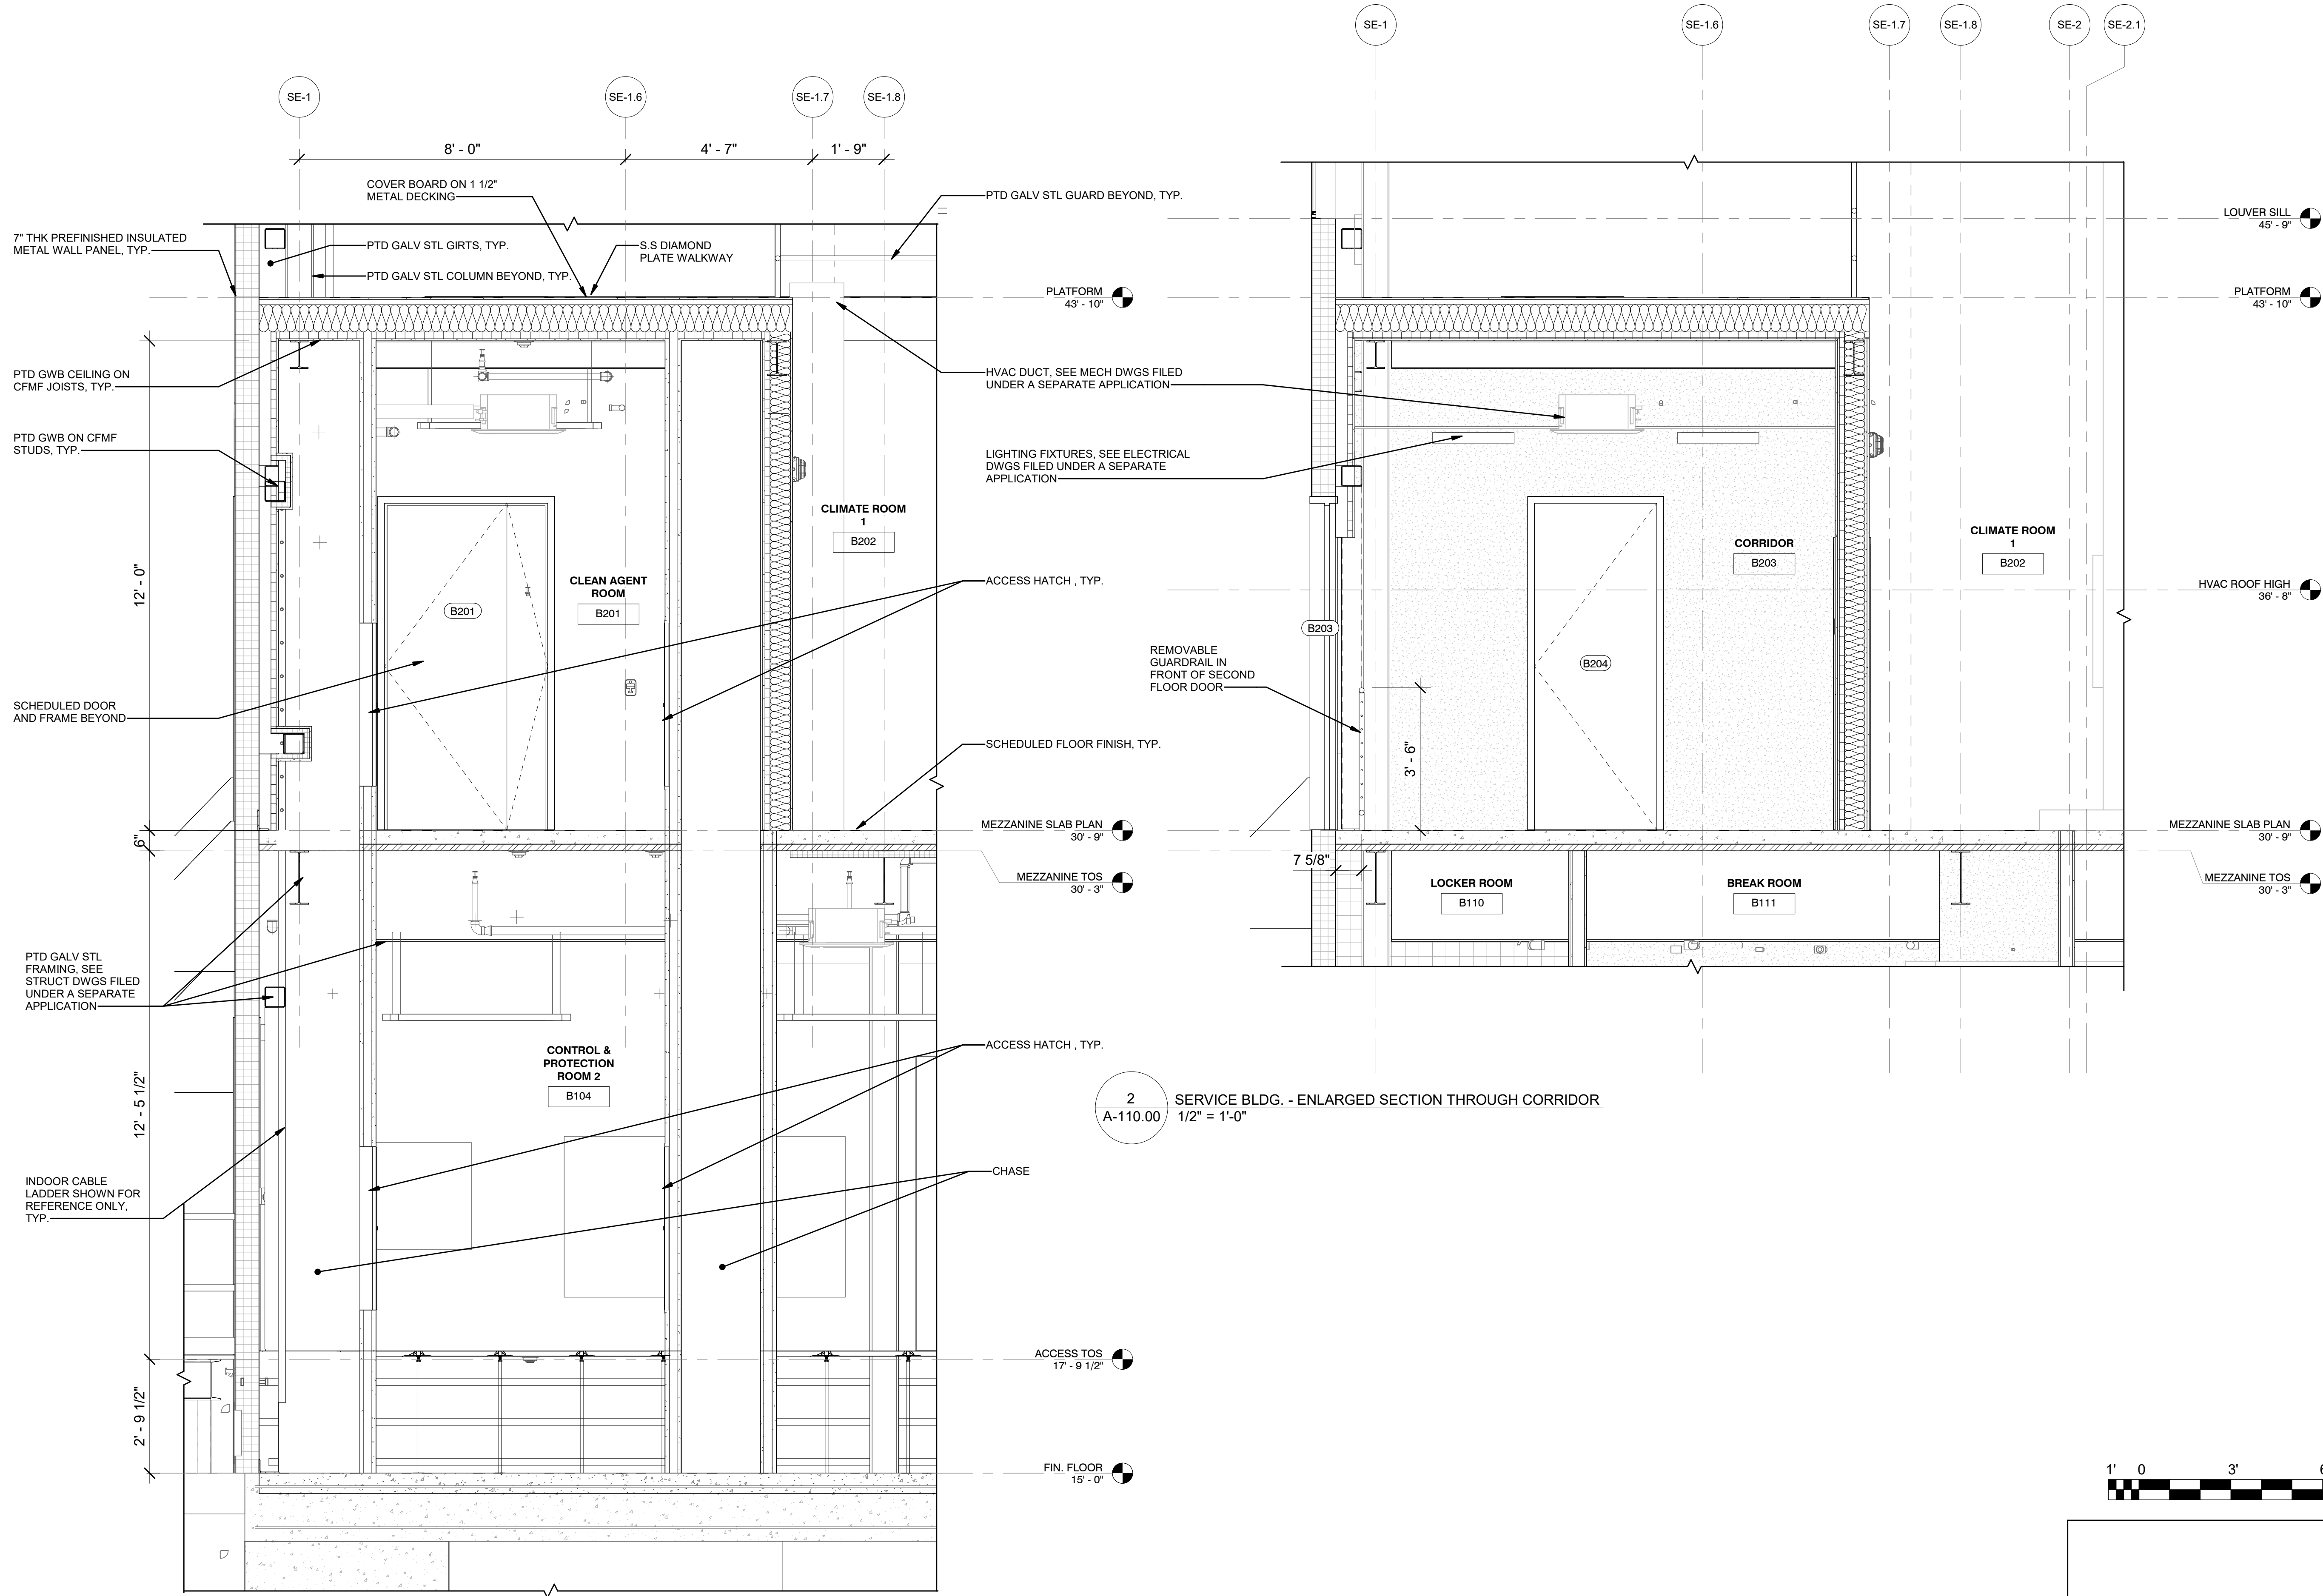

2 SERVICE BLDG. - ENLARGED SECTION THROUGH CORRIDOR
A-110.00 1/2" = 1'-0"

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| REV | DESCRIPTION | DRW BY | CHK BY | DATE |
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| B | FINAL SUBMISSION | RAC | ZH | 12/12/2022 |
| A | INTERIM SUBMISSION | RAC | ZH | 09/13/2022 |

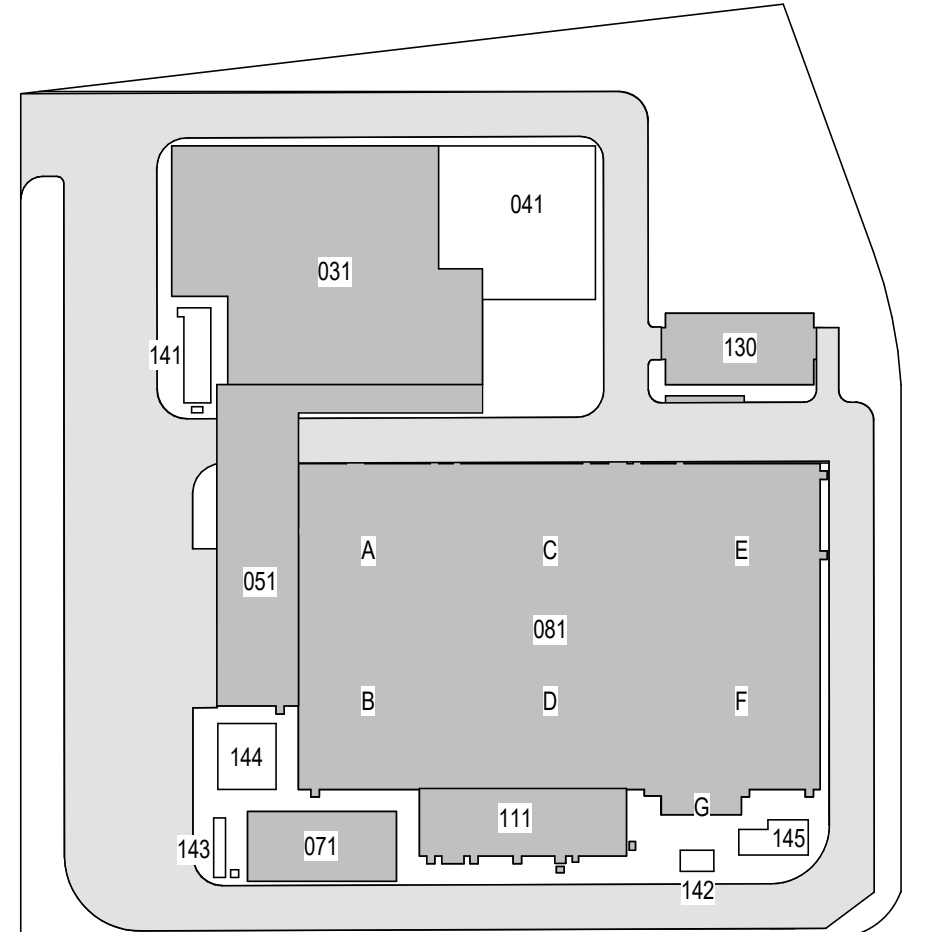
Kiewit
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Woodcliff Lake, NJ 07677

Hitachi Energy
901 Main Campus Drive
Raleigh, North Carolina 27606


PROJECT
CHPE
Champlain Hudson
Power Express
**Astoria HVDC
Converter Station**
31-45 20th Avenue, Astoria, Queens NY 11105
Block #850 - Lot #310 - BIN #4624437

SECTION DETAILS 4


REGISTERED ARCHITECT
SUZANNE SOWINSKI
STATE OF NEW YORK
026049
DATE 12/12/22
PROJECT NO 105121
DRAWING BY Author
CHECKED BY Designer
DRAWING NO
A-603.00
CADD FILE NO
Astoria-HVDC-CHPE
Astoria-CHPE-111-ZZ-M3-A-001.rvt

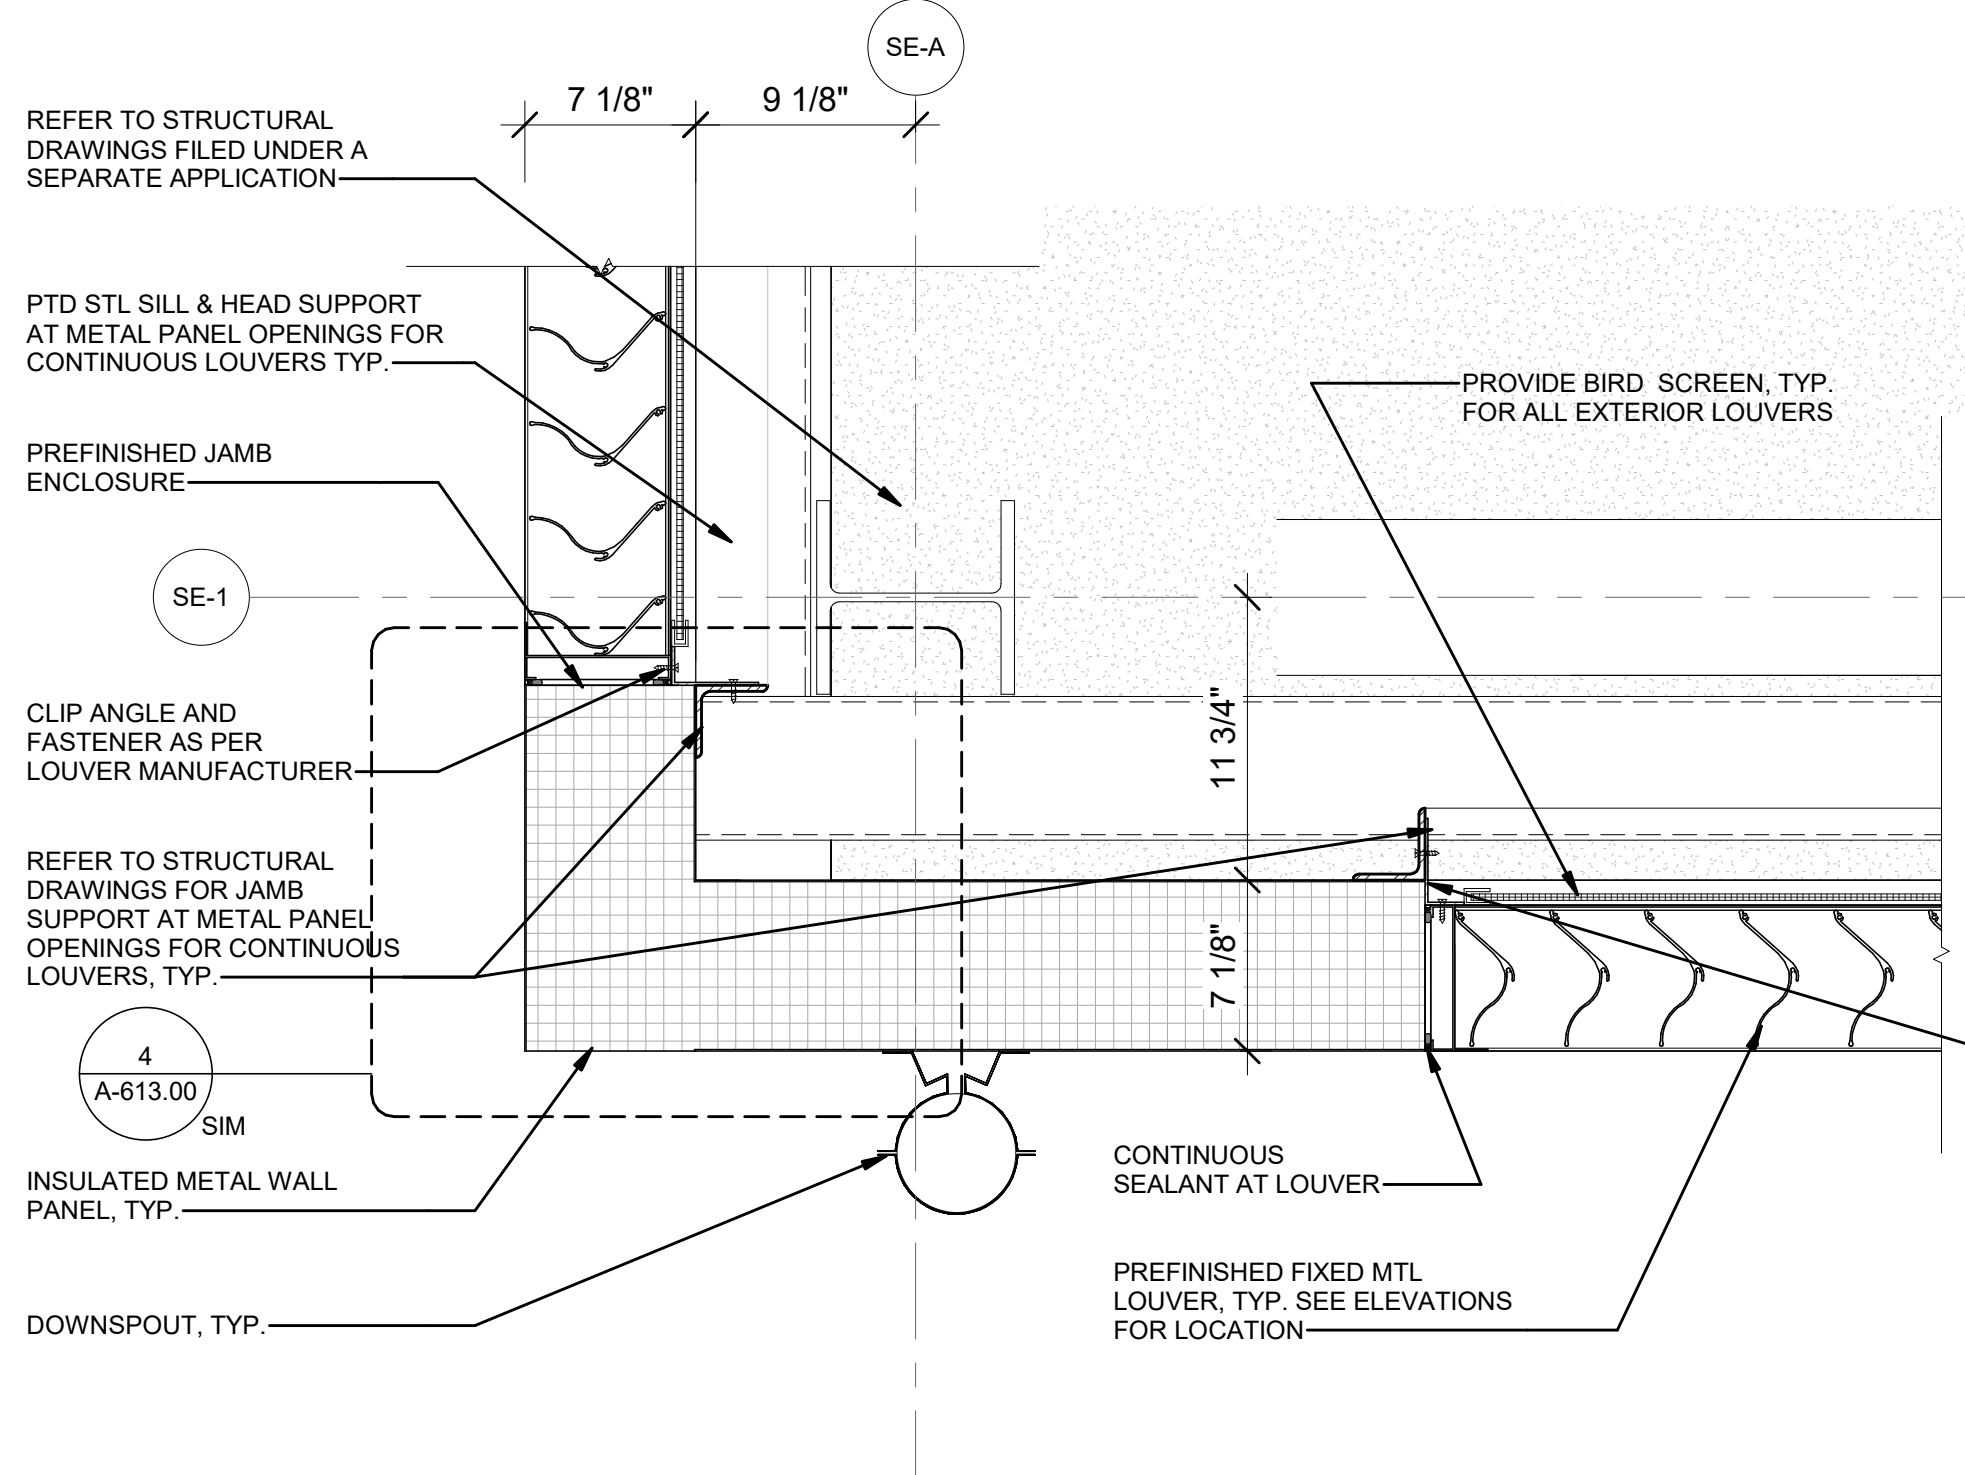


1 PLAN DETAIL - SERVICE BLDG. PLATFORM PLAN - PART G
A-110.00 1 1/2" = 1'-0"

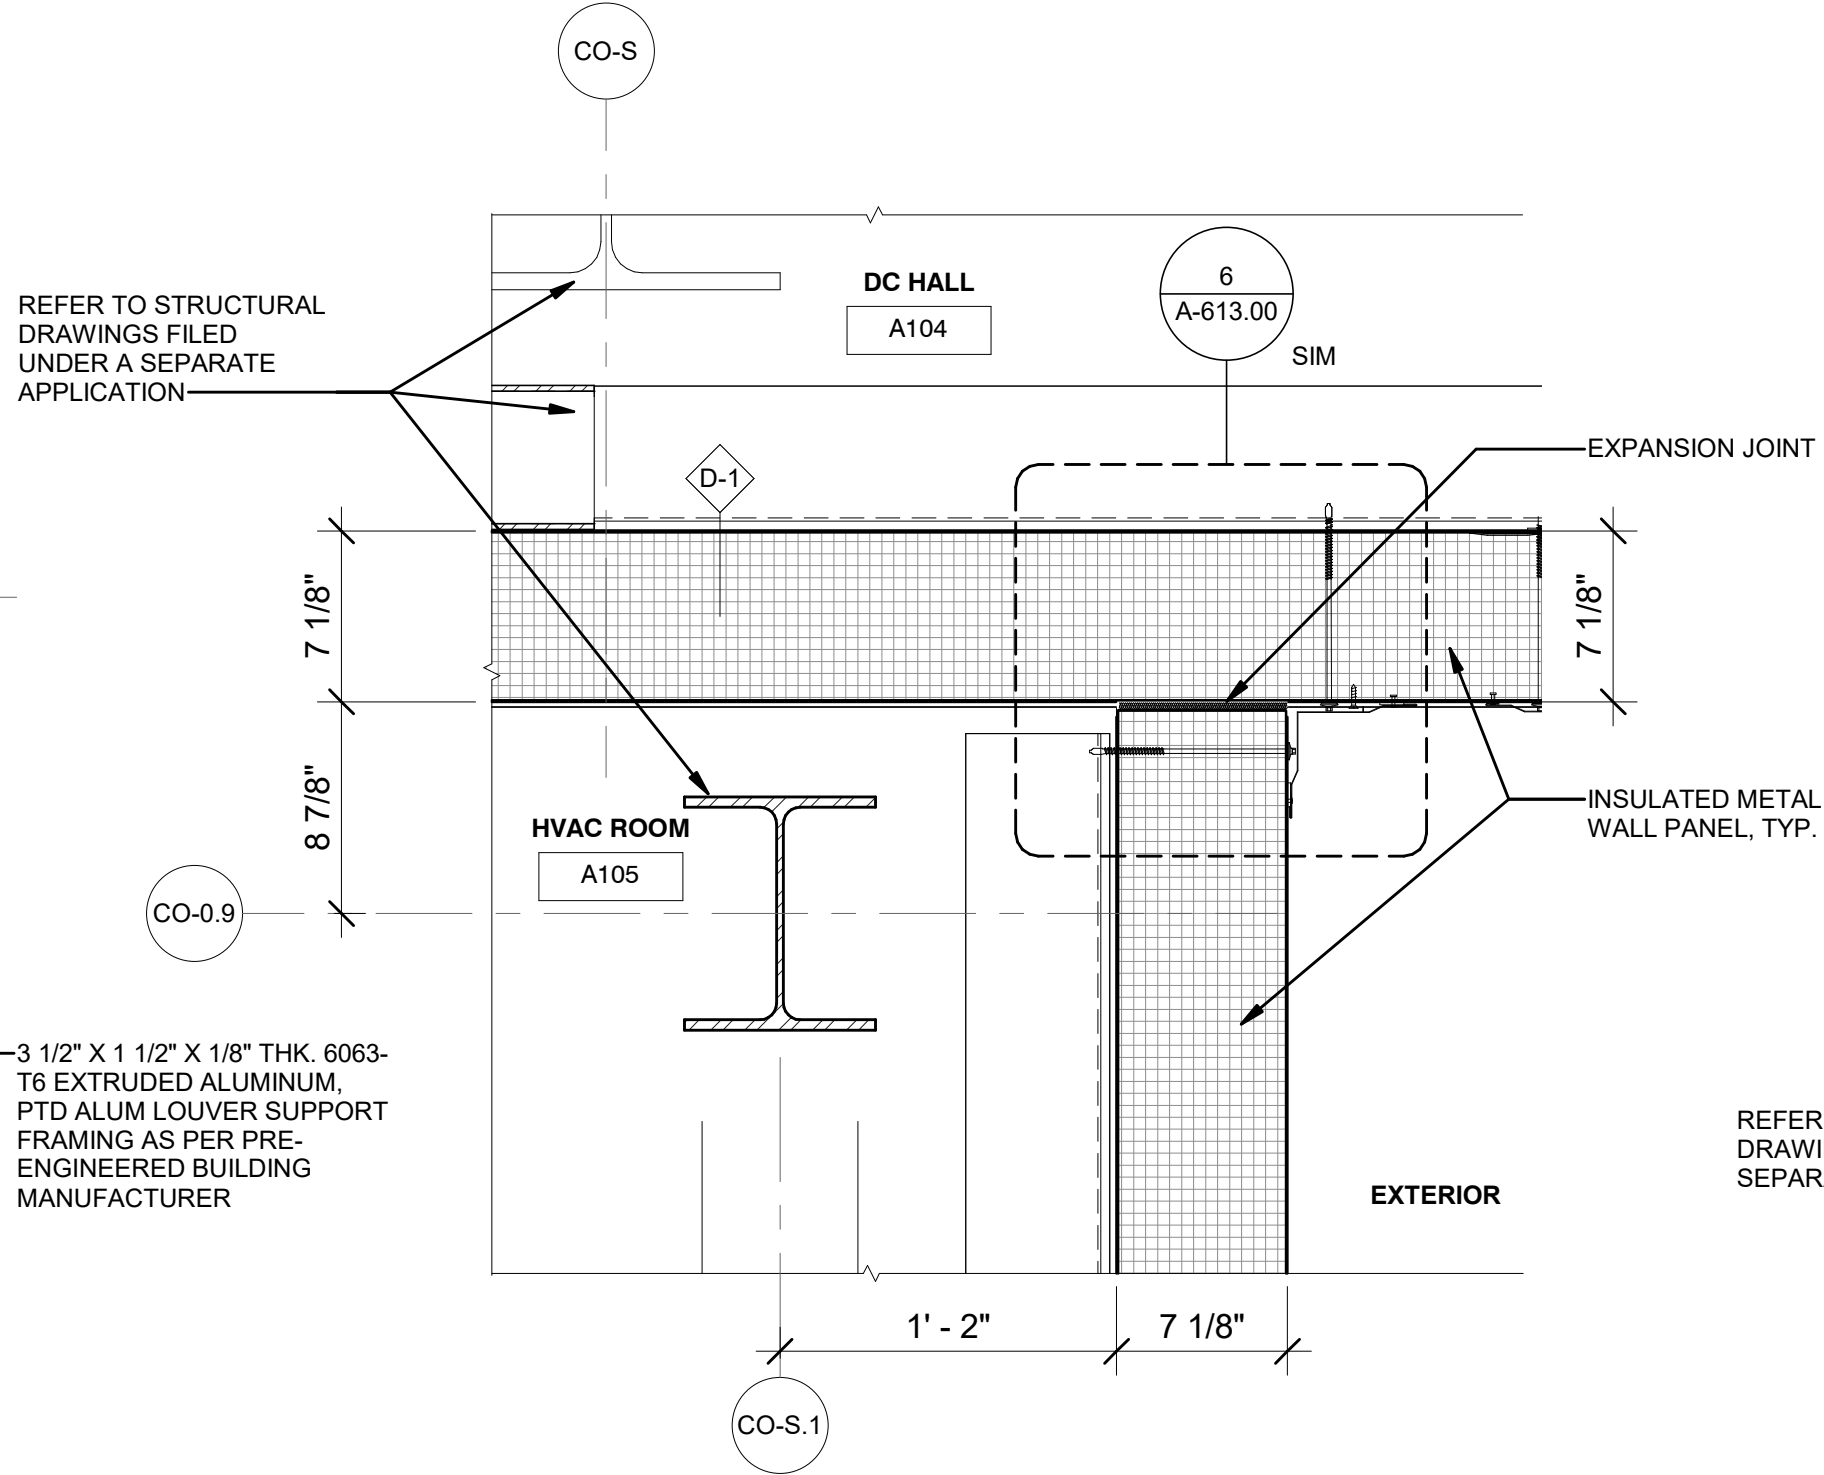


2 PLAN DETAIL - PART F - HVAC ROOM & DC HALL
A-106.00 1 1/2" = 1'-0"

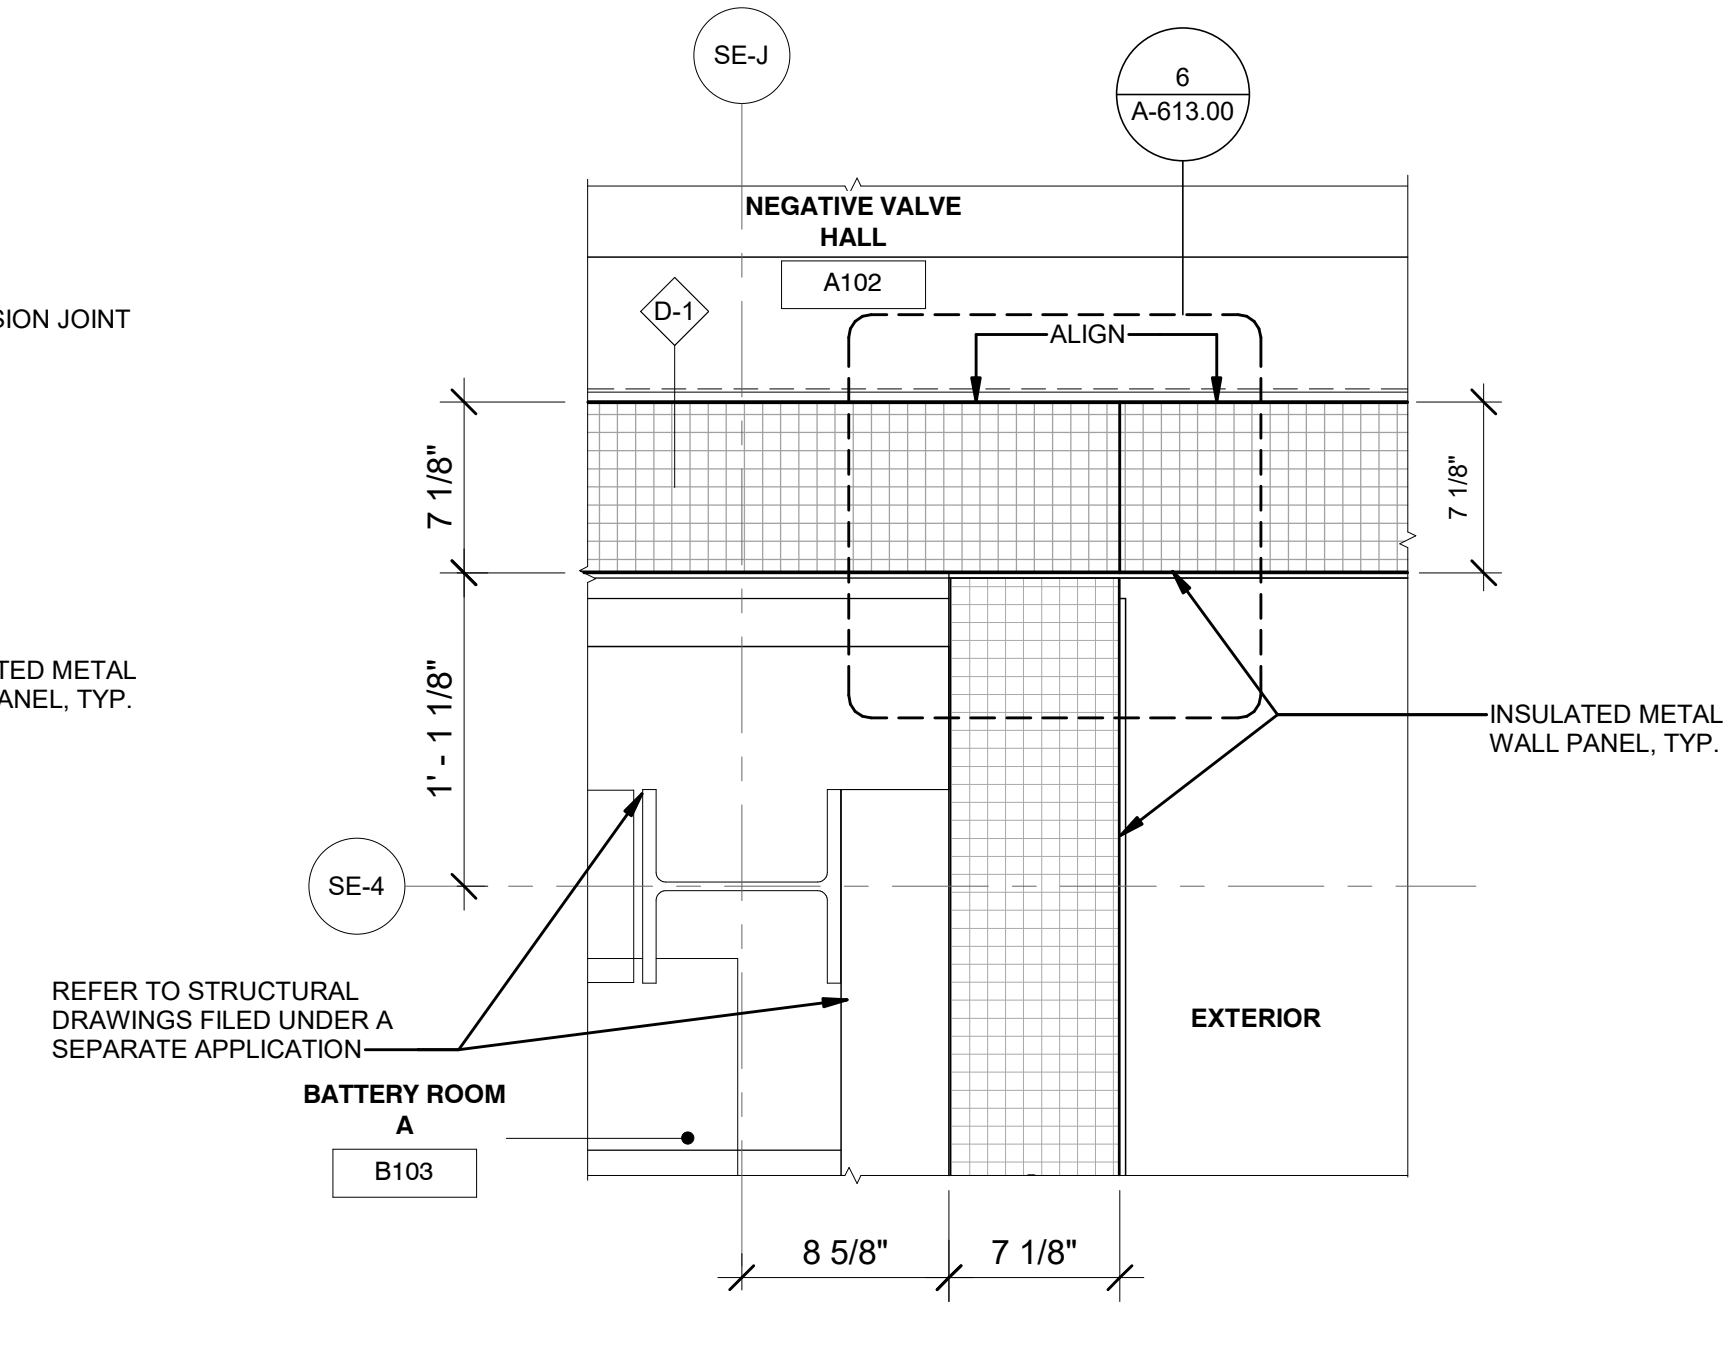


3 PLAN DETAIL - PART D - BATTERY RM. & NEGATIVE VALVE HALL
A-104.00 1 1/2" = 1'-0"

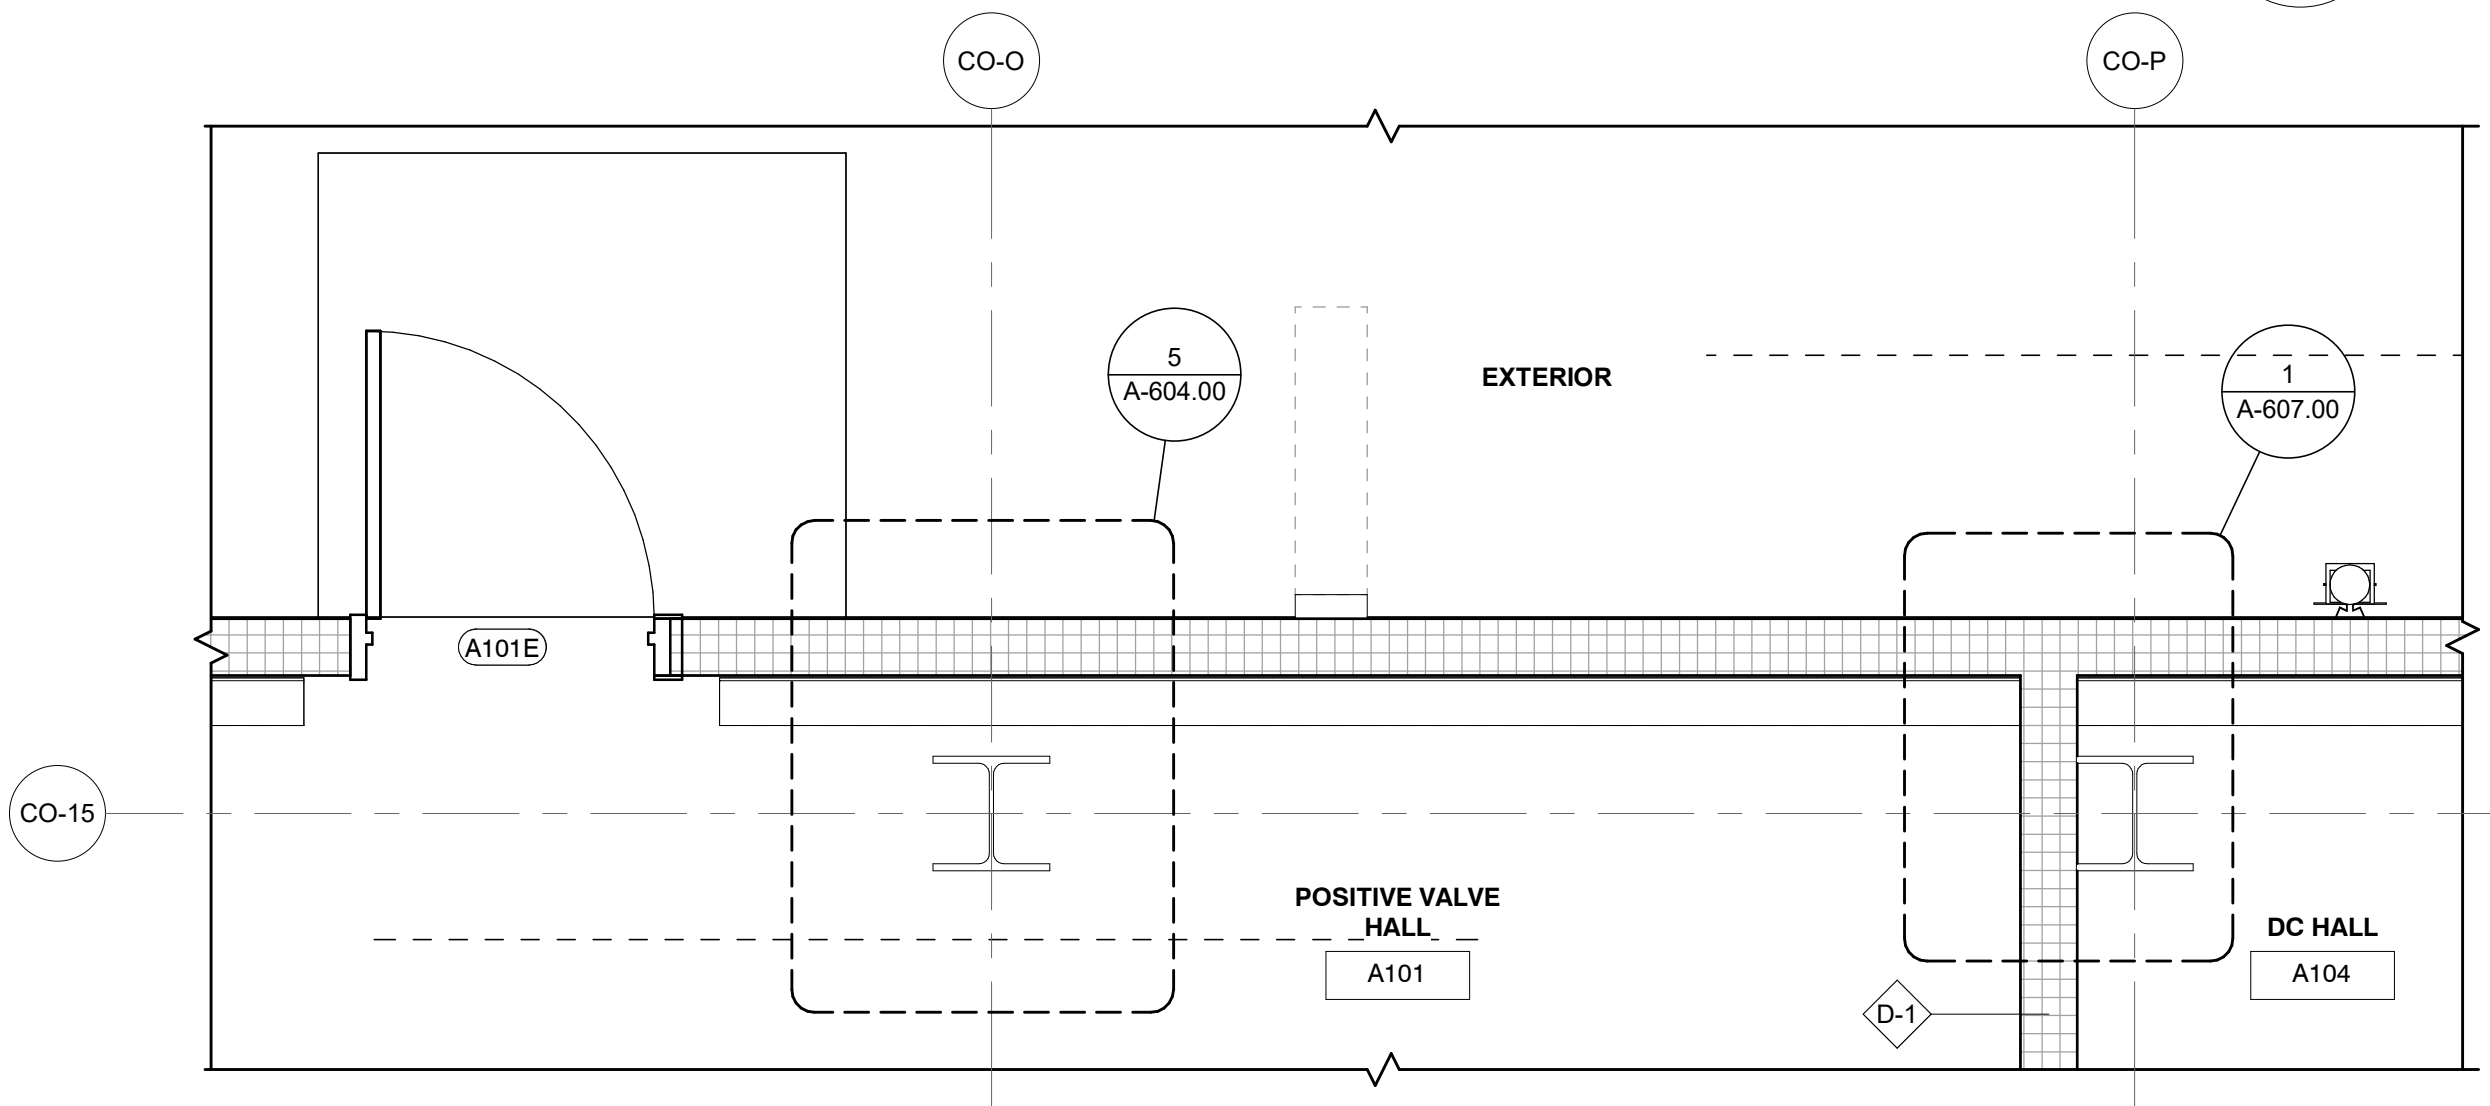

4 PLAN DETAIL - POSITIVE VALVE HALL
A-103.00 1/2" = 1'-0"

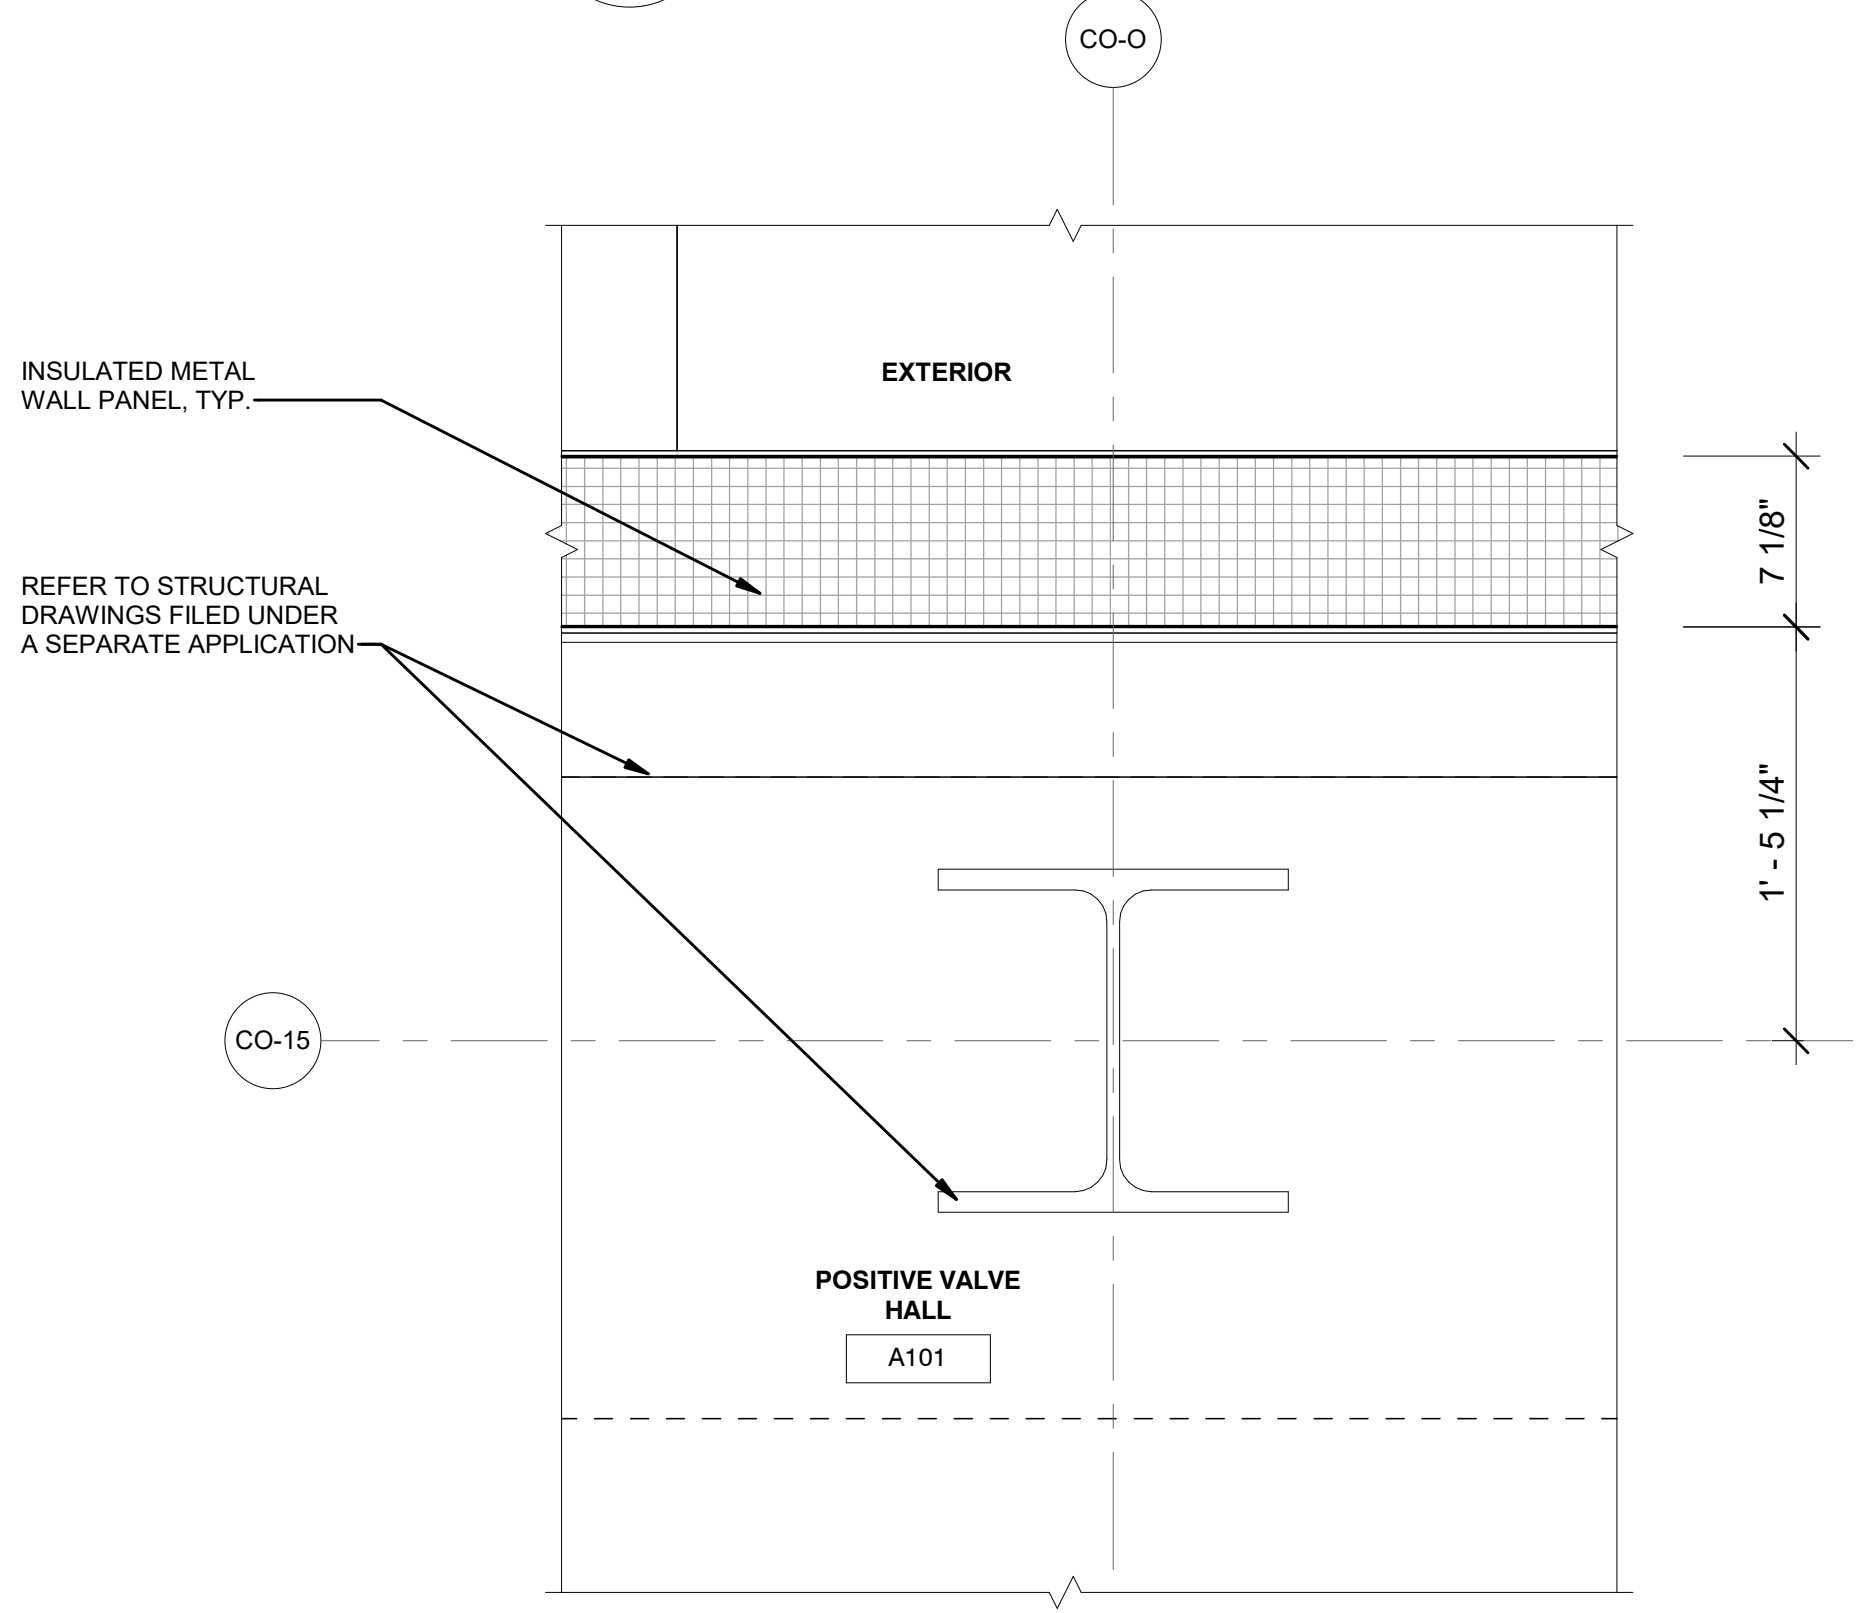

5 COLUMN GROUNDING DETAIL - POSITIVE VALVE HALL
A-103.00 1 1/2" = 1'-0"

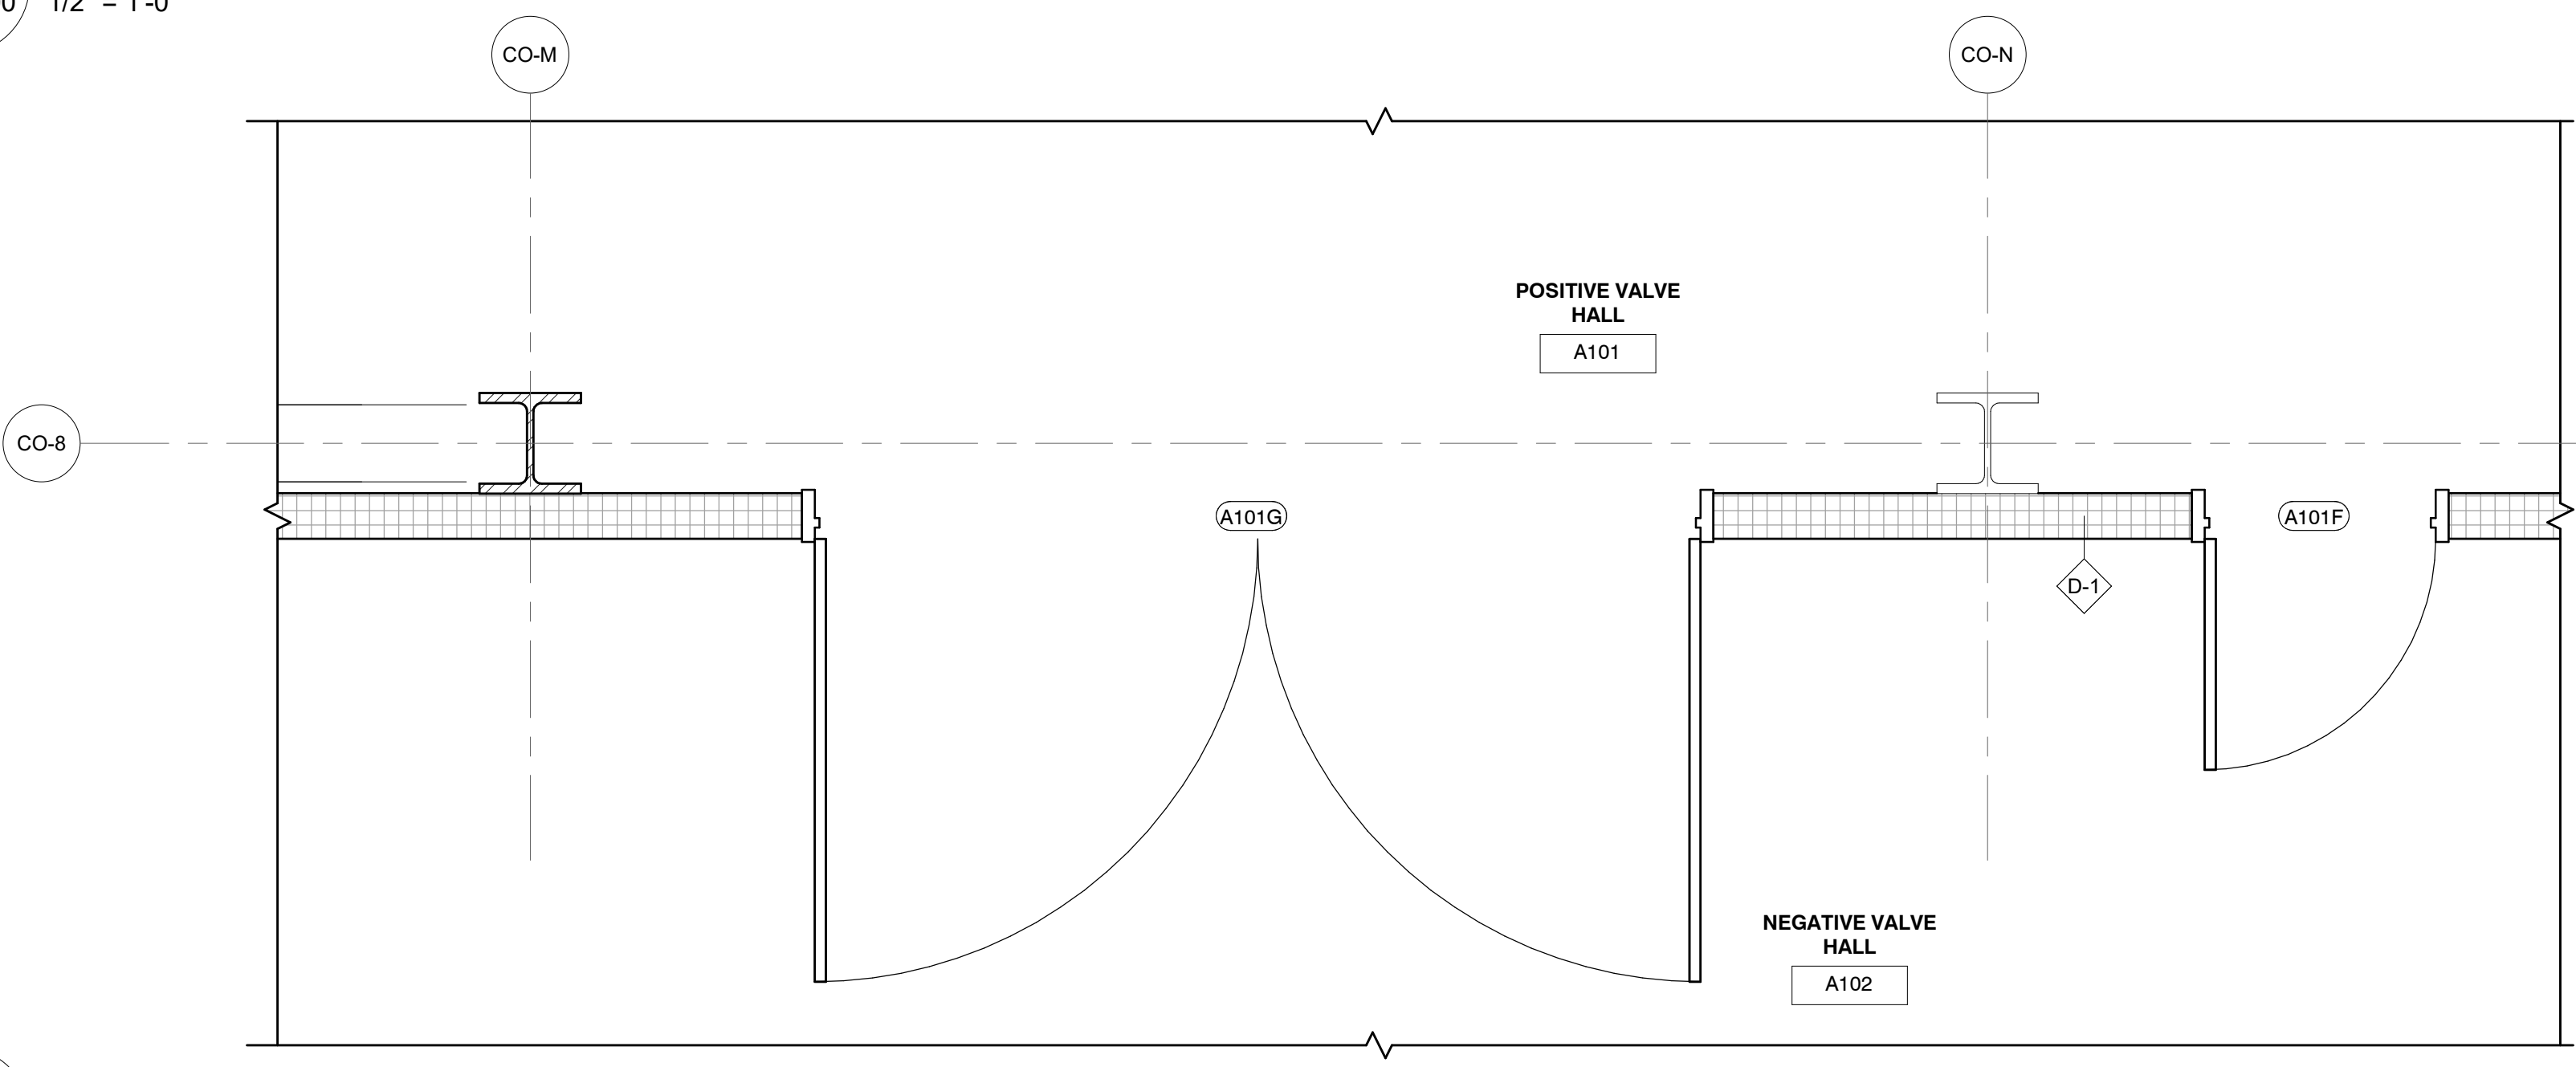

6 PLAN DETAIL - POSITIVE & NEGATIVE VALVE HALLS
A-103.00 1/2" = 1'-0"

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PROJECT
CHPE
Champlain Hudson
Power Express


**Astoria HVDC
Converter Station**

31-45 20th Avenue, Astoria, Queens NY 11105
Block #850 - Lot #310 - BIN #4624437


PLAN DETAILS 1



DATE 12/12/22
PROJECT NO 105121
DRAWING BY R. COLES
CHECKED BY Z. HARR
DRAWING NO
A-604.00
CADD FILE NO
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Astoria-CHA-KIE-111-ZZ-M3-A-001.rvt

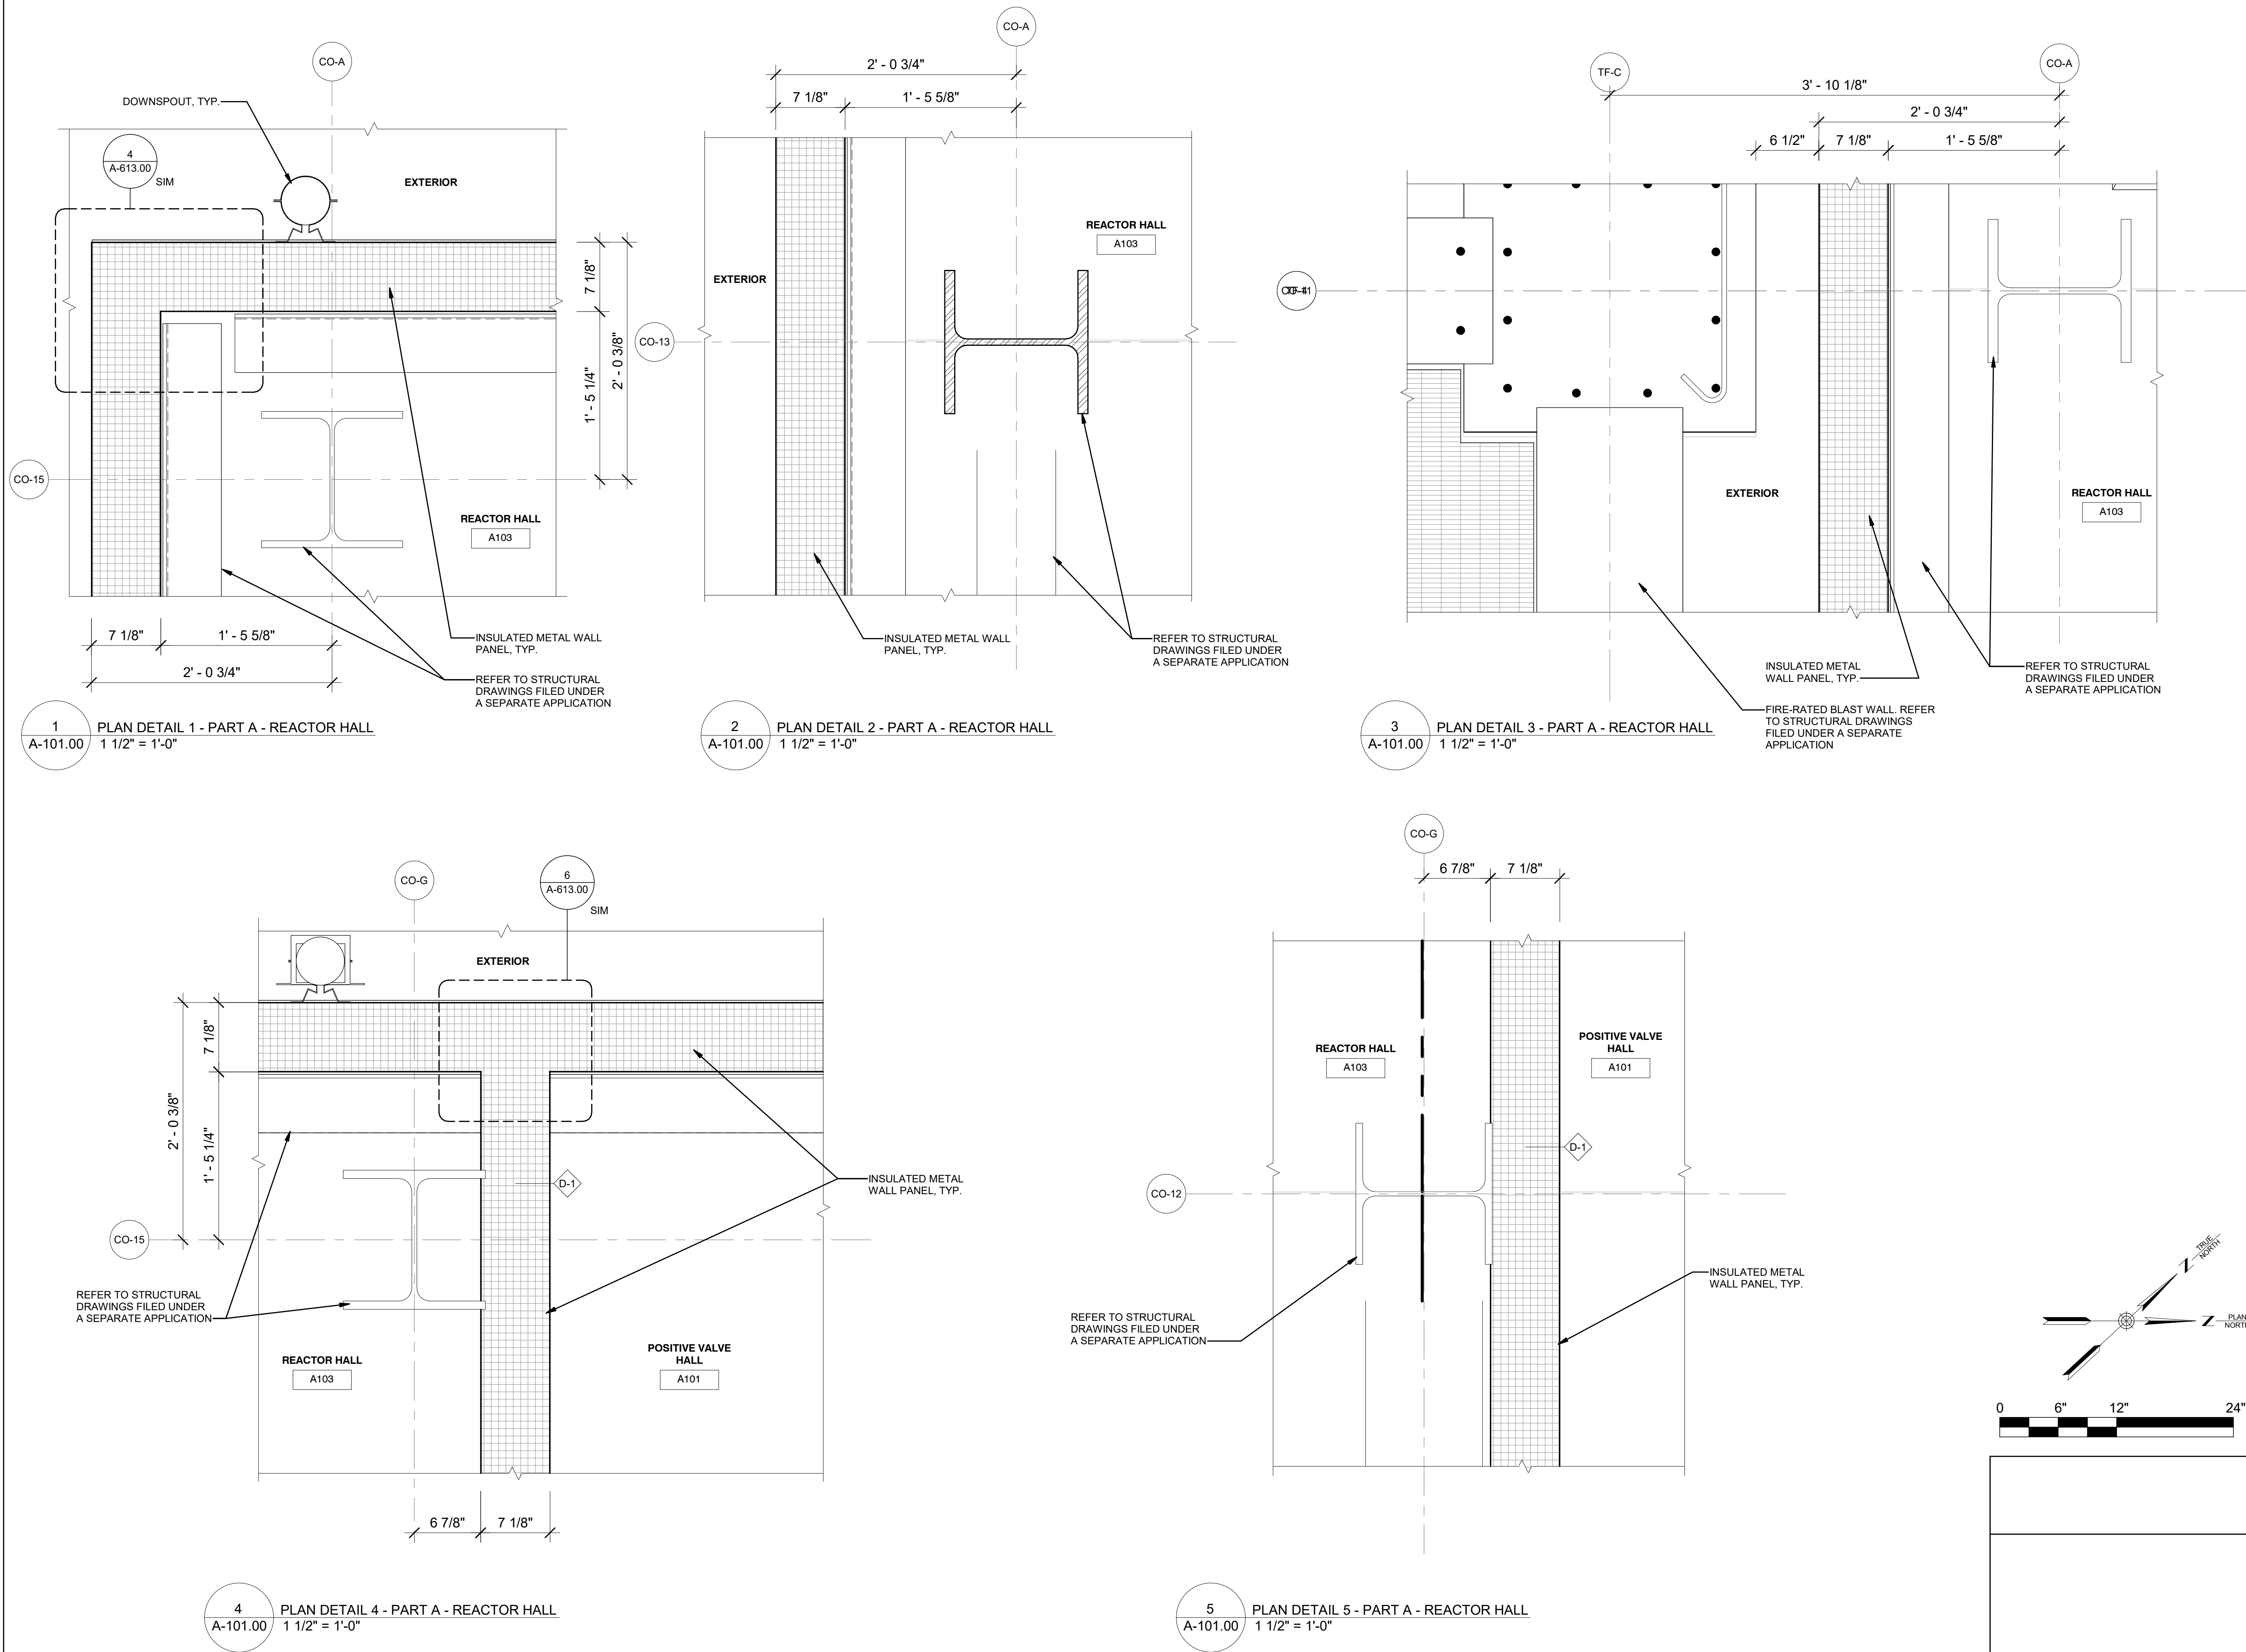

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Converter Station

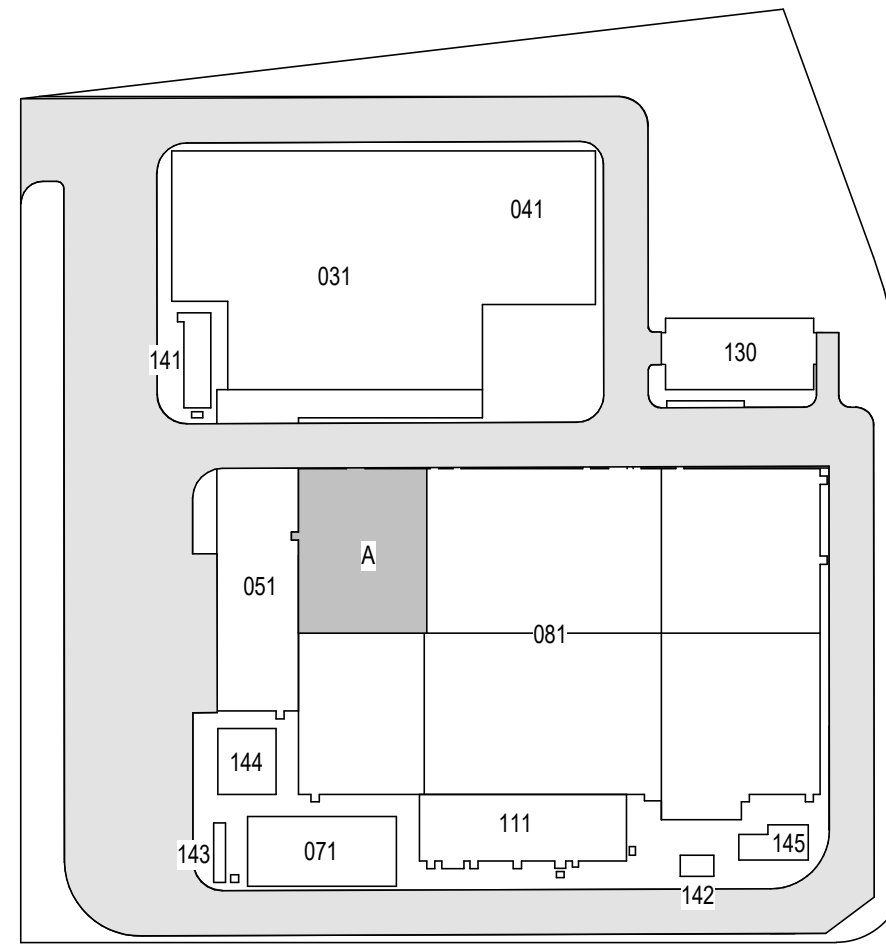
31-45 20th Avenue, Astoria, Queens NY 11105
Block #850 - Lot #310 - BIN #4624437

PLAN DETAILS 2




DATE 12/12/22
PROJECT NO 105121
DRAWING BY R. COLES
CHECKED BY Z. HARR
DRAWING NO
A-605.00
CADD FILE NO
Astoria-HVDC-CHPE
Astoria-CHPE-111-ZZ-M3-A-001.rvt


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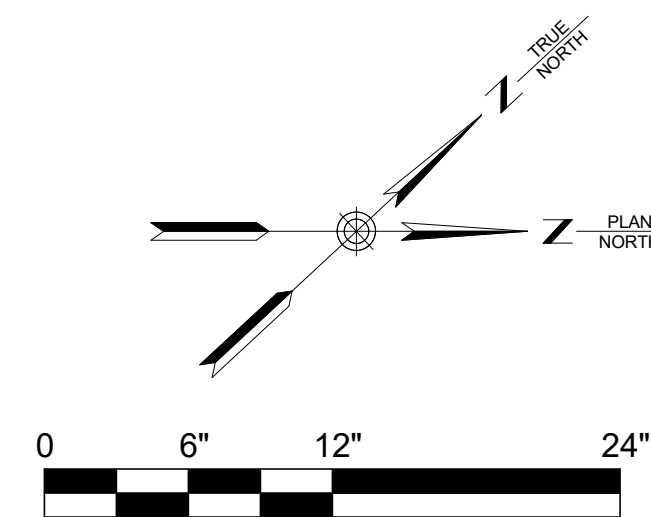
1
A-101.00
PLAN DETAIL - PART B - REACTOR HALL & VALVE HALLS INTERSECTION
1 1/2" = 1'-0"

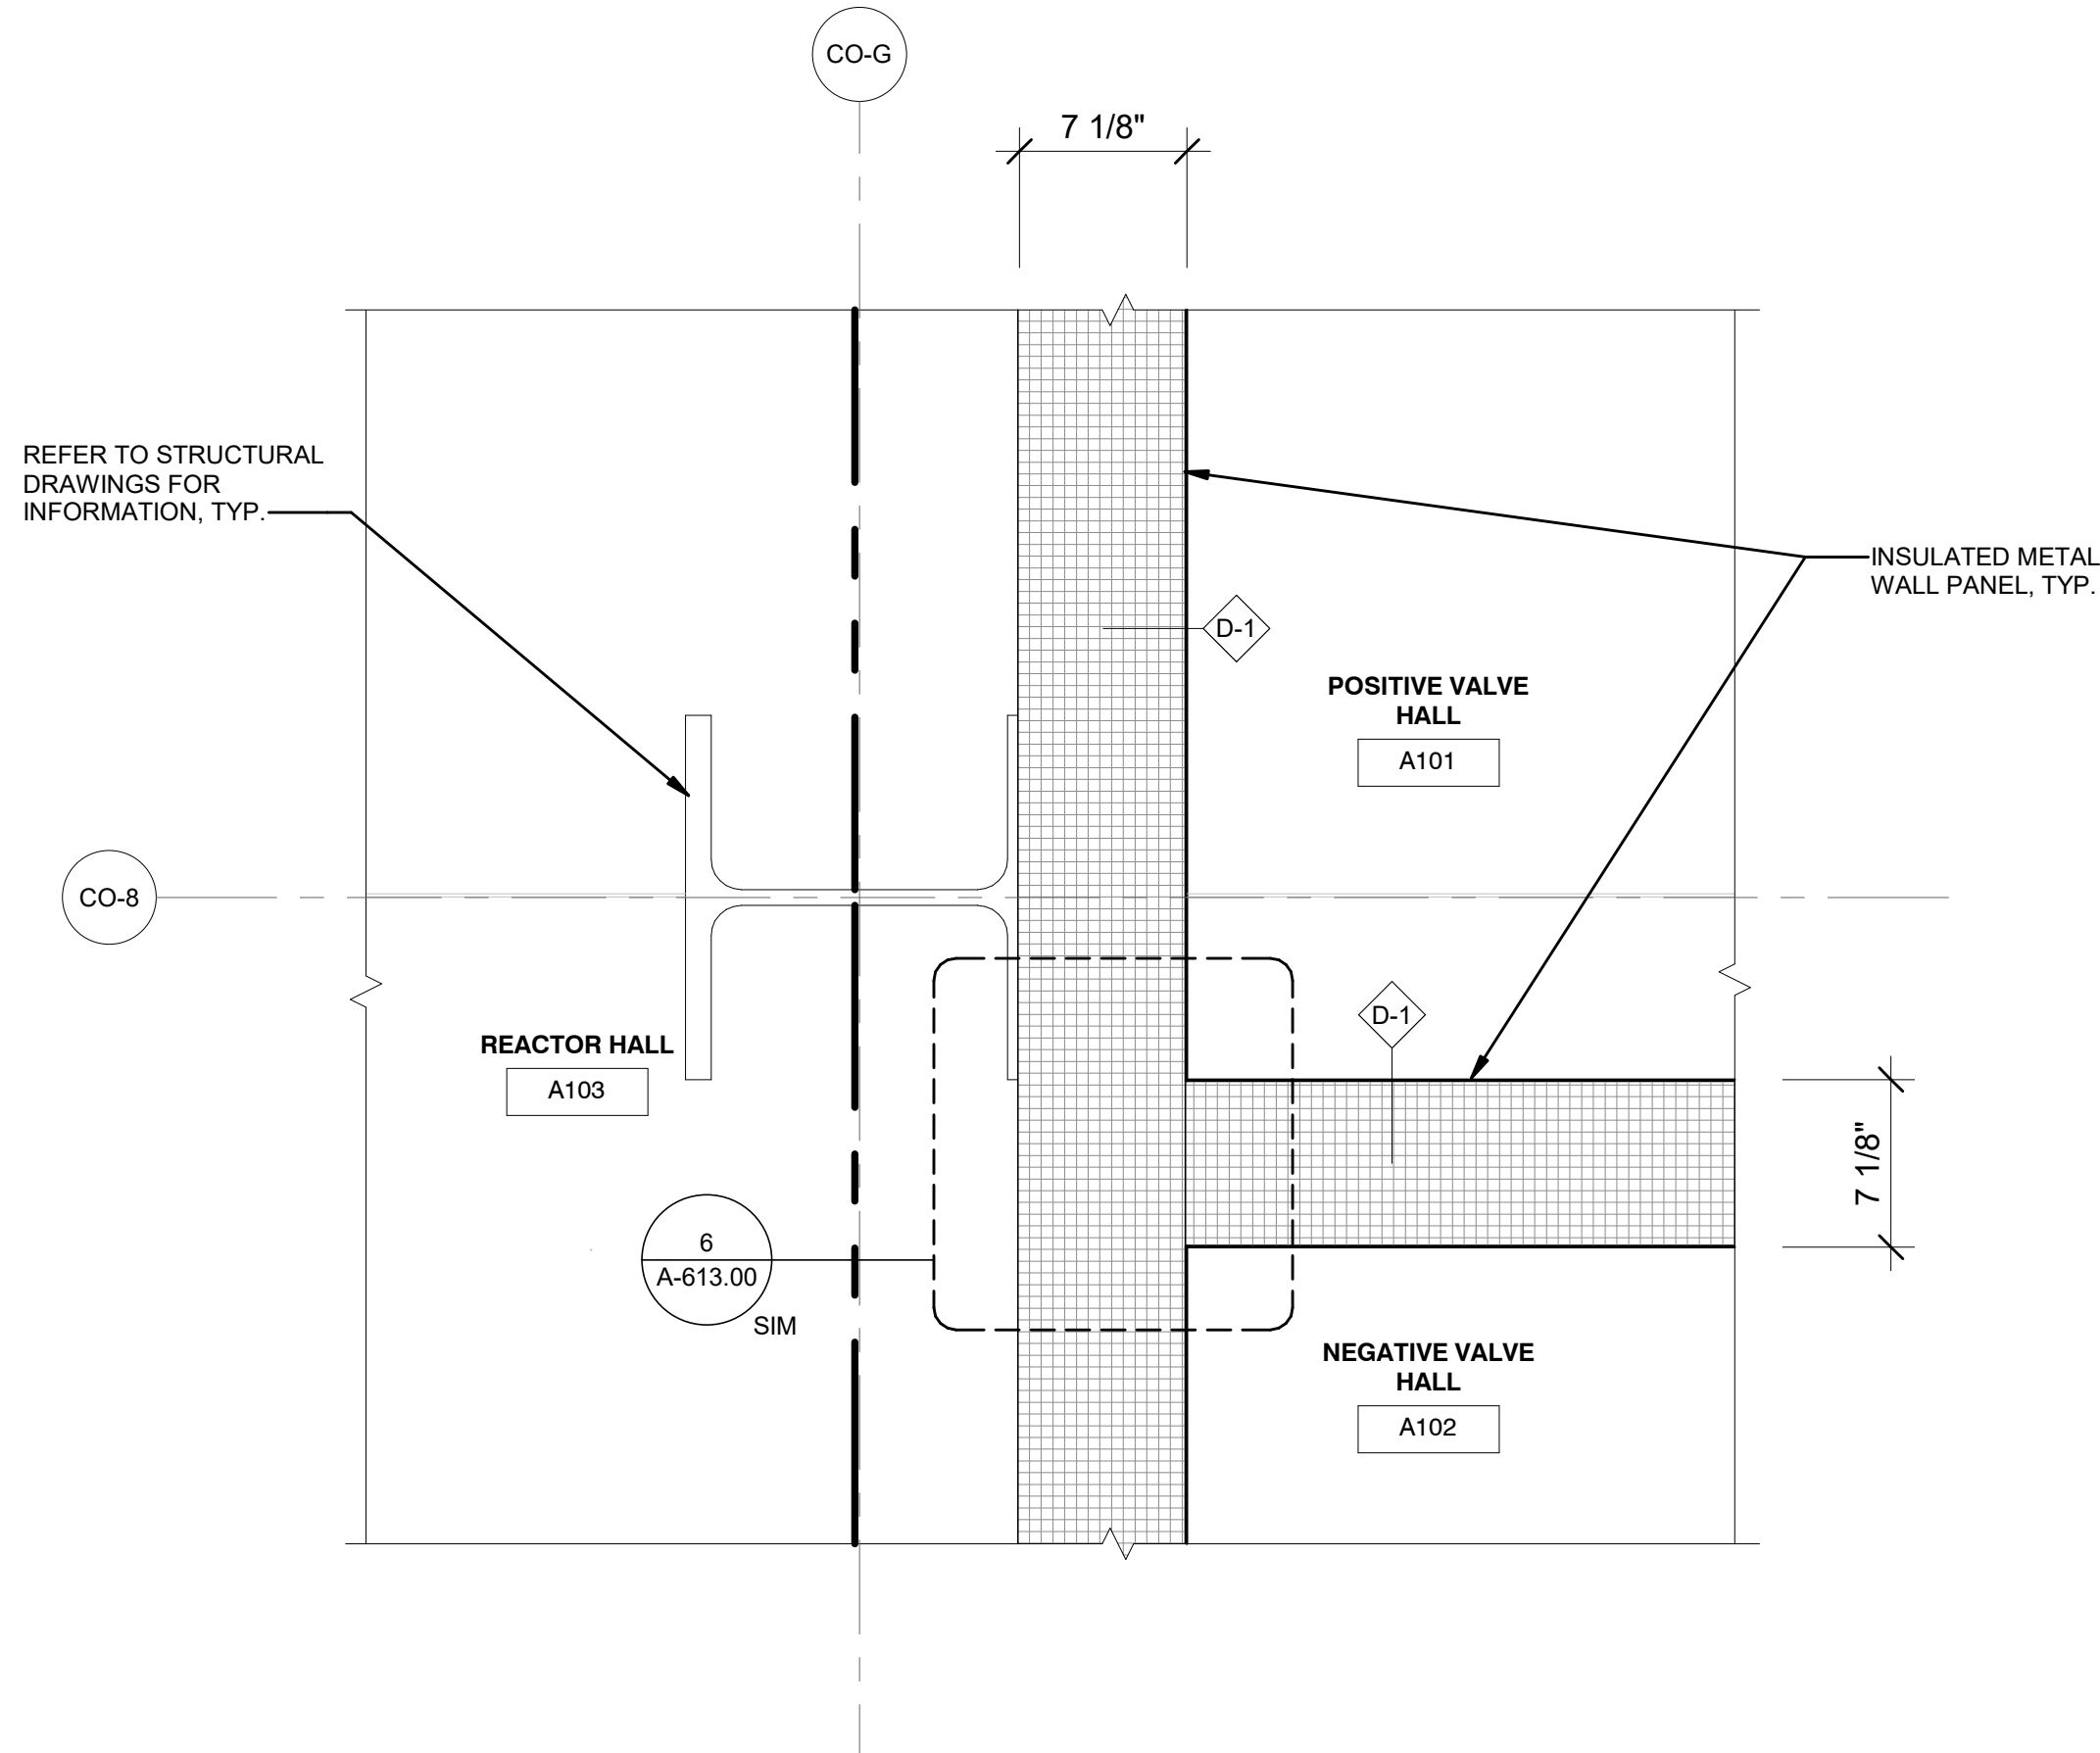


2
A-102.00
PLAN DETAIL - PART B - REACTOR HALL & SERVICE BLDG. INTERSECTION
1 1/2" = 1'-0"

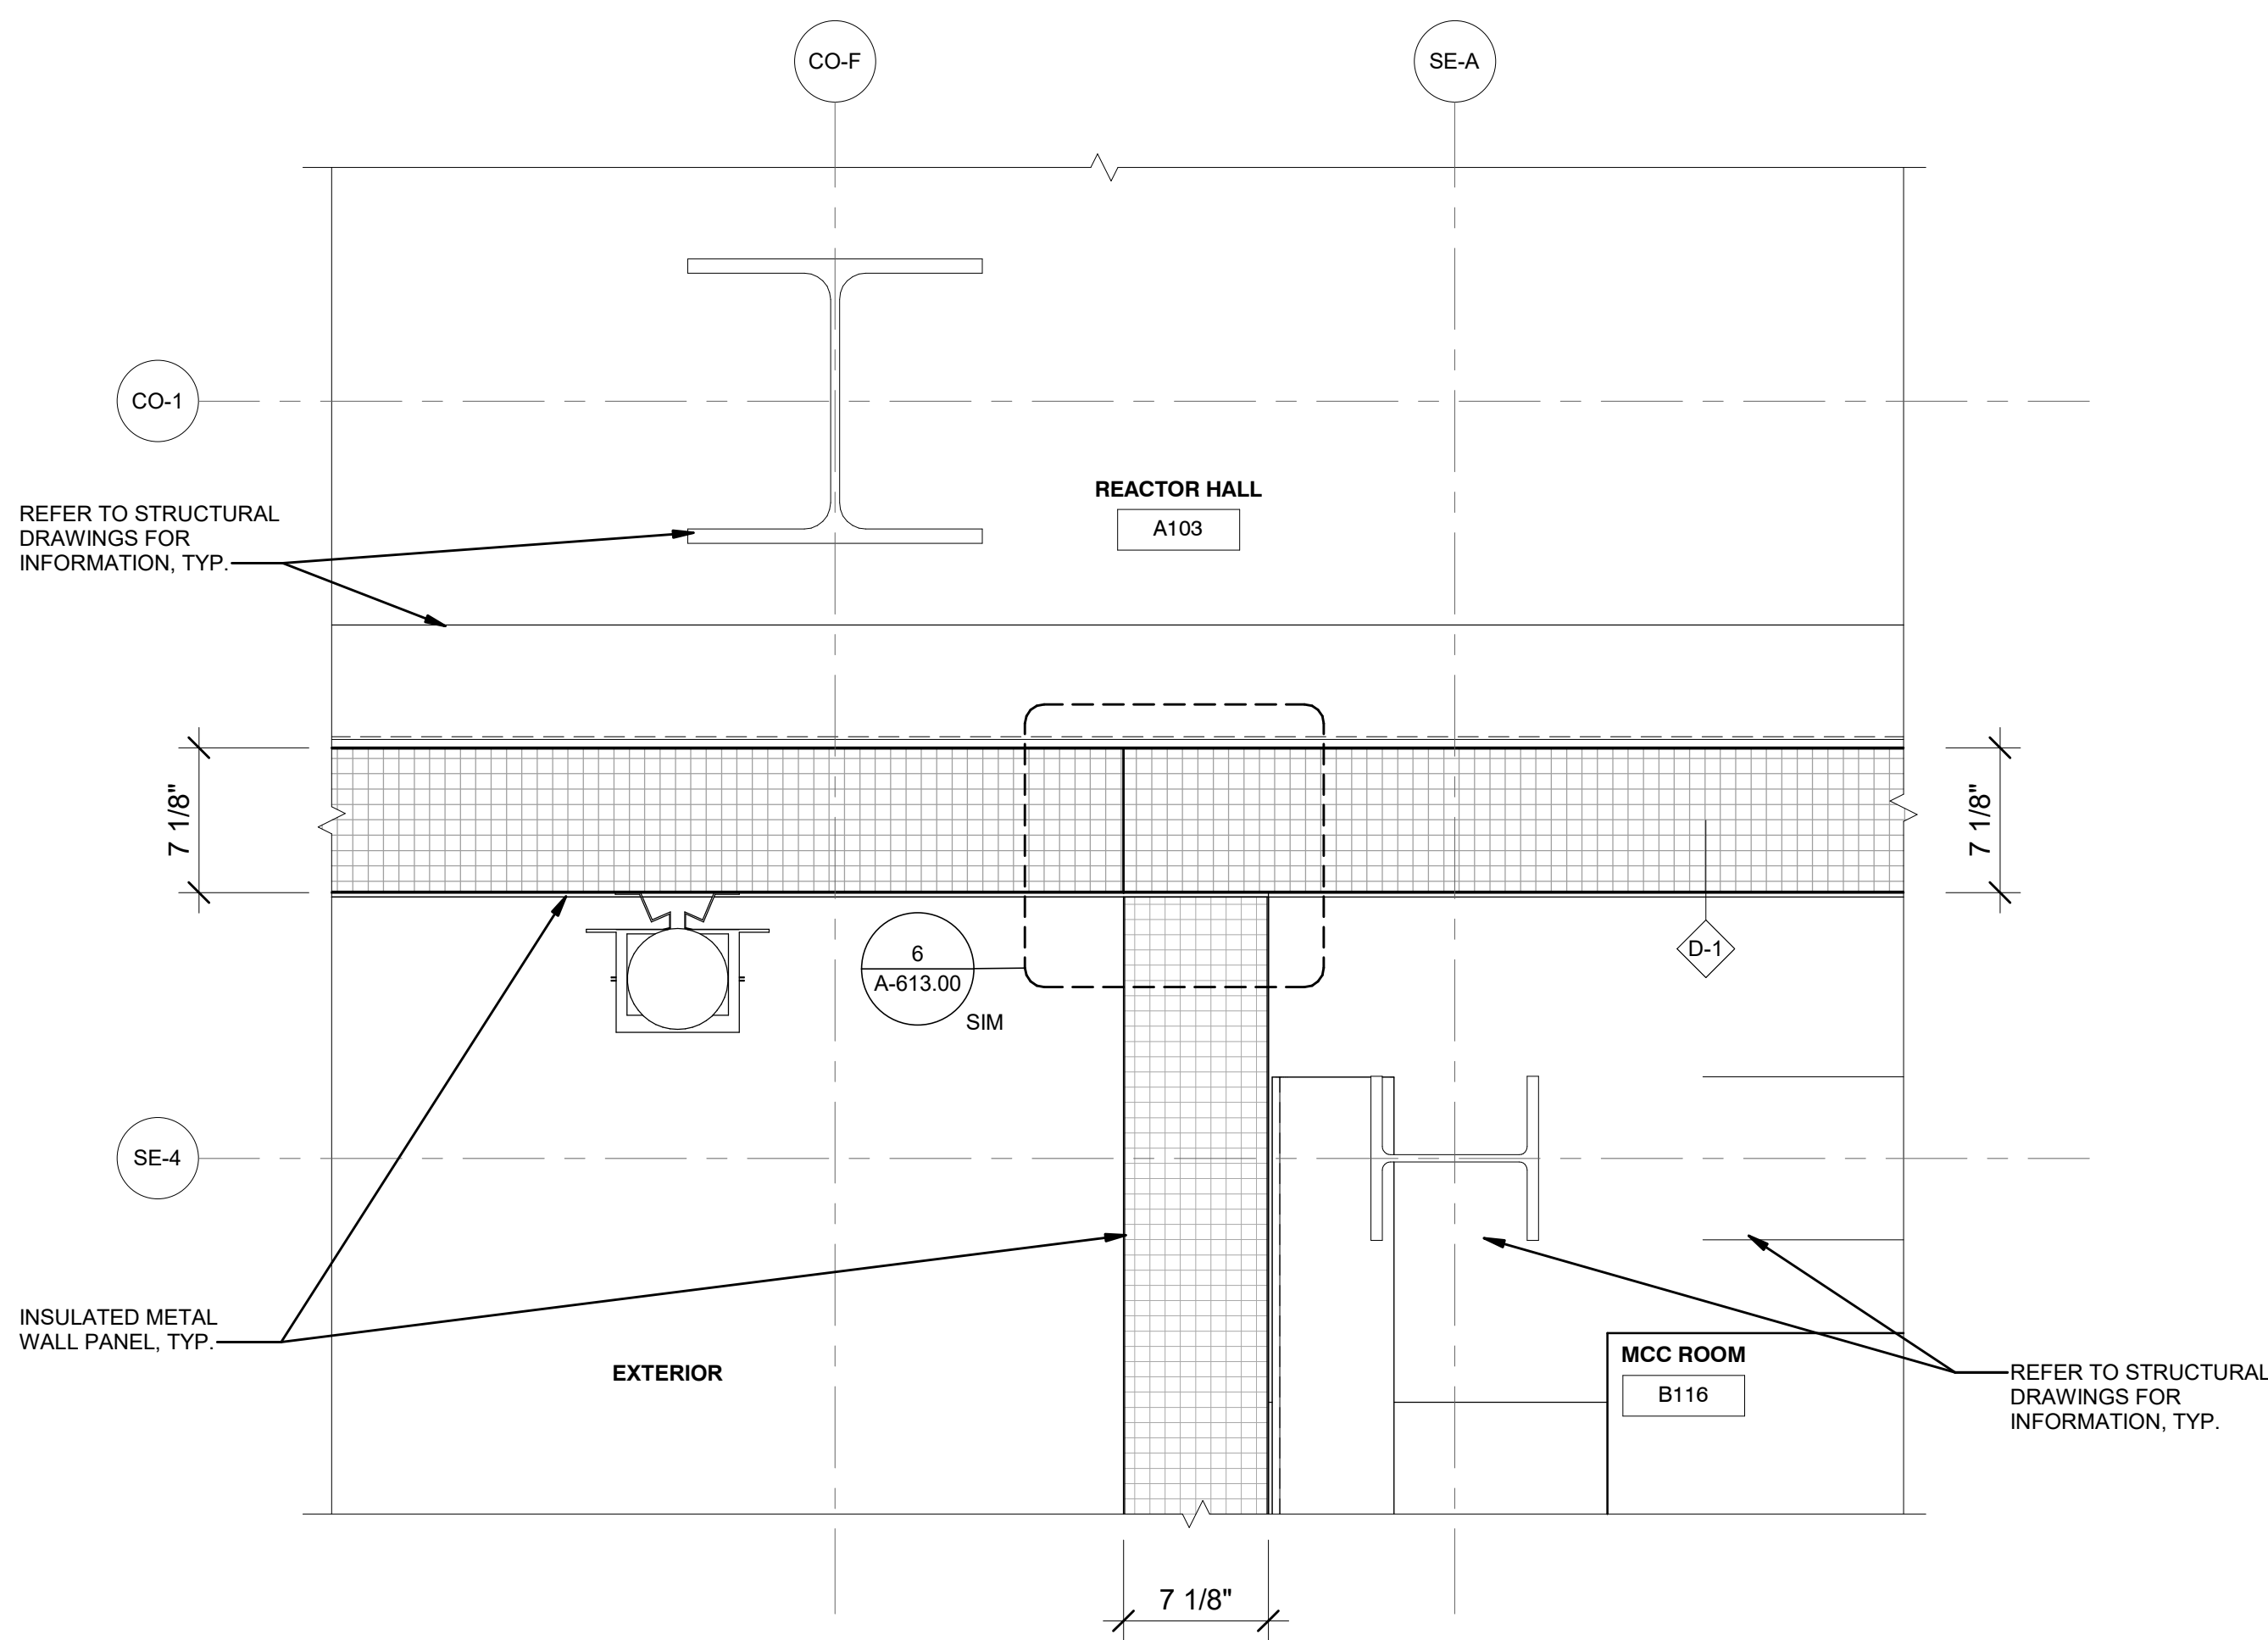

3
A-102.00
PLAN DETAIL - PART B - REACTOR HALL, SERVICE BLDG. & VALVE HALL INTERSECTION
1 1/2" = 1'-0"

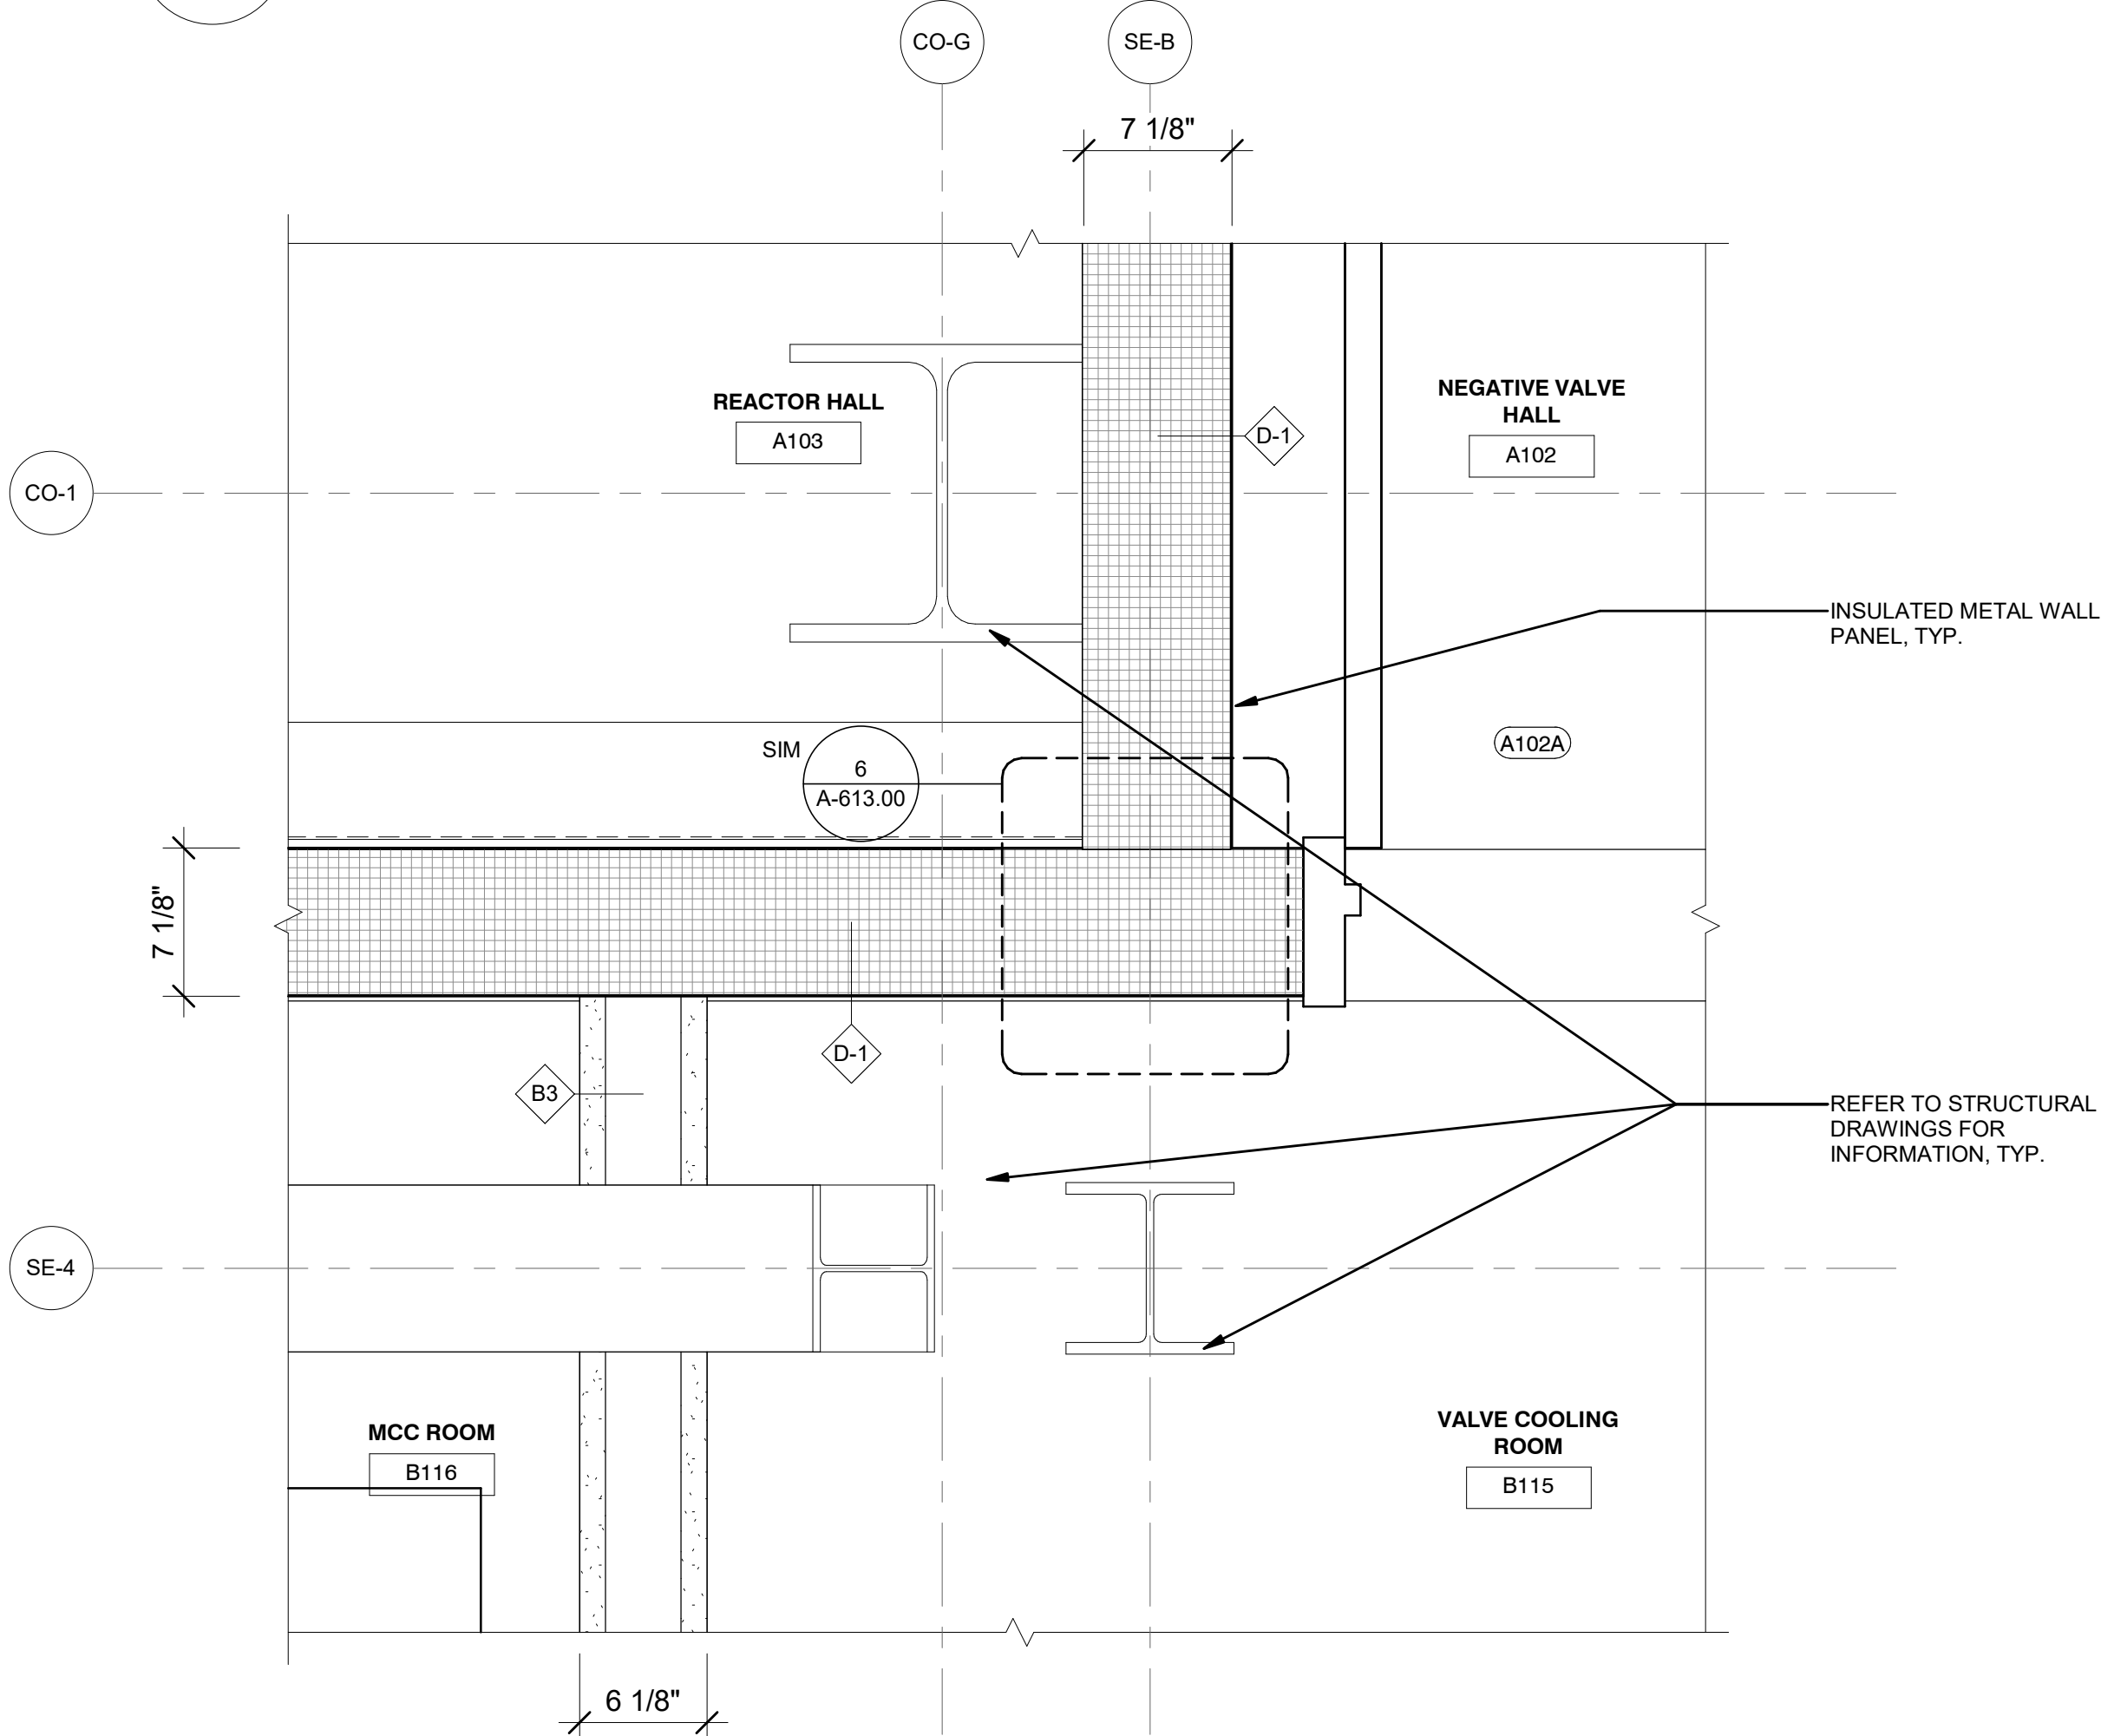

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Kiewit
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PROJECT

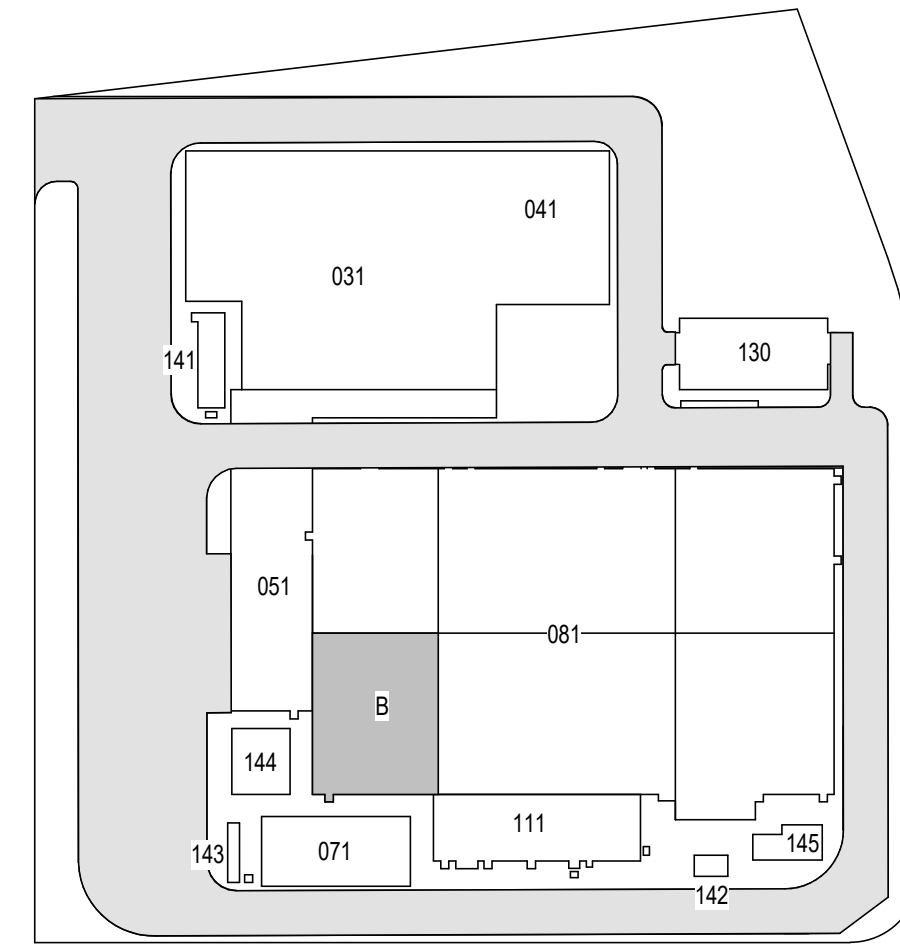CHPE
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Power Express


Astoria HVDC
Converter Station

31-45 20th Avenue, Astoria, Queens NY 11105
Block #850 - Lot #310 - BIN #4624437


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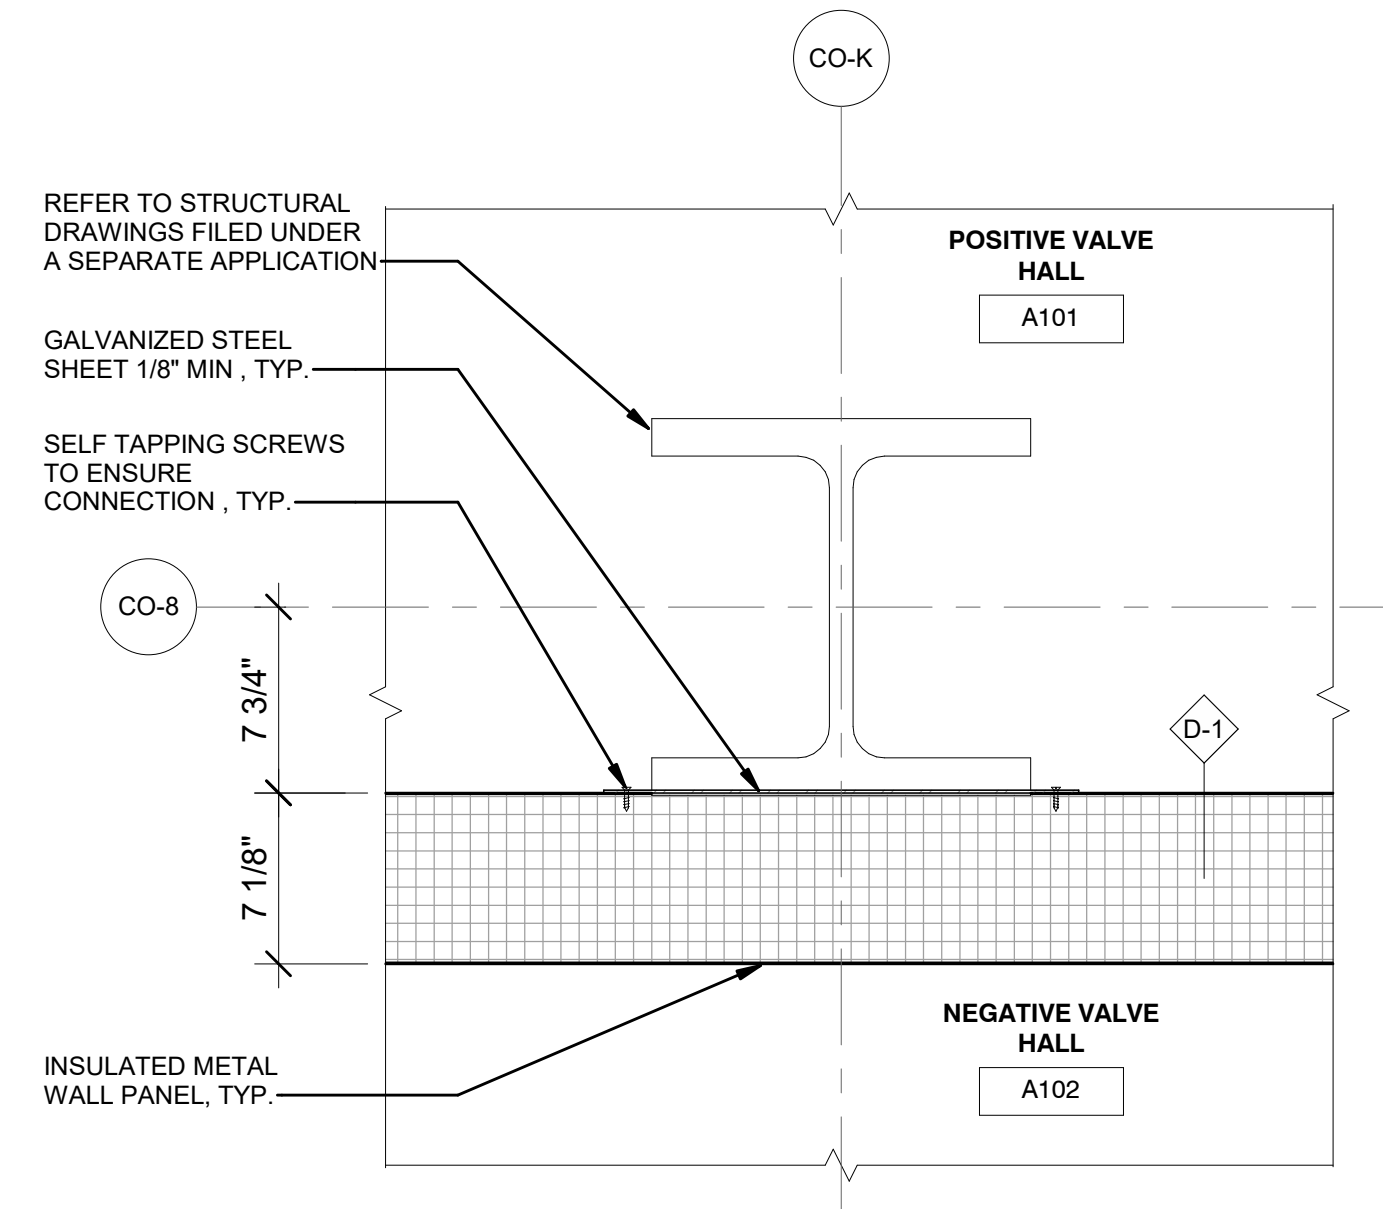
DATE 12/12/22
PROJECT NO 105121
DRAWING BY R. COLES
CHECKED BY Z. HARR
DRAWING NO
A-606.00
CADD FILE NO
Astoria-HVDC-CHPE
Astoria-CHA-KE-111-22-M3-A-001.rvt




1 PLAN DETAIL - PART C - VALVE HALL & DC HALL
A-103.00 1 1/2" = 1'-0"

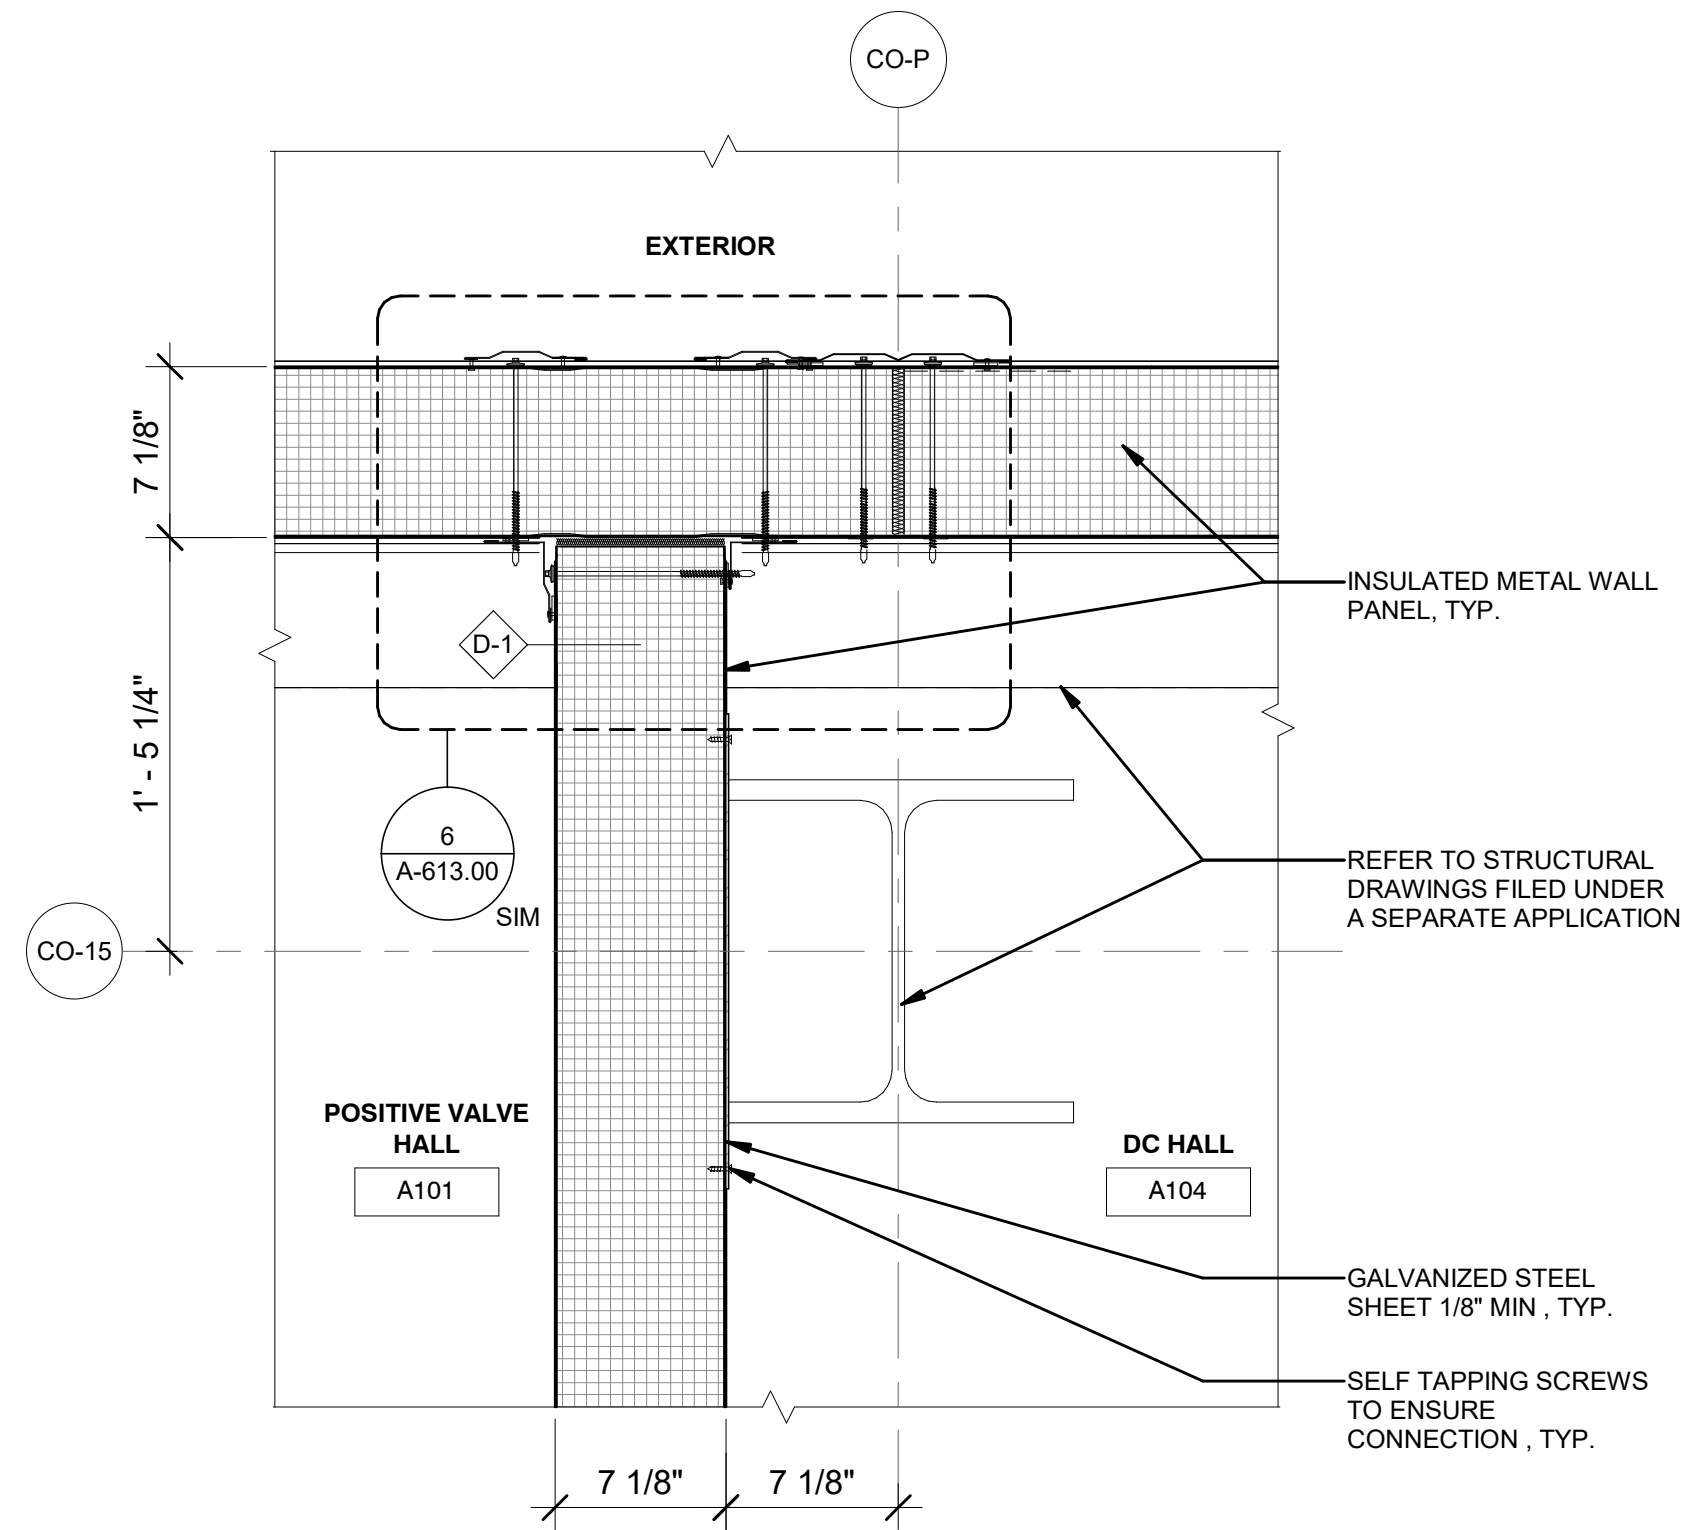


5 PLAN DETAIL - PART C - VALVE HALLS & DC HALL
A-103.00 1 1/2" = 1'-0"

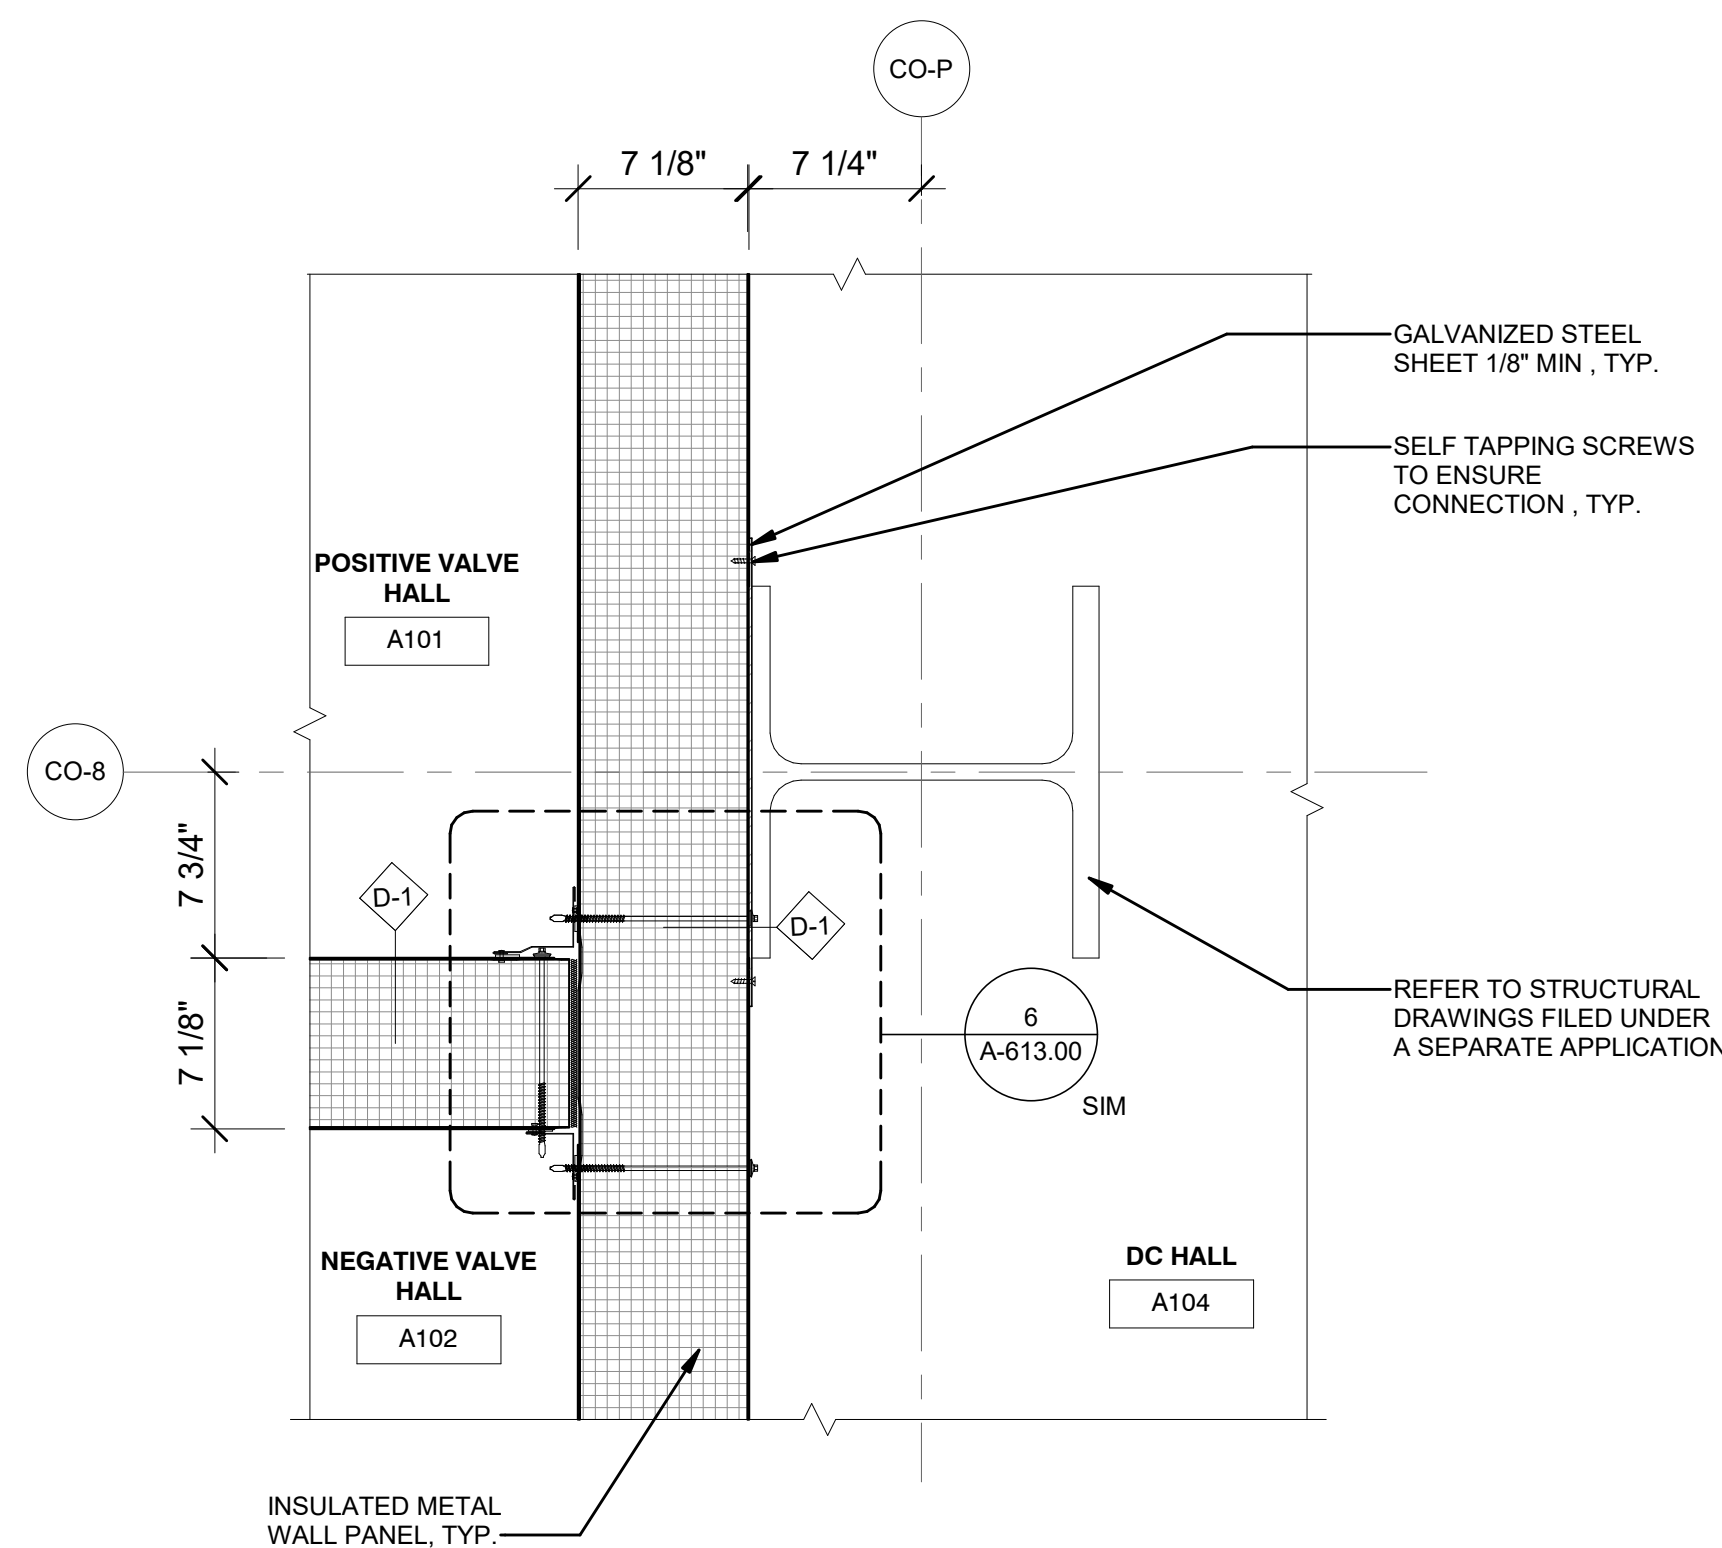


4 PLAN DETAIL - PART C - VALVE HALLS 1 & 2
A-103.00 1 1/2" = 1'-0"

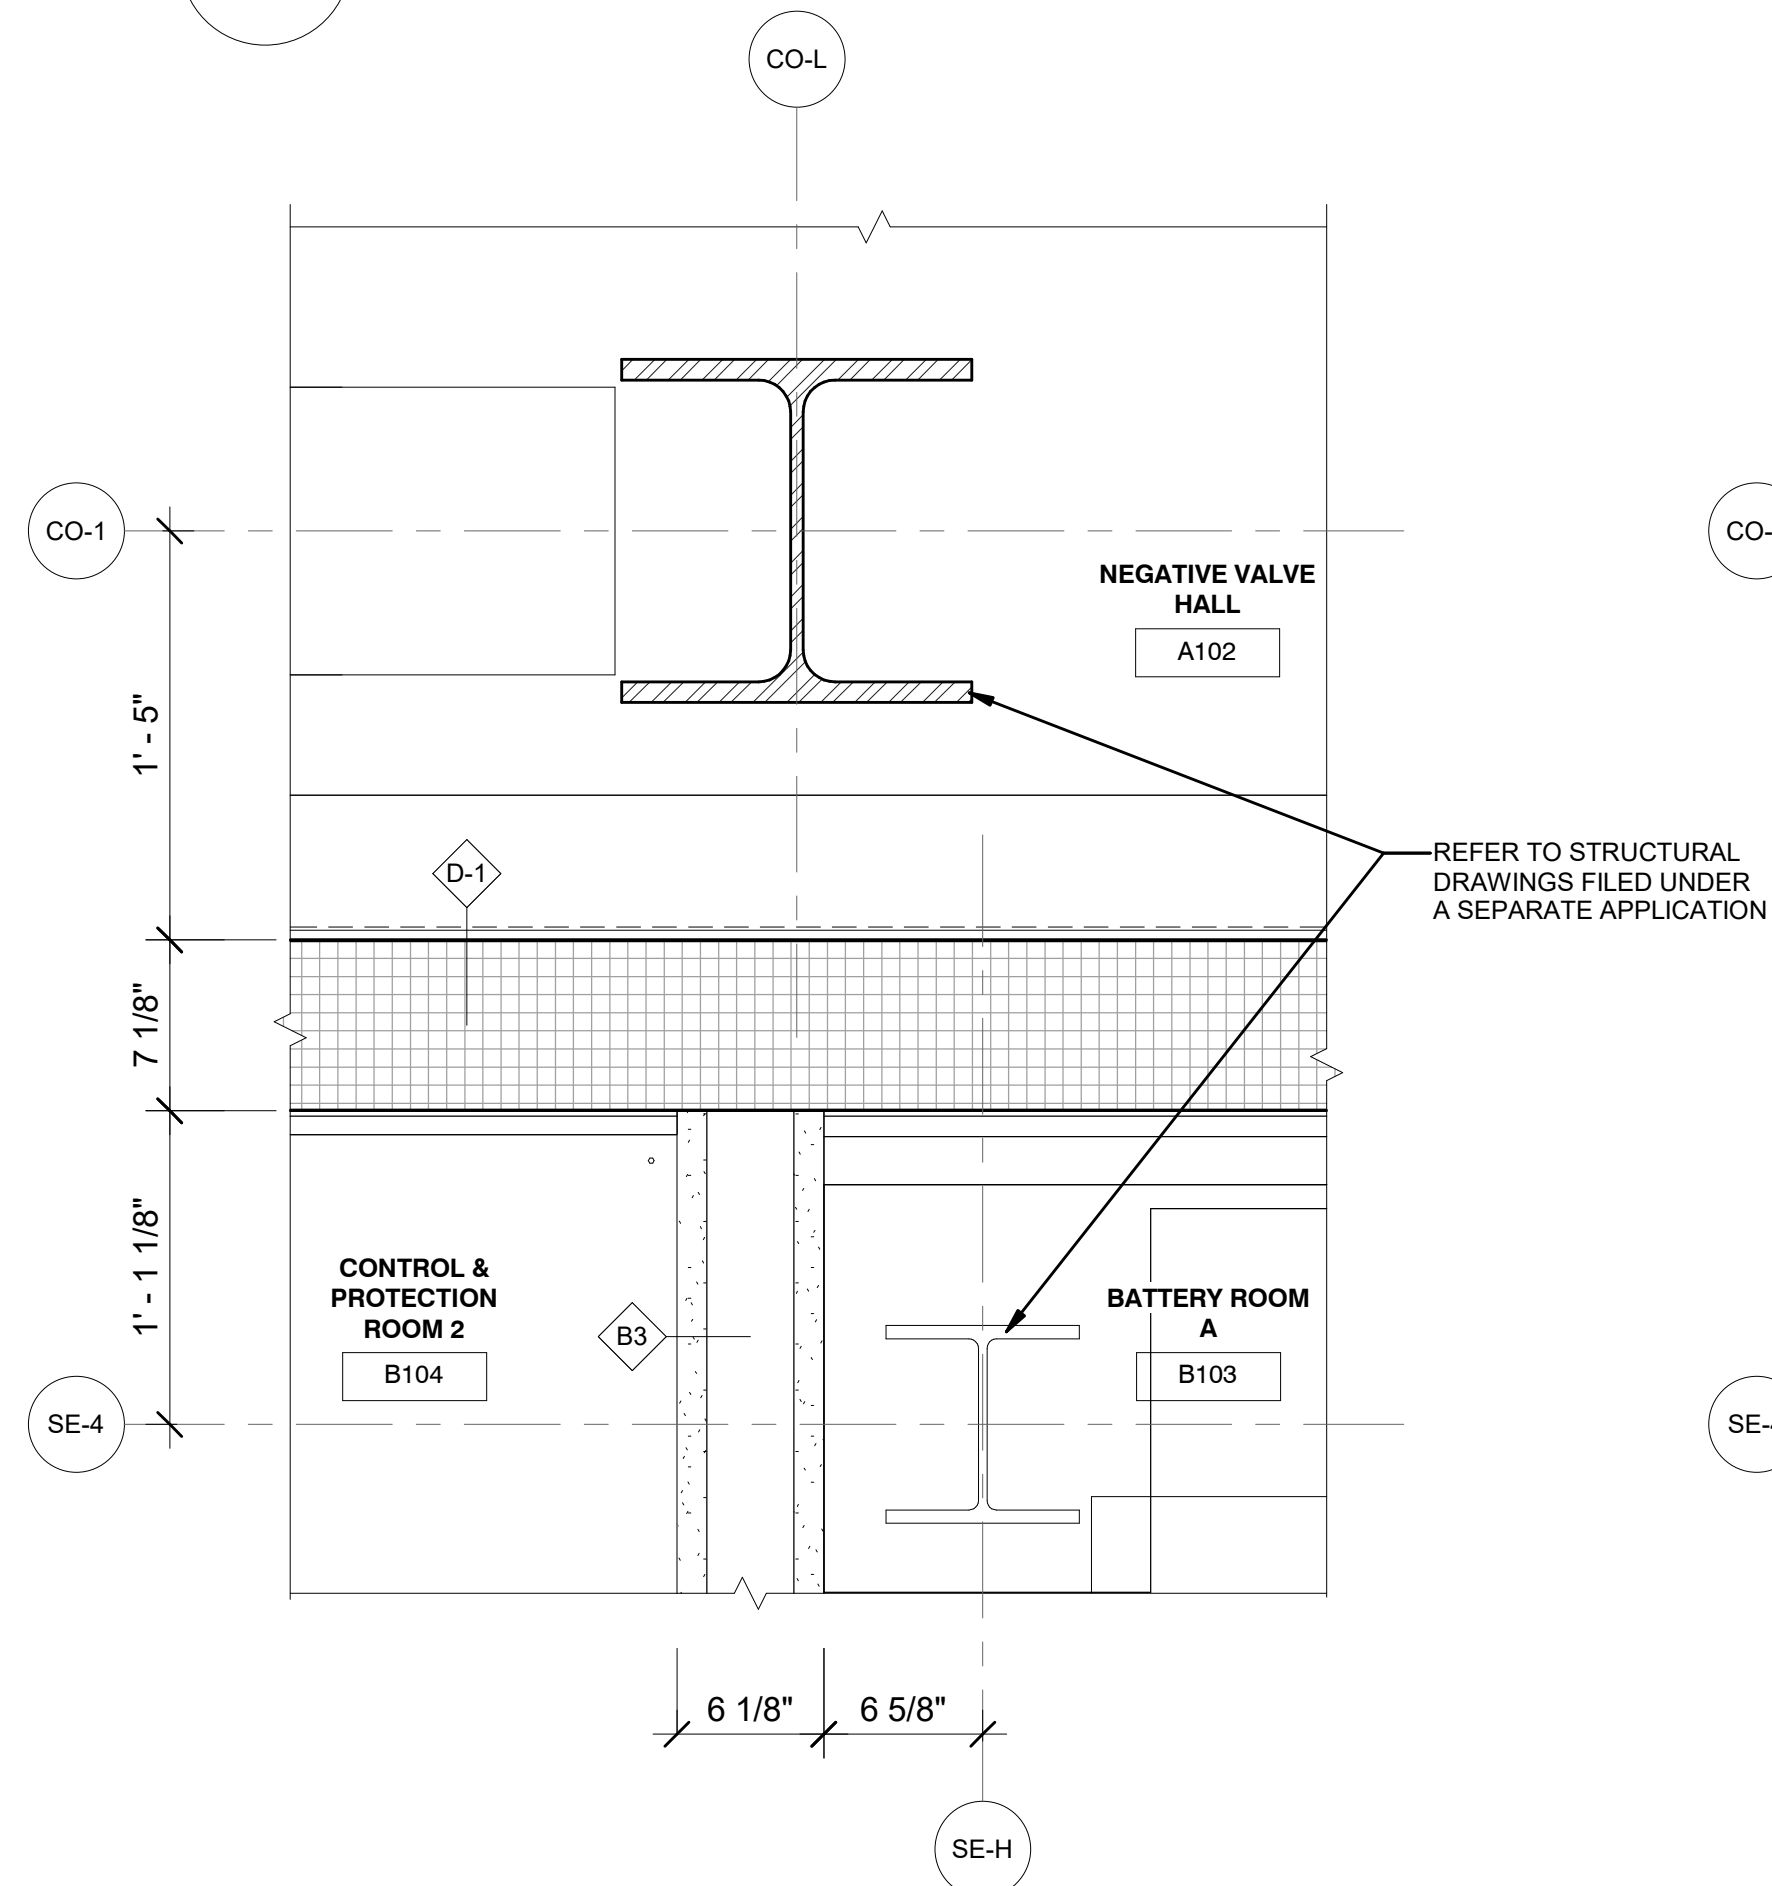

3 PLAN DETAIL - PART D - VALVE HALL 2 & BATTERY RM A
A-104.00 1 1/2" = 1'-0"

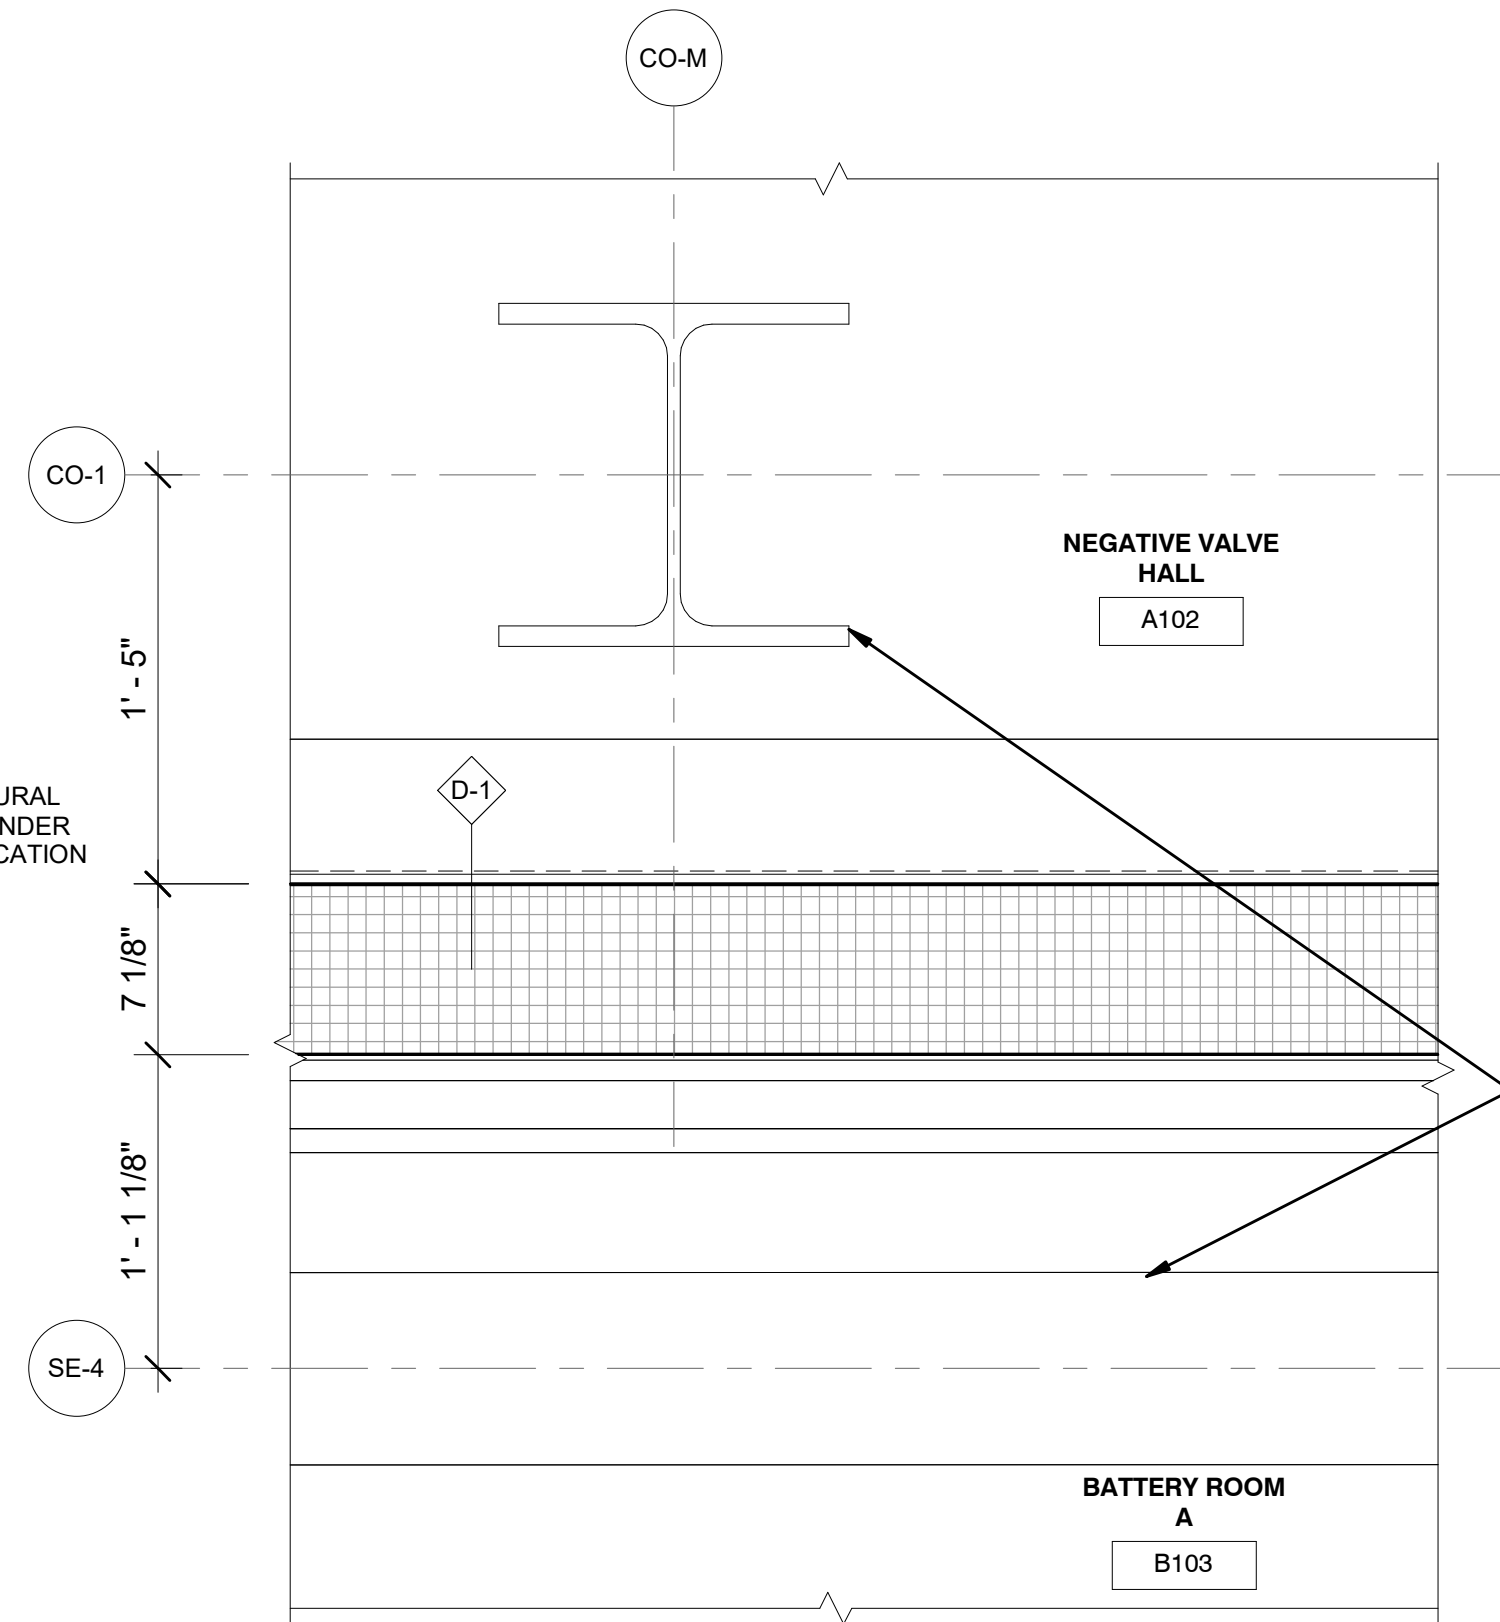


6 PLAN DETAIL - PART D - VALVE HALL 2 & BATTERY RM A - 2
A-104.00 1 1/2" = 1'-0"

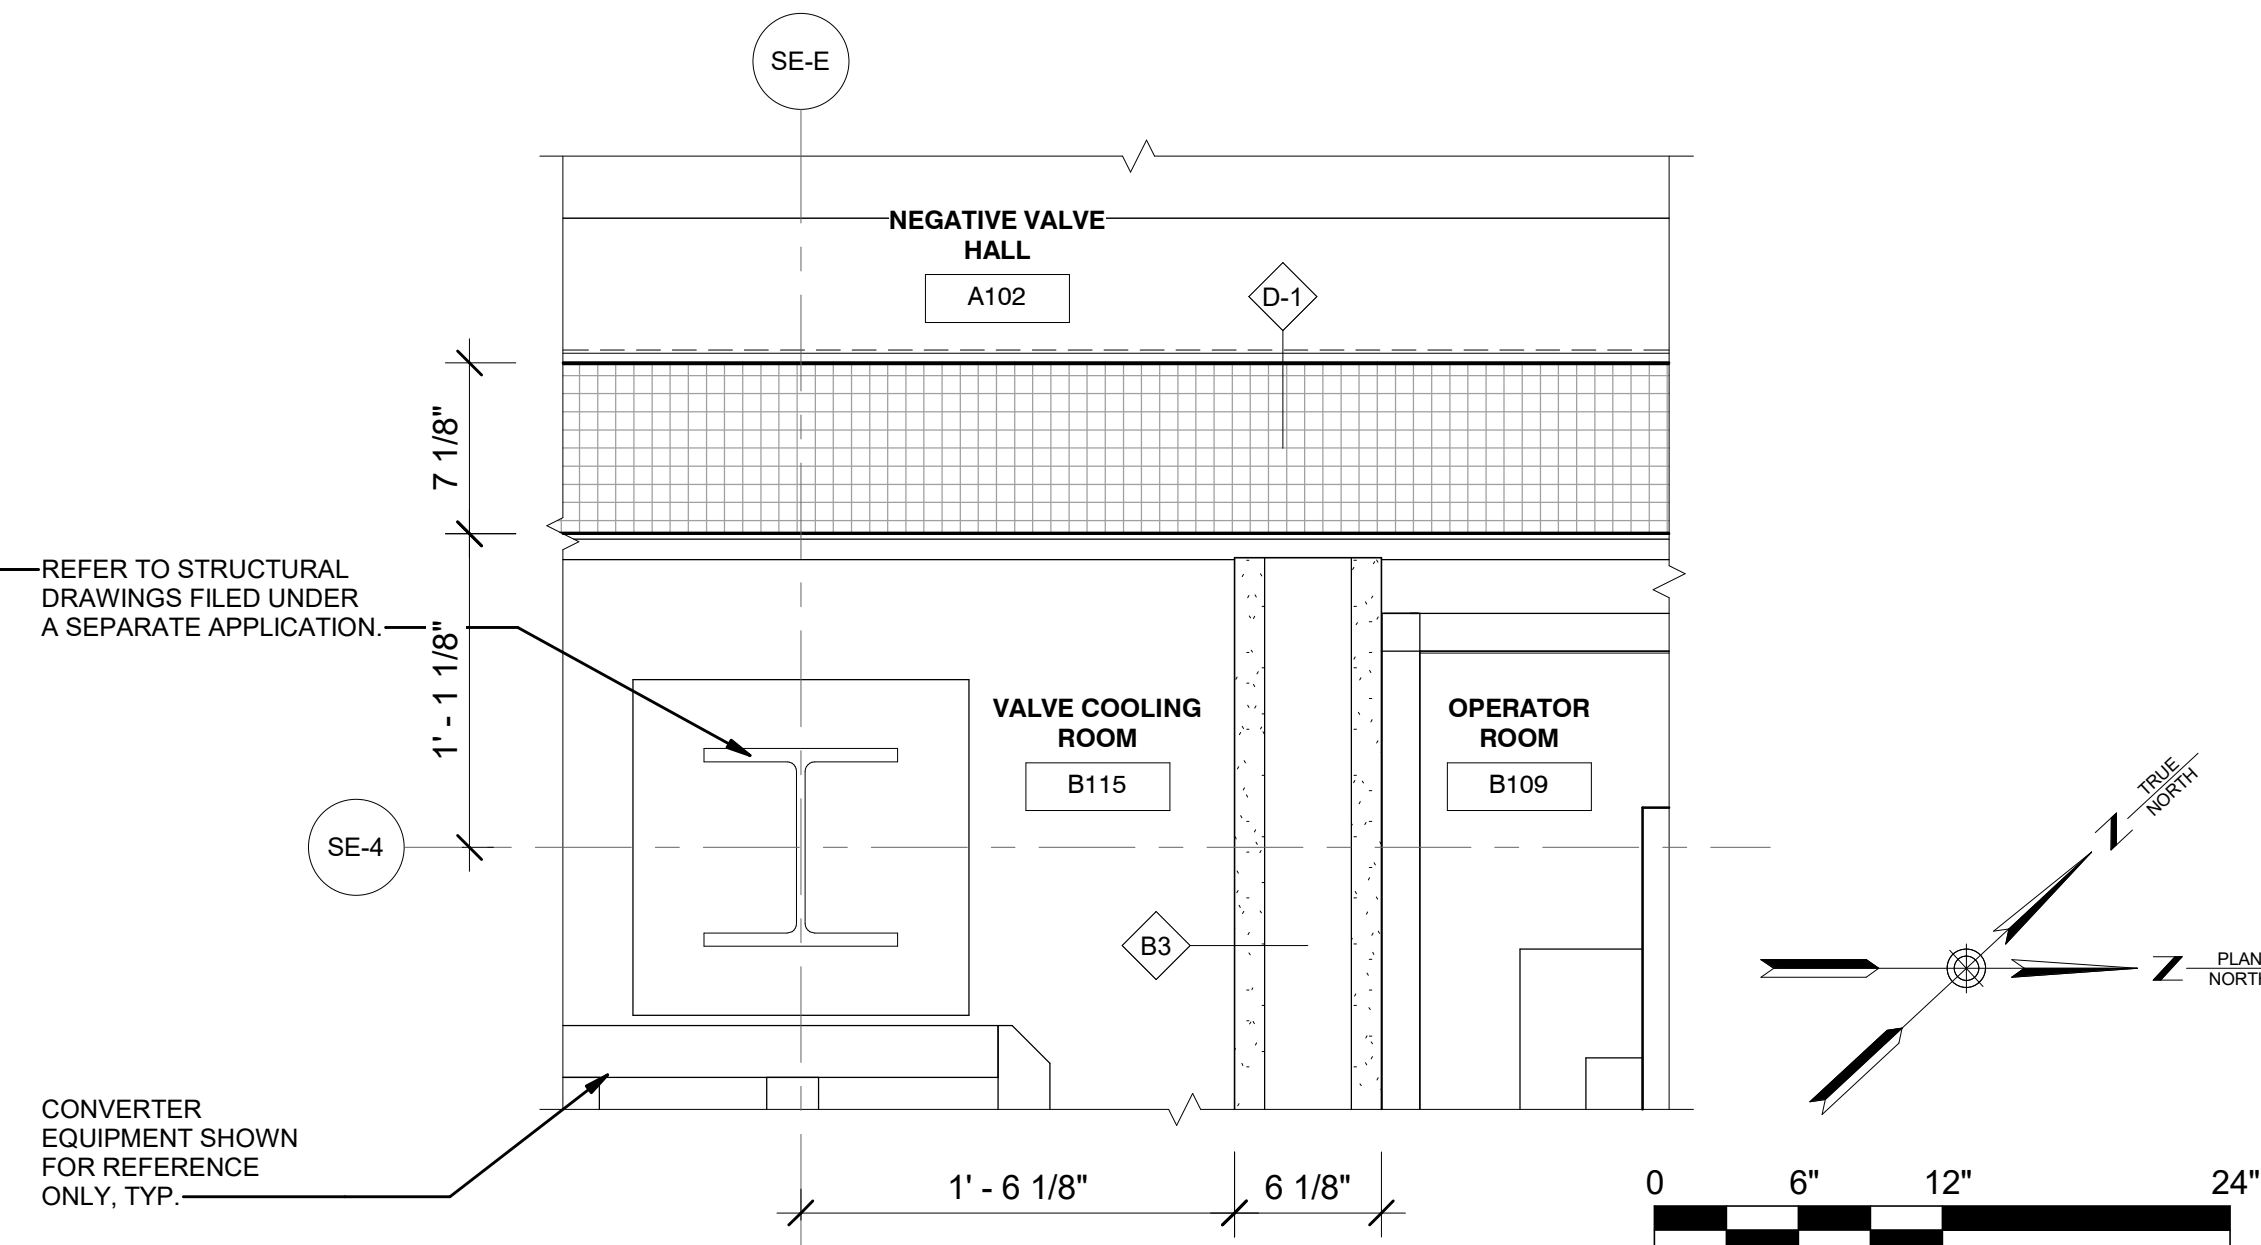

2 PLAN DETAIL - PART D - VALVE HALL 2 & OPERATOR RM
A-104.00 1 1/2" = 1'-0"

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| B | FINAL SUBMISSION | RAC | ZH | 12/12/2022 |
| A | INTERIM SUBMISSION | RAC | ZH | 09/13/2022 |

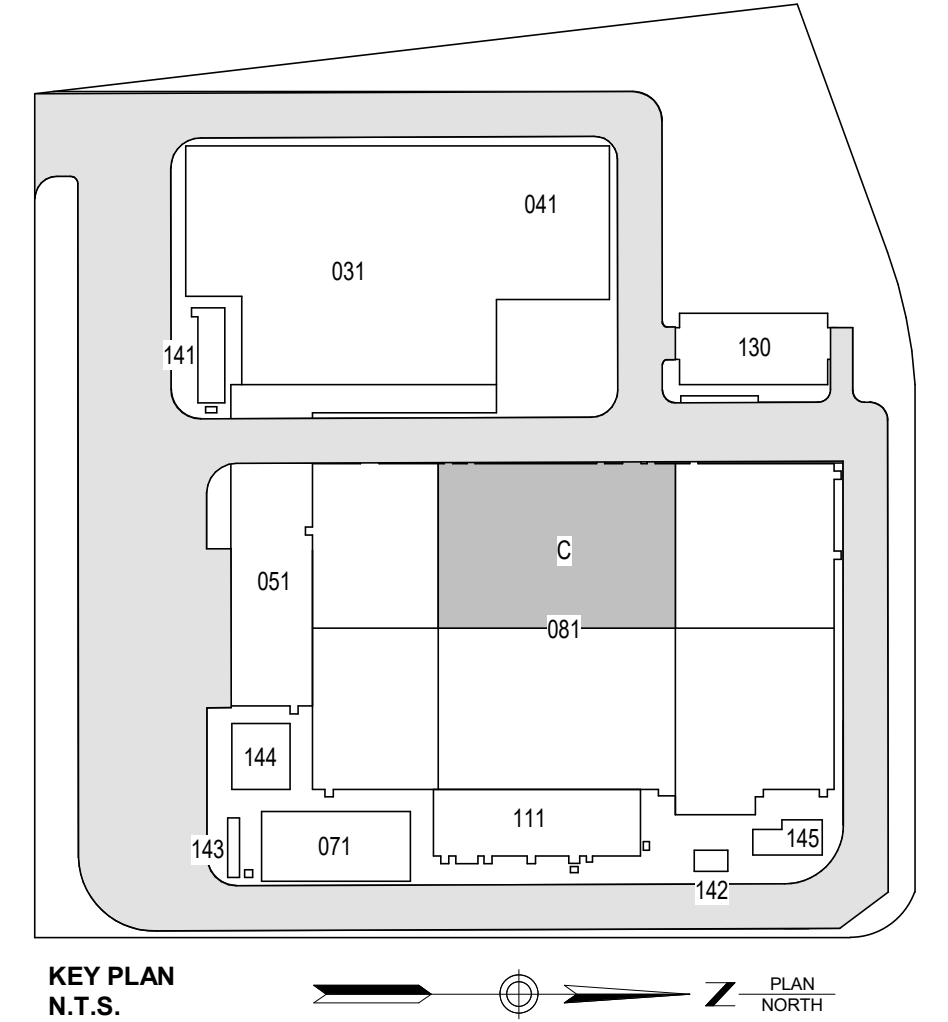Kiewit 470 Chestnut Ridge Rd # 2,
Woodcliff Lake, NJ 07677


Hitachi Energy 901 Main Campus Drive
Raleigh, North Carolina 27606

PROJECT
CHPE
Champlain Hudson
Power Express
**Astoria HVDC
Converter Station**
31-45 20th Avenue, Astoria, Queens NY 11105
Block #850 - Lot #310 - BIN #4624437


PLAN DETAILS 4

REGISTERED ARCHITECT
SUZANNE SOWINSKI
STATE OF NEW YORK
026048


DATE 12/12/22
PROJECT NO 105121
DRAWING BY R. COLES
CHECKED BY Z. HARR
DRAWING NO
A-607.00
CADD FILE NO
Astoria/CHA-KE-111-ZZ-M3-A-001.rvt

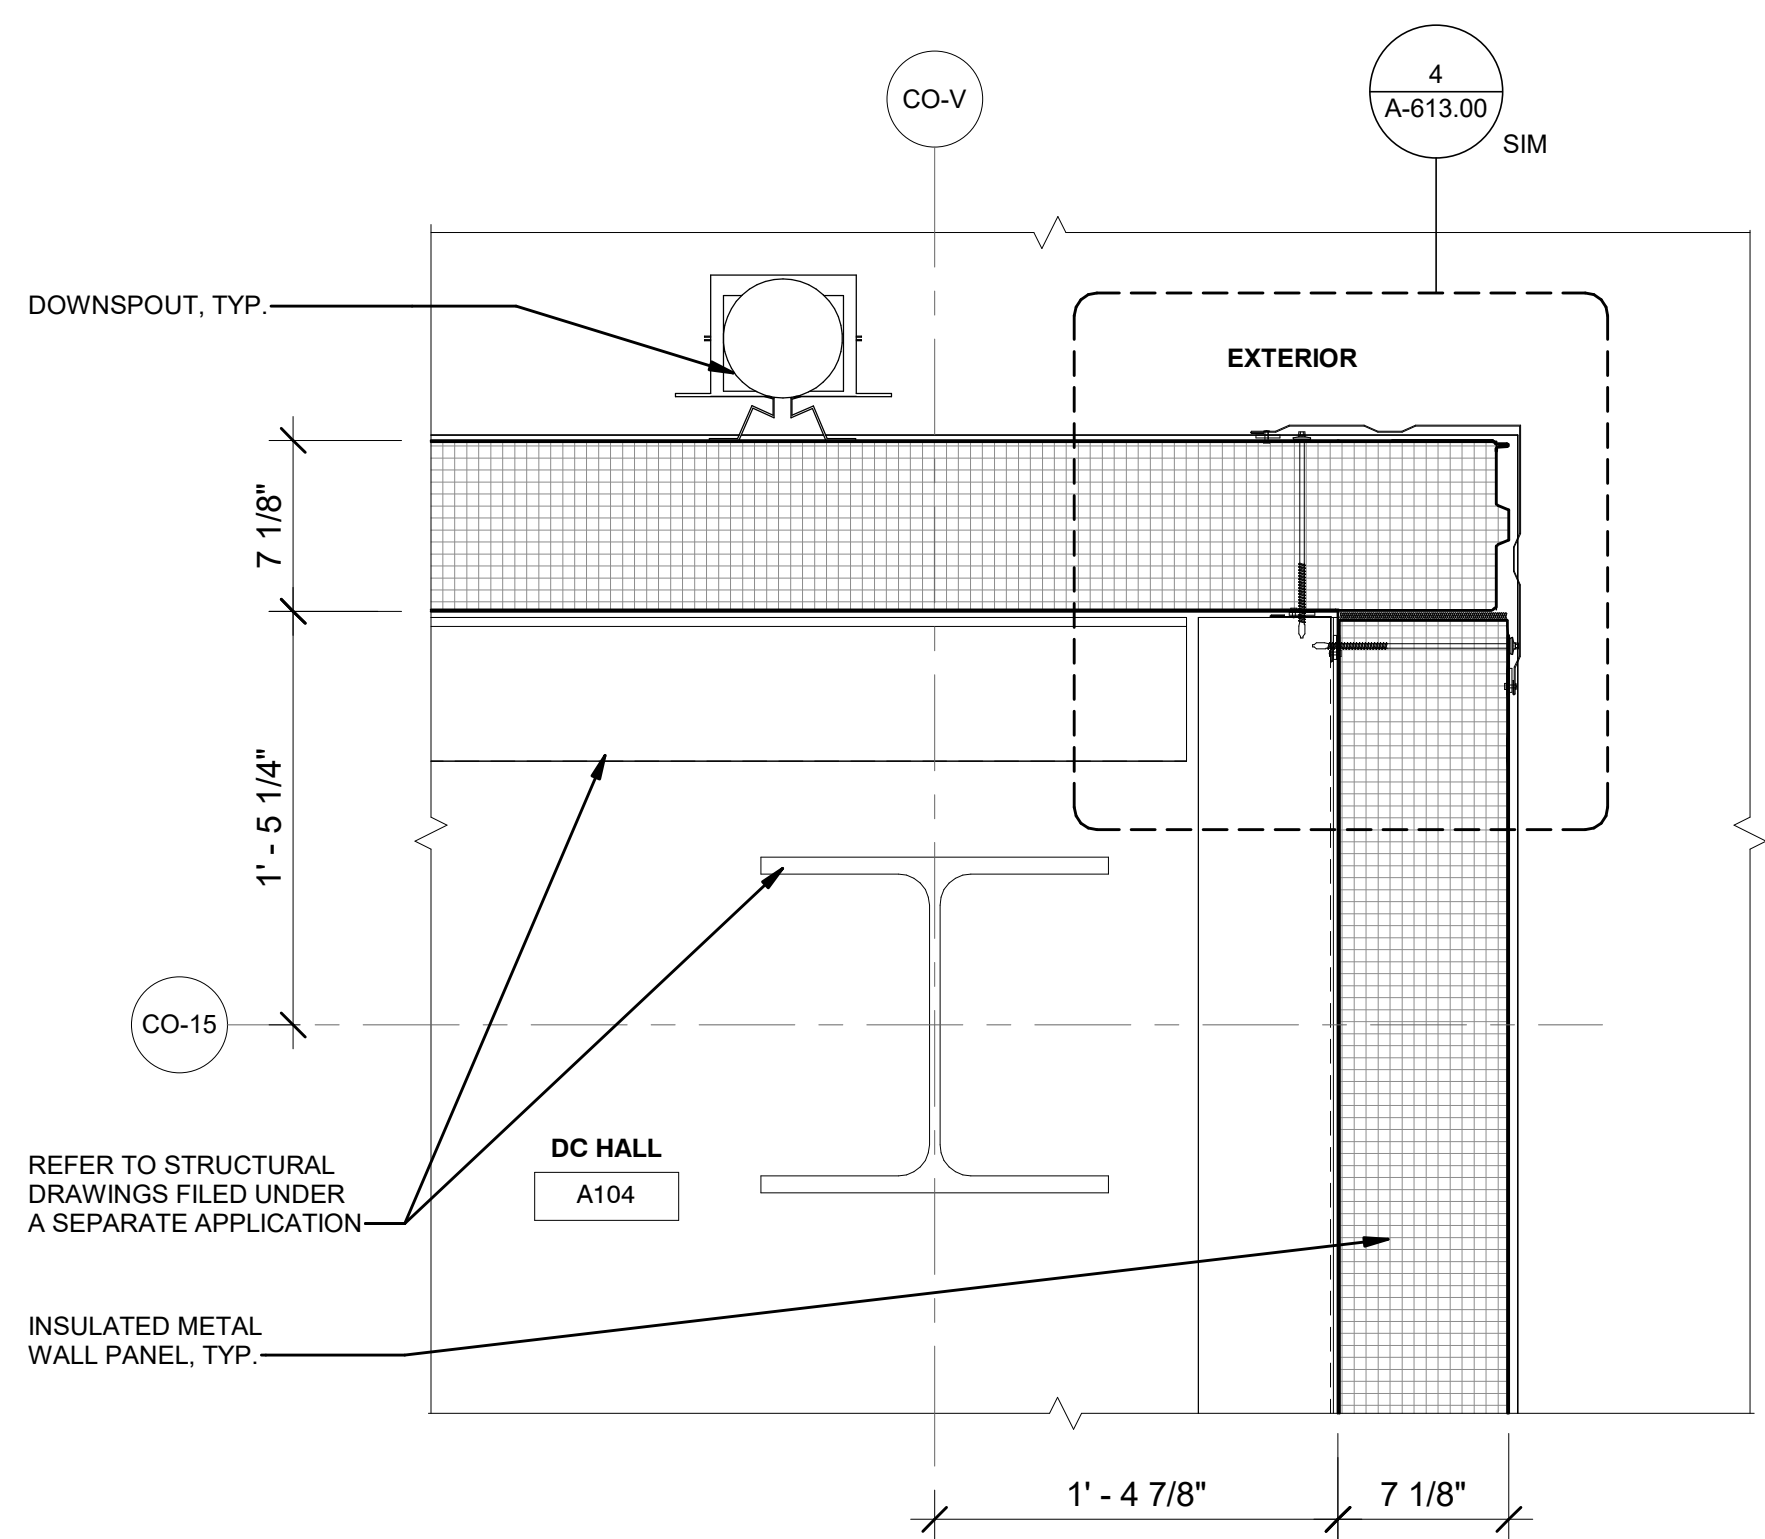


3 PLAN DETAIL - PART E - DC HALL CORNER
A-105.00 1 1/2" = 1'-0"

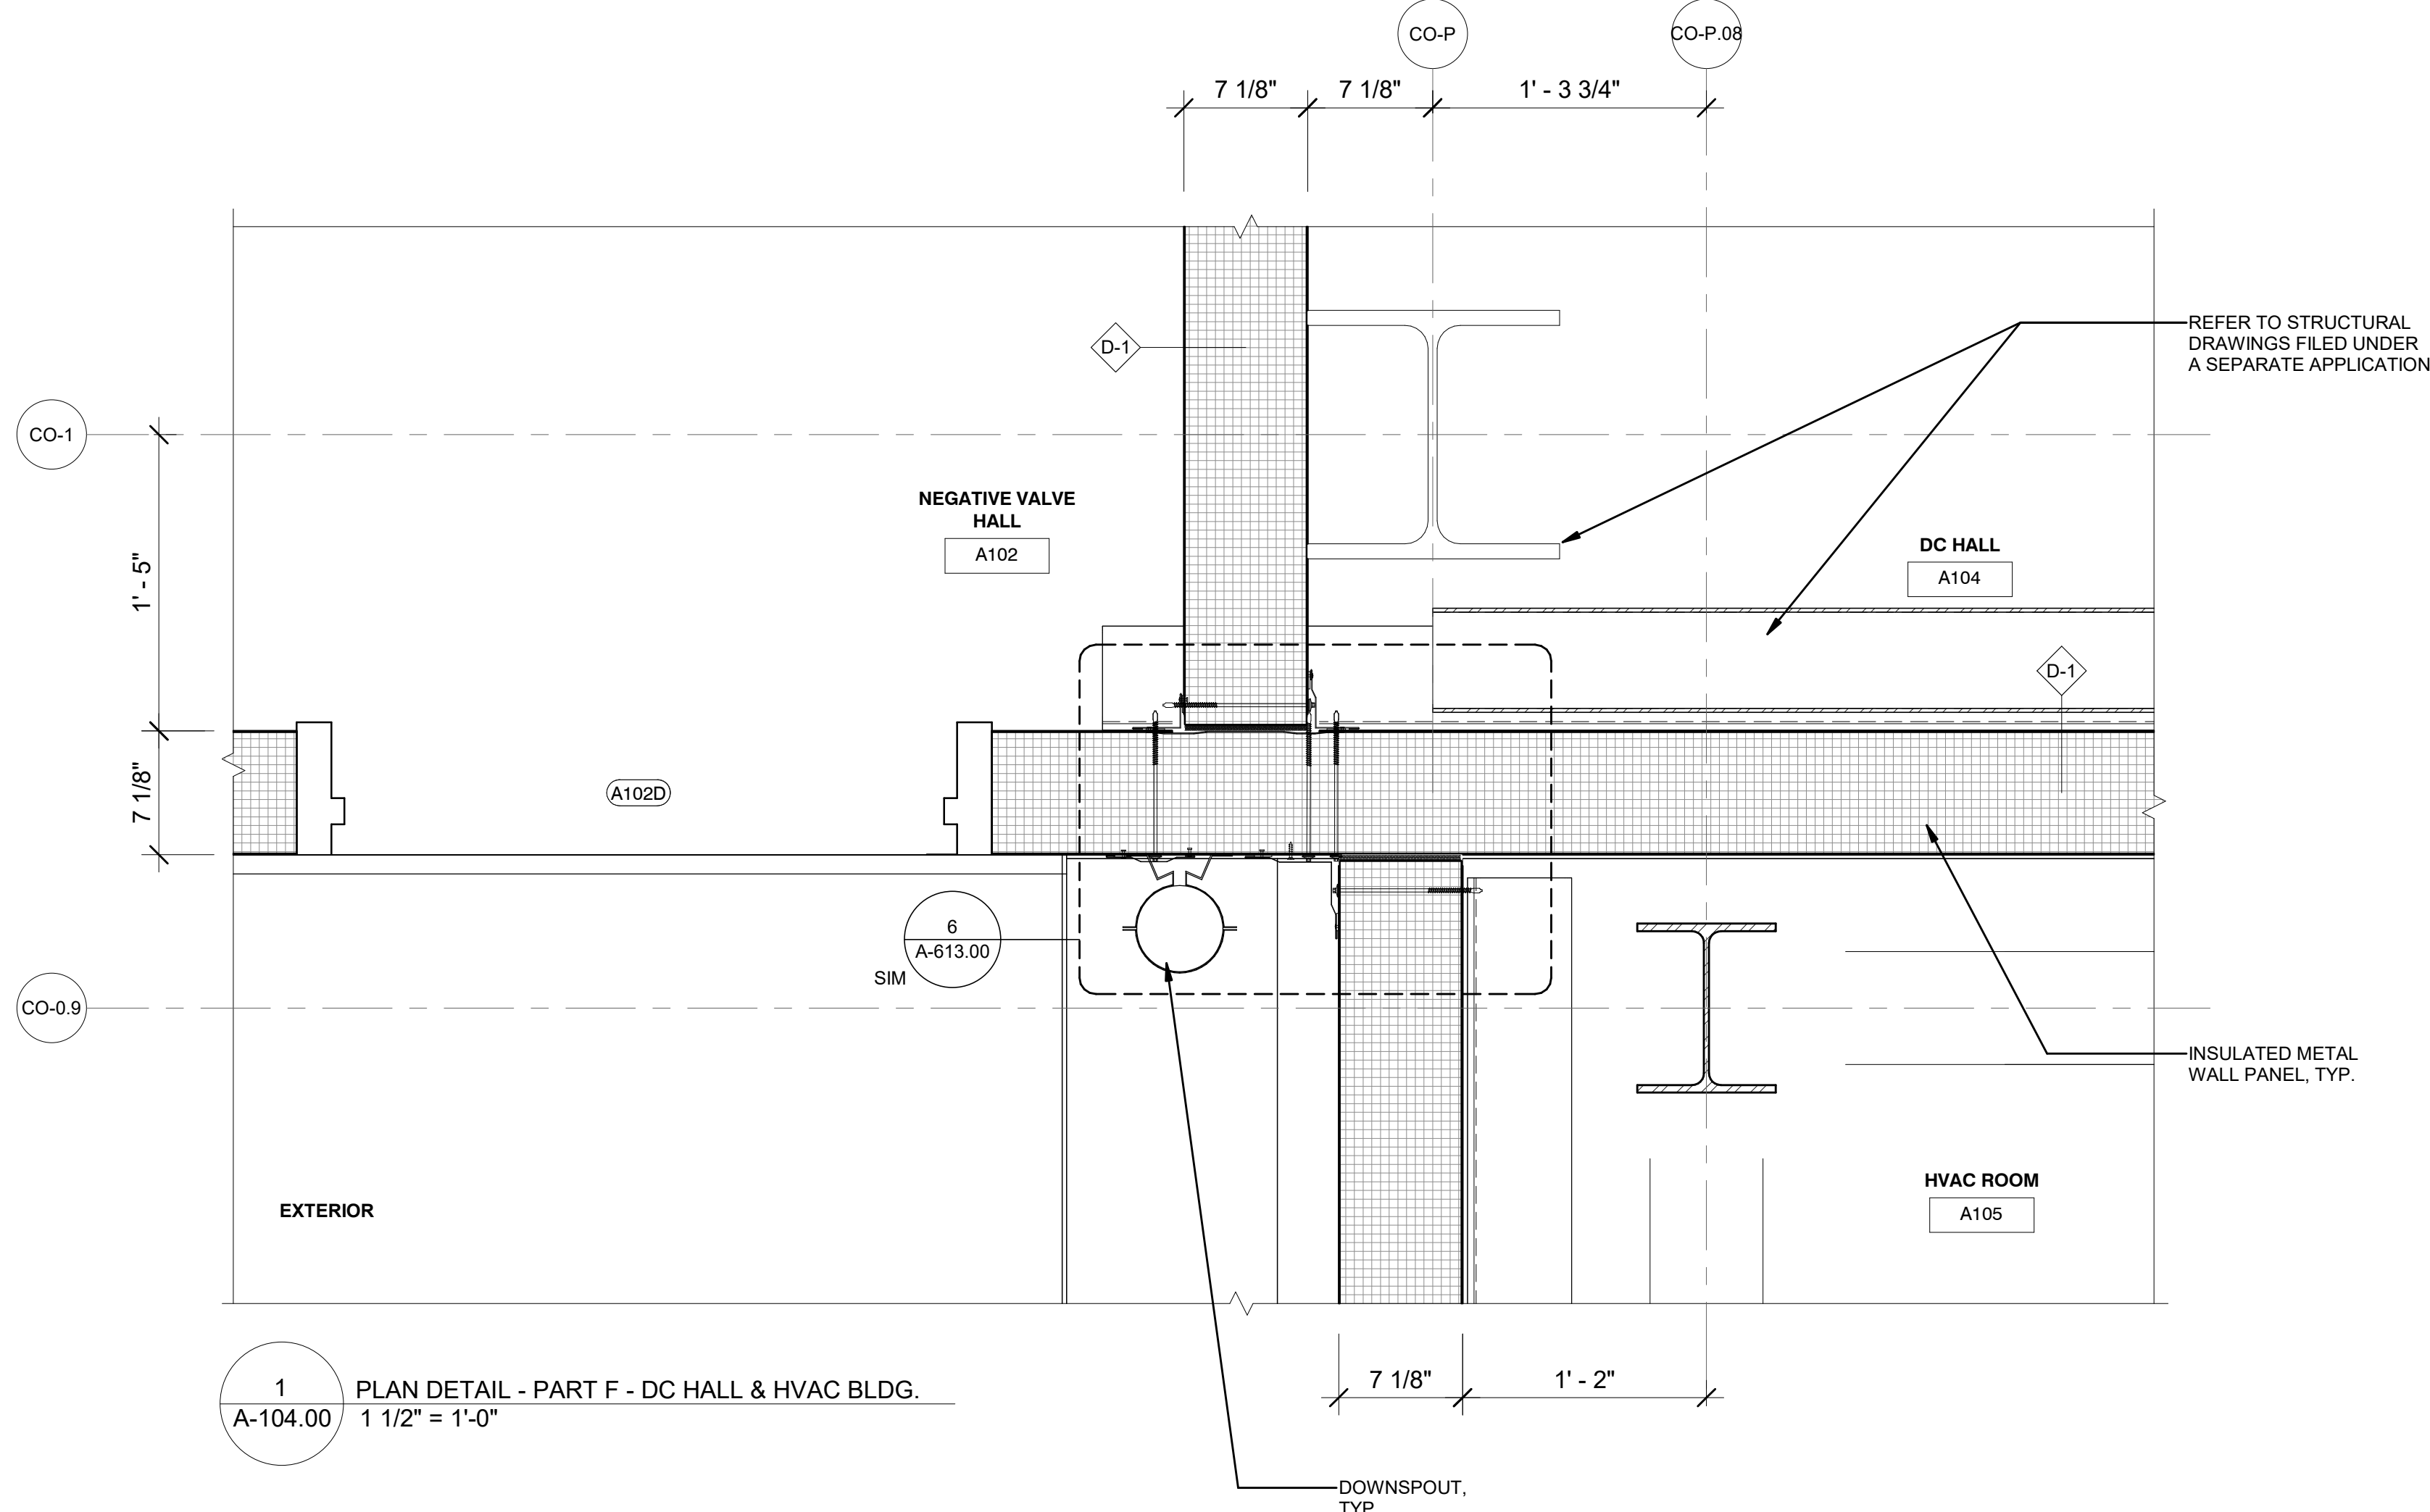


1 PLAN DETAIL - PART F - DC HALL & HVAC BLDG.
A-104.00 1 1/2" = 1'-0"

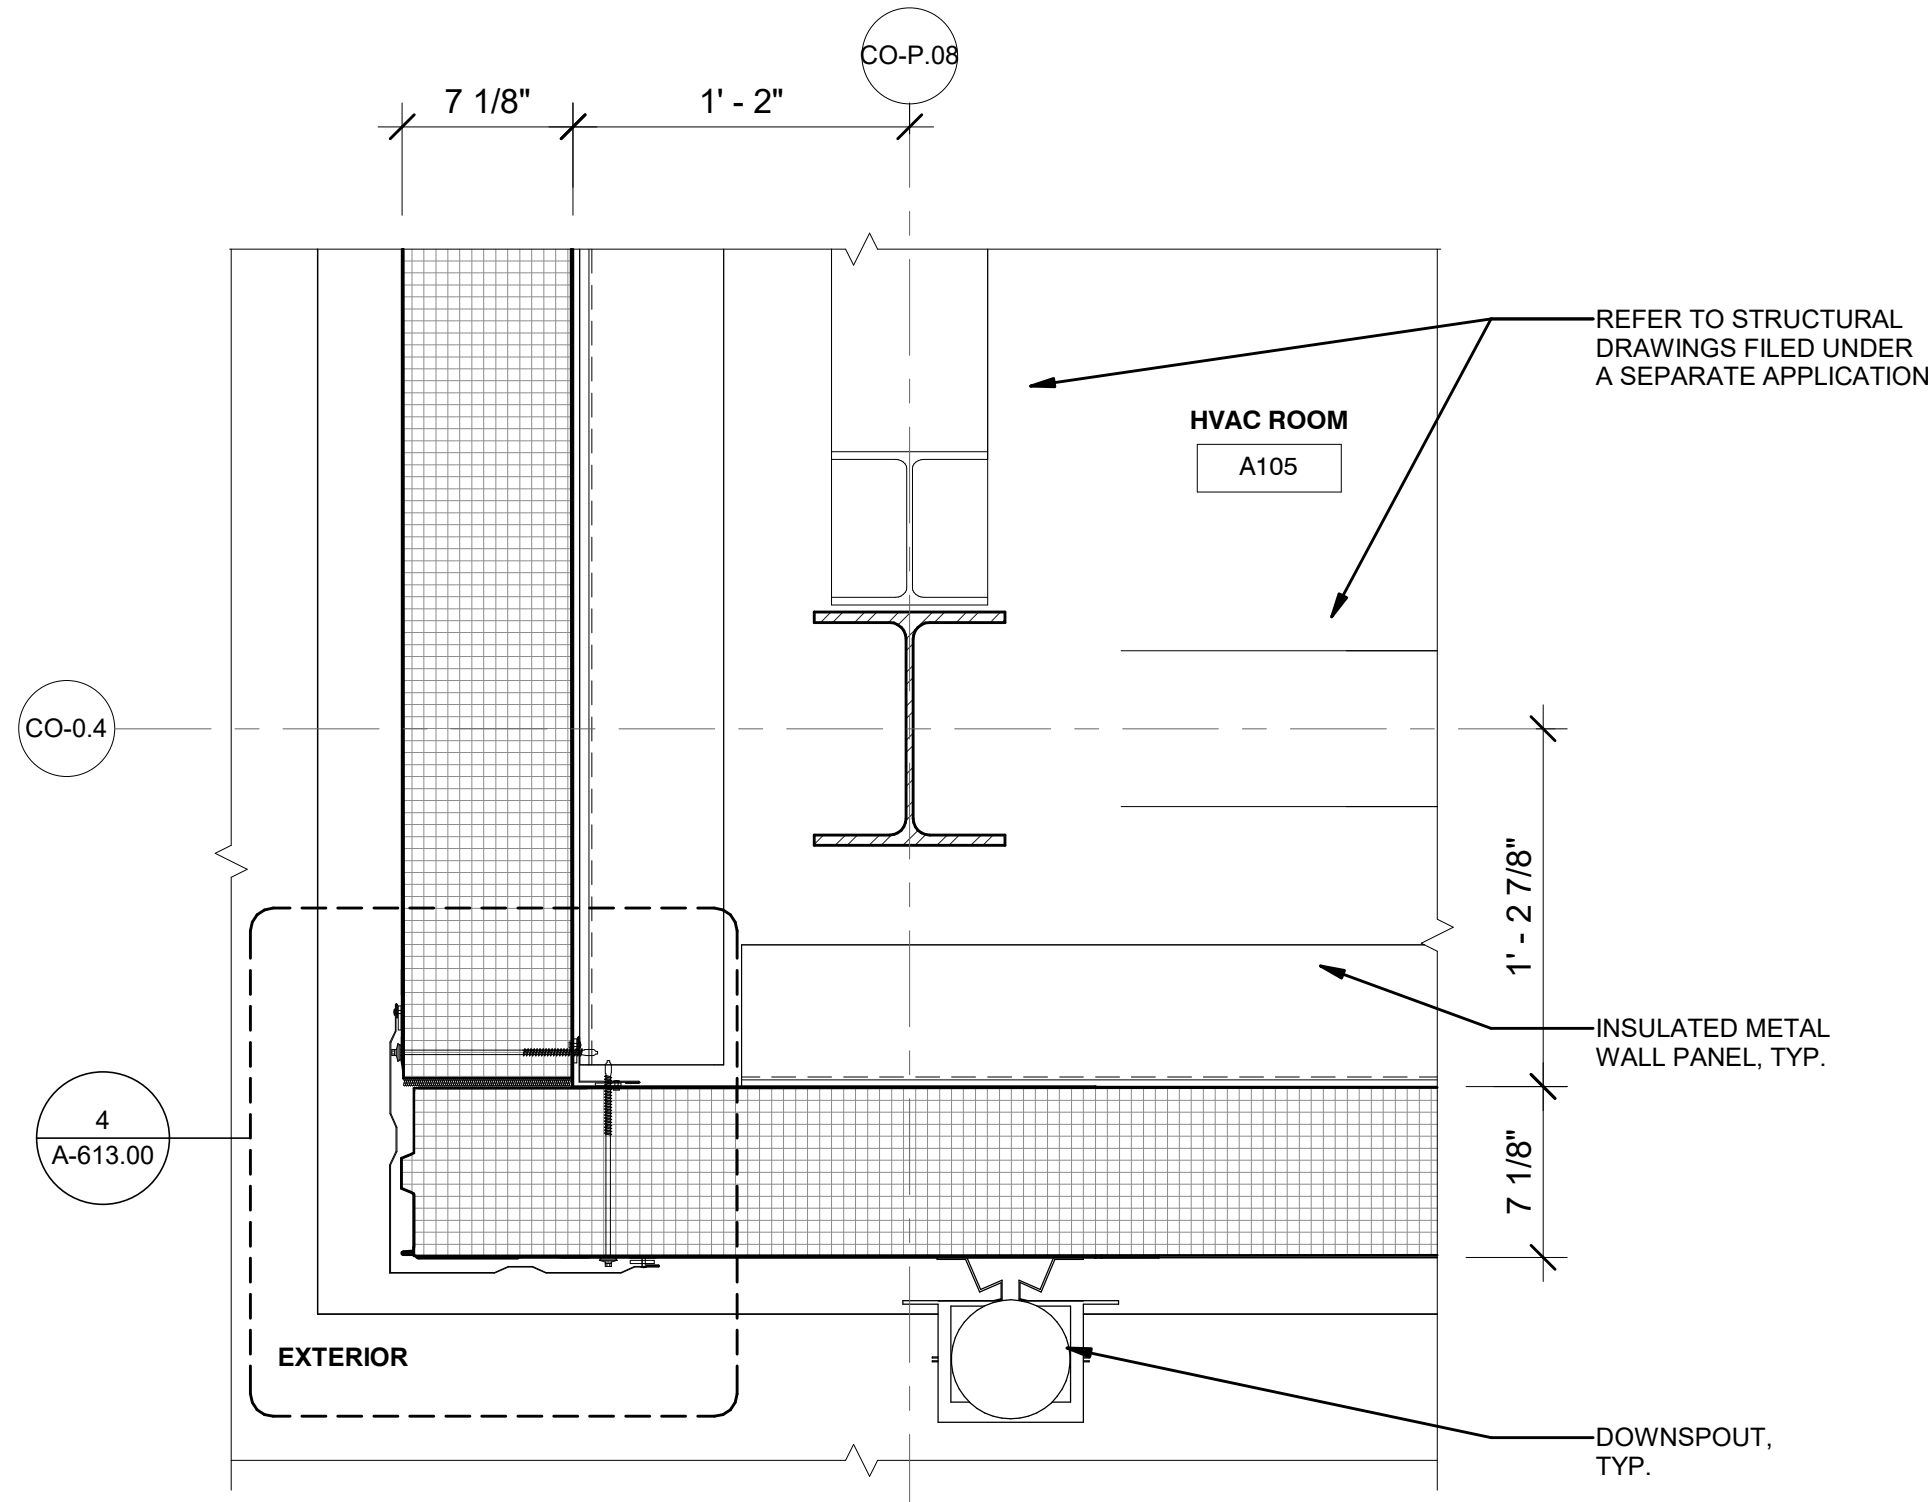


2 PLAN DETAIL - PART F - HVAC ENCLOSURE CORNER
A-106.00 1 1/2" = 1'-0"

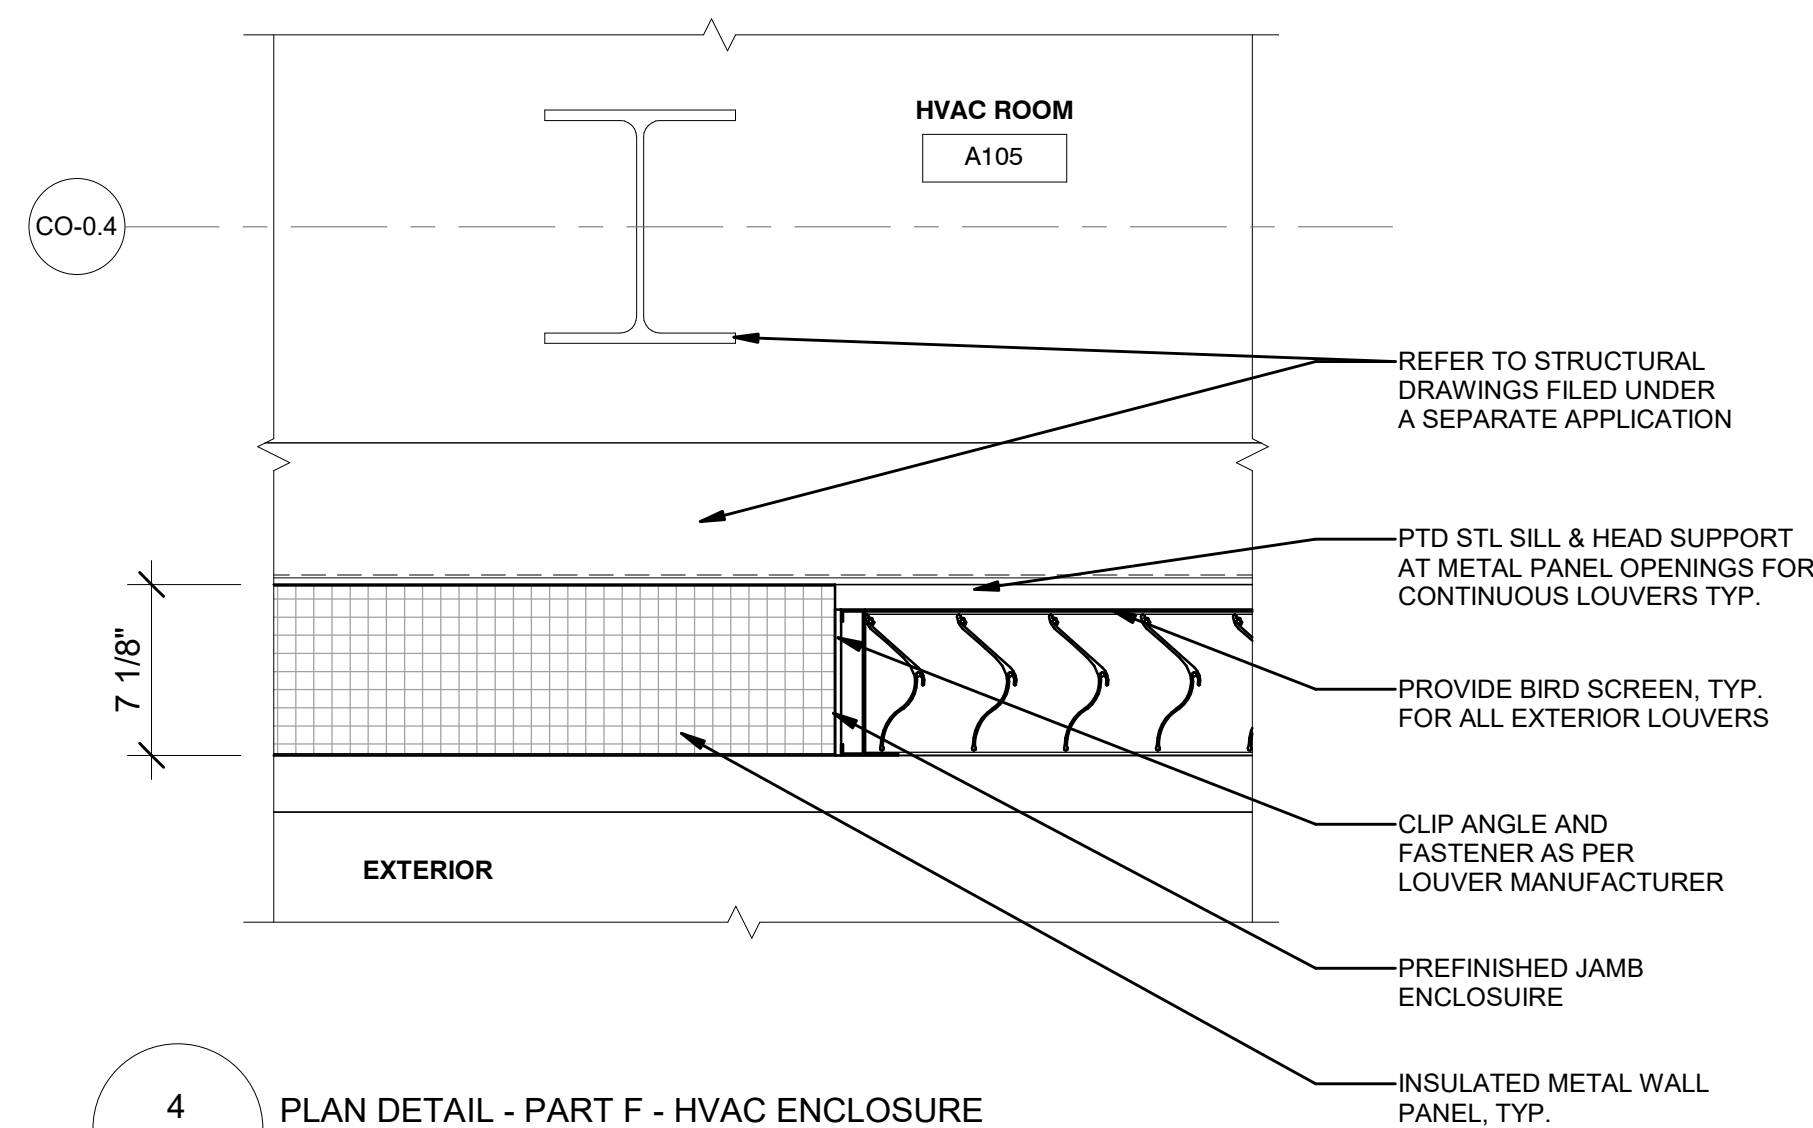

4 PLAN DETAIL - PART F - HVAC ENCLOSURE
A-106.00 1 1/2" = 1'-0"

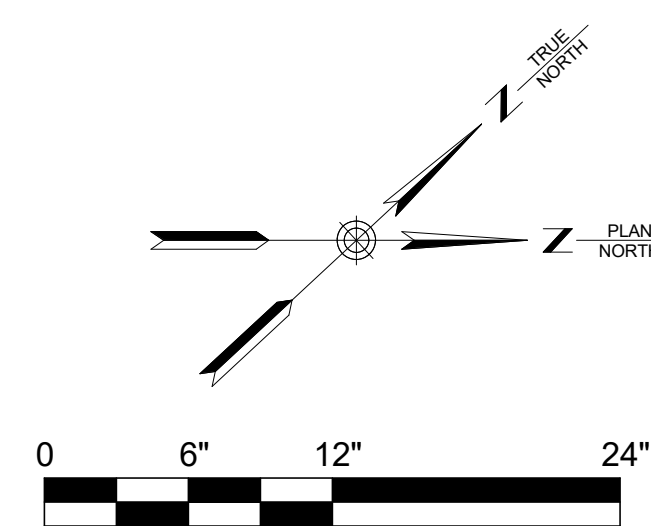

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| 0 | FINAL SUBMISSION | RAC | ZH | 12/12/2022 |

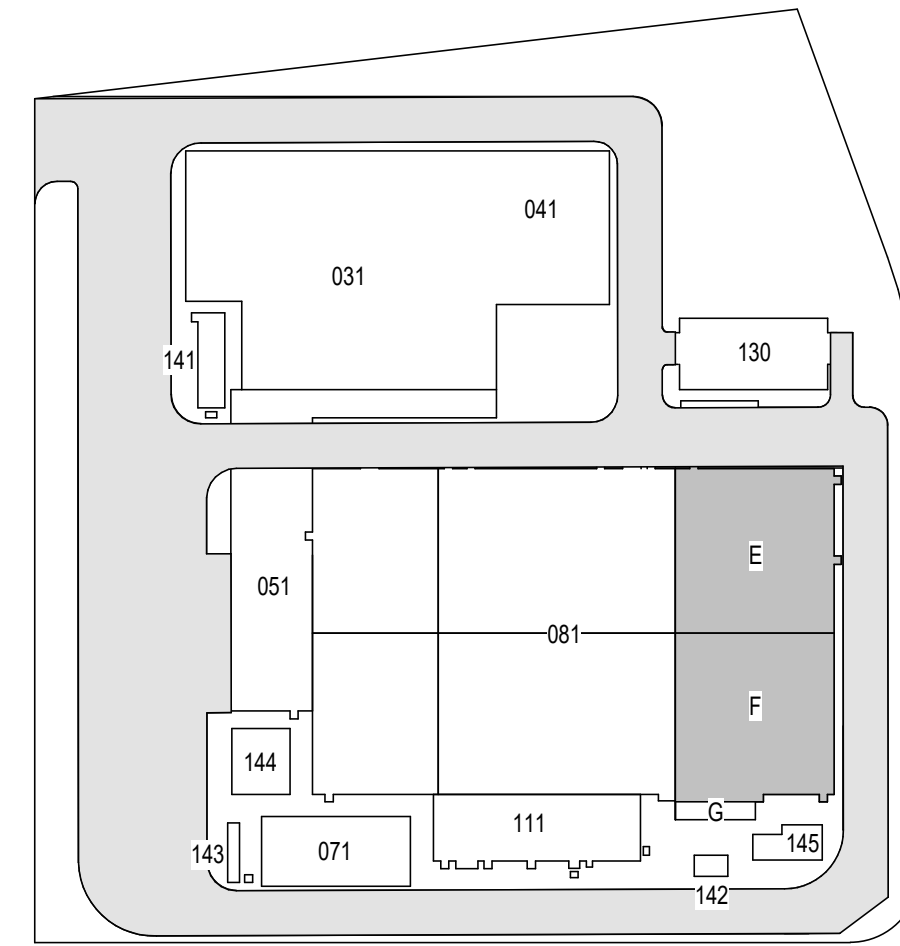Kiewit

470 Chestnut Ridge Rd # 2,
Woodcliff Lake, NJ 07677

Hitachi Energy

901 Main Campus Drive
Raleigh, North Carolina 27606

PROJECT

CHPE
Champlain Hudson
Power Express


Astoria HVDC
Converter Station

31-45 20th Avenue, Astoria, Queens NY 11105
Block #850 - Lot #310 - BIN #4624437


PLAN DETAILS 5




DATE 12/12/22
PROJECT NO 105121
DRAWING BY R. COLES
CHECKED BY Z. HARR
DRAWING NO
A-608.00
CADD FILE NO
Astoria-HVDC-CHPE
Astoria-CHPE-111-ZZ-M3-A-001.rvt

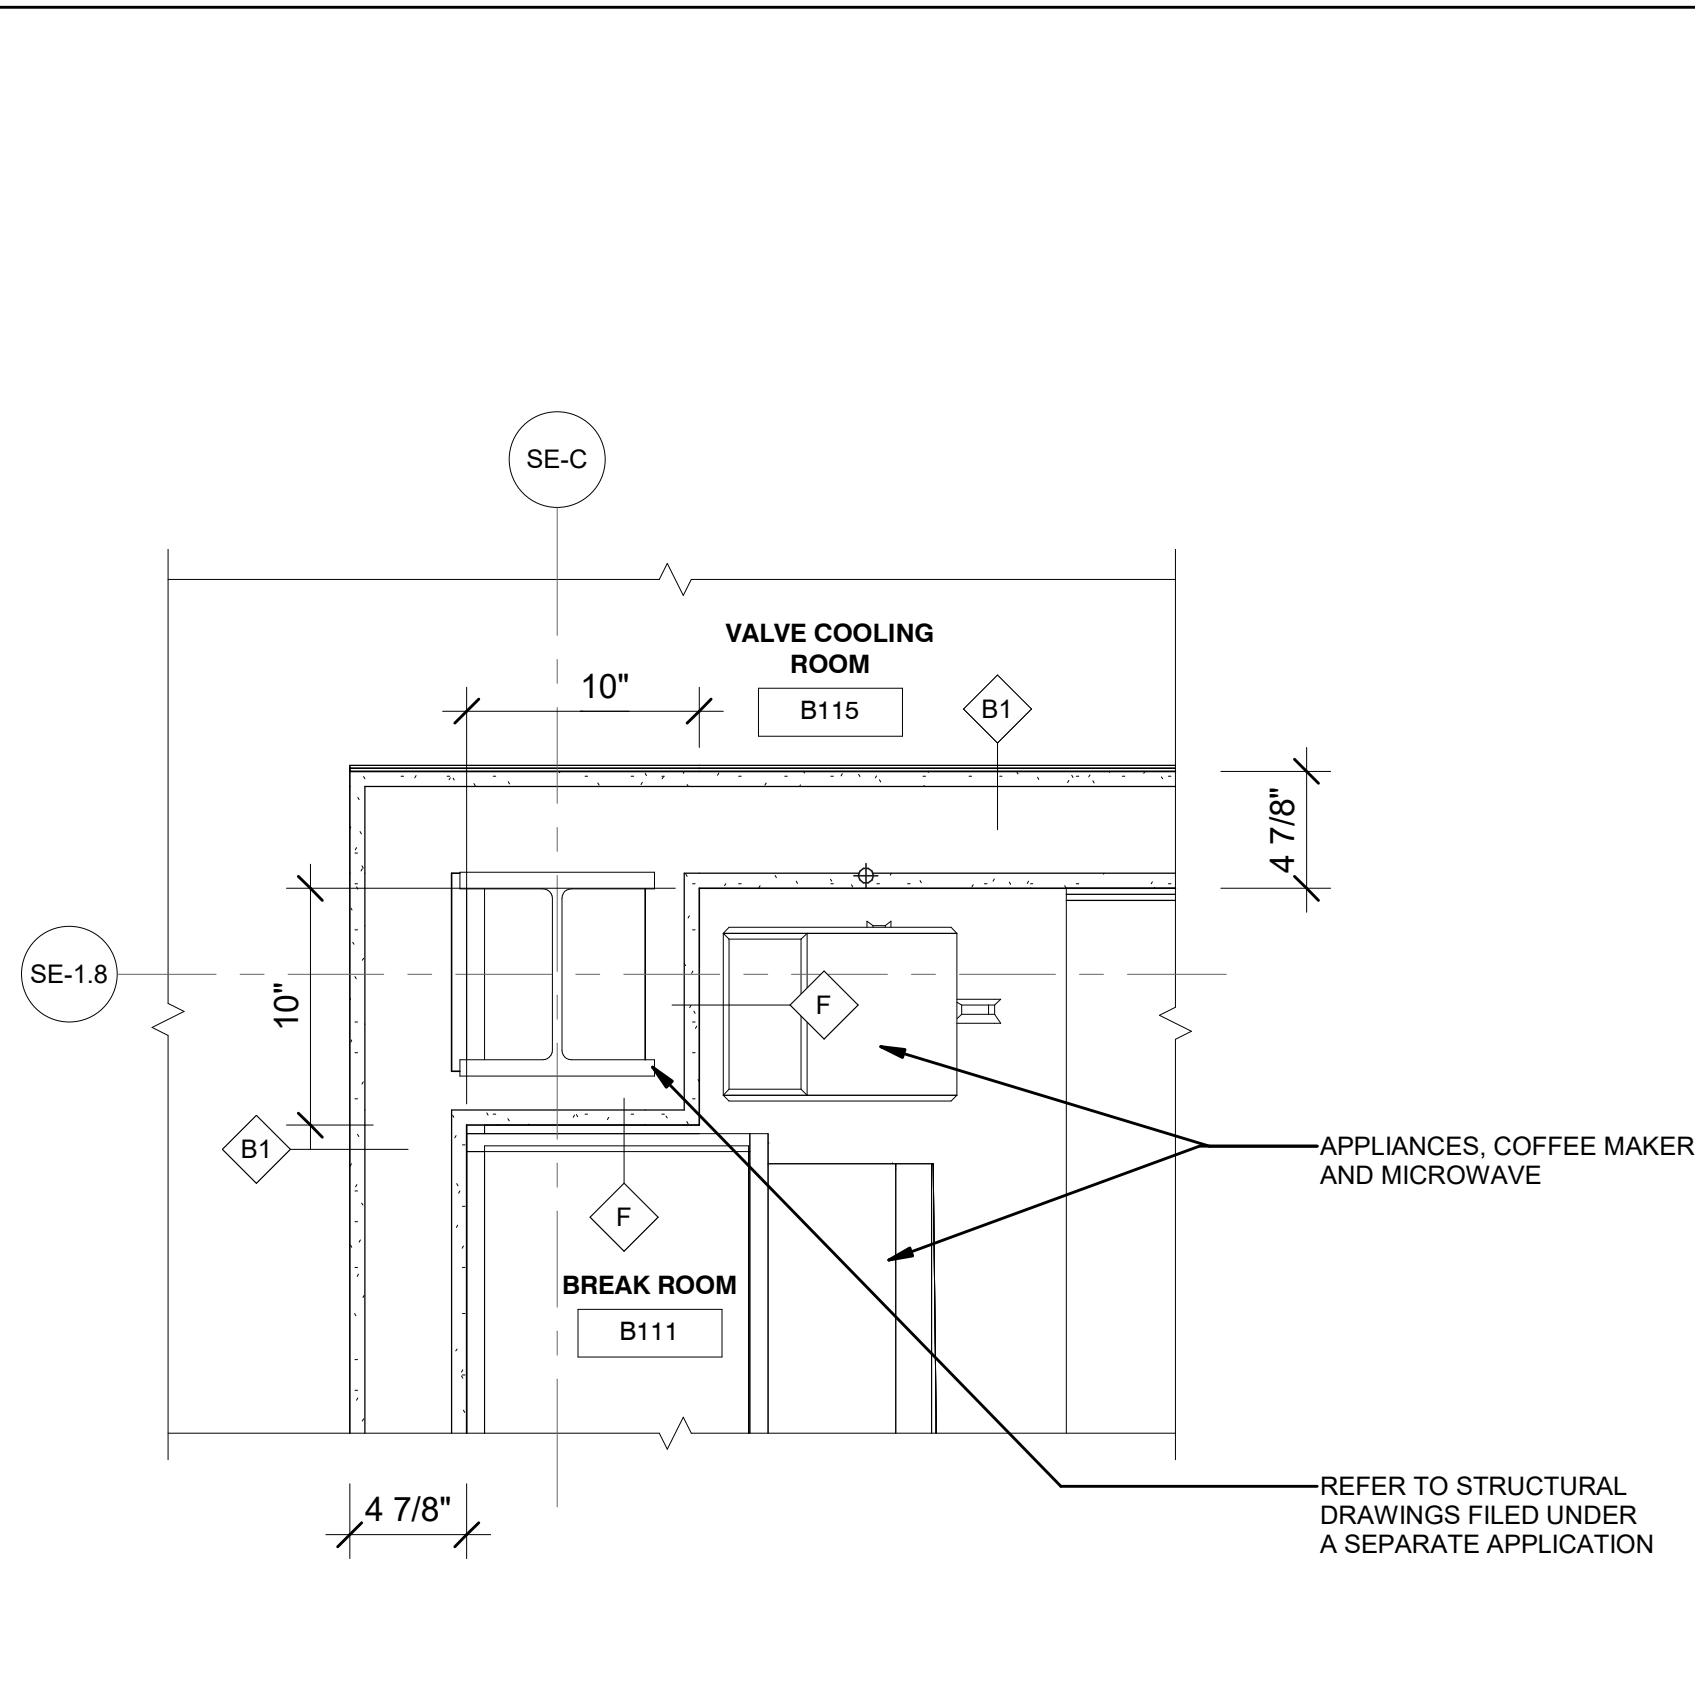


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A-403.00 1 1/2" = 1'-0"

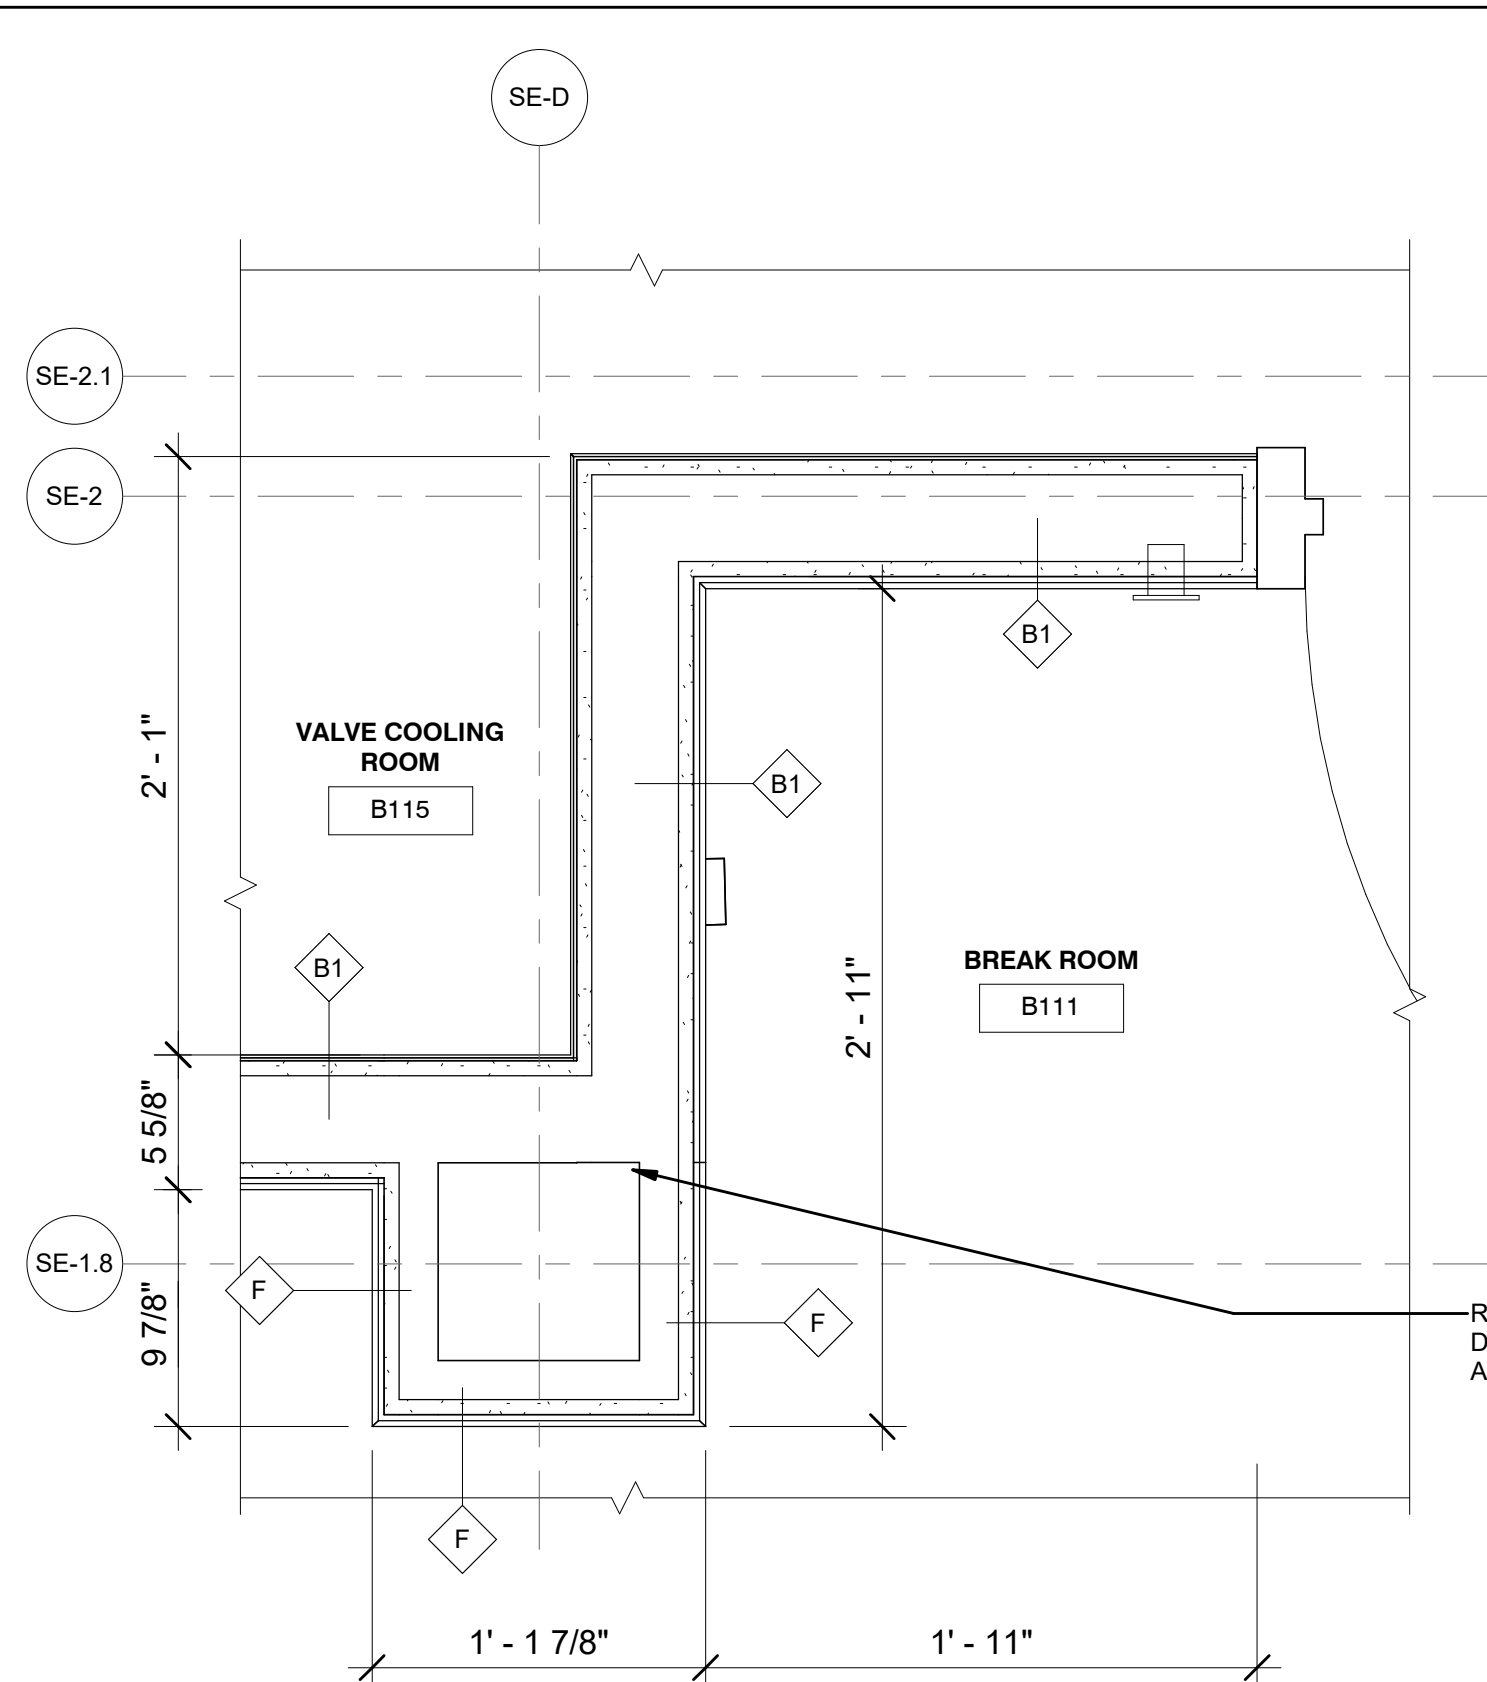


2 PLAN DETAIL 2 - SERVICE BLDG. FIRST FLOOR
A-403.00 1 1/2" = 1'-0"

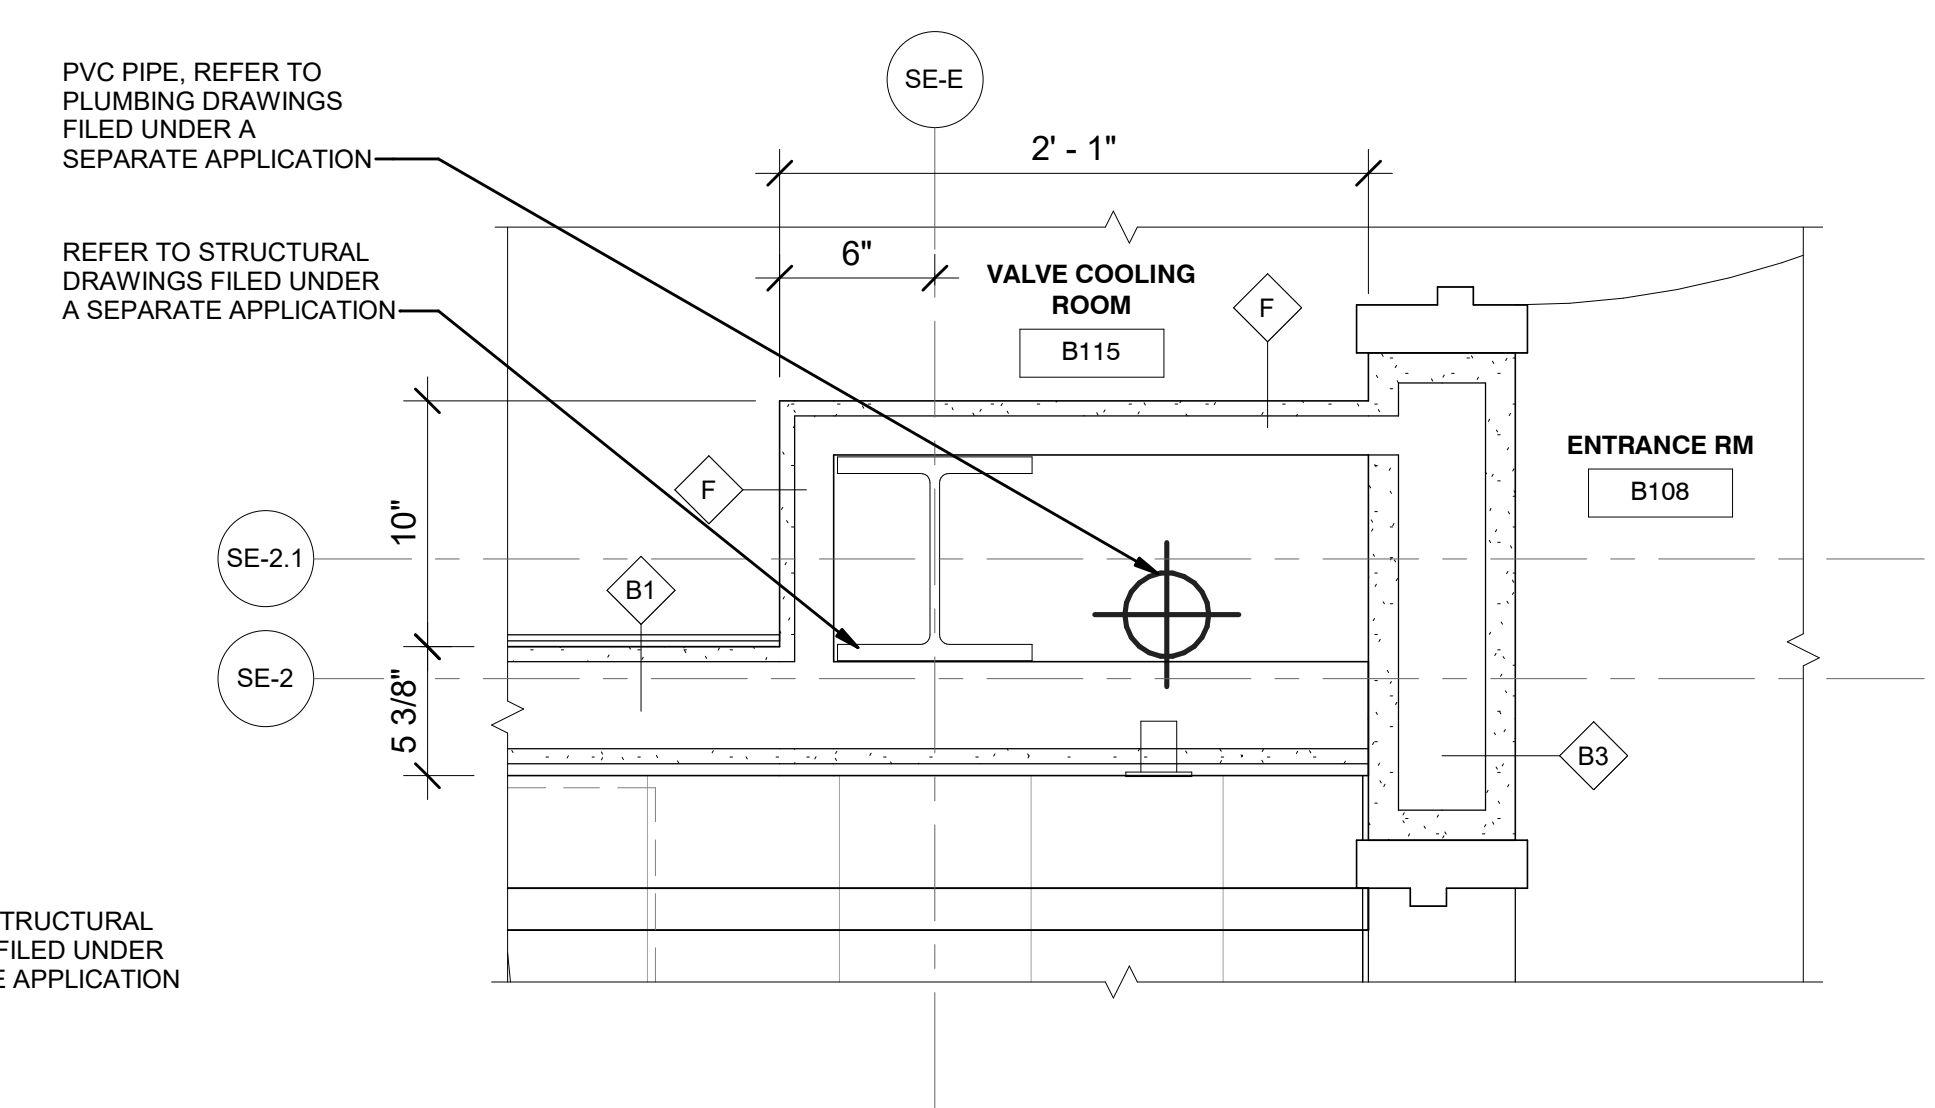


3 PLAN DETAIL 3 - SERVICE BLDG. FIRST FLOOR
A-403.00 1 1/2" = 1'-0"

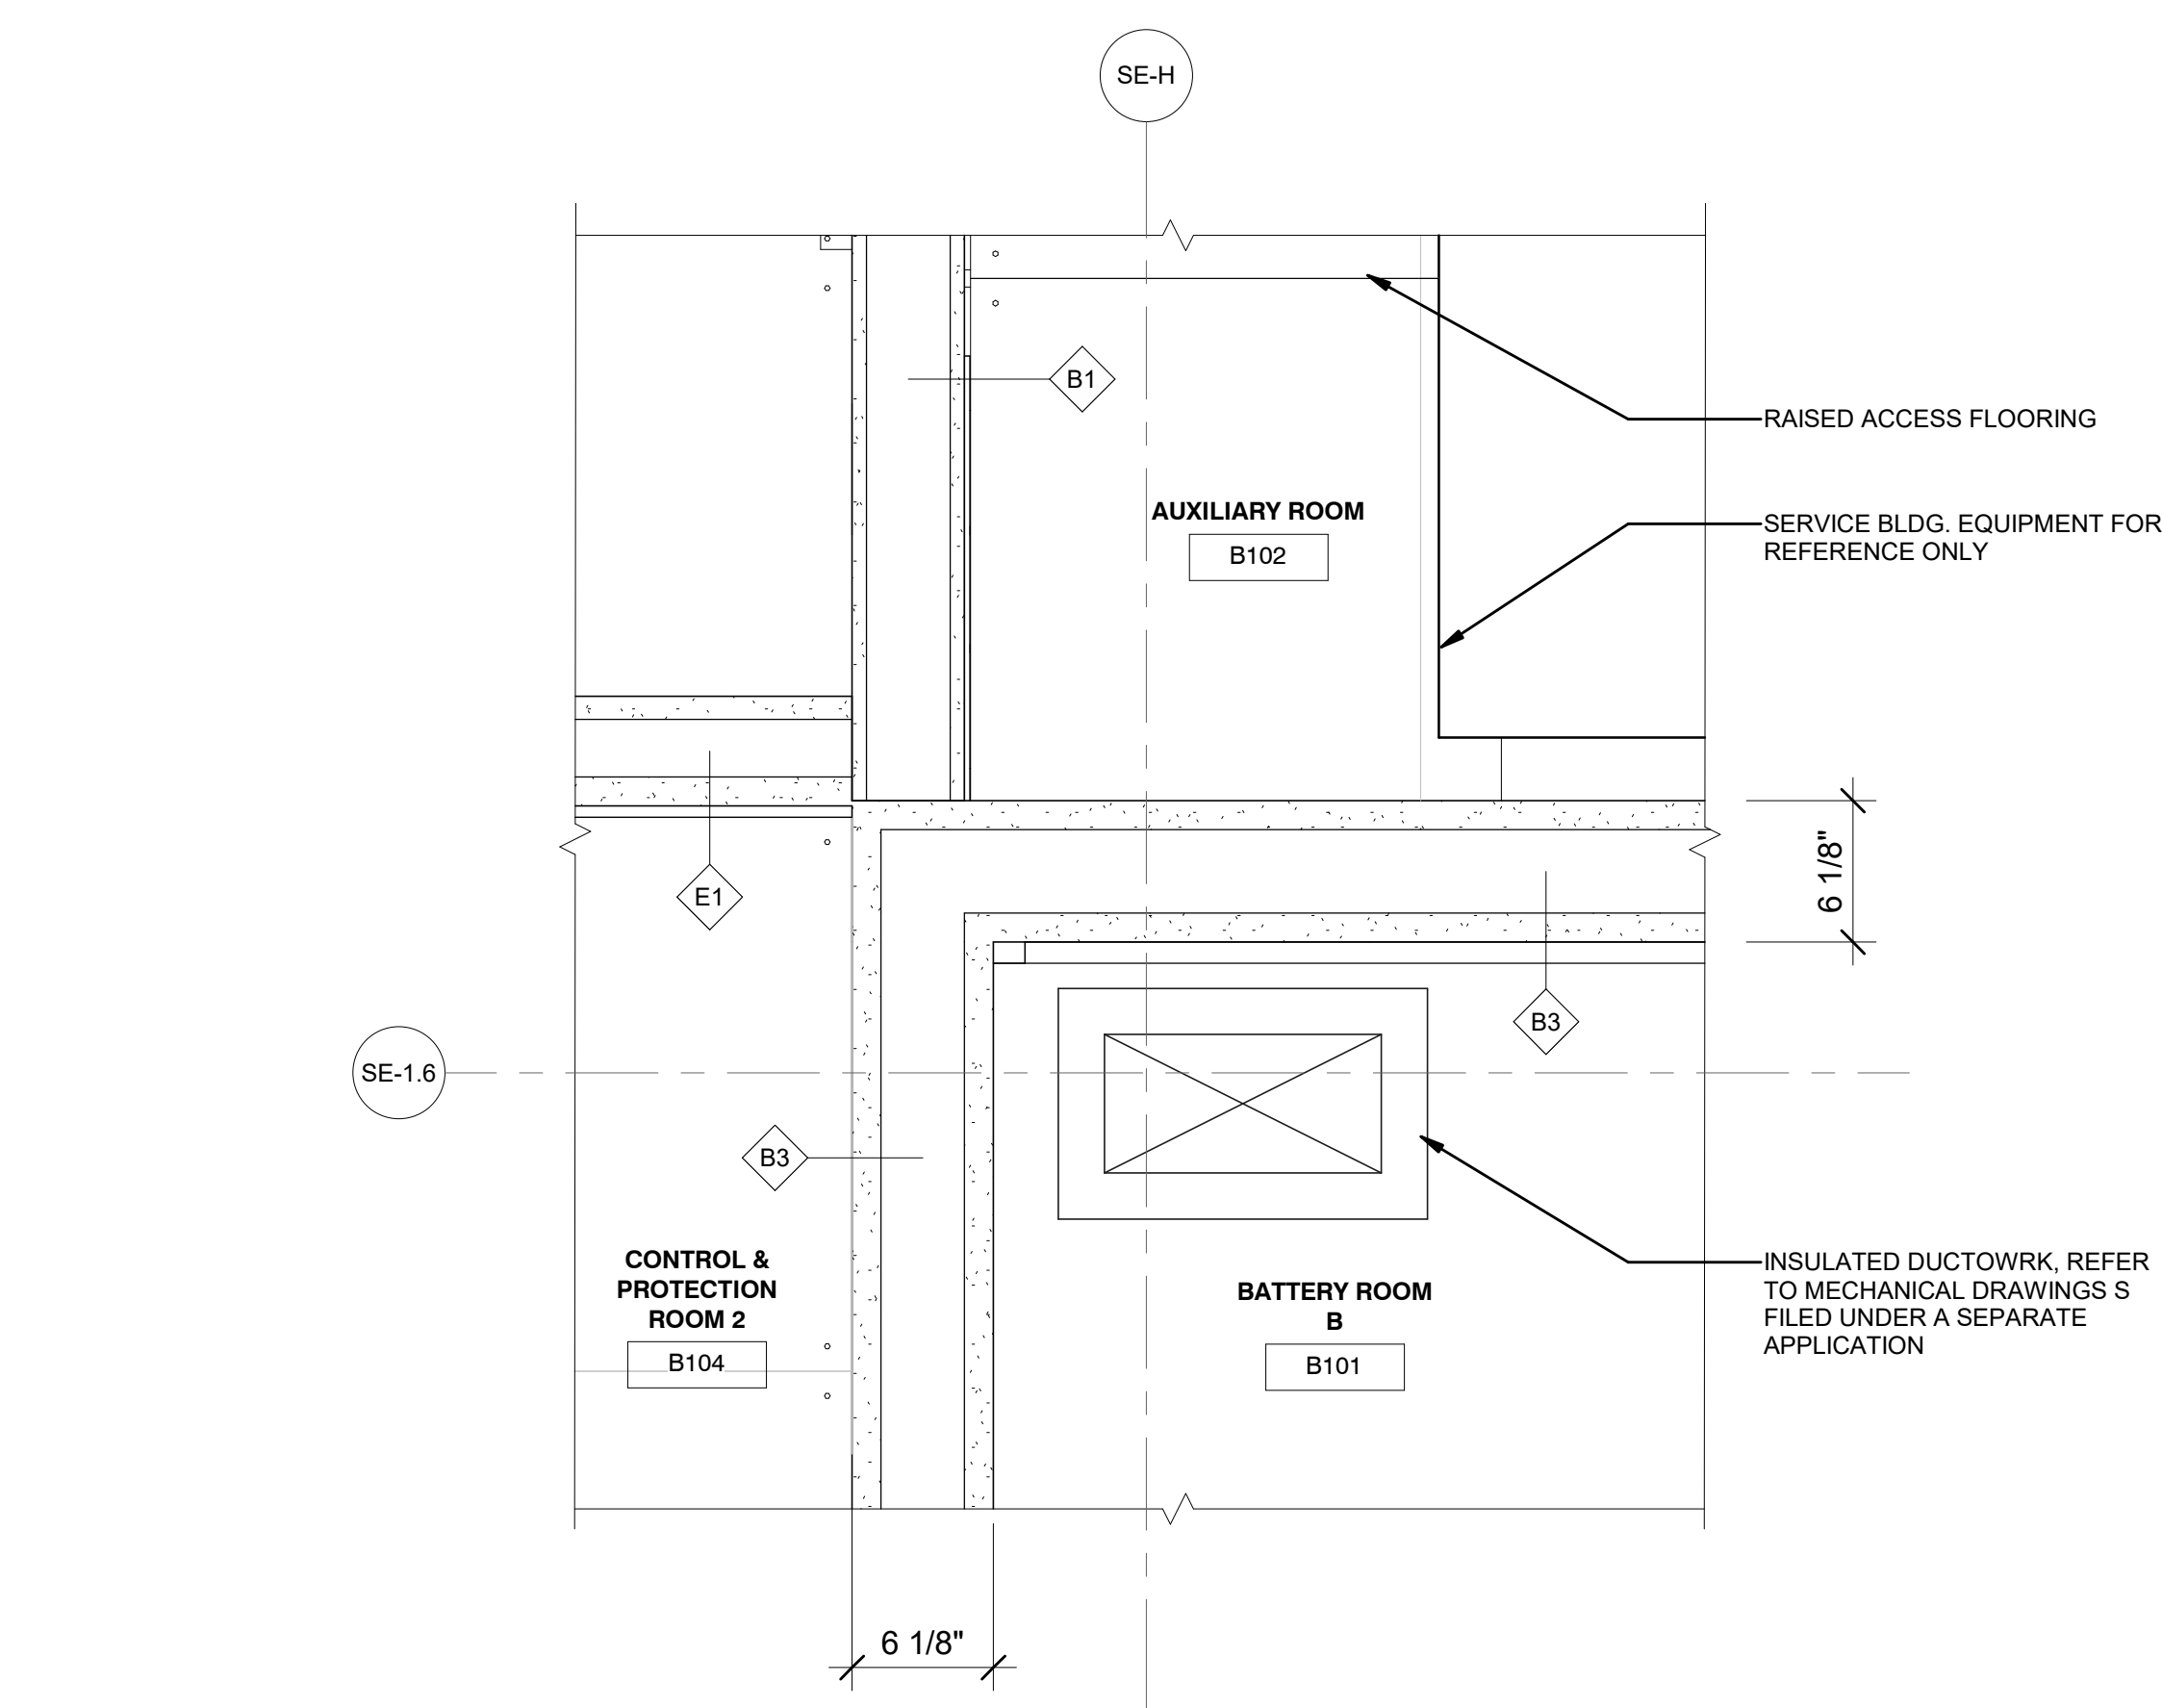


4 PLAN DETAIL 4 - SERVICE BLDG. FIRST FLOOR
A-409.00 1 1/2" = 1'-0"

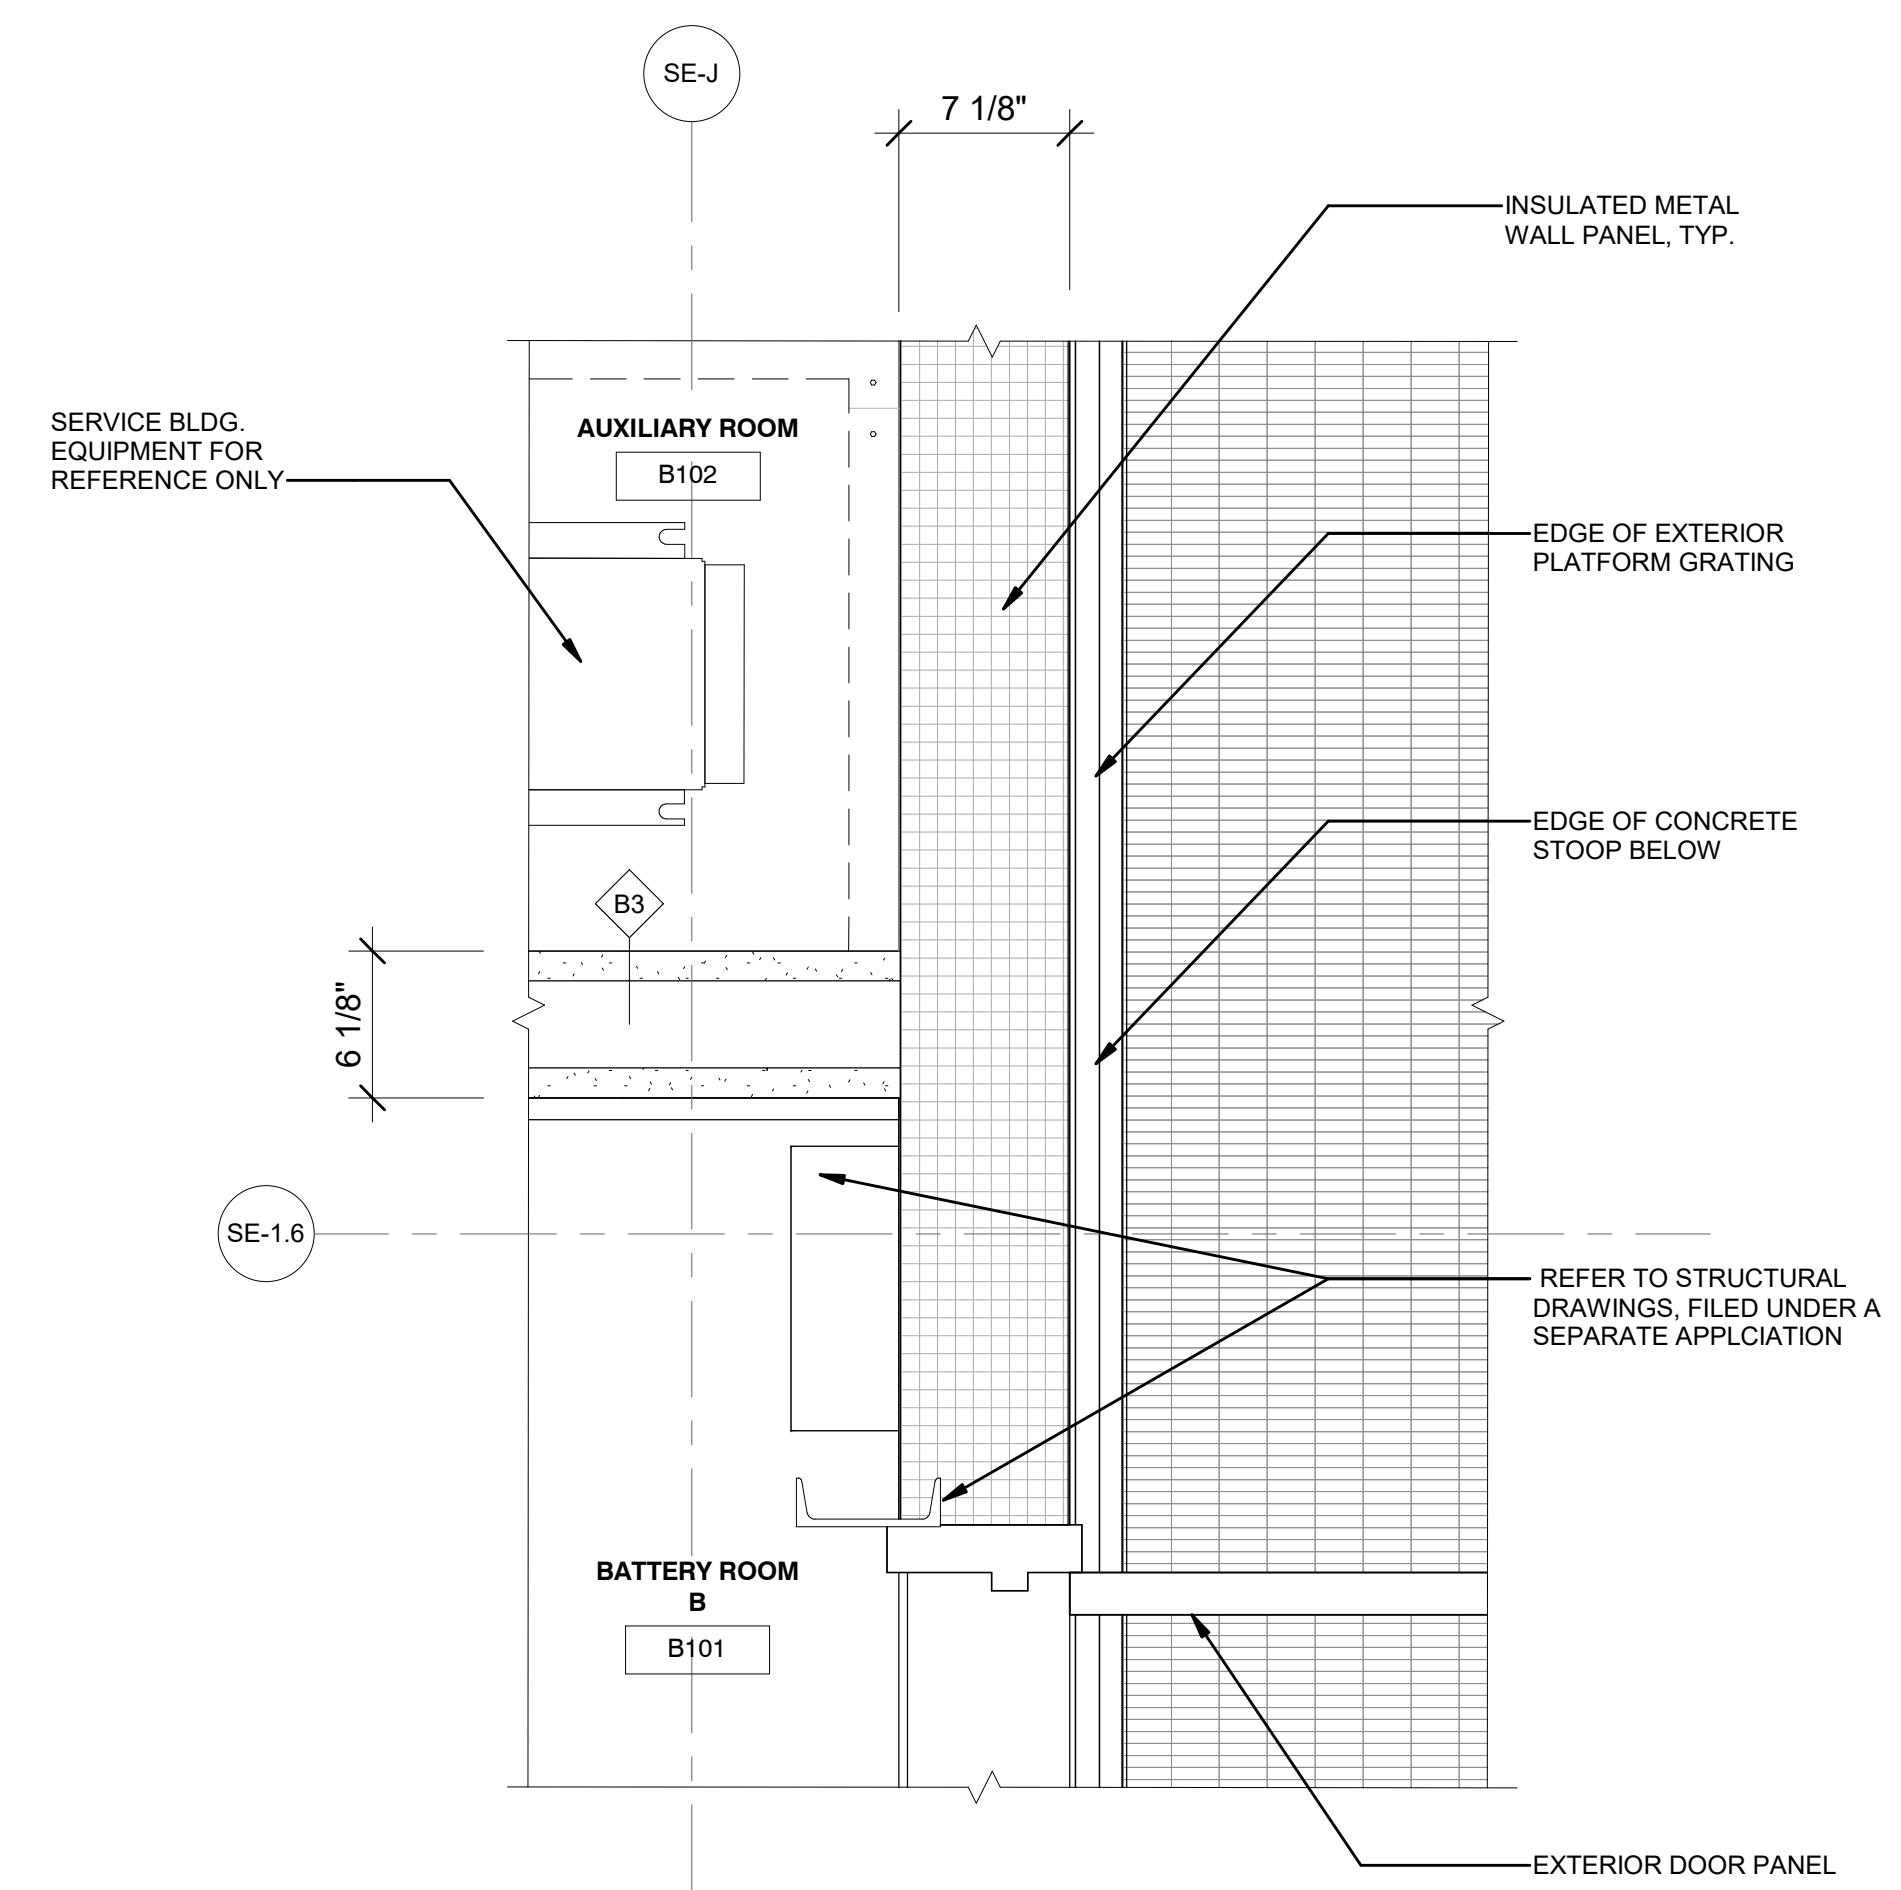

5 PLAN DETAIL 5 - SERVICE BLDG. FIRST FLOOR
A-409.00 1 1/2" = 1'-0"

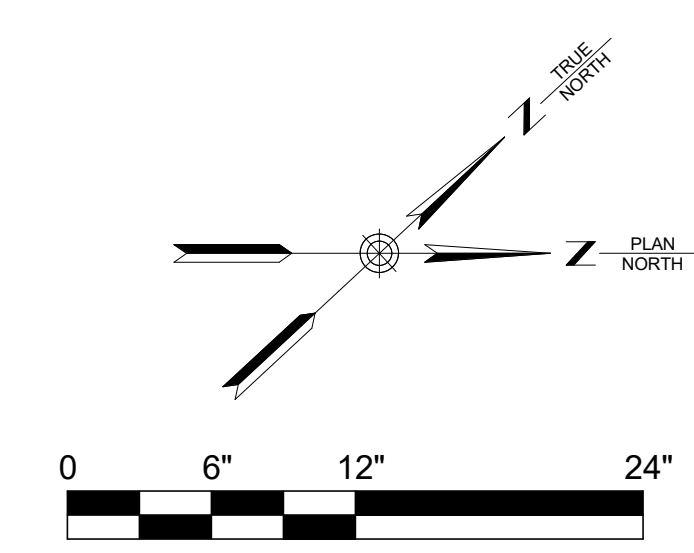

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| REV | DESCRIPTION | DRW BY | CHK BY | DATE |
|-----|--------------------|--------|--------|------------|
| B | FINAL SUBMISSION | RAC | ZH | 12/12/2022 |
| A | INTERIM SUBMISSION | RAC | ZH | 09/13/2022 |

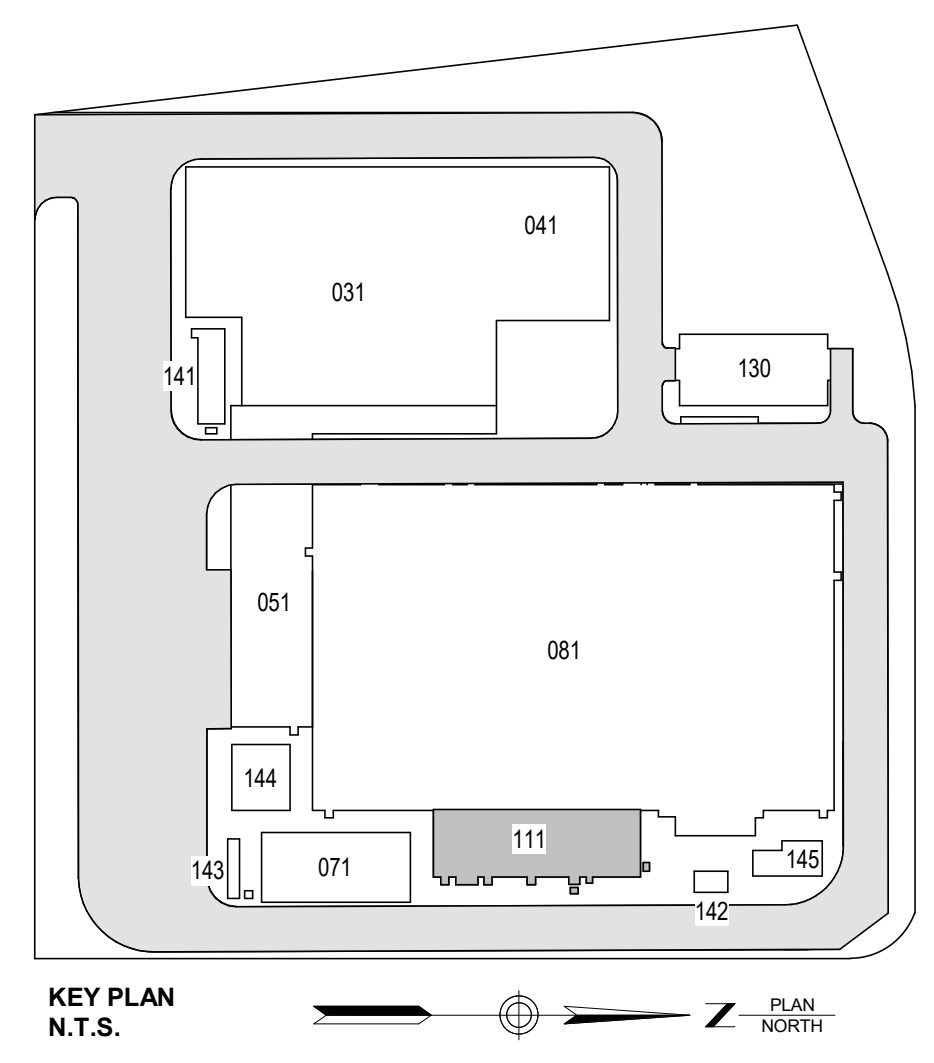Kiewit
470 Chestnut Ridge Rd # 2,
Woodcliff Lake, NJ 07677

Hitachi Energy
901 Main Campus Drive
Raleigh, North Carolina 27606


PROJECT

CHPE
Champlain Hudson
Power Express


Astoria HVDC Converter Station
31-45 20th Avenue, Astoria, Queens NY 11105
Block #850 - Lot #310 - BIN #4624437

PLAN DETAILS 6


DATE: 12/12/22
PROJECT NO: 105121
DRAWING BY: R. COLES
CHECKED BY: Z. HARR
DRAWING NO: **A-609.00**
CADD FILE NO:
Astoria/CHPE-111-22-M3-A-001.rvt

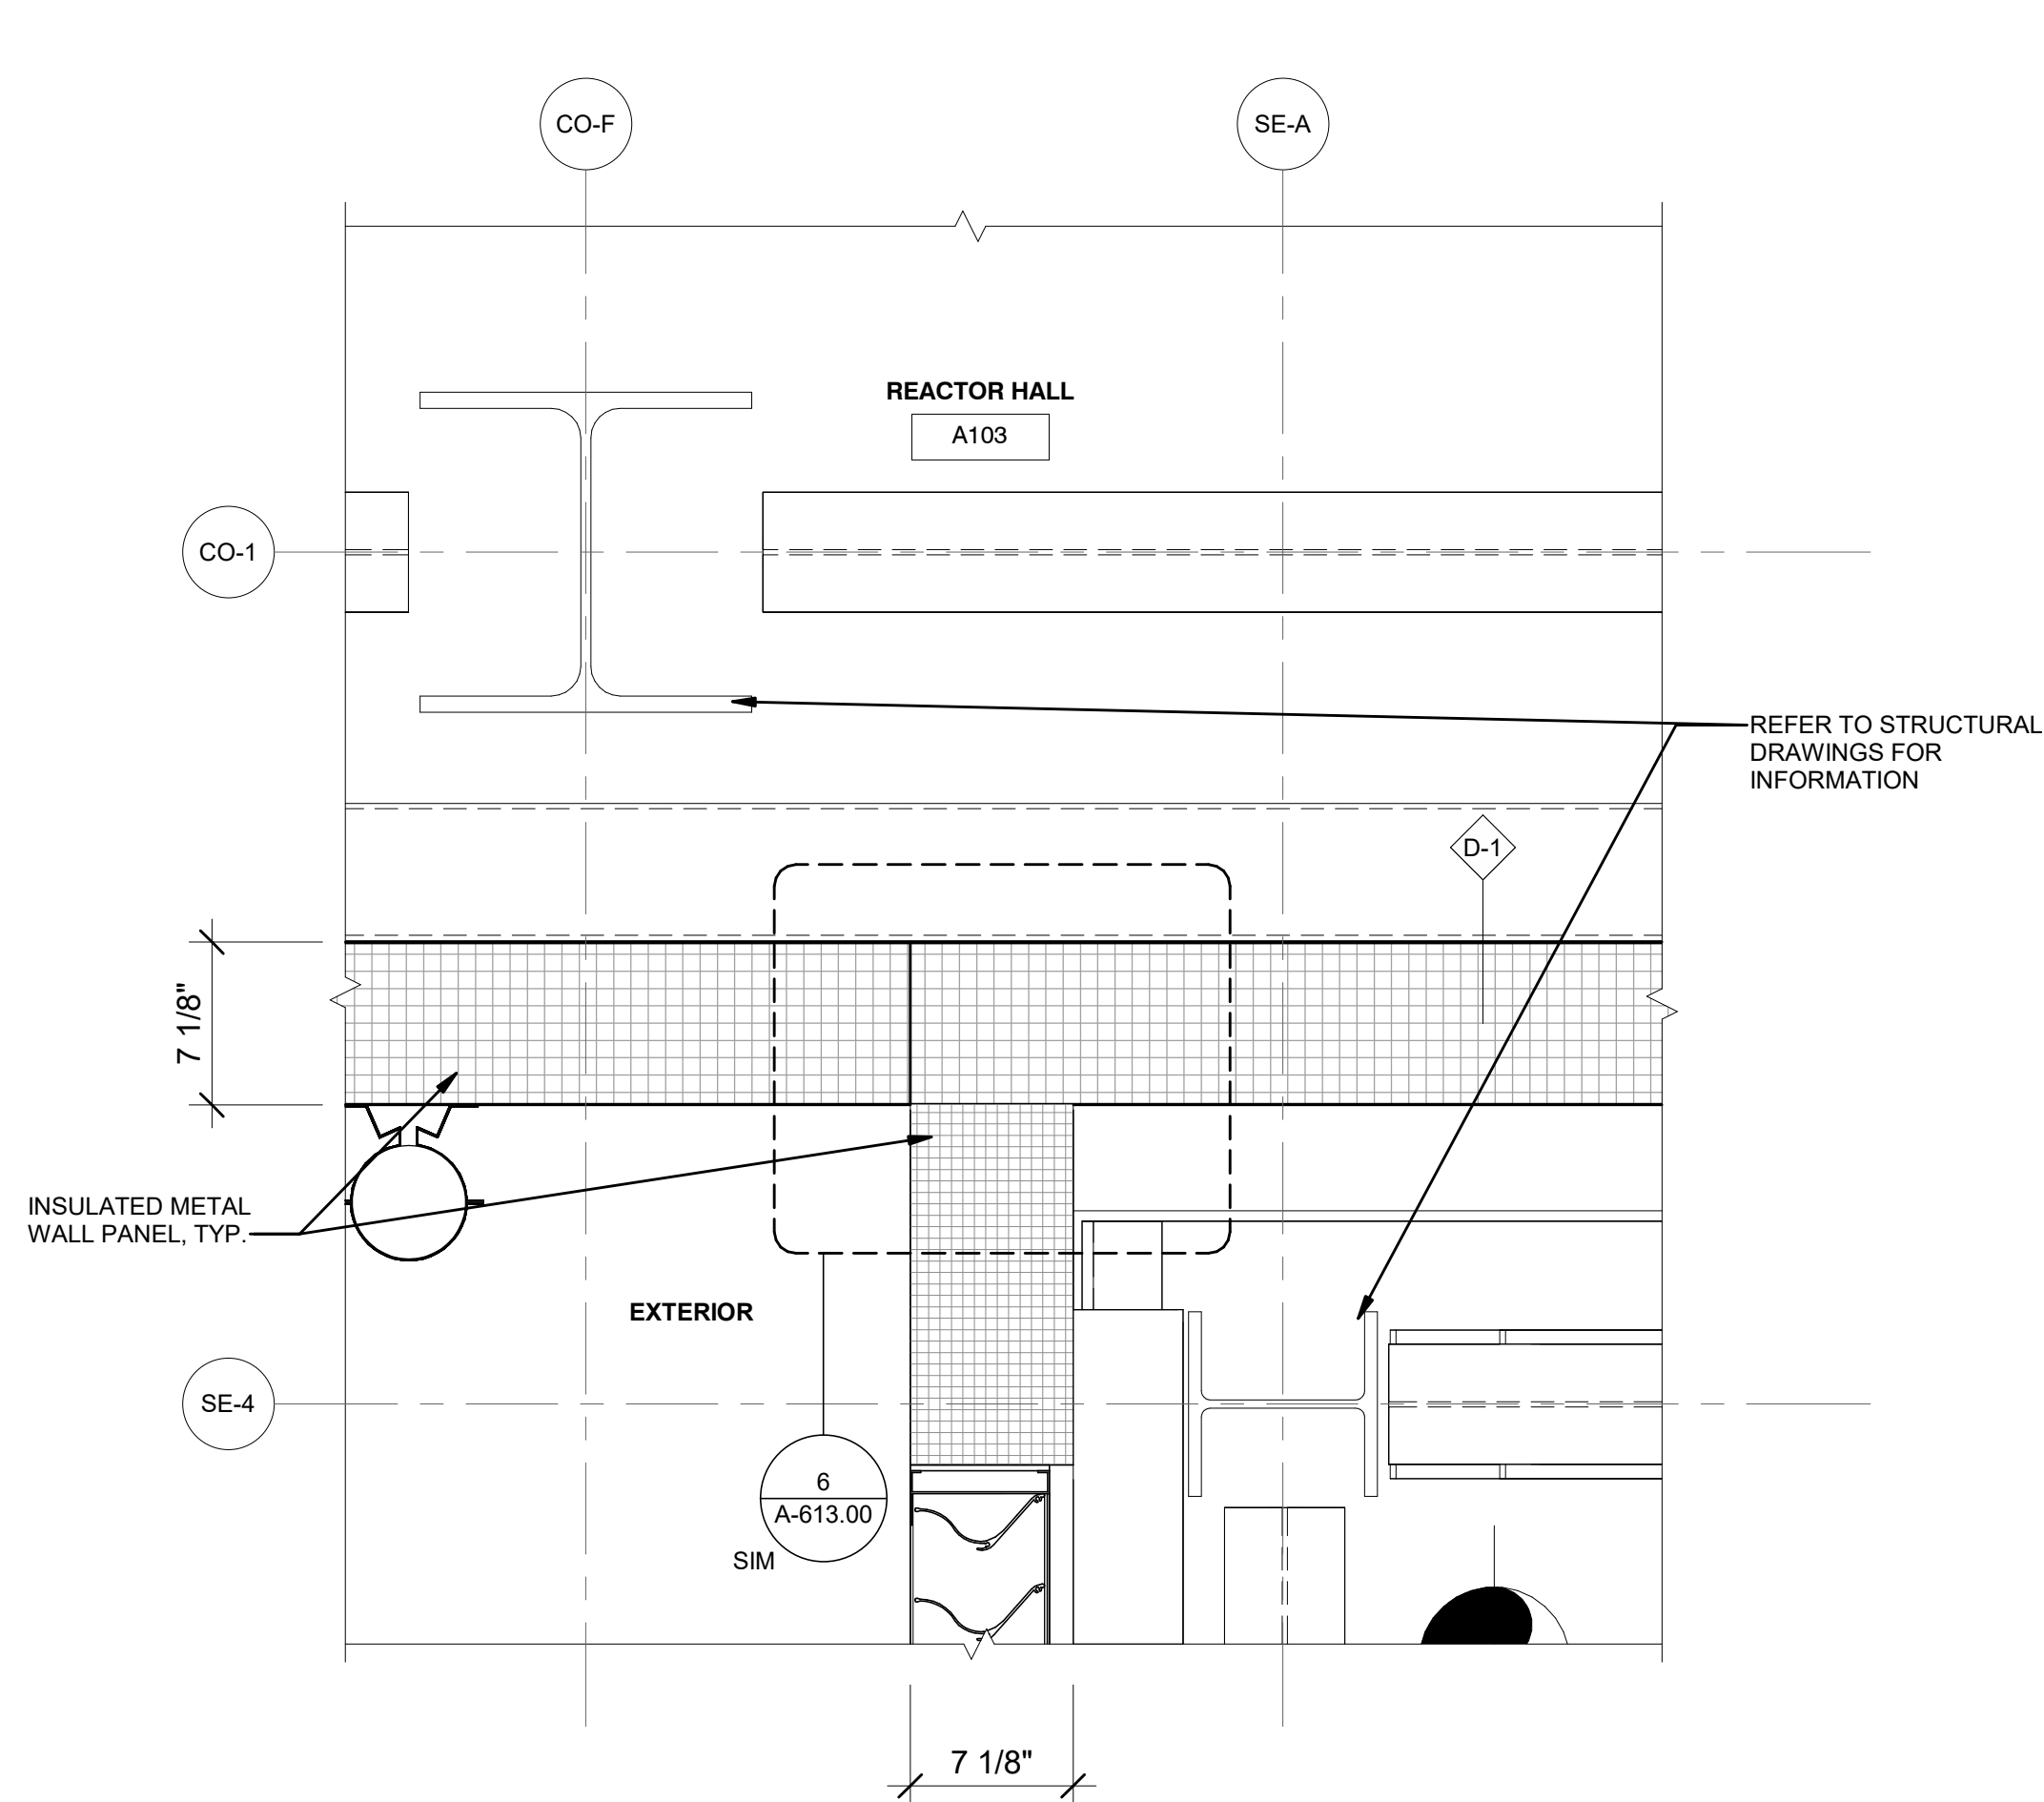


1 PLAN DETAIL 1 - SERVICE BLDG. SECOND FLOOR
A-110.00 1 1/2" = 1'-0"

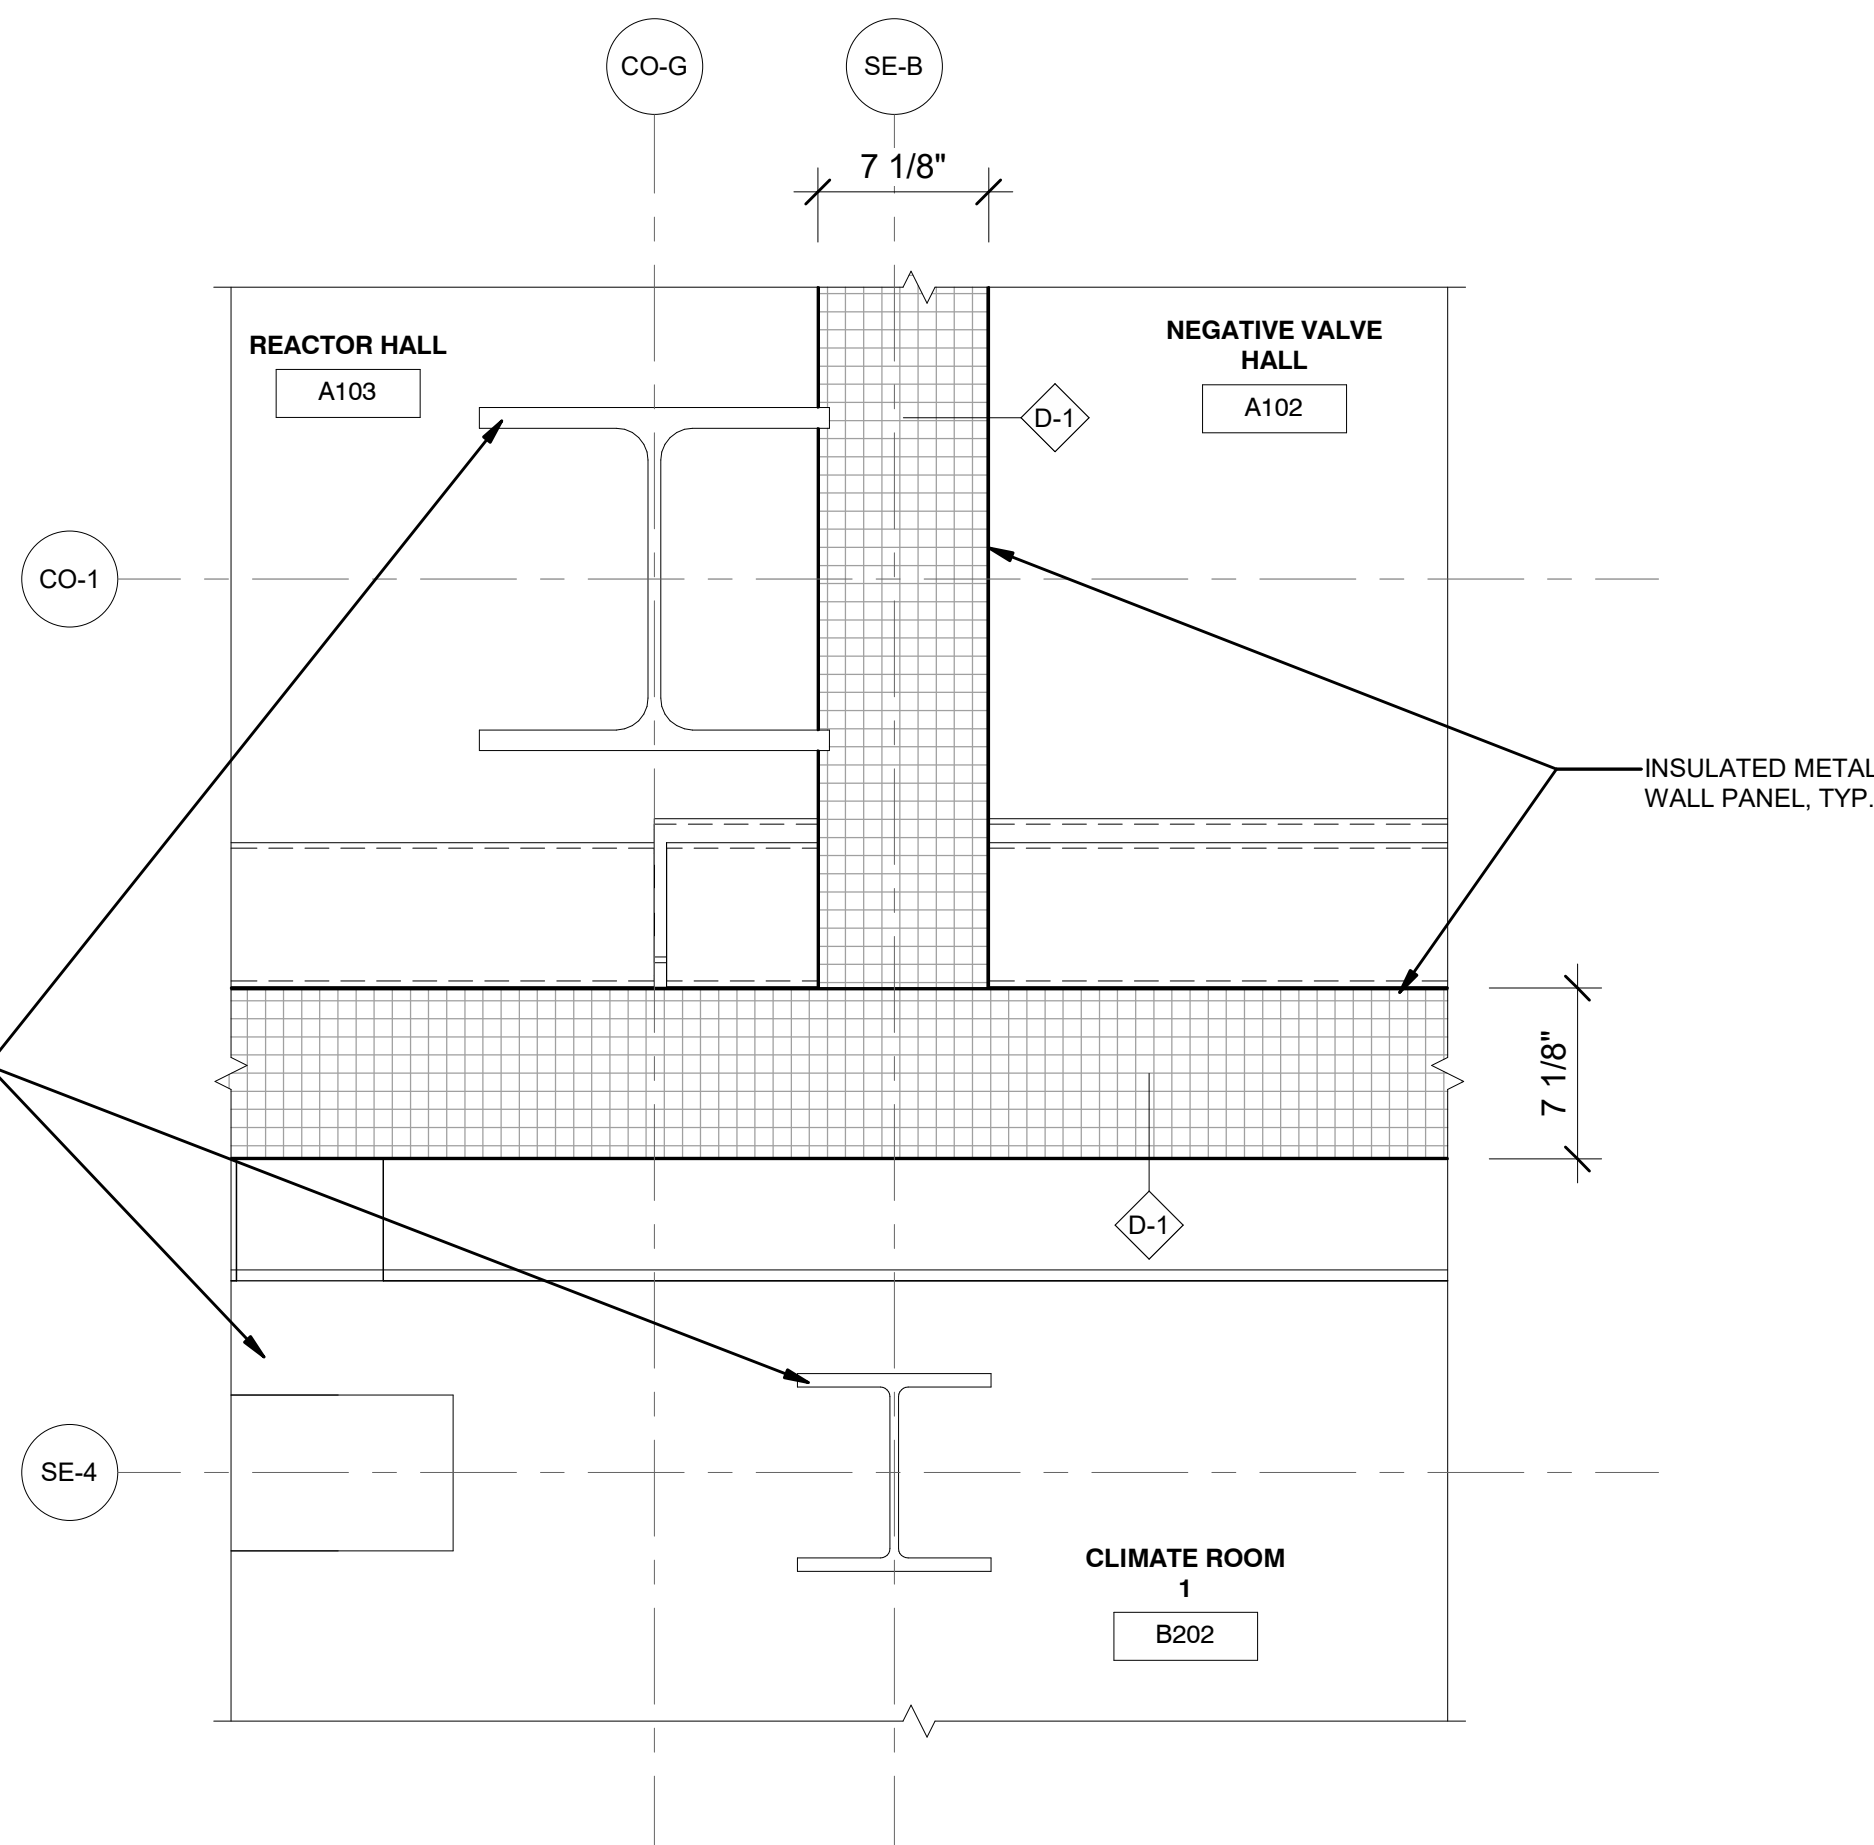


2 PLAN DETAIL 2 - SERVICE BLDG. SECOND FLOOR
A-110.00 1 1/2" = 1'-0"

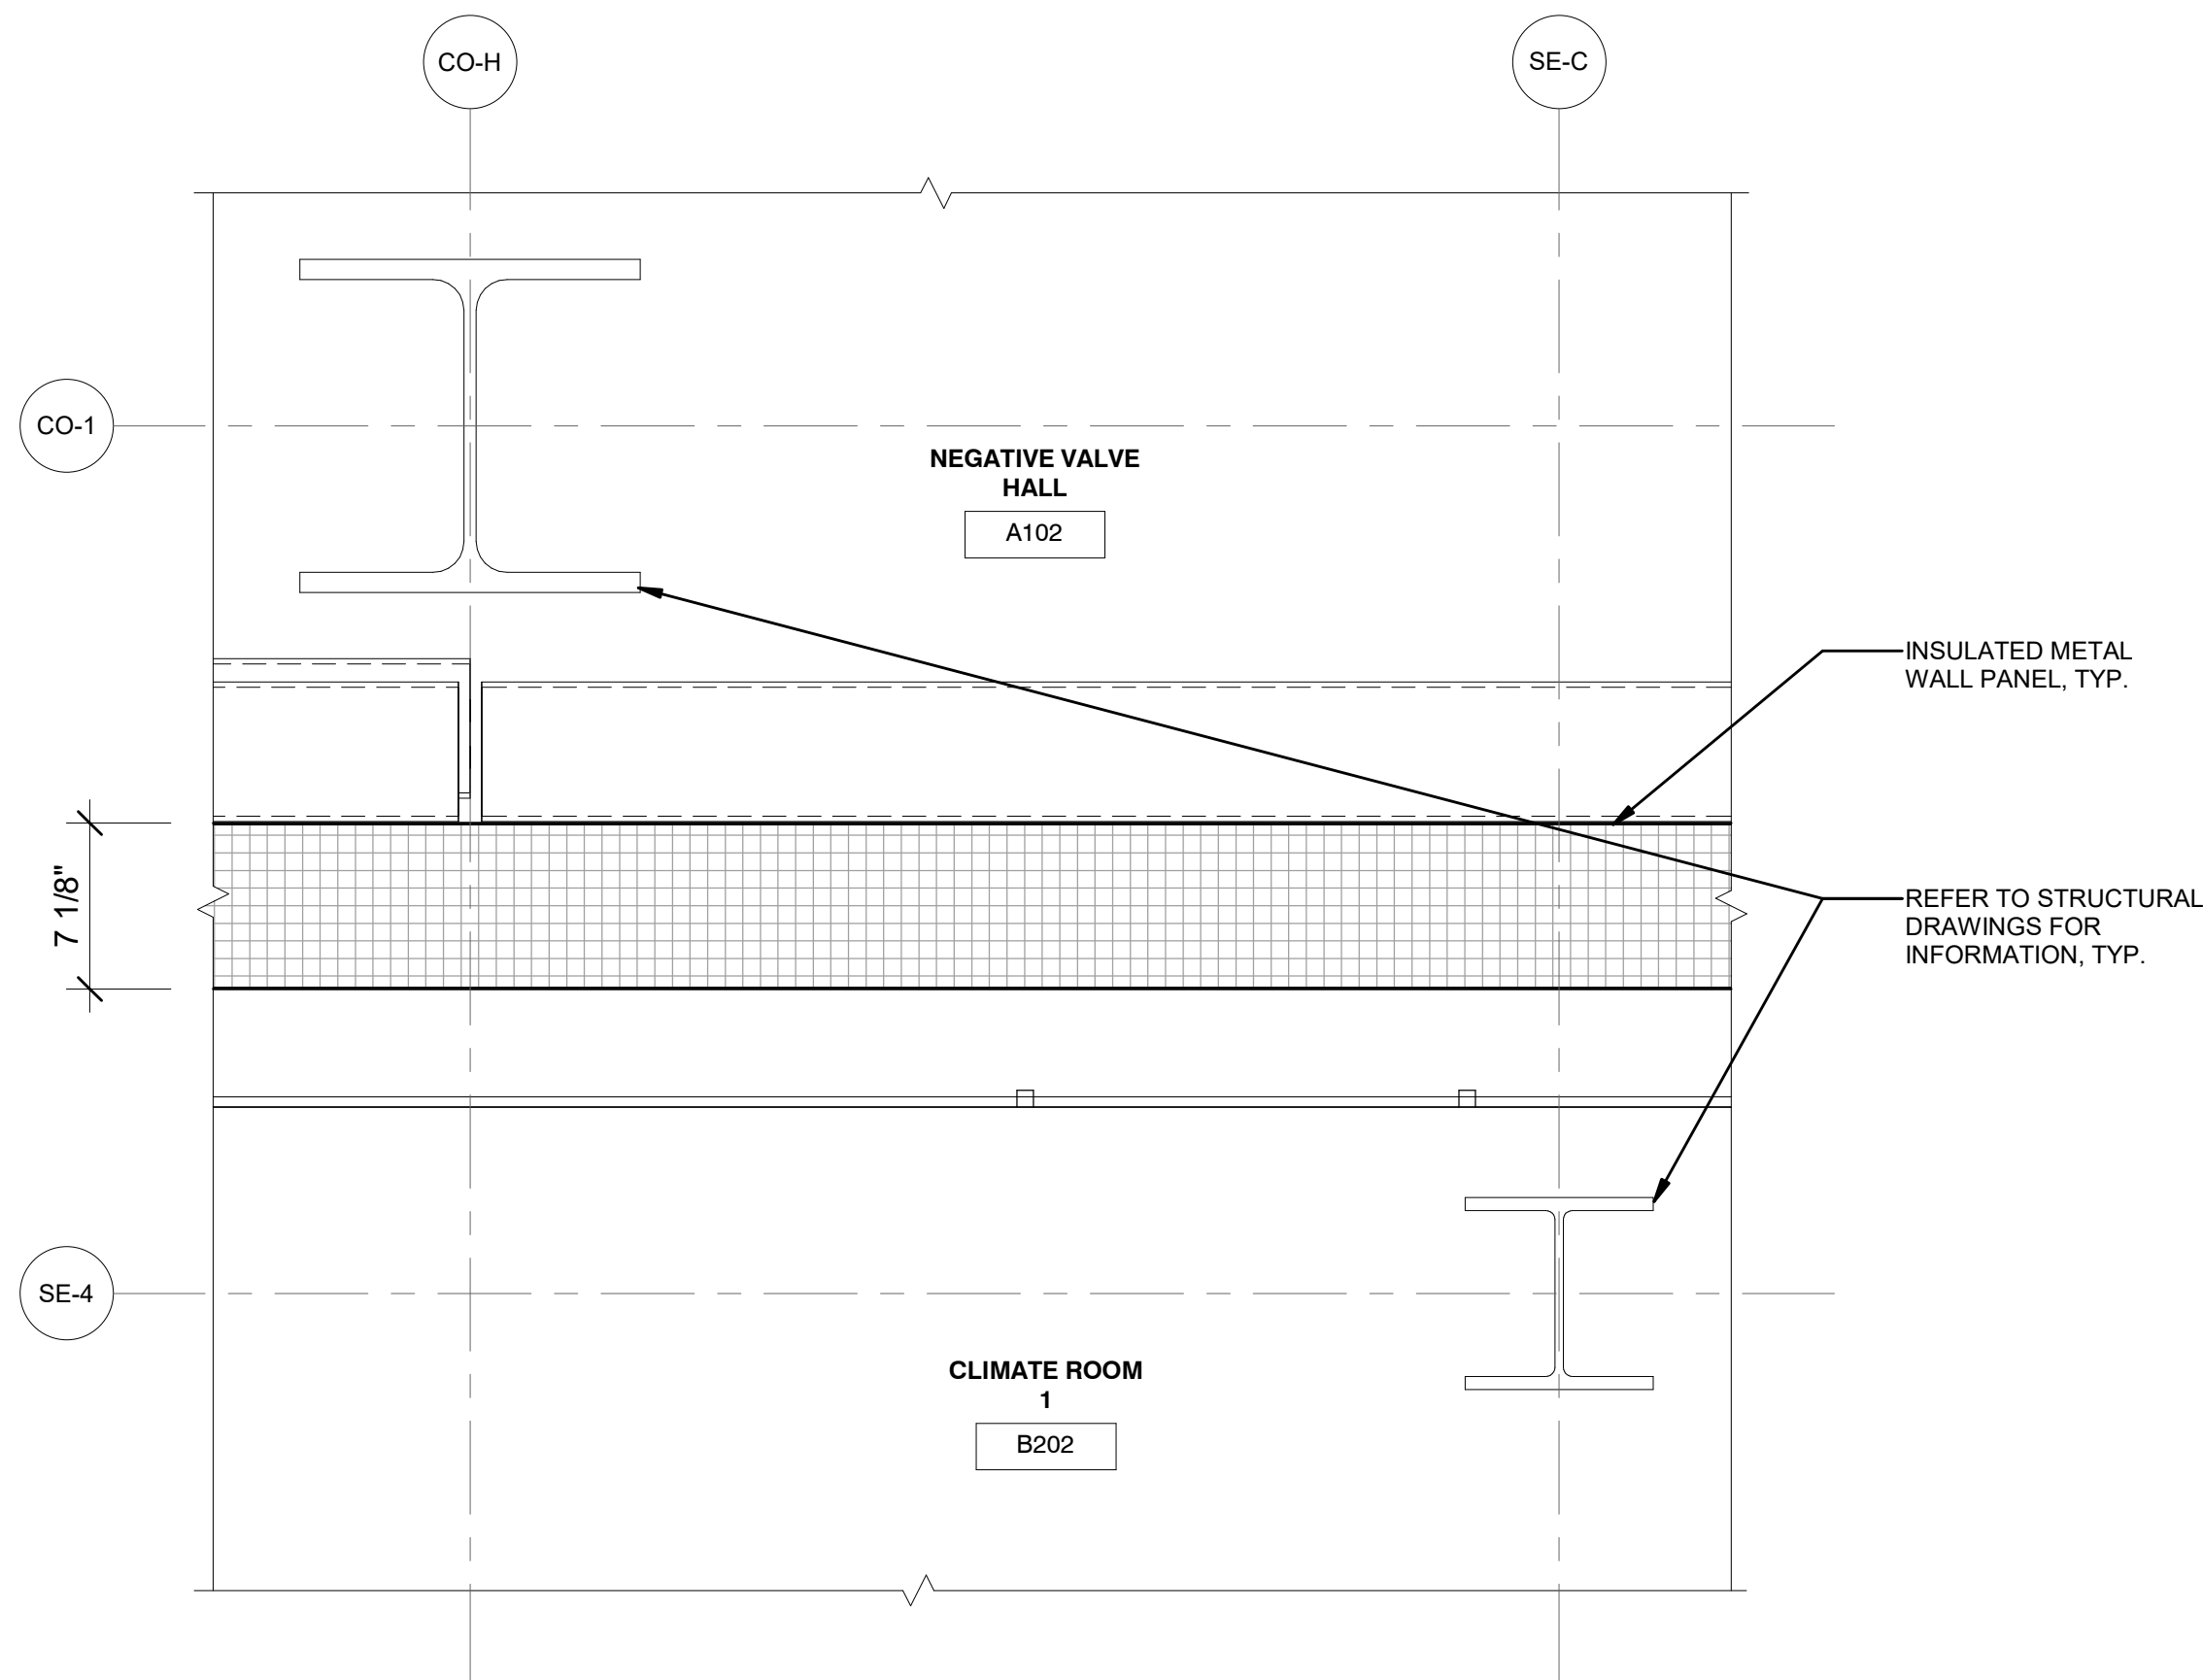


3 PLAN DETAIL 3 - SERVICE BLDG. SECOND FLOOR
A-110.00 1 1/2" = 1'-0"

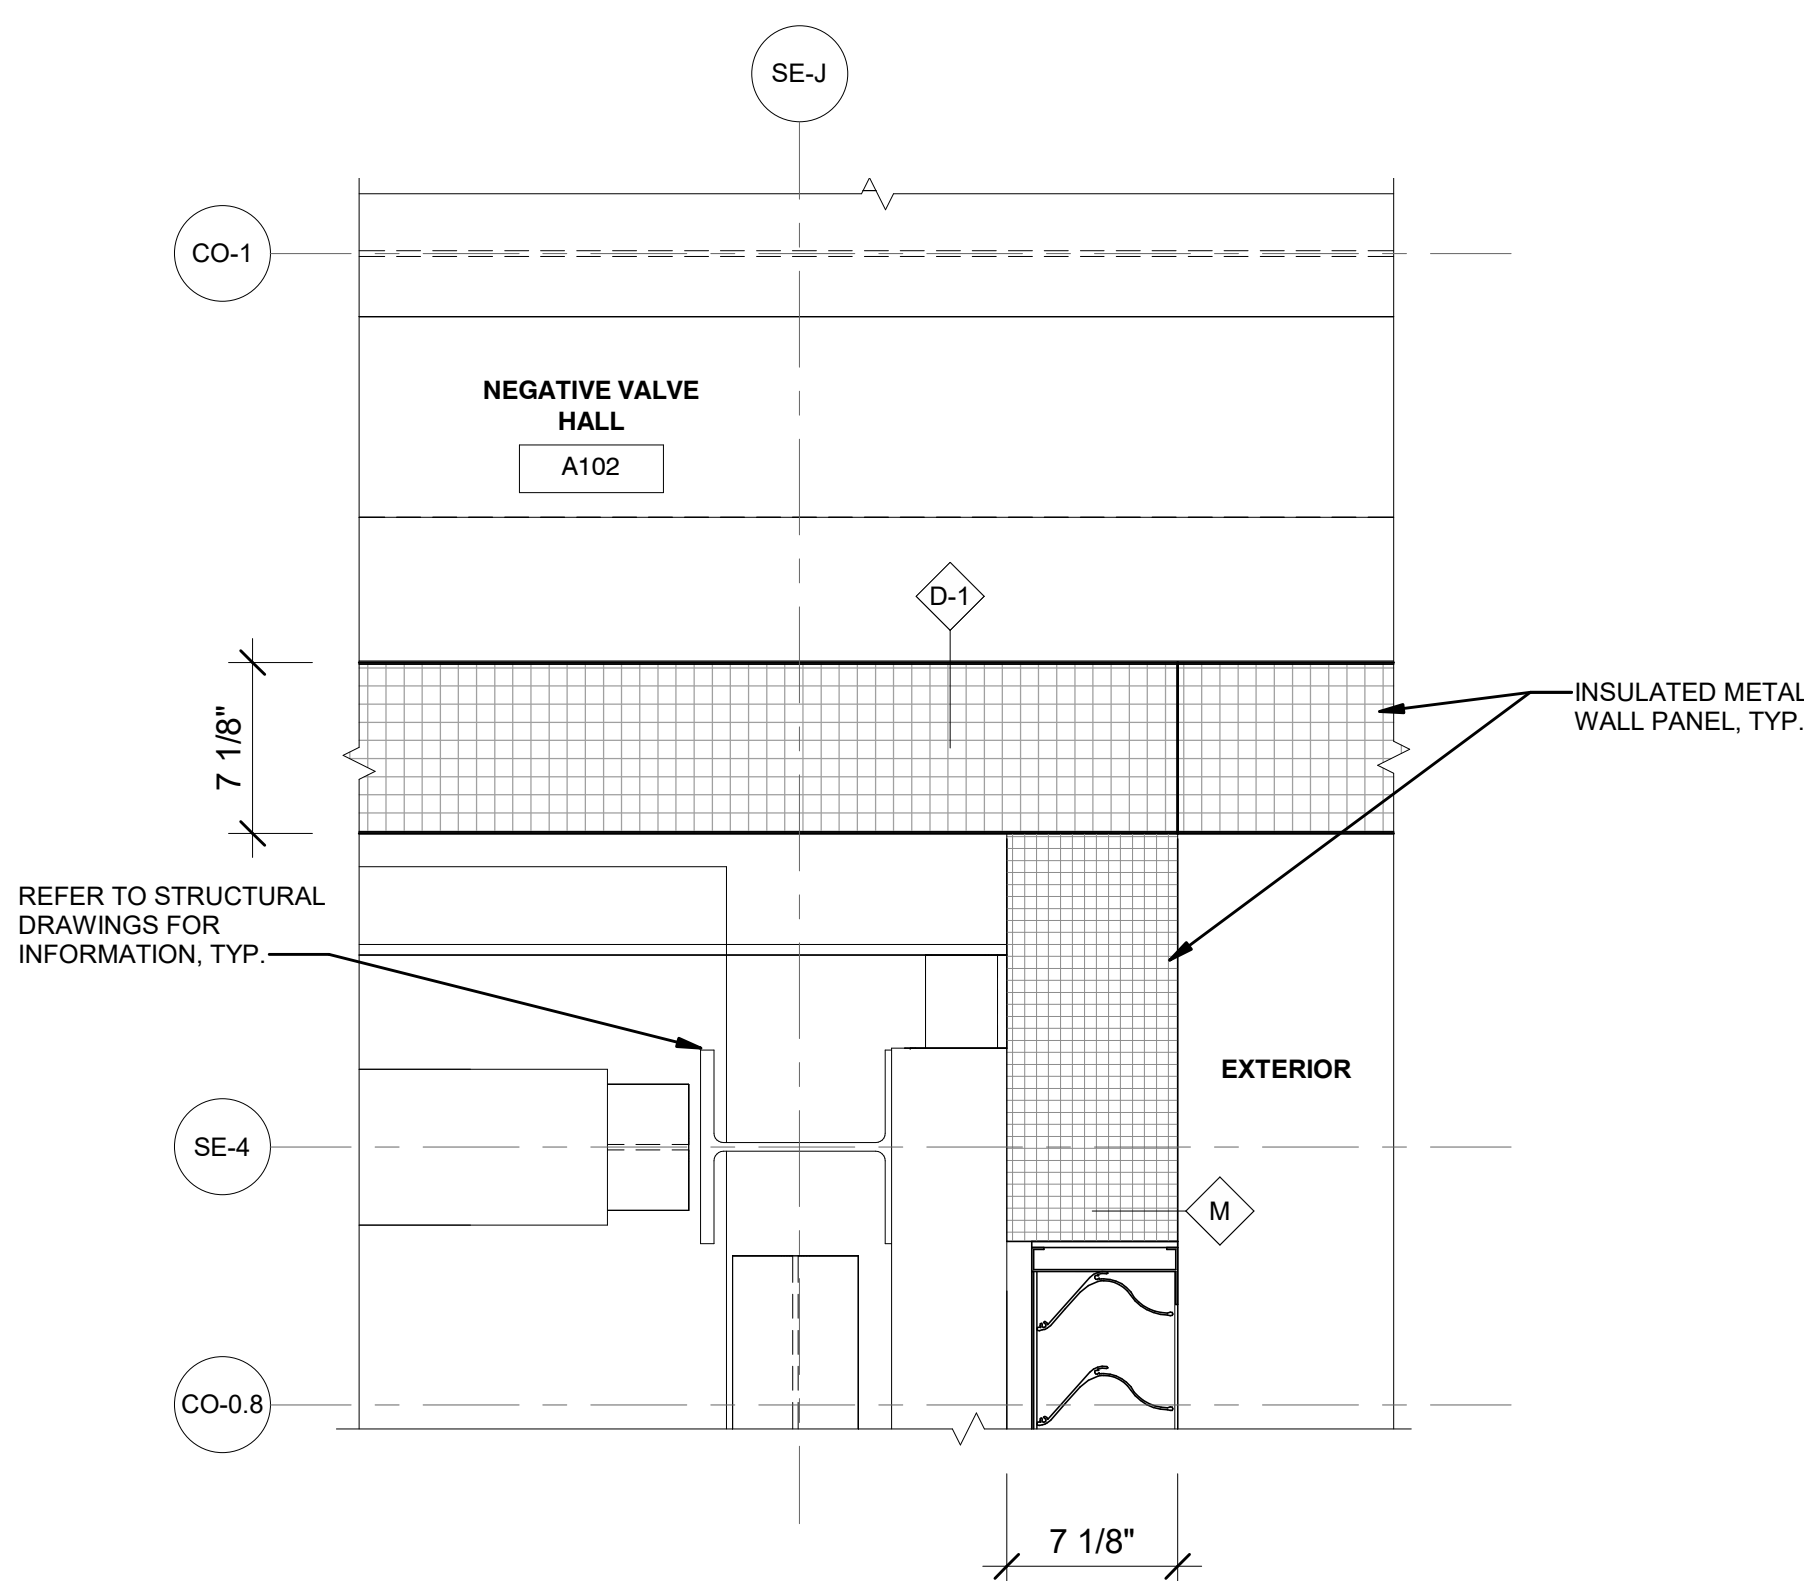

4 PLAN DETAIL 4 - SERVICE BLDG. SECOND FLOOR
A-110.00 1 1/2" = 1'-0"

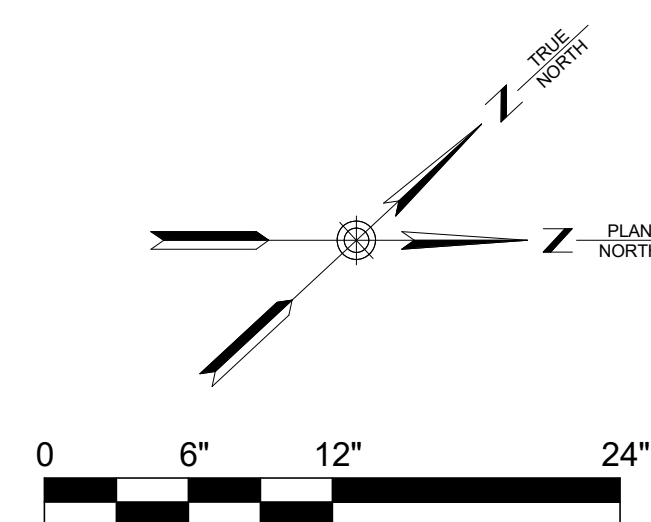

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| REV | DESCRIPTION | DRW BY | CHK BY | DATE |

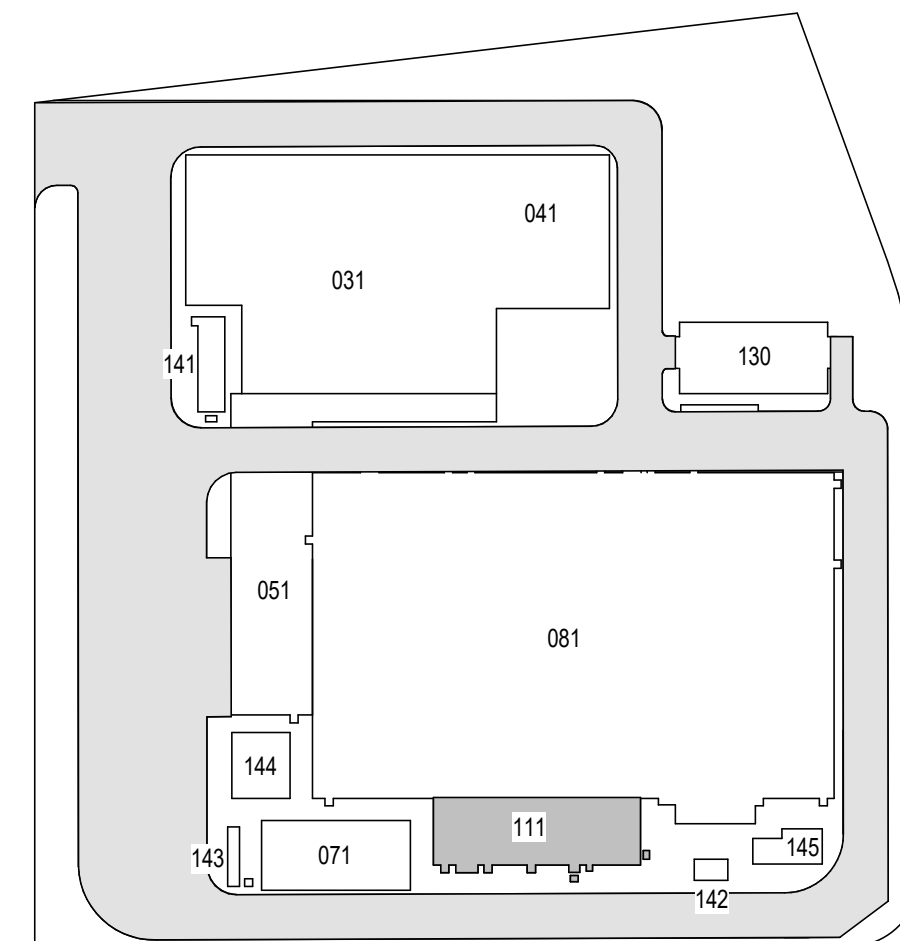Kiewit
470 Chestnut Ridge Rd # 2,
Woodcliff Lake, NJ 07677

Hitachi Energy
901 Main Campus Drive
Raleigh, North Carolina 27606

PROJECT

CHPE
Champlain Hudson
Power Express


**Astoria HVDC
Converter Station**

31-45 20th Avenue, Astoria, Queens NY 11105
Block #850 - Lot #310 - BIN #4624437


PLAN DETAILS 7




DATE 12/12/22
PROJECT NO 105121
DRAWING BY R. COLES
CHECKED BY Z. HARR
DRAWING NO
A-610.00
CADD FILE NO
AstoriaHVDC-CHPE
AstoriaCHPE-111-ZZ-M3-A-001.rvt

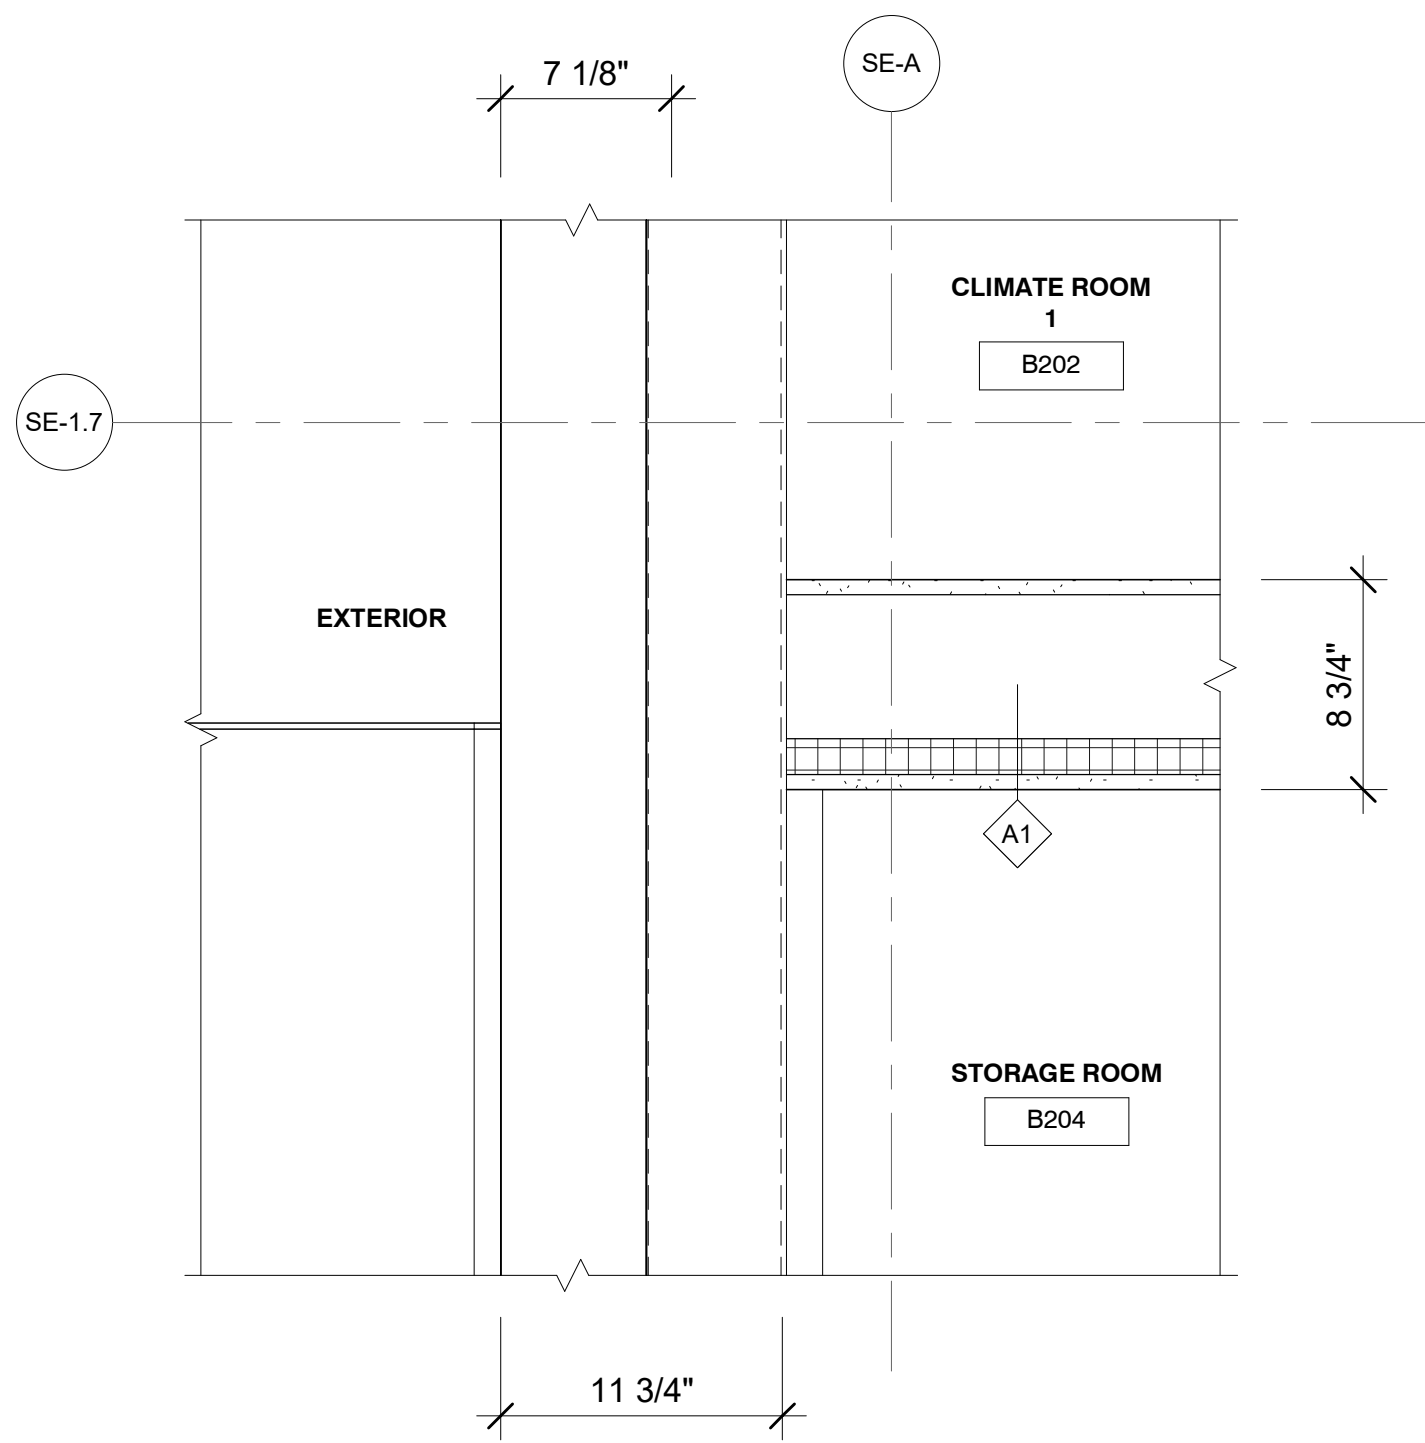


1
A-110.00 PLAN DETAIL 5 - SERVICE BLDG. SECOND FLOOR
1 1/2" = 1'-0"

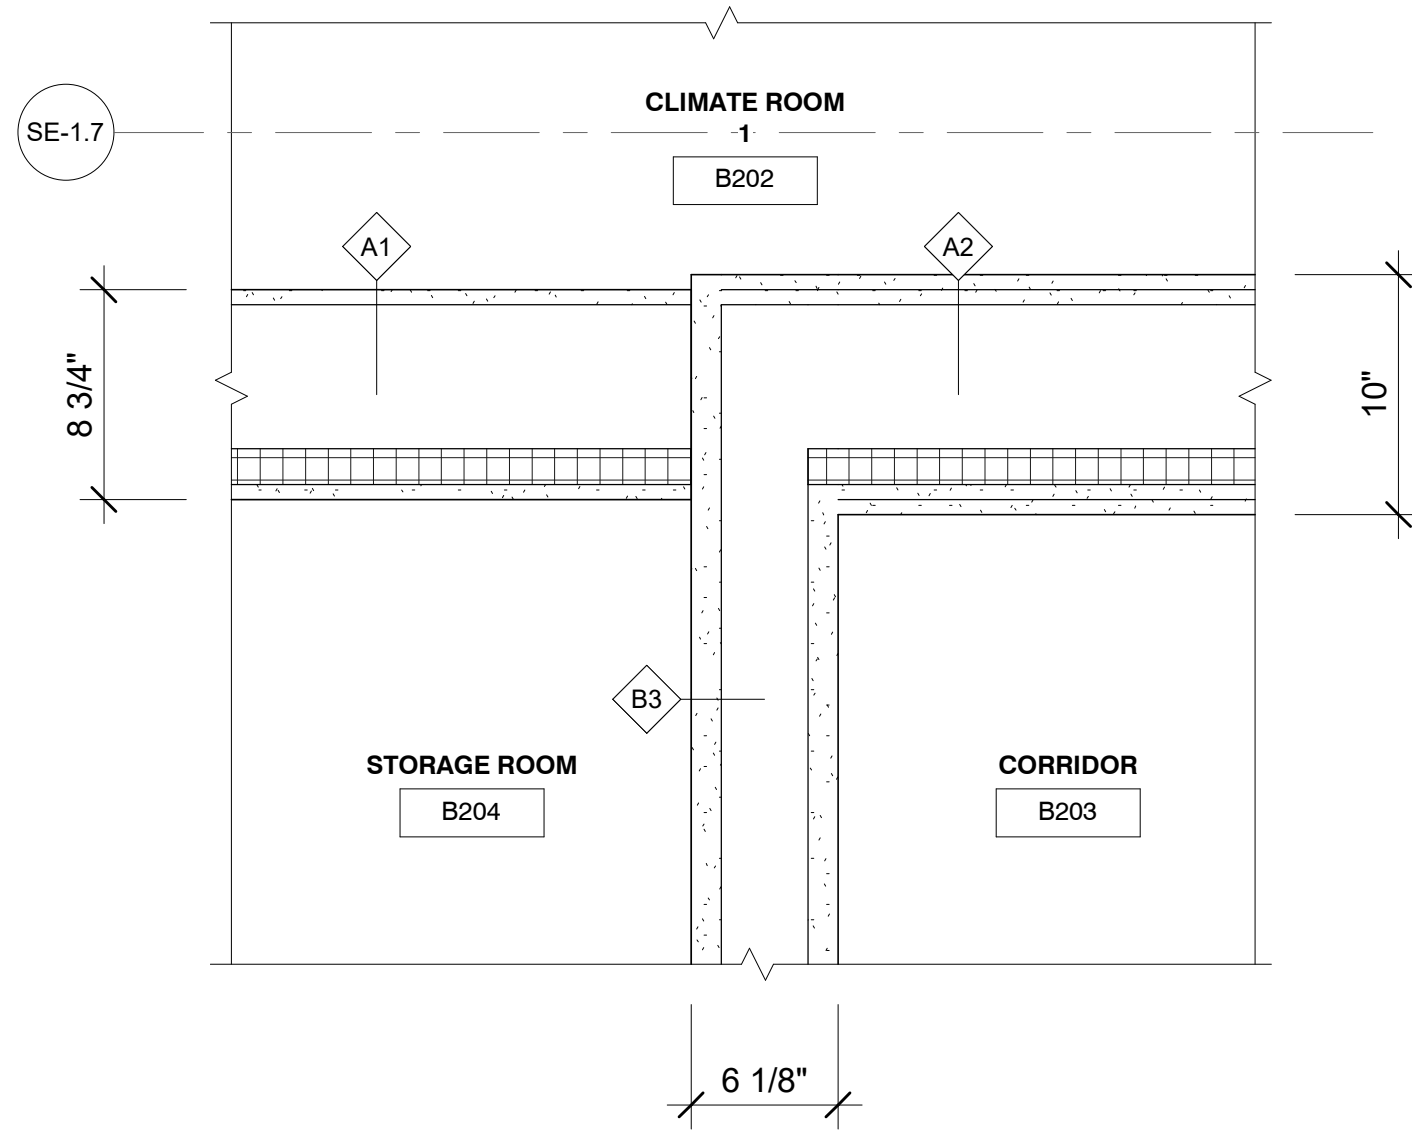


2
A-110.00 PLAN DETAIL 6 - SERVICE BLDG. SECOND FLOOR
1 1/2" = 1'-0"

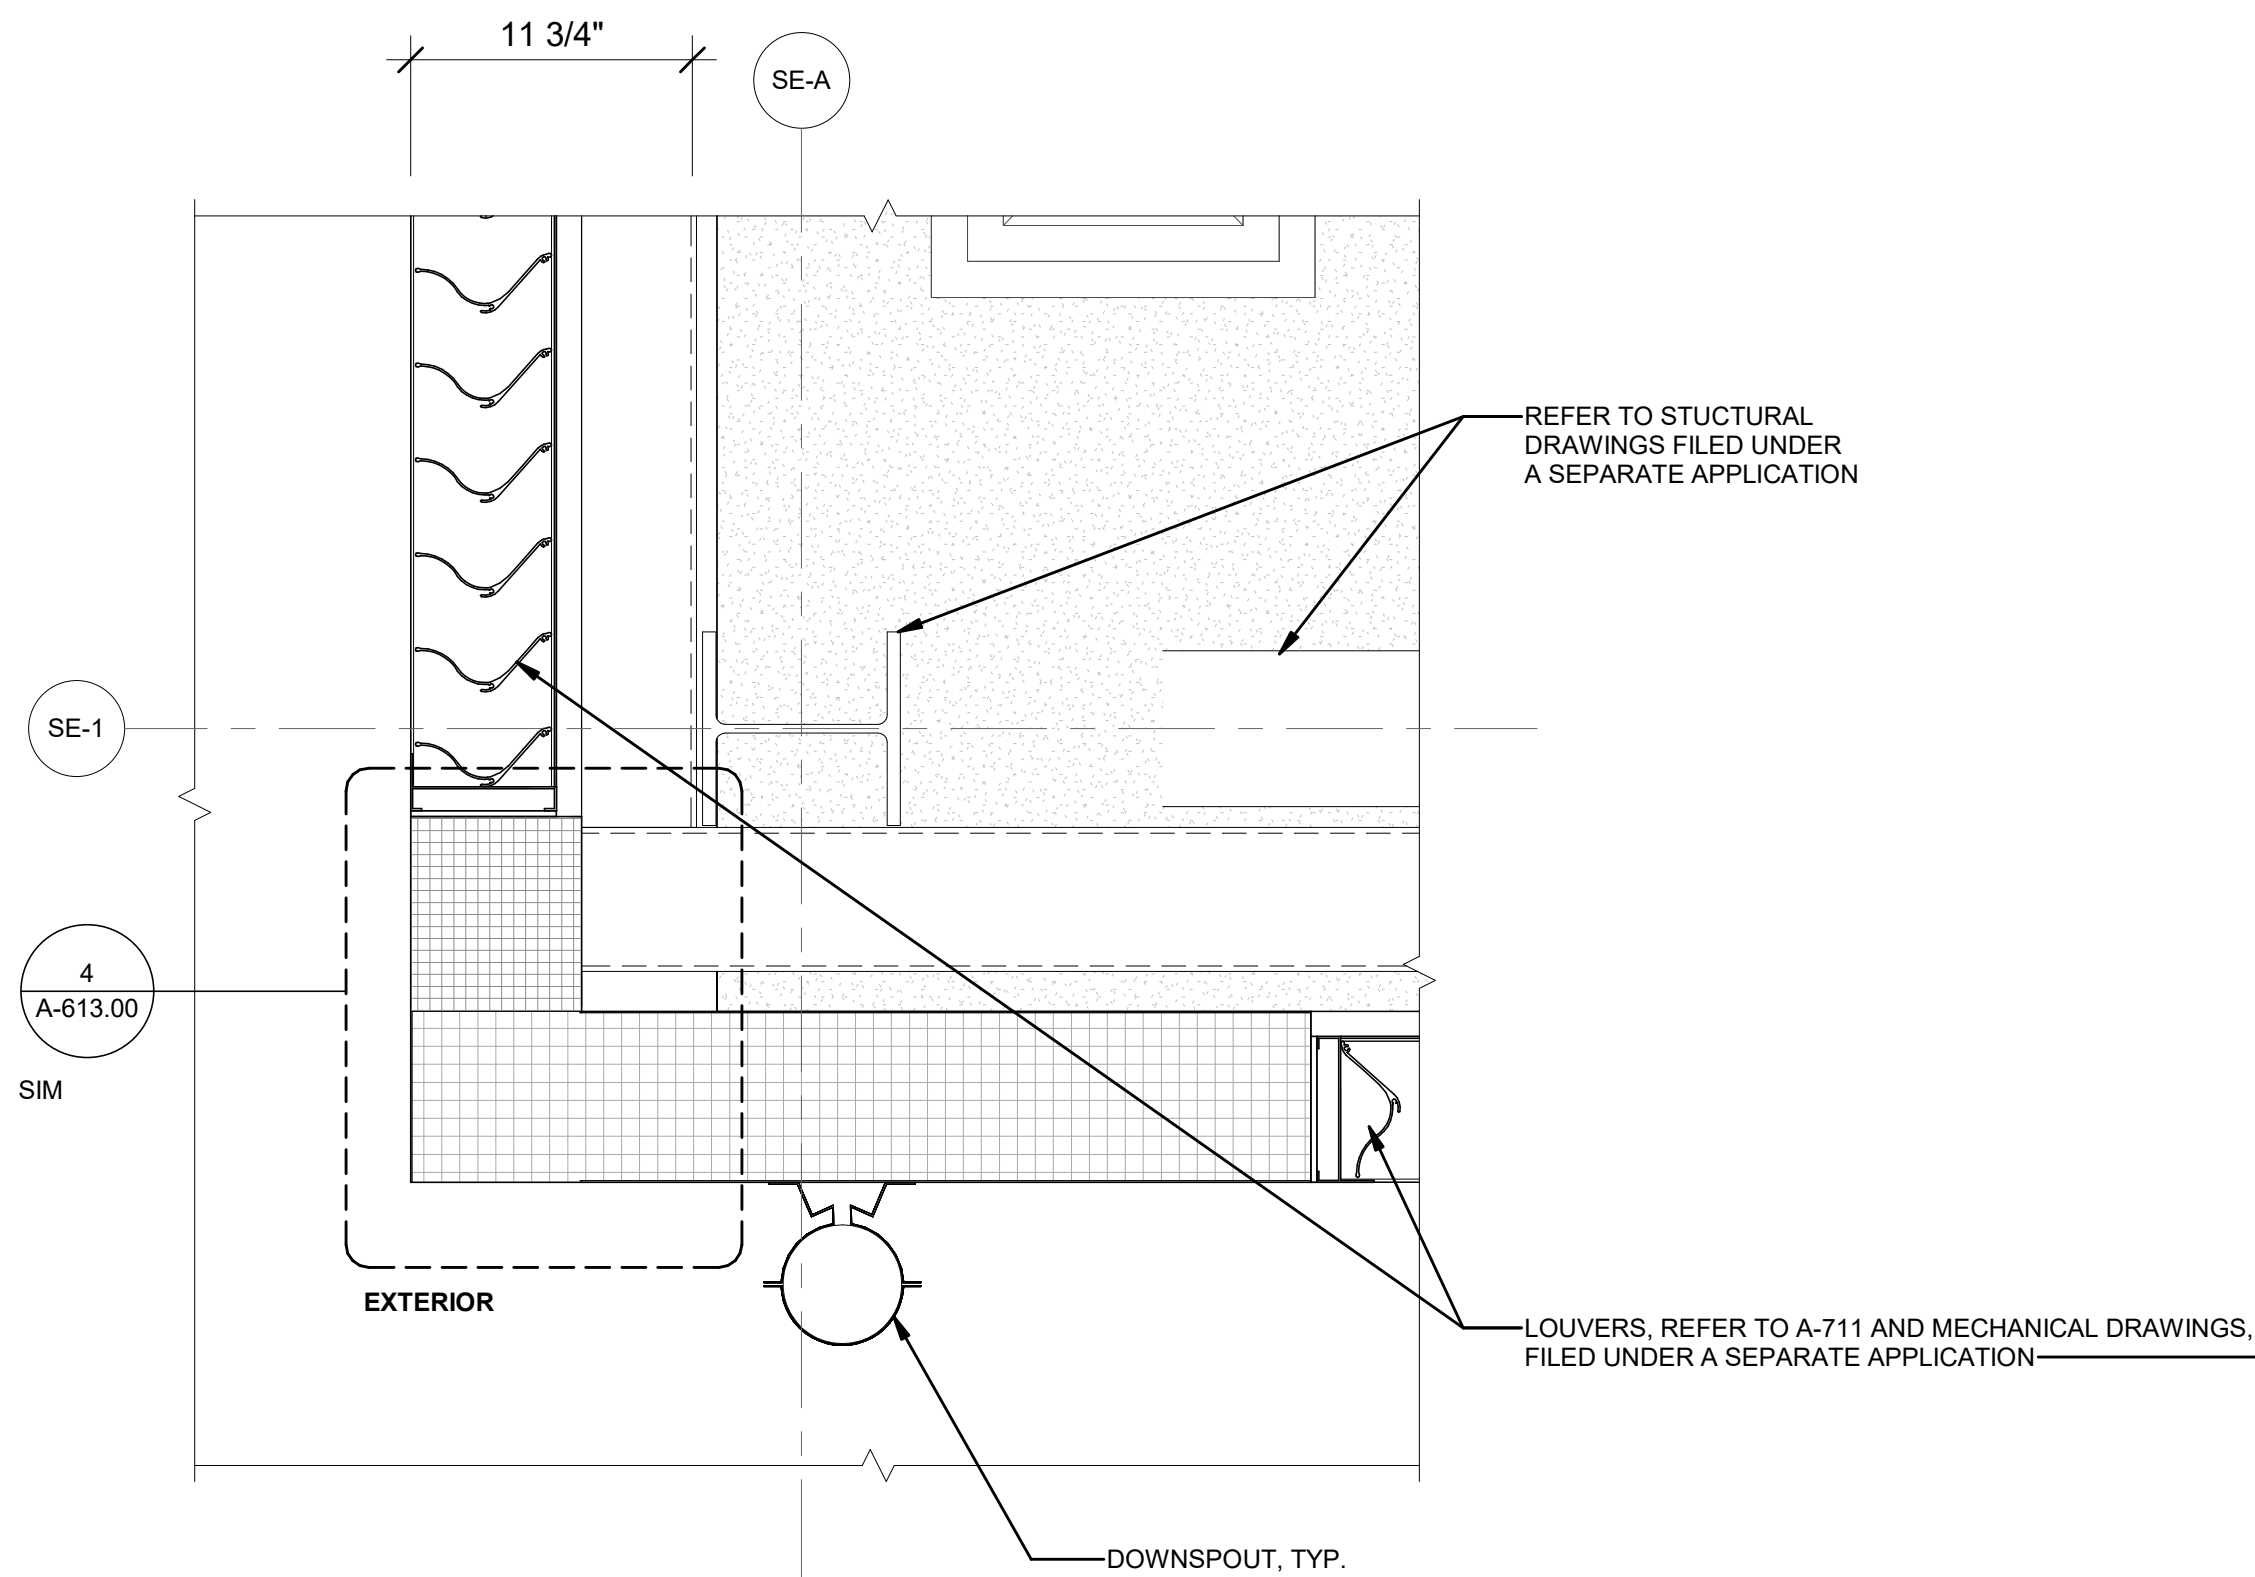


3
A-110.00 PLAN DETAIL 7 - SERVICE BLDG. SECOND FLOOR
1 1/2" = 1'-0"

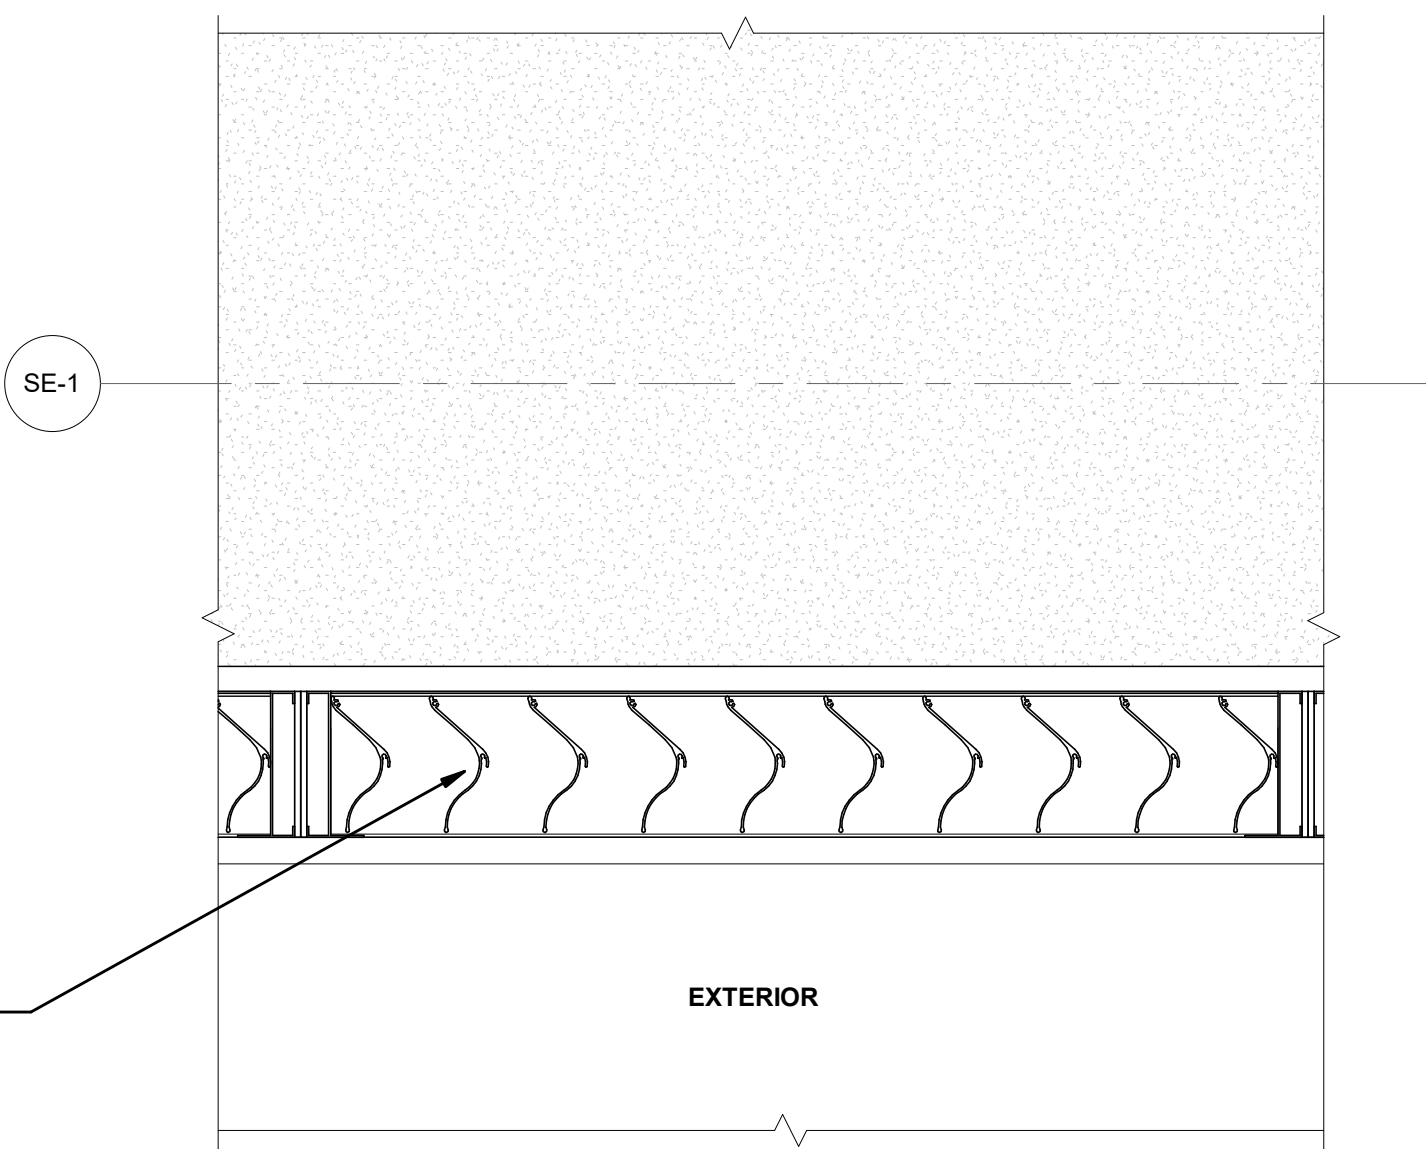

4
A-110.00 PLAN DETAIL 8 - SERVICE BLDG. SECOND FLOOR
1 1/2" = 1'-0"

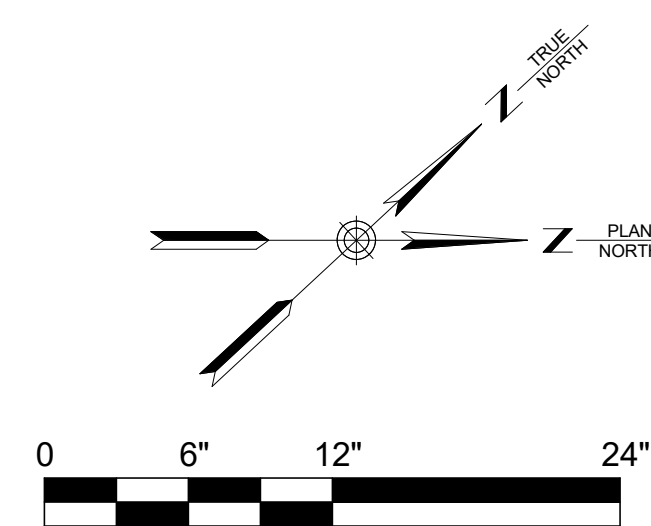

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Kiewit
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Woodcliff Lake, NJ 07677

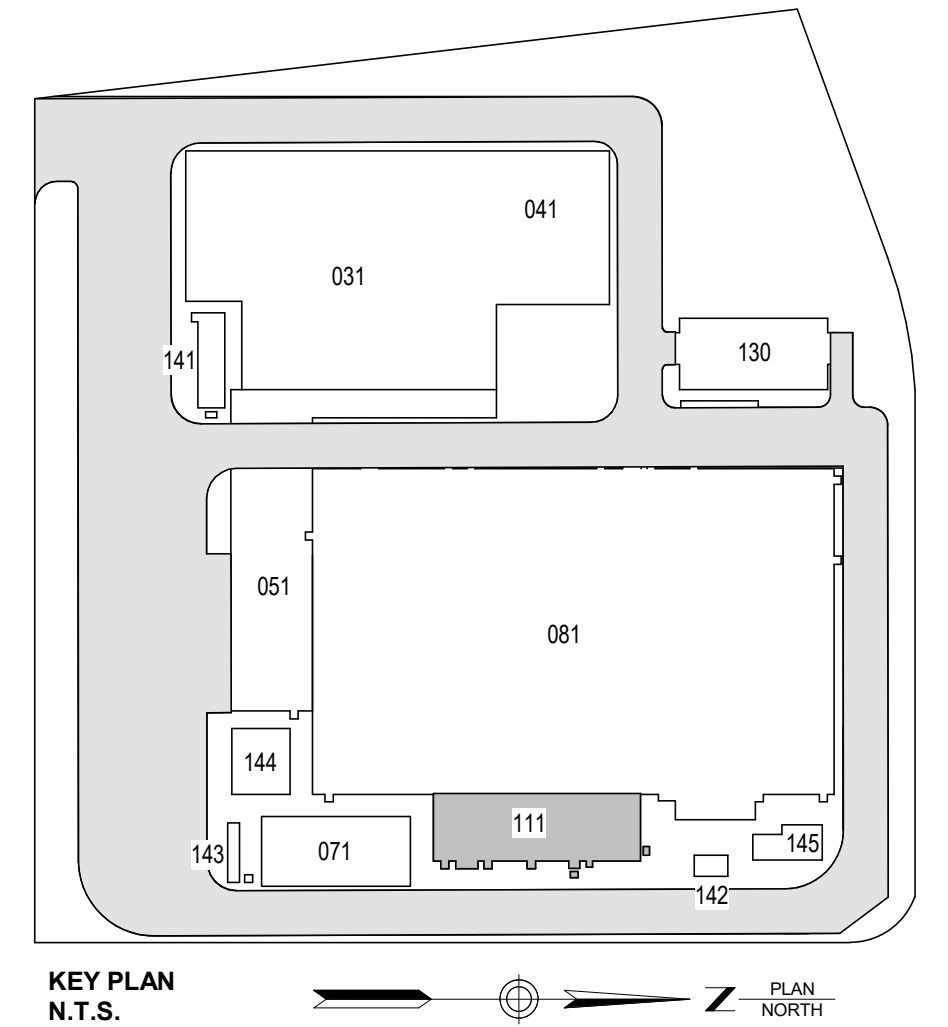Hitachi Energy
901 Main Campus Drive
Raleigh, North Carolina 27606

PROJECT


CHPE
Champlain Hudson
Power Express

Astoria HVDC Converter Station
31-45 20th Avenue, Astoria, Queens NY 11105
Block #850 - Lot #310 - BIN #4624437


PLAN DETAILS 8

REGISTERED ARCHITECT
SUZANNE SOWINSKI SULLIVAN
STATE OF NEW YORK
026049


DATE: 12/12/22
PROJECT NO: 105121
DRAWING BY: R. COLES
CHECKED BY: Z. HARR
DRAWING NO:
A-611.00
CADD FILE NO:
AstoriaHVDC-CHPE
AstoriaCHPE-111-ZZ-M3-A-001.rvt

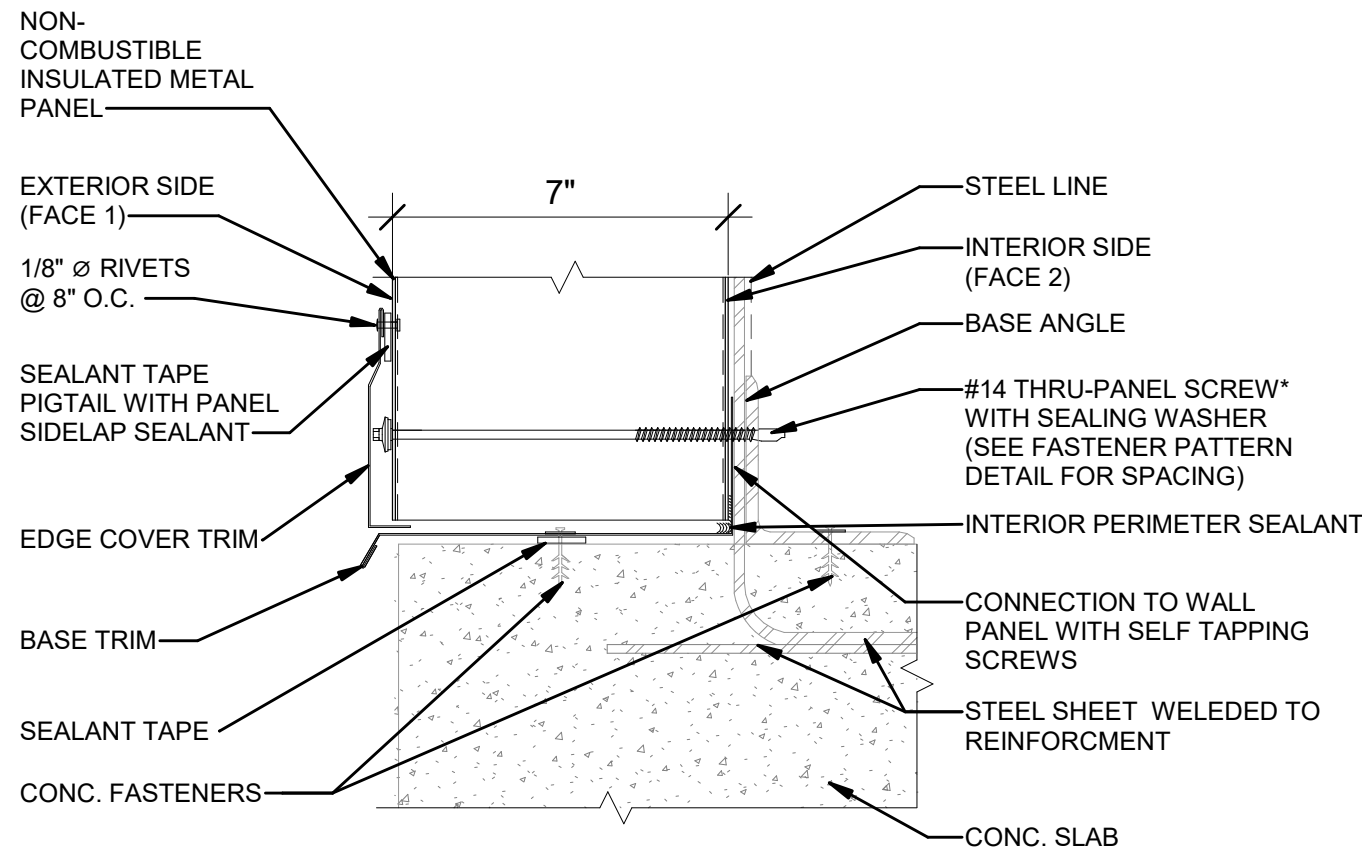


1 BASE DETAIL-BASE ANGLE VERTICAL THERMSAFE PANEL
3" = 1'-0"

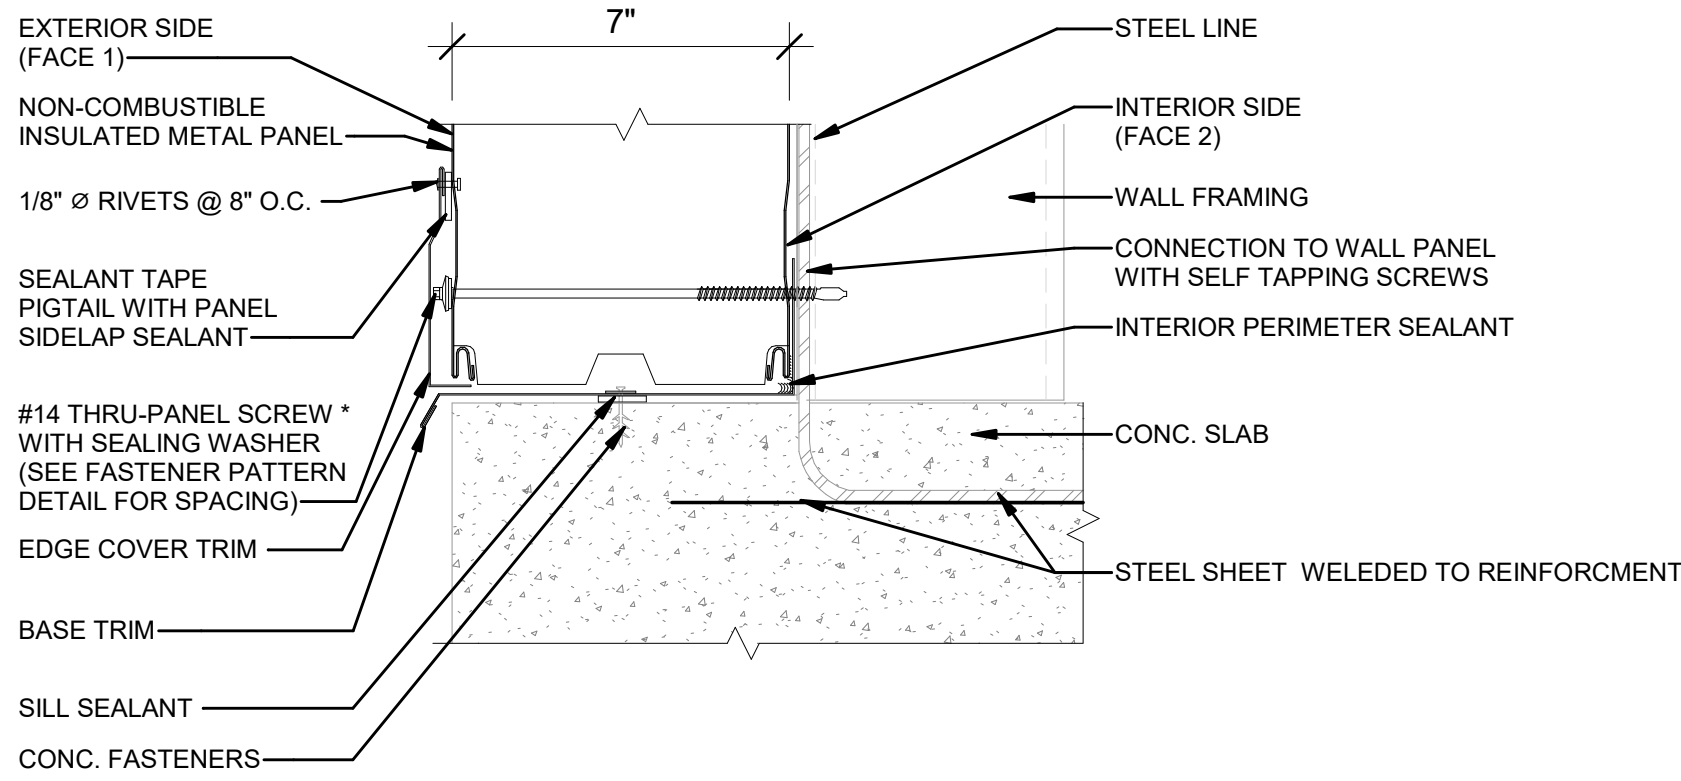


2 BASE DETAIL HORIZONTAL THERMSAFE PANEL
3" = 1'-0"

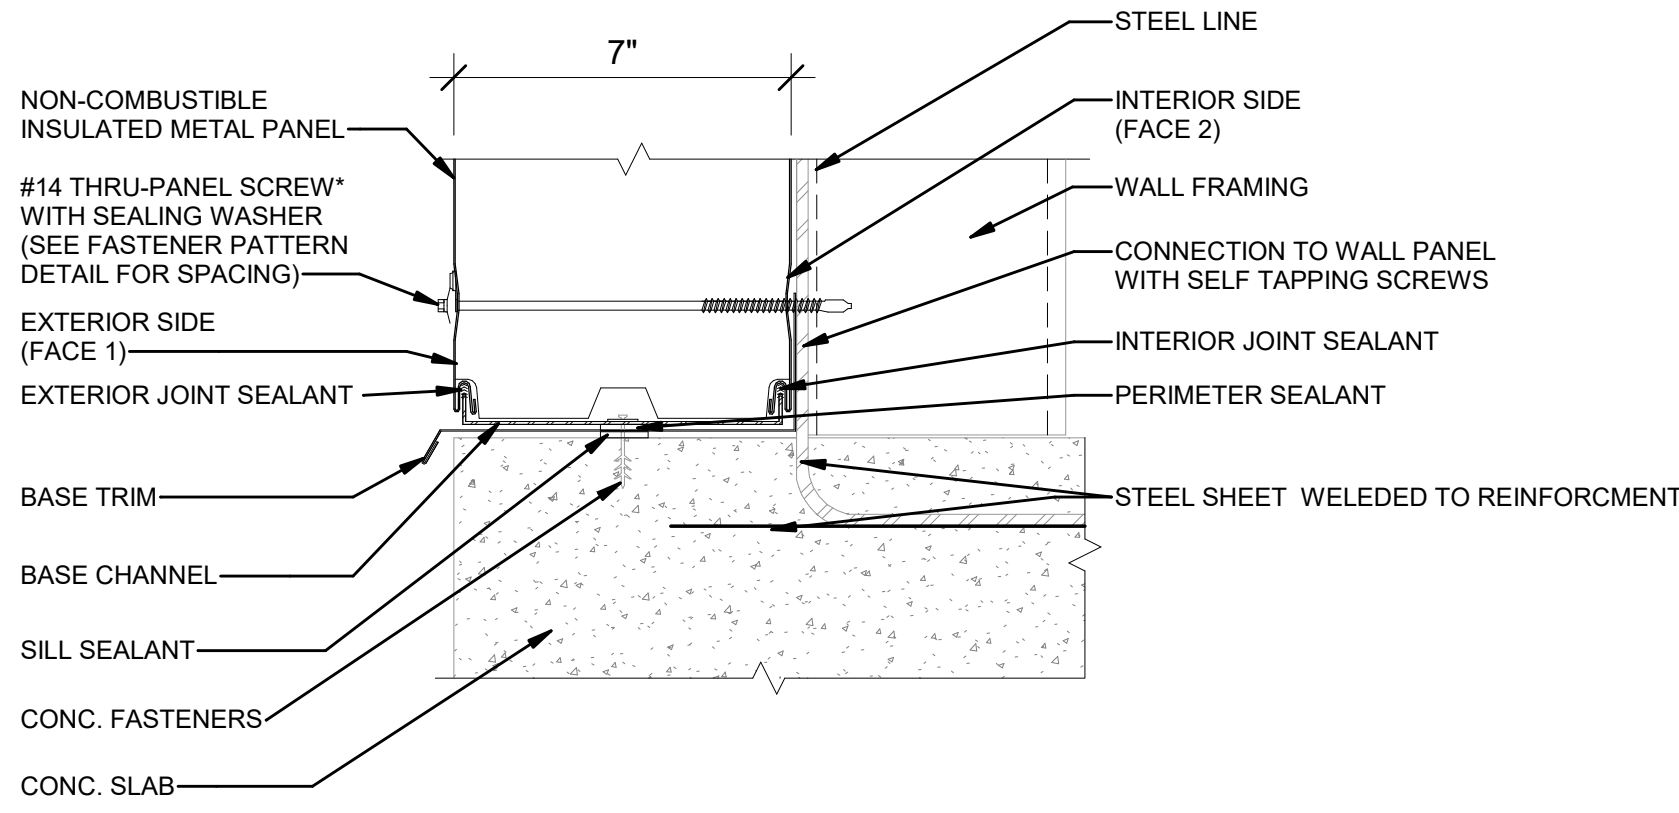


3 BASE DETAIL- BASE CHANNEL HORIZONTAL THERMSAFE PANEL
3" = 1'-0"

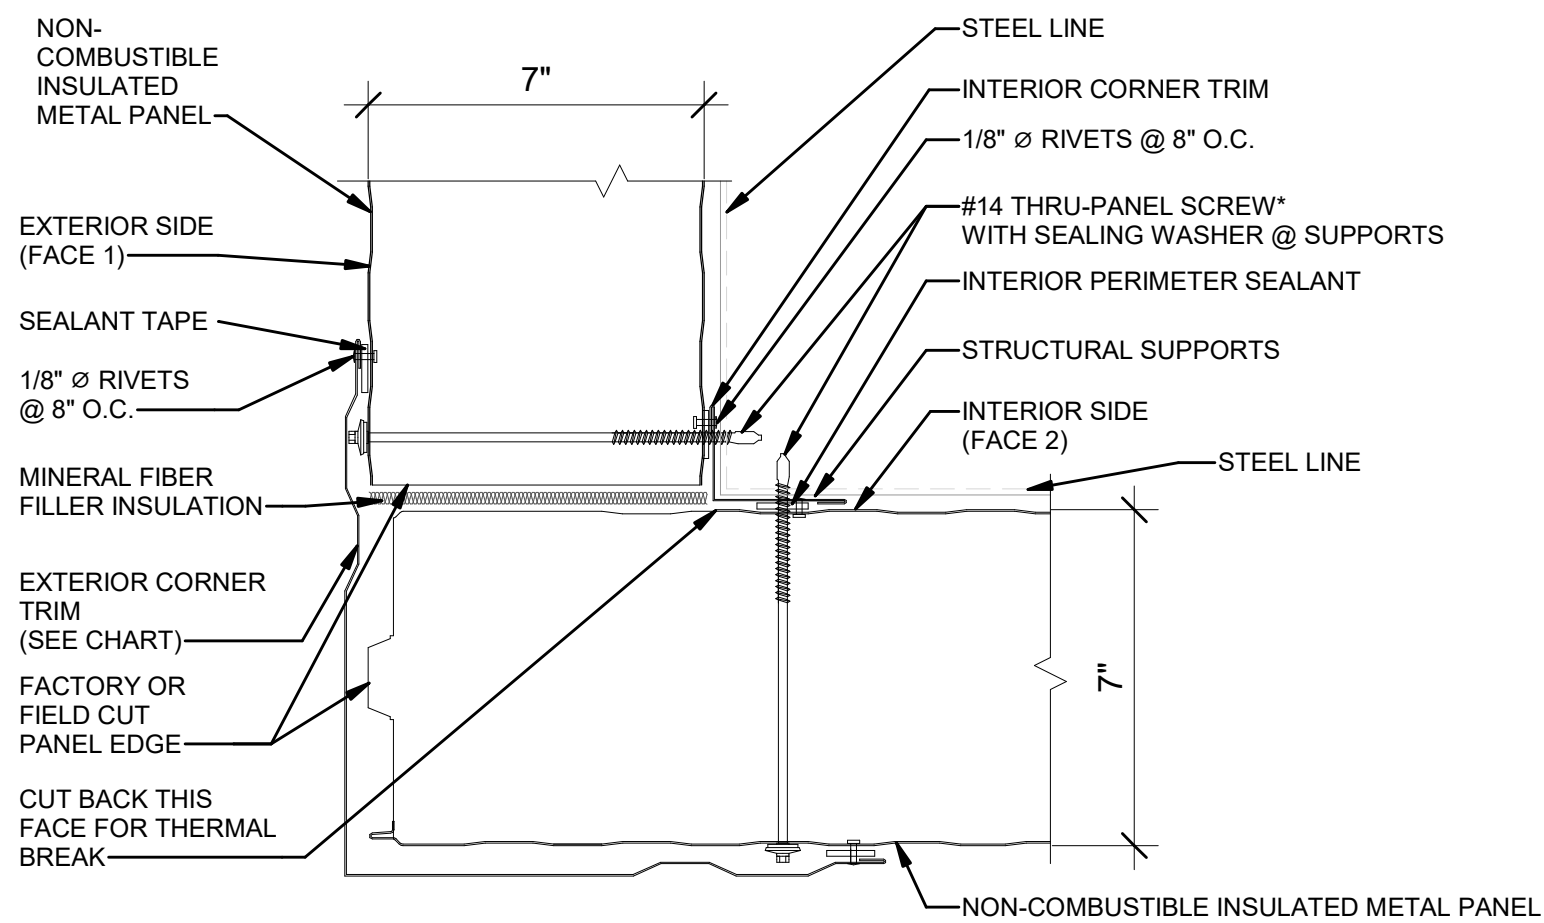


4 OUTSIDE CORNER VERTICAL THERMSAFE PANEL
A-604.00 3" = 1'-0"

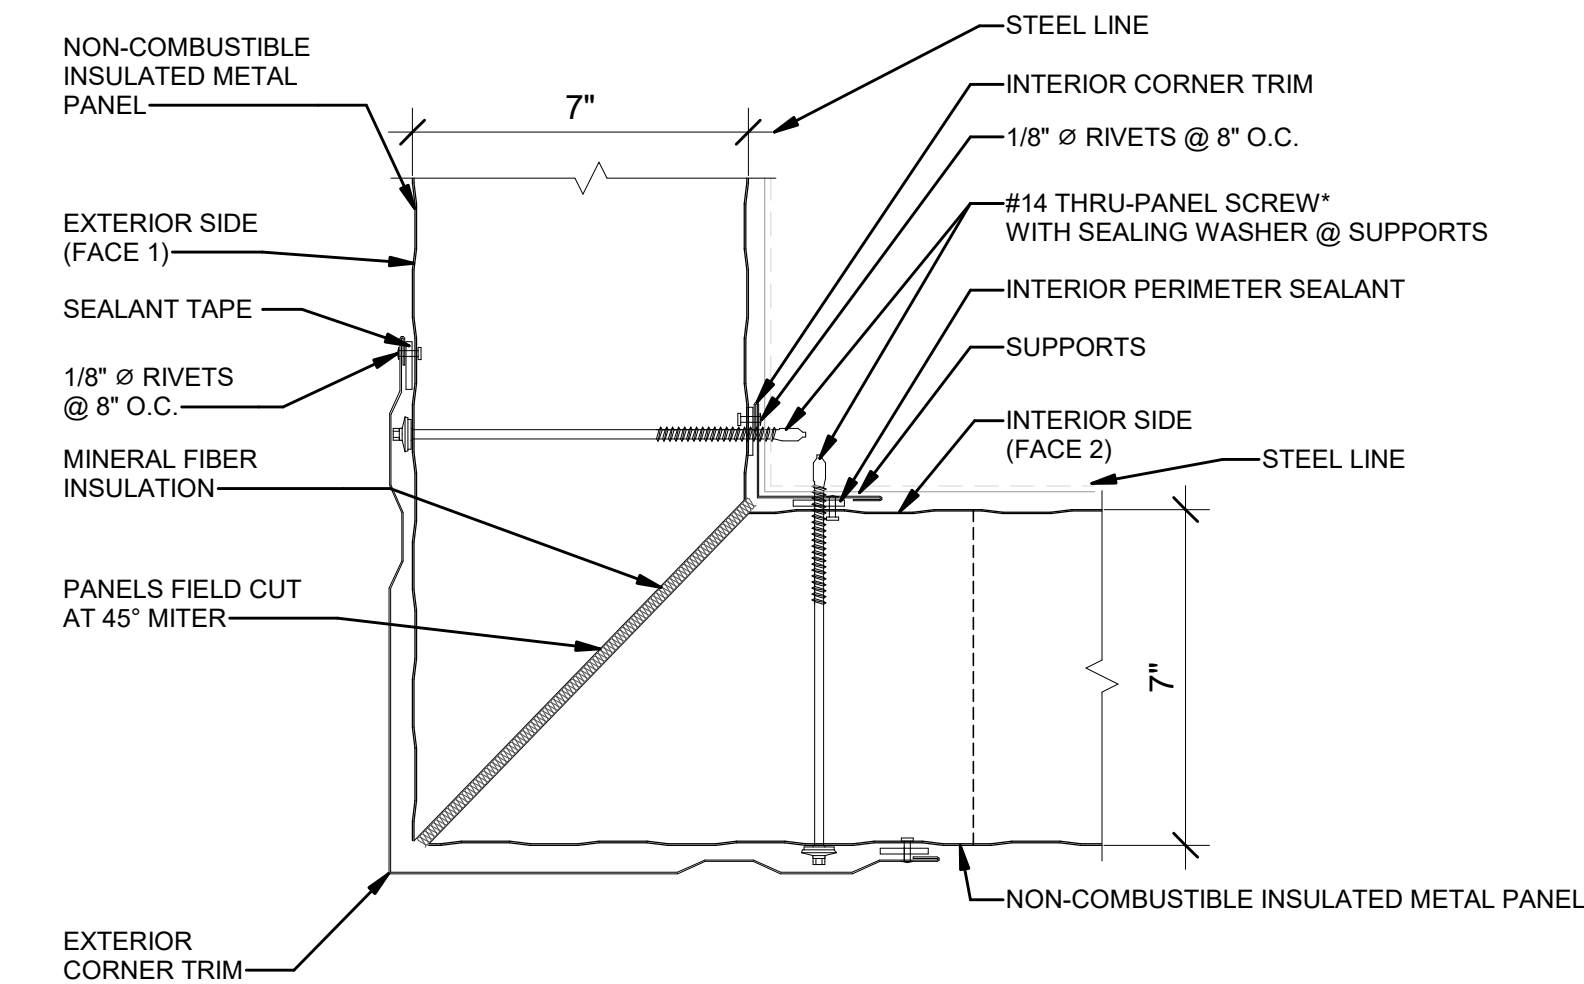


5 OUTSIDE CORNER - MITERED VERTICAL THERMSAFE PANEL
3" = 1'-0"

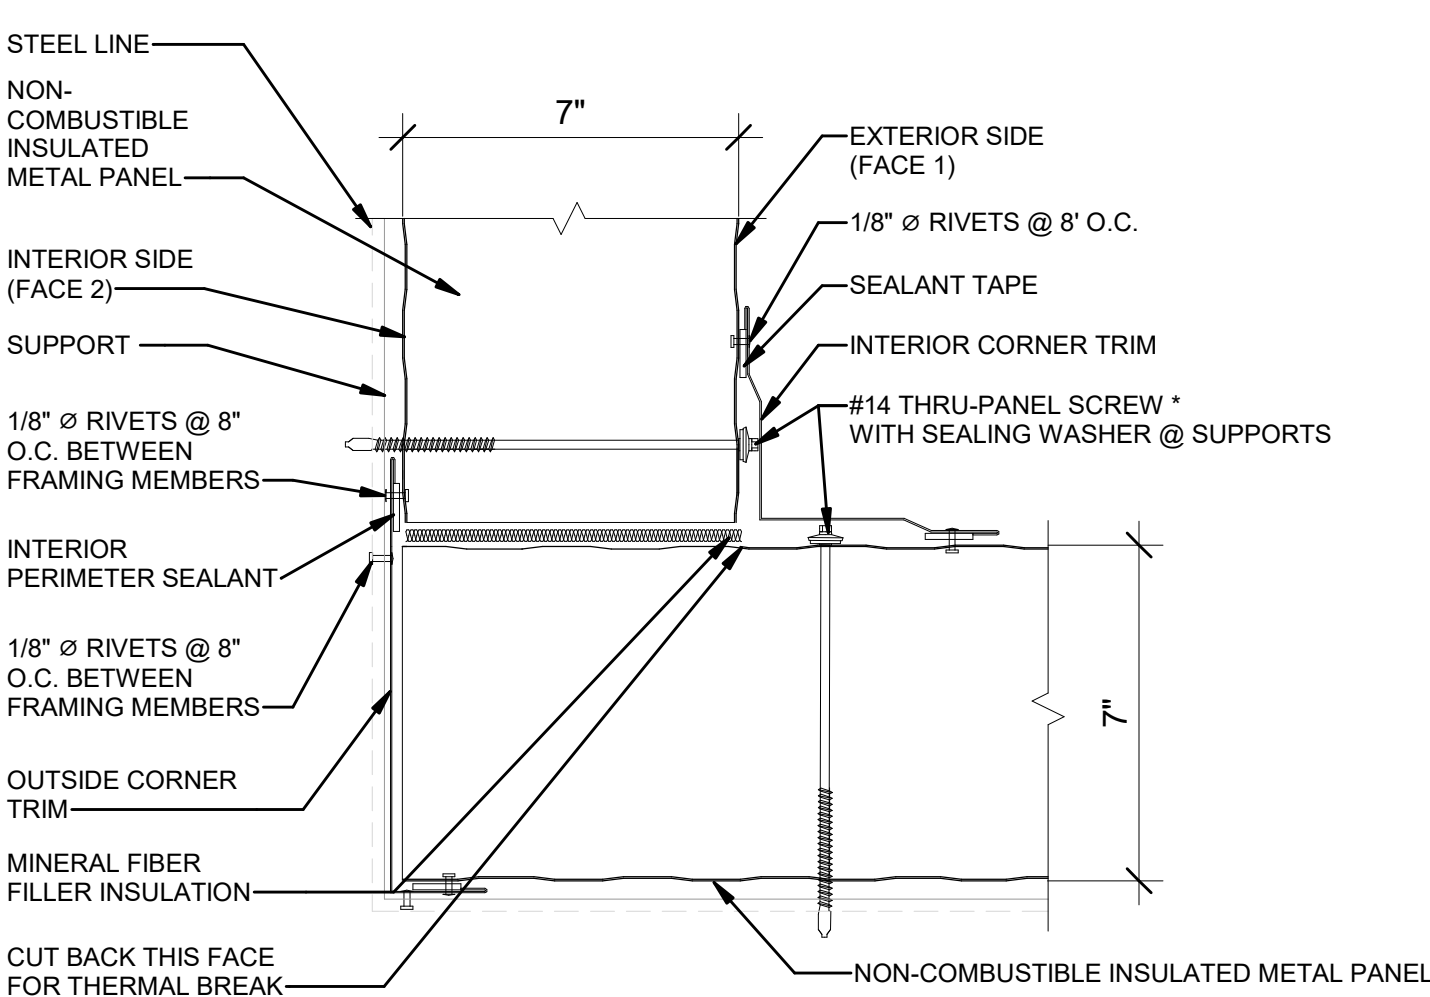


6 INSIDE CORNER VERTICAL THERMSAFE PANEL
A-604.00 3" = 1'-0"

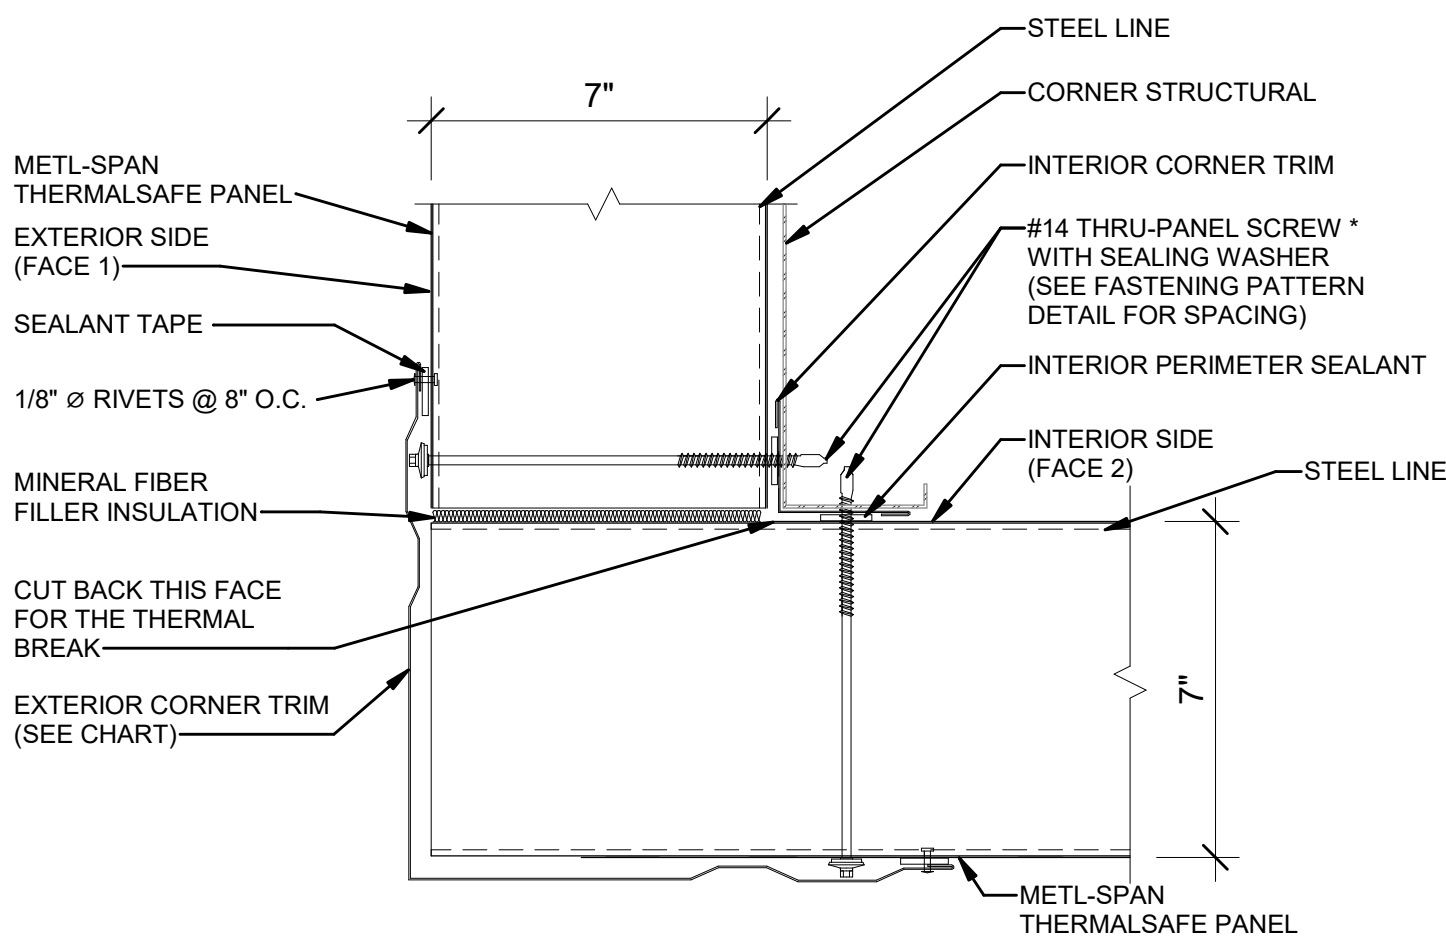


7 OUTSIDE CORNER HORIZONTAL THERMSAFE PANEL
3" = 1'-0"

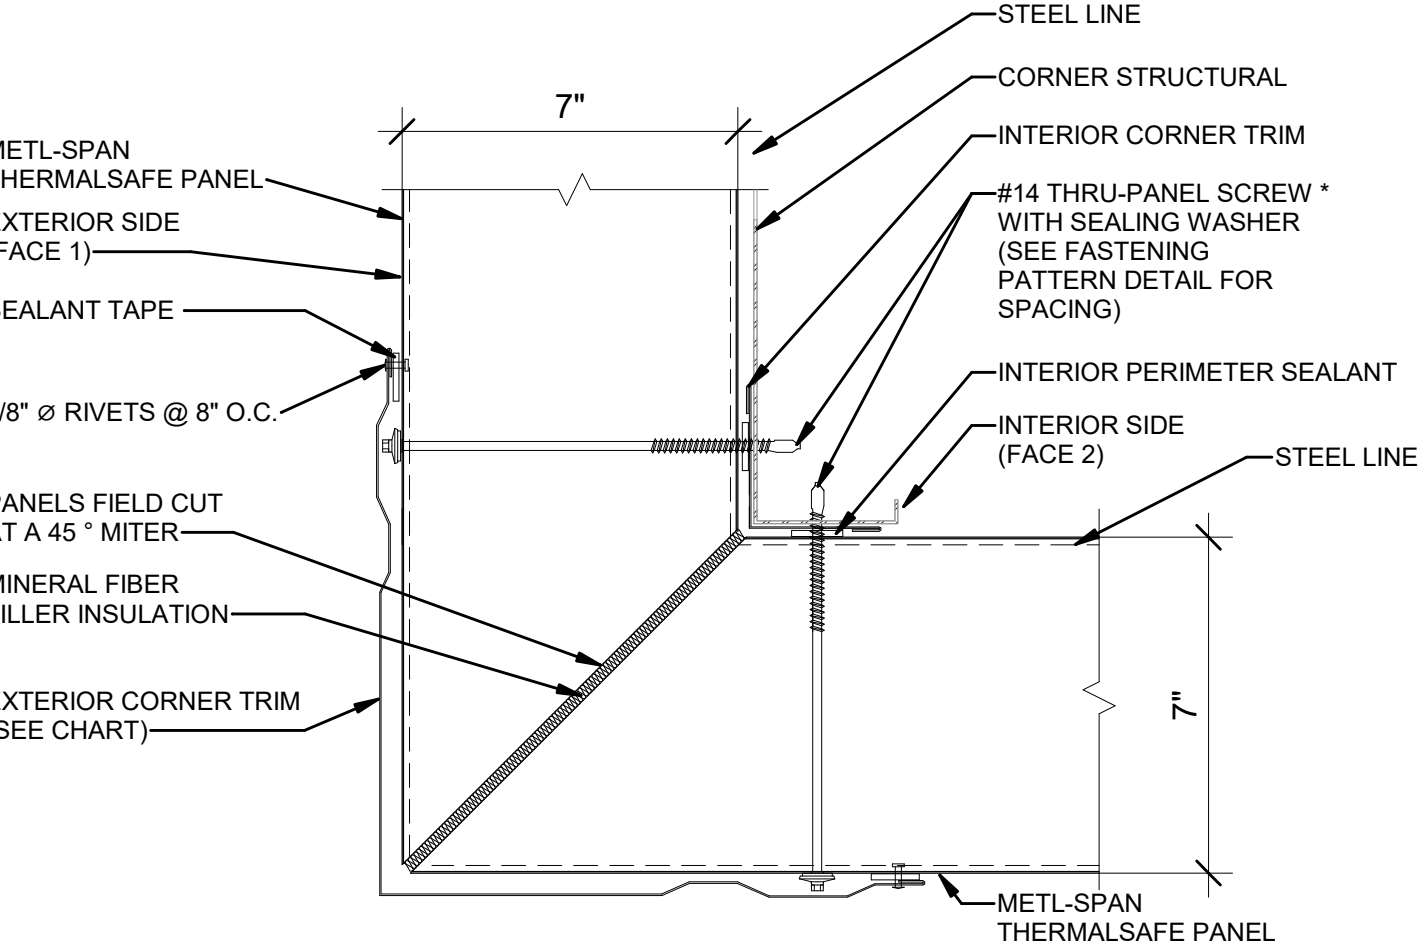

8 OUTSIDE CORNER - MITERED HORIZONTAL THERMSAFE PANEL
3" = 1'-0"

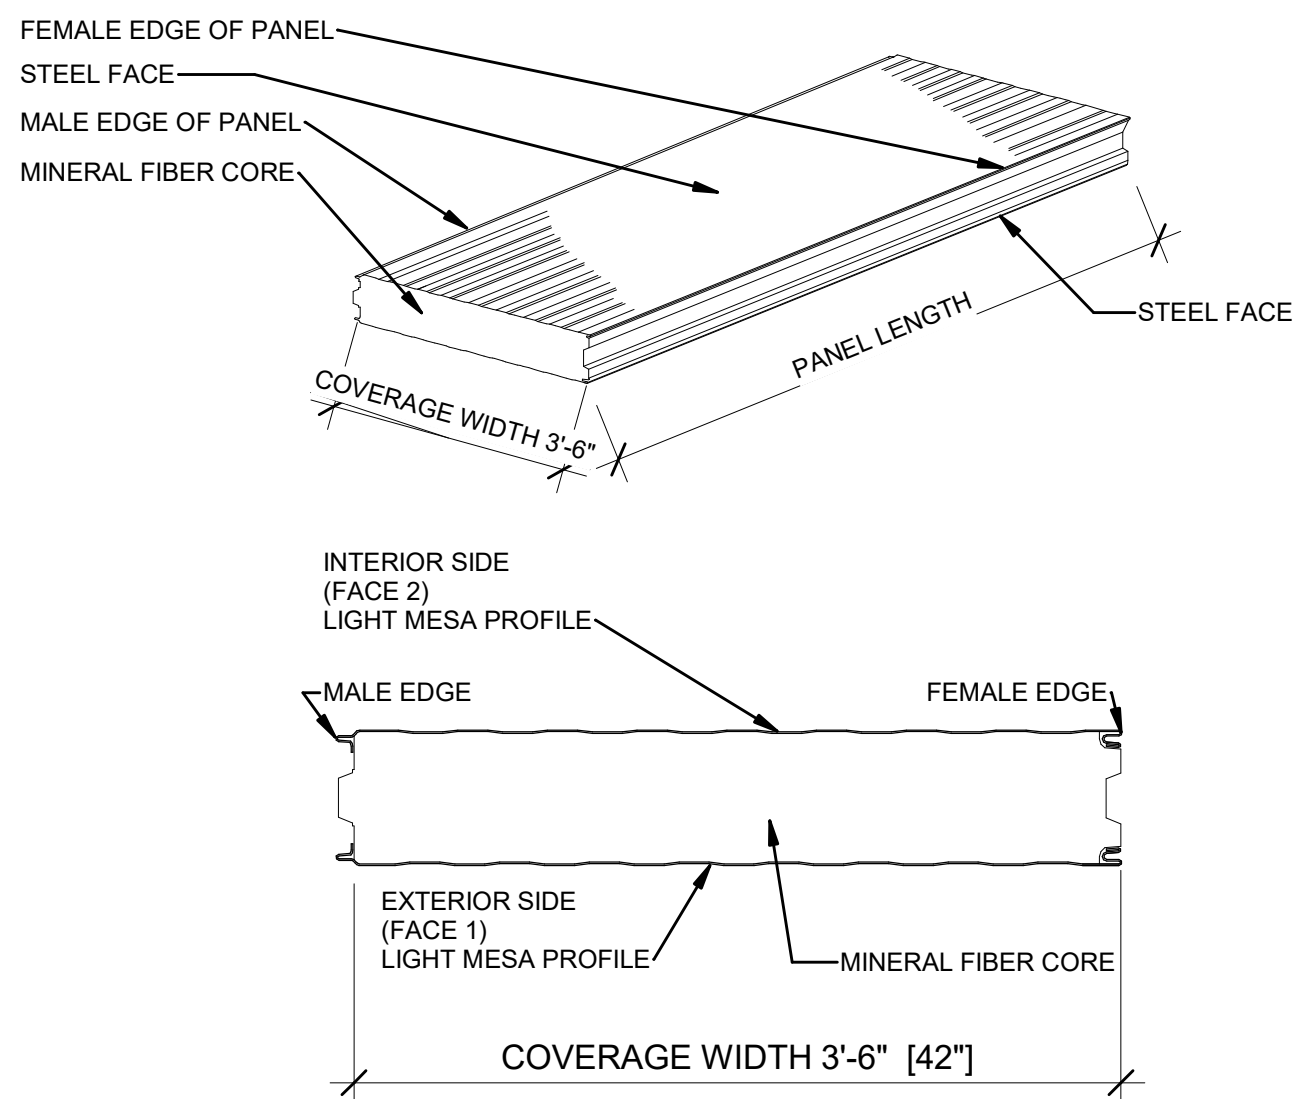

9 CROSS SECTION THERMSAFE PANEL
3" = 1'-0"

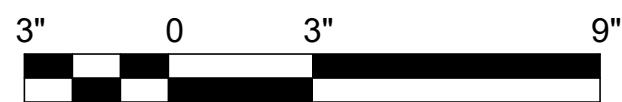

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Kiewit
470 Chestnut Ridge Rd # 2,
Woodcliff Lake, NJ 07677

Hitachi Energy
901 Main Campus Drive
Raleigh, North Carolina 27606

PROJECT



CHPE
Champlain Hudson Power Express

Astoria HVDC Converter Station
31-45 20th Avenue, Astoria, Queens NY 11105
Block #850 - Lot #310 - BIN #4624437

MISCELLANEOUS DETAILS
1


REGISTERED ARCHITECT
SUZANNE SOWINSKI SULLIVAN
STATE OF NEW YORK
026049

DATE: 12/12/22
PROJECT NO: 105121
DRAWING BY: R. COLES
CHECKED BY: Z. HARR
DRAWING NO: **A-613.00**
CADD FILE NO: Astoria CHA-KIE-111-22-M3-A-001.rvt

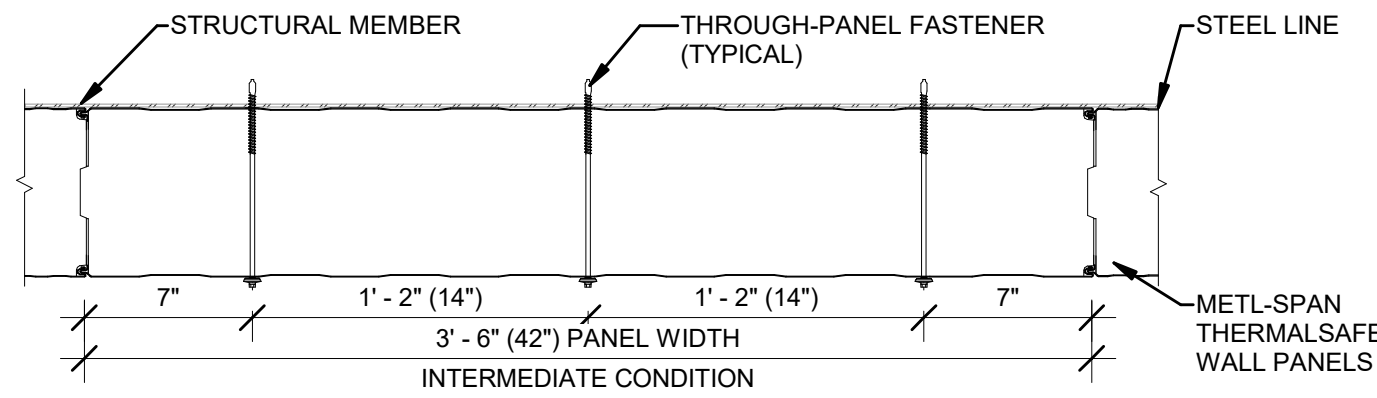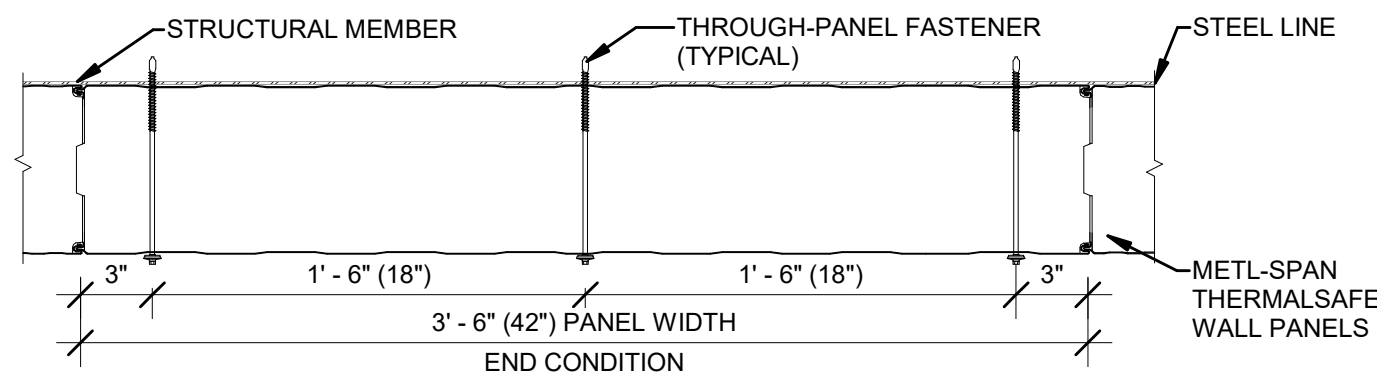


NOTE: FASTENER PATTERN TO BE DETERMINED PER SPECIFIC PROJECT DESIGN REQUIREMENTS.

1 FASTENER PATTERNS TSFP1 VERTICAL THERMSAFE PANEL
1 1/2" = 1'-0"

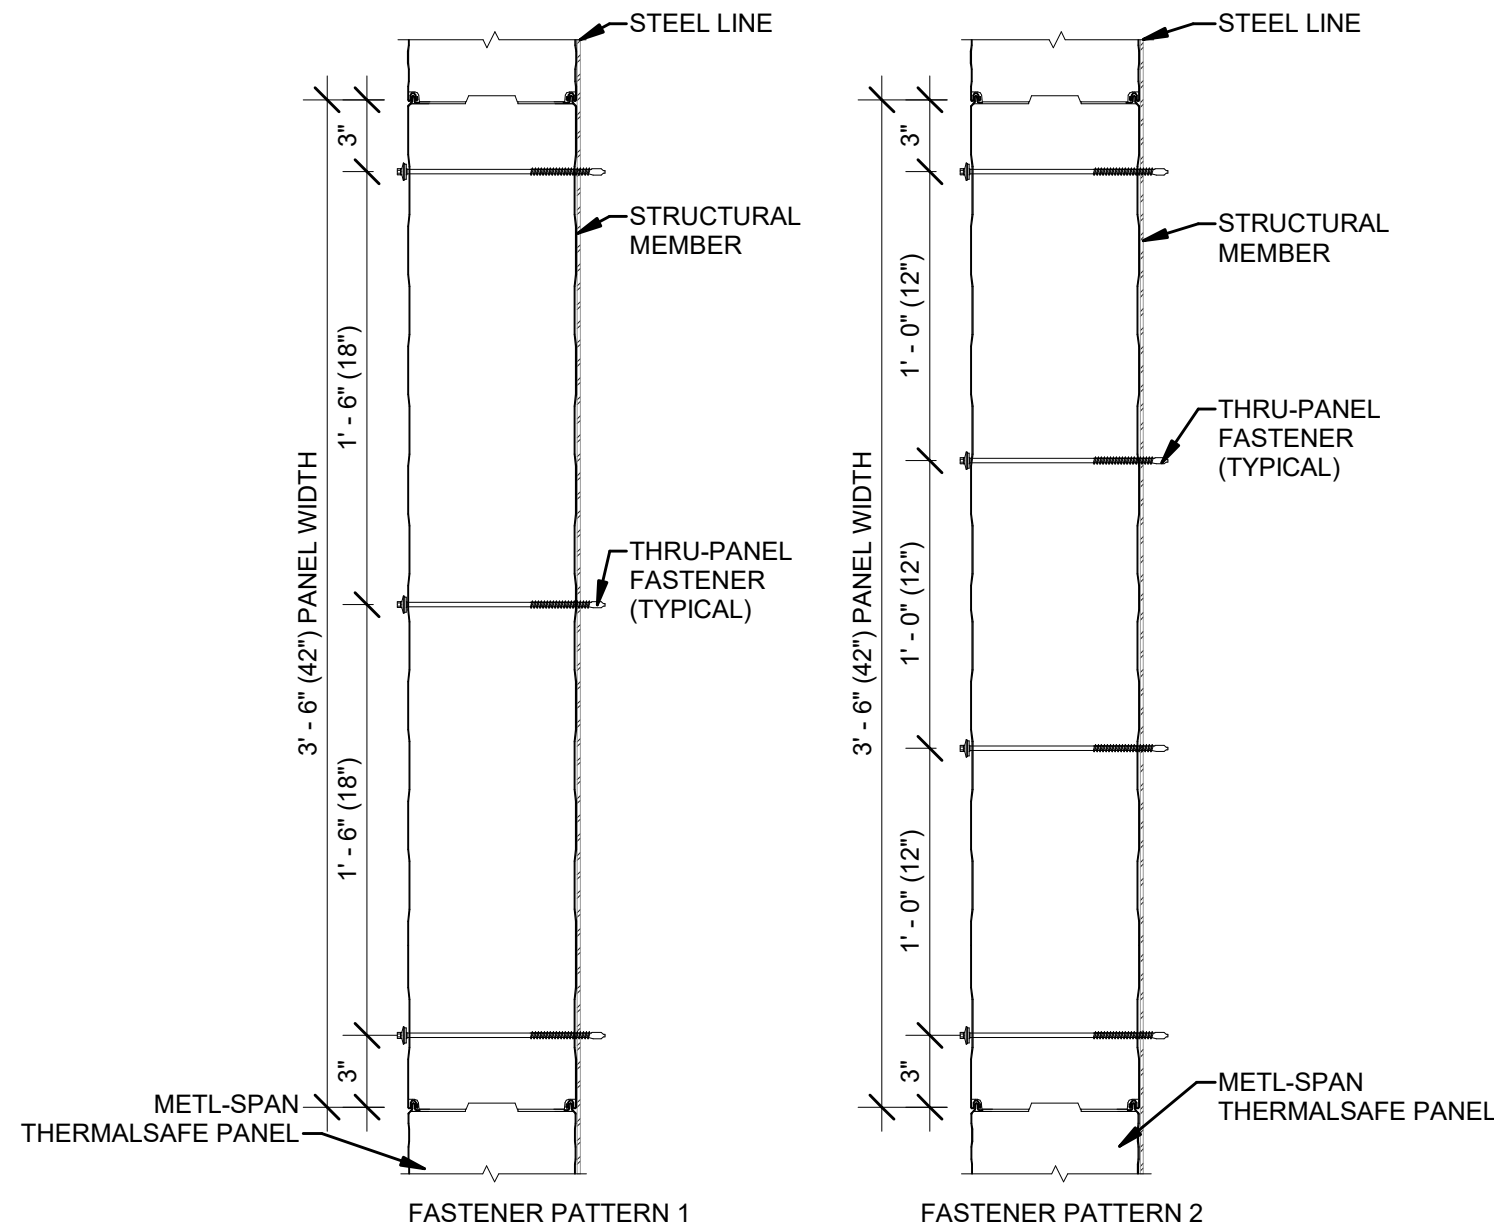


NOTE: FASTENER PATTERN TO BE DETERMINED PER SPECIFIC PROJECT DESIGN REQUIREMENTS.

4 FASTENER PATTERNS AT PANEL ENDS HORIZONTAL THERMSAFE PANEL
1 1/2" = 1'-0"

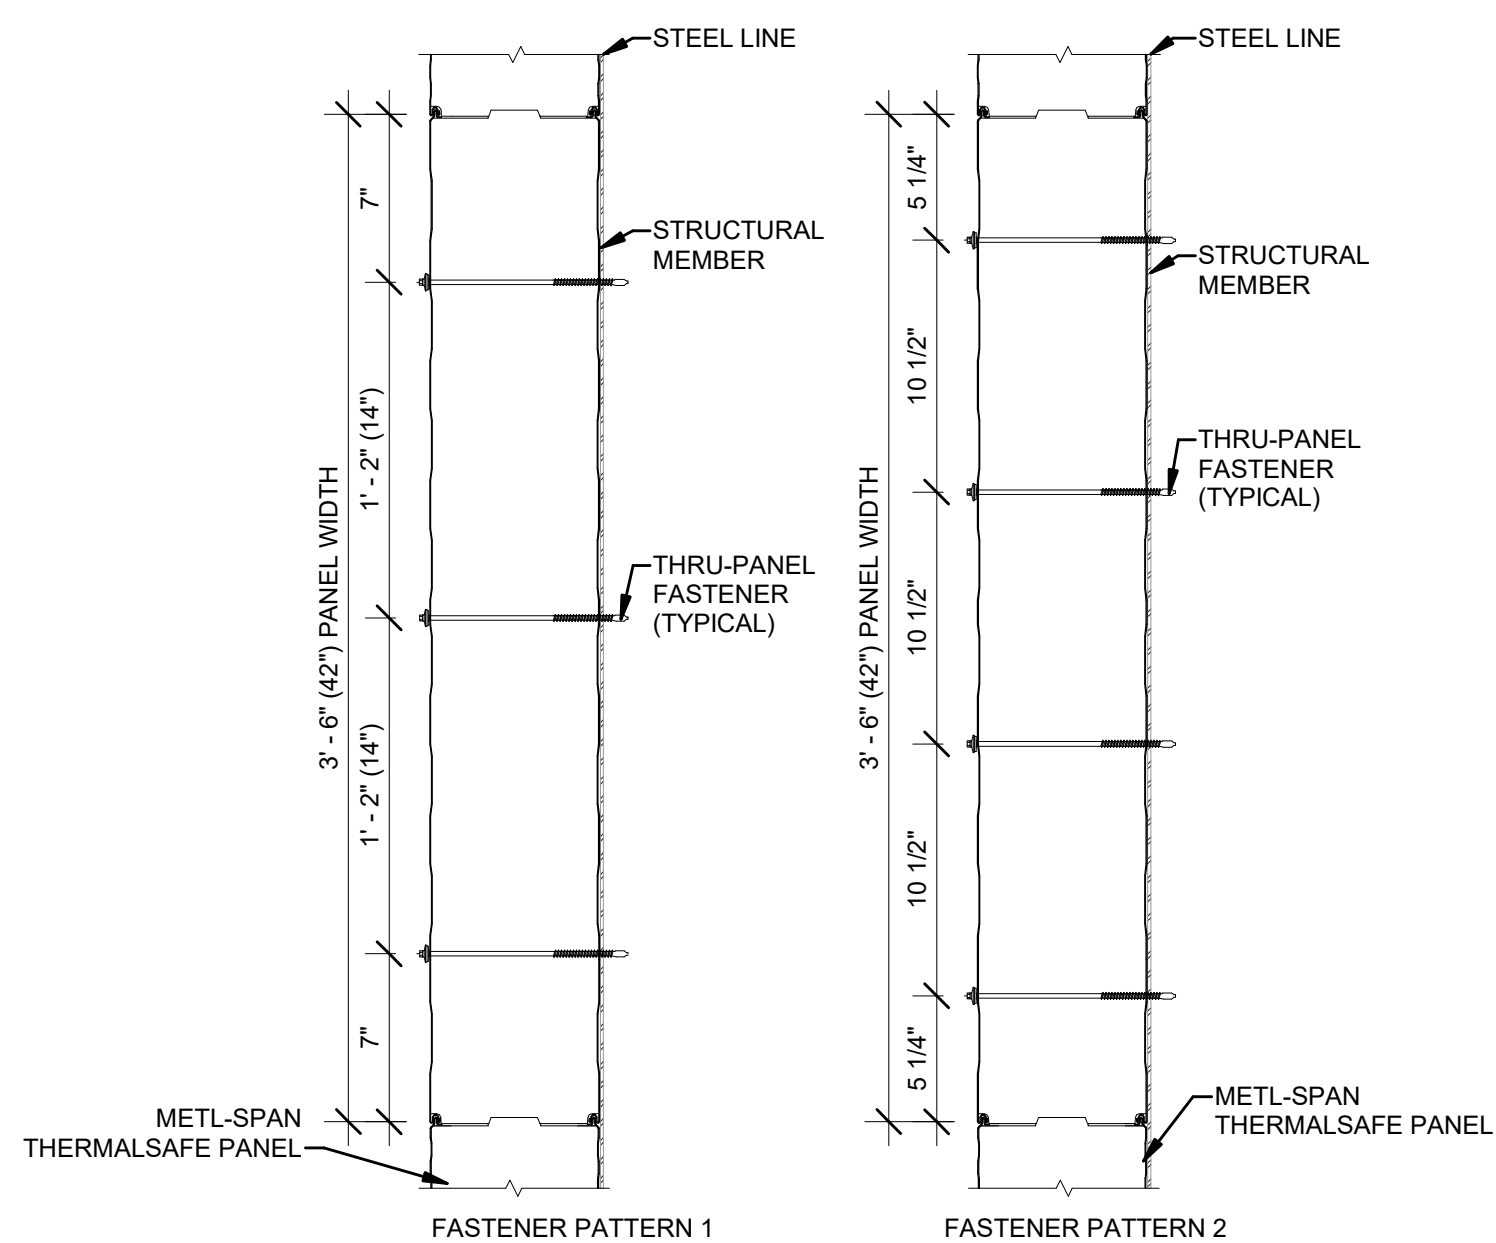


NOTE: FASTENER PATTERN TO BE DETERMINED PER SPECIFIC PROJECT DESIGN REQUIREMENTS.


5 INTERMEDIATE FASTENER PATTERNS FOR HORIZONTAL THERMSAFE PANEL
1 1/2" = 1'-0"

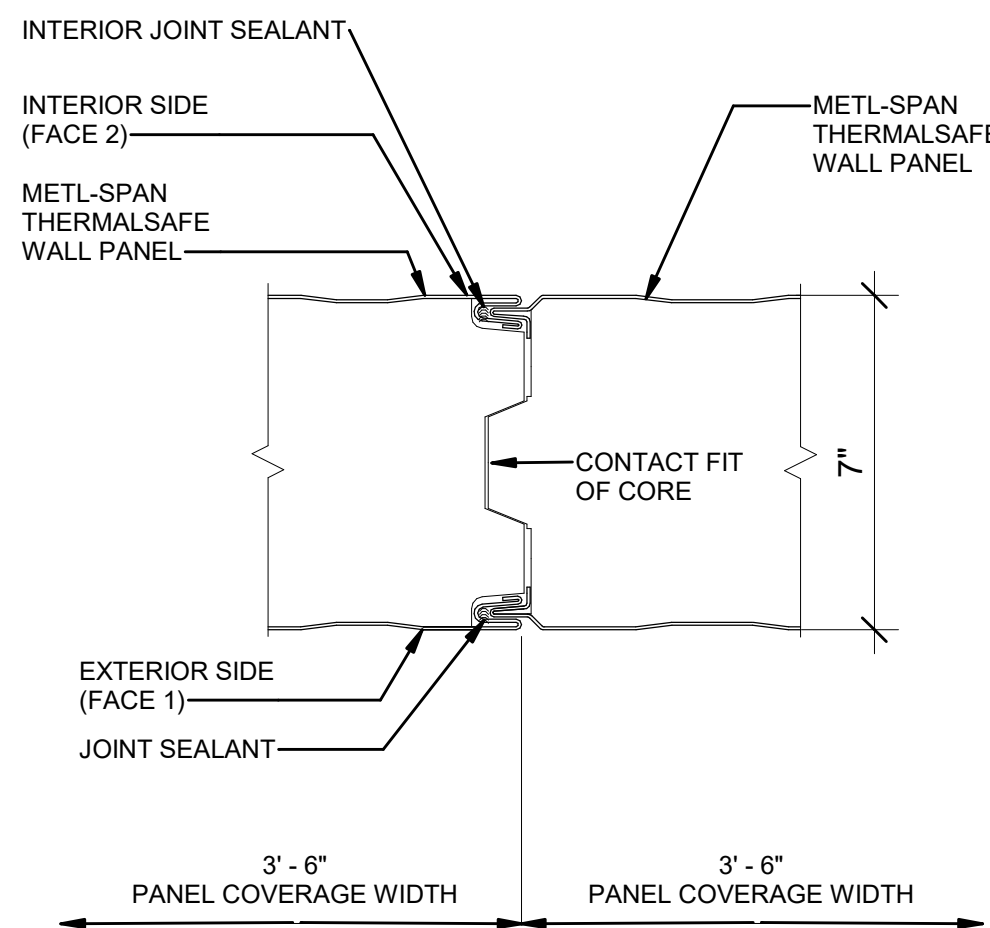


6 VERTICAL JOINT DETAIL THERMSAFE PANEL
3" = 1'-0"

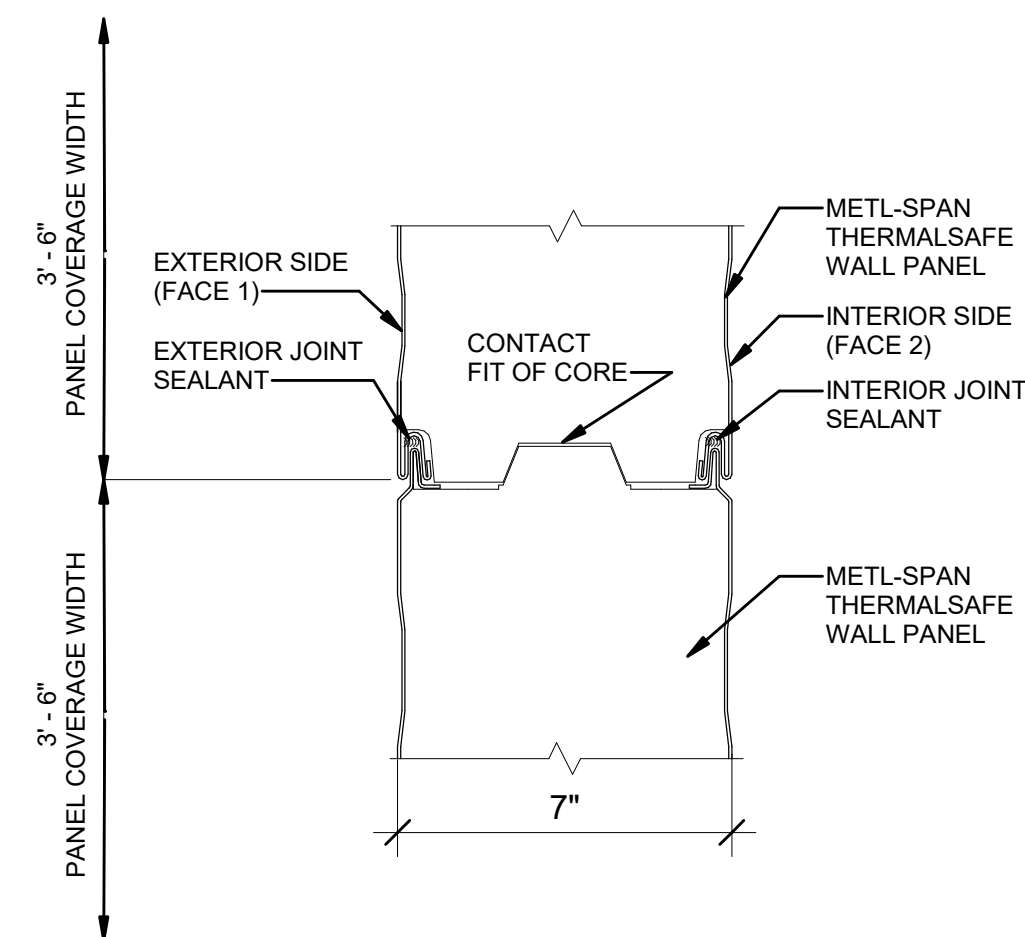


7 HORIZONTAL JOINT DETAIL THERMSAFE PANEL
3" = 1'-0"

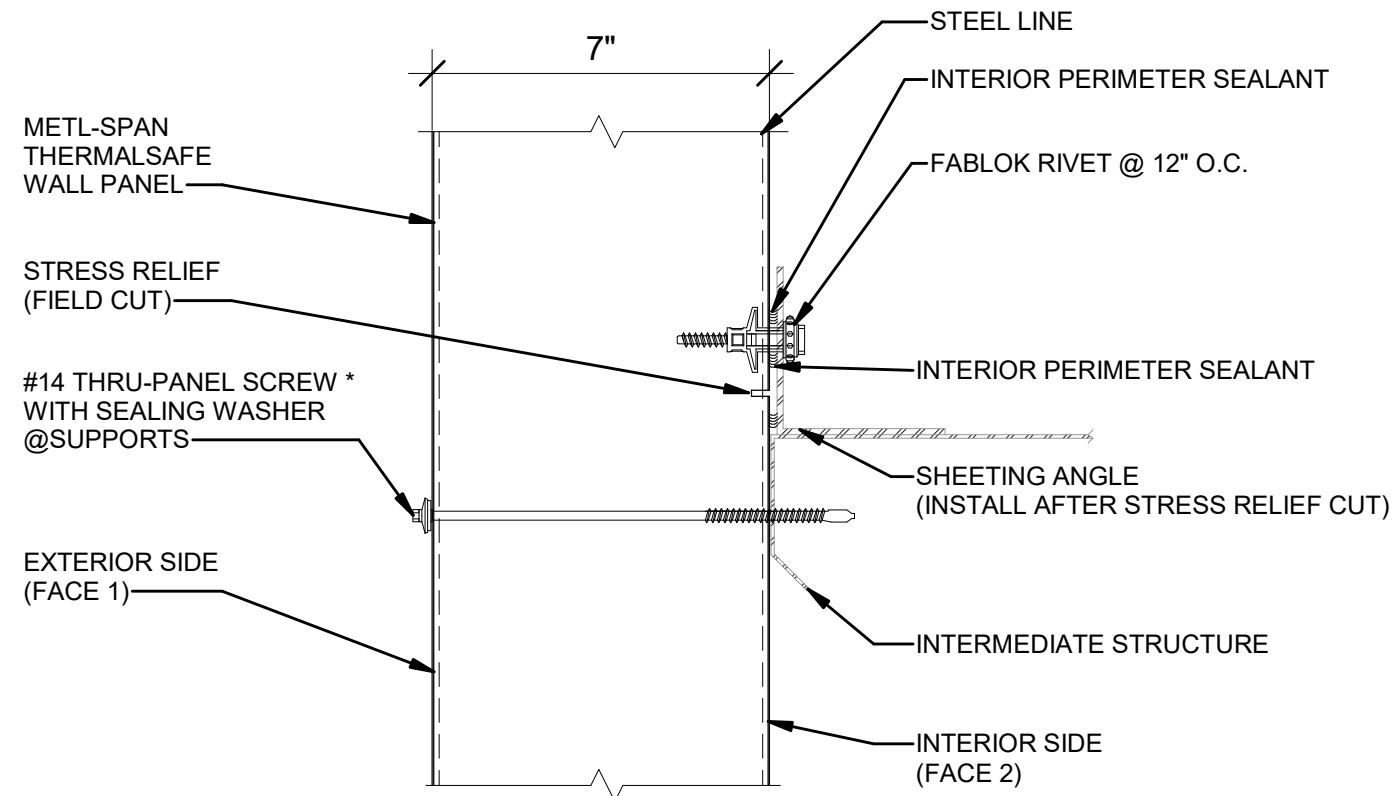

8 INTERMEDIATE FASTENER ATTACHMENT THERMAL STRESS RELIEF VERTICAL THERMSAFE PANEL
3" = 1'-0"

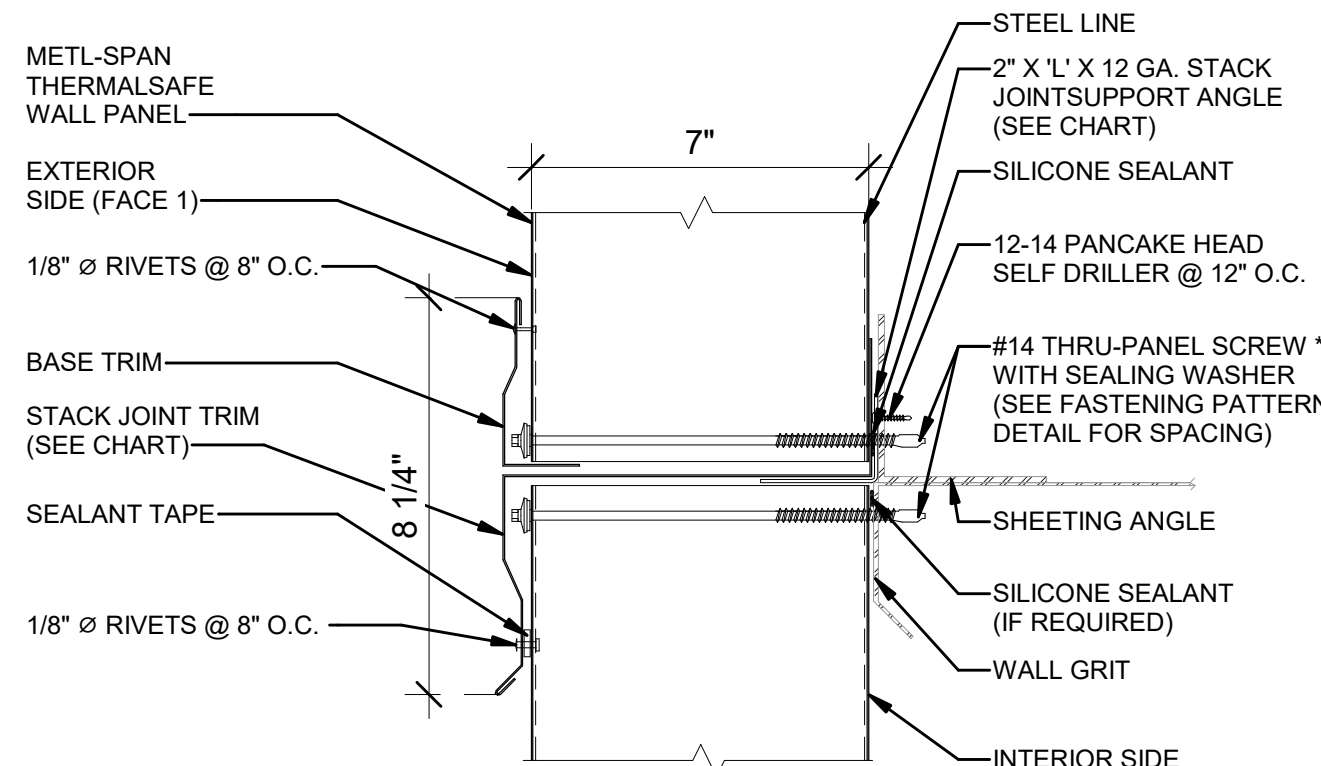

9 VERTICAL STACK JOINT THERMSAFE PANEL
3" = 1'-0"

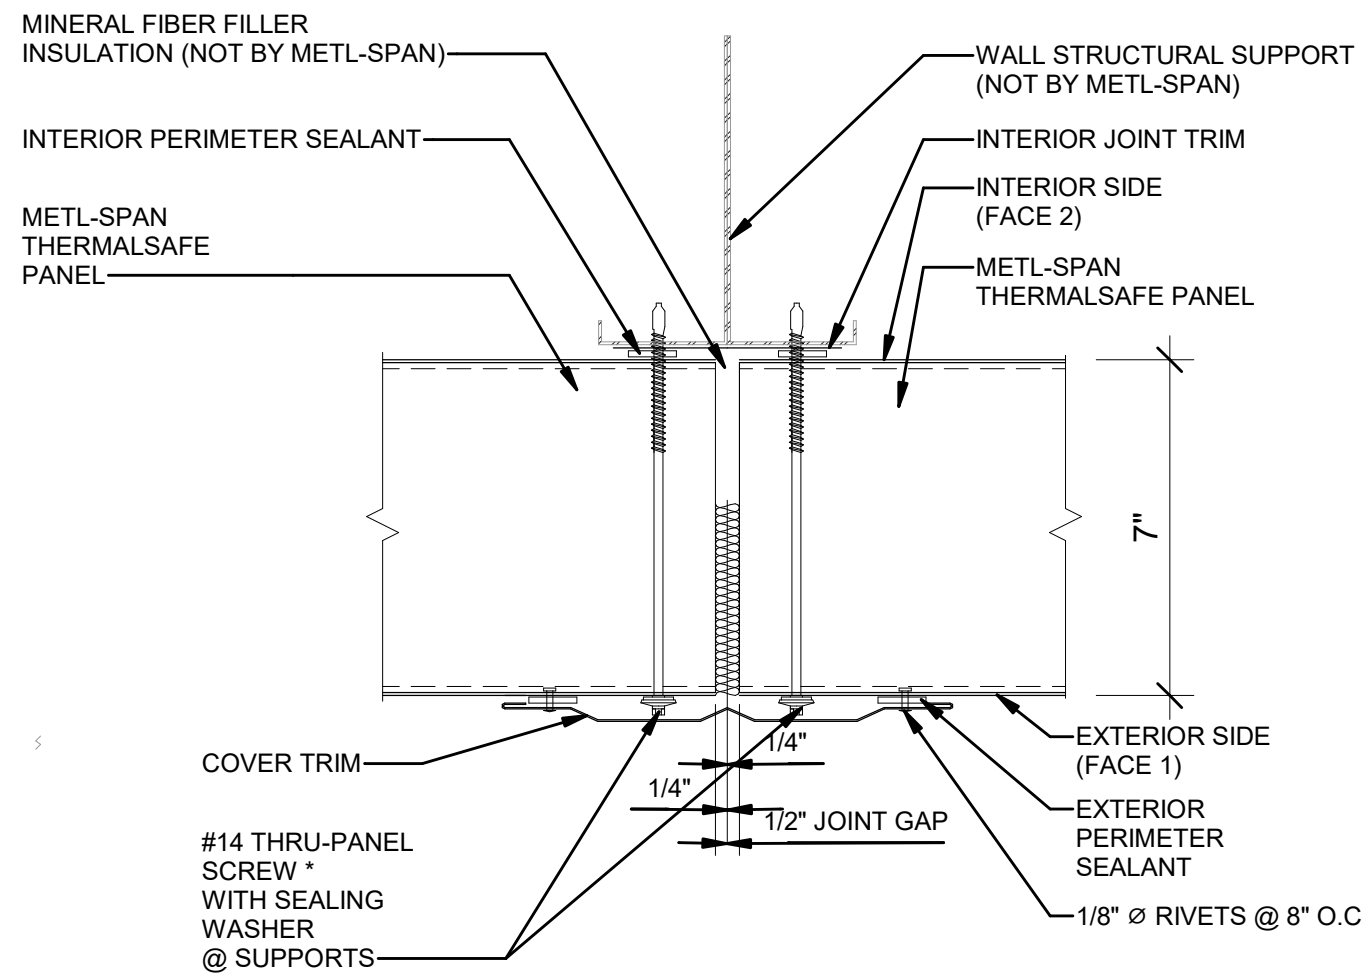

10 VERTICAL JOINT DETAIL HORIZONTAL THERMSAFE PANEL
3" = 1'-0"

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Woodcliff Lake, NJ 07677

Hitachi Energy
901 Main Campus Drive
Raleigh, North Carolina 27606

PROJECT

CHPE
Champlain Hudson
Power Express

Astoria HVDC
Converter Station


31-45 20th Avenue, Astoria, Queens NY 11105
Block #850 - Lot #310 - BIN #4624437

MISCELLANEOUS DETAILS
2




| | |
|-------------------------------------|-------------------|
| DATE | 12/12/22 |
| PROJECT NO | 105121 |
| DRAWING BY | R. COLES |
| CHECKED BY | Z. HARR |
| DRAWING NO | A-614.00 |
| CADD FILE NO | Astoria-HVDC-CHPE |
| Author: CHA-KIE-111-ZZ-M3-A-001.rvt | |

12/8/2022 11:26:45 AM

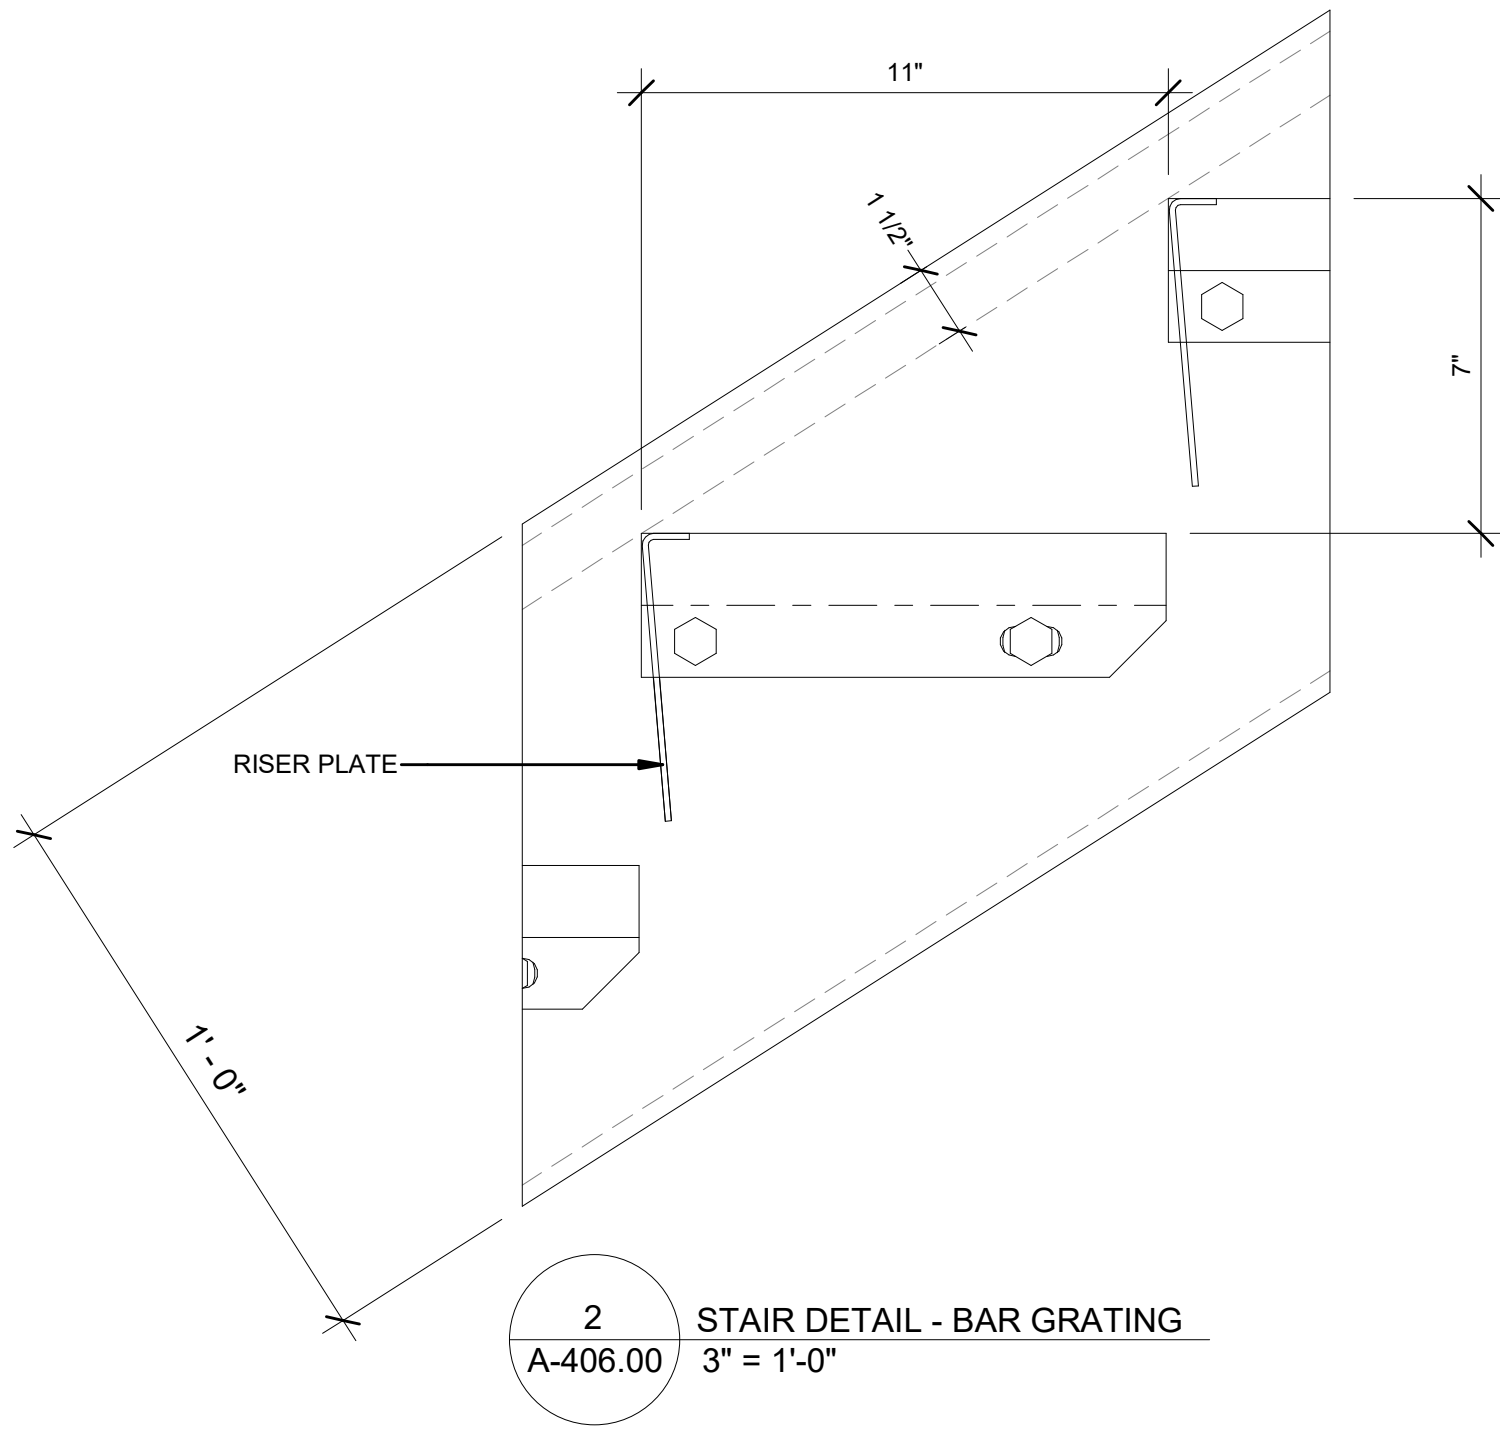


2 STAIR DETAIL - BAR GRATING
3" = 1'-0"

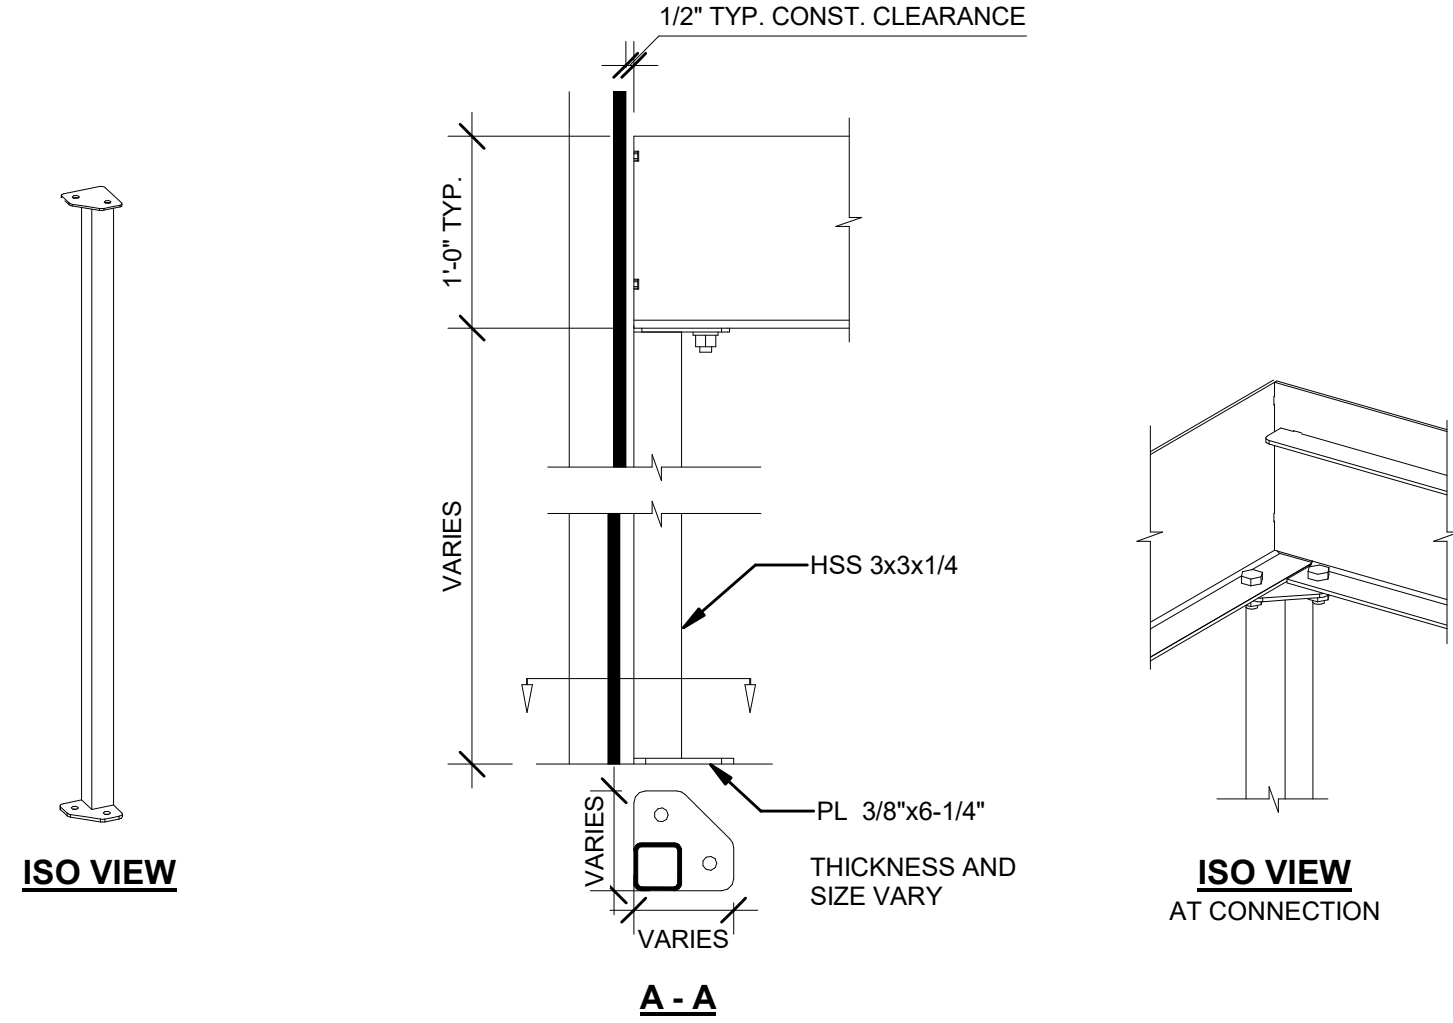


TYPICAL COLUMN DETAIL WITH BASE PLATES


3 STAIR DETAIL - SUPPORT POST PLATFORM
3" = 1'-0"

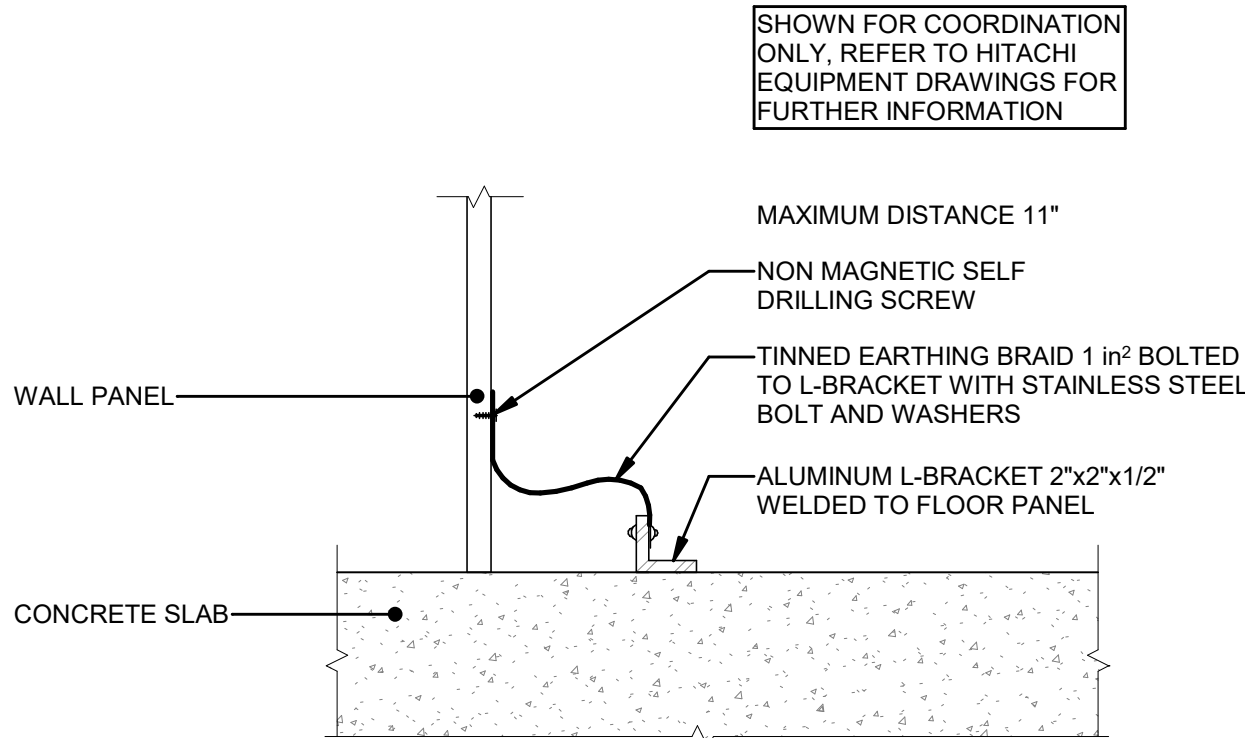


9 REACTOR HALL DETAIL WALL-FLOOR
1/2" = 1'-0"

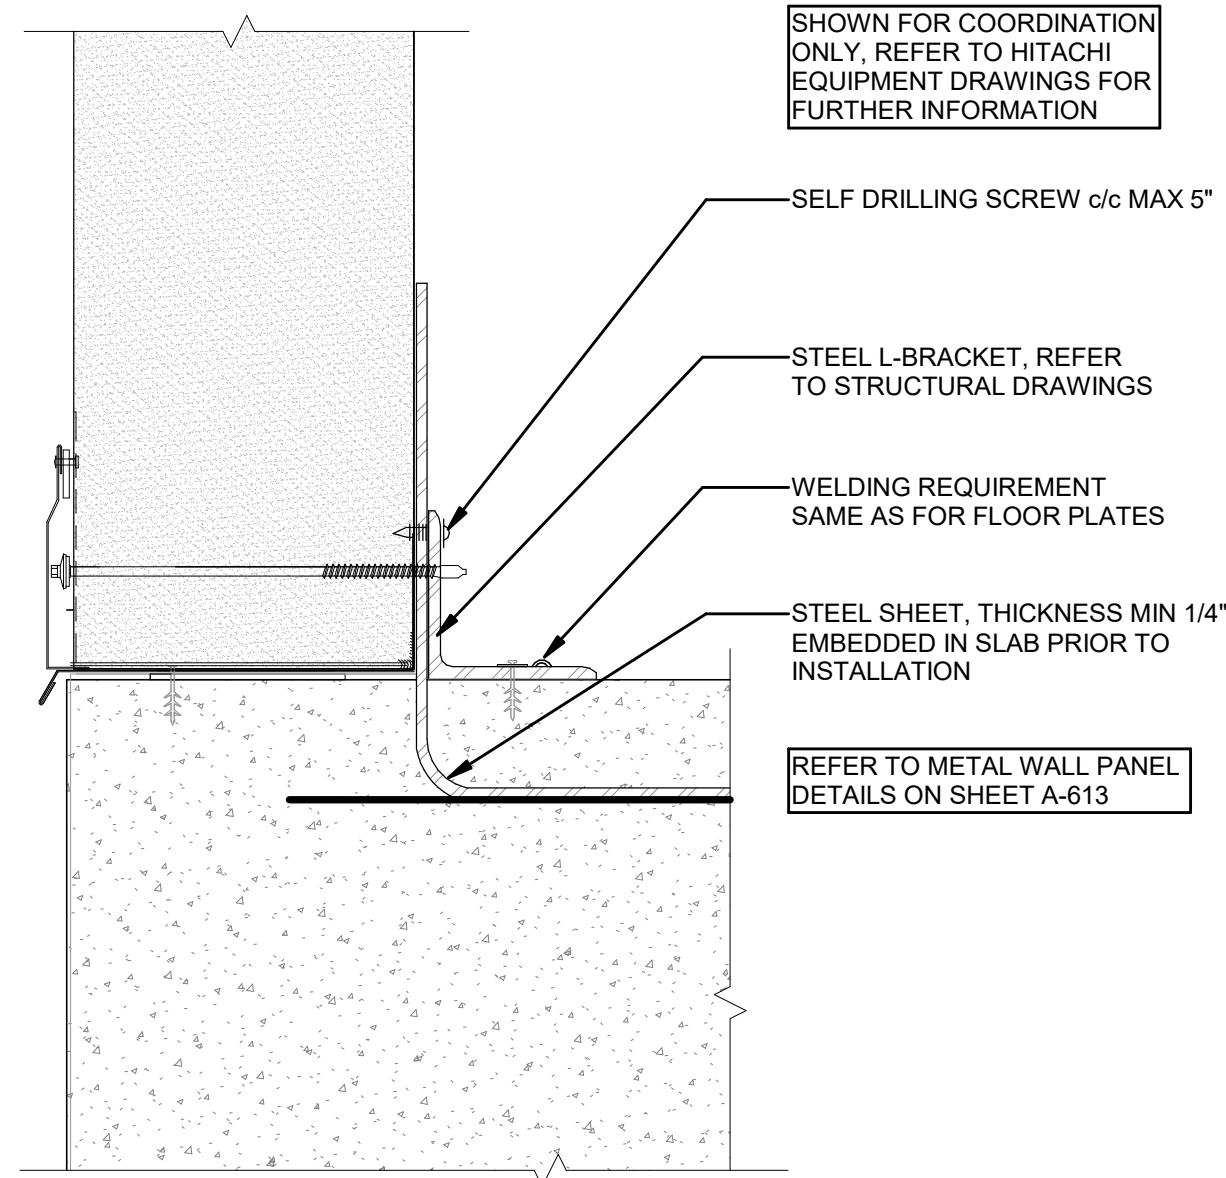


5 REACTOR HALL DETAIL FLOOR-WALL
3" = 1'-0"

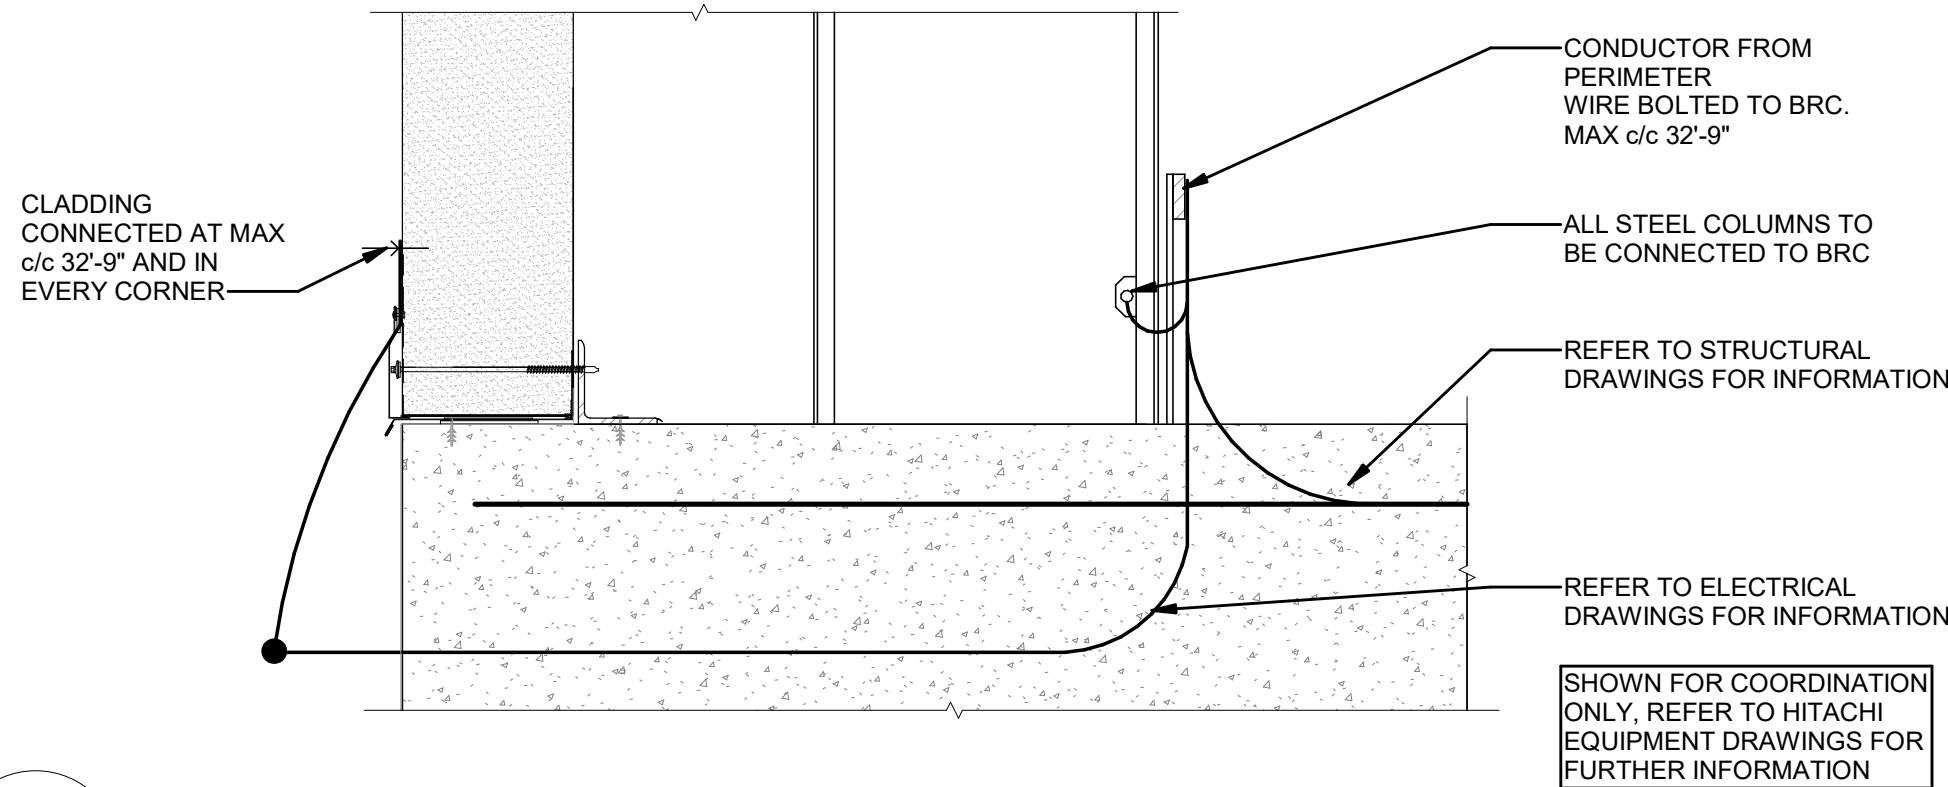

6 REACTOR HALL GROUNDING DETAIL I
1 1/2" = 1'-0"

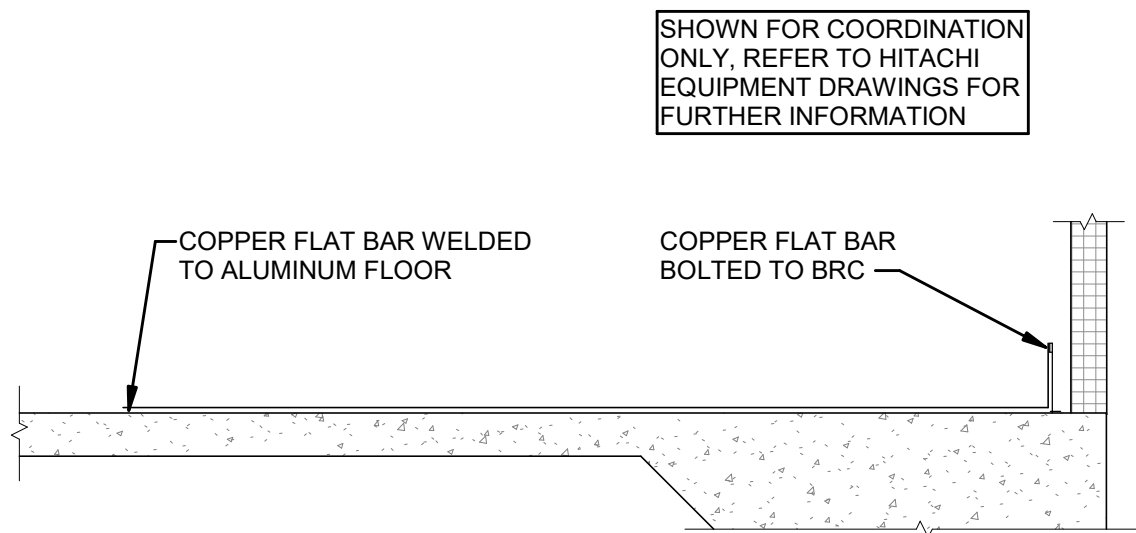

7 REACTOR HALL GROUNDING DETAIL II
1/2" = 1'-0"

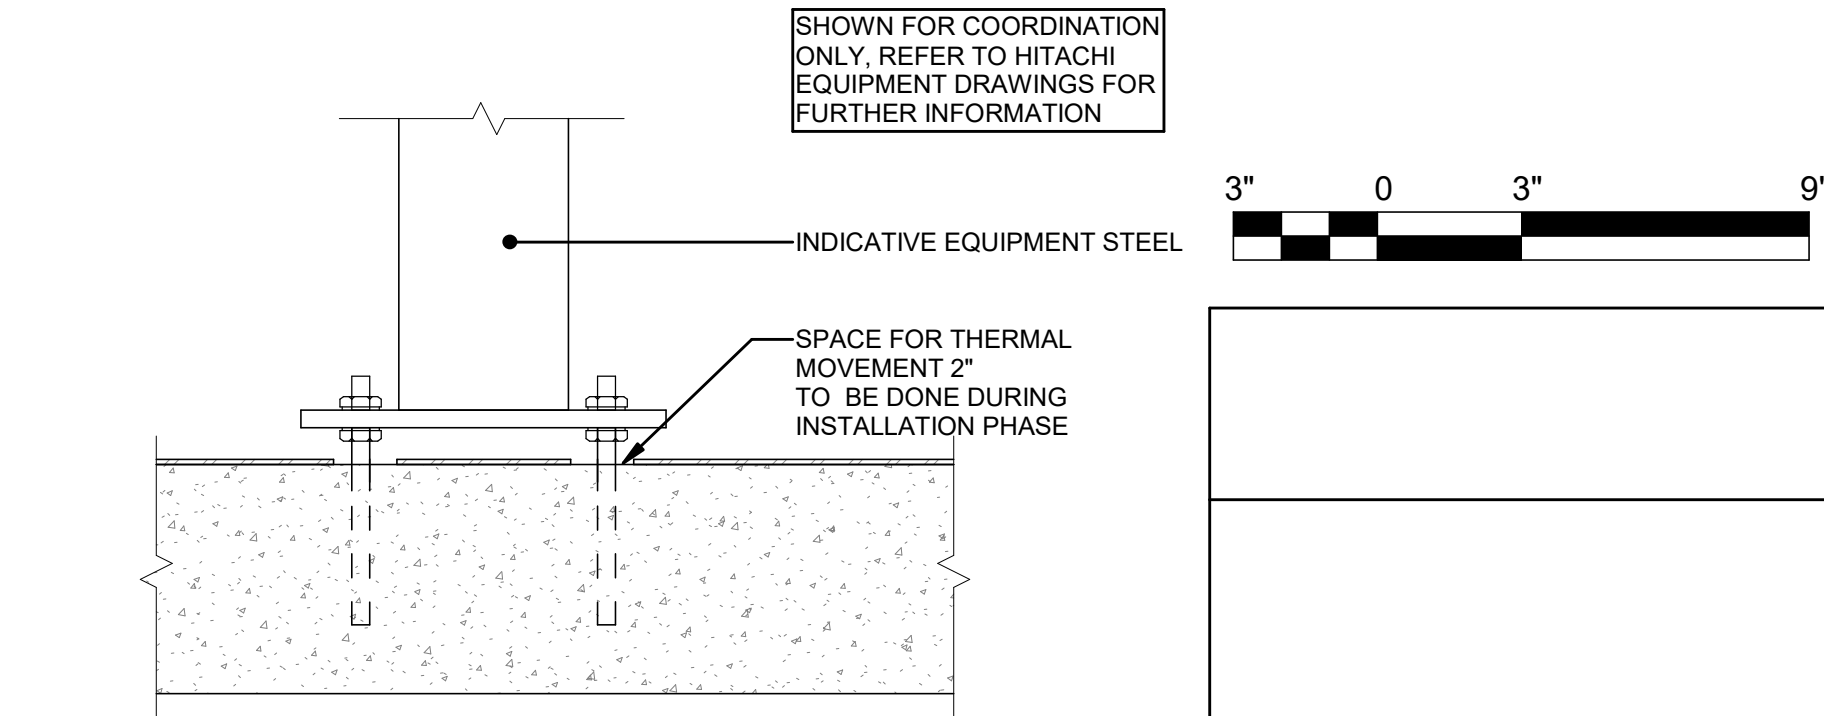

8 REACTOR HALL BASE PLATE TYPICAL
1 1/2" = 1'-0"

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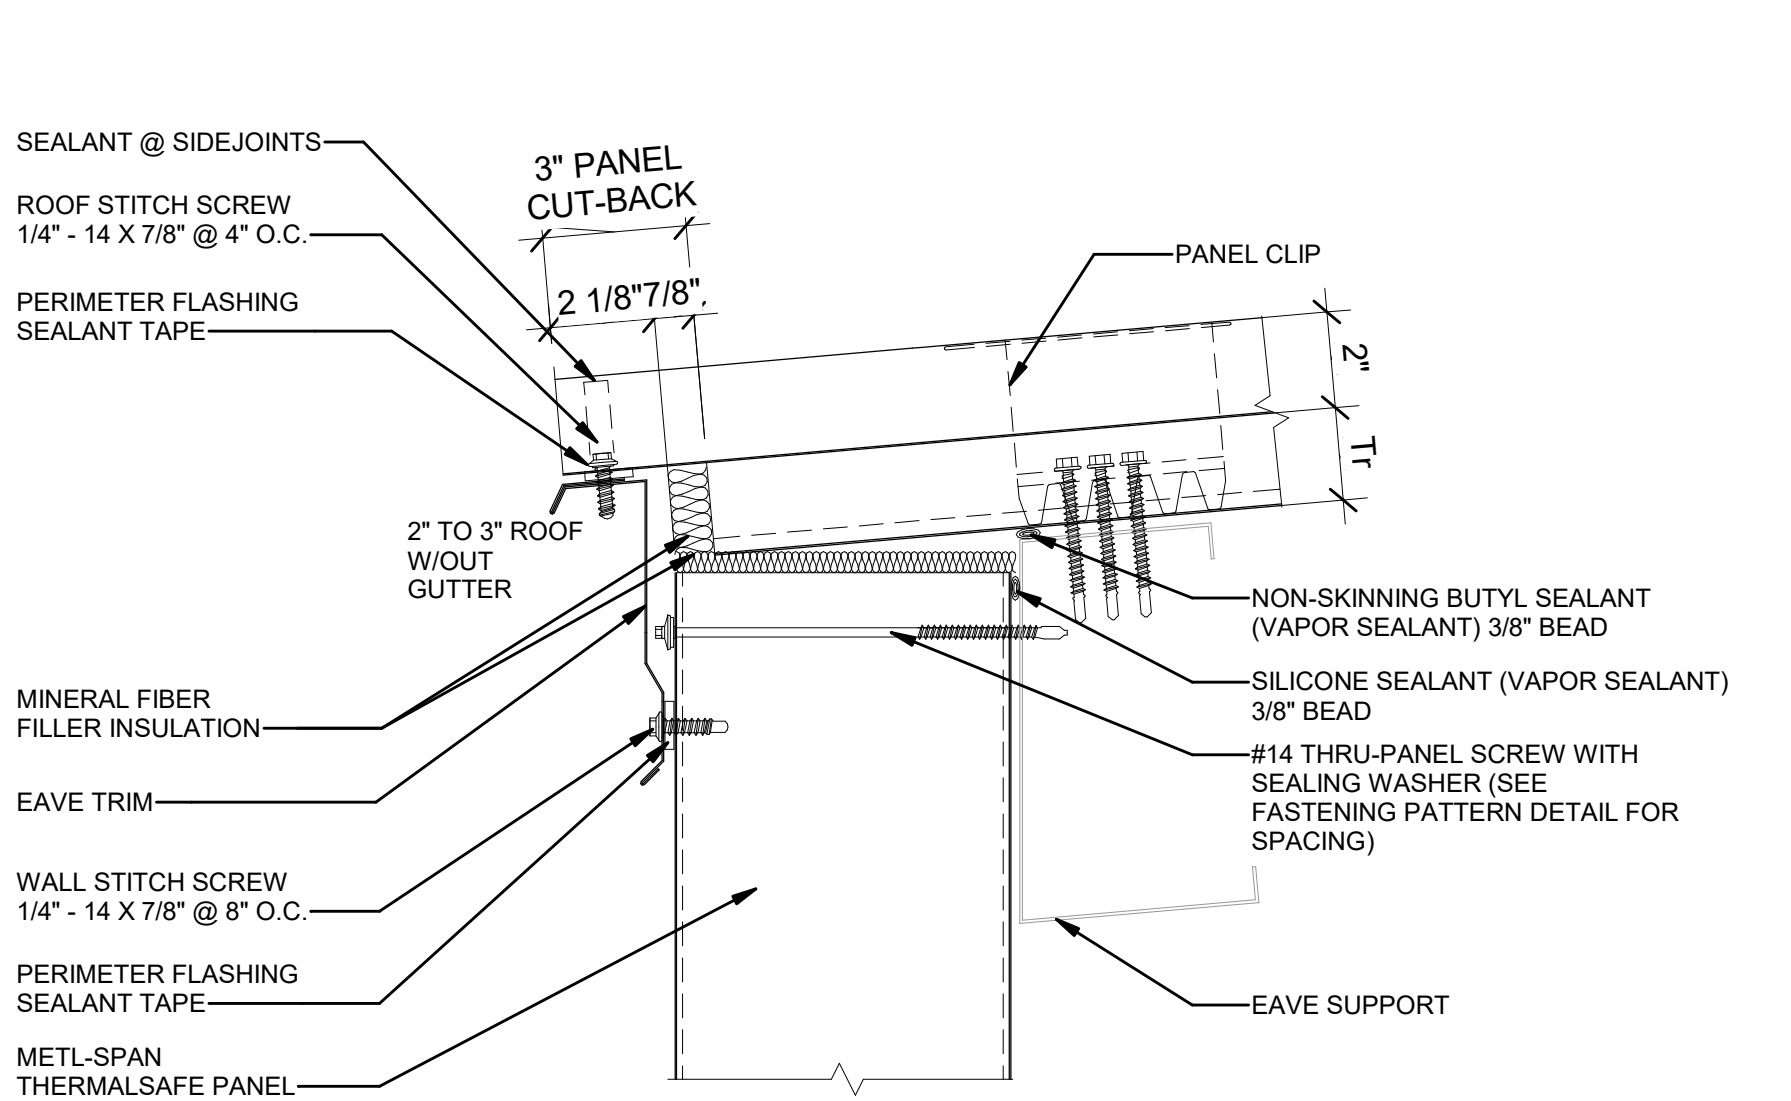
Astoria HVDC
Converter Station

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Block #850 - Lot #310 - BIN #4624437


MISCELLANEOUS DETAILS
3




DATE 12/12/22
PROJECT NO 105121
DRAWING BY R. COLES
CHECKED BY Z. HARR
DRAWING NO
A-615.00
CADD FILE NO
Astoria-HVDC-CHPE
Astoria-CHA-KIE-11-22-M3-A-001.rvt




1 CFR ROOF - THERMSAFE WALL WITH EAVE TRIM
3" = 1'-0"

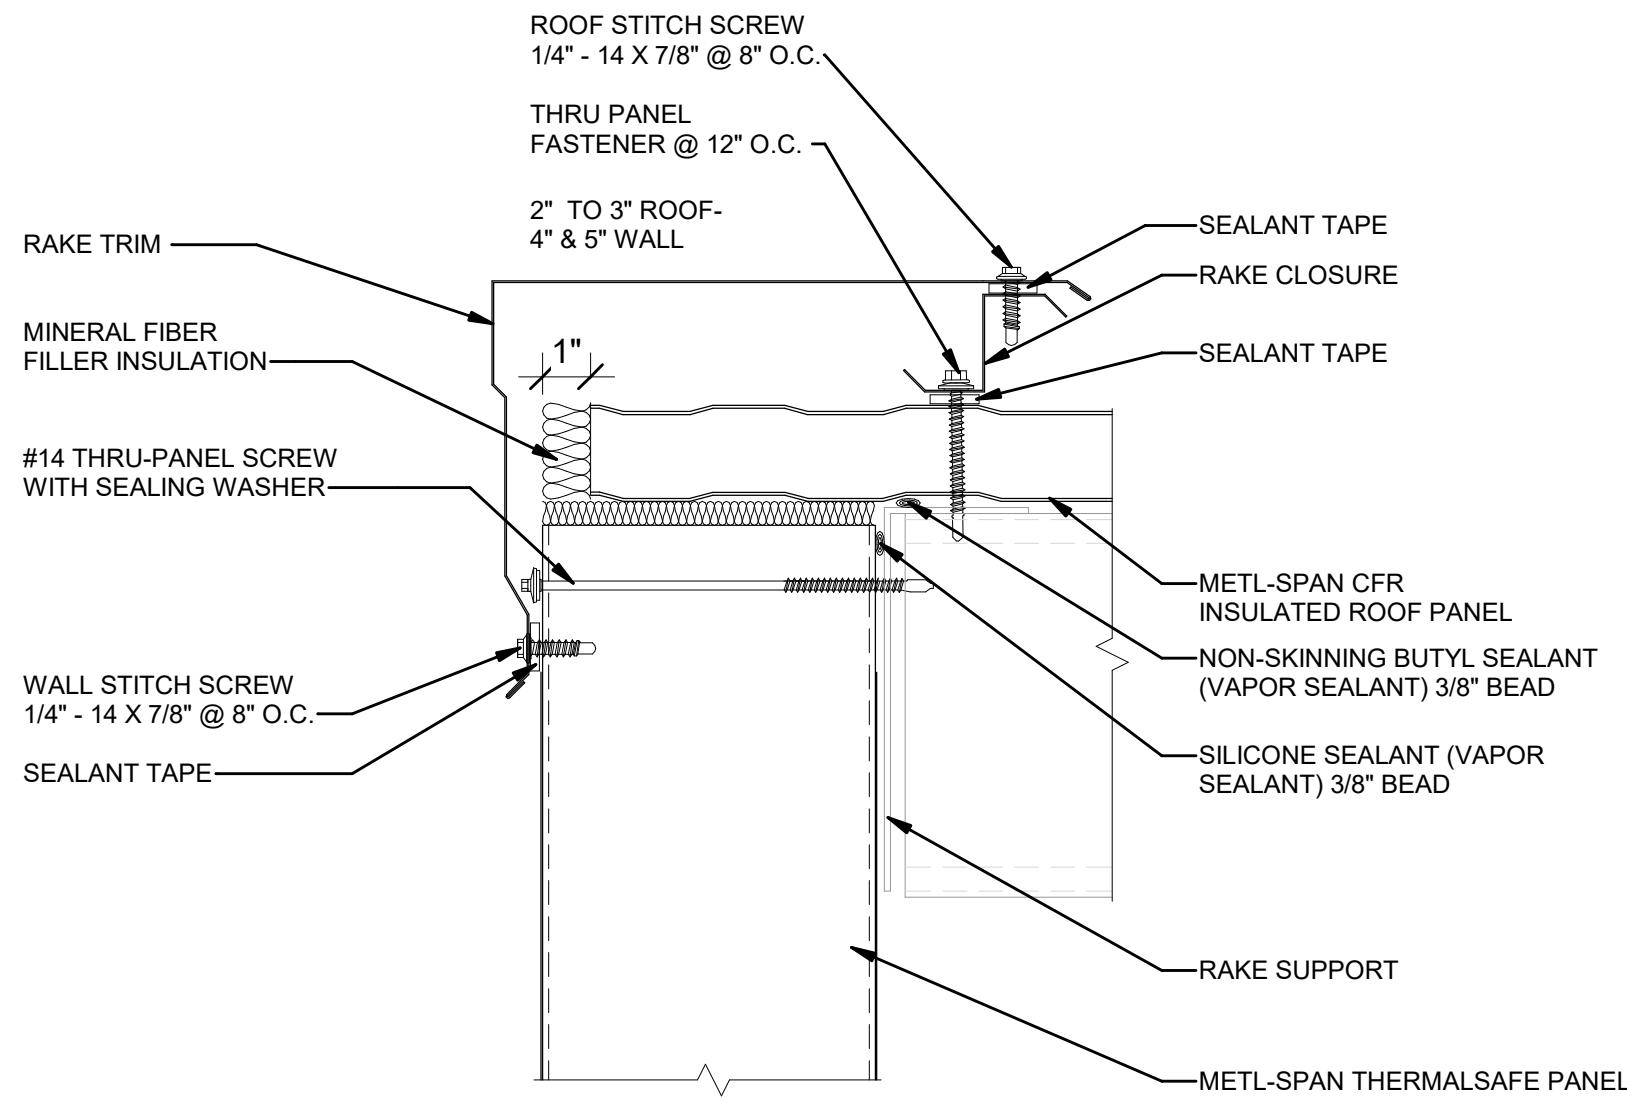


2 CFR ROOF - THERMSAFE WALL STANDARD RAKE TRIM
3" = 1'-0"

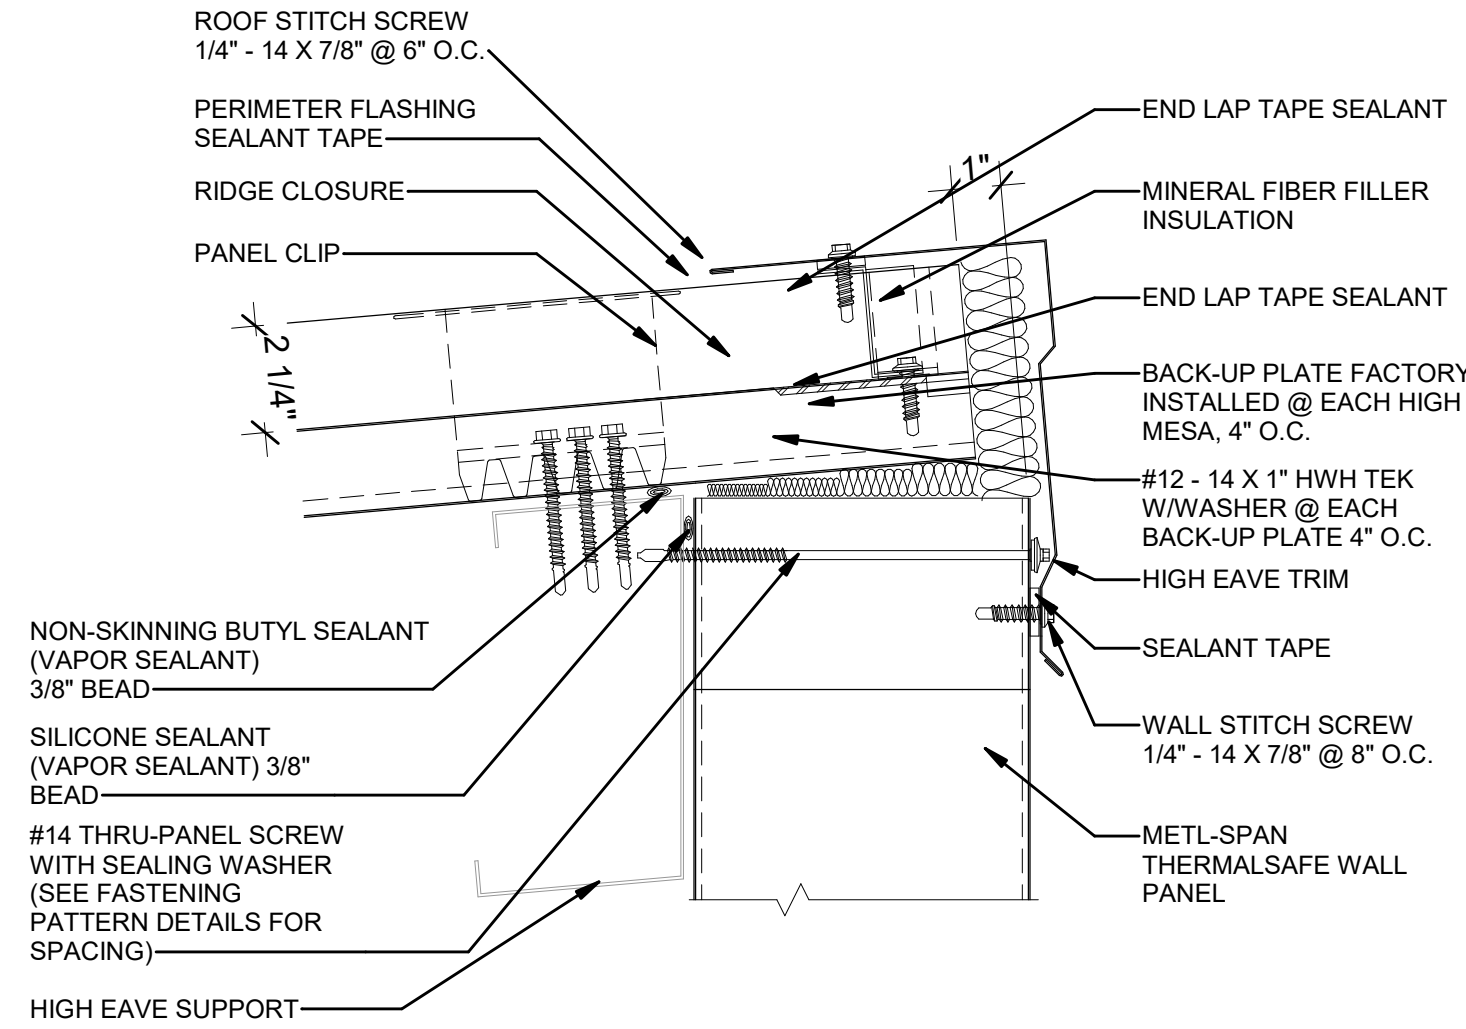


3 CFR ROOF-THERMSAFE WALL HIGH SIDE TRIM
3" = 1'-0"

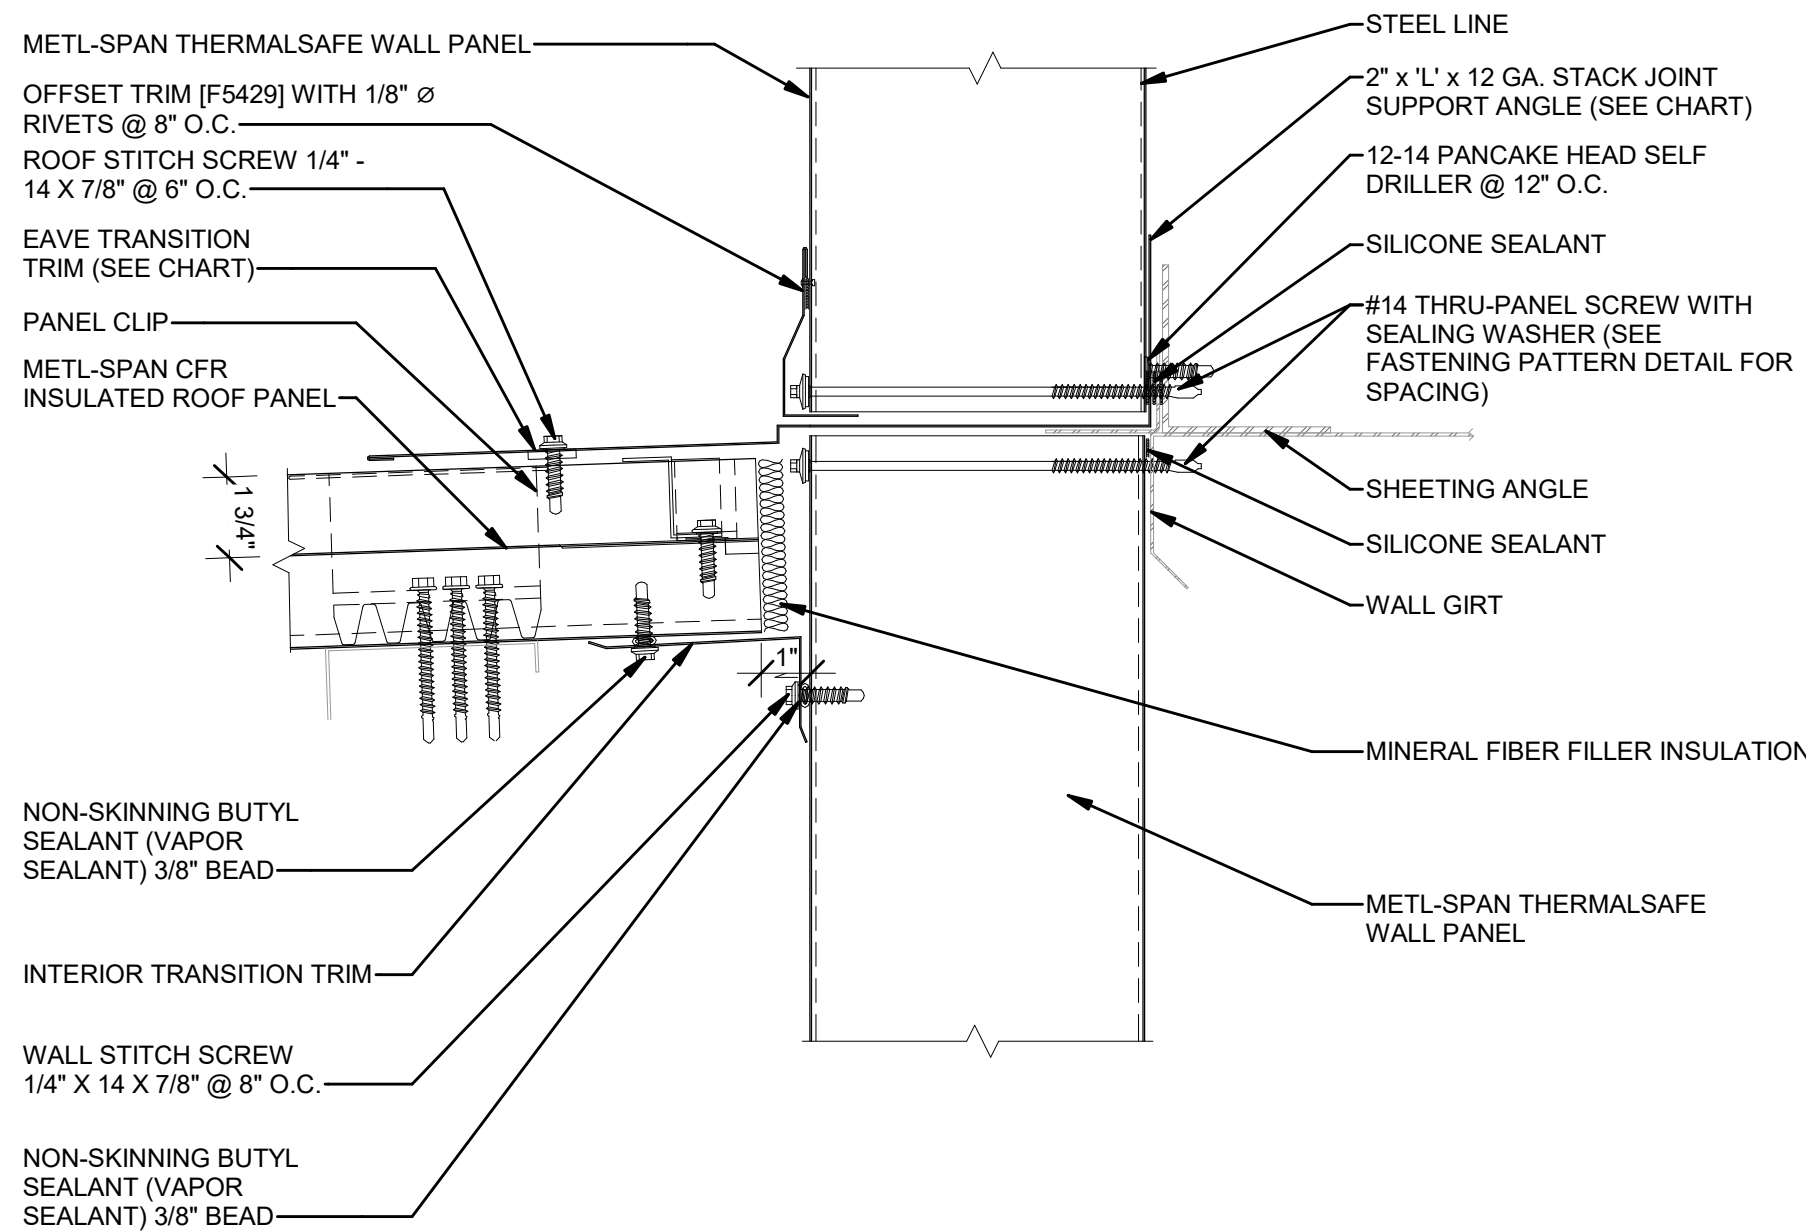

4 CFR ROOF - THERMSAFE WALL BELOW EAVE TIE-IN COMMON WALL SHEETED
3" = 1'-0"

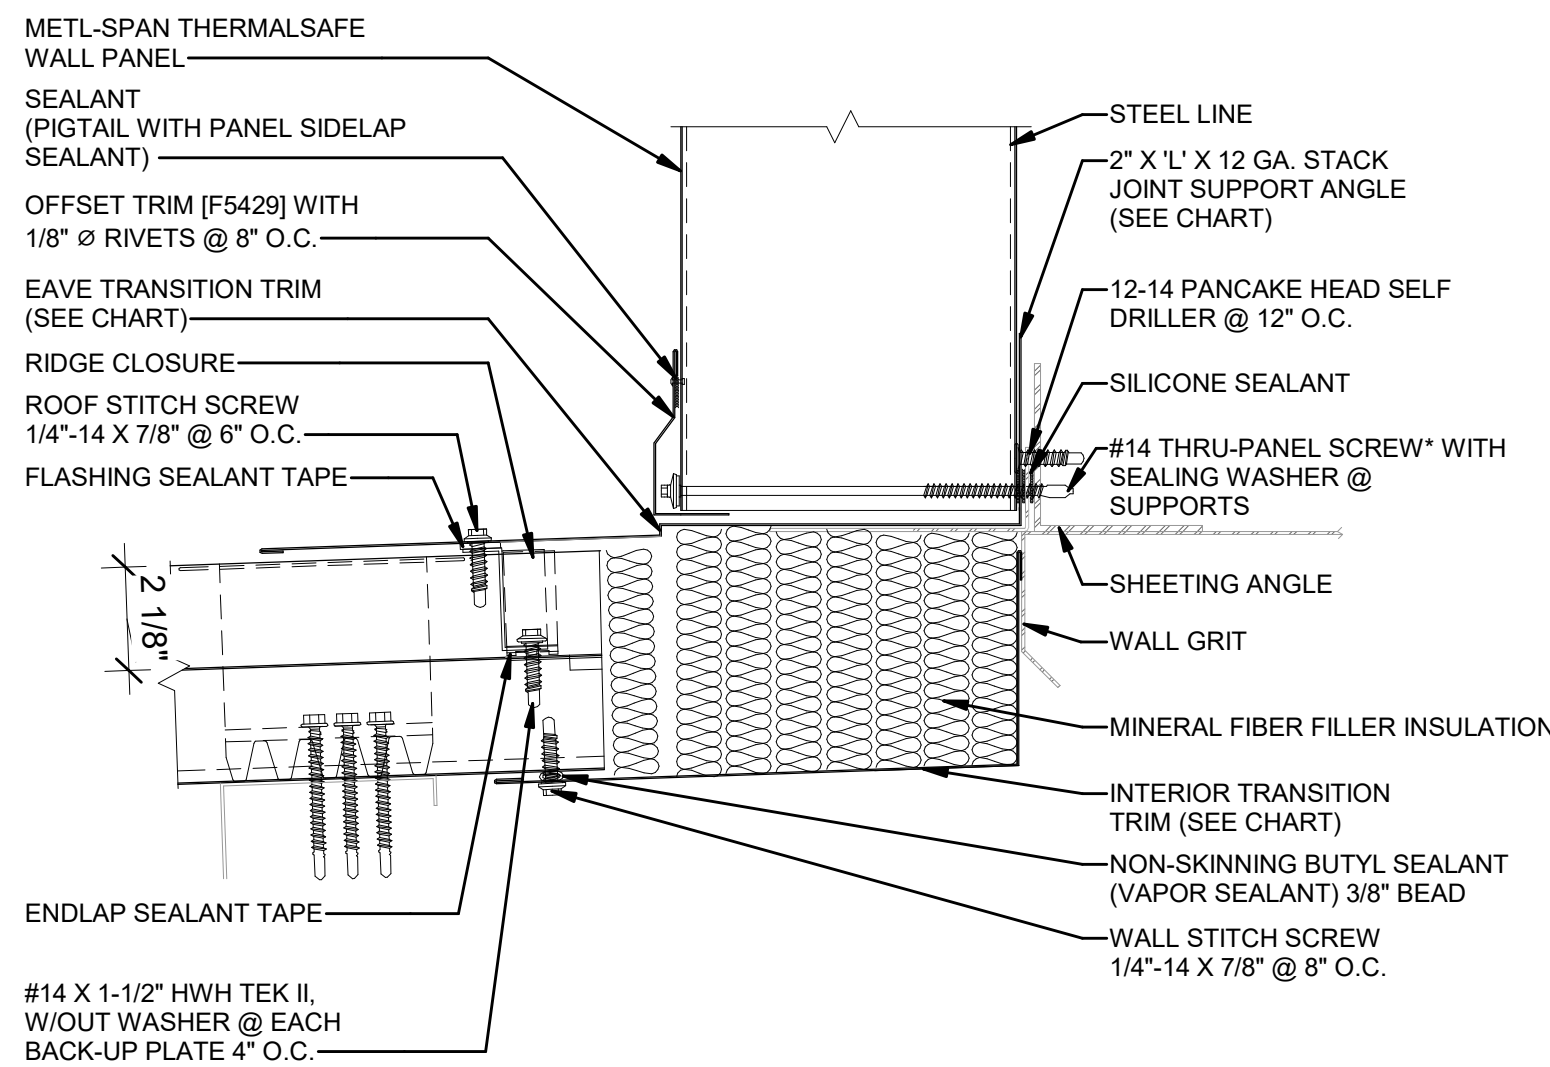

5 CFR- THERMSAFE WALL BELOW EAVE TIE-IN COMMON WALL OPEN
3" = 1'-0"

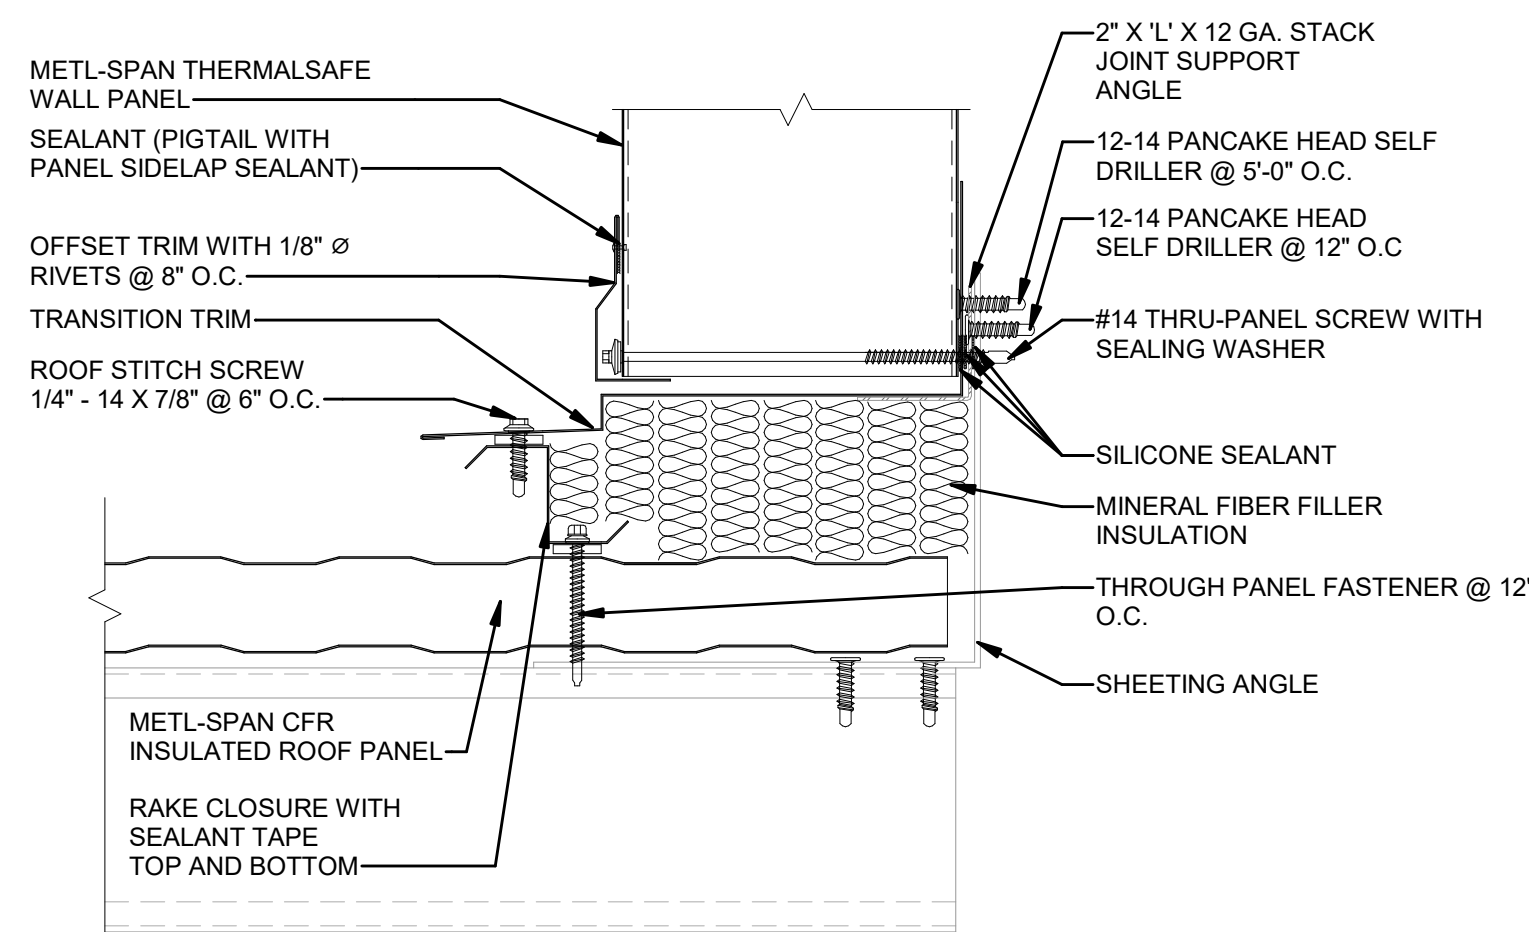

6 CFR ROOF - THERMSAFE WALL RAKE PARAPET TIE-IN COMMON WALL OPEN
3" = 1'-0"



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| 0 | FINAL SUBMISSION | RAC | ZH | 12/12/2022 |
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| REV | DESCRIPTION | DRW BY | CHK BY | DATE |

Kiewit

470 Chestnut Ridge Rd # 2,
Woodcliff Lake, NJ 07677

Hitachi Energy

901 Main Campus Drive
Raleigh, North Carolina 27606

PROJECT

CHPE
Champlain Hudson
Power Express

**Astoria HVDC
Converter Station**


31-45 20th Avenue, Astoria, Queens NY 11105
Block #850 - Lot #310 - BIN #4624437

MISCELLANEOUS DETAILS


4



DATE 12/12/22
PROJECT NO 105121
DRAWING BY R. COLES
CHECKED BY Z. HARR
DRAWING NO
A-616.00
CADD FILE NO
Astoria-HVDC-CHPE
Astoria-CHA-KIE-111-ZZ-M3-A-001.rvt

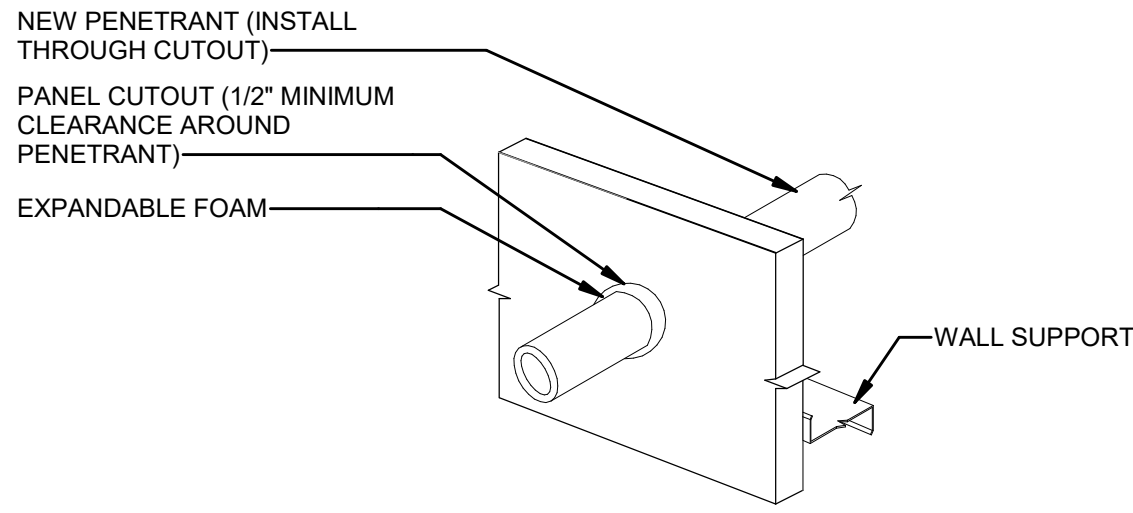


1 PIPE PENETRATION- FIELD OF PANEL
1" = 1'-0"

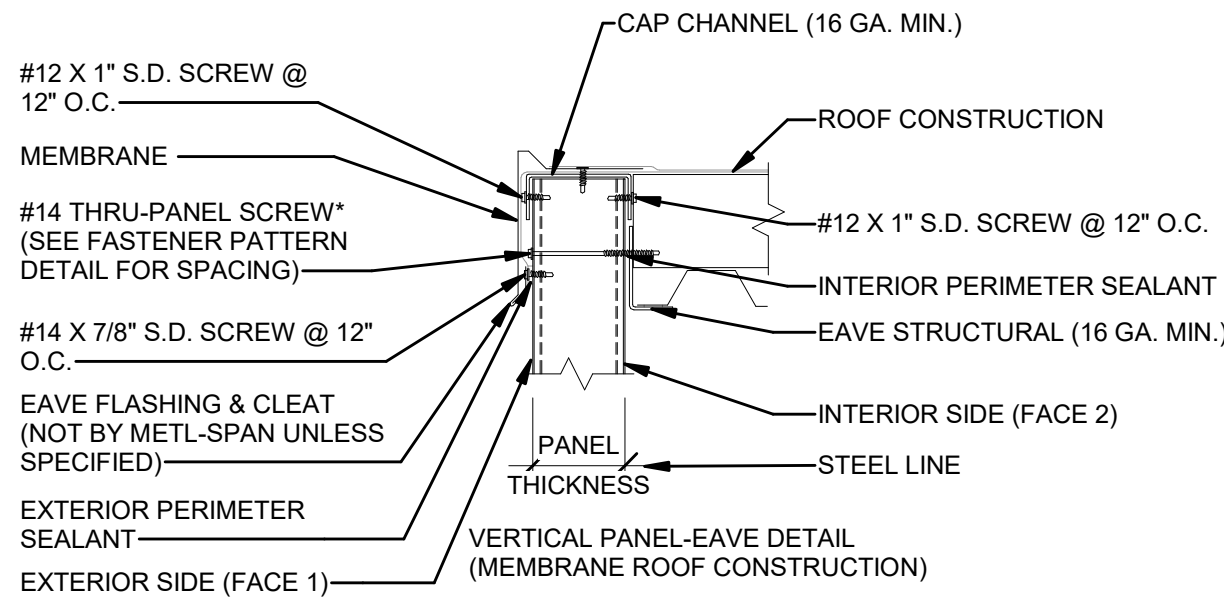


NOTES: 1. FIRE PROTECTION OF THE EAVE STRUCTURAL MAY BE REQUIRED, SUBJECT TO THE PROJECT'S BUILDING CODE REQUIREMENTS. FIRE PROTECTION OF THE STRUCTURAL MEMBERS IS NOT BY METL-SPAN.
2. *FASTENER TYPE IS SUBJECT TO THE EAVE STRUCTURAL MATERIAL AND THE PANEL THICKNESS.
3. TO CONFORM TO THE REQUIREMENTS OF THE ASTM E119 FIRE RESISTANCE RATING, THE FILLER INSULATION MUST HAVE AN APPROVED CLASSIFICATION MARKING FOR SURFACE BURNING CHARACTERISTICS OR FIRE RESISTANCE.
4. REFERENCE THE ROOF SYSTEM'S ERECTION DRAWINGS FOR SPECIFIC CONSTRUCTION DETAILS.


2 EXTERIOR EAVE DETAIL
3" = 1'-0"

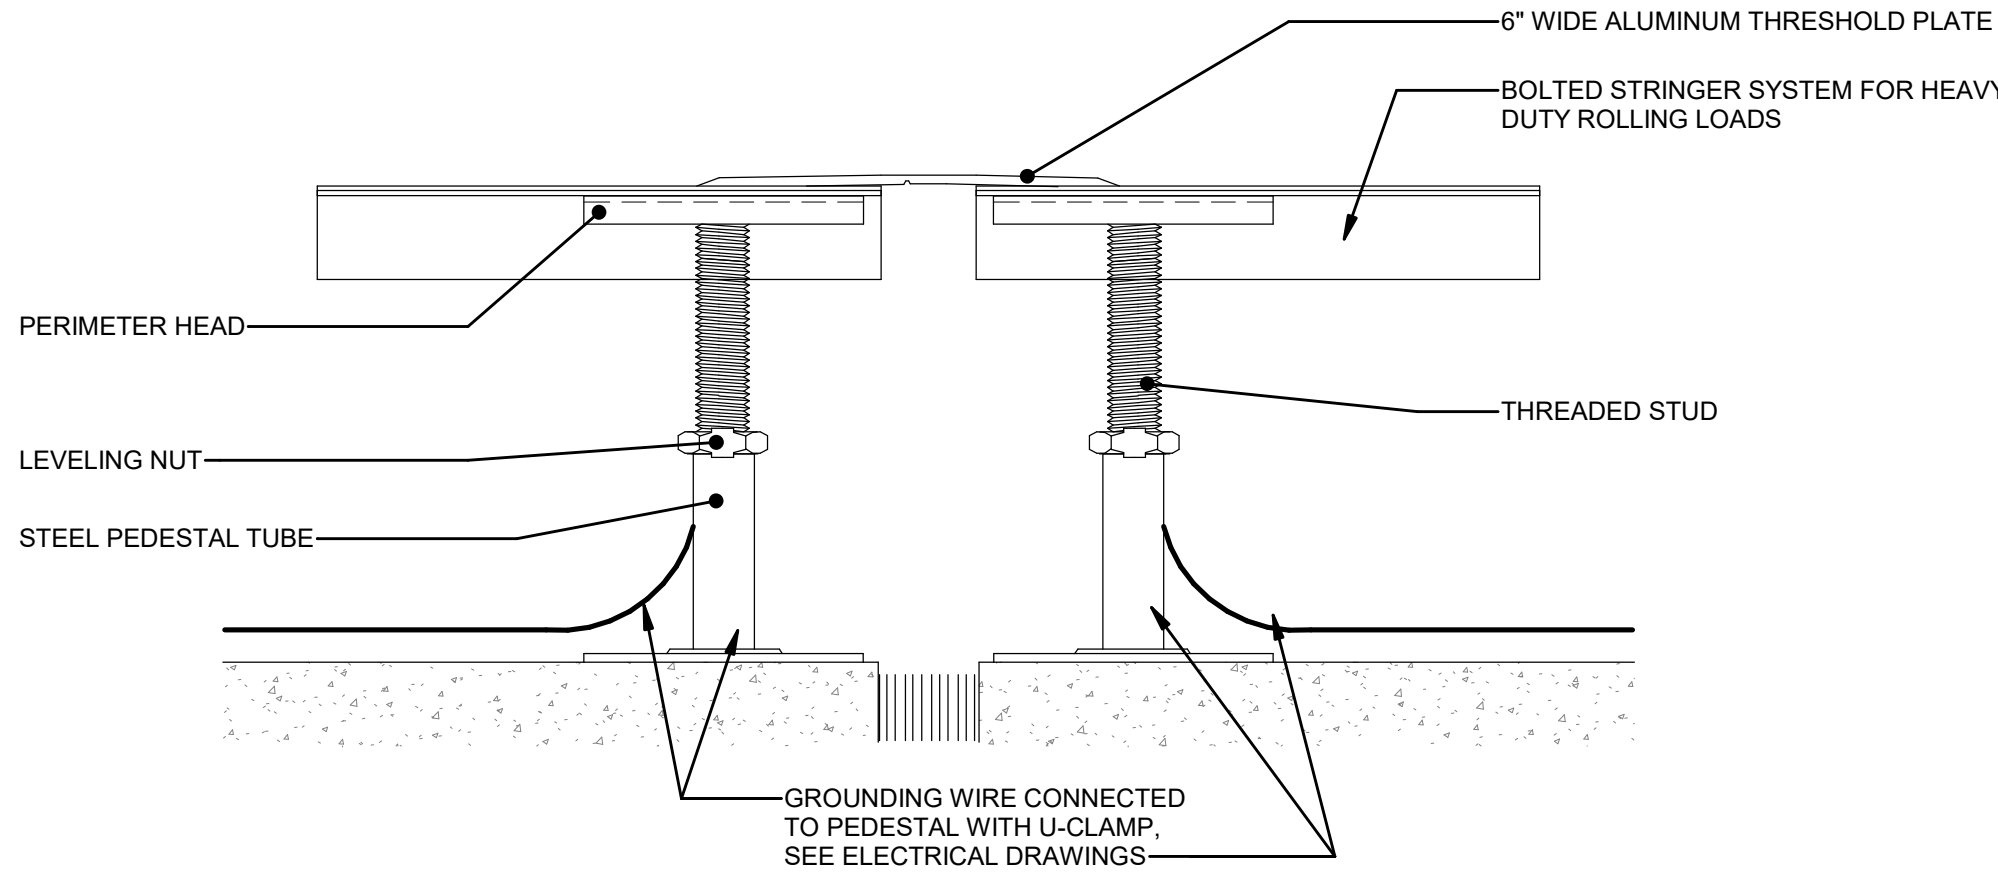


3 UNDERSTRUCTURE-EXPANSION JOINT DETAIL
1 1/2" = 1'-0"

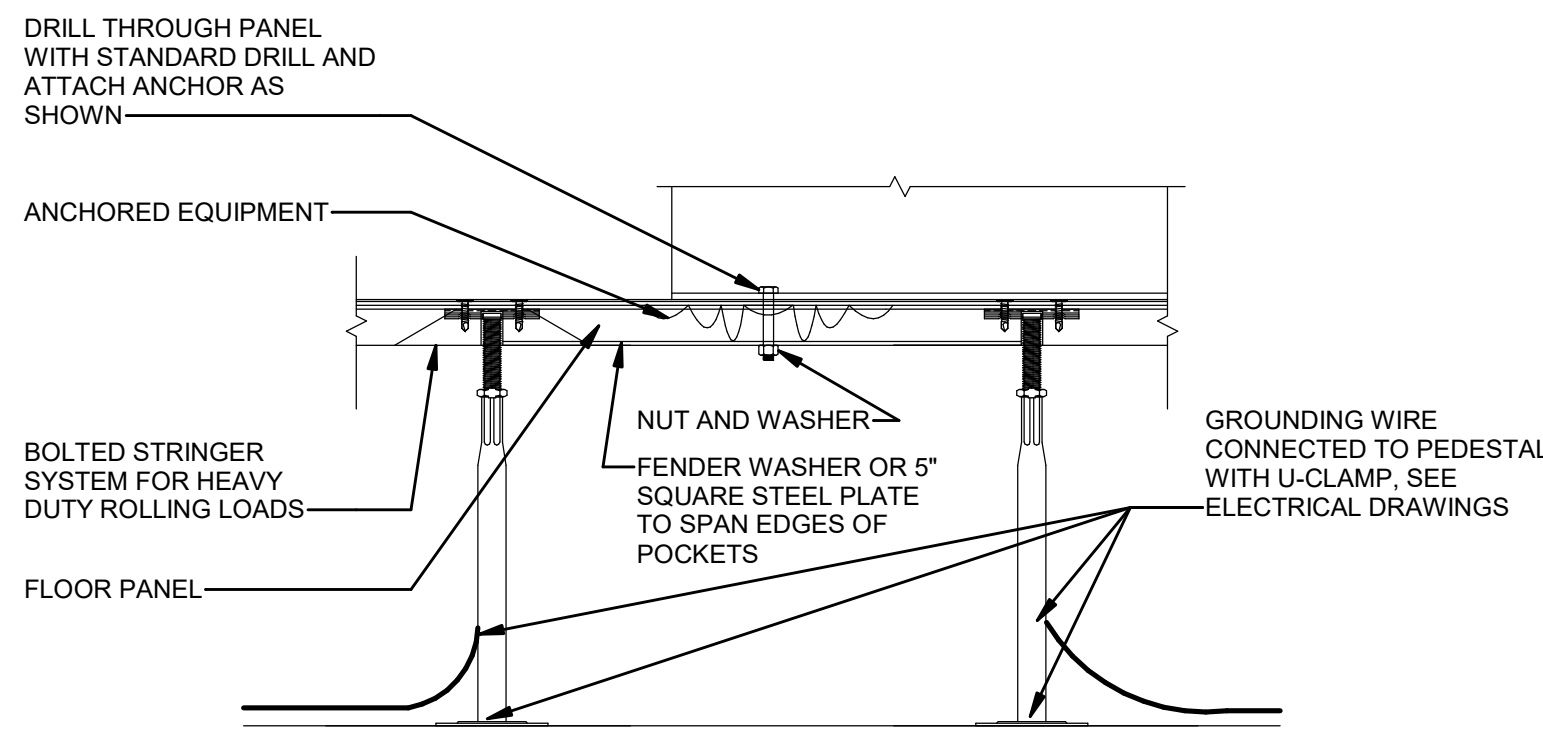

4 RAISED FLOOR ASSEMBLY
1/2" = 1'-0"

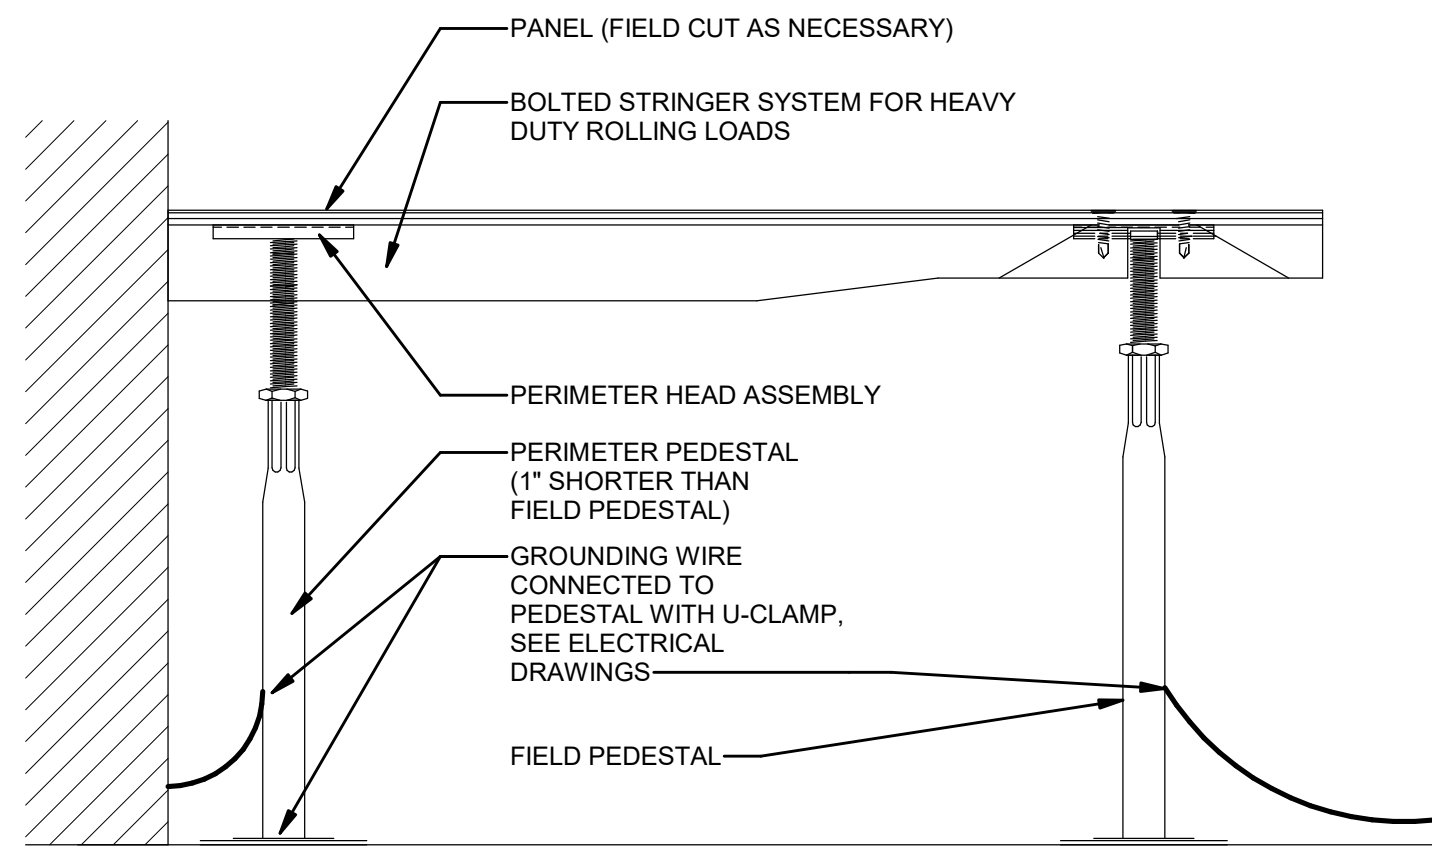


5 RAISED FLOOR SECTION DETAIL
3/4" = 1'-0"

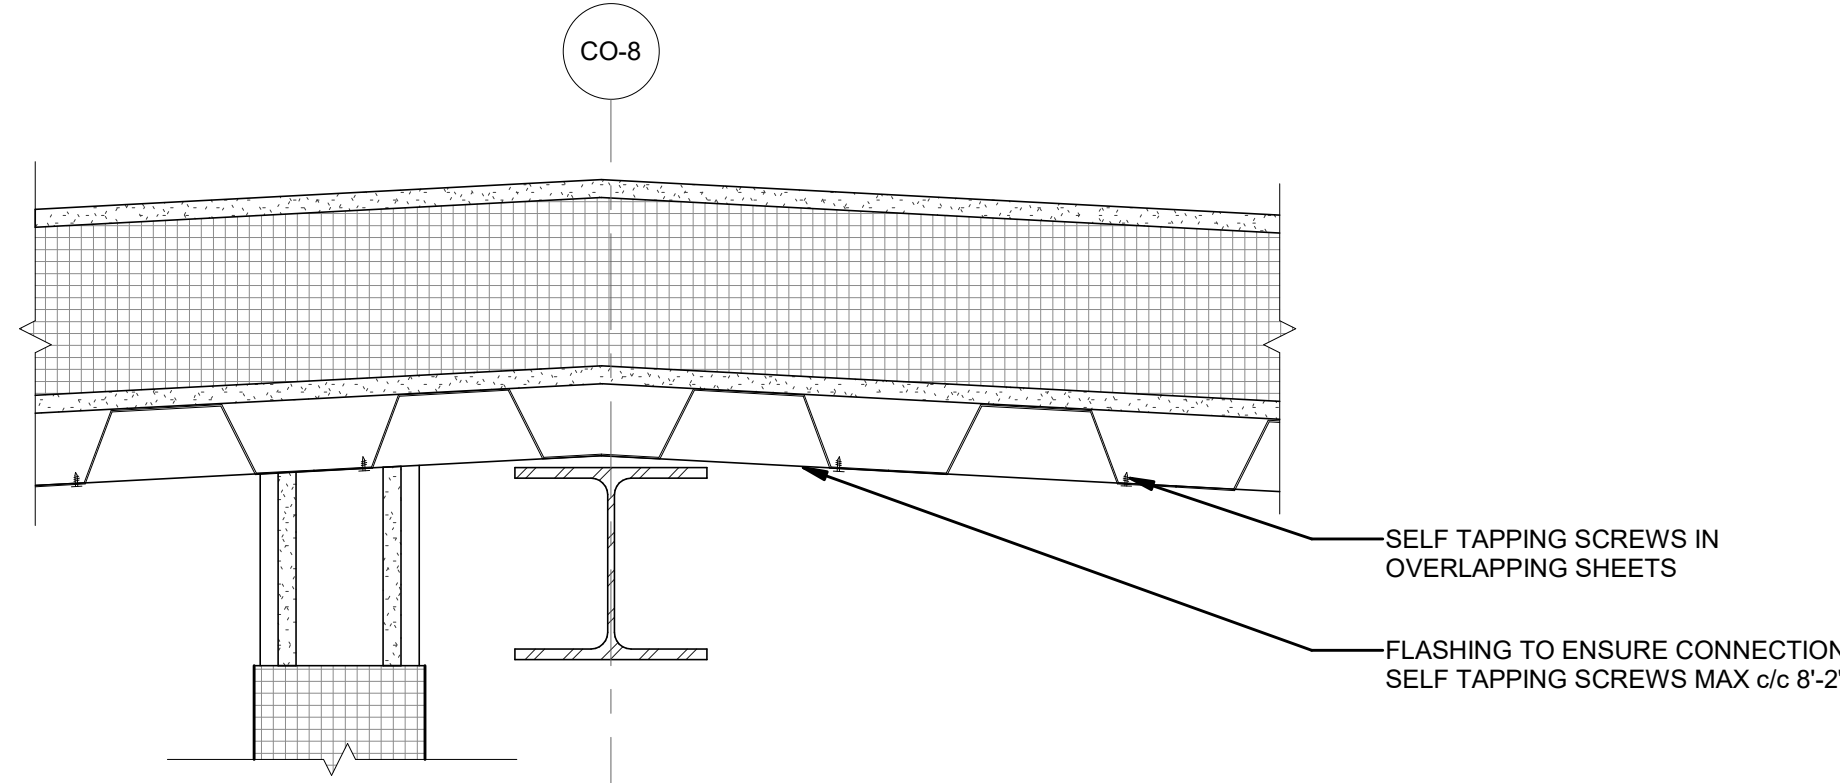


7 VALVE HALL ROOF RIDGE DETAIL
1 1/2" = 1'-0"


VALVE COOLING PIPES WERE PENETRATING THE VALVE HALL SHALL BE ELECTRICALLY CONNECTED TO THE WALL, TYPICALLY ACCORDING TO BELOW:

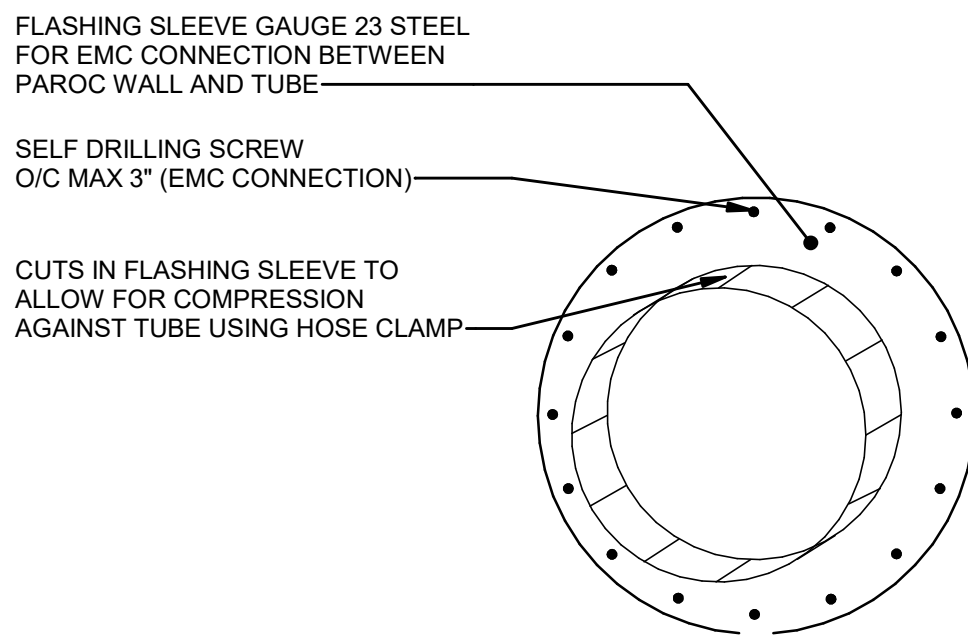


11 VALVE HALL - PENETRATION GROUNDING DETAIL
N.T.S.

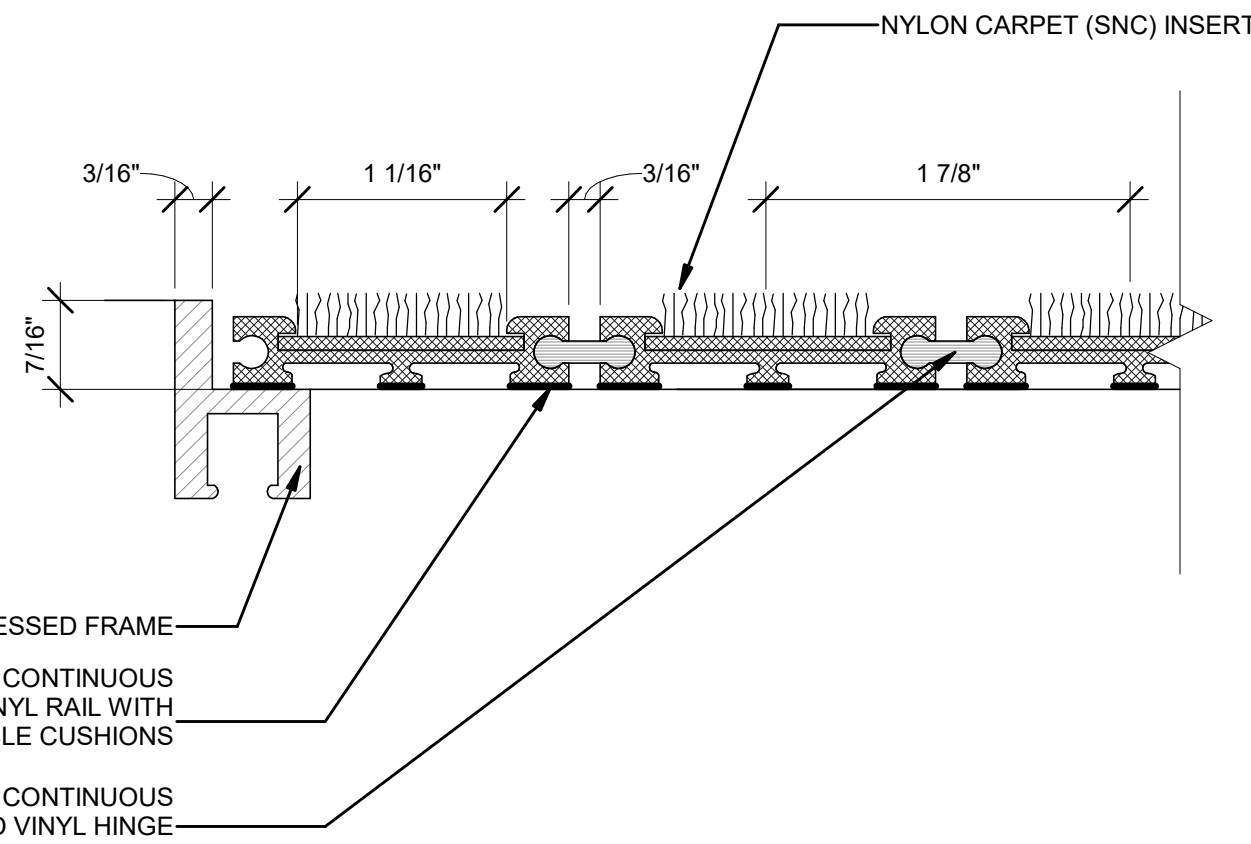


6 ENTRANCE FLOOR MAT DETAIL
12" = 1'-0"

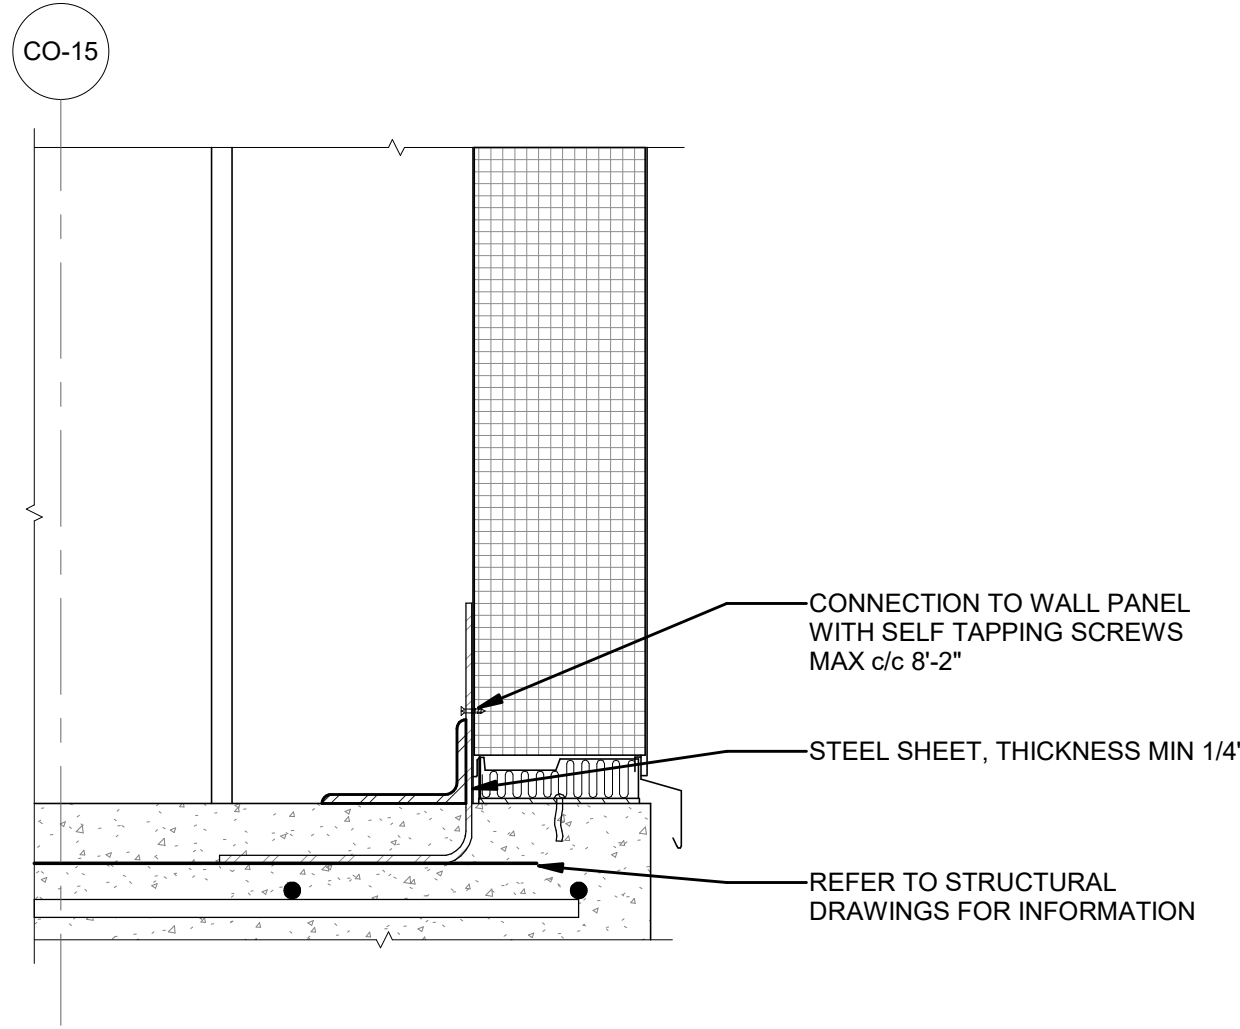

8 VALVE HALL SLAB WALL DETAIL
1 1/2" = 1'-0"

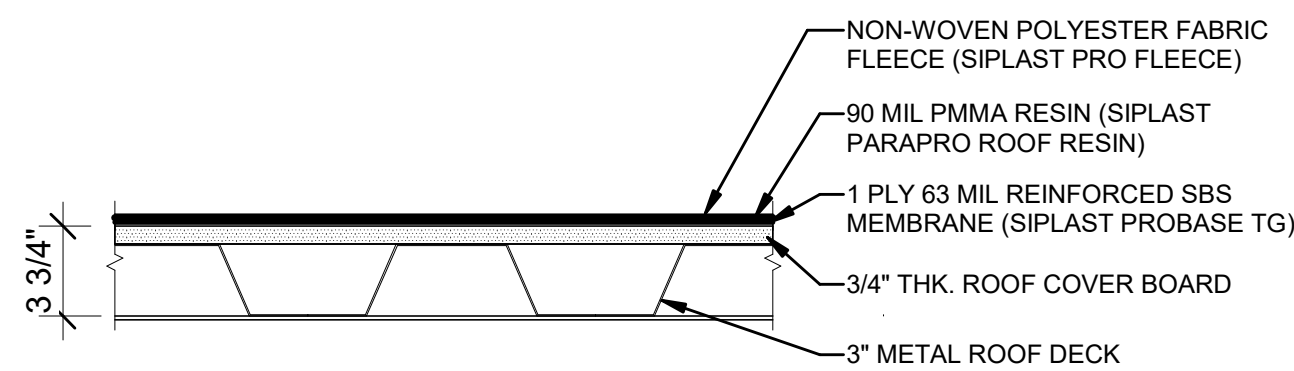

9 TYPICAL ROOF DETAIL
1 1/2" = 1'-0"

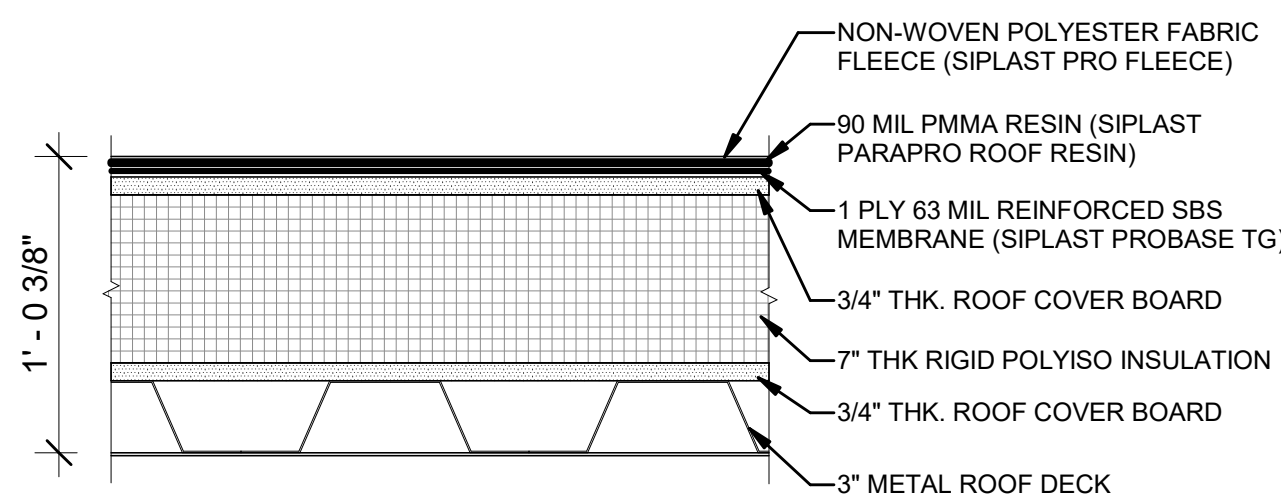

10 TYPICAL ROOF DETAIL AT VALVE HALL
1 1/2" = 1'-0"



ISSUED FOR PERMIT

Engineering and
Land Surveying, P.C.
370 7th Avenue
SUITE 1604
New York, NY 10001

SOWINSKI
SULLIVAN
25 Mohawk Avenue
Sparta, NJ 07871

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| B | FINAL SUBMISSION | RAC | ZH | 12/12/2022 |
|-----|--------------------|--------|--------|------------|
| A | INTERIM SUBMISSION | RAC | ZH | 09/13/2022 |
| REV | DESCRIPTION | DRW BY | CHK BY | DATE |

Kiewit
470 Chestnut Ridge Rd # 2,
Woodcliff Lake, NJ 07677

Hitachi Energy
901 Main Campus Drive
Raleigh, North Carolina 27606

PROJECT
CHPE
Champlain Hudson
Power Express


**Astoria HVDC
Converter Station**

31-45 20th Avenue, Astoria, Queens NY 11105
Block #850 - Lot #310 - BIN #4624437


MISCELLANEOUS DETAILS
5

REGISTERED ARCHITECT
SUZANNE SOWINSKI
STATE OF NEW YORK
026049
DATE: 12/12/22
PROJECT NO: 105121
DRAWING BY: R. COLES
CHECKED BY: Z. HARR
DRAWING NO:
A-617.00
CADD FILE NO:
Astoria-HVDC-CHPE
Astoria-CHA-KIE-111-ZZ-M3-A-001.rvt

12/12/2022 1:09:28 PM

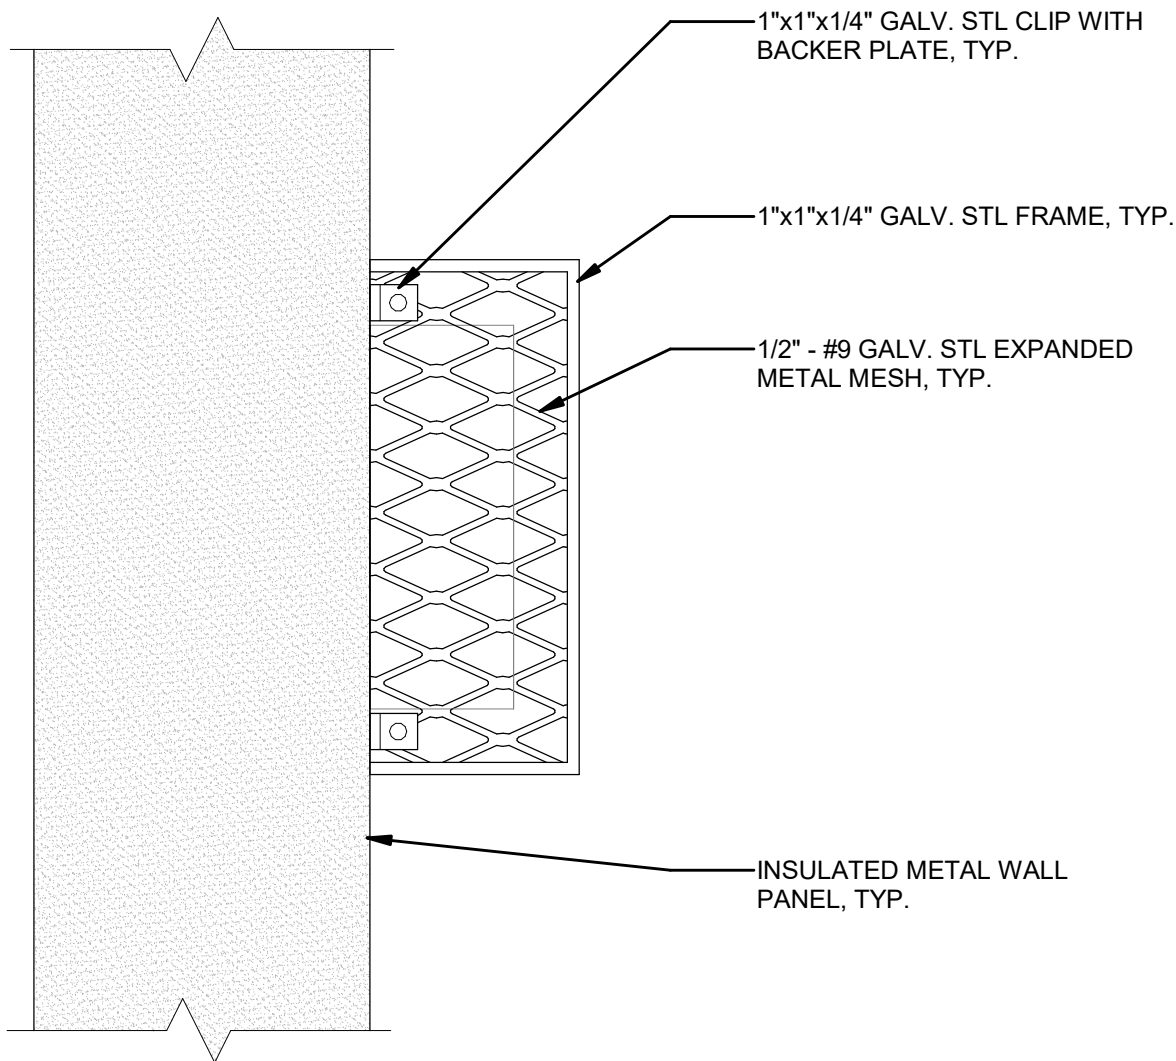


1 FARADAY CAGE ELEVATION DETAIL
3" = 1'-0"

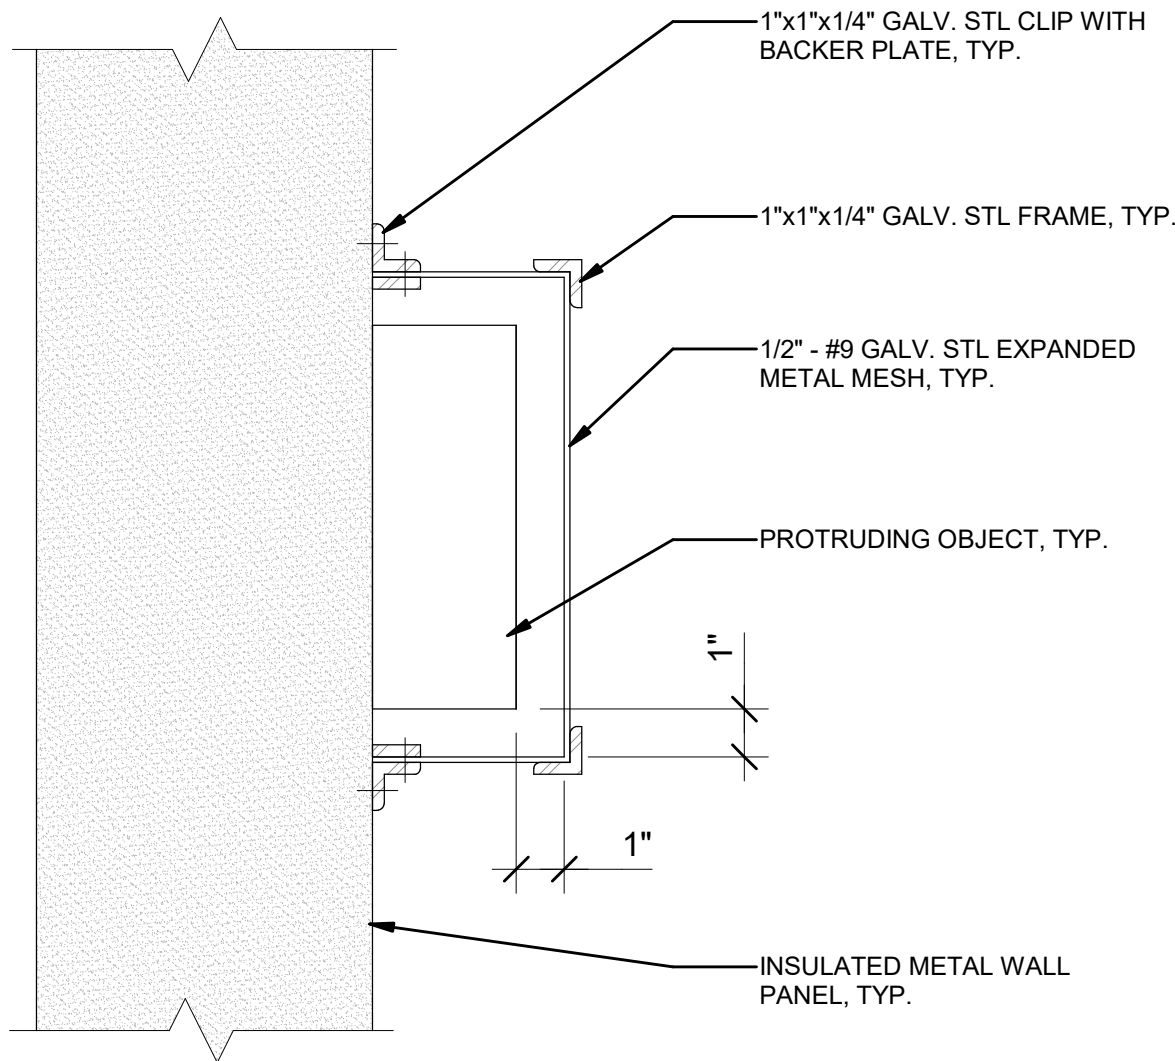

2 FARADAY CAGE SECTION DETAIL
3" = 1'-0"

IF DETAILS CANNOT BE ACHIEVED WHEN USING SANDWICH PANELS, AN EXPANDED METAL MESH SHOULD BE USED INSTEAD, PROVIDING A FARADAYS CAGE WITH THE BELOW CHARACTERISTICS:

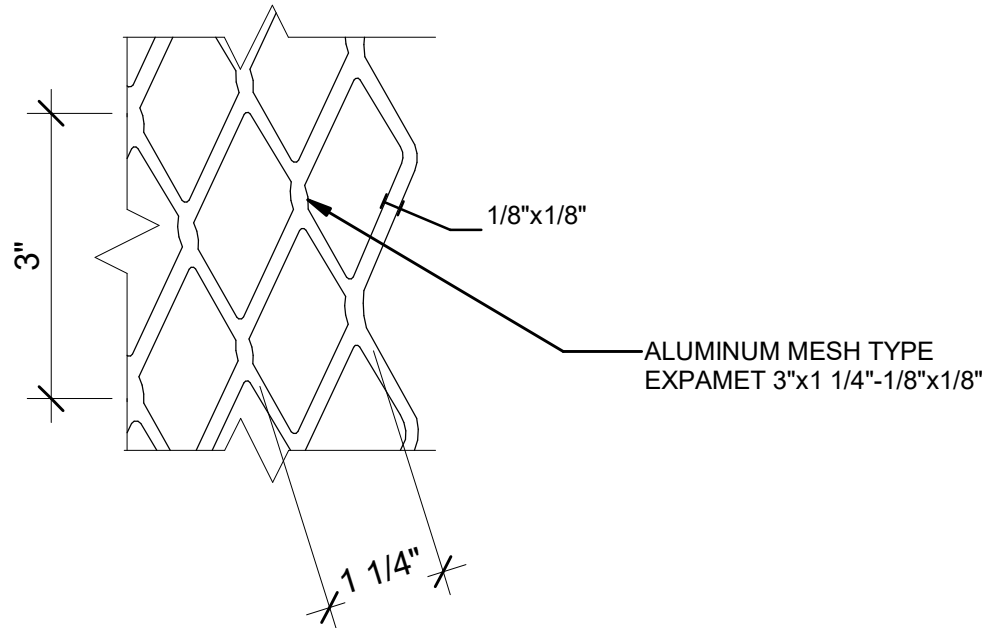

3 FARADAY CAGE GROUNDING DETAIL
6" = 1'-0"

ISSUED FOR PERMIT

Engineering and
Land Surveying, P.C.
370 7th Avenue
SUITE 1604
New York, NY 10001

SOWINSKI
SULLIVAN
25 Mohawk Avenue
Sparta, NJ 07871

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| B | FINAL SUBMISSION | RAC | ZH | 12/12/2022 |
| A | INTERIM SUBMISSION | RAC | ZH | 09/13/2022 |
| REV | DESCRIPTION | DRW BY | CHK BY | DATE |

Kiewit
470 Chestnut Ridge Rd # 2,
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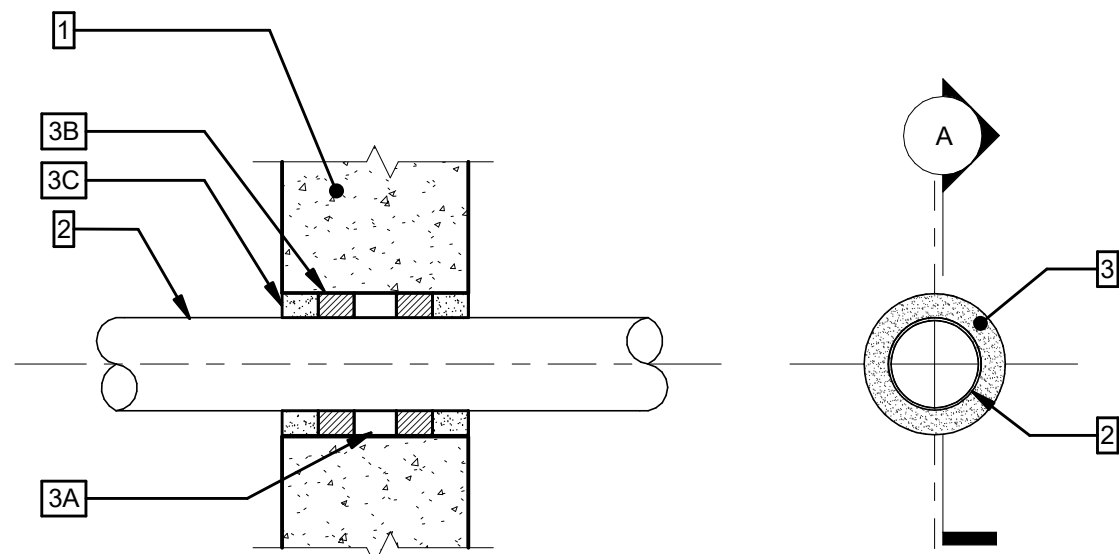
31-45 20th Avenue, Astoria, Queens NY 11105
Block #850 - Lot #310 - BIN #4624437

MISCELLANEOUS DETAILS
6



DATE 12/12/22
PROJECT NO 105121
DRAWING BY R. COLES
CHECKED BY Z. HARR
DRAWING NO
A-618.00
CADD FILE NO
AstoriaHVDC-CHPE
AstoriaCHV-KIE-111-ZZ-M3-A-001.rvt





SECTION "A"

FIRE STOPPING DETAIL, NON-METALLIC PIPE THROUGH MASONRY WALL

UL SYSTEM NO. W-J-2005 FOR, 2 HR. RATING

1. RATED PARTITION REFER TO ARCHITECTURAL DRAWINGS FOR FURTHER INFORMATION. MAXIMUM DIAMETER OF OPENING IS 8".
2. ONE NON-METALLIC PIPE TO BE INSTALLED CENTERED WITHIN THE FIRESTOP SYSTEM. PIPE TO BE RIGIDLY SUPPORTED ON BOTH SIDES OF WALL ASSEMBLY.


PIPE: MAX. NOMINAL 4" DIA (OR SMALLER) SCHEDULE 40 PVC OR SDR17 CPVC PIPE IN CLOSED PIPING SYSTEMS.

- 3A. STEEL SLEEVE OR WIRE MESH — NO. 8 STEEL WIRE MESH HAVING A MIN 1" LAP ALONG THE LONGITUDINAL SEAM. LENGTH OF SLEEVE TO BE 1/4" TO 1/2" LESS THAN OVERALL THICKNESS OF WALL SUCH THAT WHEN INSTALLED IN CIRCULAT OPENING, THE ENDS OF THE SLEEVE ARE RECESSED 1/8" TO 1/4" FROM EACH SURFACE OF THE WALL. SLEEVE MAY ALSO BE FORMED OF MIN 0.034" THICK GALV SHEET STEEL.

- 3B. PACKING MATERIAL — MINERAL WOOL BATT INSULATION FIRMLY PACKED INTO OPENING AS A PERMANENT FORM. PACKING MATERIAL TO BE RECESSED FROM BOTH SURFACES OF WALL AS REQUIRED TO ACCOMMODATE THE REQUIRED THICKNESS OF FILL MATERIAL.

- 3C. FILL, VOID, OR CAVITY MATERIAL - CAULK: MINIMUM 1 1/4" FORMING AND FILL DEPTH APPLIED WITHIN THE ANNULUS, FLUSH WITH BOTH SURFACES OF WALL.

CAULK MANUFACTURED BY:
RECTORSEAL - METACAULK 950, OR APPROVED EQUAL

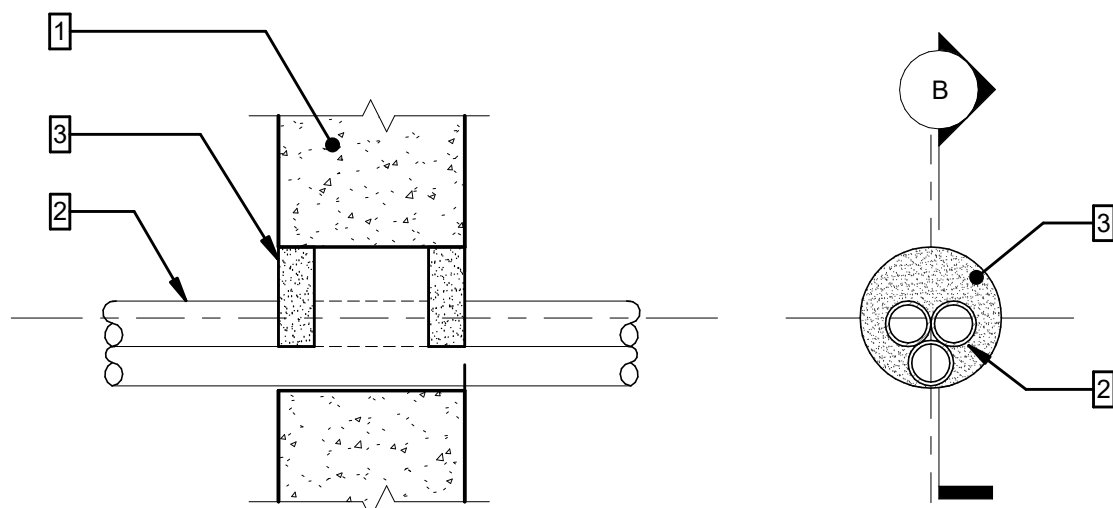

SECTION "B"

FIRE STOPPING DETAIL, NON-METALLIC PIPE THROUGH MASONRY WALL

UL SYSTEM NO. W-J-2043 FOR, 2 HR. RATING


1. RATED PARTITION REFER TO ARCHITECTURAL DRAWINGS FOR FURTHER INFORMATION. MAXIMUM DIAMETER OF OPENING IS 3 1/2".
2. ONE TO THREE NON-METALLIC PIPE, CONDUITS, OR TUBES TO BE BUNDLED TOGETHER AND INSTALLED ECCENTRICALLY OR CONCENTRICALLY WITHIN THE FIRESTOP SYSTEM. SEPARATION BETWEEN PENETRANTS TO BE MIN 0" (POINT OF CONTACT) TO MAX 1". PIPE, CONDUIT OR TUBING TO BE RIGIDLY SUPPORTED ON BOTH SIDES OF WALL ASSEMBLY.

PIPE, CONDUIT OR TUBING:

- A. MAX. NOMINAL 1" DIA (OR SMALLER) SCHEDULE 40 PVC OR SDR17 CPVC PIPE IN CLOSED PIPING SYSTEMS.
- B. RIGID NONMETALLIC CONDUIT: MAX. NOMINAL 1" DIA (OR SMALLER) SCHEDULE 40 PVC CONDUIT INSTALLED IN ACCORDANCE WITH ARTICLE 347 OF NFPA 70.
- C. ELECTRICAL NONMETALLIC TUBING: MAX. NOMINAL 1" DIA (OR SMALLER) SCHEDULE 40 PVC TUBING INSTALLED IN ACCORDANCE WITH ARTICLE 331 OF NFPA 70.
- D. OPTICAL FIBER RACEWAY: MAX. NOMINAL 1" DIA (OR SMALLER) FORMED FROM PVC OR PVDF INSTALLED IN ACCORDANCE WITH ARTICLE 770 OF NFPA 70.
- E. MAX. NOMINAL 1" DIA (OR SMALLER) SDR9 PEX TUBING FOR USE IN CLOSED PIPING SYSTEMS.

3. FILL, VOID, OR CAVITY MATERIAL - SEALANT: MINIMUM 5/8" THICKNESS OF FILL MATERIAL APPLIED WITHIN THE ANNULUS, FLUSH WITH BOTH SURFACES OF WALL ASSEMBLY. SEALANT TO BE FORCED INTO INTERSTICES BETWEEN PENETRANTS TO MAXIMUM EXTENT POSSIBLE. AT POINT OF CONTACT LOCATION, MIN 1/4" DIA BEAD OF FILL MATERIAL APPLIED AT NONMETALLIC PIPE/CONCRETE INTERFACE ON BOTH SURFACES OF WALL.

SEALANT MANUFACTURED BY:
SPECIFIED TECHNOLOGIES INC - SPECSEAL SSS SERIES OR LCI SEALANT, OR APPROVED EQUAL

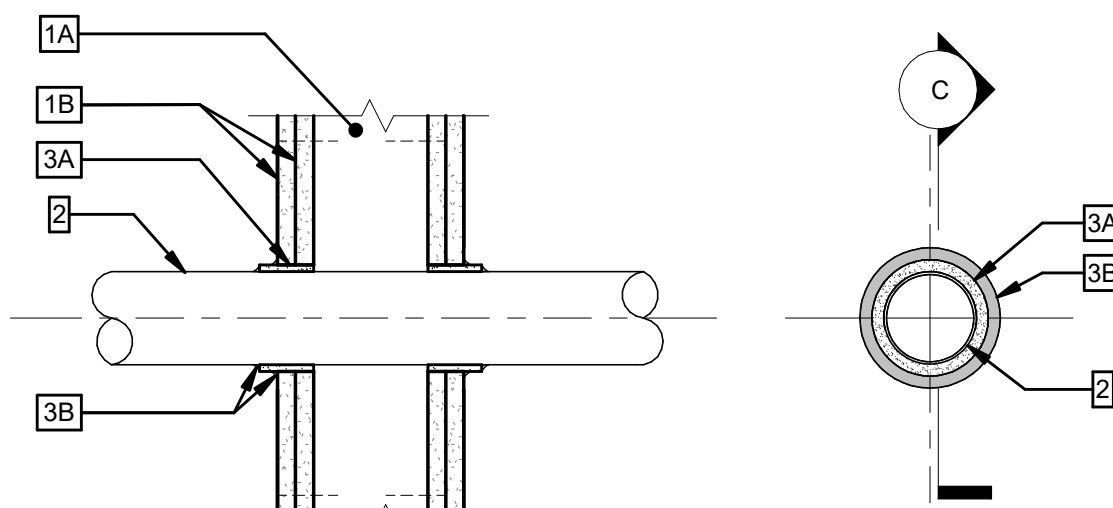

SECTION "C"

FIRE STOPPING DETAIL, NON-METALLIC PIPE THROUGH FRAMED WALL

UL SYSTEM NO. W-L-2003 FOR, 2 HR. RATING

1. RATED PARTITION REFER TO ARCHITECTURAL DRAWINGS FOR FURTHER INFORMATION. MAXIMUM DIAMETER OF OPENING IS 3 1/8".

2. ONE NON-METALLIC PIPE OR CONDUIT TO BE CENTERED IN THE THROUGH OPENING. PIPE OR CONDUIT TO BE RIGIDLY SUPPORTED ON BOTH SIDES OF WALL ASSEMBLY.

PIPE OR CONDUIT:

- A. MAX NOMINAL 2" DIA (OR SMALLER) SCHEDULE 40 SOLID CORE PVC PIPE IN CLOSED OR VENTED SYSTEM.
- B. RIGID NONMETALLIC CONDUIT — MAX NOMINAL 2" DIA (OR SMALLER) SCHEDULE 40 OR 80 PVC CONDUIT INSTALLED IN ACCORDANCE WITH NFPA 70.
- C. MAX NOMINAL 2" DIA (OR SMALLER) SDR13.5 CPVC PIPE IN CLOSED SYSTEMS.
- D. MAX NOMINAL 2" DIA (OR SMALLER) SCHEDULE 40 CELLULAR CORE PVC PIPE IN CLOSED OR VENTED SYSTEMS.
- E. MAX NOMINAL 2" DIA (OR SMALLER) SCHEDULE 40 SOLID CORE ABS PIPE IN CLOSED OR VENTED SYSTEMS.
- F. MAX NOMINAL 2" DIA (OR SMALLER) SCHEDULE 40 CELLULAR CORE ABS PIPE IN CLOSED OR VENTED SYSTEMS.

3. FIRESTOP SYSTEM — INSTALLED SYMMETRICALLY ON BOTH SIDES OF WALL ASSEMBLY.


- A. WRAP STRIP — NOMINAL 1/4" THICK INTUMESCENT ELASTOMERIC MATERIAL FACED ON ONE SIDE WITH ALUMINUM FOIL, SUPPLIED IN 2" WIDE STRIPS. NOMINAL 2" WIDE STRIP TIGHTLY WRAPPED AROUND NONMETALLIC PIPE (FOIL SIDE OUT) WITH SEAM BUTTED. WRAP STRIP LAYER SECURELY BOUND WITH STEEL WIRE OR ALUMINUM FOIL TAPE AND SLID INTO ANNULAR SPACE APPROX 1-1/4" SUCH THAT APPROX 3/4" OF THE WRAP STRIP PROTRUDES FROM THE WALL SURFACE.

WRAP STRIP MANUFACTURED BY:
3M COMPANY - FS-195+, OR APPROVED EQUAL

- B. CAULK, SEALANT OR PUTTY — MIN 5/8" THICKNESS OF CAULK OR PUTTY APPLIED INTO ANNULAR SPACE BETWEEN WRAP STRIP AND PERIPHERY OF OPENING. A NOM 1/4" DIA BEAD OF CAULK OR PUTTY TO BE APPLIED TO THE WRAP STRIP/WALL INTERFACE AND TO THE EXPOSED EDGE OF THE WRAP STRIP LAYERS APPROX 3/4" FROM THE WALL SURFACE.

CAULK, SEALANT OR PUTTY MANUFACTURED BY 3M COMPANY OR APPROVED EQUAL
CP 25WB+ CAULK OR MP+ STIX PUTTY, IC 15WB+ CAULK, FIREDAM 150+ CAULK OR FB-3000 WT SEALANT

- C. FOIL TAPE (NOT SHOWN) — NOMNAL 4" WIDE, 3 MIL THICK ALUMINUM TAPE WRAPPED AROUND PIPE PRIOR TO THE INSTALLATION OF THE WRAP STRIP (ITEM 3A), MIN OF ONE WRAP, FLUSH WITH BOTH SIDES OF WALL AND PROCEEDING OUTWARD.

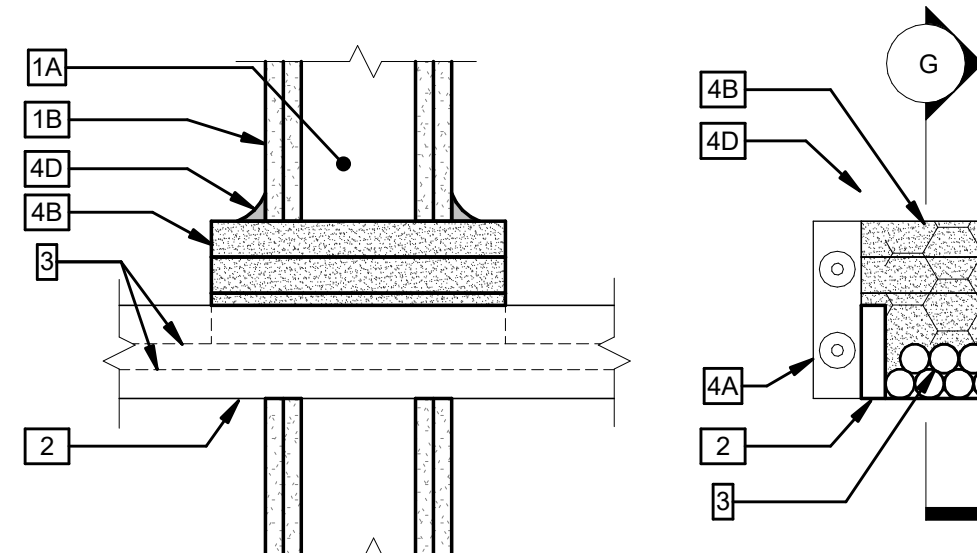

SECTION "G"

FIRE STOPPING DETAIL, CABLE TRAY THROUGH FRAMED WALL

UL SYSTEM NO. W-L-4003 FOR, 2 HR. RATING

1. RATED PARTITION REFER TO ARCHITECTURAL DRAWINGS FOR FURTHER INFORMATION. MAXIMUM AREA OF OPENING IS 160 SQUARE INCHES WITH MAX DIMENSION OF 20".

2. ONE CABLE TRAY SHALL BE INSTALLED IN THE OPENING. THE ANNULAR SPACE BETWEEN THE CABLE TRAY THE AND TOP AND BOTTOM OF THE OPENING SHALL RANGE FROM 0" (POINT CONTACT) TO A MAX 2". THE ANNULAR SPACE BETWEEN THE CABLE TRAY AND EACH SIDE SHALL BE A NOMINAL 1".

CABLE TRAY:

- A. MAX 18" WIDE BY 6" DEEP OPEN LADDER CABLE FORMED FROM NO. 16 MSG (0.060") THICK GALV STEEL WITH 1" WIDE BY 3/4" DEEP GALV STEEL RUNGS SPACED 9" OC.
- B. MAX 18" WIDE BY 4" DEEP OPEN LADDER ALUMINUM TRAY FORMED FROM 0.060 IN. THICK ALUMINUM WITH 1 IN. WIDE BY 1-7/16 IN. DEEP ALUMINUM RUNGS SPACED 9 IN. OC.

3. AGGREGATE CROSS-SECTIONAL AREA OF CABLES IN CABLE TRAY TO BE MAX 30 PERCENT OF THE CROSS-SECTIONAL AREA OF THE CABLE TRAY BASED ON A MAX 3" CABLE LOADING DEPTH WITHIN THE CABLE TRAY. THE MAX CABLE LOADING WITHIN THE CABLE TRAY IS DEPENDENT UPON THE DEPTH OF THE CABLE TRAY. FOR CABLE TRAYS HAVING A DEPTH OF 4 IN. OR LESS, THE MAX CABLE LOADING DEPTH IS 30 PERCENT. FOR CABLE TRAYS HAVING A DEPTH GREATER THAN 4 IN., THE MAX CABLE LOADING IS 18 PERCENT. ANY COMBINATION OF THE FOLLOWING TYPES AND SIZES OF COPPER CONDUCTOR CABLES MAY BE USED:

CABLES:

- A. MAX 1/C NO. 300 KCMIL CABLE WITH XLPE JACKET.

4. FIRESTOP SYSTEM


- A. STEEL CHANNEL — "C" SHAPED CHANNEL FIELD FABRICATED FROM MIN NO. 30 MSG (0.016 IN.) THICK GALV SHEET STEEL. CHANNEL SHALL CONSIST OF TWO MIN 3" WIDE BY 6" LONG FLANGE AND A MIN 5" DEEP BY 6" WIDE WEB. THE CHANNELS SHALL BE FITTED AGAINST EACH SIDE OF THE OPENING. EACH FLANGE SHALL BE SECURED TO THE STEEL STUDS ON BOTH SURFACES OF THE WALL BY MEANS OF 2-1/4" LONG TYPE S SELF-DRILLING, SELF-TAPPING BUGLE-HEAD STEEL SCREWS AND 1/4" BY 1-1/2" DIA STEEL FENDER WASHERS, SPACED 4" OC.
- B. PILLOWS — MAX 9-1/2" LONG BY 8" WIDE BY 2-1/4" THICK PLASTIC COVERED INTUMESCENT PILLOWS. PILLOWS TO BE INSTALLED WITH 9-1/2" DIMENSION PROJECTING THROUGH WALL AND CENTERED WITHIN THE OPENING OF THE WALL ASSEMBLY. PILLOWS TIGHTLY PACKED INTO OPENING TO FILL THE ANNULAR SPACE BETWEEN CABLES AND PERIPHERY OF OPENING AND BETWEEN CABLE TRAY AND PERIPHERY OF OPENING.

PILLOW MANUFACTURED BY:
EGS NELSON FIRESTOP - TYPE PLW, OR APPROVED EQUAL

- C. PUTTY (NOT SHOWN) — AFTER INSTALLATION OF THE PILLOWS, PUTTY SHALL BE APPLIED TO SEAL ANY VOIDS BETWEEN THE CABLES AND THE PILLOWS AND BETWEEN THE CABLE TRAY AND THE PILLOWS ON BOTH SIDES OF WALL ASSEMBLY.

PUTTY MANUFACTURED BY:
EGS NELSON FIRESTOP - TYPE FSP PUTTY, OR APPROVED EQUAL

- D. WIRE LATH NOMINAL 2" HEXAGONAL SHAPED WIRE LATH FABRICATED FROM MIN NO. 19 SWG (0.041 IN.) GALV STEEL WIRE. WIRE LATH CUT TO FIT THE CONTOUR OF THE OPENING WITH A MIN 3" LAP BEYOND THE PERIPHERY OF THE OPENING TO KEEP THE PILLOWS IN PLACE. WIRE LATH SECURED TO BOTH SURFACES OF WALL ASSEMBLY BY MEANS OF 2-1/4 IN. LONG TYPE S SELF-DRILLING, SELF-TAPPING BUGLE-HEAD STEEL SCREWS AND 1/4 IN. BY 1-1/2 IN DIAM STEEL FENDER WASHERS, SPACED 6 IN. OC.

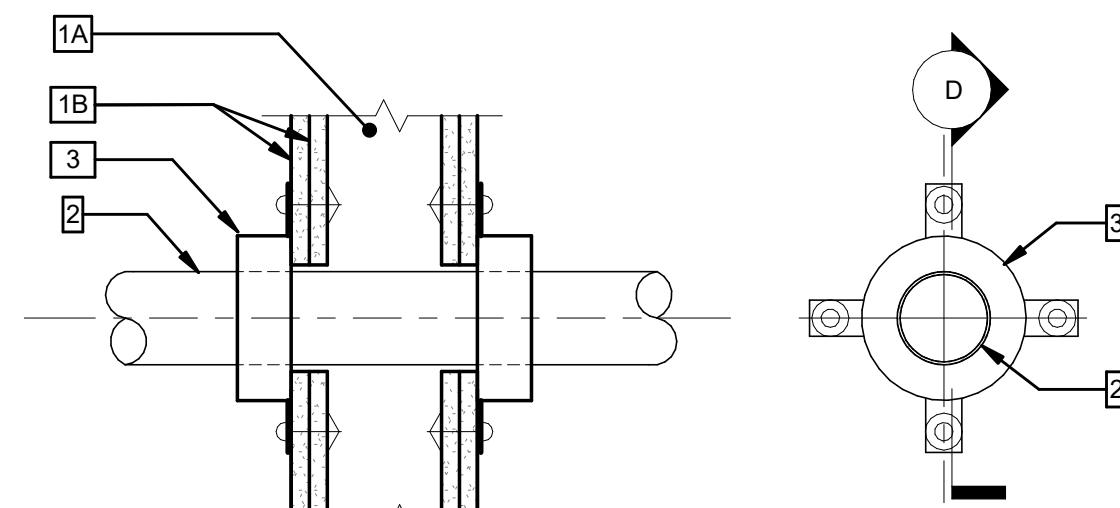

SECTION "D"

FIRE STOPPING DETAIL, NON-METALLIC PIPE THROUGH FRAMED WALL

UL SYSTEM NO. W-L-2037 FOR, 2 HR. RATING

1. RATED PARTITION REFER TO ARCHITECTURAL DRAWINGS FOR FURTHER INFORMATION. MAXIMUM DIAMETER OF OPENING IS 9 1/8".


2. ONE NON-METALLIC PIPE OR CONDUIT TO BE CENTERED WITHIN THE FIRESTOP SYSTEM. THE ANNULAR SPACE BETWEEN PIPE OR CONDUIT AND PERIPHERY OF OPENING SHALL BE MIN 0" (POINT CONTACT) TO MAX 1/16". PIPE OR CONDUIT TO BE RIGIDLY SUPPORTED ON BOTH SIDES OF WALL ASSEMBLY.

PIPE OR CONDUIT:

- A. MAX NOMINAL 8" DIA (OR SMALLER) SCHEDULE 40 SOLID CORE PVC PIPE IN CLOSED OR VENTED SYSTEM.
- B. RIGID NONMETALLIC CONDUIT — MAX NOMINAL 4" DIA (OR SMALLER) SCHEDULE 40 PVC CONDUIT INSTALLED IN ACCORDANCE WITH ARTICLE 347 OF NFPA 70.
- C. MAX NOMINAL 4" DIA (OR SMALLER) SDR 17 CPVC PIPE IN CLOSED SYSTEMS.
- D. MAX NOMINAL 2" DIA (OR SMALLER) SCHEDULE 40 CELLULAR CORE ABS PIPE IN CLOSED OR VENTED SYSTEMS.
- F. MAX NOMINAL 4" DIA (OR SMALLER) SCHEDULE 40 FRPP PIPE IN CLOSED OR VENTED SYSTEMS.

3. FIRESTOP DEVICE - GALV STEEL COLLAR LINED WITH AN INTUMESCENT MATERIAL SIZED TO FIT THE SPECIFIC DIAMETER OF THE THROUGH-PENETRANT. DEVICE SHALL INCORPORATE FOUR ANCHOR TABS FOR SECUREMENT TO EACH SURFACE OF WALL ASSEMBLY BY MEANS OF 1/8" DIA BY 3" LONG TOGGLE BOLTS IN CONJUNCTION WITH 1/8" DIA BY 3/4" AND 1/4" DIA BY 1-1/4" STEEL FENDER WASHERS.

COLLAR MANUFACTURED BY:
RECTORSEAL - FSD DEVICE, OR APPROVED EQUAL

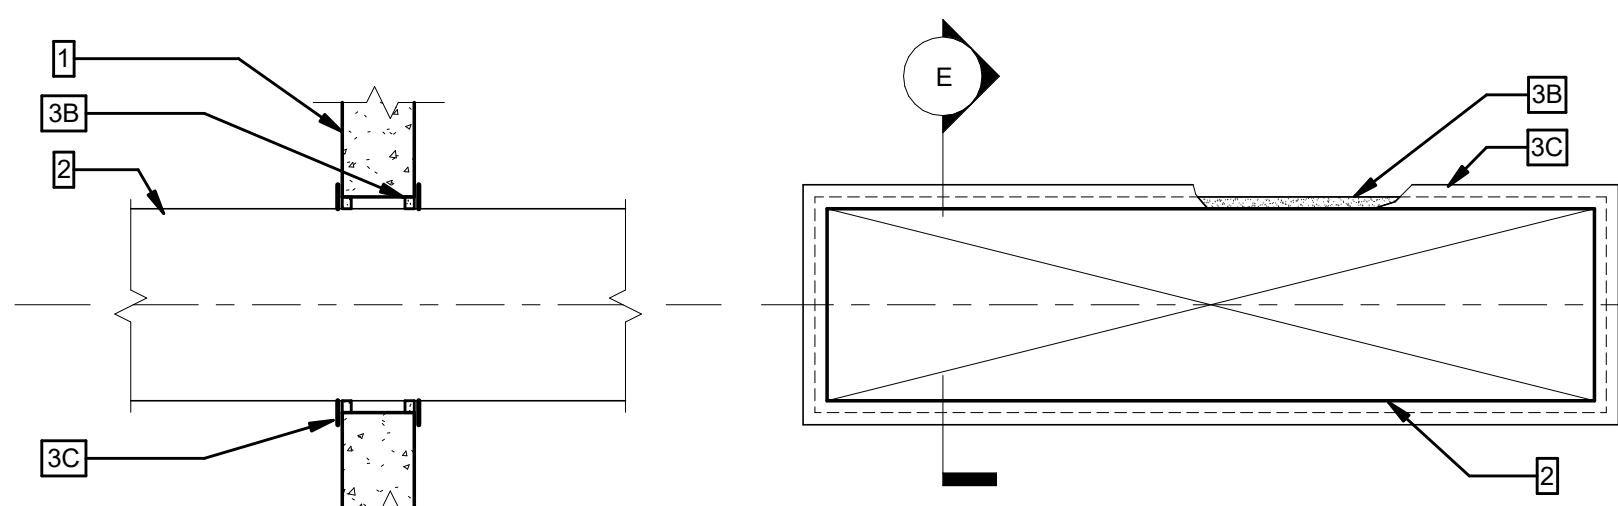

SECTION "E"

FIRE STOPPING DETAIL, STEEL DUCT THROUGH MASONRY WALL


UL SYSTEM NO. W-J-7007 FOR, 2 HR. RATING

1. RATED PARTITION REFER TO ARCHITECTURAL DRAWINGS FOR FURTHER INFORMATION. MAXIMUM AREA OF OPENING IS 73.7 SF WITH MAX DIMENSION OF 104".

2. ONE GALV STEEL DUCT, NO 26 GAUGE (OR HEAVIER), MAX 100" BY 100" TO BE INSTALLED EITHER CONCENTRICALLY OR ECCENTRICALLY WITHIN THE FIRESTOP SYSTEM. THE SPACE BETWEEN THE STEEL DUCT AND PERIPHERY OR OPENING SHALL MIN 0" (POINT CONTACT) TO MAX 2". STEEL DUCT TO BE RIGIDLY SUPPORTED ON BOTH SIDES OF THE WALL ASSEMBLY.
- 3A. PACKING MATERIAL — (OPTIONAL, NOT SHOWN) - POLYETHYLENE BACKER ROD, MINERAL WOOL BATT INSULATION OR FIBERGLASS BATT INSULATION FRICTION FITTED INTO ANNULAR SPACE OF OPENING. PACKING MATERIAL TO BE RECESSED FROM BOTH SURFACES OF WALL AS REQUIRED THICKNESS OF FILL MATERIAL.
- 3B. SEALANT — MIN 5/8" THICKNESS OF FILL MATERIAL APPLIED WITHIN THE ANNULUS, FLUSH WITH BOTH SURFACES OF WALL. AT THE POINT CONTACT LOCATION BETWEEN THE STEEL DUCT AND THE CONCRETE WALL, A MIN 1/4" DIA BEAD OF FILL MATERIAL SHALL BE APPLIED AT THE CONCRETE/STEEL DUCT INTERFACE ON BOTH SURFACES OF WALL ASSEMBLY.

SEALANT MANUFACTURED BY:
SPECIFIED TECHNOLOGIES INC - SPECSEAL SERIES SSS OR LCI SEALANT, OR APPROVED EQUAL

- 3C. STEEL RETAINING ANGLES — MIN NO. 16 GAUGE GALV STEEL ANGLES SIZED TO LAP STEEL DUCT A MIN OF 2" AND TO LAP WALL SURFACES A MIN OF 1". ANGLES ATTACHED TO STEEL DUCT ON BOTH SIDES OF WALL WITH MIN NO. 10 BY 1/2" LONG STEEL SHEET METAL SCREWS LOCATED A MAX OF 1" FROM EACH END OF THE STEEL DUCT AND SPACED A MAX OF 6" OC.

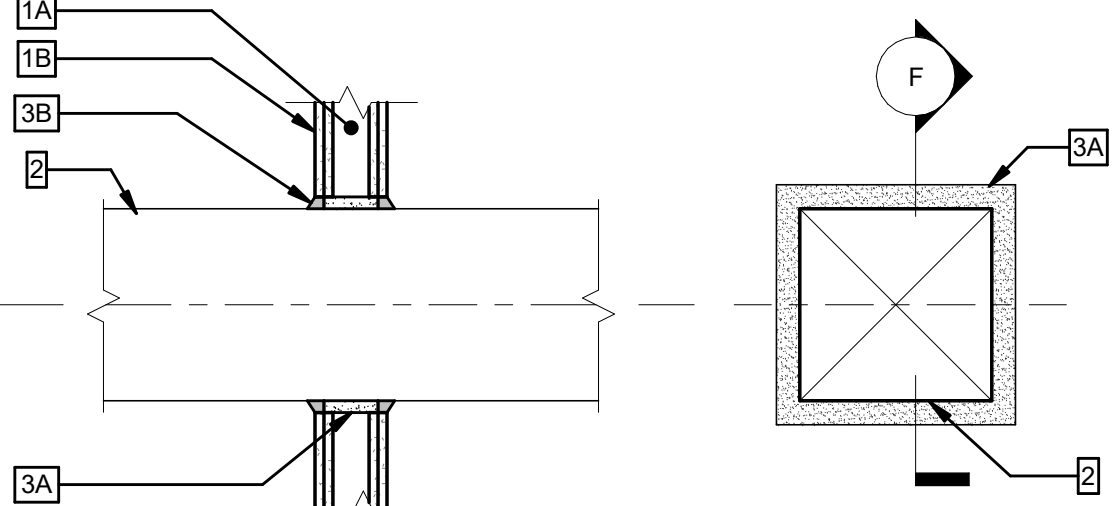

SECTION "F"

FIRE STOPPING DETAIL, STEEL DUCT THROUGH MASONRY WALL

UL SYSTEM NO. W-J-7006 FOR, 2 HR. RATING

1. RATED PARTITION REFER TO ARCHITECTURAL DRAWINGS FOR FURTHER INFORMATION. MAXIMUM AREA OF OPENING IS 196 SQUARE INCHES WITH MAX DIMENSIONS OF 14".

2. ONE GALV STEEL DUCT, NO 24 GAUGE (OR HEAVIER), MAX NOMINAL 12" BY 12" (OR SMALLER) TO BE CENTERED WITHIN THE FIRESTOP SYSTEM. A NOMINAL 1" ANNULAR SPACE IS REQUIRED. STEEL DUCT TO BE RIGIDLY SUPPORTED ON BOTH SIDES OF THE WALL ASSEMBLY.
- 3A. PACKING MATERIAL — MIN 3-1/2" THICKNESS OF MIN 4 PCF MINERAL WOOL BATT INSULATION FIRMLY PACKED INTO OPENING AS A PERMANENT FORM. PACKING MATERIAL TO BE RECESSED FROM BOTH SURFACES OF WALL TO ACCOMMODATE THE REQUIRED THICKNESS OF FILL MATERIAL.
- 3B. SEALANT — MIN 3/4" THICKNESS OF FILL MATERIAL APPLIED WITHIN THE ANNULUS, ON BOTH SURFACES OF WALL. ADDITIONAL FILL MATERIAL TO BE INSTALLED SUCH THAT A MIN 1/4" THICK CROWN IS FORMED AROUND THE PENETRATING ITEM AND LAPPING A MIN 1/4" BEYOND THE PERIPHERY OF THE OPENING.

SEALANT MANUFACTURED BY:
RECTORSEAL - FLAMESAFE FS1900, METACAULK 1000, METACAULK 350i, BIOSTOP 350i, BIOSTOP 500+, OR APPROVED EQUAL

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Land Surveying, P.C.

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SUITE 1604
New York, NY 10001

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| REV | DESCRIPTION | DRW BY | CHK BY | DATE |
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| B | FINAL SUBMISSION | RAC | ZH | 12/12/2022 |
| A | INTERIM SUBMISSION | RAC | ZH | 09/13/2022 |

Kiewit
470 Chestnut Ridge Rd # 2,
Woodcliff Lake, NJ 07677

Hitachi Energy
901 Main Campus Drive
Raleigh, North Carolina 27606

PROJECT

CHPE
Champlain Hudson
Power Express

Astoria HVDC
Converter Station


31-45 20th Avenue, Astoria, Queens NY 11105
Block #850 - Lot #310 - BIN #4624437

TYPICAL FIRESTOPPING
DETAILS I



DATE 12/12/22
PROJECT NO 105121
DRAWING BY R. COLES
CHECKED BY Z. HARR
DRAWING NO
A-619.00
CADD FILE NO
Astoria CHA-KE-111-ZZ-M3-A-001.rvt

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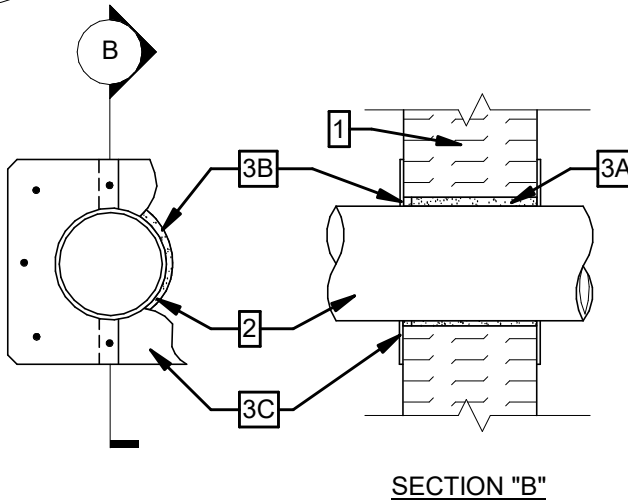


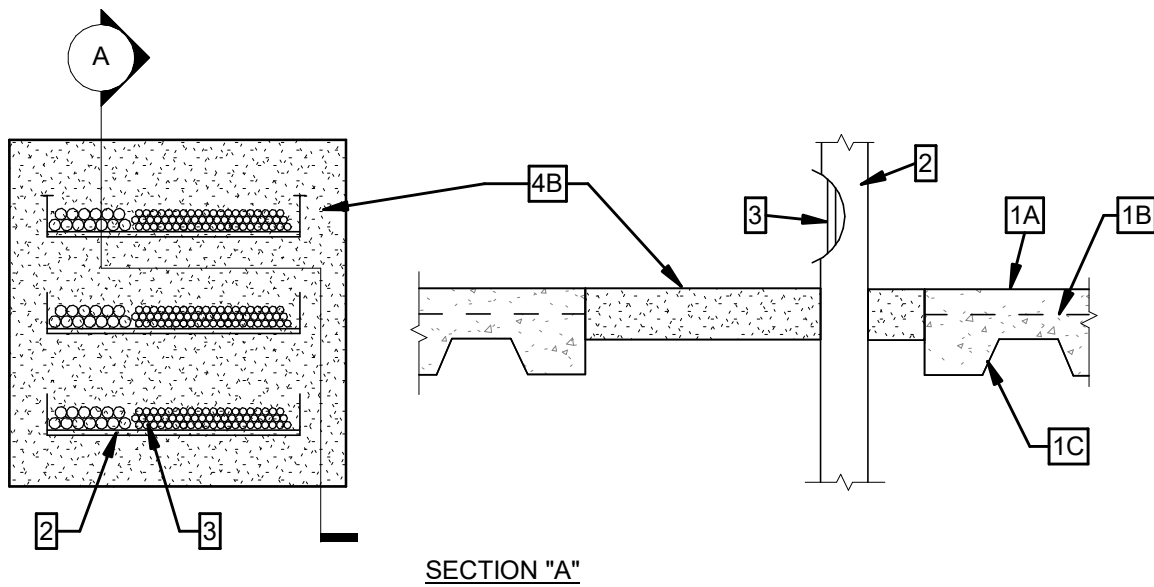FIRE STOPPING DETAIL, THROUGH-PENETRATION FIRESTOP SYSTEMS

UL SYSTEM NO. F-A-4002 FOR, 3 HR. RATING

- THE FIRE-RATED UNPROTECTED STEEL DECK FLOOR-CEILING ASSEMBLY SHALL BE CONSTRUCTED OF THE MATERIALS AND IN THE MANNER SPECIFIED IN THE INDIVIDUAL D900 SERIES DESIGNS IN THE UL FIRE RESISTANCE DIRECTORY AND AS SUMMARIZED BELOW:
 - CONCRETE THICKNESS ABOVE THE CREST OF THE DECK SHALL BE MIN 2-1/2" NORMAL WEIGHT CONCRETE WITH CARBONATE OR SILICEOUS AGGREGATE, 145 TO 155 PCF UNIT WEIGHT, MIN 3000 PSI COMPRESSIVE STRENGTH, LIGHTWEIGHT CONCRETE EXPANDED SHALE, CLAY, OR SLATE AGGREGATE, 105 TO 115 PCF UNIT WEIGHT, MIN 3000 PSI COMPRESSIVE STRENGTH.
 - WELDED WIRE FABRIC - 6 X 6, W1.4 X W1.4.
 - STEEL FLOOR AND FORM UNITS - COMPOSITE OR NONCOMPOSITE 1-5/16" TO 3" DEEP GALV UNITS OR AS SPECIFIED IN THE INDIVIDUAL FLOOR-CEILING DESIGNS. MAX AREA OF OPENING IS 1024 SQ IN. WITH MAX DIMENSION OF 32".
- THE FOLLOWING TYPES OF CABLE TRAYS MAY BE USED:
 - MAX 24" WIDE BY MAX 4" DEEP OPEN-LADDER CABLE TRAY WITH CHANNEL-SHAPED SIDE RAILS FORMED OF MIN 0.048" THICK STEEL AND WITH RUNGS SPACED 9" IN OC.
 - MAX 24" WIDE BY MAX 4" DEEP OPEN-LADDER CABLE TRAY FORMED OF MIN 0.060" THICK ALUMINUM SIDE RAILS AND WITH RUNGS SPACED 9" OC.A MAX OF THREE CABLE TRAYS TO BE INSTALLED IN THE OPENING. OF THE THREE CABLE TRAYS, ONLY ONE MAY BE ALUMINUM. THE ANNULAR SPACE BETWEEN CABLE TRAYS SHALL BE A MIN 5-1/4". THE ANNULAR SPACE BETWEEN CABLE TRAYS AND PERIPHERY OF THE OPENING SHALL BE MIN 1 IN. CABLE TRAYS TO BE RIGIDLY SUPPORTED ON BOTH SIDES OF FLOOR OR WALL ASSEMBLY.
- CABLES - AGGREGATE CROSS-SECTIONAL AREA OF CABLES IN CABLE TRAY SHALL BE MAX 30 PERCENT OF THE CROSS-SECTIONAL AREA OF STEEL CABLE TRAY AND MAX 20 PERCENT OF THE CROSS-SECTIONAL AREA OF ALUMINUM CABLE TRAY, BASED ON A MAX 3" CABLE LOADING DEPTH WITHIN THE CABLE TRAY. ANY COMBINATION OF THE FOLLOWING TYPES AND SIZES OF COPPER CONDUCTOR CABLES MAY BE USED:
 - MAX 350 KCMIL SINGLE-CONDUCTOR POWER CABLES WITH POLYVINYL CHLORIDE (PVC) INSULATION AND JACKET.
 - MAX 7/C NO. 12 AWG COPPER CONDUCTOR CABLE WITH PVC INSULATION AND JACKET.
 - MAX 100 PAIR NO. 24 AWG CABLE WITH PVC INSULATION AND JACKET.
 - MAX 3/C NO. 2 AWG COPPER CONDUCTOR CABLE WITH PVC INSULATION AND JACKET.
 - MAX 3/C NO. 16 AWG COPPER CONDUCTOR CABLE WITH PVC INSULATION AND JACKET.
 - FIBER OPTICAL COMMUNICATION CABLE 62.5/125 UM.
- THE FIRESTOP SYSTEM SHALL CONSIST OF THE FOLLOWING:
 - FORMS — (NOT SHOWN) — USED AS A FORM TO PREVENT LEAKAGE OF FILL MATERIAL DURING INSTALLATION. FORMS TO BE A RIGID SHEET MATERIAL, CUT TO FIT THE CONTOUR OF THE PENETRATING ITEM AND POSITIONED AS REQUIRED TO ACCOMMODATE THE REQUIRED THICKNESS OF FILL MATERIALS. FORMS MAY BE REMOVED AFTER FILL MATERIAL HAS CURED.
 - FILL, VOID OR CAVITY MATERIAL — MORTAR — MIN 2-1/2" THICKNESS OF FILL MATERIAL APPLIED WITHIN THE ANNULUS FLUSH WITH TOP SURFACE OF FLOOR. MORTAR TO BE RECESSED INTO INTERSTICES OF CABLES TO MAX EXTENT POSSIBLE. MORTAR TO BE MIXED WITH WATER AT A RATE OF 1.9 TO 2.4 GAL (7-9 LITERS) PER 25 LB BAG IN ACCORDANCE WITH MANUFACTURERS INSTALLATION INSTRUCTIONS.

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TYPICAL WALL PENETRATION FIRESTOPPING II
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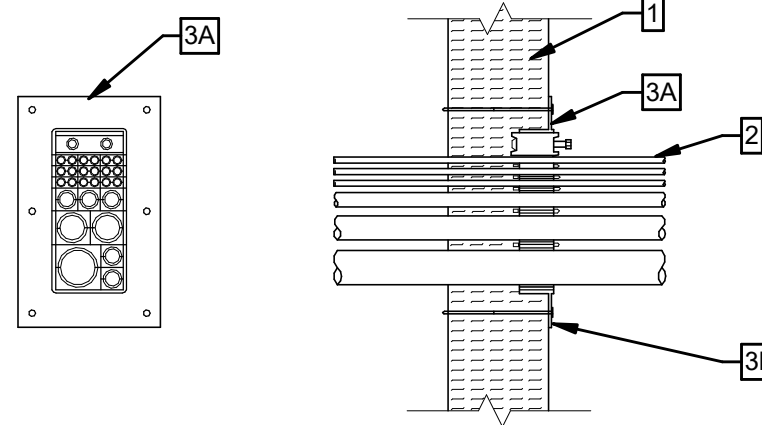


FIRE STOPPING DETAIL, THROUGH PENETRATION FIRESTOP SYSTEMS

UL SYSTEM NO. W-N-1001 FOR, 2 HR. RATING

- WALL ASSEMBLY — THE 1 OR 2 HR FIRE RATED COMPOSITE WALL ASSEMBLY SHALL BE CONSTRUCTED OF NOM 4" OR 7" THICK, RESPECTIVELY, GALVANIZED STEEL OR PAINTED GALVANIZED STEEL FACED PARTITION PANEL UNITS (CJMR) INSTALLED IN THE MANNER SPECIFIED IN WALL AND PARTITION DESIGN NO. U050 IN THE FIRE RESISTANCE DIRECTORY. MAX DIAM OF OPENING IS 20-1/4". OPENING CAN BE LOCATED ON OR OFF PANEL UNIT JOINTS.
- THROUGH-PENETRANTS — ONE METALLIC PIPE, CONDUIT OR TUBE TO BE INSTALLED ECCENTRICALLY OR CONCENTRICALLY WITHIN THE OPENING. AN ANNULAR SPACE OF MIN 1/4 IN. (6 MM) TO MAX 1/2 IN. (13 MM) IS REQUIRED WITHIN THE FIRESTOP SYSTEM. PIPE, CONDUIT OR TUBE TO BE RIGIDLY SUPPORTED ON BOTH SIDES OF THE WALL ASSEMBLY. THE FOLLOWING TYPES AND SIZES OF METALLIC PIPES, CONDUIT OR TUBING MAY BE USED:
 - STEEL PIPE — NOM 18" DIAM (OR SMALLER) SCHEDULE 10 (OR HEAVIER) STEEL PIPE.
 - IRON PIPE — NOM 18" DIAM (OR SMALLER) CAST OR DUCTILE IRON PIPE.
 - CONDUIT — NOM 6" DIAM (OR SMALLER) STEEL ELECTRICAL METALLIC TUBING OR NOM 4 IN. DIAM (OR SMALLER) STEEL CONDUIT.
 - COPPER TUBING — NOM 6" DIAM (OR SMALLER) TYPE L (OR HEAVIER) COPPER TUBING.
 - COPPER PIPE — NOM 6" DIAM (OR SMALLER) REGULAR (OR HEAVIER) COPPER PIPE.
- FIRESTOP SYSTEM — THE FIRESTOP SYSTEM SHALL CONSIST OF THE FOLLOWING:
 - PACKING MATERIAL — MIN 4 PCF (64 KG/M3) MINERAL WOOL BATT INSULATION FIRMLY PACKED INTO OPENING AS A PERMANENT FORM. MIN 3-1/4" AND MIN 6-1/4" THICKNESS REQUIRED FOR 1 HR AND 2 HR FIRE RATED WALLS, RESPECTIVELY. PACKING MATERIAL MAY BE RECESSED FROM ONE OR BOTH SURFACES OF WALL TO ACCOMMODATE THE THICKNESS OF THE OPTIONAL FILL MATERIAL (ITEM 3B).
 - FILL, VOID OR CAVITY MATERIAL* — SEALANT — (OPTIONAL) - NOM 3/8" THICKNESS OF FILL MATERIAL APPLIED WITHIN THE ANNULUS, FLUSH WITH ONE OR BOTH WALL SURFACES. SEE FILL, VOID OR CAVITY MATERIAL (XHHW) CATEGORY IN THE FIRE RESISTANCE DIRECTORY FOR THE NAMES OF MANUFACTURERS. ANY SEALANT OR CAULK MATERIAL MEETING THE ABOVE SPECIFICATION AND BEARING THE UL CLASSIFICATION MARKING MAY BE USED.
 - COVER PLATE — COVER PLATE AVAILABLE FROM THE WALL PANEL MANUFACTURER OR FIELD PROVIDED. COVER PLATE FABRICATED FROM TWO PIECES OF MIN 0.019" THICK GALV OR PAINTED GALV SHEET STEEL, CUT TO THE SHAPE AS SHOWN IN DETAIL ABOVE. INSIDE DIAMETER OF COVER PLATE TO EQUAL OUTSIDE DIAMETER OF PENETRANT. OUTSIDE DIMENSION OF COVER PLATE TO BE 4" GREATER THAN OUTER DIAM OF PENETRANT, WITH A RADIUS 2" GREATER THAN OUTER RADIUS OF METALLIC PENETRANT. TWO HALVES OF COVER PLATE INSTALLED AROUND THROUGH PENETRANT WITH NOM 1" OVERLAP AT THE MATING ENDS. COVER PLATE TO BE INSTALLED ON BOTH SIDES OF WALL AND SECURED TO STEEL WALL PANEL SKINS WITH MIN 1/8" DIAM STAINLESS STEEL RIVETS OR NO. 12 BY MIN 1/2" LONG HEX WASHER HEAD (HWH) STEEL SCREWS. ONE FASTENER TO BE LOCATED AT EACH OVERLAP WITH INTERMEDIATE FASTENERS LOCATED MAX 4" ON CENTER AROUND PERIPHERY OF OPENING. FASTENERS LOCATED MIN 3/8" FROM CUT OPENING IN WALL PANEL.

4
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TYPICAL INSULATED METAL WALL PANEL
THROUGH-PENETRATION FIRESTOP SYSTEM - PIPING
N.T.S.




FIRE STOPPING DETAIL THROUGH-PENETRATION FIRESTOP SYSTEMS

UL SYSTEM NO. W-N-8002, 2 HR. RATING

- THROUGH-PENETRANTS — WITHIN THE LOADING AREA FOR THE FIRESTOP DEVICE, THE PENETRANTS MAY REPRESENT A 0 TO 100 PERCENT VISUAL FILL. PENETRANTS TO BE INSTALLED THROUGH THE FIRESTOP DEVICE AND THE INSULATION CORE OF THE PARTITION PANEL TO PASS THROUGH THE OPENING. PENETRANTS TO BE RIGIDLY SUPPORTED ON BOTH SIDES OF WALL ASSEMBLY.
 - CABLES — THE FOLLOWING CABLE TYPES MAY BE USED:
 - METALLIC PENETRANTS — THE FOLLOWING TYPES AND SIZES OF METALLIC PENETRANTS MAY BE USED:
- FIRESTOP SYSTEM — THE FIRESTOP SYSTEM SHALL CONSIST OF THE FOLLOWING:
 - FIRESTOP DEVICES — FIRESTOP DEVICES EACH CONSIST OF A RECTANGULAR STEEL FRAME WITH INTEGRAL FLANGE, MULTI DIAMETER ELASTOMERIC SEALING MODULES, STEEL STAY PLATES AND A COMPRESSION UNIT CONSISTING OF A ROXTEC WEDGE (OR OTHER APPROVED MATERIAL). FIRESTOP DEVICE FRAME SHALL BE INSTALLED INTO THE PANEL CUTOUT AT ONE SIDE OF WALL WITH THE FLANGE OF DEVICE INSTALLED FLUSH AGAINST STEEL SKIN OF PARTITION PANEL. THE RECTANGULAR PACKING AREA OF EACH FRAME SHALL BE FILLED WITH MULTIPLE ROWS OF MULTI DIAMETER ELASTOMERIC SEALING MODULES WITH A MAX OF ONE CABLE IN EACH SEALING MODULE. THE LAYERS OF THE MULTI DIAMETER SEALING MODULE HALVES ARE REMOVED ONE BY ONE UNTIL A MAX GAP OF 0.04" IS FORMED BETWEEN THE TWO MODULE HALVES. WHEN THE NUMBER OF SEALING MODULES EXCEEDS THE NUMBER OF CABLES, THE SOLID CYLINDRICAL CORES OF THE UNPENETRATED SEALING MODULES SHALL BE LEFT IN PLACE OR "BLANK" (SOLID) SEALING MODULES SHALL BE USED. DURING INSTALLATION OF THE ELASTOMERIC SEALING MODULES, THIN STEEL STAY PLATES SHALL BE USED TO SEPARATE THE ROWS OF SEALING MODULES AND TO RETAIN THE SEALING MODULES WITHIN THE STEEL FRAME. AFTER INSTALLATION OF THE MODULES, THE BOLTS OF THE COMPRESSION UNIT ARE TIGHTENED TO FORM AN EFFECTIVE SEAL AROUND THE THROUGH PENETRANTS AND INSERT MODULES. FIRESTOP DEVICE SECURED IN PLACE WITH MIN 1/4" DIAM BY MIN 6-1/2" LONG WASHER HEAD LAG SCREWS WITHIN EACH PREFORMED HOLE IN DEVICE FLANGE AROUND PERIPHERY OF OPENING AND EXTENDING THROUGH FULL THICKNESS OF PARTITION PANEL. THE FIRESTOP DEVICES SHALL BE INSTALLED IN ACCORDANCE WITH THE ACCOMPANYING INSTALLATION INSTRUCTIONS.
 - FILL, VOID OR CAVITY MATERIAL — SEALANT — NOM 3/8" BEAD OF FILL MATERIAL APPLIED AROUND THE PERIPHERY OF THE FIRESTOP DEVICE FRAME FLANGE AT THE INTERFACE WITH THE STEEL SKIN OF THE PARTITION PANEL. IN ADDITION, FOR L RATING, SEALANT SHALL BE APPLIED ON THE DEVICE FRAME FLANGE TO SEAL EACH SCREW HEAD LOCATION AND AT THE PANEL SEAM.

2
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ROXTEC THROUGH-PENETRATION FIRESTOP
N.T.S.

3
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THROUGH-PENETRATION FIRESTOPPING
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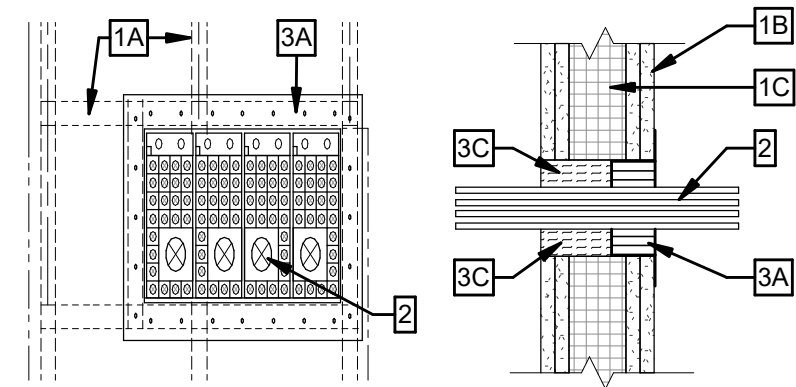


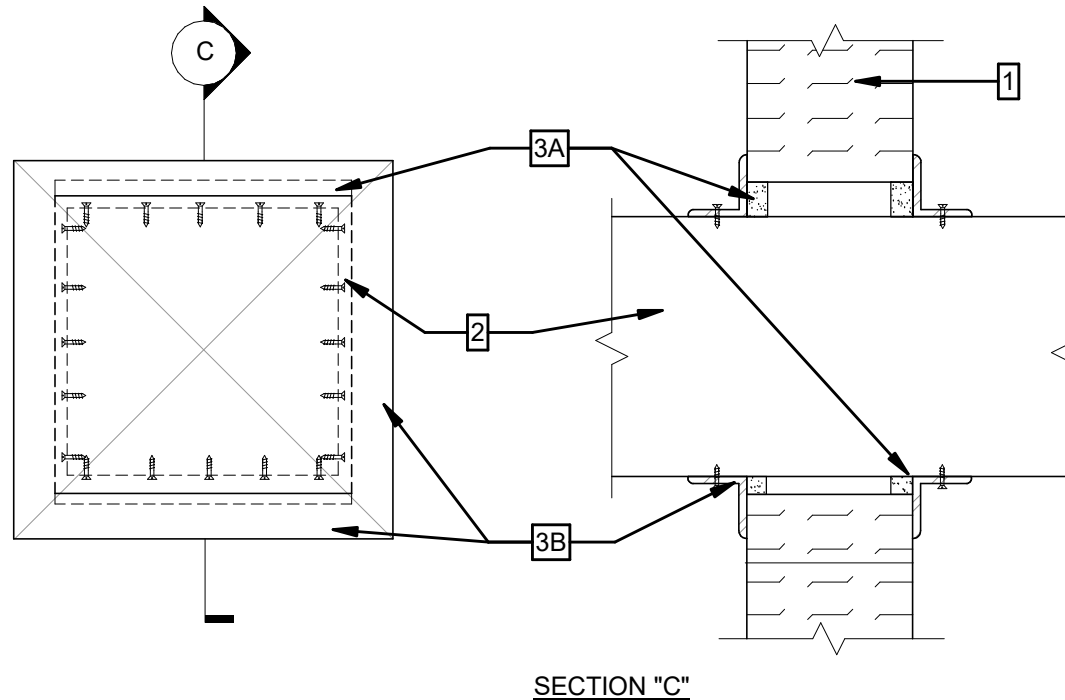FIRE STOPPING DETAIL, THROUGH PENETRATION FIRESTOP SYSTEMS

UL SYSTEM NO. W-N-7001 FOR, 2 HR. RATING

- WALL ASSEMBLY — THE 1 OR 2 HR FIRE RATED COMPOSITE WALL ASSEMBLY SHALL BE CONSTRUCTED OF NOM 4" OR 7" THICK, RESPECTIVELY, GALVANIZED STEEL OR PAINTED GALVANIZED STEEL FACED PARTITION PANEL UNITS* (CJMR) INSTALLED IN THE MANNER SPECIFIED IN WALL AND PARTITION DESIGN NO. U050 IN THE FIRE RESISTANCE DIRECTORY. MAX AREA OF OPENING IS 564 SQ IN. WITH A MAX DIMENSION OF 23-3/4". OPENING CAN BE LOCATED ON OR OFF PANEL UNIT JOINTS.
- STEEL DUCT — NOM 23" BY 23", OR NOM 23" DIAM, (OR SMALLER) NO. 24 GAUGE (OR HEAVIER) GALV STEEL DUCT TO BE INSTALLED EITHER CONCENTRICALLY OR ECCENTRICALLY WITHIN THE FIRESTOP SYSTEM. THE ANNULAR SPACE BETWEEN THE STEEL DUCT AND THE PERIPHERY OF THE OPENING SHALL BE MIN 1/4" TO MAX 1/2". STEEL DUCT TO BE RIGIDLY SUPPORTED ON BOTH SIDES OF THE WALL ASSEMBLY.
- FIRESTOP SYSTEM — THE FIRESTOP SYSTEM SHALL CONSIST OF THE FOLLOWING:
 - PACKING MATERIAL — MIN 4 PCF (64 KG/M3) MINERAL WOOL BATT INSULATION FIRMLY PACKED INTO OPENING AS A PERMANENT FORM. MIN 3-1/4" AND MIN 6-1/4" THICKNESS REQUIRED FOR 1 HR AND 2 HR FIRE RATED WALLS, RESPECTIVELY. PACKING MATERIAL SHALL BE RECESSED FROM BOTH SURFACES OF WALL TO ACCOMMODATE THE REQUIRED THICKNESS OF THE FILL MATERIAL (ITEM 3B).
 - FILL, VOID OR CAVITY MATERIAL* — CAULK — MIN 5/8" THICKNESS OF FILL MATERIAL APPLIED WITHIN THE ANNULUS, FLUSH WITH BOTH SURFACES OF WALL.
 - STEEL RETAINING ANGLES — MIN NO. 20 GA, 2" BY 2" GALV STEEL ANGLES FOR CIRCULAR DUCTS, ANGLES TO BE ROLL FORMED TO FIT THE OD OF THE DUCT. ANGLES ATTACHED TO DUCT ONLY ON BOTH SIDES OF WALL WITH MIN NO. 10 BY 3/4" LONG STEEL SHEET METAL SCREWS SPACED A MAX OF 1-1/2" FROM EACH END OF STEEL DUCT AND SPACED MAX 6" OC. ANGLES INSTALLED SUCH THAT THEY TIGHTLY ABUT THE WALL SURFACE ON BOTH SIDES OF WALL.

5
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TYPICAL INSULATED METAL WALL PANEL
THROUGH-PENETRATION FIRESTOP SYSTEM - DUCTWORK
N.T.S.



FIRE STOPPING DETAIL, THROUGH-PENETRATION FIRESTOP SYSTEMS

UL SYSTEMS NO. W-L-3359 FOR, 2 HR. RATING

- WALL ASSEMBLY — THE 1 OR 2 H FIRE-RATED GYPSUM WALLBOARD/STUD WALL ASSEMBLY SHALL BE CONSTRUCTED OF THE MATERIALS AND IN THE MANNER SPECIFIED IN THE INDIVIDUAL U400, V400 OR W400 SERIES WALL AND PARTITION DESIGNS IN THE UL FIRE RESISTANCE DIRECTORY AND SHALL INCLUDE THE FOLLOWING CONSTRUCTION FEATURES:
 - STEEL STUDS — (NOT SHOWN) — CHANNEL-SHAPED, 3-5/8" DEEP. ADDITIONAL FRAMING MEMBERS TO BE INSTALLED TO FORM A RECTANGULAR BOX HAVING DIMENSIONS WHICH ARE MAX 1/4" GREATER THAN THE WIDTH AND HEIGHT OF THE FIRESTOP DEVICE FRAME (ITEM 3A), EXCLUDING MOUNTING FLANGES. THE OPENING MUST BE FRAMED IN SUCH MANNER TO MEET STRUCTURAL REQUIREMENTS OF U400 OR V400 SERIES WALL AND PARTITION DESIGNS IN THE UL FIRE RESISTANCE DIRECTORY. MAX DIMENSION OF FRAMED OPENING IS 21-1/16" WIDE BY 11-5/8" HIGH (G 8X4 DEVICE).
 - GYPSUM BOARD — FOR 2 HR RATING, TWO LAYERS OF MIN 1/2" THICK, GYPSUM BOARD, AS SPECIFIED IN THE INDIVIDUAL WALL AND PARTITION DESIGN.
- CABLES — WITHIN THE LOADING AREA FOR EACH FIRESTOP DEVICE MODULE THE CABLES MAY REPRESENT A 0 TO 00 PERCENT VISUAL FILL. CABLES TO BE RIGIDLY SUPPORTED ON BOTH SIDES OF WALL ASSEMBLY. ANY COMBINATION OF THE FOLLOWING TYPES AND SIZES OF CABLES MAY BE USED.
- FIRESTOP SYSTEMS — THE FIRESTOP SYSTEM SHALL CONSIST OF THE FOLLOWING:
 - FIRESTOP DEVICES — FIRESTOP DEVICES EACH CONSIST OF A RECTANGULAR STEEL FRAME WITH INTEGRAL FLANGE, MULTI DIAMETER ELASTOMERIC SEALING MODULES, STEEL STAY PLATES AND A COMPRESSION UNIT CONSISTING OF A ROXTEC WEDGE (OR OTHER APPROVED MATERIAL). THE FIRESTOP DEVICES SHALL BE INSERTED INTO THE FRAMED OPENING ON ONE SIDE OF THE WALL ASSEMBLY. THE STEEL FRAME OF EACH FIRESTOP DEVICE SHALL BE SECURED TO THE STEEL STUD FRAMING OF THE WALL ASSEMBLY, THROUGH THE GYPSUM BOARD LAYERS, BY MEANS OF NO. 8 BY MIN 3" LONG SELF-DRILLING, SELF-TAPPING STEEL SCREWS THROUGH THE PRE-DRILLED HOLES SPACED MAX 5-1/2" OC IN THE DEVICE FRAME MOUNTING FLANGE. THE RECTANGULAR OPENING(S) OF EACH DEVICE FRAME SHALL BE FILLED WITH MULTIPLE ROWS OF MULTI DIAMETER ELASTOMERIC SEALING MODULES WITH A MAX OF ONE CABLE IN EACH SEALING MODULE. THE SHEETS OF THE MULTI DIAMETER SEALING MODULE HALVES ARE REMOVED ONE BY ONE UNTIL A MAX GAP OF 0.04" IS FORMED BETWEEN THE TWO MODULES HALVE. WHEN THE NUMBER OF SEALING MODULES EXCEEDS THE NUMBER OF CABLES, THE SOLID CYLINDRICAL CORES OF THE UNPENETRATED SEALING MODULES SHALL BE LEFT IN PLACE OR "BLANK" (SOLID) SEALING MODULES SHALL BE USED. DURING INSTALLATION OF THE ELASTOMERIC SEALING MODULES, THIN STEEL STAY PLATES SHALL BE USED TO SEPARATE THE ROWS OF SEALING MODULES AND TO RETAIN THE SEALING MODULES WITHIN THE STEEL FRAME. AFTER INSTALLATION OF THE MODULES, THE BOLTS OF THE COMPRESSION UNIT ARE TIGHTENED TO FORM AN EFFECTIVE SEAL AROUND THE THROUGH PENETRANTS AND INSERT MODULES. THE FIRESTOP DEVICES SHALL BE INSTALLED IN ACCORDANCE WITH THE ACCOMPANYING INSTALLATION INSTRUCTIONS.
 - SILICONE RTV SEALANT — (NOT SHOWN) — A MIN 1/4" DIAM BEAD OF SILICONE RTV SEALANT SHALL BE APPLIED AS A GASKET BETWEEN THE DEVICE FRAME MOUNTING FLANGE AND GYPSUM BOARD. THE SEALANT BEAD SHALL BE LOCATED BETWEEN THE EDGE OF THE OPENING AND THE LINE OF FASTENERS AROUND THE ENTIRE PERIMETER OF THE FRAMED OPENING.
 - PACKING MATERIAL — PIECES OF MIN 3" THICK MIN 2.76 PCF DENSITY MINERAL WOOL BATT INSULATION CUT TO LINE FOUR SIDES OF THROUGH OPENING WITHIN WALL CAVITY. PIECES CUT TO LENGTH AND TIGHTLY FRICITION-FIT BETWEEN FRAMING OF WALL OPENING AND CABLES AND IN-BETWEEN CABLES AND MADE FLUSH WITH WALL SURFACE.

ISSUED FOR PERMIT

Engineering and
Land Surveying, P.C.

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SUITE 1604
New York, NY 10001

SOWINSKI
SULLIVAN
ARCHITECTS & ENGINEERS

25 Mohawk Avenue
Sparta, NJ 07871

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| B | FINAL SUBMISSION | RAC | ZH | 12/12/2022 |
| A | INTERIM SUBMISSION | RAC | ZH | 09/13/2022 |
| REV | DESCRIPTION | DRW BY | CHK BY | DATE |

Kiewit

470 Chestnut Ridge Rd # 2,
Woodcliff Lake, NJ 07677

Hitachi Energy

901 Main Campus Drive
Raleigh, North Carolina 27606

PROJECT

CHPE
Champlain Hudson
Power Express

**Astoria HVDC
Converter Station**


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Block #850 - Lot #310 - BIN #4624437

**TYPICAL FIRESTOPPING
DETAILS II**




DATE 12/12/22
PROJECT NO 105121
DRAWING BY R. COLES
CHECKED BY Z. HARR
DRAWING NO
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CADD FILE NO
Astoria CHPE-111-22-M3-A-001.rvt

- NOTES:
- WOOD NAILERS MUST BE INSTALLED WITH SUITABLE FASTENERS TO MEET APPLICABLE BUILDING CODES (MIN 200 LBS PER LINEAR FOOT IN ANY GIVEN DIRECTION).
 - ALL SHEET METAL IS TO BE INSTALLED PER SMACNA GUIDELINES.
 - MECHANICAL UNITS SHOULD NOT BE SET UNTIL THE ROOF MEMBRANE AND FLASHING HAVE BEEN INSTALLED.
 - EMBED GRANULES ON CAP SHEET PRIOR TO APPLYING LIQUID FLASHING.
 - LIQUID FLASHING SHALL BE APPLIED WITH A BOTTOM COAT, EMBEDMENT COAT, AND FINISH COAT OF 30 MILS WET THICKNESS EACH.

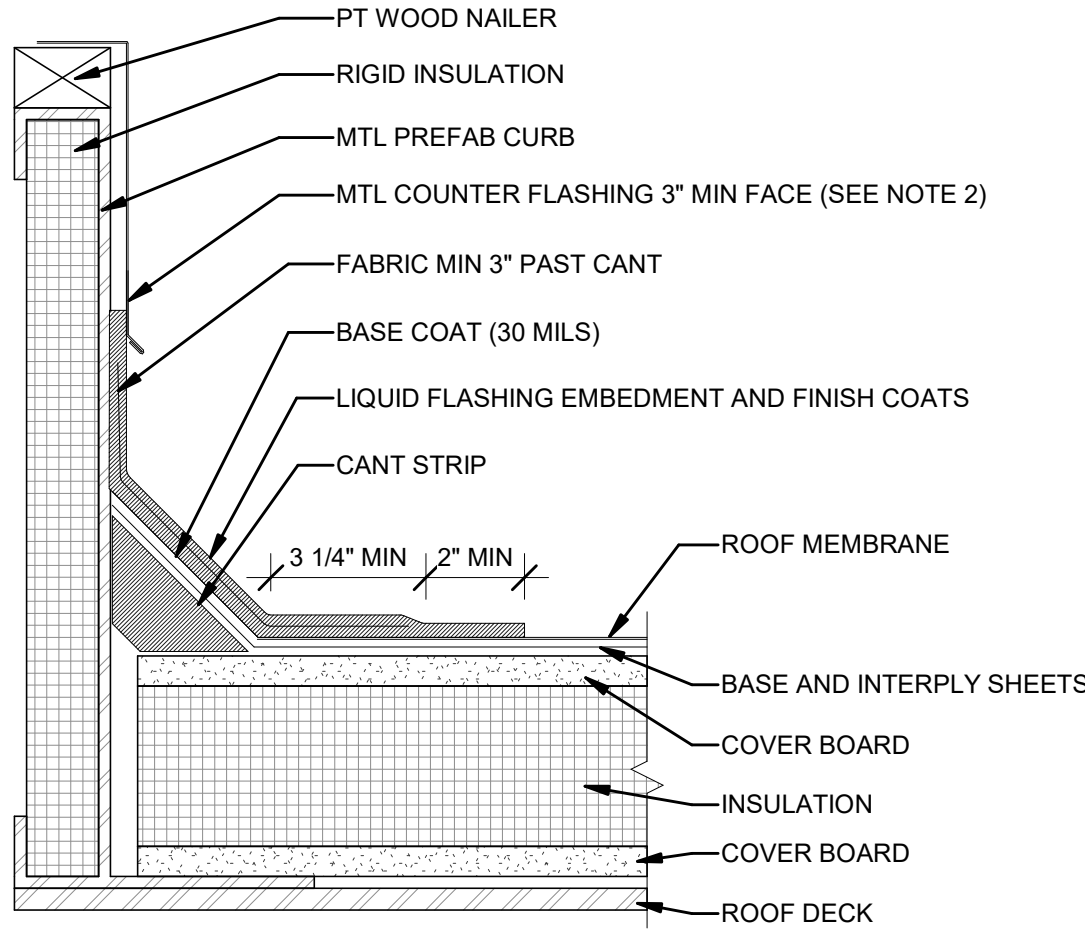


1 TYPICAL ROOF CURB DETAIL
3" = 1'-0"

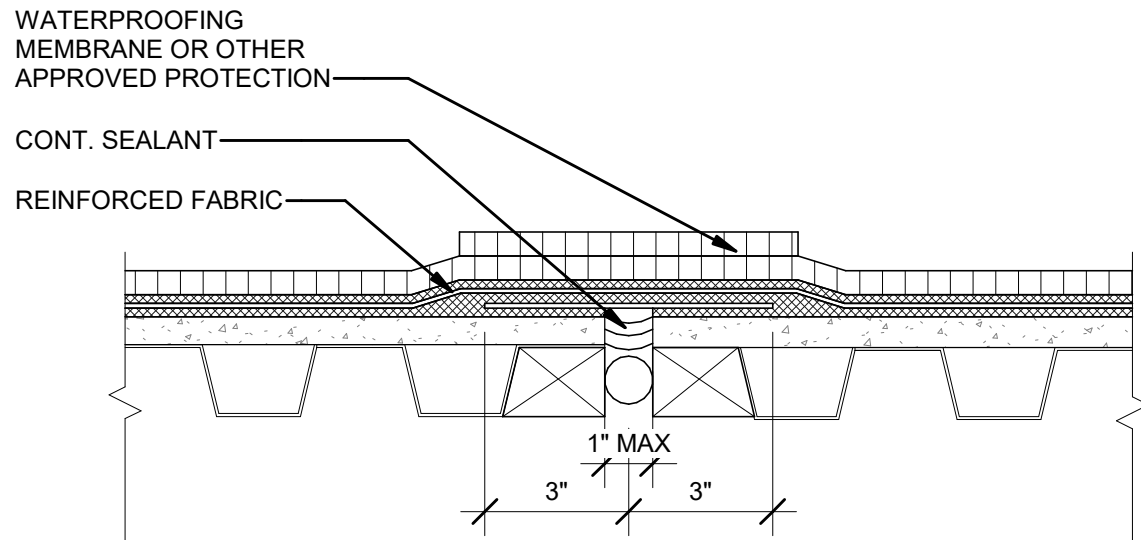


- NOTES:
- DETAIL DESIGNED FOR JOINTS WITH MAX. MOVEMENT ACCOMMODATION FACTOR OF 25%.
 - BACKER ROD AND SEALANT ARE REQUIRED IN JOINT PRIOR TO REINFORCED FABRIC INSTALLATION.
 - IN COVERED/ BURIED CONDITIONS REINFORCED FABRIC IS EXTENDED AS CONTINUOUS FLASHING AS HIGH AS THE OVERBURDEN LEVEL. FLASHING MUST BE TERMINATED NO LESS THAN 4" ABOVE SUBSTRATE. IN ADDITION, ADEQUATE PROTECTION MUST BE PROVIDED FOR FLASHING FROM SUBSEQUENT TOPPING/BACKFILL. WHENEVER POSSIBLE THE EXPANSION JOINT SHALL BE EXTENDED UP THROUGH ALL TOPPING LAYERS.
 - REGLETS CAN BE CAST/FORMED OR CUT INTO THE CONCRETE. REGLETS SHALL BE MIN. 1/2" DEEP AND PROVIDE AN EASY TRANSITION FOR THE MEMBRANE FLASHING.

2 TYPICAL ROOF EXPANSION JOINT DETAIL
3" = 1'-0"

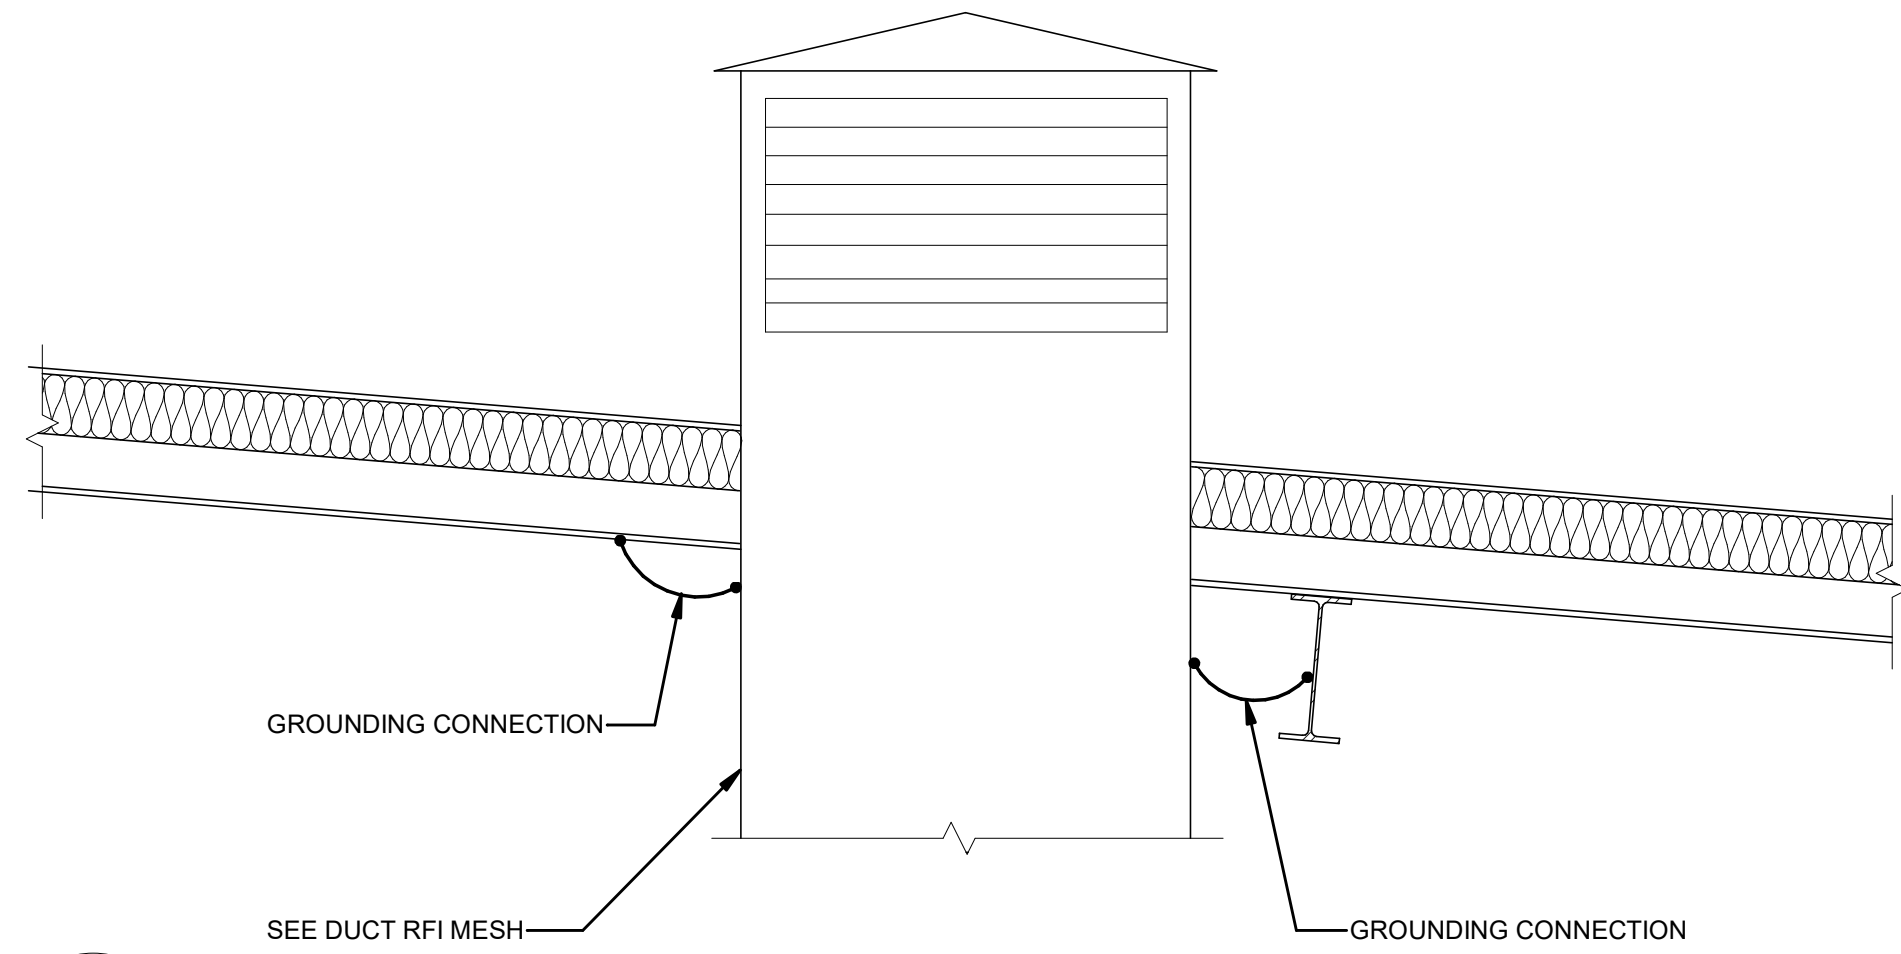

3 ROOF PENETRATION GROUNDING DETAIL
1/2" = 1'-0"

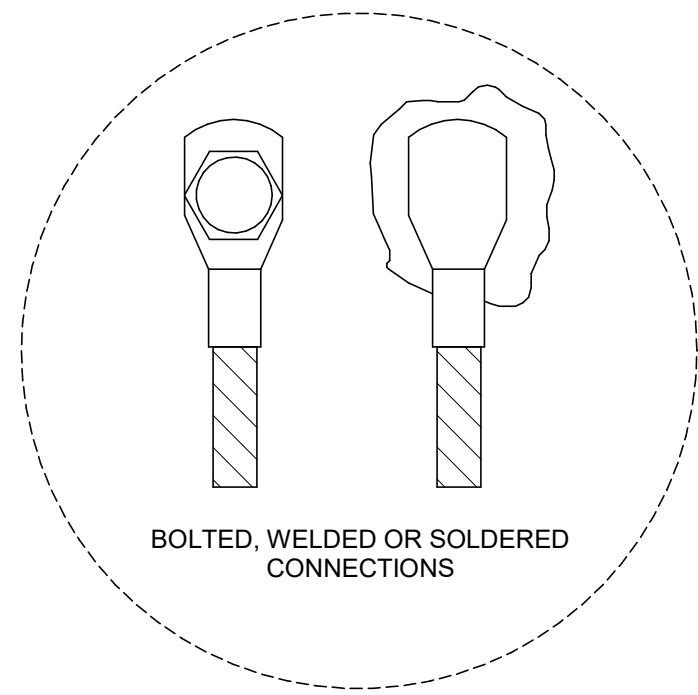

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Kiewit

470 Chestnut Ridge Rd # 2,
Woodcliff Lake, NJ 07677



901 Main Campus Drive
Raleigh, North Carolina 27606

PROJECT

CHPE
Champlain Hudson
Power Express

**Astoria HVDC
Converter Station**

31-45 20th Avenue, Astoria, Queens NY 11105
Block #850 - Lot #310 - BIN #4624437

TYPICAL ROOF DETAILS 1



DATE 12/12/22
PROJECT NO 105121
DRAWING BY R. COLES
CHECKED BY Z. HARR
DRAWING NO
A-621.00
CADD FILE NO
Astoria-HVDC-CHPE
Astoria-CHA-KIE-111-ZZ-M3-A-001.rvt

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Hitachi Energy
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PROJECT

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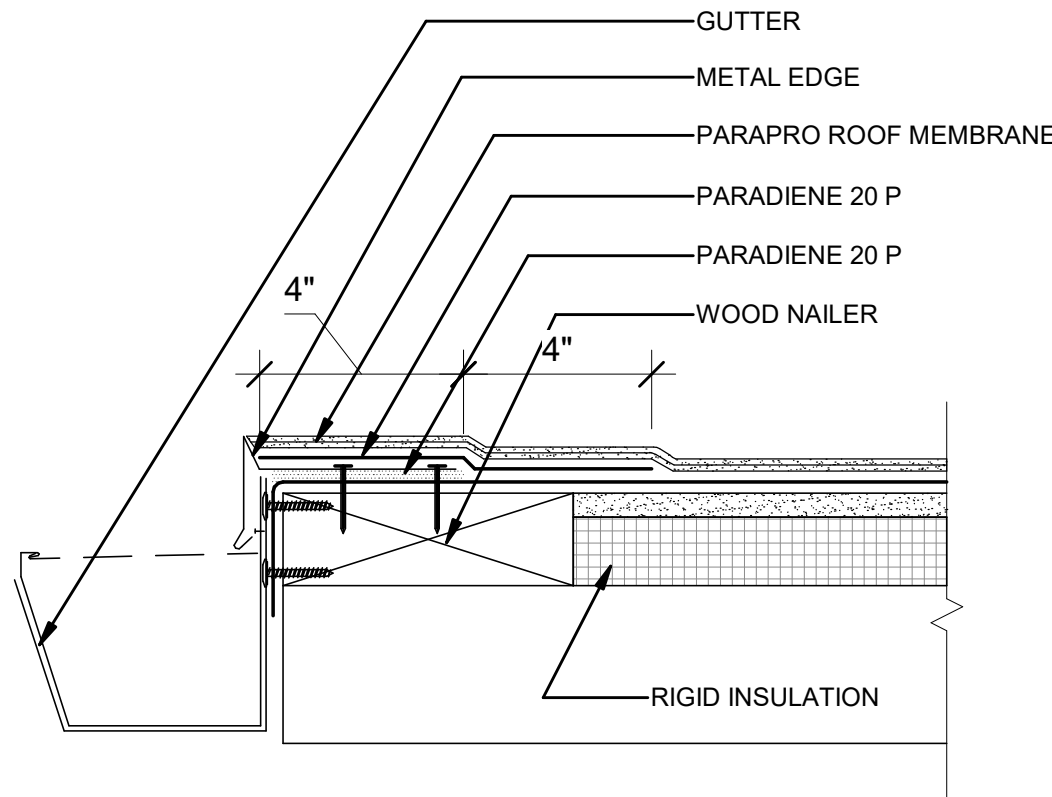
**Astoria HVDC
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Block #850 - Lot #310 - BIN #4624437


TYPICAL ROOF DETAILS 2




DATE 12/12/22
PROJECT NO 105121
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CHECKED BY Z. HARR
DRAWING NO
A-622.00
CADD FILE NO
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Astoria-CHA-KIE-111-ZZ-M3-A-001.rvt




1 GUTTER EDGE DETAIL
3" = 1'-0"

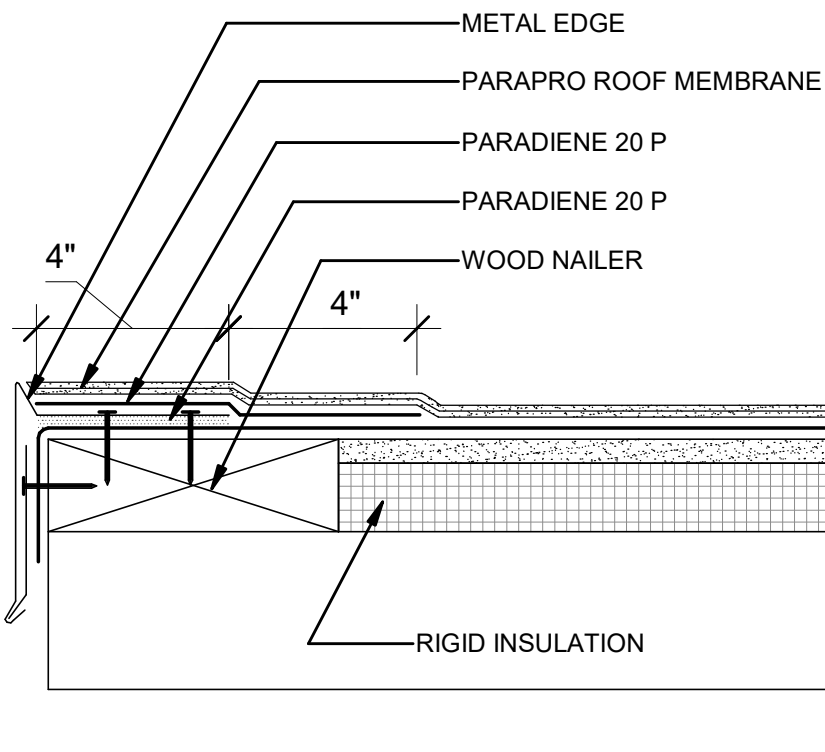


2 ROOF EDGE DETAIL
3" = 1'-0"

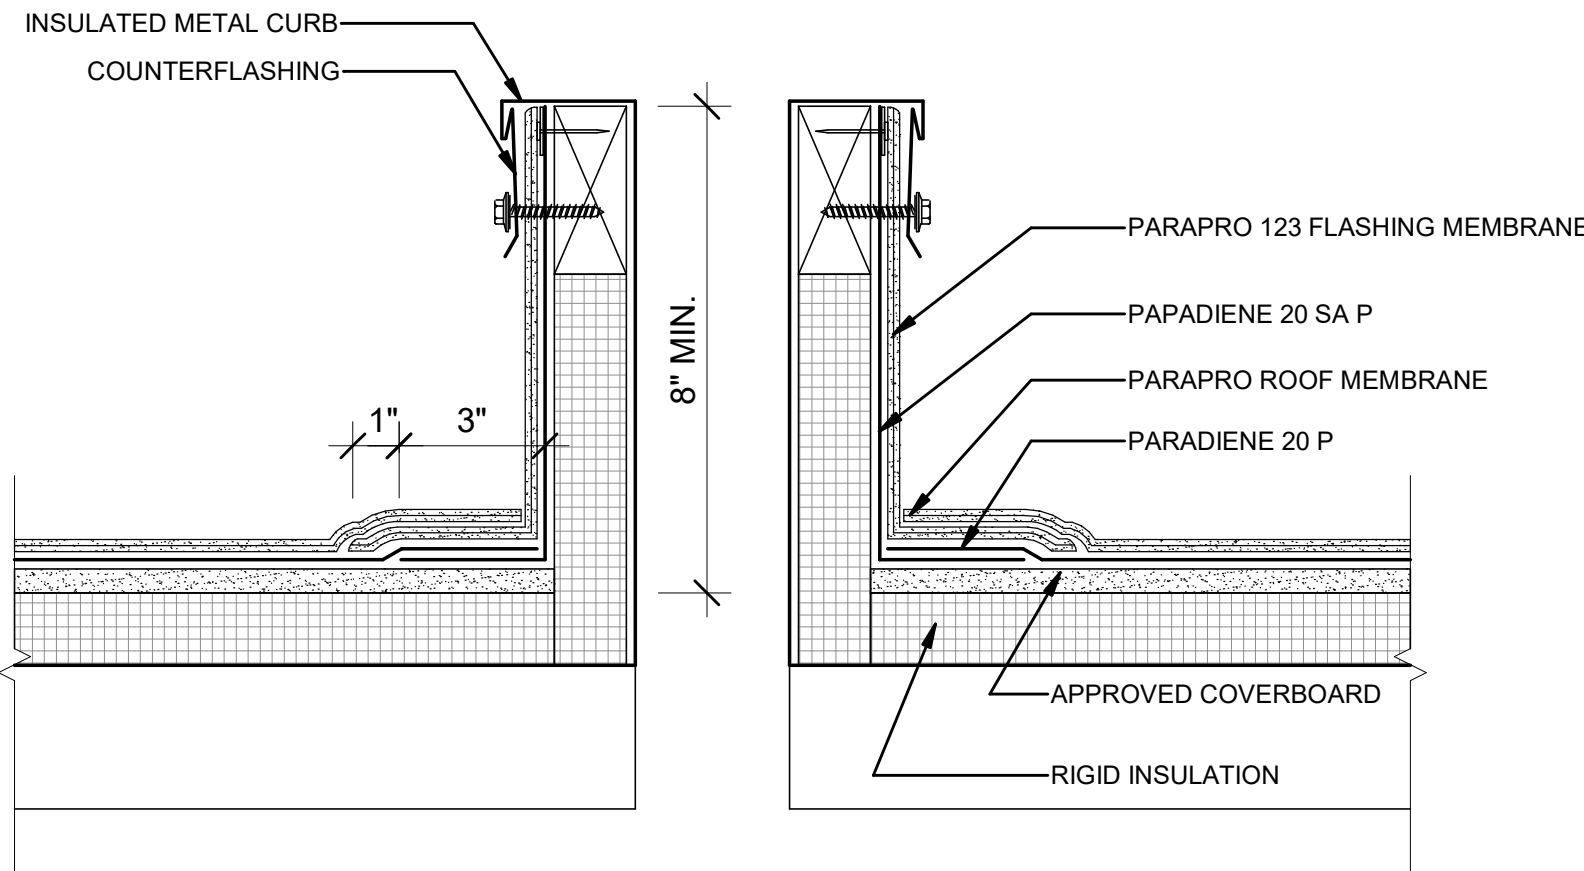


3 HVAC CURB DETAIL
3" = 1'-0"

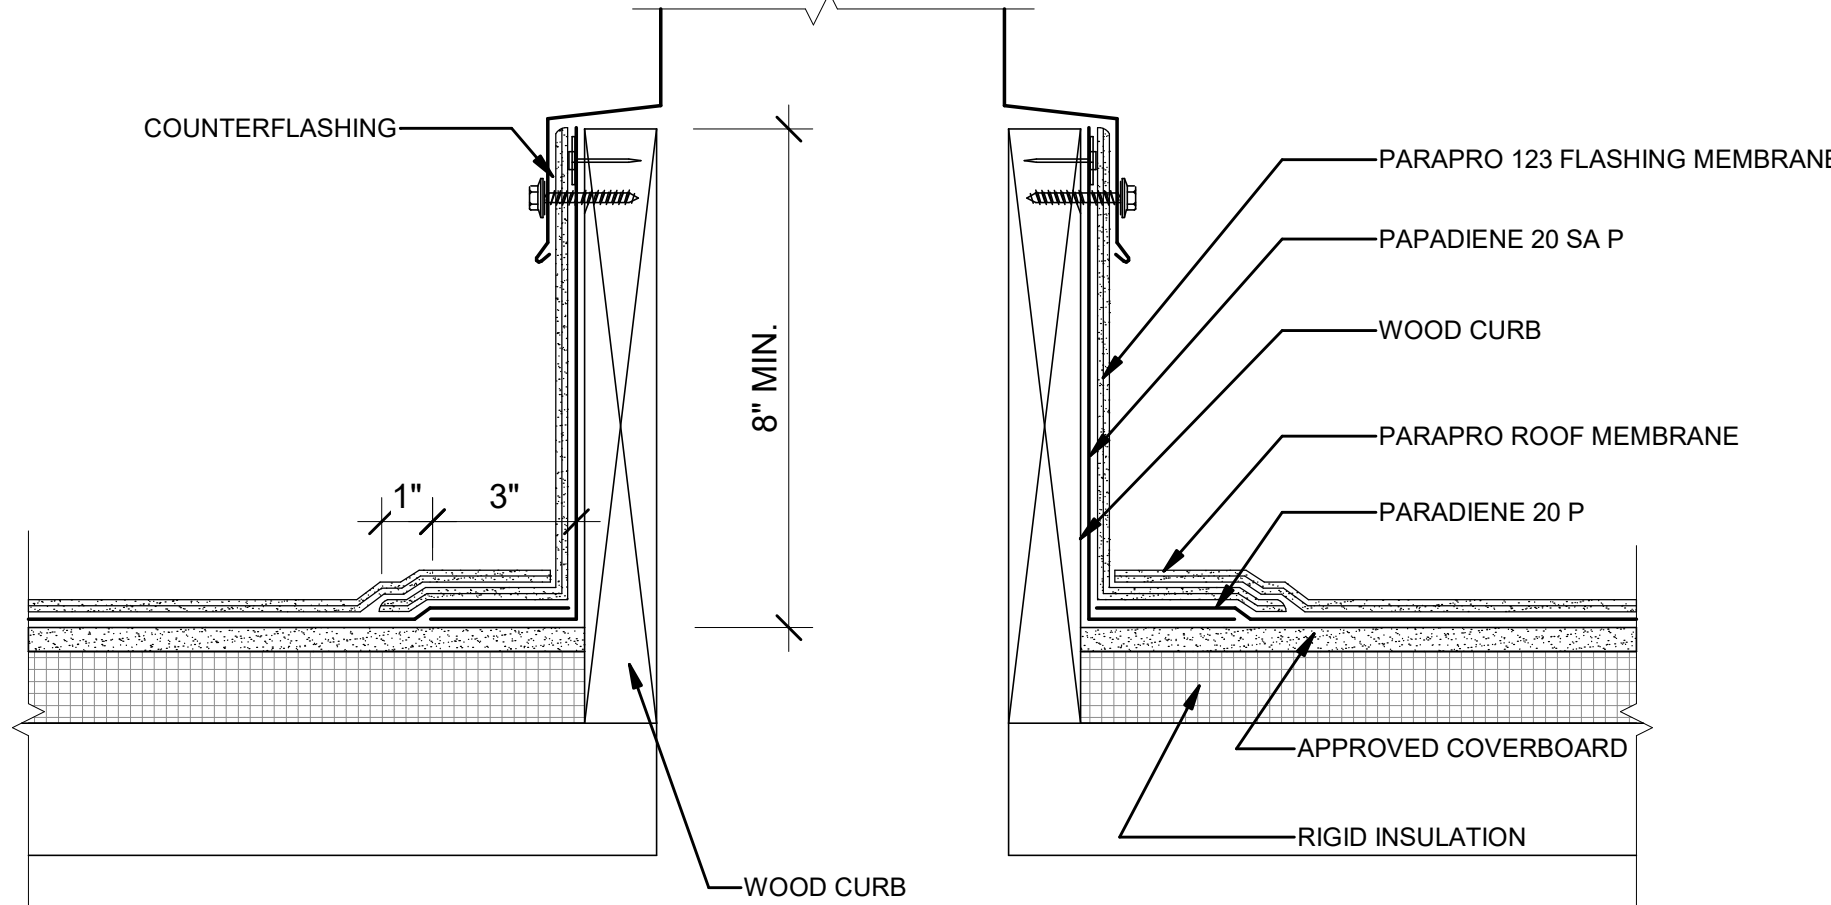


4 CURB DETAIL
3" = 1'-0"

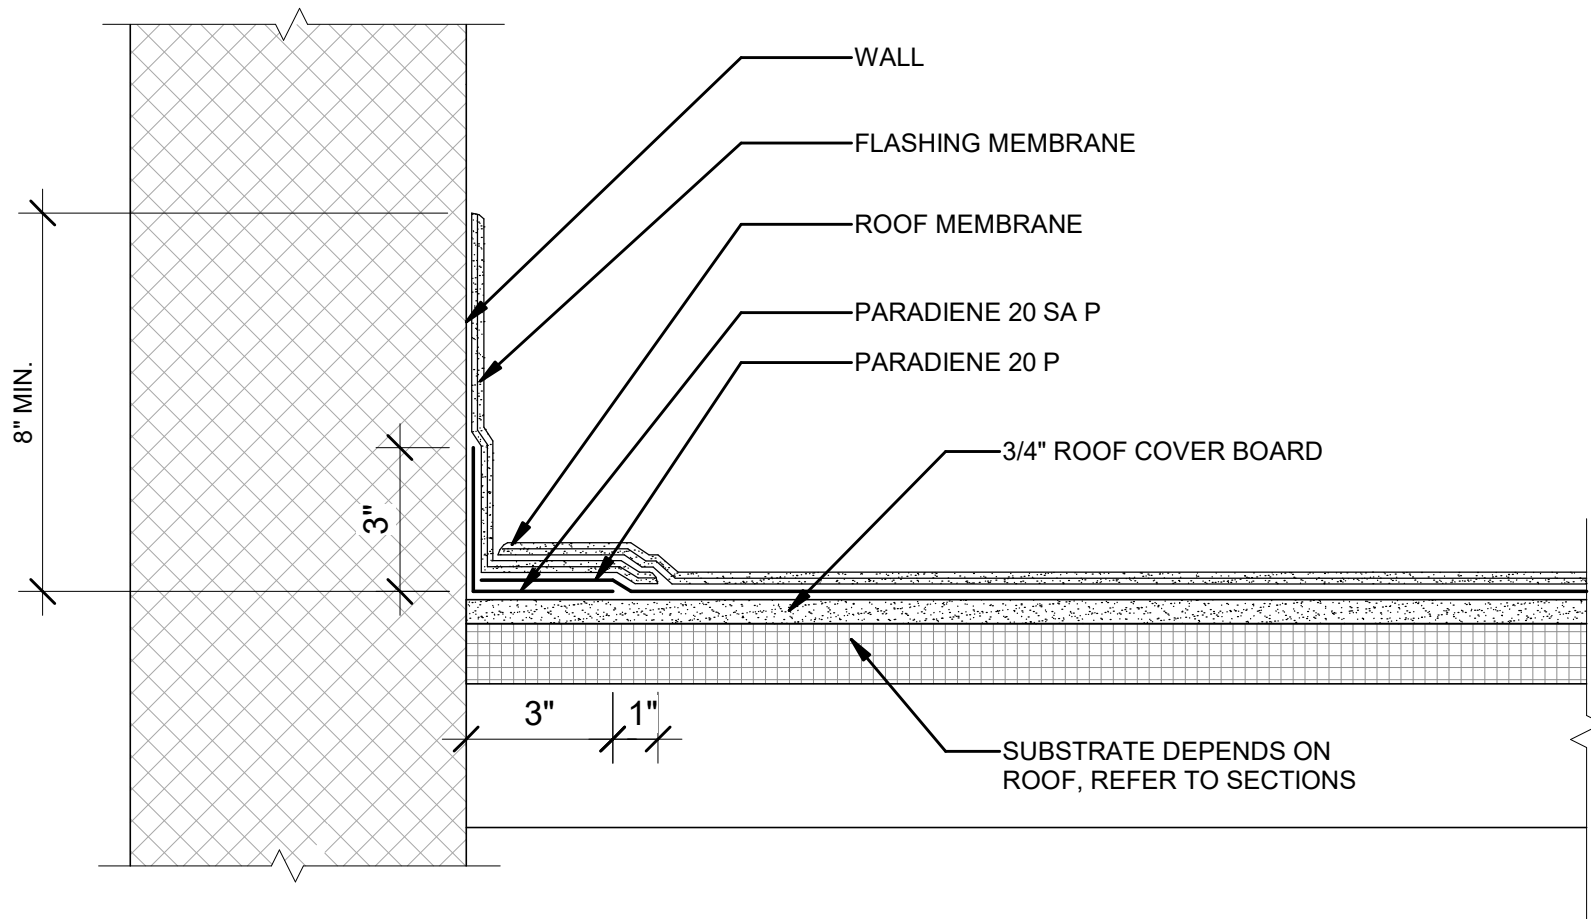


5 WALL WITH SELF TERMINATING PARAPRO FLASHING DETAIL
3" = 1'-0"

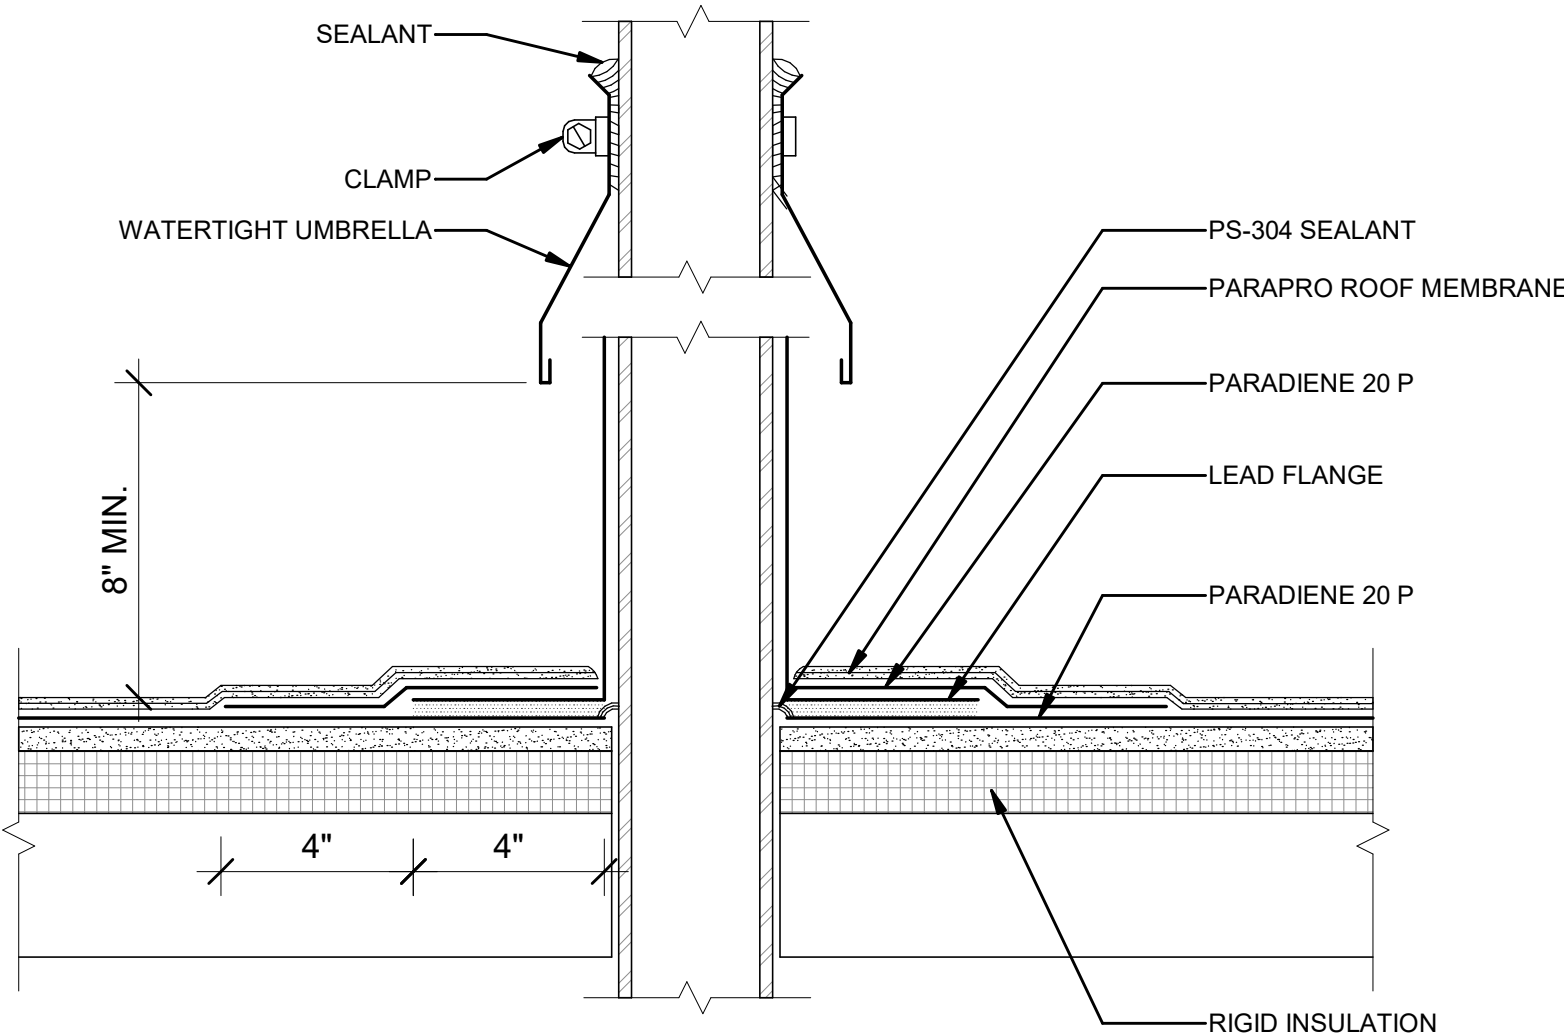

6 EQUIPMENT FRAME DETAIL
3" = 1'-0"

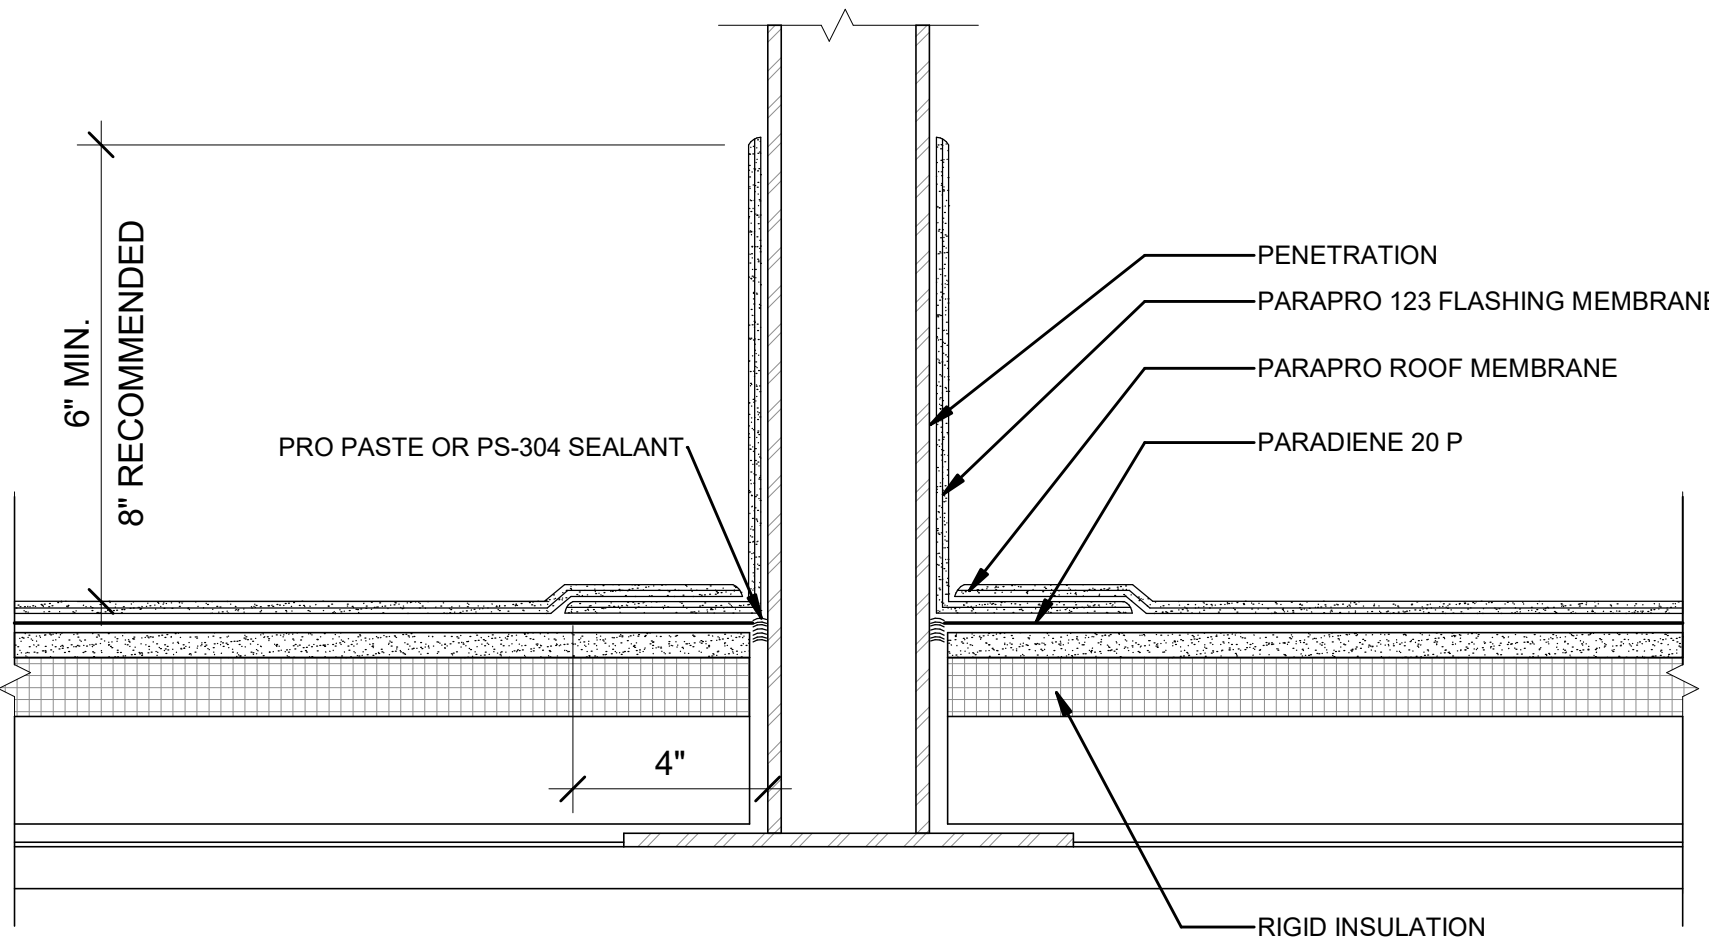


7 ROOF PENETRATION DETAIL
3" = 1'-0"

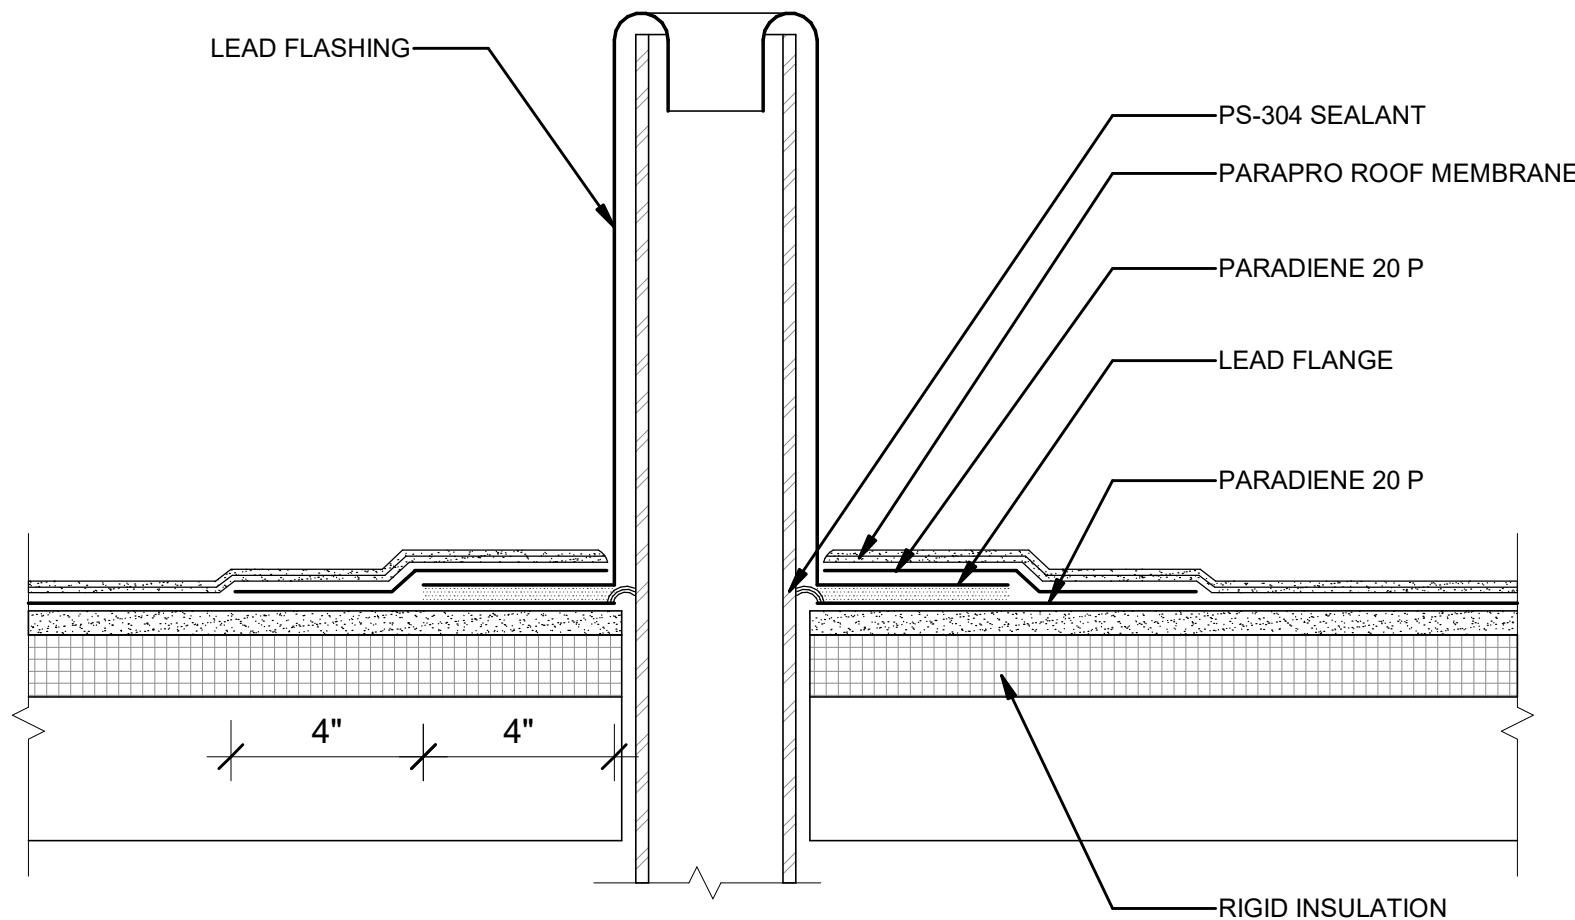

8 WASTE STACK DETAIL
3" = 1'-0"



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1 COUNTER / SINK DETAIL
1" = 1'-0"

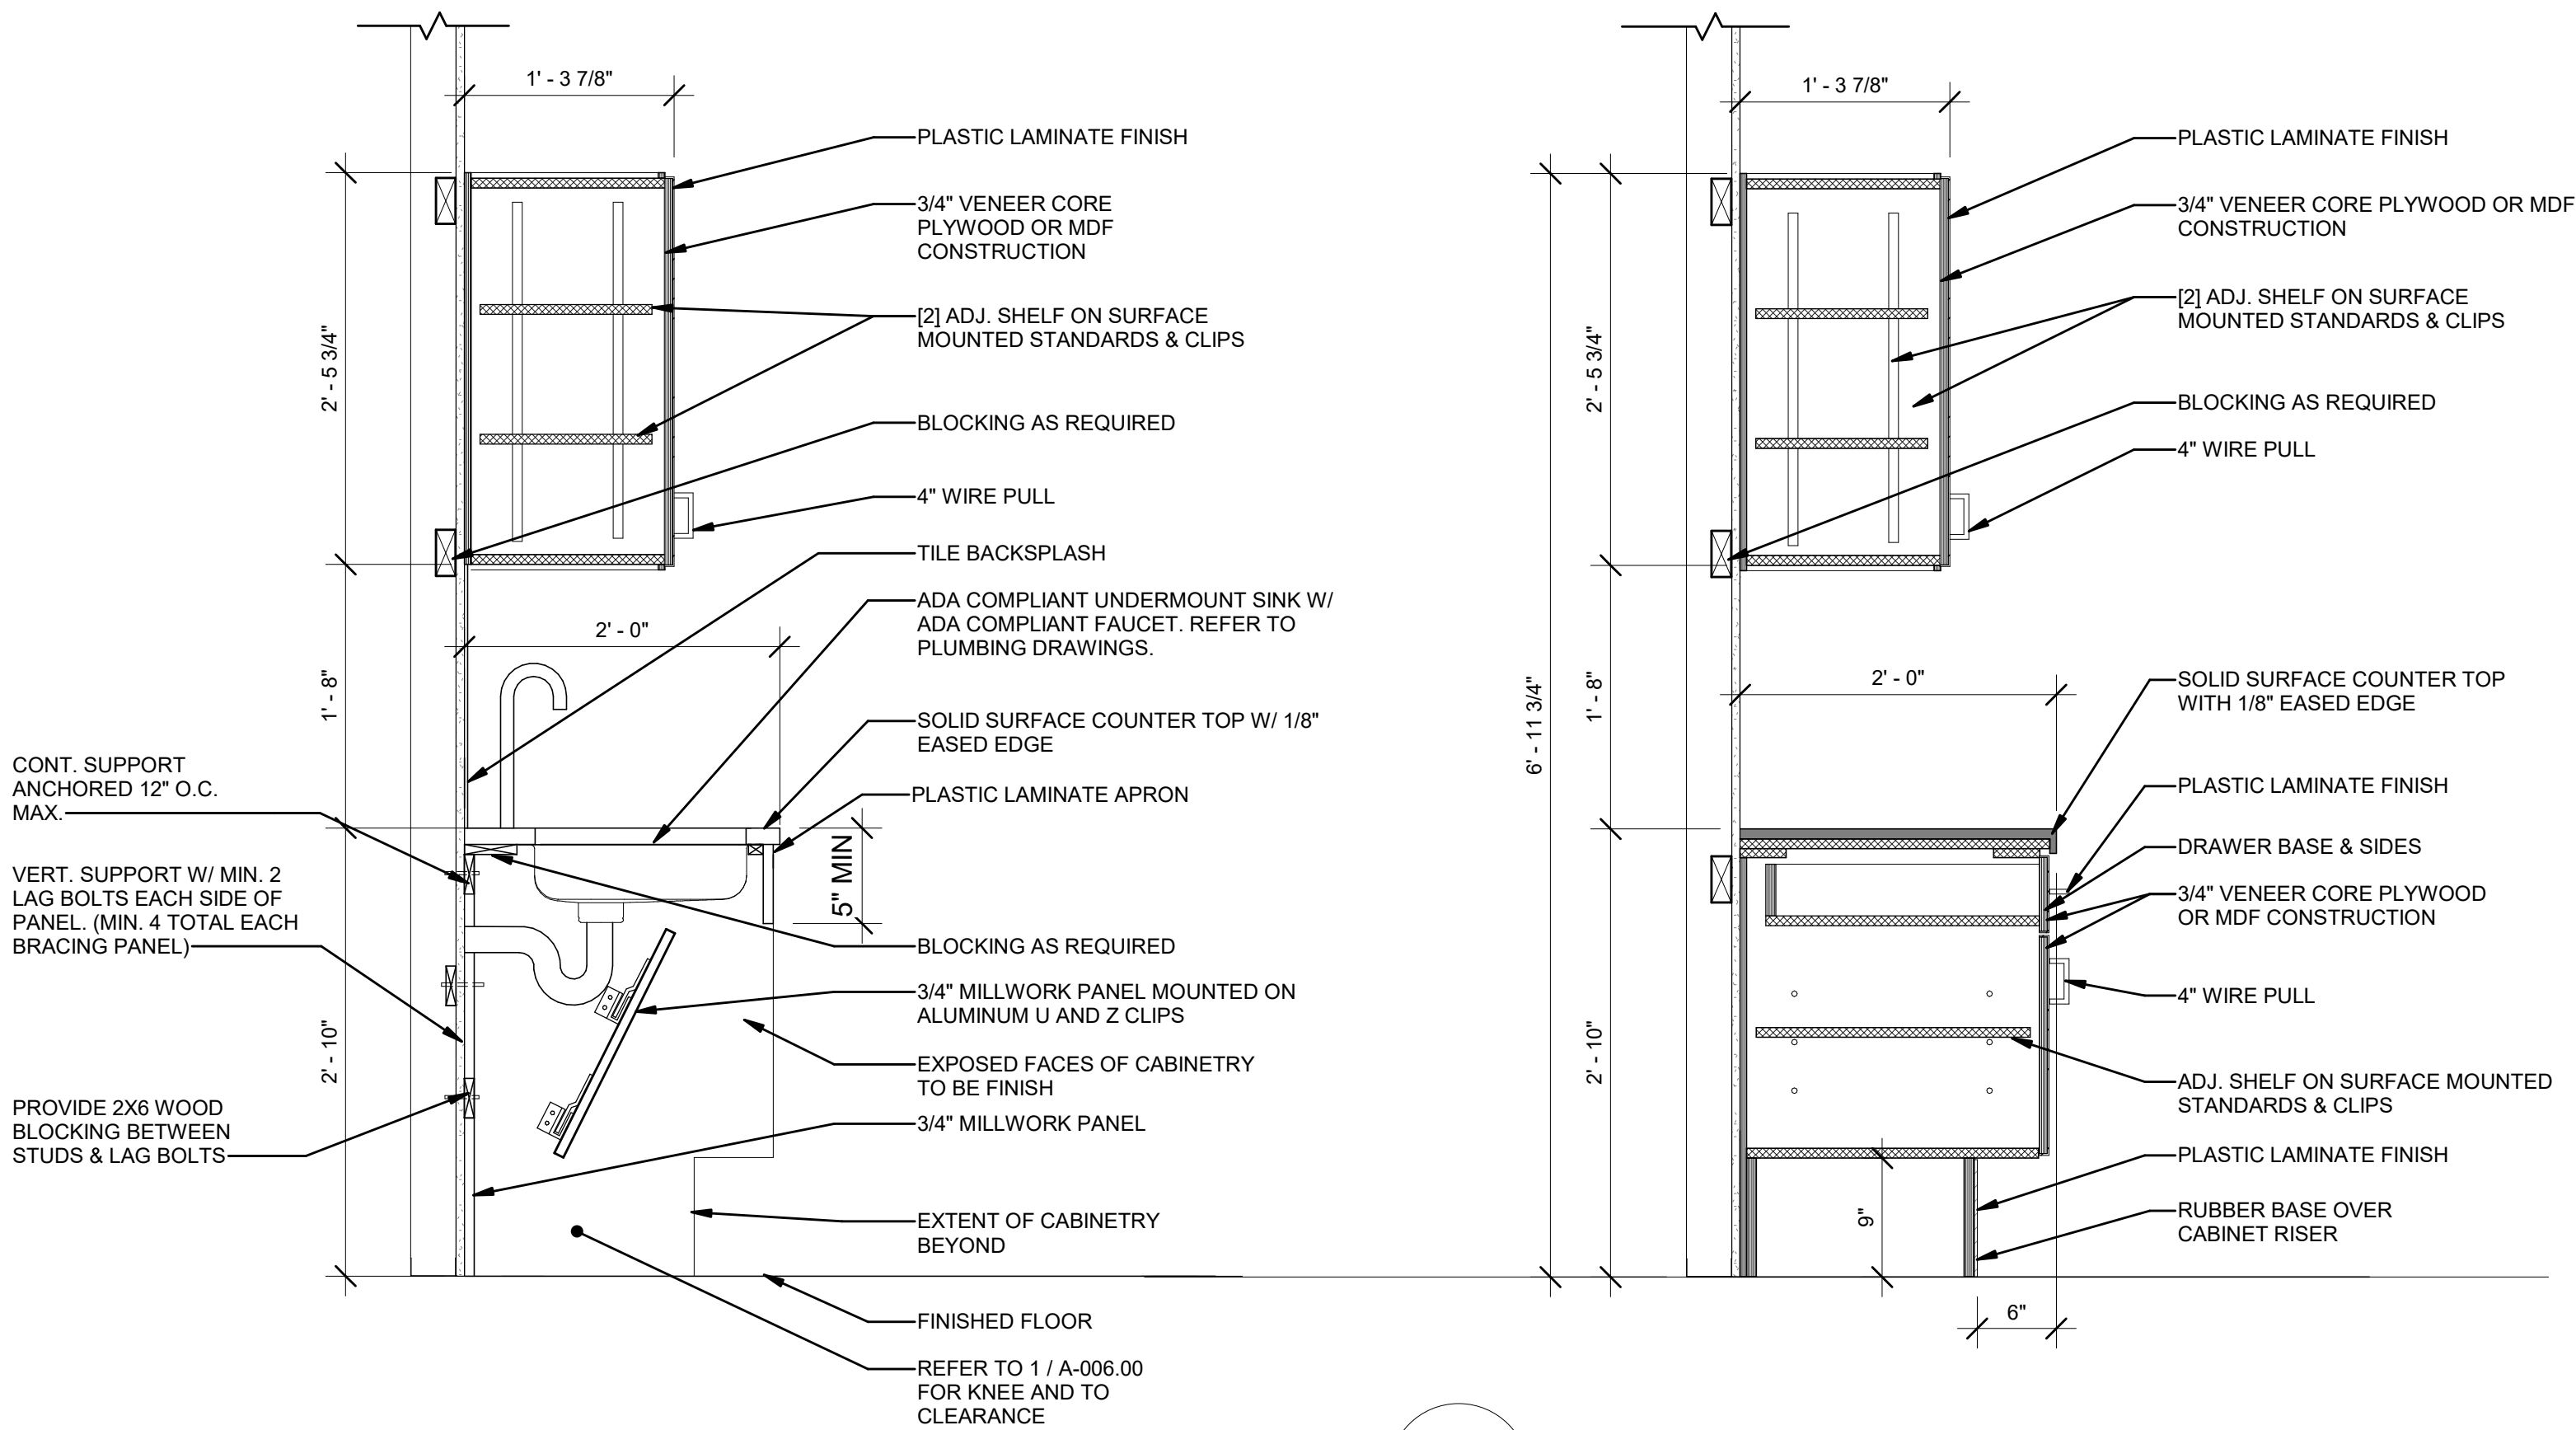2 WALL AND BASE CABINET DETAIL
1" = 1'-0"



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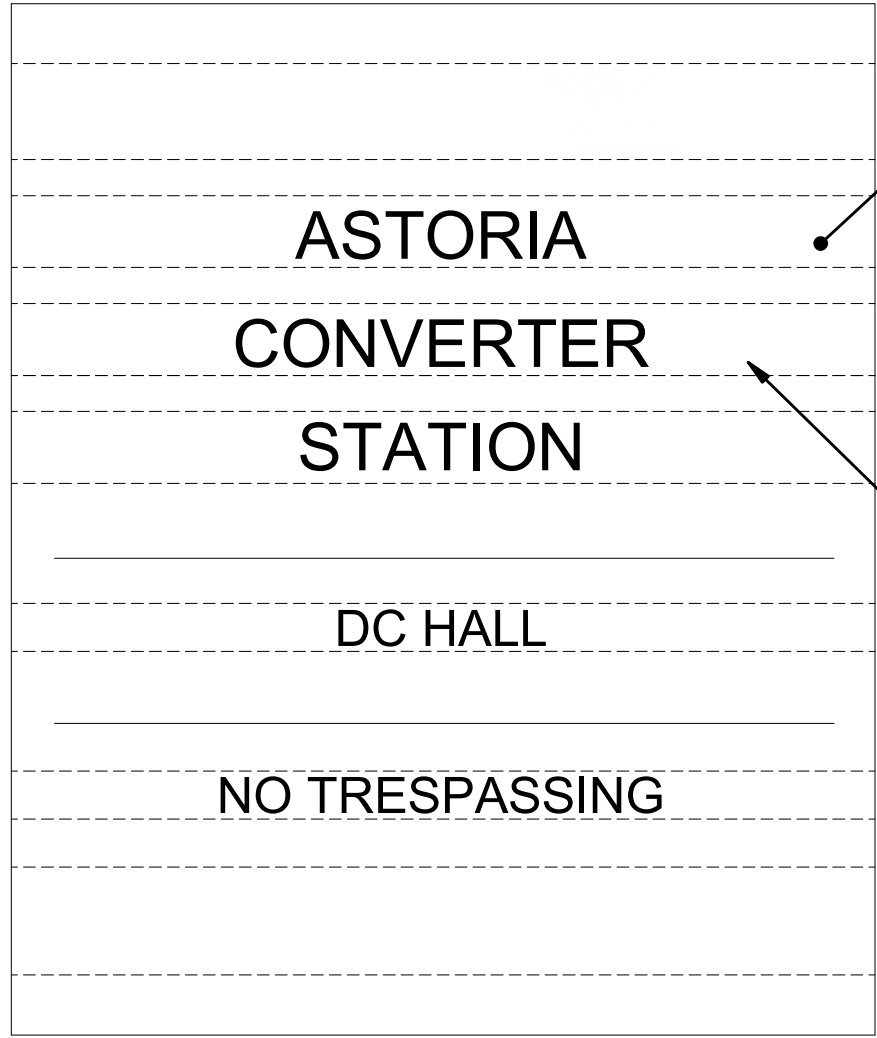
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Block #850 - Lot #310 - BIN #4624437

MILLWORK DETAILS 1




DATE 12/12/22
PROJECT NO 105121
DRAWING BY R. COLES
CHECKED BY Z. HARR
DRAWING NO
A-623.00
CADD FILE NO
Astoria-HVDC-CHPE
Astoria-CHA-KIE-111-ZZ-M3-A-001.rvt




SIGN TYPE 1

1 SIGNAGE - DC HALL
1 1/2" = 1'-0"

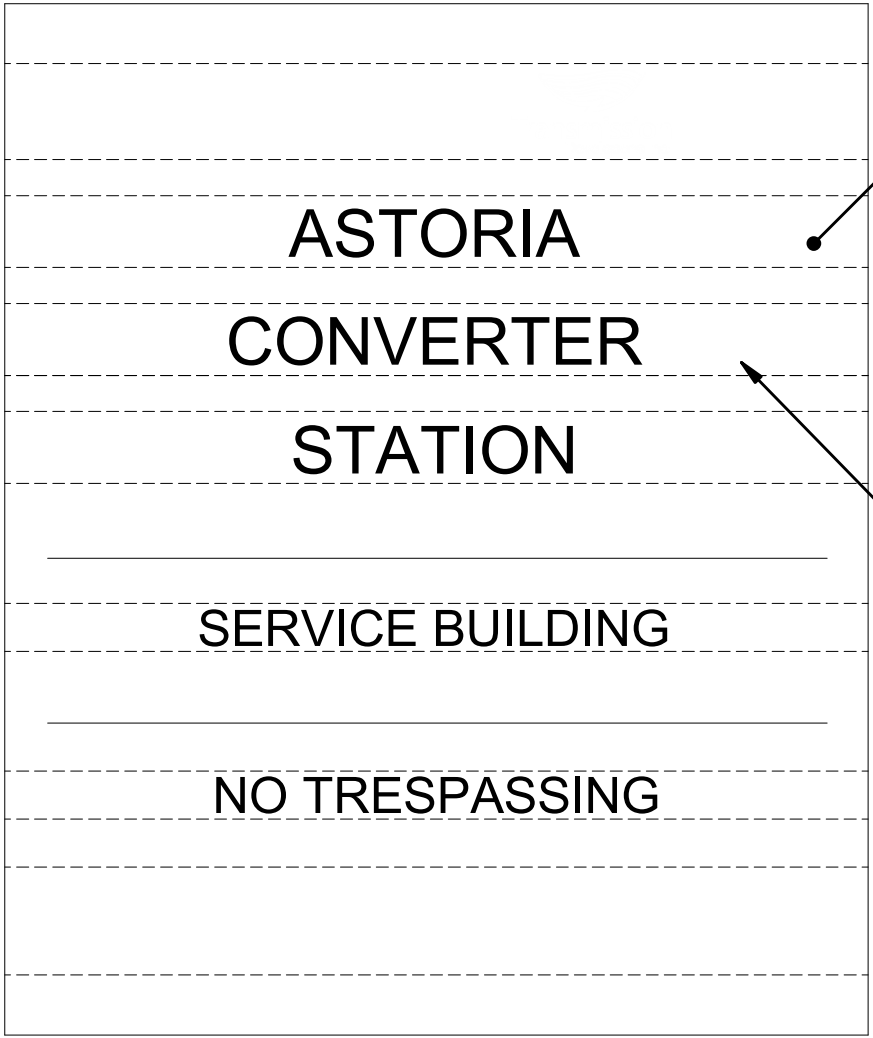


SIGN TYPE 2

2 SIGNAGE - SERVICE BUILDING
1 1/2" = 1'-0"

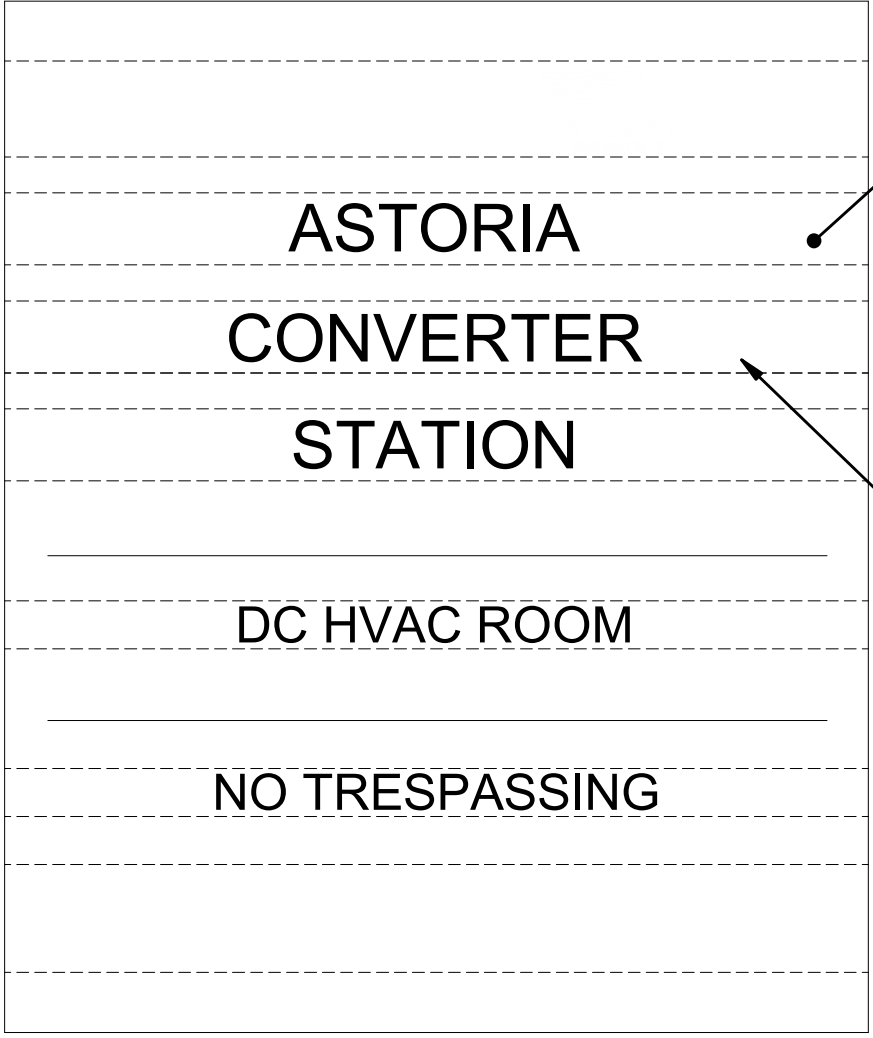


SIGN TYPE 3

3 SIGNAGE - DC HVAC ROOM
1 1/2" = 1'-0"

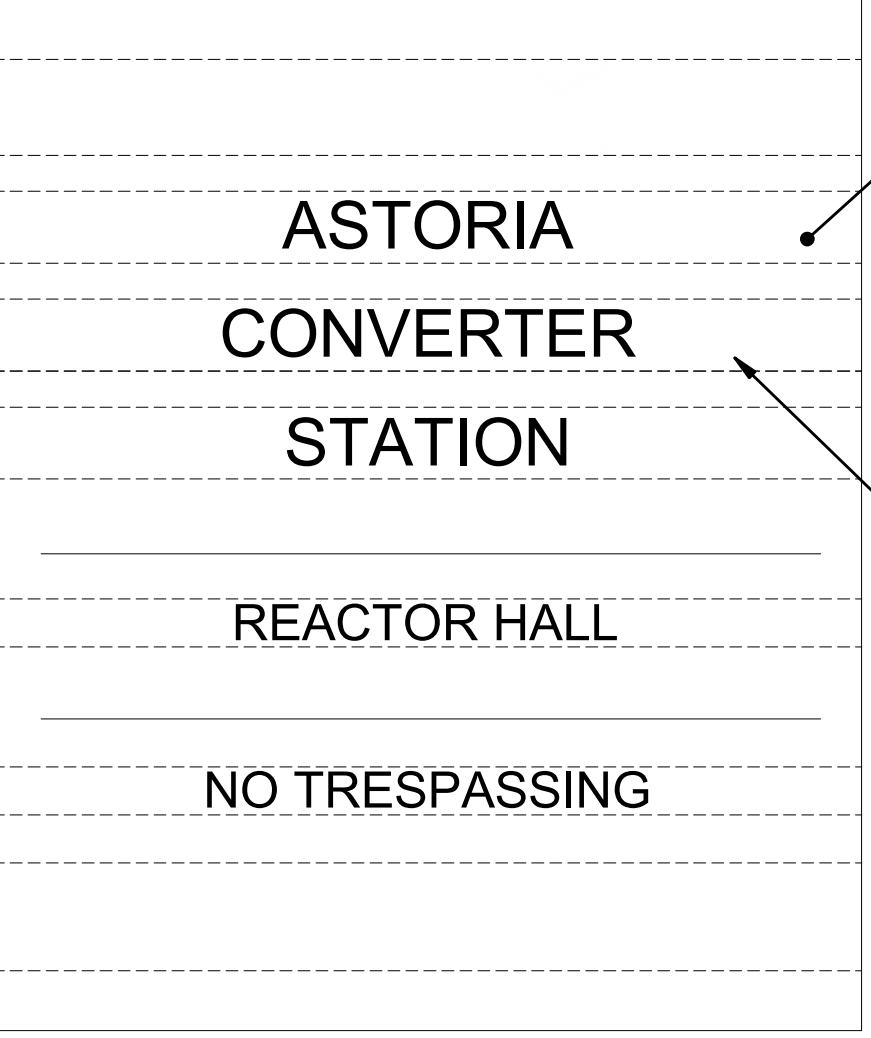

SIGN TYPE 4

4 SIGNAGE - REACTOR HALL
1 1/2" = 1'-0"

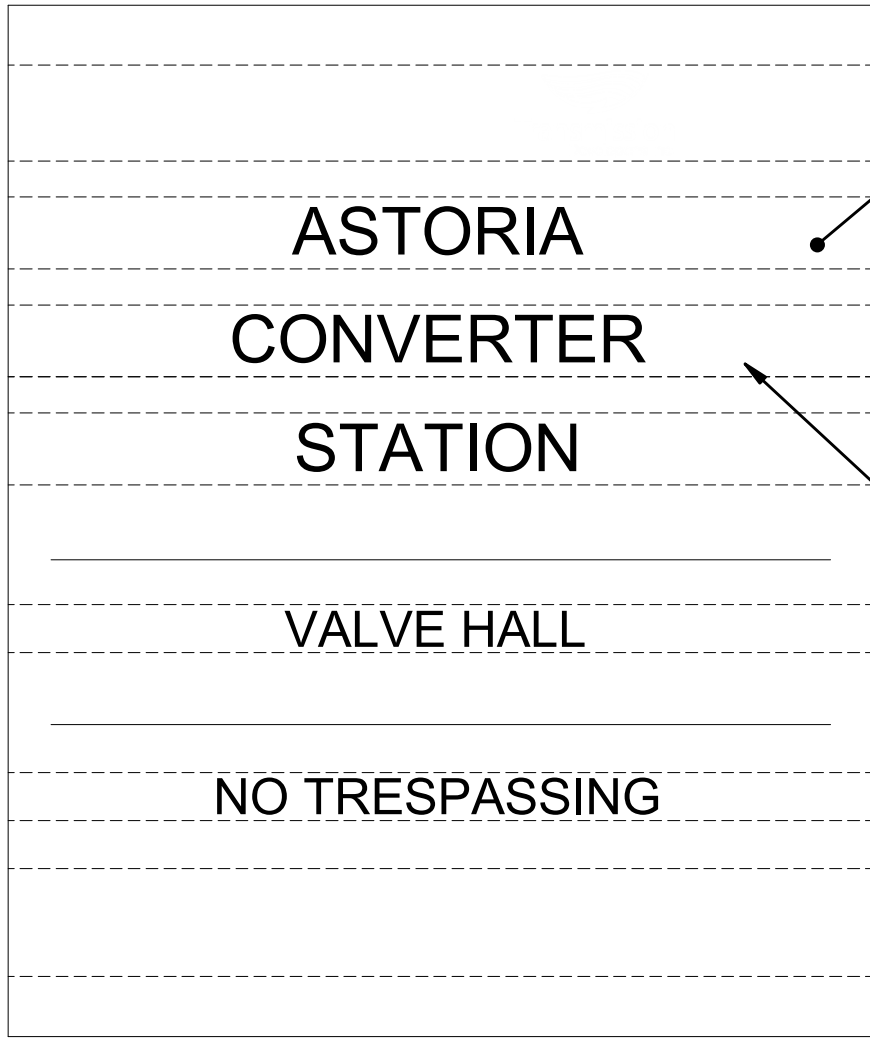

SIGN TYPE 5

5 SIGNAGE - VALVE HALL
1 1/2" = 1'-0"




SIGN TYPE 6

6 SIGNAGE - WARNING
3" = 1'-0"




SIGN TYPE 7

7 SIGNAGE - HAZARDOUS VOLTAGE WARNING
3" = 1'-0"

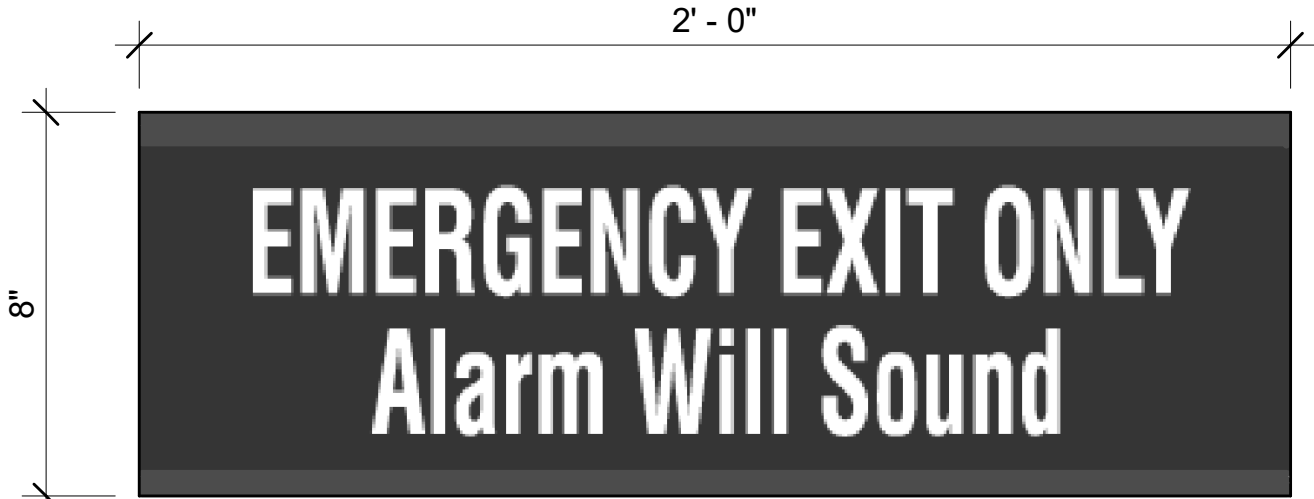


SIGN TYPE 8

8 SIGNAGE - EMERGENCY EXIT ONLY
3" = 1'-0"

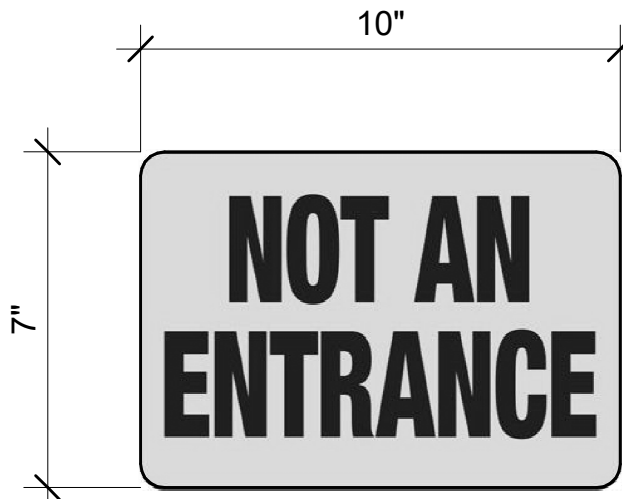

SIGN TYPE 9

9 SIGNAGE - NOT AN ENTRANCE
3" = 1'-0"

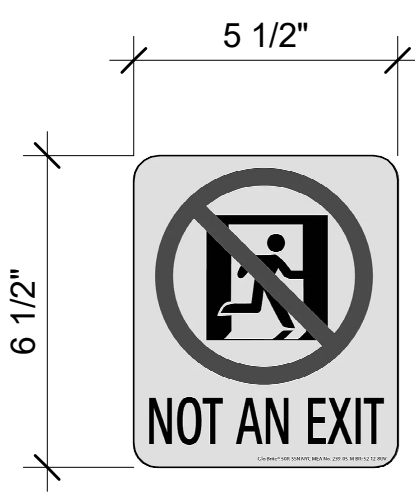

SIGN TYPE 10

10 SIGNAGE - NOT AN EXIT
3" = 1'-0"



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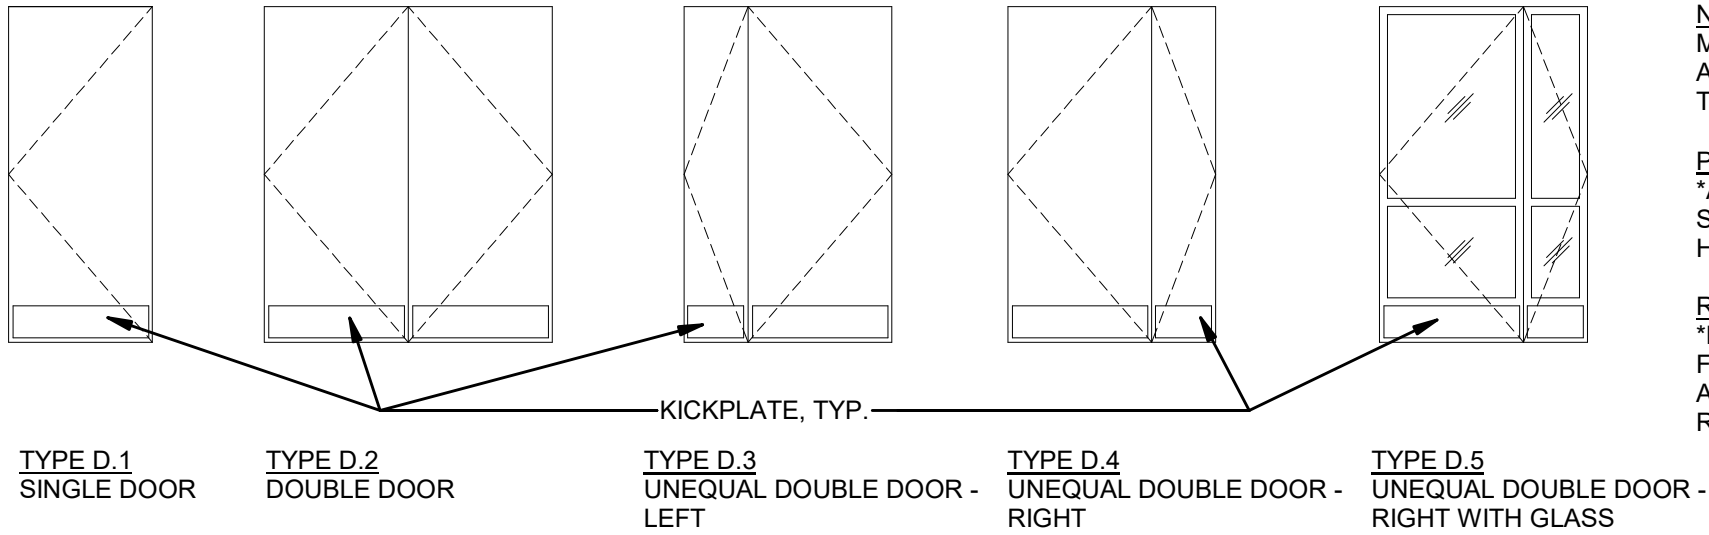
SIGNAGE DETAILS




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PROJECT NO 105121
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CHECKED BY Z. HARR
DRAWING NO
A-624.00
CADD FILE NO
AstoriaHVDC-CHPE
AstoriaCHPE-11-22-M3-A-001.rvt

| DOOR AND FRAME SCHEDULE | | | | | | | | | | | | | | | | | | |
|-------------------------|----|--------------|----------|---------|----------------------|--------|--------|---------|----------------|----------------|-------------------|----------------|------------|--------------|-----------------------------------|----------------|---------------|--|
| NUMBE R | | HARDWARE SET | TYP E | DOOR | | | FRAME | | HEAD DETAIL | JAMB DETAIL | THRESHOLD DETAIL | FIRE RATING | EMC GASKET | AIR TIGHT | CONNECTED TO GROUNDING GRID | DOOR CLOSER | KEY INTERLOCK | REMARKS |
| | | | | FINISH | SIZE WIDTH HEIGHT | TYPE | FINISH | | | | | | | | | | | |
| A101A | 2 | | D.1 | SST | 3'-0" | 7'-0" | F.1 | SST | 5/A-701.00 | 7/A-701.00 | 3/A-701.00 | | 90 MIN | YES | YES | YES | YES | ELECTRIFIED PANIC HARDWARE - LOW PROFILE CYLINDER PULL ON EXTERIOR TRIM - FAIL SECURE, EMERGENCY EXIT ONLY, DOOR POSITION SWITCH |
| A101B | 2 | | D.1 | SST | 3'-0" | 7'-0" | F.1 | SST | 5/A-701.00 | 7/A-701.00 | 3/A-701.00 | | 90 MIN | YES | YES | YES | YES | ELECTRIFIED PANIC HARDWARE - LOW PROFILE CYLINDER PULL ON EXTERIOR TRIM - FAIL SECURE, EMERGENCY EXIT ONLY, DOOR POSITION SWITCH |
| A101C | 2 | | D.1 | SST | 3'-0" | 7'-0" | F.1 | SST | 5/A-701.00 | 7/A-701.00 | 3/A-701.00 | | 90 MIN | YES | YES | YES | YES | ELECTRIFIED PANIC HARDWARE - LOW PROFILE CYLINDER PULL ON EXTERIOR TRIM - FAIL SECURE, EMERGENCY EXIT ONLY, DOOR POSITION SWITCH |
| A101D | 3 | | D.2 | SST | 11'-6" | 11'-6" | F.1A | SST | 5/A-701.00 | 7/A-701.00 | 6/A-700.00 | | 90 MIN | | YES | YES | NO | RADIO FREQUENCY INTERFERENCE DOOR - LOW PROFILE CYLINDER PULL ON EXTERIOR TRIM, REMOVEABLE MULLION - FAIL SECURE, SERVICE DOOR, DOOR POSITION SWITCH |
| A101E | 1 | | | SST | 3'-0" | 7'-0" | | SST | 5/A-701.00 | 3/A-700.00 | 3/A-701.00 | | | | YES | YES | YES | MANUAL INTERLOCK SYSTEM DOOR |
| A101F | 22 | | D.1 | SST | 3'-0" | 7'-0" | F.1 | SST | 5/A-701.00 | 7/A-701.00 | | | 90 MIN | | YES | YES | YES | PANIC HARDWARE WITH LEVER TRIM, NOT KEYED, INTERIOR ENTRANCE DOOR, DOOR POSITION SWITCH |
| A101G | 21 | | D.2 | SST | 11'-6" | 11'-6" | F.1A | SST | 5/A-701.00 | 7/A-701.00 | 6/A-700.00 | | 90 MIN | | YES | YES | YES | RADIO FREQUENCY INTERFERENCE DOOR - WITH LEVER TRIM, REMOVEABLE MULLION, NOT KEYED, INTERIOR DOOR, DOOR POSITION SWITCH |
| A102A | 20 | | D.2 | SST | 10'-0" | 11'-6" | F.4A | SST | 5/A-701.00 | 9/A-701.00 | 6/A-700.00 | | | | YES | YES | YES | MANUAL INTERLOCK SYSTEM DOOR, RADIO FREQUENCY INTERFERENCE DOOR, REMOVEABLE MULLION, INTERIOR DOOR |
| A102B | 2 | | D.1 | SST | 3'-0" | 7'-0" | F.1 | SST | 5/A-701.00 | 7/A-701.00 | 4/A-701.00 | | 90 MIN | YES | YES | YES | YES | ELECTRIFIED PANIC HARDWARE - LEVER TRIM - FAIL SECURE, INTERIOR DOOR, EMERGENCY EXIT ONLY, DOOR POSITION SWITCH |
| A102D | 2 | | D.1 | SST | 3'-0" | 7'-0" | F.1 | SST | 5/A-701.00 | 7/A-701.00 | 6/A-700.00 | | | YES | YES | YES | YES | RADIO FREQUENCY INTERFERENCE DOOR - WITH EXTERIOR LEVER TRIM, REMOVEABLE MULLION, & CARD READER - FAIL SECURE, DOOR POSITION SWITCH |
| A102E | 22 | | D.1 | SST | 3'-0" | 7'-0" | F.1 | SST | 5/A-701.00 | 7/A-701.00 | | | 90 MIN | | YES | YES | YES | PANIC HARDWARE WITH LEVER TRIM, NOT KEYED, INTERIOR ENTRANCE DOOR, DOOR POSITION SWITCH |
| A103A | 2 | | D.1 | HM | 3'-0" | 7'-0" | F.1 | HM | 5/A-701.00 | 7/A-701.00 | 3/A-701.00 | | | YES | YES | YES | YES | ELECTRIFIED PANIC HARDWARE - LOW PROFILE CYLINDER PULL ON EXTERIOR TRIM - FAIL SECURE, EMERGENCY EXIT ONLY, DOOR POSITION SWITCH |
| A103B | 3 | | D.2 | HM | 11'-6" | 11'-6" | F.1A | HM | 5/A-701.00 | 7/A-701.00 | 6/A-700.00 | | | YES | YES | YES | YES | RADIO FREQUENCY INTERFERENCE DOOR - LOW PROFILE CYLINDER PULL ON EXTERIOR TRIM, REMOVEABLE MULLION - FAIL SECURE, SERVICE DOOR, DOOR POSITION SWITCH |
| A103C | 1 | | D.1 | HM | 3'-0" | 7'-0" | F.4 | HM | 5/A-701.00 | 9/A-701.00 | 3/A-701.00 | | | | YES | YES | YES | MANUAL INTERLOCK SYSTEM DOOR |
| A103D | 2 | | D.1 | HM | 3'-0" | 7'-0" | F.1 | HM | 5/A-701.00 | 7/A-701.00 | 3/A-701.00 | | | YES | YES | YES | YES | ELECTRIFIED PANIC HARDWARE - LOW PROFILE CYLINDER PULL ON EXTERIOR TRIM - FAIL SECURE, EMERGENCY EXIT ONLY, DOOR POSITION SWITCH |
| A103E | 1 | | D.1 | HM | 3'-0" | 7'-0" | F.4 | HM | 5/A-701.00 | 9/A-701.00 | 3/A-701.00 | | | | YES | YES | YES | MANUAL INTERLOCK SYSTEM DOOR |
| A103G | 2 | | | HM | 3'-0" | 7'-0" | | HM | 5/A-701.00 | 7/A-701.00 | 3/A-701.00 | | | | YES | YES | YES | ELECTRIFIED PANIC HARDWARE - LOW PROFILE CYLINDER PULL ON EXTERIOR TRIM - FAIL SECURE, EMERGENCY EXIT ONLY, DOOR POSITION SWITCH |
| A104A | 2 | | D.1 | HM | 3'-0" | 7'-0" | F.1 | HM | 5/A-701.00 | 7/A-701.00 | 3/A-701.00 | | | YES | YES | YES | YES | ELECTRIFIED PANIC HARDWARE - LOW PROFILE CYLINDER PULL ON EXTERIOR TRIM - FAIL SECURE, EMERGENCY EXIT ONLY, DOOR POSITION SWITCH |
| A104B | 2 | | D.1 | HM | 3'-0" | 7'-0" | F.1 | HM | 5/A-701.00 | 7/A-701.00 | 3/A-701.00 | | | YES | YES | YES | YES | ELECTRIFIED PANIC HARDWARE - LOW PROFILE CYLINDER PULL ON EXTERIOR TRIM - FAIL SECURE, EMERGENCY EXIT ONLY, DOOR POSITION SWITCH |
| A104C | 2 | | D.1 | HM | 3'-0" | 7'-0" | F.1 | HM | 5/A-701.00 | 7/A-701.00 | 3/A-701.00 | | | YES | YES | YES | YES | ELECTRIFIED PANIC HARDWARE - LOW PROFILE CYLINDER PULL ON EXTERIOR TRIM - FAIL SECURE, EMERGENCY EXIT ONLY, DOOR POSITION SWITCH |
| A104D | 2 | | D.1 | HM | 3'-0" | 7'-0" | F.1 | HM | 5/A-701.00 | 7/A-701.00 | 3/A-701.00 | | | YES | YES | YES | YES | ELECTRIFIED PANIC HARDWARE - LOW PROFILE CYLINDER PULL ON EXTERIOR TRIM - FAIL SECURE, EMERGENCY EXIT ONLY, DOOR POSITION SWITCH |
| A104E | 3 | | D.2 | HM | 13'-2" | 16'-6" | F.1A | HM | 5/A-701.00 | 7/A-701.00 | 6/A-700.00 | | | YES | YES | YES | YES | RADIO FREQUENCY INTERFERENCE DOOR - LOW PROFILE CYLINDER PULL ON EXTERIOR TRIM, REMOVEABLE MULLION - FAIL SECURE, SERVICE DOOR, DOOR POSITION SWITCH |
| A104F | 1 | | | HM | 3'-0" | 7'-0" | | HM | 5/A-701.00 | 9/A-701.00 | 3/A-701.00 | | | | YES | YES | YES | MANUAL INTERLOCK SYSTEM DOOR |
| A104G | 2 | | D.1 | HM | 3'-0" | 7'-0" | F.1 | HM | 5/A-701.00 | 7/A-701.00 | 3/A-701.00 | | | YES | YES | YES | YES | ELECTRIFIED PANIC HARDWARE - LOW PROFILE CYLINDER PULL ON EXTERIOR TRIM - FAIL SECURE, EMERGENCY EXIT ONLY, DOOR POSITION SWITCH |
| A104H | 2 | | D.1 | HM | 3'-0" | 7'-0" | F.1 | HM | 5/A-701.00 | 7/A-701.00 | 3/A-701.00 | | | YES | YES | YES | YES | ELECTRIFIED PANIC HARDWARE - LOW PROFILE CYLINDER PULL ON EXTERIOR TRIM - FAIL SECURE, EMERGENCY EXIT ONLY, DOOR POSITION SWITCH |
| A104I | 2 | | D.1 | HM | 3'-0" | 7'-0" | F.1 | HM | 5/A-701.00 | 7/A-701.00 | 3/A-701.00 | | | YES | YES | YES | YES | ELECTRIFIED PANIC HARDWARE - LOW PROFILE CYLINDER PULL ON EXTERIOR TRIM - FAIL SECURE, EMERGENCY EXIT ONLY, DOOR POSITION SWITCH |
| A104J | 2 | | D.1 | HM | 3'-0" | 7'-0" | F.1 | HM | 5/A-701.00 | 7/A-701.00 | 3/A-701.00 | | | YES | YES | YES | YES | ELECTRIFIED PANIC HARDWARE - LOW PROFILE CYLINDER PULL ON EXTERIOR TRIM - FAIL SECURE, EMERGENCY EXIT ONLY, DOOR POSITION SWITCH |
| A104K | 1 | | D.1 | HM | 3'-0" | 7'-0" | F.4 | HM | 5/A-701.00 | 7/A-701.00 | 3/A-701.00 | | | | YES | YES | YES | MANUAL INTERLOCK SYSTEM DOOR |
| A105A | 15 | | D.2 | HM | 6'-0" | 7'-0" | F.1A | HM | 5/A-701.00 | 7/A-701.00 | 3/A-701.00 | | | YES | YES | YES | YES | STORE ROOM LOCKSET, DOOR POSITION SWITCH, EXTERIOR LEVER TRIM |
| B101 | 6 | | D.3 | HM, PTD | 4'-4" | 8'-0" | F.1A | HM, PTD | 1/A-700.00 | 3/A-700.00 | 4/A-701.00 | | | NO | | YES | NO | ELECTRIFIED PANIC HARDWARE - WITH EXTERIOR LEVER TRIM, REMOVEALBE MULLION, & CARD READER - FAIL SECURE |
| B102A | 6 | | D.4 | HM, PTD | 4'-4" | 8'-0" | F.1A | SST | 1/A-700.00 | 3/A-700.00 | 3/A-701.00 | | | NO | | YES | NO | ELECTRIFIED PANIC HARDWARE - NO EXTERIOR TRIM, REMOVEALBE MULLION, & CARD READER - FAIL SECURE |
| B102B | 7 | | D.3 | HM, PTD | 4'-4" | 8'-0" | F.3 | HM, PTD | 1/A-701.00 | 1/A-701.00 | RAISED FLOOR | | | NO | | YES | NO | ELECTRIFIED PANIC HARDWARE - WITH LEVER TRIM, REMOVEALBE MULLION, & CARD READER - FAIL SAFE |
| B103 | 6 | | D.3 | HM, PTD | 4'-4" | 8'-0" | F.1A | SST | 1/A-700.00 | 3/A-700.00 | 4/A-701.00 | | | NO | | YES | NO | ELECTRIFIED PANIC HARDWARE - WITH EXTERIOR LEVER TRIM, REMOVEALBE MULLION, & CARD READER - FAIL SECURE |
| B104 | 6 | | D.3 | HM, PTD | 4'-4" | 8'-0" | F.1A | SST | 1/A-700.00 | 3/A-700.00 | 9/A-700.00 | | | NO | | YES | NO | ELECTRIFIED PANIC HARDWARE - NO EXTERIOR TRIM, REMOVEALBE MULLION, & CARD READER - FAIL SECURE |
| B105 | 8 | | D.4 | HM, PTD | 4'-4" | 8'-0" | F.3 | SST | 1/A-701.00 | 1/A-701.00 | RAISED FLOOR | | 90 MIN | NO | | YES | NO | ELECTRIFIED HARDWARE, STOREROOM LOCKSET, REMOVEALBE MULLION, CARD READER - FAIL SAFE |
| B106 | 19 | | D.3 | HM, PTD | 4'-4" | 8'-0" | F.3 | SST | 1/A-701.00 | 1/A-701.00 | RAISED FLOOR | | 90 MIN | NO | | YES | NO | ELECTRIFIED PANIC HARDWARE - WITH LEVER TRIM, REMOVEALBE MULLION, & CARD READER - FAIL SAFE |
| B107 | 8 | | D.3 | HM, PTD | 4'-4" | 8'-0" | F.3 | SST | 1/A-701.00 | 1/A-701.00 | RAISED FLOOR | | 90 MIN | NO | | YES | NO | ELECTRIFIED HARDWARE, STOREROOM LOCKSET, REMOVEALBE MULLION, CARD READER - FAIL SAFE |
| B108 | 6 | | D.4 | HM, PTD | 4'-4" | 8'-0" | F.1A | SST | 1/A-700.00 | 3/A-700.00 | 3/A-701.00 | | | NO | | YES | NO | ELECTRIFIED PANIC HARDWARE - WITH EXTERIOR LEVER TRIM, REMOVEALBE MULLION, & CARD READER - FAIL SECURE |
| B109 | 13 | | D.1 | HM, PTD | 3'-0" | 7'-0" | F.2 | SST | 1/A-701.00 | 1/A-701.00 | | | 90 MIN | NO | | YES | NO | ELECTRIFIED PANIC HARDWARE - WITH LEVER TRIM & CARD READER - FAIL SAFE |
| B110 | 12 | | D.1 | HM, PTD | 3'-0" | 7'-0" | F.2 | SST | 1/A-701.00 | 1/A-701.00 | ADA MARBLE SADDLE | | 90 MIN | NO | | YES | NO | ELECTRIFIED STOREROOM LOCKSET, CARD READER |
| B111 | 10 | | D.1 | HM, PTD | 3'-0" | 7'-0" | F.2 | SST | 1/A-701.00 | 1/A-701.00 | | | | NO | | YES | NO | PASSAGE LOCK |
| B112 | 11 | | D.1 | HM, PTD | 3'-0" | 7'-0" | F.2 | SST | 1/A-701.00 | 1/A-701.00 | ADA MARBLE SADDLE | | 90 MIN | NO | | YES | NO | PRIVACY LOCKSET |
| B113 | 9 | | D.1 | HM, PTD | 2'-8" | 7'-0" | F.2 | SST | 1/A-701.00 | 1/A-701.00 | ADA MARBLE SADDLE | | 90 MIN | NO | | YES | NO | STOREROOM LOCKSET |
| B114 | 5 | | D.1 | HM, PTD | 3'-0" | 7'-0" | F.1 | SST | 1/A-701.00 | 1/A-701.00 | 4/A-701.00 | | | NO | | YES | NO | ELECTRIFIED STOREROOM LOCKSET, CARD READER |
| B115A | 4 | | | HM, PTD | 12'-0" | 12'-0" | | SST | 1/A-700.00 | 3/A-700.00 | 6/A-700.00 | | | NO | | YES | NO | RADIO FREQUENCY INTERFERENCE DOOR, REMOVEABLE MULLION, NO EXTERIOR TRIM, ELECTRIFIED HARDWARE, CARD READER - FAIL SECURE |
| B115C | 18 | | D.1 | HM, PTD | 3'-0" | 7'-0" | F.2 | SST | 1/A-701.00 | 1/A-701.00 | | | 90 MIN | NO | | YES | NO | ELECTRIFIED PANIC HARDWARE - WITH LEVER TRIM & CARD READER - FAIL SAFE |
| B116 | 8 | | D.4 | HM, PTD | 4'-4" | 8'-0" | F.1A | SST | 1/A-701.00 | 1/A-701.00 | | | | NO | | YES | NO | ELECTRIFIED STOREROOM LOCKSET, CARD READER |
| B201 | 8 | | D.4 | HM, PTD | 4'-0" | 8'-0" | F.3 | SST | 1/A-701.00 | 1/A-701.00 | | | 90 MIN | NO | | YES | NO | ELECTRIFIED PANIC HARDWARE - WITH LEVER TRIM, REMOVEALBE MULLION, & CARD READER - FAIL SAFE |
| B202A | 14 | | D.2 | HM, PTD | 7'-0" | 7'-0" | F.3 | SST | 5/A-700.00 | 5/A-700.00 | | | 90 MIN | NO | | YES | NO | ELECTRIFIED PANIC HARDWARE - WITH LEVER TRIM, REMOVEALBE MULLION, & CARD READER - FAIL SAFE |
| B202B | 14 | | D.2 | HM, PTD | 7'-0" | 7'-0" | F.3 | SST | 5/A-700.00 | 5/A-700.00 | | | 90 MIN | NO | | YES | NO | ELECTRIFIED PANIC HARDWARE - WITH LEVER TRIM, REMOVEALBE MULLION, & CARD READER - FAIL SAFE |
| B203 | 16 | | D.2 | HM, PTD | 7'-0" | 8'-0" | F.1A | SST | 1/A-700.00 | 3/A-700.00 | 3/A-701.00 | | | NO | | YES | NO | ELECTRIFIED STOREROOM LOCKSET - EXTERIOR SAFETY GATE, REMOVEABLE MULLION & CARD READER - FAIL SECURE |
| B204 | 17 | | D.1 | HM, PTD | 3'-0" | 8'-0" | F.2 | SST | 1/A-700.00 | 1/A-701.00 | | | 90 MIN | NO | | YES | NO | ELECTRIFIED PANIC HARDWARE - WITH LEVER TRIM & CARD READER - FAIL SAFE |
| B205 | 7 | | D.3 | HM, PTD | 4'-0" | 8'-0" | F.1A | SST | 1/A-701.00 | 1/A-701.00 | | | | NO | | YES | NO | ELECTRIFIED PANIC HARDWARE - WITH LEVER TRIM, REMOVEALBE MULLION, & CARD READER - FAIL SAFE |


DOOR TYPE LEGEND



FRAME TYPE LEGEND

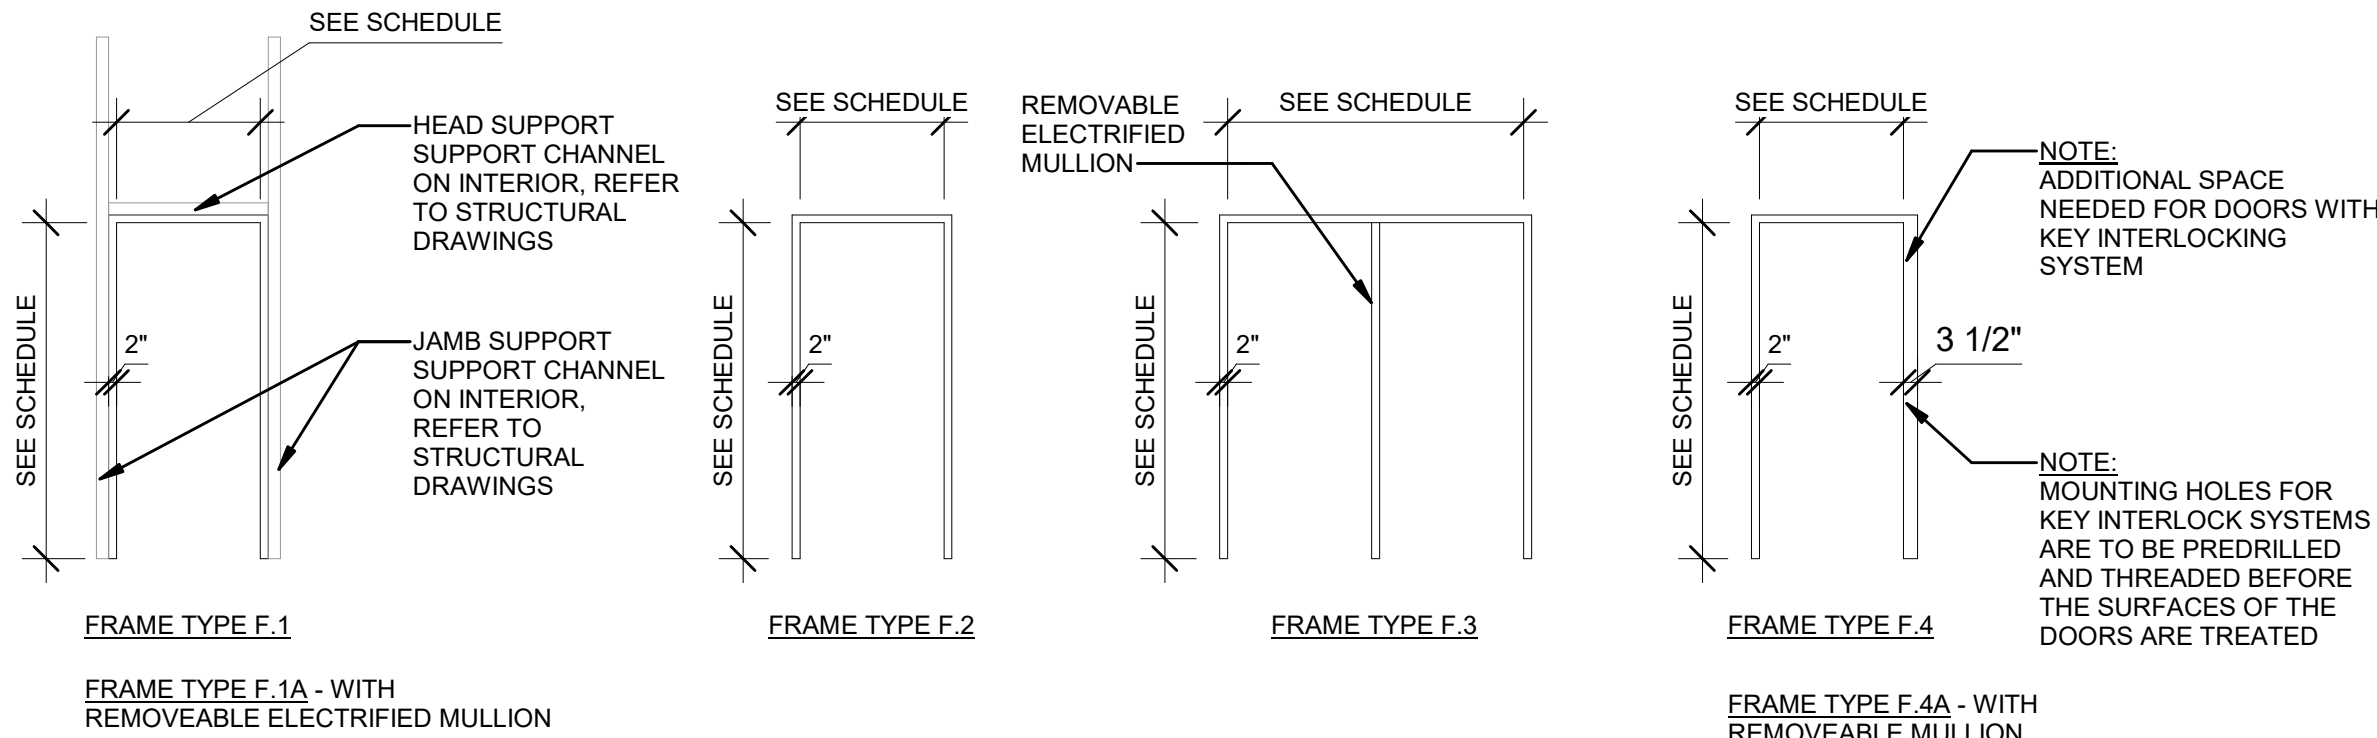

TYP. DOOR GROUNDING & RFI PROTECTION

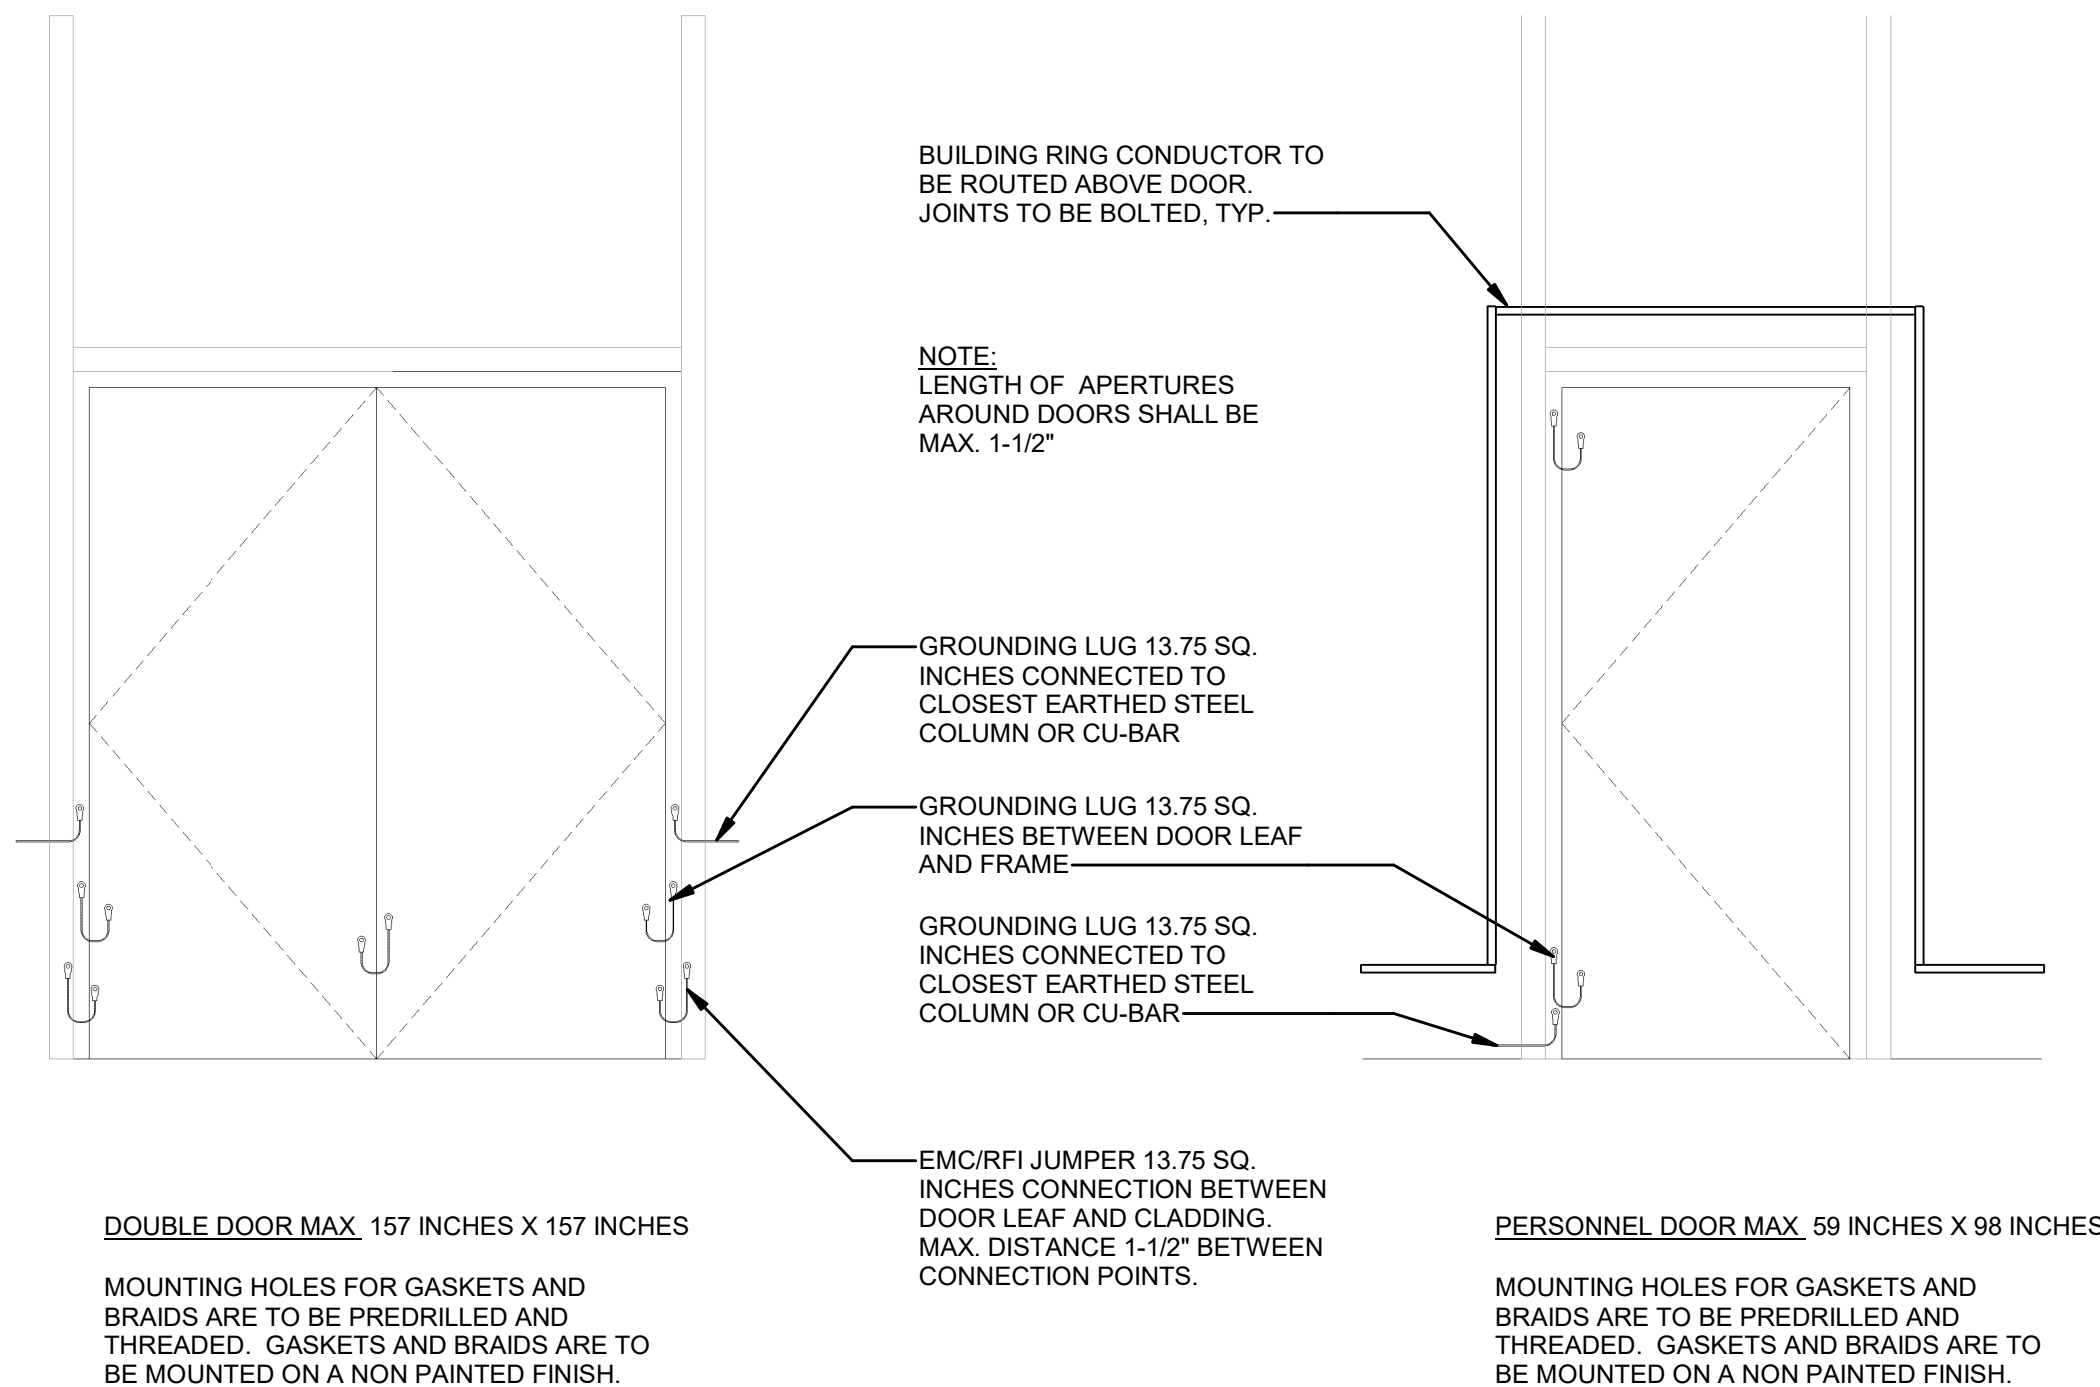

ISSUED FOR PERMIT

Engineering and
Land Surveying, P.C.

370 7th Avenue
SUITE 1604
New York, NY 10001

SOWINSKI
SULLIVAN
ARCHITECTURE + ENGINEERING

25 Mohawk Avenue
Sparta, NJ 07871

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| | | | | |
|-----|------------------|--------|--------|------------|
| 0 | FINAL SUBMISSION | RAC | ZH | 12/12/2022 |
| REV | DESCRIPTION | DRW BY | CHK BY | DATE |

Kiewit

470 Chestnut Ridge Rd # 2,
Woodcliff Lake, NJ 07677

Hitachi Energy

901 Main Campus Drive
Raleigh, North Carolina 27606

PROJECT

CHPE
Champlain Hudson
Power Express

Astoria HVDC
Converter Station

31-45 20th Avenue, Astoria, Queens NY 11105
Block #850 - Lot #310 - BIN #4624437

DOOR SCHEDULE




DATE 12/12/22
PROJECT NO 105121
DRAWING BY R. COLES
CHECKED BY Z. HARR
DRAWING NO


A-701.00

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Astoria CHA-KIE-111-22-M3-A-001.rvt


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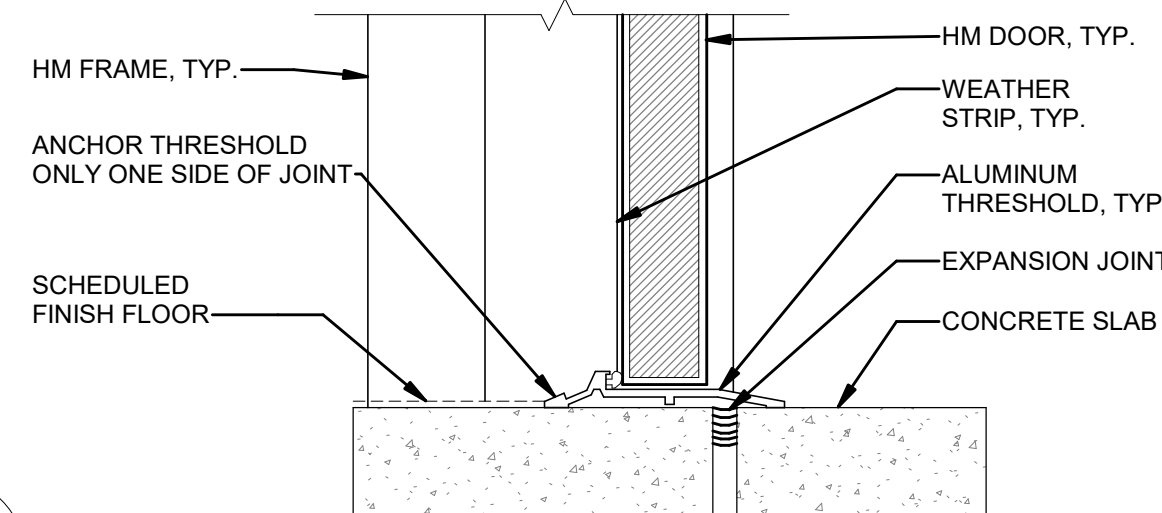
1 HM FRAME / GWB PARTITION JAMB/HEAD DETAIL
3" = 1'-0"

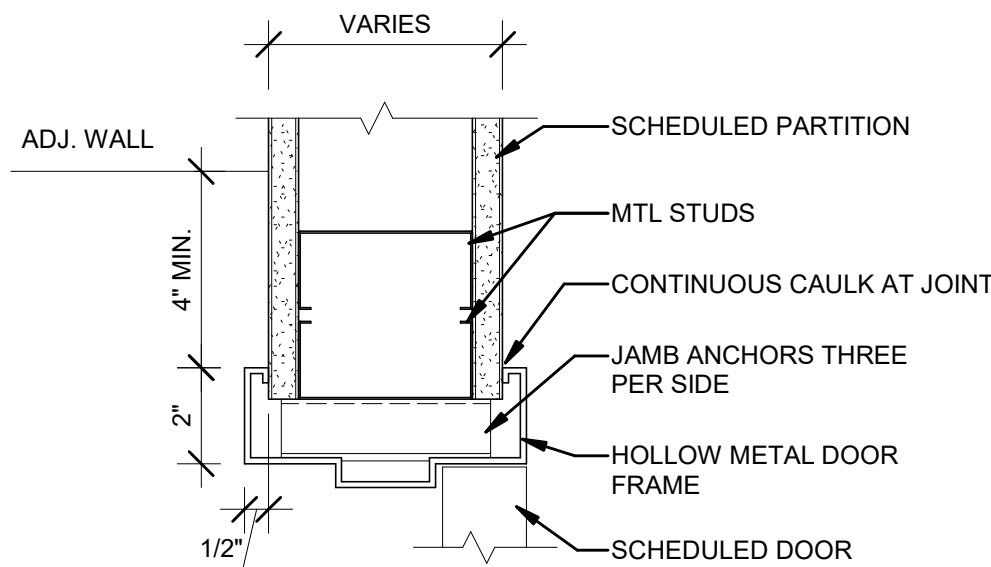


2 HM FRAME / GWB PARTITION JAMB/HEAD DETAIL - WIDE
3" = 1'-0"

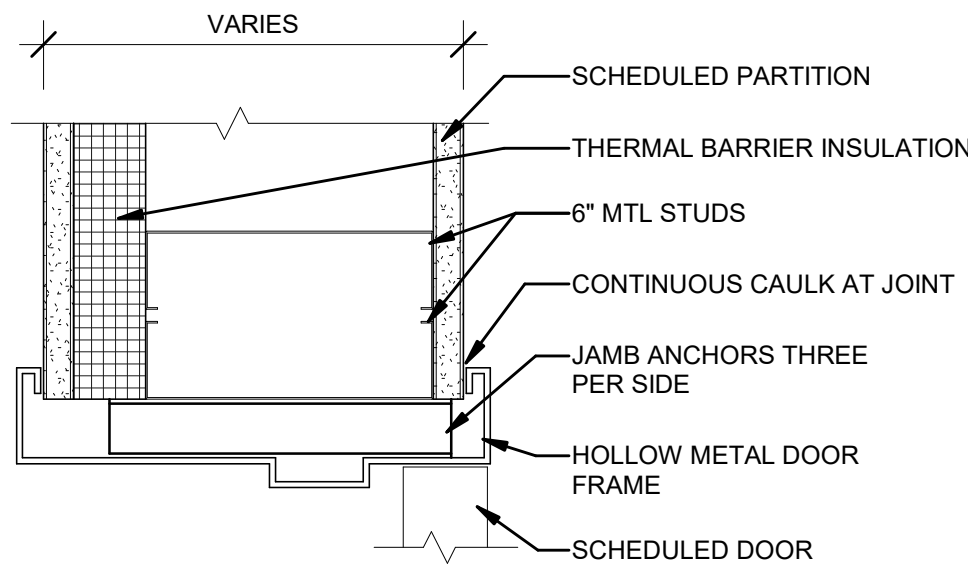


3 HM DOOR THRESHOLD DETAIL
3" = 1'-0"

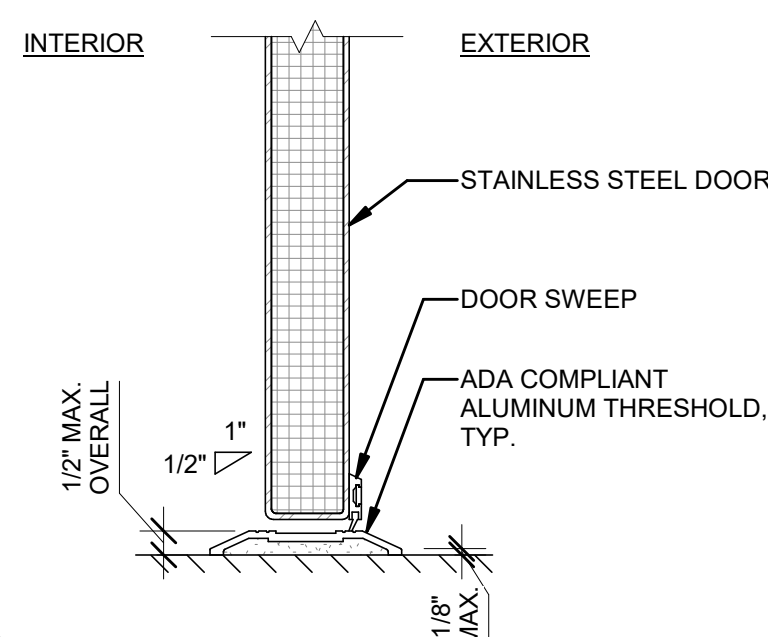


4 HM DOOR FIRE RATED SILL DETAIL
3" = 1'-0"

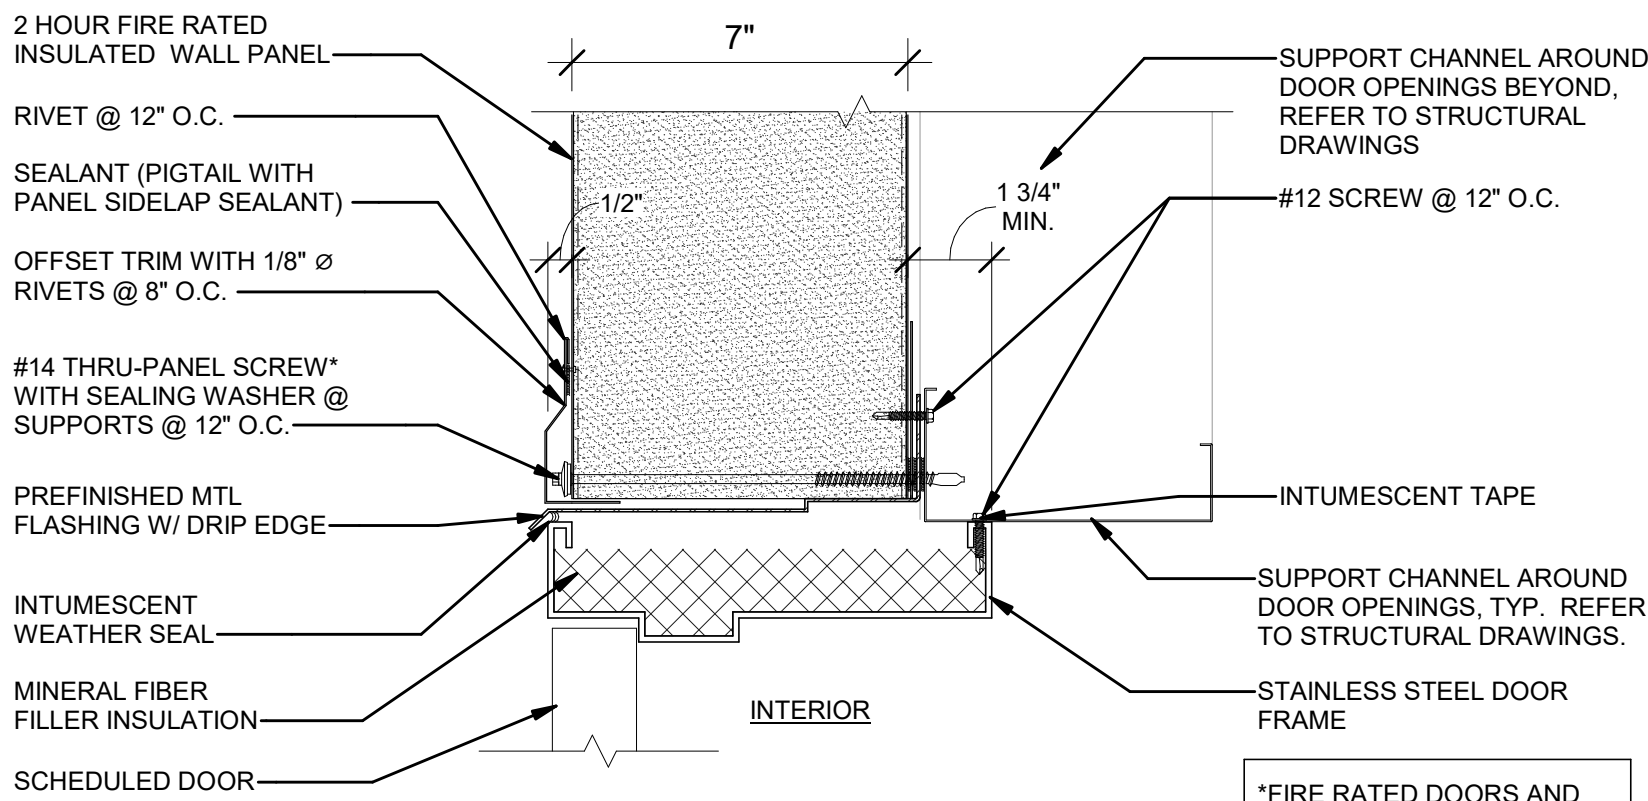


5 TYPICAL EXTERIOR DOOR HEAD DETAIL
3" = 1'-0"

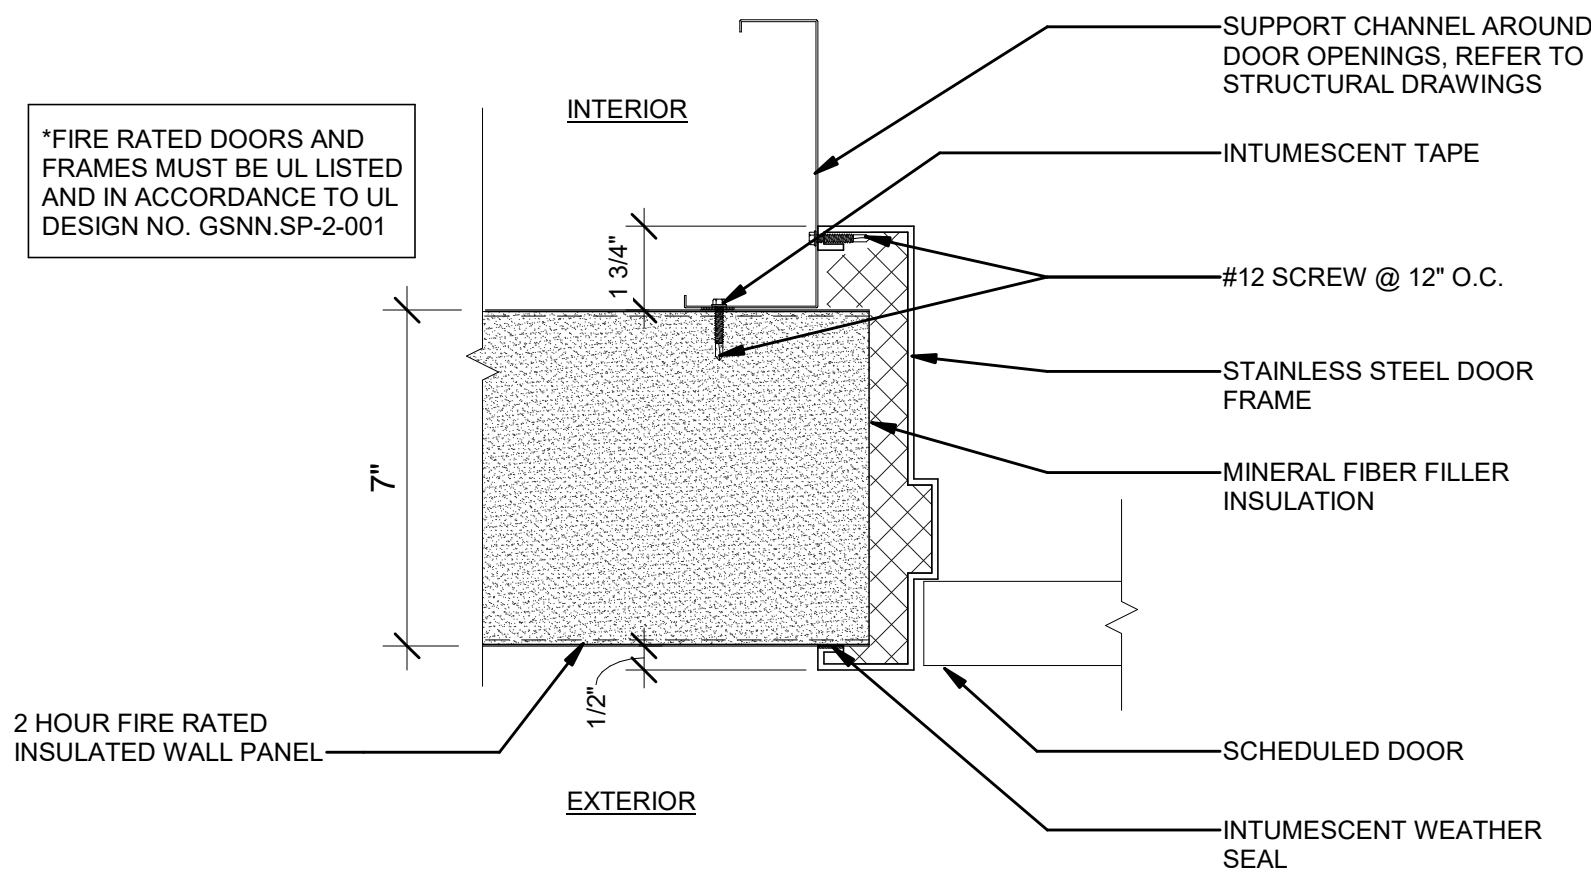


6 TYPICAL EXTERIOR DOOR JAMB DETAIL
3" = 1'-0"

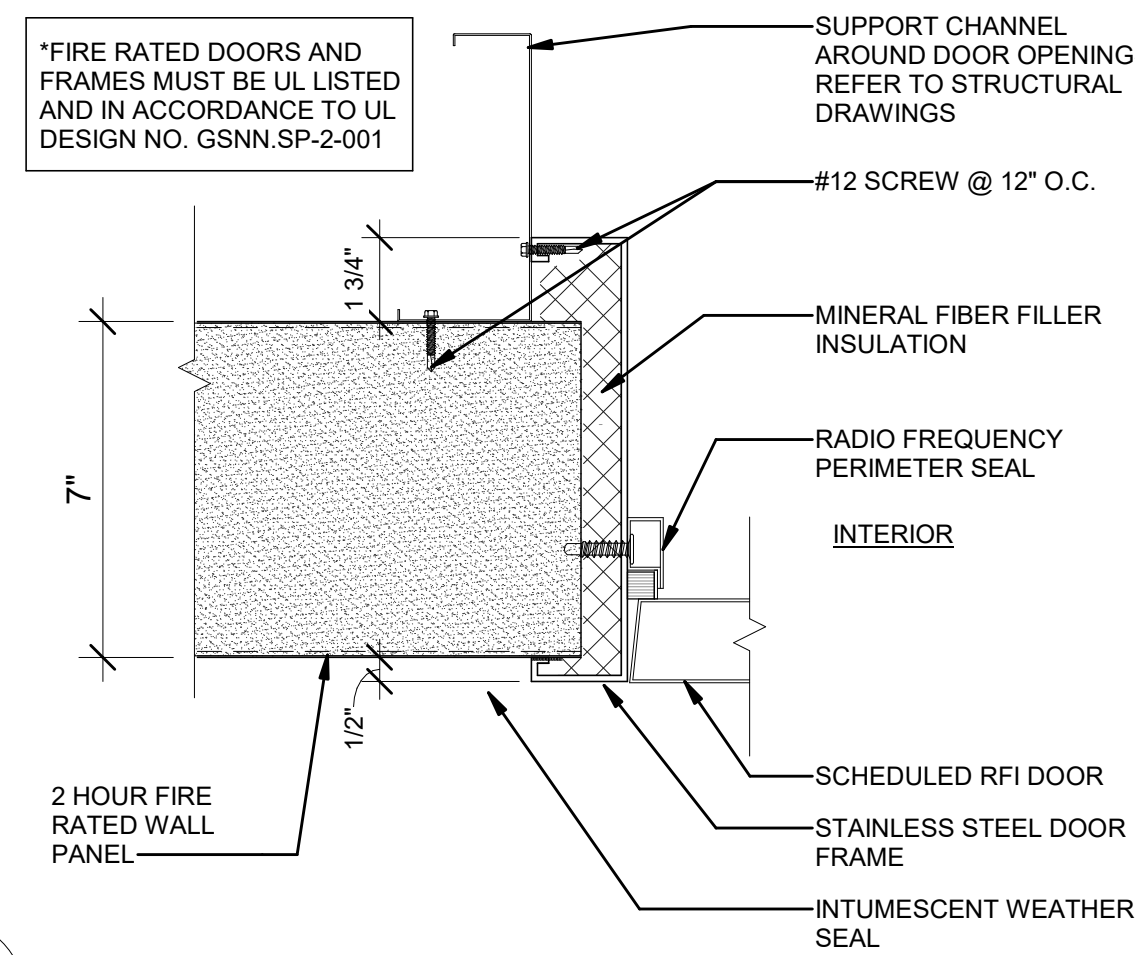

7 RFI EXTERIOR DOOR JAMB DETAIL
3" = 1'-0"

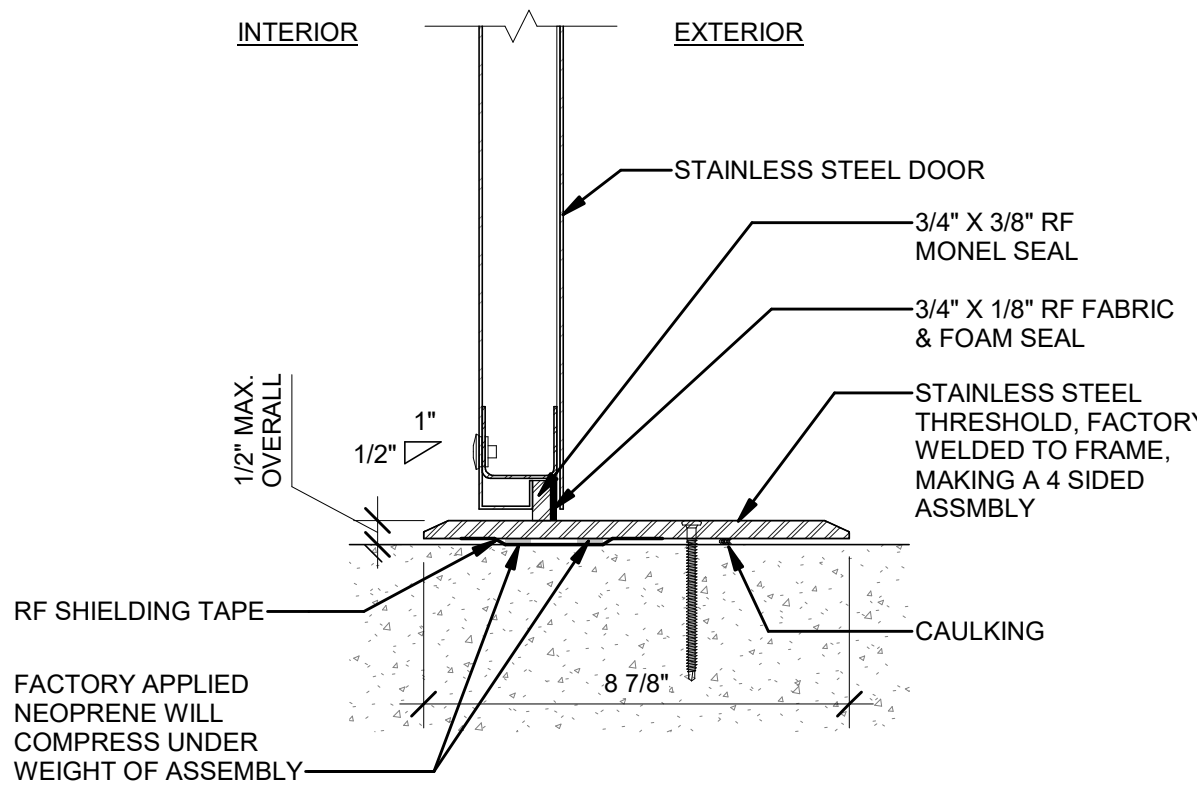

8 RFI DOOR THRESHOLD DETAIL
3" = 1'-0"

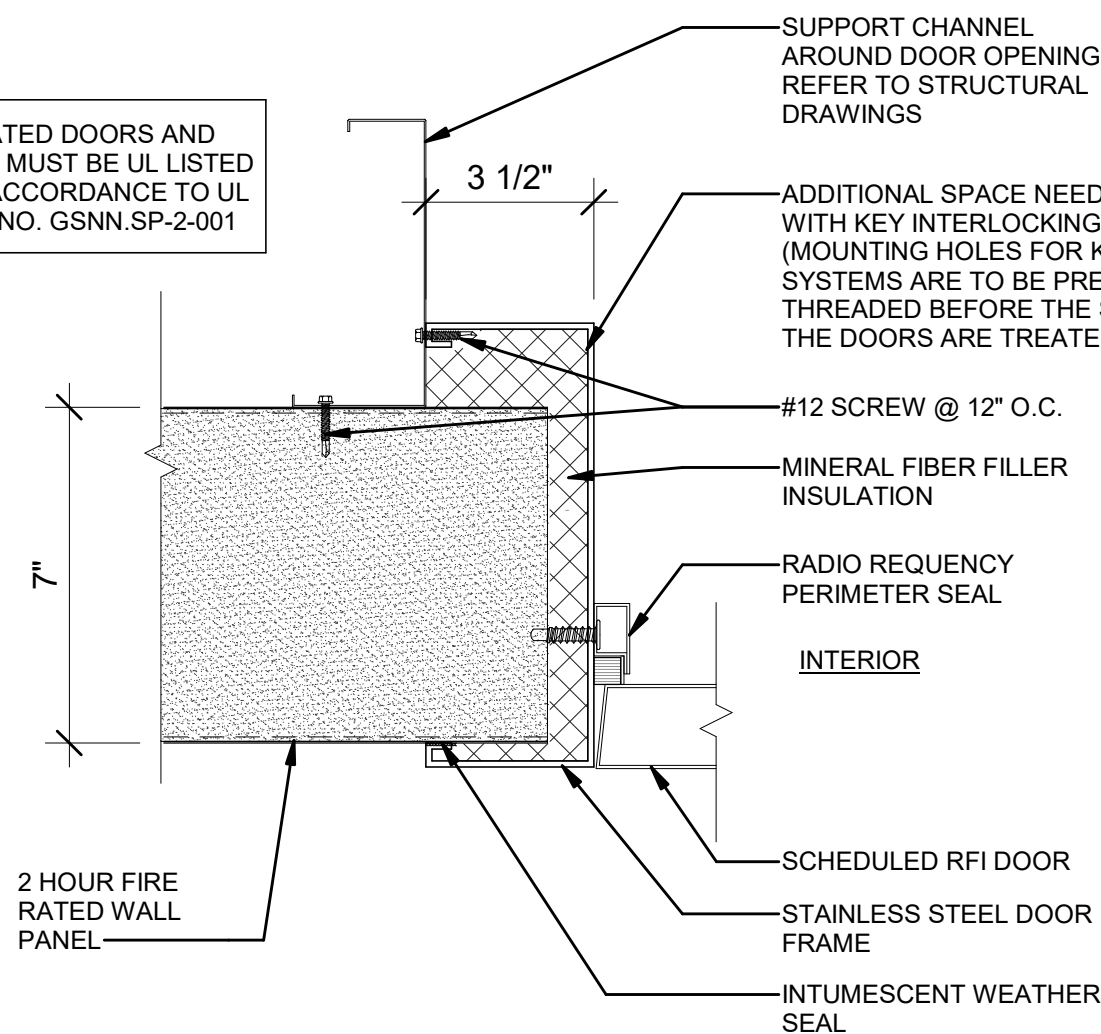

9 RFI EXTERIOR DOOR JAMB DETAIL - KEY INTERLOCK SYSTEMS DOORS
3" = 1'-0"

ISSUED FOR PERMIT

Engineering and
Land Surveying, P.C.

370 7th Avenue
SUITE 1604
New York, NY 10001

SOWINSKI
SULLIVAN
ARCHITECTURE+ENGINEERING

25 Mohawk Avenue
Sparta, NJ 07871

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| 0 | FINAL SUBMISSION | RAC | ZH | 12/12/2022 |
|-----|------------------|--------|--------|------------|
| REV | DESCRIPTION | DRW BY | CHK BY | DATE |

Kiewit
470 Chestnut Ridge Rd # 2,
Woodcliff Lake, NJ 07677

Hitachi Energy
901 Main Campus Drive
Raleigh, North Carolina 27606


PROJECT

CHPE
Champlain Hudson
Power Express

**Astoria HVDC
Converter Station**

31-45 20th Avenue, Astoria, Queens NY 11105
Block #850 - Lot #310 - BIN #4624437

DOOR DETAILS

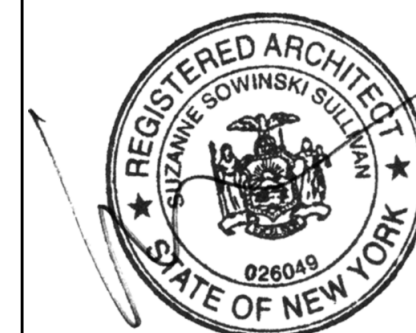

DATE 12/12/22
PROJECT NO 105121
DRAWING BY R. COLES
CHECKED BY Z. HARR
DRAWING NO
A-702.00
CADD FILE NO
Astoria-HVDC-CHPE
Astoria-CHA-KIE-111-ZZ-M3-A-001.rvt

3" 0 3" 9"

| FINISH LEGEND | | | | |
|---------------|--------------------------------|--------------------------------|----------------|--|
| TAG | FINISH TYPE | MANUFACTURER OR APPROVED EQUAL | COLOR / FINISH | NOTES |
| ACC-1 | RAISED ACCESS FLOORING | TATE OR APPROVED EQUAL | | HEAVIEST DESIGN LOAD WITH HEAVY DUTY 2" BOLTED STRINGER |
| ALU-1 | ALUMINIUM FLOOR (REACTOR HALL) | | | WELDED WITH COPPER FLAT BAR, SPACED FOR THERMAL MOVMENT UNDERNEATH EQUIPMENT STEEL |
| EP-1 | EPOXY FLOOR COATING SYSTEM | | | |
| PT-1 | PAINT | | | |
| PT-2 | PAINT | | | |
| QT-1 | PORCELAIN TILE | | | WALL AND FLOOR TILE |
| VB-1 | RUBBER BASE | | | |


| ROOM FINISH SCHEDULE | | | | | |
|----------------------|-----------|-------------|-------------|--------------|----------------|
| ROOM NUMBER | ROOM NAME | BASE FINISH | WALL FINISH | FLOOR FINISH | CEILING FINISH |

| | | | | | |
|------|-----------------------------|-------|--|--------|-------|
| | <varies> | - | | EP-1 | PT-1 |
| A101 | POSITIVE VALVE HALL | - | | EP-1 | PT-1 |
| A102 | NEGATIVE VALVE HALL | - | | EP-1 | PT-1 |
| A103 | REACTOR HALL | - | | EP-1 | PT-1 |
| A104 | DC HALL | - | | EP-1 | PT-1 |
| A105 | HVAC ROOM | - | | EP-1 | PT-1 |
| B101 | BATTERY ROOM B | VINYL | | EP-1 | PT-1 |
| B102 | AUXILIARY ROOM | VINYL | | ACC-1 | PT-1 |
| B103 | BATTERY ROOM A | VINYL | | EP-1 | PT-1 |
| B104 | CONTROL & PROTECTION ROOM 2 | VINYL | | ACC-1 | PT-1 |
| B105 | I/O ROOM | VINYL | | ACC-1 | PT-1 |
| B106 | CORRIDOR | VINYL | | ACC-1 | PT-1 |
| B107 | CONTROL & PROTECTION ROOM 1 | VINYL | | ACC-1 | PT-1 |
| B108 | ENTRANCE RM | VINYL | | CONC-1 | ACT-1 |
| B109 | OPERATOR ROOM | VINYL | | EP-1 | ACT-1 |
| B110 | LOCKER ROOM | QT-1 | | QT-1 | ACT-1 |
| B111 | BREAK ROOM | QT-1 | | QT-1 | ACT-1 |
| B112 | RESTROOM | QT-1 | | QT-1 | PT-1 |
| B113 | CLEANING ROOM | QT-1 | | EP-1 | PT-1 |
| B114 | UMD BATTERY ROOM | VINYL | | EP-1 | PT-1 |
| B115 | VALVE COOLING ROOM | VINYL | | EP-1 | PT-1 |
| B116 | MCC ROOM | VINYL | | EP-1 | PT-1 |
| B201 | CLEAN AGENT ROOM | VINYL | | EP-1 | PT-1 |
| B202 | CLIMATE ROOM 1 | VINYL | | EP-1 | PT-1 |
| B203 | CORRIDOR | VINYL | | EP-1 | ACT-1 |
| B204 | STORAGE ROOM | VINYL | | EP-1 | PT-1 |
| B205 | TELECOM ROOM | VINYL | | EP-1 | PT-1 |

| COATING FINISH SCHEDULE | | | | | | |
|-------------------------|-----------|---------|-------------------|---------|-----------|--------------|
| ROOM NUMBER | ROOM NAME | COLUMNS | SECONDARY FRAMING | TRUSSES | ROOF DECK | ROOF FRAMING |

| | | | | | | |
|------|-----------------------------|---|---|---|------------------|------------------|
| | <varies> | | | | | |
| A101 | POSITIVE VALVE HALL | INTUMESCENT PAINTED | INTUMESCENT PAINTED | INTUMESCENT PAINTED | GALVANIZED | GALVANIZED |
| A102 | NEGATIVE VALVE HALL | INTUMESCENT PAINTED | INTUMESCENT PAINTED | INTUMESCENT PAINTED | GALVANIZED | GALVANIZED |
| A103 | REACTOR HALL | GALVANIZED, EXCEPT ALONG 2 HOUR RATED WALL COLUMN LINE CO-G | GALVANIZED, EXCEPT ALONG 2 HOUR RATED WALL COLUMN LINE CO-G | GALVANIZED, EXCEPT ALONG 2 HOUR RATED WALL COLUMN LINE CO-G | GALVANIZED | GALVANIZED |
| A104 | DC HALL | GALVANIZED, EXCEPT ALONG 2 HOUR RATED WALL COLUMN LINE CO-P | GALVANIZED, EXCEPT ALONG 2 HOUR RATED WALL COLUMN LINE CO-P | GALVANIZED, EXCEPT ALONG 2 HOUR RATED WALL COLUMN LINE CO-P | GALVANIZED | GALVANIZED |
| A105 | HVAC ROOM | GALVANIZED | GALVANIZED | GALVANIZED | GALVANIZED | GALVANIZED |
| B101 | BATTERY ROOM B | CEMENTITIOUS | CEMENTITIOUS | NON GALV PAINTED | NON GALV PAINTED | NON GALV PAINTED |
| B102 | AUXILIARY ROOM | NON GALV PAINTED, EXCEPT CEMENTITIOUS ALONG RATED WALLS | NON GALV PAINTED, EXCEPT CEMENTITIOUS ALONG RATED WALLS | NON GALV PAINTED | NON GALV PAINTED | NON GALV PAINTED |
| B103 | BATTERY ROOM A | CEMENTITIOUS | CEMENTITIOUS | NON GALV PAINTED | NON GALV PAINTED | NON GALV PAINTED |
| B104 | CONTROL & PROTECTION ROOM 2 | NON GALV PAINTED, EXCEPT CEMENTITIOUS ALONG RATED WALLS | NON GALV PAINTED, EXCEPT CEMENTITIOUS ALONG RATED WALLS | NON GALV PAINTED | NON GALV PAINTED | NON GALV PAINTED |
| B105 | I/O ROOM | NON GALV PAINTED, EXCEPT CEMENTITIOUS ALONG RATED WALLS | NON GALV PAINTED, EXCEPT CEMENTITIOUS ALONG RATED WALLS | NON GALV PAINTED | NON GALV PAINTED | NON GALV PAINTED |
| B106 | CORRIDOR | CEMENTITIOUS | CEMENTITIOUS | NON GALV PAINTED | NON GALV PAINTED | NON GALV PAINTED |
| B107 | CONTROL & PROTECTION ROOM 1 | NON GALV PAINTED, EXCEPT CEMENTITIOUS ALONG RATED WALLS | NON GALV PAINTED, EXCEPT CEMENTITIOUS ALONG RATED WALLS | NON GALV PAINTED | NON GALV PAINTED | NON GALV PAINTED |
| B108 | ENTRANCE RM | CEMENTITIOUS | CEMENTITIOUS | NON GALV PAINTED | NON GALV PAINTED | NON GALV PAINTED |
| B109 | OPERATOR ROOM | CEMENTITIOUS | CEMENTITIOUS | NON GALV PAINTED | NON GALV PAINTED | NON GALV PAINTED |
| B110 | LOCKER ROOM | NON GALV PAINTED, EXCEPT CEMENTITIOUS ALONG RATED WALLS | NON GALV PAINTED, EXCEPT CEMENTITIOUS ALONG RATED WALLS | NON GALV PAINTED | NON GALV PAINTED | NON GALV PAINTED |
| B111 | BREAK ROOM | NON GALV PAINTED | NON GALV PAINTED | NON GALV PAINTED | NON GALV PAINTED | NON GALV PAINTED |
| B112 | RESTROOM | NON GALV PAINTED, EXCEPT CEMENTITIOUS ALONG RATED WALLS | NON GALV PAINTED, EXCEPT CEMENTITIOUS ALONG RATED WALLS | NON GALV PAINTED | NON GALV PAINTED | NON GALV PAINTED |
| B113 | CLEANING ROOM | NON GALV PAINTED | NON GALV PAINTED | NON GALV PAINTED | NON GALV PAINTED | NON GALV PAINTED |
| B114 | UMD BATTERY ROOM | NON GALV PAINTED, EXCEPT CEMENTITIOUS ALONG RATED WALLS | NON GALV PAINTED, EXCEPT CEMENTITIOUS ALONG RATED WALLS | NON GALV PAINTED | NON GALV PAINTED | NON GALV PAINTED |
| B115 | VALVE COOLING ROOM | NON GALV PAINTED, EXCEPT CEMENTITIOUS ALONG RATED WALLS | NON GALV PAINTED, EXCEPT CEMENTITIOUS ALONG RATED WALLS | NON GALV PAINTED | NON GALV PAINTED | NON GALV PAINTED |
| B116 | MCC ROOM | NON GALV PAINTED, EXCEPT CEMENTITIOUS ALONG RATED WALLS | NON GALV PAINTED, EXCEPT CEMENTITIOUS ALONG RATED WALLS | NON GALV PAINTED | NON GALV PAINTED | NON GALV PAINTED |
| B201 | CLEAN AGENT ROOM | NON GALV PAINTED, EXCEPT CEMENTITIOUS ALONG RATED WALLS | NON GALV PAINTED, EXCEPT CEMENTITIOUS ALONG RATED WALLS | NON GALV PAINTED | NON GALV PAINTED | NON GALV PAINTED |
| B202 | CLIMATE ROOM 1 | GALVANIZED, AND CEMENTITIOUS ALONG RATED WALLS | NON GALV PAINTED, AND CEMENTITIOUS ALONG RATED WALLS | GALVINZED | GALVANZED | GALVANIZED |
| B203 | CORRIDOR | NON GALV PAINTED, EXCEPT CEMENTITIOUS ALONG RATED WALLS | NON GALV PAINTED, EXCEPT CEMENTITIOUS ALONG RATED WALLS | NON GALV PAINTED | NON GALV PAINTED | NON GALV PAINTED |
| B204 | STORAGE ROOM | NON GALV PAINTED, EXCEPT CEMENTITIOUS ALONG RATED WALLS | NON GALV PAINTED, EXCEPT CEMENTITIOUS ALONG RATED WALLS | NON GALV PAINTED | NON GALV PAINTED | NON GALV PAINTED |
| B205 | TELECOM ROOM | NON GALV PAINTED, EXCEPT CEMENTITIOUS ALONG RATED WALLS | NON GALV PAINTED, EXCEPT CEMENTITIOUS ALONG RATED WALLS | NON GALV PAINTED | NON GALV PAINTED | NON GALV PAINTED |

ISSUED FOR PERMIT



Engineering and
Land Surveying, P.C.

SUITE 1604
New York, NY 10001




25 Mohawk Avenue
Sparta, NJ 07871


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| 0 | FINAL SUBMISSION | RAC | ZH | 12/12/2022 |
| REV | DESCRIPTION | DRW BY | CHK BY | DATE |



Kiewit
470 Chestnut Ridge Rd # 2,
Woodcliff Lake, NJ 07677



Hitachi Energy
901 Main Campus Drive
Raleigh, North Carolina 27606

PROJECT




Champlain Hudson
Power Express

Astoria HVDC
Converter Station

31-45 20th Avenue, Astoria, Queens NY 11105
Block #850 - Lot #310 - BIN #4624437

FINISH SCHEDULE



DATE12/12/22

PROJECT NO105121

DRAWING BYR. COLES

CHECKED BYZ. HARR

DRAWING NO

A-704.00

CADD FILE NO
Astoria-HVDC-CHPE
Astoria-CHA-KIE-111-ZZ-M3-A-001.rvt

| FURNITURE SCHEDULE | | | | | | | | | | |
|--------------------|-------------|-----------|-----------------------|--|---------------|---------------|----------------|--------|--------|-------------|
| FURNITURE ID | ROOM NUMBER | ROOM NAME | MANUFACTURER | MODEL | OVERALL DEPTH | OVERALL WIDTH | OVERALL HEIGHT | FINISH | FABRIC | ACCESSORIES |
| CH-2 | | | Haworth | SJT-x0-41 - Height Adjustable Arms - With Lumbar | | | | | | |
| CH-2 | | | Haworth | SJT-x0-41 - Height Adjustable Arms - With Lumbar | | | | | | |
| CH-2 | | | Haworth | SJT-x0-41 - Height Adjustable Arms - With Lumbar | | | | | | |
| CH-2 | | | Haworth | SJT-x0-41 - Height Adjustable Arms - With Lumbar | | | | | | |
| WC-2 | | | | 60" x 36" | | | | | | |
| WC-1 | | | | 96" x 36" | | | | | | |
| WC-1 | | | | 96" x 36" | | | | | | |
| WC-2 | | | | 60" x 36" | | | | | | |
| B-1 | | | | Furniture-Bench-Reed_ADA | | | | | | |
| CH-1 | | | DAUPHIN NORTH AMERICA | FI75100 | | | | | | |
| CH-1 | | | DAUPHIN NORTH AMERICA | FI75100 | | | | | | |
| CH-1 | | | DAUPHIN NORTH AMERICA | FI75100 | | | | | | |
| CH-1 | | | DAUPHIN NORTH AMERICA | FI75100 | | | | | | |
| T-1 | | | | 72" x 36" T-9 | | | | | | |
| REC-1 | | | PPP | SW2, Wastebasket | | | | | | |

| EMERGENCY EYEWASH SCHEDULE | | | | | | | |
|----------------------------|---|----------|------------------|-------------------|------------------------------|-----------------|--|
| SYMBOL | DESCRIPTION | BUILDING | BASIS OF DESIGN | FIXTURE SIZE (in) | CARRIER | MOUNTING HEIGHT | REMARKS |
| EEW-111-01 | WALL MOUNTED PORTABLE EMERGENCY EYEWASH STATION | SERVICE | HAWS: MODEL 7501 | 22"x22"x10"-DEEP | STAINLESS STEEL WALL BRACKET | | PROVIDE WITH WASTE CONTAINER MODEL 9009, HAWSCLEAN PORTABLE EYEWASH CLEANSING STICK MODEL9083, AND WATER ADDITIVE MODEL 9082 |

ISSUED FOR PERMIT

K Engineering and Land Surveying, P.C.
370 7th Avenue
SUITE 1604
New York, NY 10001

SOWINSKI SULLIVAN
ARCHITECTURE+ENGINEERING
25 Mohawk Avenue
Sparta, NJ 07871

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| 0 | FINAL SUBMISSION | RAC | ZH | 12/12/2022 |
| REV | DESCRIPTION | DRW BY | CHK BY | DATE |

**Kiewit**
470 Chestnut Ridge Rd # 2,
Woodcliff Lake, NJ 07677


**Hitachi Energy**
901 Main Campus Drive
Raleigh, North Carolina 27606

PROJECT

**CHPE**
Champlain Hudson
Power Express

Astoria HVDC Converter Station
31-45 20th Avenue, Astoria, Queens NY 11105
Block #850 - Lot #310 - BIN #4624437

FURNITURE SCHEDULE



DATE12/12/22

PROJECT NO105121







DRAWING BYR. COLES

CHECKED BYZ. HARR


DRAWING NO

A-706.00

CADD FILE NO
AstoriaHVDC-CHPE
AstoriaCHV-KIE-111-ZZ-M3-A-001.rvt

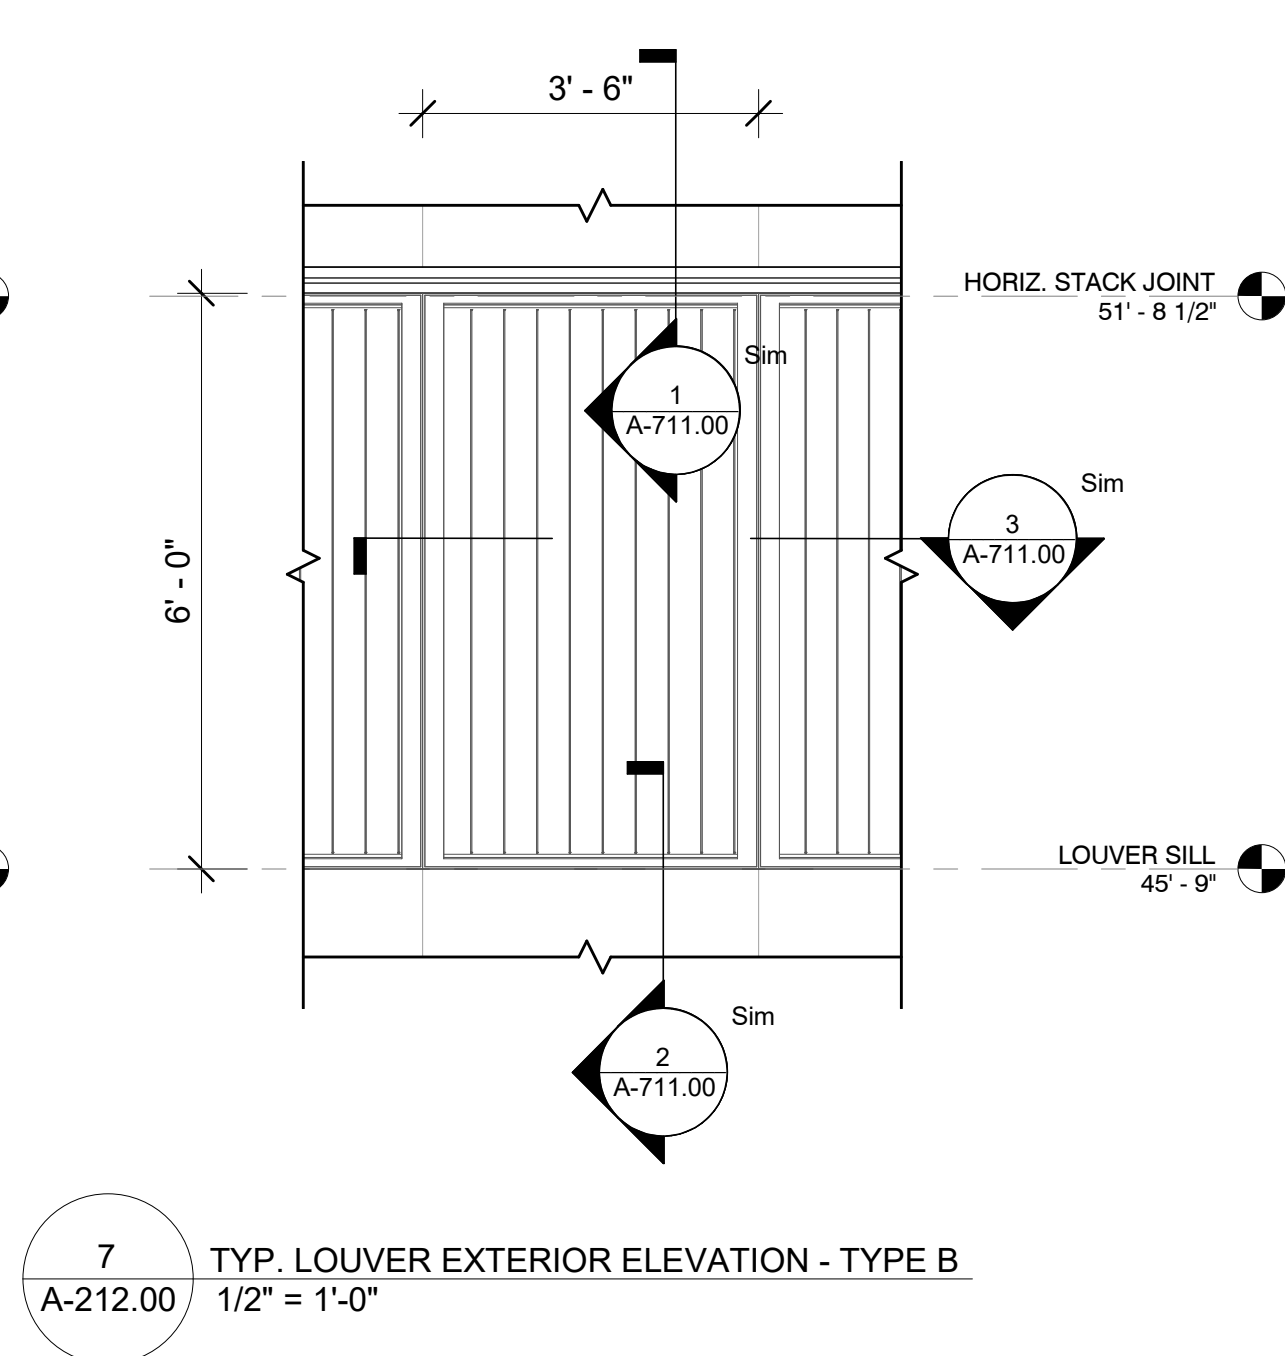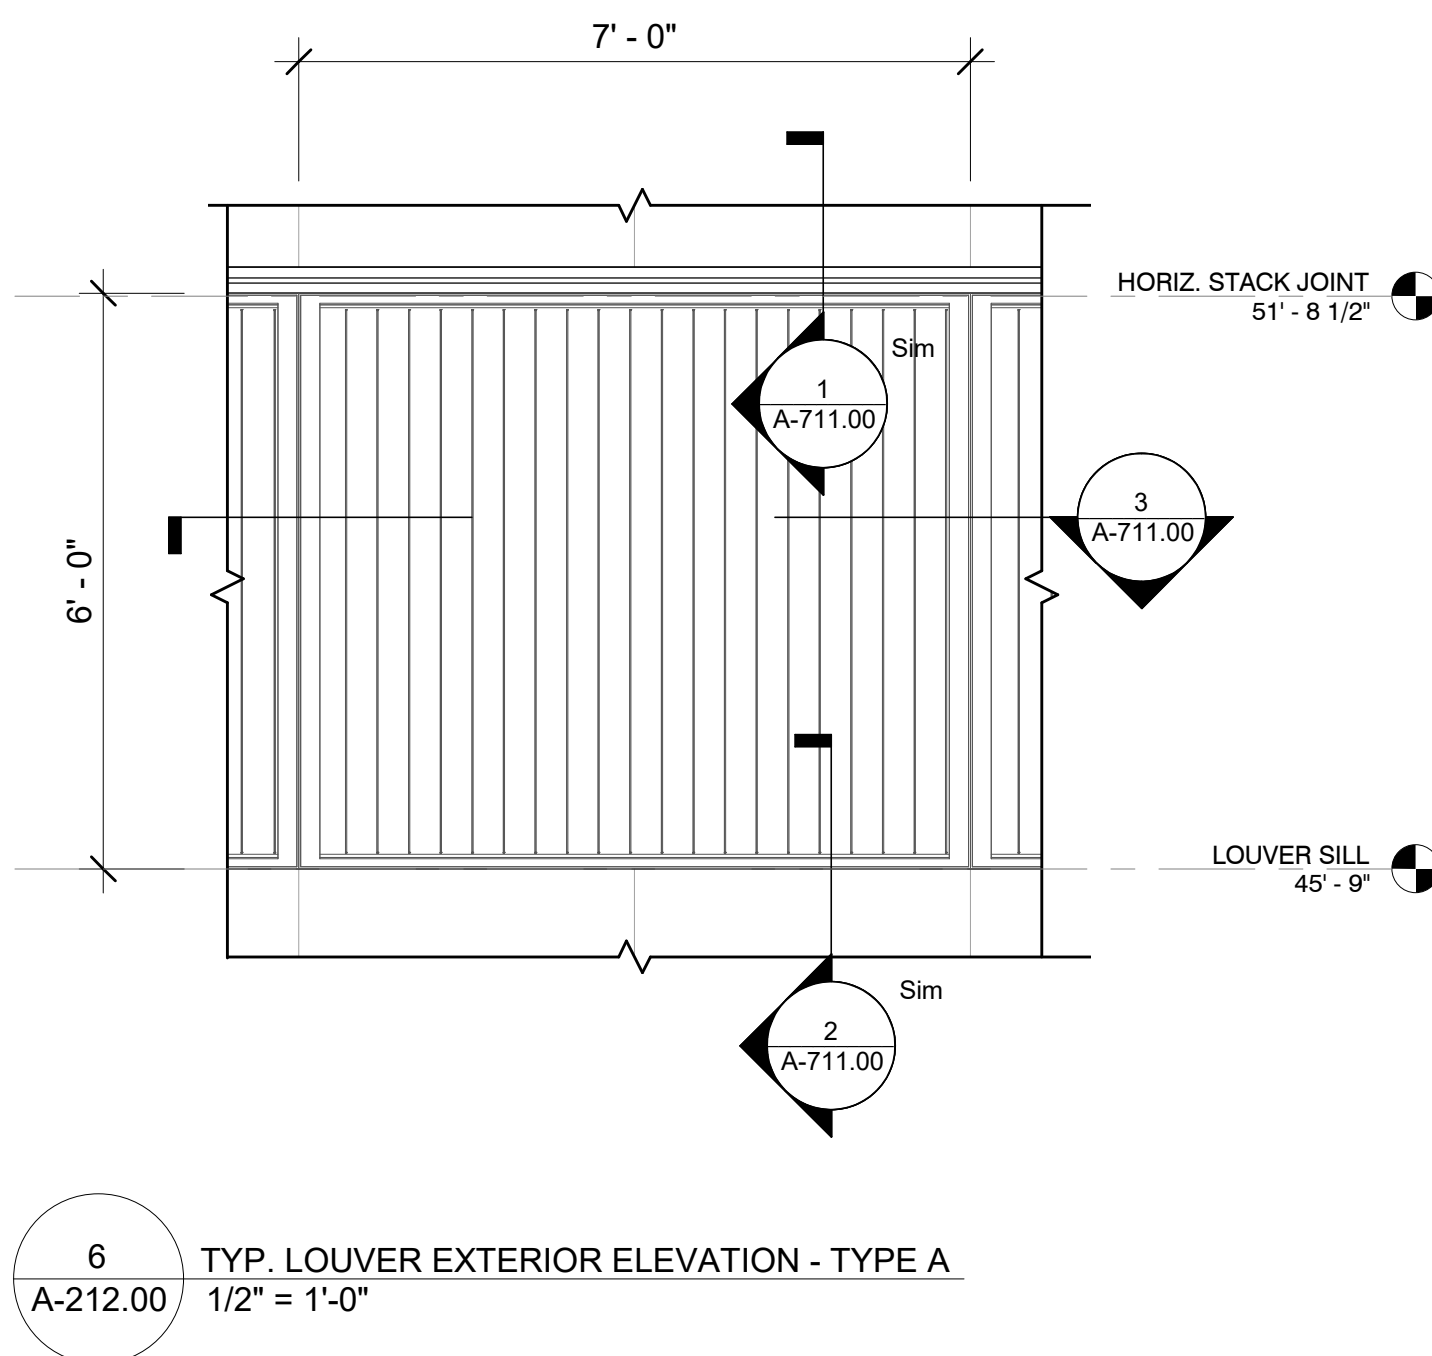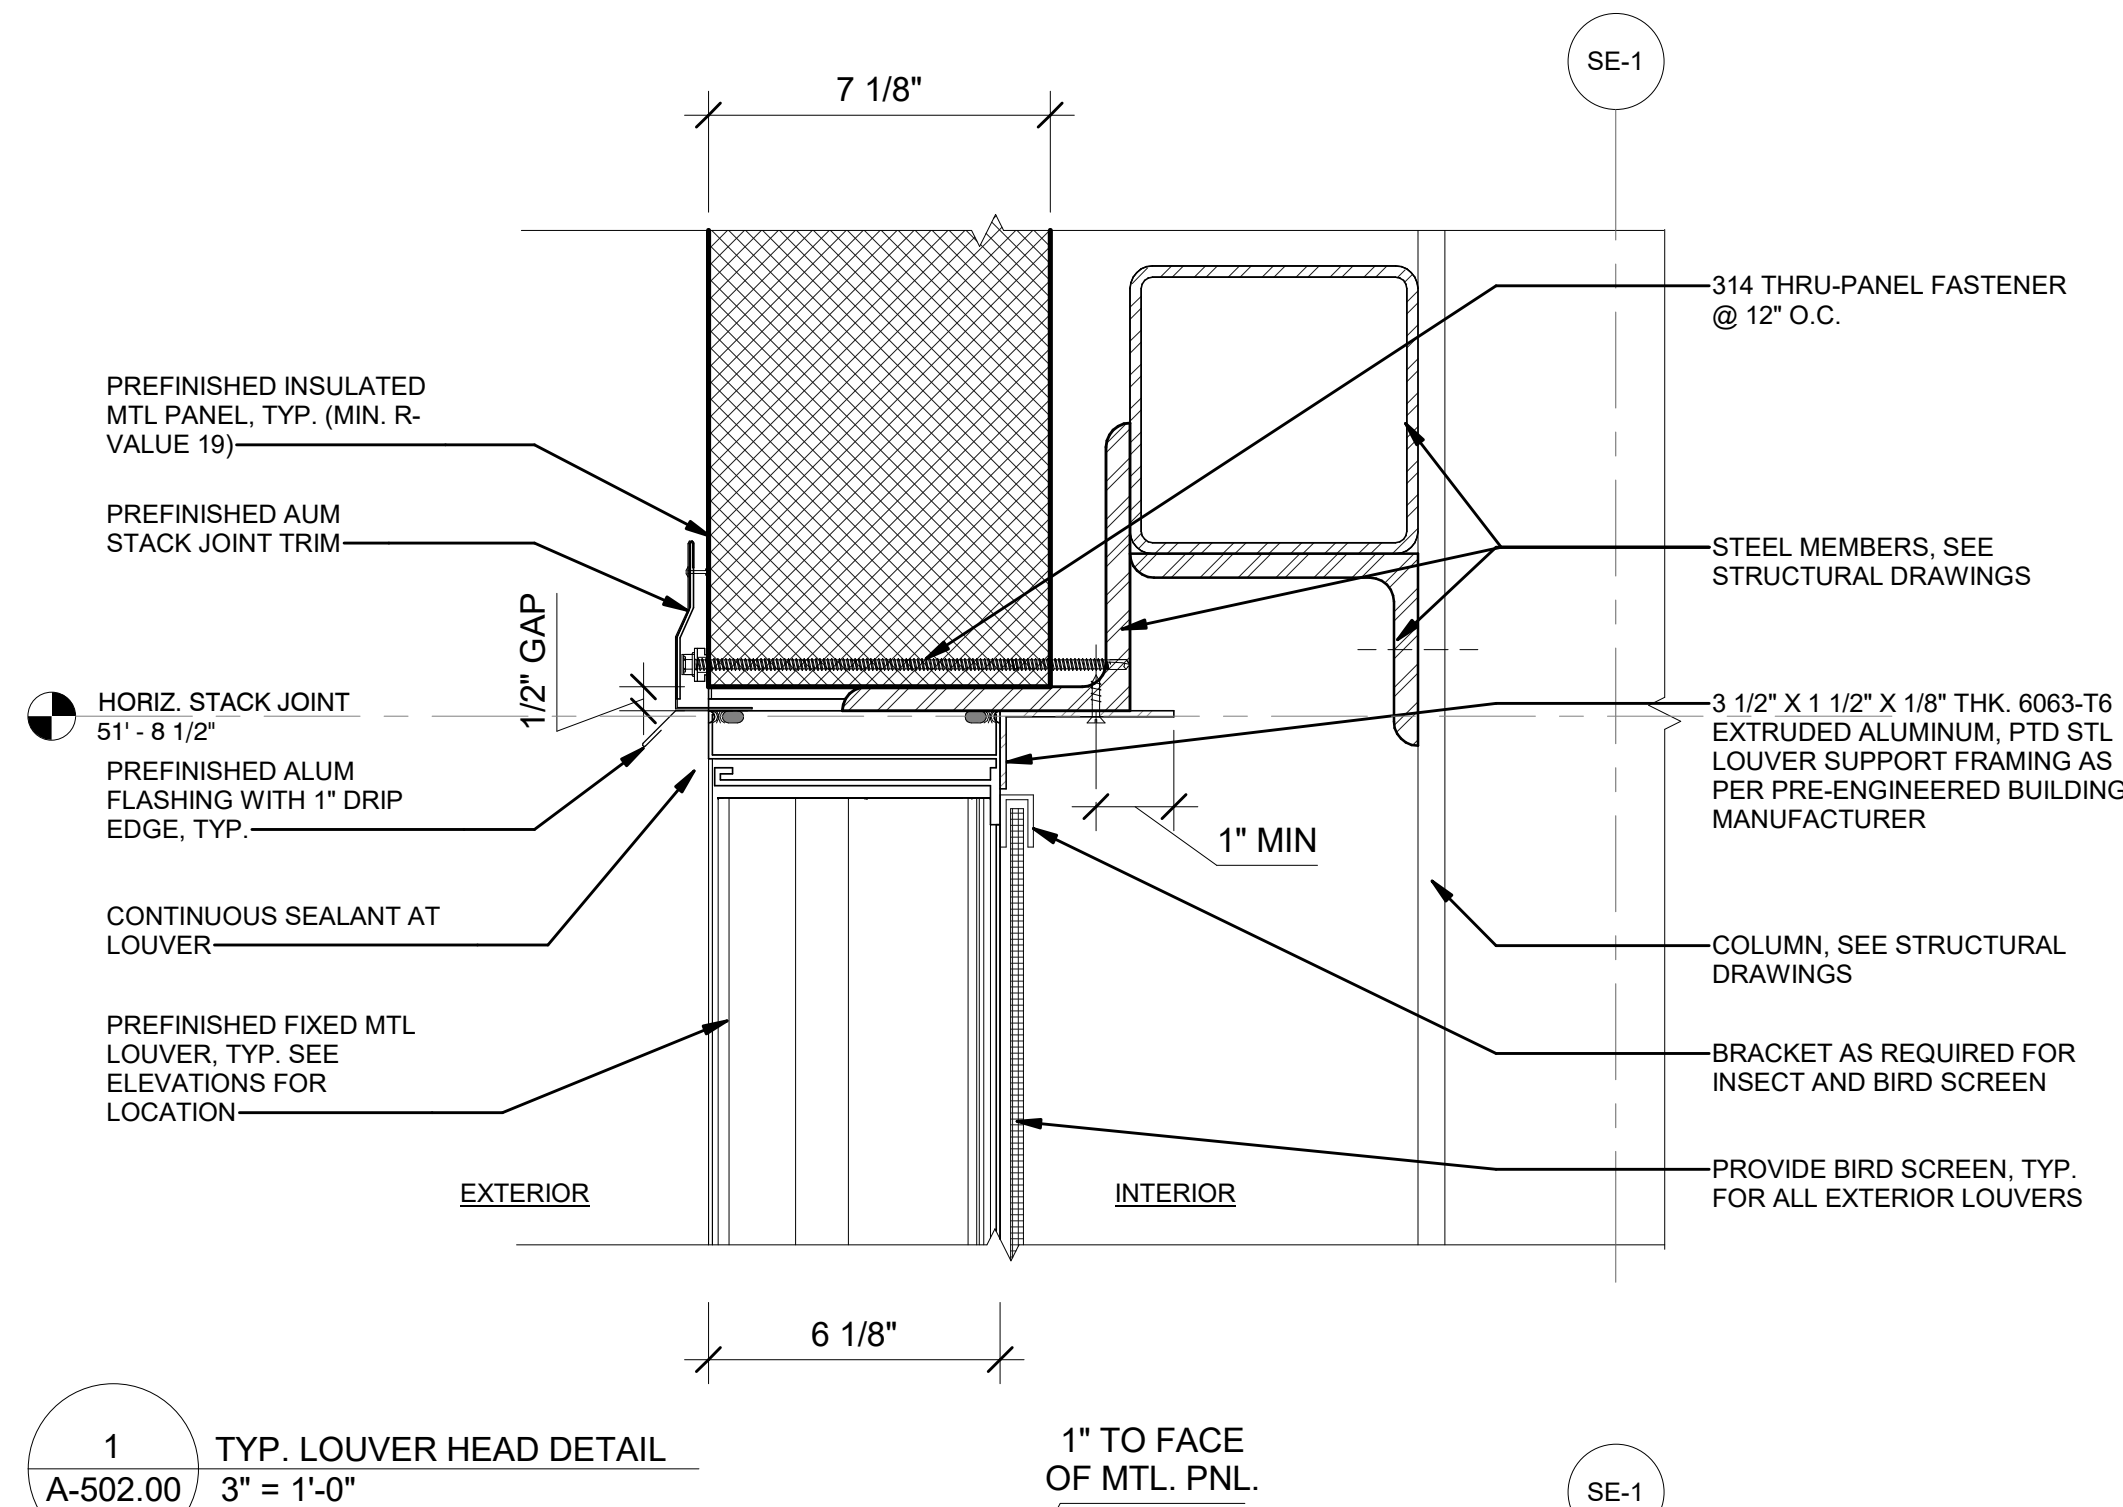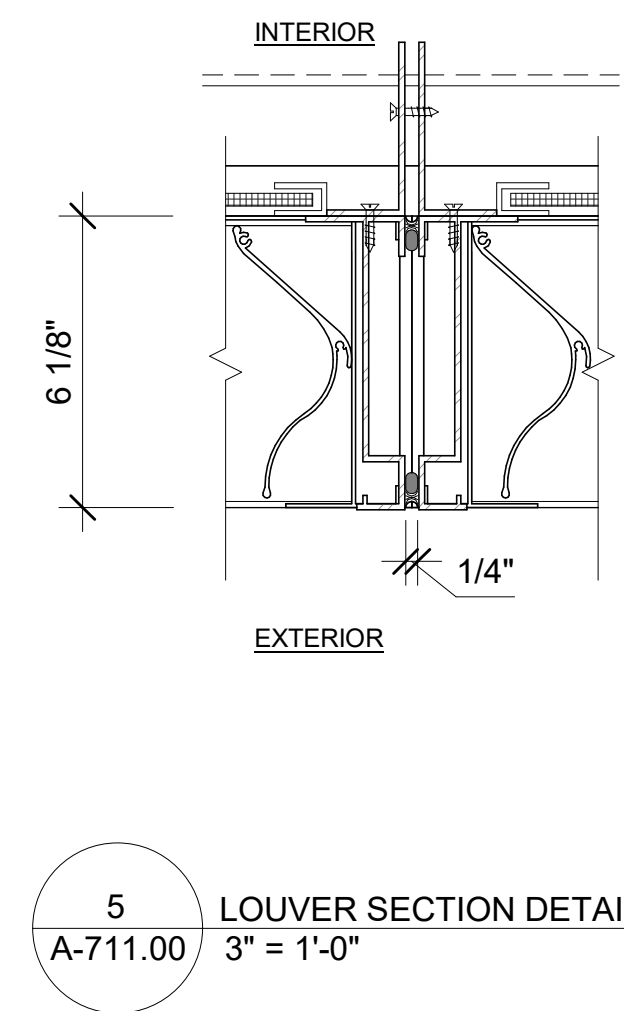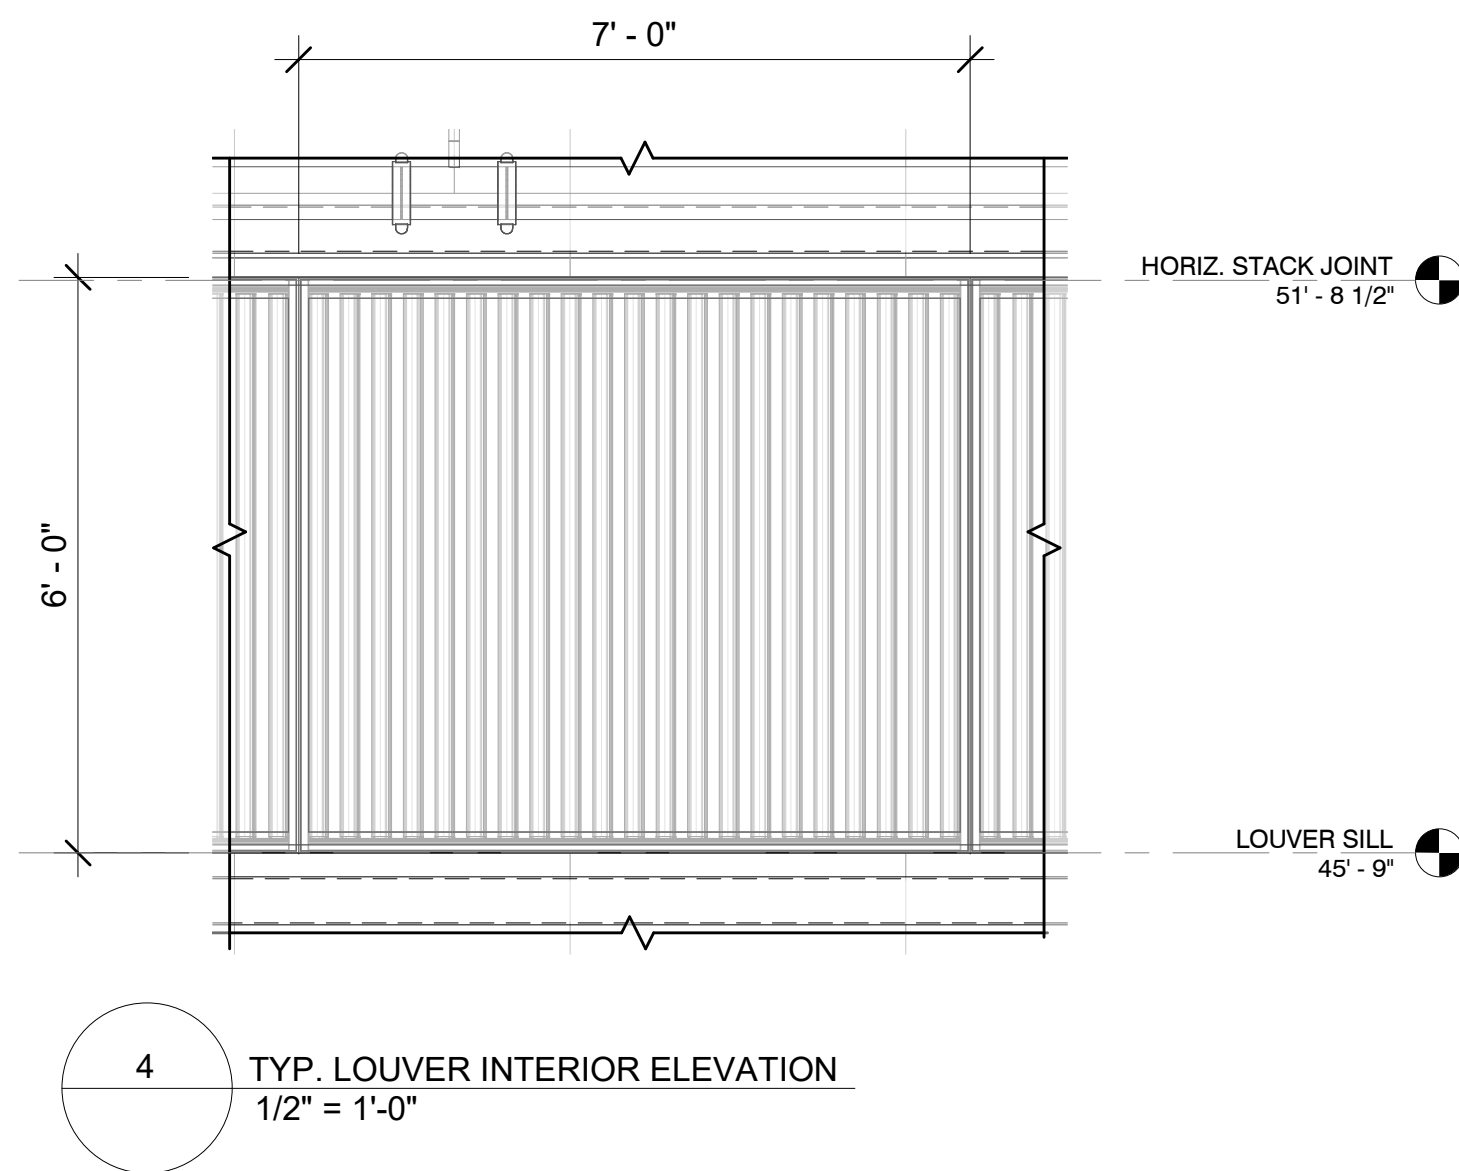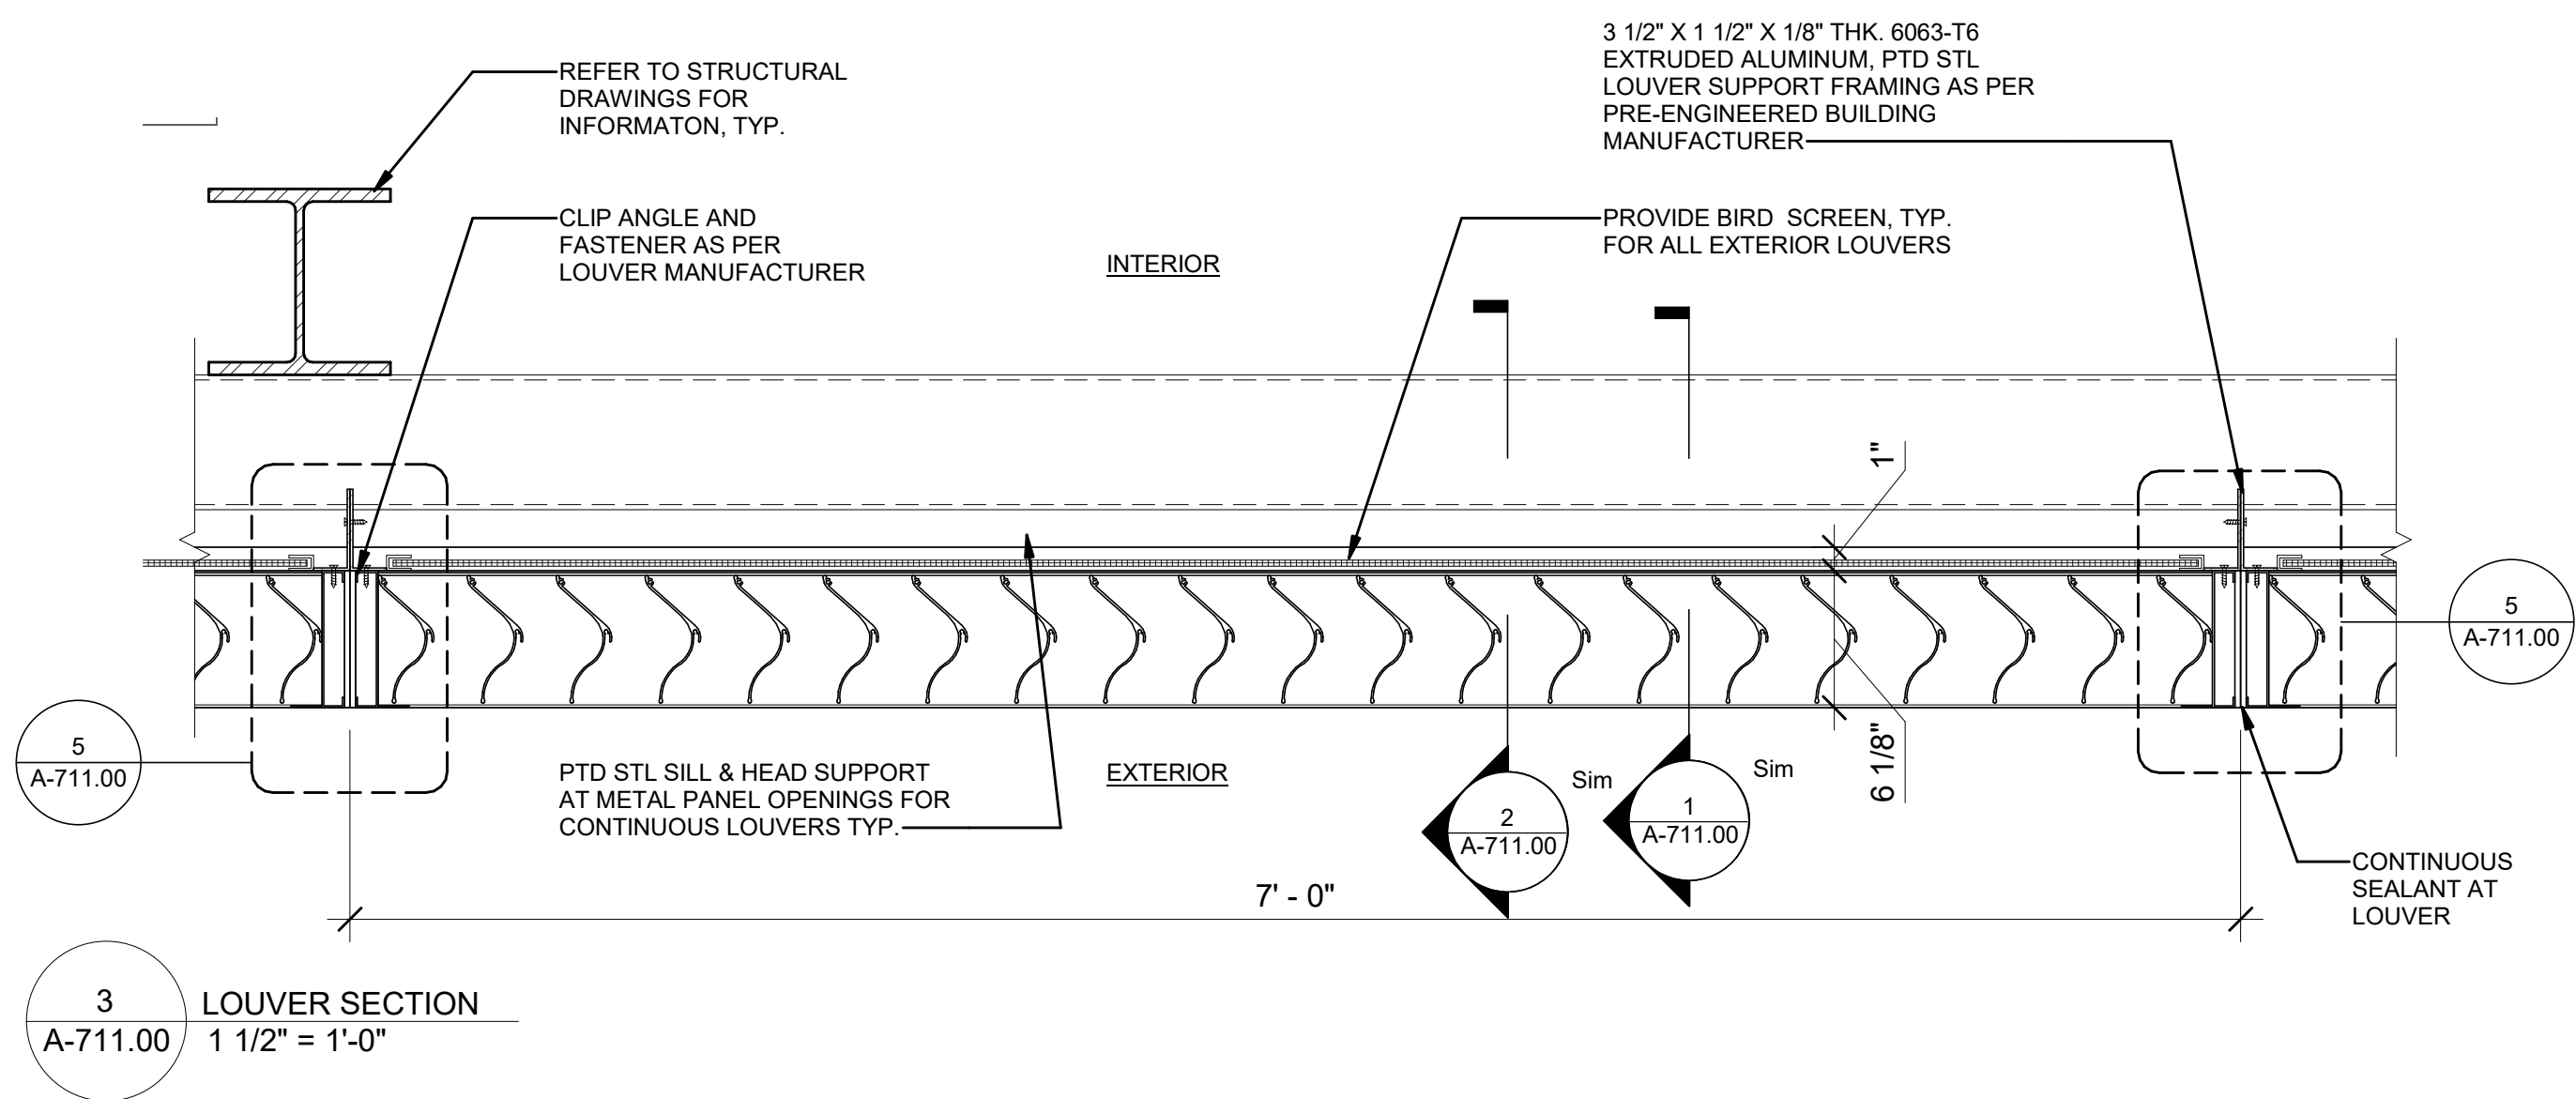

| LOUVER SCHEDULE | | | | | | |
|-----------------|---------|-------------|------------|------------|----------|-------------------------------------|
| TYPE | HEIGHT | WIDTH | HEAD/SILL | JAMB | QUANTITY | EQUIPMENT TAG, SEE MECHANICAL DWGS |
| L-1 | 6' - 0" | 7' - 0" | 1/A-711.00 | 2/A-711.00 | 16 | (16) L-1 + (10) L-2 = LVR-111-01 |
| L-2 | 6' - 0" | 3' - 6" | 1/A-711.00 | 2/A-711.00 | 22 | (6) = LVR-111-02, (6) = LVR-111-03, |
| L-3 | 10'-0" | 4' - 3" | 1/A-711.00 | 2/A-711.00 | 4 | (4) = LVR-081-03 |
| L-4 | 6' - 6" | 4' - 4 1/2" | 1/A-711.00 | 2/A-711.00 | 8 | (4) = LVR-081-01 & (4) = LVR-081-02 |
| L-5 | 6' - 0" | 7' - 0" | 1/A-711.00 | 2/A-711.00 | 1 | |
| L-6 | 12'-0" | 4' - 3" | 1/A-711.00 | 2/A-711.00 | 4 | (4) = LVR-081-04 |
| L-10 | 2' - 0" | 2' - 6" | 3/A-507.00 | 4/A-507.00 | 2 | LVR-130-01 + LVR-130-02 |
| L-11 | 2' - 6" | 2' - 6" | 2/A-507.00 | 2/A-507.00 | 1 | LVR-130-03 |

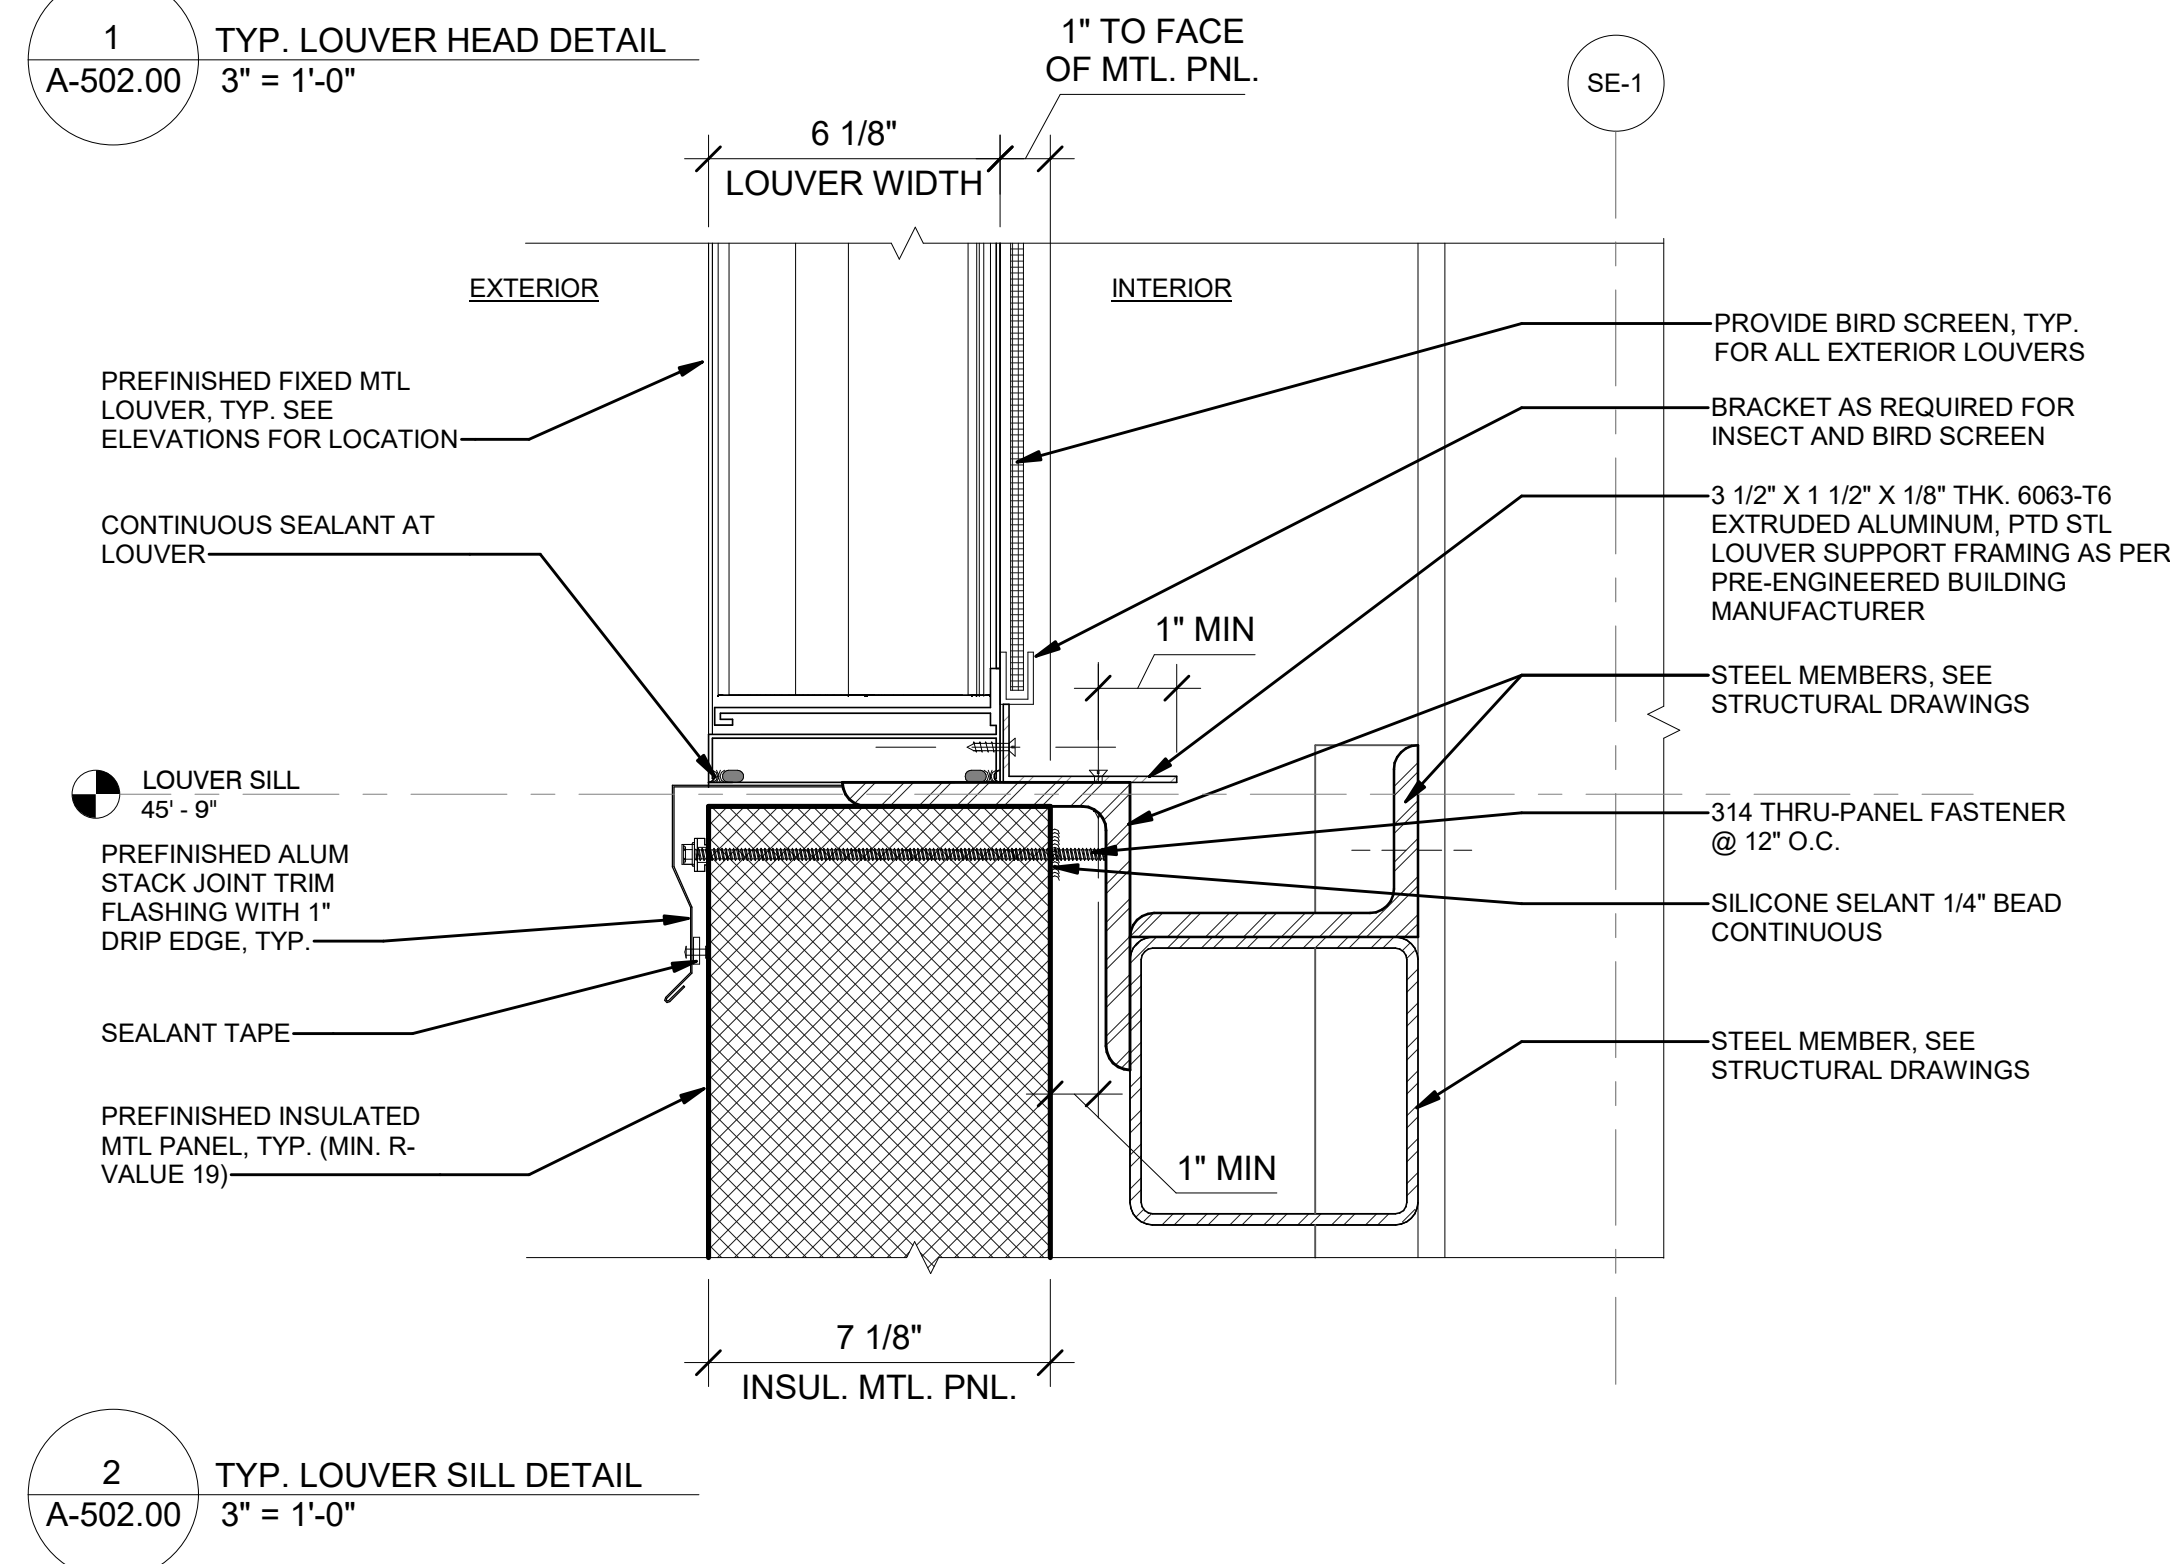

ISSUED FOR PERMIT

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| 0 | FINAL SUBMISSION | RAC | ZH | 12/12/2022 |
|-----|------------------|--------|--------|------------|
| REV | DESCRIPTION | DRW BY | CHK BY | DATE |

Kiewit

470 Chestnut Ridge Rd # 2,
Woodcliff Lake, NJ 07677

Hitachi Energy

901 Main Campus Drive
Raleigh, North Carolina 27606

PROJECT

CHPE

Champlain Hudson
Power Express

Astoria HVDC Converter Station

31-45 20th Avenue, Astoria, Queens NY 11105
Block #850 - Lot #310 - BIN #4624437

LOUVER SCHEDULE AND DETAILS

REGISTERED ARCHITECT
SUZANNE SOWINSKI
STATE OF NEW YORK
026049

DATE 12/12/22
PROJECT NO 105121
DRAWING BY R. COLES
CHECKED BY Z. HARR
DRAWING NO
A-711.00
CADD FILE NO
Astoria CHA-KIE-111-ZZ-M3-A-001.rvt