APPENDIX C.5 CASE 10-T-0139 SITE PLANS AND CONSTRUCTION DRAWINGS SITE PLAN - UTILITIES ASTORIA HVDC CONVERTER STATION SEGMENT 22



ASTORIA HVDC CONVERTER STATION

SITE UTILITIES PACKAGE

SCOPE OF WORK

THE SITE UTILITIES SCOPE OF WORK INCLUDES THE FOLLOWING:


1. SITE DRAINAGE

FLOOD ZONE DESIGN CERTIFICATION:

THE EXISTING PROPERTY IS IN THE SPECIAL FLOOD HAZARD AREA (SFHA), ZONE AE PER EFFECTIVE 2015 FLOOD INSURANCE RATE MAP(FIRM). THIS IS TO CONFIRM THAT THE PROPOSED INSTALLATION IS IN COMPLIANCE WITH THE REQUIREMENTS SET FORTH IN APPENDIX Q OF THE NYC BUILDING CODE.


NYC ENERGY CODE COMPLIANCE:

STATEMENT: TO THE BEST OF MY KNOWLEDGE, BELIEF AND PROFESSIONAL JUDGEMENT, THESE PLANS AND SPECIFICATIONS ARE IN COMPLIANCE WITH THE NEW YORK CITY ENERGY CONSERVATION CODE. PROPOSED WORK MEETS THE GUIDELINES AND INSTRUCTIONS OUTLINED IN THE 2020 NYC ECC CHAPTER 4.

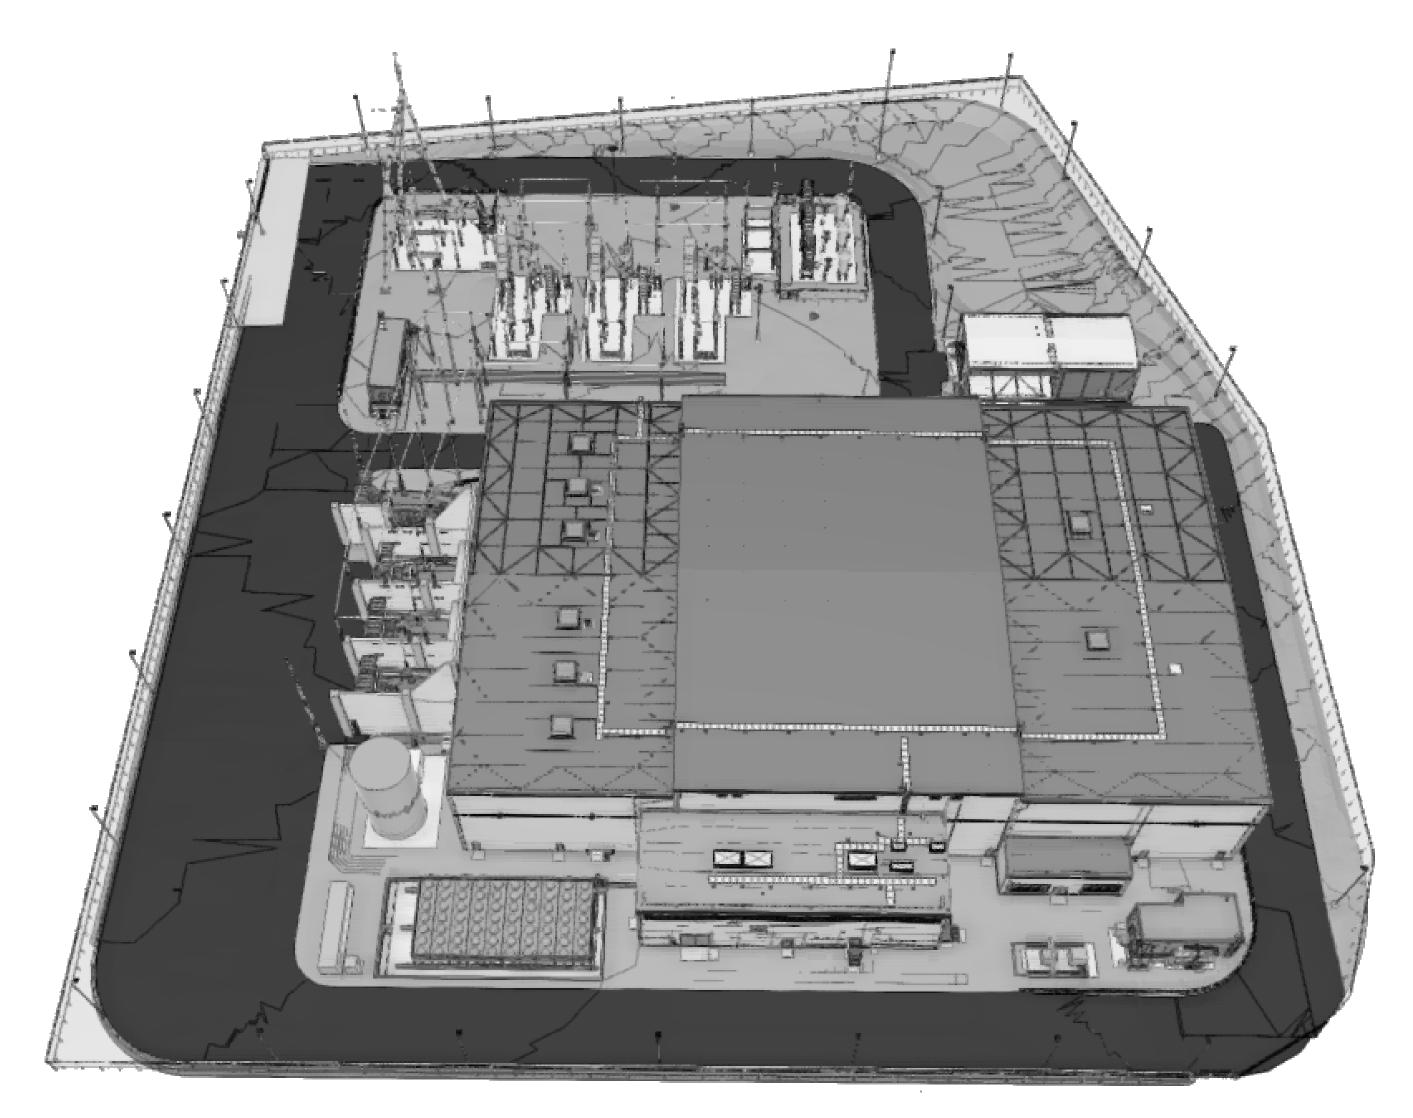



ISSUED FOR PERMIT

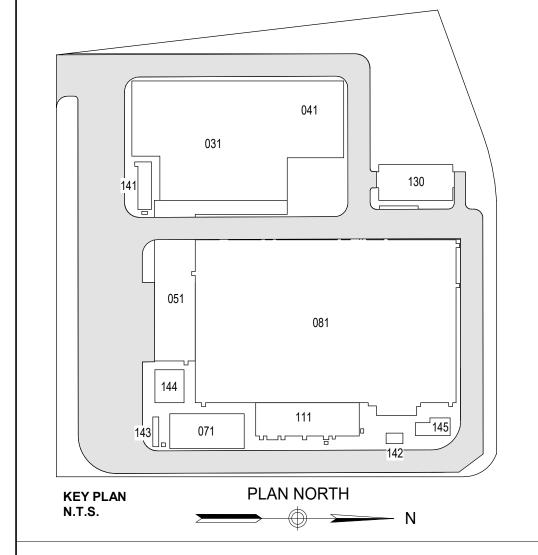



370 7th Avenue SUITE 1604 New York, NY 10001



25 Mohawk Avenue Sparta, NJ 07871

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	В	FINAL SUBMISSION	VSP	EK	11/08/2022
	Α	INTERIM SUBMISSION	VSP	EK	09/13/2022
ſ	RFV	DESCRIPTION	DRW BY	CHK BY	DATE



Hitachi Energy
 901 Main Campus Drive
 Raleigh, North Carolina 27606


PROJECT



Astoria HVDC Converter Station

31-45 20th Avenue, Astoria, Queens NY 11105 Block #850 - Lot #310 - BIN #4624437

COVER SHEET

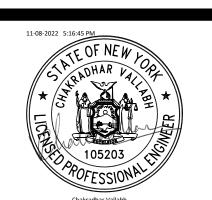

DATE	11/08/2022
PROJECT NO	105121
DRAWING BY	V. PATEL
CHECKED BY	E. KIDANE
DRAWING NO	

T-001.00

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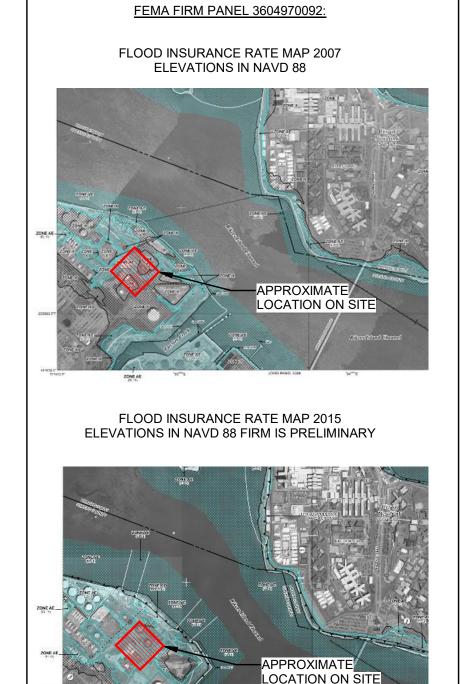
GENERAL NOTES:

- 1. THE PLANS SHOW SUBSURFACE STRUCTURES, ABOVE GROUND STRUCTURES, AND/OR UTILITIES FROM FIELD LOCATION AND RECORD MAPPING, EXACT LOCATION OF WHICH MAY VARY FROM THE LOCATIONS INDICATED. IN PARTICULAR, THE CONTRACTOR IS WARNED THAT THE EXACT OR EVEN APPROXIMATE LOCATION OF SUCH PIPELINES, SUBSURFACE STRUCTURES, AND/OR UTILITIES IN THE AREA MAY BE DIFFERENT FROM THAT SHOWN OR MAY NOT BE SHOWN, AND IT SHALL BE HIS RESPONSIBILITY TO PROCEED WITH GREAT CARE IN EXECUTING ANY WORK. 48 HOURS BEFORE YOU DIG, DRILL, OR BLAST, CALL UNDERGROUND FACILITIES PROTECTION ORGANIZATION (UFPO) 1-(800)-962-7962 TOLL FREE.
- 2. THE ENGINEER SHALL BE NOTIFIED IN WRITING OF ANY CONDITIONS THAT VARY FROM THOSE SHOWN ON THE PLANS. THE CONTRACTOR'S WORK SHALL NOT VARY FROM THE PLANS WITHOUT THE PRIOR APPROVAL OF THE ENGINEER.
- 3. THE CONTRACTOR SHALL PROTECT AND PRESERVE ALL PUBLIC AND PRIVATE PROPERTY, INCLUDING ALL EXISTING VEGETATION, EXISTING LANDSCAPE FEATURES, AND MONUMENTS WITHIN, ALONG, AND ADJACENT TO THE PROPERTY. ALL AREAS DISTURBED BY THE CONTRACTOR SHALL BE RESTORED TO A PLEASING AND ACCEPTABLE CONDITION.
- 4. THE CONTRACTOR SHALL BE RESPONSIBLE FOR OBTAINING AND INCURRING THE COST OF ALL REQUIRED PERMITS, INSPECTIONS, CERTIFICATES, ETC. AND SHALL COMPLY WITH ALL REQUIRED PERMITS.
- 5. ALL WORK SHALL BE DONE IN STRICT COMPLIANCE WITH ALL APPLICABLE NATIONAL, STATE, AND LOCAL CODES, STANDARDS, ORDINANCES, RULES, AND
- 6. ALL PROPOSED UTILITIES AND APPURTENANCES SHALL BE CONSTRUCTED IN COMPLIANCE WITH THE LOCAL MUNICIPALITIES' CODES AND REGULATIONS GOVERNING THE INSTALLATION OF SUCH UTILITIES.
- 7. THE ENGINEER RESERVES THE RIGHT TO EXAMINE ANY WORK DONE ON THIS PROJECT AT ANY TIME TO DETERMINE THE CONFORMANCE WITH THE REQUIREMENTS OF THE CONTRACT DOCUMENTS OF THIS PROJECT.
- 8. THE CONTRACTOR SHALL PROTECT EXISTING PROPERTY LINE MONUMENTATION. ANY MONUMENTATION DISTURBED OR DESTROYED, AS JUDGED BY THE ENGINEER OR OWNER, SHALL BE REPLACED AT THE CONTRACTOR'S EXPENSE UNDER THE SUPERVISION OF A NEW YORK STATE LICENSED LAND SURVEYOR.
- 9. IT IS THE CONTRACTOR'S RESPONSIBILITY TO EXAMINE ALL PLAN SHEETS AND COORDINATE WORK WITH ALL OTHER CONTRACTS FOR THE SITE.
- 10. THE CONTRACTOR SHALL:
 - 10.A. VERIFY ALL CONDITIONS IN THE FIELD PRIOR TO COMMENCEMENT OF WORK AND NOTIFY THE ENGINEER OF ANY DISCREPANCIES.
 - 10.B. EXAMINE THE SITE AND INCLUDE IN HIS WORK THE EFFECT OF ALL EXISTING CONDITIONS ON THE WORK.
 - 10.C. PROVIDE AND INSTALL ALL MATERIALS AND PERFORM ALL WORK IN ACCORDANCE WITH GOOD STANDARD PRACTICE.
- 11. ALL TRENCH EXCAVATION AND ANY REQUIRED SHEETING AND SHORING SHALL BE DONE IN ACCORDANCE WITH THE LATEST REVISIONS OF NEW YORK CITY BUILDING CODE CHAPTER 33 AND OSHA REGULATIONS FOR CONSTRUCTION. SHEET PILING SHALL BE DESIGNED AND SEALED BY A NEW YORK STATE LICENSED PROFESSIONAL ENGINEER.
- 12. CONTRACTOR SHALL BE RESPONSIBLE FOR ROUTINE DEWATERING RELATED TO THE MAINTENANCE OF SURFACE DRAINAGE DURING THE COURSE OF WORK. CONTRACTOR SHALL MAINTAIN EXISTING SITE DRAINAGE PATTERNS THROUGHOUT CONSTRUCTION UNLESS OTHERWISE SHOWN ON THE PLANS. DEWATERING FOR MAJOR CONSTRUCTION ITEMS IS NOT THE RESPONSIBILITY OF THE CONTRACTOR AND SHALL BE PERFORMED BY TDI.
- 13. CONTRACTOR SHALL NOT DISRUPT SERVICE TO ANY UTILITIES WITHOUT PRIOR COORDINATION WITH UTILITY OWNER.
- 14. ALL FRAMES/COVERS WITHIN PAVED AREAS SHALL HAVE THE TOPS SET FLUSH WITH THE FINAL PAVEMENT GRADE. IN LANDSCAPED AREAS, ALL FRAMES SHALL BE 0.1' ABOVE GRADE.
- 15. THE CONTRACTOR SHALL BE RESPONSIBLE FOR PROVIDING ALL FIELD LAYOUT. THE CONTRACTOR SHALL PROVIDE MARKED-UP AS-BUILT PLANS FOR ALL UTILITIES SHOWING TIE-IN AND CONNECTIONS, BENDS, VALVES, LENGTHS OF LINES, AND INVERTS. AS-BUILT PLANS FOR ALL UTILITIES SHOWING TIES TO CONNECTIONS, BENDS, VALVES, LENGTHS OF LINES, AND INVERTS. AS-BUILT PLANS SHOWING ALL UNDERGROUND UTILITIES INSTALLED OR ENCOUNTERED SHALL BE SUBMITTED TO THE OWNER AND HIS REPRESENTATIVES.
- 16. CONTRACTOR SHALL MAINTAIN ALL TRAFFIC IN ALL AREAS (INCLUDING THE ADJACENT ROADWAYS TO THE SITE AND CONSTRUCTION VEHICLE ENTRANCE AND EXIT TO THE SITE) AS PER COORDINATION WITH ADJACENT PROPERTY OWNERS.
- 17. ALL EXCAVATIONS SHALL BE PROTECTED AT THE END OF EACH WORK DAY.
- 18. CONTRACTOR SHALL TAKE CARE TO PREVENT DAMAGE TO EXISTING UTILITIES. DAMAGED UTILITIES SHALL BE IMMEDIATELY REPAIRED BY THE CONTRACTOR AT THE CONTRACTOR'S EXPENSE. IF DURING EXCAVATION PREVIOUSLY DAMAGED UTILITIES ARE UNCOVERED, CONTRACTOR SHALL DOCUMENT THE DAMAGE AND REPORT DAMAGE TO THE APPROPRIATE OWNER.
- 19. THE CONTRACTOR MUST COORDINATE HIS SCHEDULE OF OPERATIONS WITH THE VARIOUS UTILITY OWNERS INVOLVED WITH THE PROJECT AND SHALL VERIFY UTILITY INFORMATION FOUND IN THE CONTRACT DOCUMENTS.
- 20. PRIOR TO THE COMMENCEMENT OF CONSTRUCTION, TDI SHALL COORDINATE WITH ALL THE KNOWN PUBLIC AND PRIVATE UTILITY COMPANIES THAT MAY HAVE POTENTIAL IMPACT TO OVERHEAD AND UNDERGROUND UTILITIES FROM THE CONTRACTORS WORK. THE CONTRACTOR SHALL, AT THIS MEETING, INFORM THE UTILITY COMPANIES OF HIS SCHEDULE OF OPERATIONS SO THAT UTILITY COMPANIES PLAN AND SCHEDULE THEIR ACTIVITIES ACCORDINGLY.
- 21. THE CONTRACTOR IS GOVERNED BY AND MUST ADHERE TO THE PROVISIONS OF THE 16 NYCRR PART 753, "PROTECTION OF UNDERGROUND FACILITIES." AND ALL ITS AMENDMENTS.: I.E. CALL 811 DIG SAFE PRIOR TO BREAKING GROUND.
- 22. THE CONTRACTOR SHALL CONDUCT ALL OPERATIONS IN ACCORDANCE WITH ALL OSHA RULES AND REGULATIONS AND IN ACCORDANCE WITH NEW YORK STATE LABOR LAW, SECTION 202-H, "THE HIGH VOLTAGE PROXIMITY ACT."
- 23. REFER TO FLOOD INSURANCE RATE MAP (FIRM) NUMBER 3604970092G FOR THE PROJECT SITE. THE SPECIAL FLOOD HAZARD AREA TYPE IS ZONE AE AND X. BASE FLOOD ELEVATION IS 13' AND DESIGN FLOOD ELEVATION IS 15'.
- 24. EXISTING IMPERVIOUS SURFACE AREA WITHIN THE PROPERTY LIMITS TOTALS 4.36 ACRES, WHILE PROPOSED IMPERVIOUS SURFACE AREA TOTALS 7.77 ACRES.

FL FLOOD

- FL-1. THE SITE IS DEFINED AS A ZONE (NON-COASTAL).
- FL-2. BASE FLOOD ELEVATION, BFE, = 13 FEET NAVD 88.
- FL-3. RECOMMENDED FREE BOARD BY THE 2022 NYCBC-APPENDIX G IS 2.0 FEET.
- FL-4. RECOMMENDED DESIGN FLOOD ELEVATION, DFE = 15 FEET NAVD 88.
- FL-5. THE STRUCTURE IS NOT SUBJECTED TO HYDRODYNAMIC LOADS.

DESIGN ELEVATION / DEPTH	FEET IN NAVD 88
DESIGN BASE FLOOD ELEVATION	13.0
FINISH FLOOR ELEVATION	15.0
SEA LEVEL RISE	NOT CONSIDERED



SITE UTILITIES SHEET INDEX		
DRAWING TITLE	DWG. NO.	
GENERAL NOTES	C-001.00	
LEGEND AND ABBREVIATIONS	C-002.00	
UTILITY NOTES	C-200.00	
OVERALL UTILITY PLAN	C-201.00	
UTILITY SECTION	C-202.00	
UTILITY PROFILE - 1	C-203.00	
UTILITY PROFILE - 2	C-204.00	
UTILITY PROFILE - 3	C-205.00	
UTILITY PROFILE - 4	C-206.00	
UTILITY PROFILE - 5	C-207.00	
UTILITY PROFILE - 6	C-208.00	
UTILITY PROFILE - 7	C-209.00	
UTILITY PROFILE - 8	C-210.00	
UTILITY PROFILE - 9	C-211.00	
UTILITY DETAILS - 1 WATER MAIN MANHOLE FRAME AND COVER	C-212.00	
UTILITY DETAILS - 2 WATER MAIN VALVE DETAILS	C-213.00	
UTILITY DETAILS - 3 FIRE HYDRANT DETAILS	C-214.00	
UTILITY DETAILS - 4 FIRE HYDRANT DETAILS	C-215.00	
UTILITY DETAILS - 5 PIPE INSTALLATION DETAILS	C-216.00	
UTILITY DETAILS - 6 SANITARY SEWER DETAILS	C-217.00	
UTILITY DETAILS - 7 GROUNDING DETAILS	C-218.00	
UTILITY DETAILS - 8 GROUNDING DETAILS AND DUCT BANK DETAILS	C-219.00	
UTILITY DETAILS - 9 DUCT BANK DETAILS	C-220.00	
MVS BUILDING CONDUIT LAYOUT	C-221.00	

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370 7th Avenue **SUITE 1604** New York, NY 10001



25 Mohawk Avenue Sparta, NJ 07871

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В	FINAL SUBMISSION	AB	JL	11/8/22
Α	INTERIM SUBMISSION	NS	JL	8/29/22
RFV	DESCRIPTION	DRW BY	CHK BY	DATE



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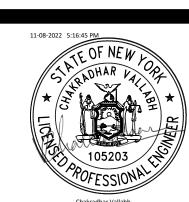
PROJECT



Astoria HVDC Converter Station

31-45 20th Avenue, Astoria, Queens NY 11105 Block #850 - Lot #310 - BIN #4624437

GENERAL NOTES



DATE	NOVEMBER 8, 2022			
PROJECT NO	105121			
DRAWING BY	A.BUDARAPU			
CHECKED BY	J.LLORENTE			
DRAWING NO				
C-001.00				

2 of 25

LIST OF SPECIFICATIONS:

22 - PLUMBING 220517 SLEEVES AND SLEEVE SEALS FOR PLUMBING

31 - EARTHWORK 310001 GENERAL PROVISIONS WATER UTILITIES 33 - UTILITIES 331000 SANITARY SEWERAGE 33 - UTILITIES 333000

PACKAGED SEWERAGE LIFT STATION, WET WELL TYPE 33 - UTILITIES

33 - UTILITIES CONCRETE TRENCHWAYS

LIST OF SPECIAL INSPECTIONS:


INSPECTION AND TEST	CODE/SECTION
CONCRETE - CAST-IN PLACE AND	BC 1704.4

PRECAST SUBGRADE INSPECTION

AND BRACING

BC 1704.7.1 **EXCAVATIONS** -BC 1704.20.2 SHEETING, SHORING

LEGENDS & SYMBOLS

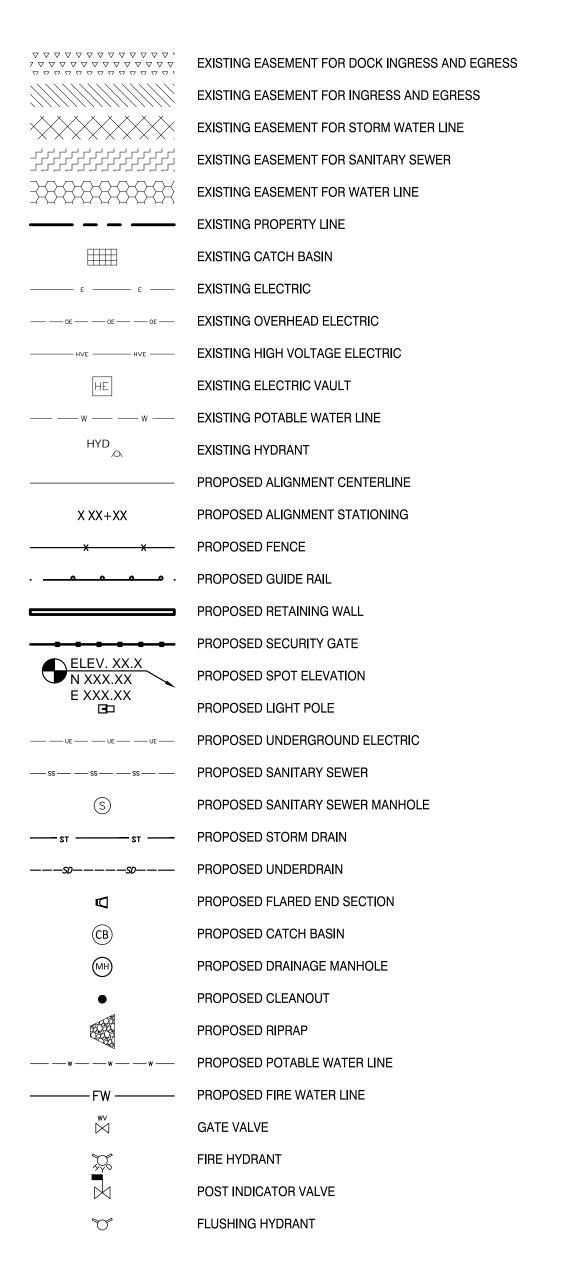

ABBREVIATIONS

HVAC = HEATING, VENTILATION AND AIR CONDITIONING

HVE = HIGH VOLTAGE ELECTRIC

LVC = LENGTH OF VERTICAL CURVE

MTS = MANUAL TRANSFER SWITCH

MVS = MEDIUM VOLTAGE SWITCHGEAR

MPT = MAINTENANCE AND PROTECTION OF TRAFFIC

NYCDOT = NEW YORK CITY DEPARTMENT OF TRANSPORTATION

NYCRR = NEW YORK CITY CODES, RULES AND REGULATIONS

NYSDOT = NEW YORK STATE DEPARTMENT OF TRANSPORTATION

NYCDEP = NEW YORK CITY DEPARTMENT OF ENVIRONMENTAL PROTECTION

ID = INNER DIAMETER

IPS = IRON PIPE SIZE

LBS = POUNDS

LF = LINEAR FEET

MAX = MAXIMUM

MH = MANHOLE

MIN = MINIMUM

N/A = NOT APPLICABLE

NTS = NOT TO SCALE

NYC = NEW YORK CITY

AASHTO = AMERICAN ASSOCIATION OF STATE HIGHWAY AND TRANSPORTATION OFFICIALS OC = ON CENTER AC = ALTERNATING CURRENT OD = OUTER DIAMETER AD = TANGENT OFFSET AT PVI OSHA = OCCUPATIONAL SAFETY AND HEALTH ADMINISTRATION APPROX = APPROXIMATEPCC = PORTLAND CEMENT CONCRETE PCD = PRECAST CONCRETE DUCTS ASCE = AMERICAN SOCIETY OF CIVIL ENGINEERS ASTM = AMERICAN SOCIETY OF TESTING AND MATERIALS PVI = POINT OF VERTICAL INTERSECTION BVCE = BEGINING OF VERTICAL CURVE ELEVATION PVMT = PAVEMENTBVCS = BEGINING OF VERTICAL CURVE STATION STA = STATIONTYP = TYPICALCB = CATCH BASINCIP = CAST IN PLACE RCP = REINFORCED CONCRETE PIPE CONC = CONCRETE RD = ROADDIA = DIAMETERREQ'D = REQUIREDDIP = DUCTILE IRON PIPE REV = REVISION DGA = DENSE GRADED AGGREGATE RF = REAR FACE WM = WATER MAINE = EPOXY COATED REBARELEV = ELEVATION WT = WEIGHTWWF = WELDED WIRE FABRIC EVCE = END OF VERTICAL CURVE ELEVATION EVCS = END OF VERTICAL CURVE STATION WZTC = WORK ZONE TRAFFIC CONTROL YR = YEAREXIST = EXISTINGFF = FRONT FACE FDNY = NEW YORK CITY FIRE DEPARTMENT FFE = FINISHED FLOOR ELEVATION HDPE = HIGH DENSITY POLYETHYLENE HPBO = HEAVY POST BLOCK OUT

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Engineering and Land Surveying, P.C.

370 7th Avenue SUITE 1604 New York, NY 10001



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В	FINAL SUBMISSION	AB	JL	11/8/22
Α	INTERIM SUBMISSION	MK	JL	8/29/22
REV	DESCRIPTION	DRW BY	CHK BY	DATE



Hitachi Energy

901 Main Campus Drive

901 Main Campus Drive Raleigh, North Carolina 27606


PROJECT



Astoria HVDC Converter Station

31-45 20th Avenue, Astoria, Queens NY 11105 Block #850 - Lot #310 - BIN #4624437

LEGEND AND ABBREVIATIONS

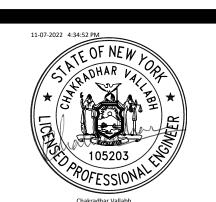

DATE November 8, 2022

PROJECT NO 105121

DRAWING BY M. KWOK

CHECKED BY J.LLORENTE

DRAWING NO

C-002.00

ADD FILE NO

OUTDOOR CABLE TRENCH AND CONDUIT NOTES

- 1. OUTDOOR CABLE TRENCHES SHALL BE CONSTRUCTED OF CAST IN SITU OR PREFABRICATED REINFORCED CONCRETE AND BE COVERED.
- 2. CABLE TRENCHES SHALL HAVE A MINIMUM WIDTH OF 500MM (20 INCHES). THE TOP OF THE TRENCH COVER SHALL BE APPROXIMATELY 100 MM (4 INCHES) ABOVE THE SURROUNDING FINISHED YARD LEVEL IN YARD AREAS, WHEREAS AT ROAD CROSSINGS THE TOP OF THE TRENCH COVER SHALL BE FLUSH WITH THE TOP OF THE ROAD.
- 3. ALL TRENCHES SHALL BE DRAINED BY THE DRAINAGE SYSTEM TO AVOID STANDING WATER IN THE TRENCHES. ALL INCOMING CONDUITS TO THE TRENCH SHALL BE SEALED TO MAKE THE TRENCHES WATER FREE.
- 4. BURIED CONDUITS SHALL BE CONSTRUCTED OF PIPES WITH PULL WIRES. PULL PITS SHALL BE INTRODUCED AS REQUIRED BY NEC.
- 5. WATERTIGHT AND FIRE-PROOF SEAL SHALL BE ADDED TO CABLE TRENCHES AND CONDUITS ENTERING BUILDINGS. FOR CABLE ENTRIES MULTI CABLE TRANSITS (MCT'S) SHALL BE USED.
- 6. ALL TRENCHES REQUIRE CONNECTION TO THE GROUNDING GRID, SEE 1 JNL 12201483

SITE UTILITIES NOTES:

IN HEIGHT THAN LIGHTNING PROTECTION TOWERS.

- 1. THE FINISHED YARD LEVEL SHALL BE SLOPED AWAY FROM THE CONVERTER BUILDING COMPLEX, EITHER TO A SEPARATE YARD DRAINAGE SYSTEM (APPLICABLE FOR LARGE YARD AREAS) OR DIRECTLY TO SURROUNDING DITCHES (APPLICABLE FOR SMALLER YARD AREAS).
- 2. A SEPARATE BURIED STORM WATER SYSTEM SHALL BE DESIGNED TO HANDLE AND DISCHARGE ALL STORM WATER FROM THE BUILDING ROOFS.
- 3. THE BUILDINGS' PLUMBING AND FIRE SUPPRESSION INSTALLATIONS SHALL BE CONNECTED TO AN EXISTING WATER MAIN NEAR EXISTING VALVE VAULT NORTH WEST OF SITE FOR THE SITE WATER LINE NETWORK. (TO BE CONFIRMED WITH UTILITY OWNER),
- 4. THE BUILDINGS' PLUMBING INSTALLATIONS SHALL BE CONNECTED TO AN EXISTING SEWAGE MAIN AT THE FENCE LINE FOR THE SITE SEWAGE SYSTEM.
- 5. WALL AND POLE MOUNTED FLOOD LIGHTS, ACCESS LIGHTS, SUB-DISTRIBUTION, SOCKET OUTLETS, CONTROL SYSTEM AND CABLING SHALL BE PROVIDED, INSTALLED, AND COMMISSIONED AS REQUIRED PER LOCAL REGULATIONS AND REQUIREMENT SPECIFICATIONS (RS). PARTS AND COMPONENTS OF THE INSTALLATION THAT MAY BE SUBJECT FOR MAINTENANCE AND REPLACEMENT, SHALL BE INSTALLED IN SUCH A WAY THAT AIR CLEARANCES TOWARDS LIVE PARTS (E.G. MAIN CIRCUIT EQUIPMENT) ARE NOT BREACHED DURING POSSIBLE MAINTENANCE WORK. RISK ASSESSMENT SHALL BE MADE OF THE DESIGN PRIOR OF INSTALLATION. LIGHT POLES/MASTS SHALL FURTHERMORE BE LOWER
- 6. SMALL POWER AND LIGHTING CABLES SHALL BE SEPARATED FROM THE HITACHI ENERGY CABLES (NOT TO BE ROUTED ON SAME LADDER/TRAY). DIFFERENT LADDER OR CONDUIT BUT IN SAME DUCT BANK MAY BE USED WHERE NEEDED.

NYCDEP NOTES:

- LOCATIONS OF EXISTING DRAINAGE STRUCTURES ARE APPROXIMATE. EXACT LOCATION AND OFFSET SHALL BE DETERMINED IN THE FIELD AS DIRECTED BY THE ENGINEER.
- 2. CARE SHALL BE TAKEN NOT TO DAMAGE EXISTING SEWERS DURING CONSTRUCTION. ANY DAMAGE CAUSED BY THE DESIGN BUILDER'S OPERATION SHALL BE REPAIRED BY THE CONTRACTOR AS DIRECTED BY THE ENGINEER.
- 3. REFER TO NOTE 5, CONSTRUCTION OPERATION NOTES, ON NYSDOT STANDARD SHEET 203-04 IF THERE IS A NEED FOR CONSTRUCTION EQUIPMENT TO CROSS NEW AND EXISTING DRAINAGE LINE INSTALLATIONS.
- 4. DRAINAGE STRUCTURES SHALL NOT BE LOCATED WITHIN CURB RAMPS OR PEDESTRIAN CROSSWALK LIMITS.
- 5. THE BRICK MASONRY OR CONCRETE FOR THE CHAMBERS SHALL BE BUILT TO WITHIN SUCH DISTANCE OF THE FINAL GRADE AS SHOWN, SPECIFIED OR ORDERED. FRAMES AND COVERS SHALL BE AS SHOWN ON THE SEWER DESIGN STANDARDS. THE FRAMES SHALL BE SET ON THE MASONRY OR CONCRETE IN A FULL BED OF STIFF FRESH CEMENT MORTAR.
- 6. DRAINAGE STRUCTURES IN THE PROJECT AREA SHALL BE MAINTAINED OPERABLE AT ALL TIMES.
- 7. THE CONTRACTOR SHALL PROVIDE TEMPORARY MEANS (PIPES, PUMPS, ETC.) TO DRAIN ANY STORM WATER WHICH MAY DEVELOP WITHIN THE PROJECT LIMITS FOR THE DURATION OF CONSTRUCTION.
- 8. ALL EXISTING INVERT ELEVATIONS, PIPE DIMENSIONS AND PIPE MATERIALS ARE OBTAINED FROM SURVEY AND/OR AS-BUILTS. THE CONTRACTOR SHALL FIELD VERIFY ALL OF THESE DETAILS BEFORE COMMENCING WORK.
- 9. THE DESIGN BUILDER ATTENTION IS DIRECTED TO OSHA STANDARDS, SECTION 1926.651(G) CONCERNING LOCATIONS OF POSSIBLE OXYGEN DEFICIENCY OR GASEOUS CONDITIONS THAT MIGHT BE ENCOUNTERED WHEN WORKING ON THE EXISTING DRAINAGE SYSTEM.
- 10. THE VERTICAL DATUM IS THE NORTH AMERICAN VERTICAL DATUM OF 1988 (NAVD88). QUEENS BOROUGH SEWER DATUM IS 2.725 FEET ABOVE THE MEAN SEA LEVEL AT SANDY HOOK, NEW JERSEY AS ESTABLISHED BY THE U.S.C.&G. SURVEY.
- 11. ALL PROPOSED DRAINAGE WORK SHALL BE DONE IN CONFORMANCE WITH THE LATEST STANDARDS OF THE DEPARTMENT OF ENVIRONMENTAL PROTECTION (NYCDEP).
- 12. PRIOR TO WORK ON NYCDEP DRAINAGE INFRASTRUCTURE THE APPLICABLE DESIGN AND PERMITTING APPROVALS SHALL BE RECEIVED FROM THE NYCDEP.
- 13. ALL EXISTING SEWER MANHOLES TO BE RETAINED WITHIN THE CONTRACT LIMITS SHALL BE ADJUSTED AS NECESSARY, SO THAT THEY WILL BE FLUSH WITH THE FINISHED GRADES AFTER COMPLETION OF THE WORK. ANY OF THESE MANHOLES WHICH HAVE DAMAGED, WORN OR NON-STANDARD FRAMES AND COVERS SHOULD BE PROVIDED WITH NEW 27" CASTINGS IN ACCORDANCE WITH THE LATEST STANDARDS OF NYCDEP INCLUDING ANY NECESSARY MODIFICATIONS OF THE MANHOLE MASONRY. ANY DAMAGE TO THE MANHOLES CAUSED BY THIS WORK SHALL BE REPAIRED OR REPLACED BY THE CONTRACTOR, AS DIRECTED BY THE ENGINEER, AND AT NO COST TO THE NYCDEP.
- 14. CARE SHALL BE TAKEN NOT TO DAMAGE EXISTING SEWERS DURING CONSTRUCTION. ANY DAMAGE CAUSED BY THE DESIGN BUILDER'S OPERATION SHALL BE REPAIRED BY THE DESIGN BUILDER AS DIRECTED BY THE ENGINEER, AT NO EXTRA COST TO NYCDEP.
- 15. WHERE THE HEIGHT OF AN EXISTING MANHOLE PERMITS MORE THAN ONE BASIN CONNECTION TO BE MADE ON THE SAME WALL, SPECIAL PRECAUTION SHALL BE TAKEN TO PROTECT THE STRUCTURAL INTEGRITY OF THE MANHOLE. THE MINIMUM CLEARANCE BETWEEN THE OUTSIDE WALLS OF ANY TWO BASIN CONNECTIONS OR BETWEEN A BASIN CONNECTION AND A SEWER, VERTICALLY OR HORIZONTALLY, SHALL BE 12 INCHES.
- 16. ALL EXISTING MANHOLES, INLETS, BASINS AND CONNECTIONS WITHIN THE LIMITS OF THIS CONTRACT AND CONTIGUOUS THERETO ARE TO BE CLEANED, FLUSHED AND OTHERWISE MADE OPERABLE TO THE SATISFACTION OF THE ENGINEER. WHERE THE EXISTING BASIN CONNECTIONS ARE FOUND TO BE DAMAGED OR IN DETERIORATING CONDITION, THEY SHALL BE REPLACED WITH NEW 12" DIAMETER DUCTILE IRON PIPE, CLASS 56, IN ACCORDANCE WITH THE LATEST NYCDEP STANDARDS. DAMAGED AND NON-STANDARD CASTINGS WITHIN THE LIMITS OF THIS CONTRACT SHOULD BE REPLACED WITH NEW STANDARD CASTINGS. EXISTING NON-STANDARD BASINS AT LOCATIONS WHERE BASINS ARE REQUIRED SHALL BE REPLACED WITH NEW STANDARD BASINS. ANY DAMAGED OR MISSING HOOD OF EXISTING BASINS WITHIN THE LIMITS OF THIS CONTRACT SHALL BE REPLACED WITH NEW STANDARD MANHOLES FRAME AND COVER WITHIN THE LIMITS OF THIS CONTRACT SHALL BE REPLACED WITH NEW STANDARD 27" DIAMETER MANHOLE FRAME AND COVER.
- 17. ALL ABANDONED BASINS, INLETS AND DRAINAGE STRUCTURES AS SHOWN ON THE CONTRACT PLANS ARE TO BE BULKHEADED AND CUT DOWN TO TWO (2) FEET BELOW THE SUBGRADE AND FILLED WITH COMPACTED CLEAN SAND. BASIN CONNECTIONS NOT REQUIRED SHALL BE PLUGGED AT BOTH ENDS. ALL ABANDONED BASINS AND BASIN CONNECTIONS MUST BE DONE AS PER NYCDEP STANDARD AND SPECIFICATIONS.
- 18. CATCH BASINS SHALL NOT, UNDER ANY CIRCUMSTANCES, BE CONNECTED TO A SANITARY SEWER.
- 19. ALL NEW CATCH BASIN CONNECTIONS SHALL BE CONNECTED TO EXISTING SEWERS AT MANHOLES, WITH 12" DUCTILE IRON PIPE, CLASS 56, WITH INTERNALLY LOCKED "PUSH-ON" JOINTS LAID ON 6" OF BROKEN STONE FOR THE ENTIRE WIDTH OF THE TRENCH AND FOR ONE-HALF THE PIPE DIAMETER. CRUSHED STONE SHALL BE BROKEN STONE, SOUND, HARD AND ROUGHLY CUBICAL IN SHAPE AND SHALL COMPLY WITH ASTM C33, SIZE NO. 67. ALL NEW CATCH BASINS SHALL HAVE A HOOD ON THE OUTLETTING
- 20. CATCH BASINS SHALL NOT BE LOCATED WITHIN PEDESTRIAN CROSSWALK LIMITS.
- 21. SLOPE ON ALL NEW CATCH BASIN CONNECTIONS SHALL BE A MINIMUM OF 0.5% AND A MAXIMUM OF 4% PROVIDED THE TOTAL DROP BETWEEN THE BASIN AND THE BASIN/MANHOLE IS AT LEAST 6 INCHES.
- 22. NYCDEP SEWERS: ALL EXISTING NYCDEP SEWERS WITHIN THE FOOTPRINT OF THE PROPOSED WORK AND WITHIN THE INFLUENCE LINES OF THE WORK SHALL BE CCTV INSPECTED. CCTV INSPECTION SHALL BE PERFORMED IN BOTH THE PRE-CONSTRUCTION AND IN THE POST-CONSTRUCTION PHASES. EXTRA CARE SHALL BE TAKEN DURING CONSTRUCTION TO PROTECT THE INTEGRITY OF NYCDEP'S EXISTING SEWER SYSTEM INCLUSIVE OF MANHOLES, CATCH BASINS, SEWERS AND SYSTEM CONNECTIONS. EXISTING NYCDEP MANHOLE FRAMES/COVERS SHALL BE RESET TO THE FINISHED GRADE AND CATCH BASINS SHALL BE POSITIONED PER NYC AGENCY REQUIREMENTS. CONTACT NYCDEP'S COLLECTION SYSTEMS INVESTIGATION (CSI) UNIT FOR COORDINATION OF CCTV SEWER INVESTIGATION. DAMAGE TO THE EXISTING SEWER SYSTEM WITHIN THE DURATION OF THE CONTRACT SHALL BE REPAIRED/REPLACED TO THE SATISFACTION OF THE ENGINEER AT NO ADDITIONAL COST TO NYCDEP.
- 23. INSTALL NYCDEP STANDARD TYPE 1 CATCH BASIN WHERE PROPOSED NYCDEP CATCH BASINS ARE REQUIRED AT LOW POINT, UNLESS SPECIFIED BY DEP.
- 24. NYCDEP RECOMMENDS 6 FEET MINIMUM EDGE-TO-EDGE HORIZONTAL CLEARANCES BETWEEN PROPOSED FOUNDATIONS AND SEWER/WATER UTILITIES.
- 25. FOR WATER MAINS CROSSING EXISTING SEWERS: THE MINIMUM CLEARANCE BETWEEN THE TOP OF A SEWER AND THE OUTSIDE BOTTOM OF THE WATER PIPE (PIPE WALL THICKNESS TO BE TAKEN INTO CONSIDERATION) SHALL BE 12 INCHES. IN ORDER TO MAINTAIN THE PROPER CLEARANCE, THE FOLLOWING ALTERNATIVES SHALL BE CONSIDERED AND APPLIED, AS DIRECTED BY THE ENGINEER:
- 25.1. THE USE OF BEVELED CONNECTION IN LIEU OF BENDS SHALL BE INVESTIGATED IF THE DEGREE OF INTERFERENCE IS OF A MINOR NATURE: OTHERWISE BENDS AND/OR REDUCERS SHALL BE USED.
- MINOR NATURE; OTHERWISE, BENDS AND/OR REDUCERS SHALL BE USED.

 25.2. THE COVER ON THE PIPE MAY BE REDUCED TO TWO AND ONE HALF (2.5) FEET.
- 25.3. IF A 12-INCH MINIMUM CLEARANCE CANNOT BE MAINTAINED, THE WATER MAIN SHALL BE SUPPORTED BY A PIER OF APPROVED DESIGN ON EACH SIDE OF THE SEWER. THE PIPE SHALL THEN BE DESIGNED TO ACT AS A BEAM BETWEEN THESE SUPPORTS. THE CLEARANCE IS TO BE FILLED WITH LAYERS OF APPROVED MATERIAL TO AVOID EXCESSIVE BEARING PRESSURE ON THE PIPE. IN NO CASE, HOWEVER, SHALL THIS CLEARANCE BE LESS THAN 6 INCHES.
- 26. ALL HORIZONTAL CLEARANCE BETWEEN WATER MAINS INSTALLED PARALLEL TO SEWERS ARE TO CONFORM TO THE FOLLOWING:
- 26.1. HORIZONTAL CLEARANCE BETWEEN THE OUTSIDE OF WATER MAINS AND CENTER LINE OF SEWER SHALL NOT BE LESS THAN SIX(6) FEET PLUS ONE HALF SEWER DIAMETER, WHERE THE DEPTH TO THE BOTTOM OF THE SEWER IS LESS THAN TEN (10) FEET.
- 26.2. WHERE THE DEPTH TO THE BOTTOM OF SEWER IS TEN (10) FEET OR MORE, HORIZONTAL CLEARANCE SHALL BE INCREASED BY ONE (1) FOOT FOR EACH ADDITIONAL FIVE (5) FEET OF DEPTH OVER THE TEN (10) FEET, OR PORTION THEREOF.
- 27. LIST OF APPLICABLE NYC D.E.P. STANDARD SEWER SPECIFICATIONS:
 27.1 NYCDEP STANDARD SEWER AND WATER MAIN SPECIFICATIONS ALIC
- 27.1. NYCDEP STANDARD SEWER AND WATER MAIN SPECIFICATIONS, AUGUST 8, 2022; 27.2. NYCDEP SEWER DESIGN STANDARDS, AUGUST 2018;
- 27.3. NYCDEP WATER MAIN STANDARD DRAWINGS, DECEMBER 9,2020.
- 28. ALL FLOATING METALLIC PIECES SHALL BE GROUNDED.
- 29. GROUND ALL METALLIC COVERS IN THE SITE BY CONNECTING THEM TO THE STATION GROUNDING GRID WITH MINIMUM 4/0 AWG GROUNDING WIRE AND PROVIDING MINIMUM OF 2 FEET OF SLACK FOR LARGER COVERS SO THAT THE COVERS CAN BE MOVED ASIDE, IF REQUIRED, WITHOUT NEED FOR UNBOLTING THE GROUNDING COVER.





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В	FINAL SUBMISSION	SC	CV	11/8/22
Α	INTERIM SUBMISSION	SC	CV	8/29/22
REV	DESCRIPTION	DRW BY	CHK BY	DATE



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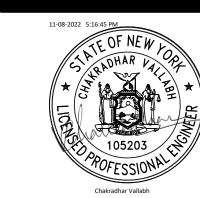
PROJECT



Astoria HVDC Converter Station

31-45 20th Avenue, Astoria, Queens NY 11105 Block #850 - Lot #310 - BIN #4624437

UTILITY NOTES



 DATE
 NOVEMBER 8, 2022


 PROJECT NO
 105121

 DRAWING BY
 S. CASH

 CHECKED BY
 C. VALLABH

C-200.00

CADD FILE NO

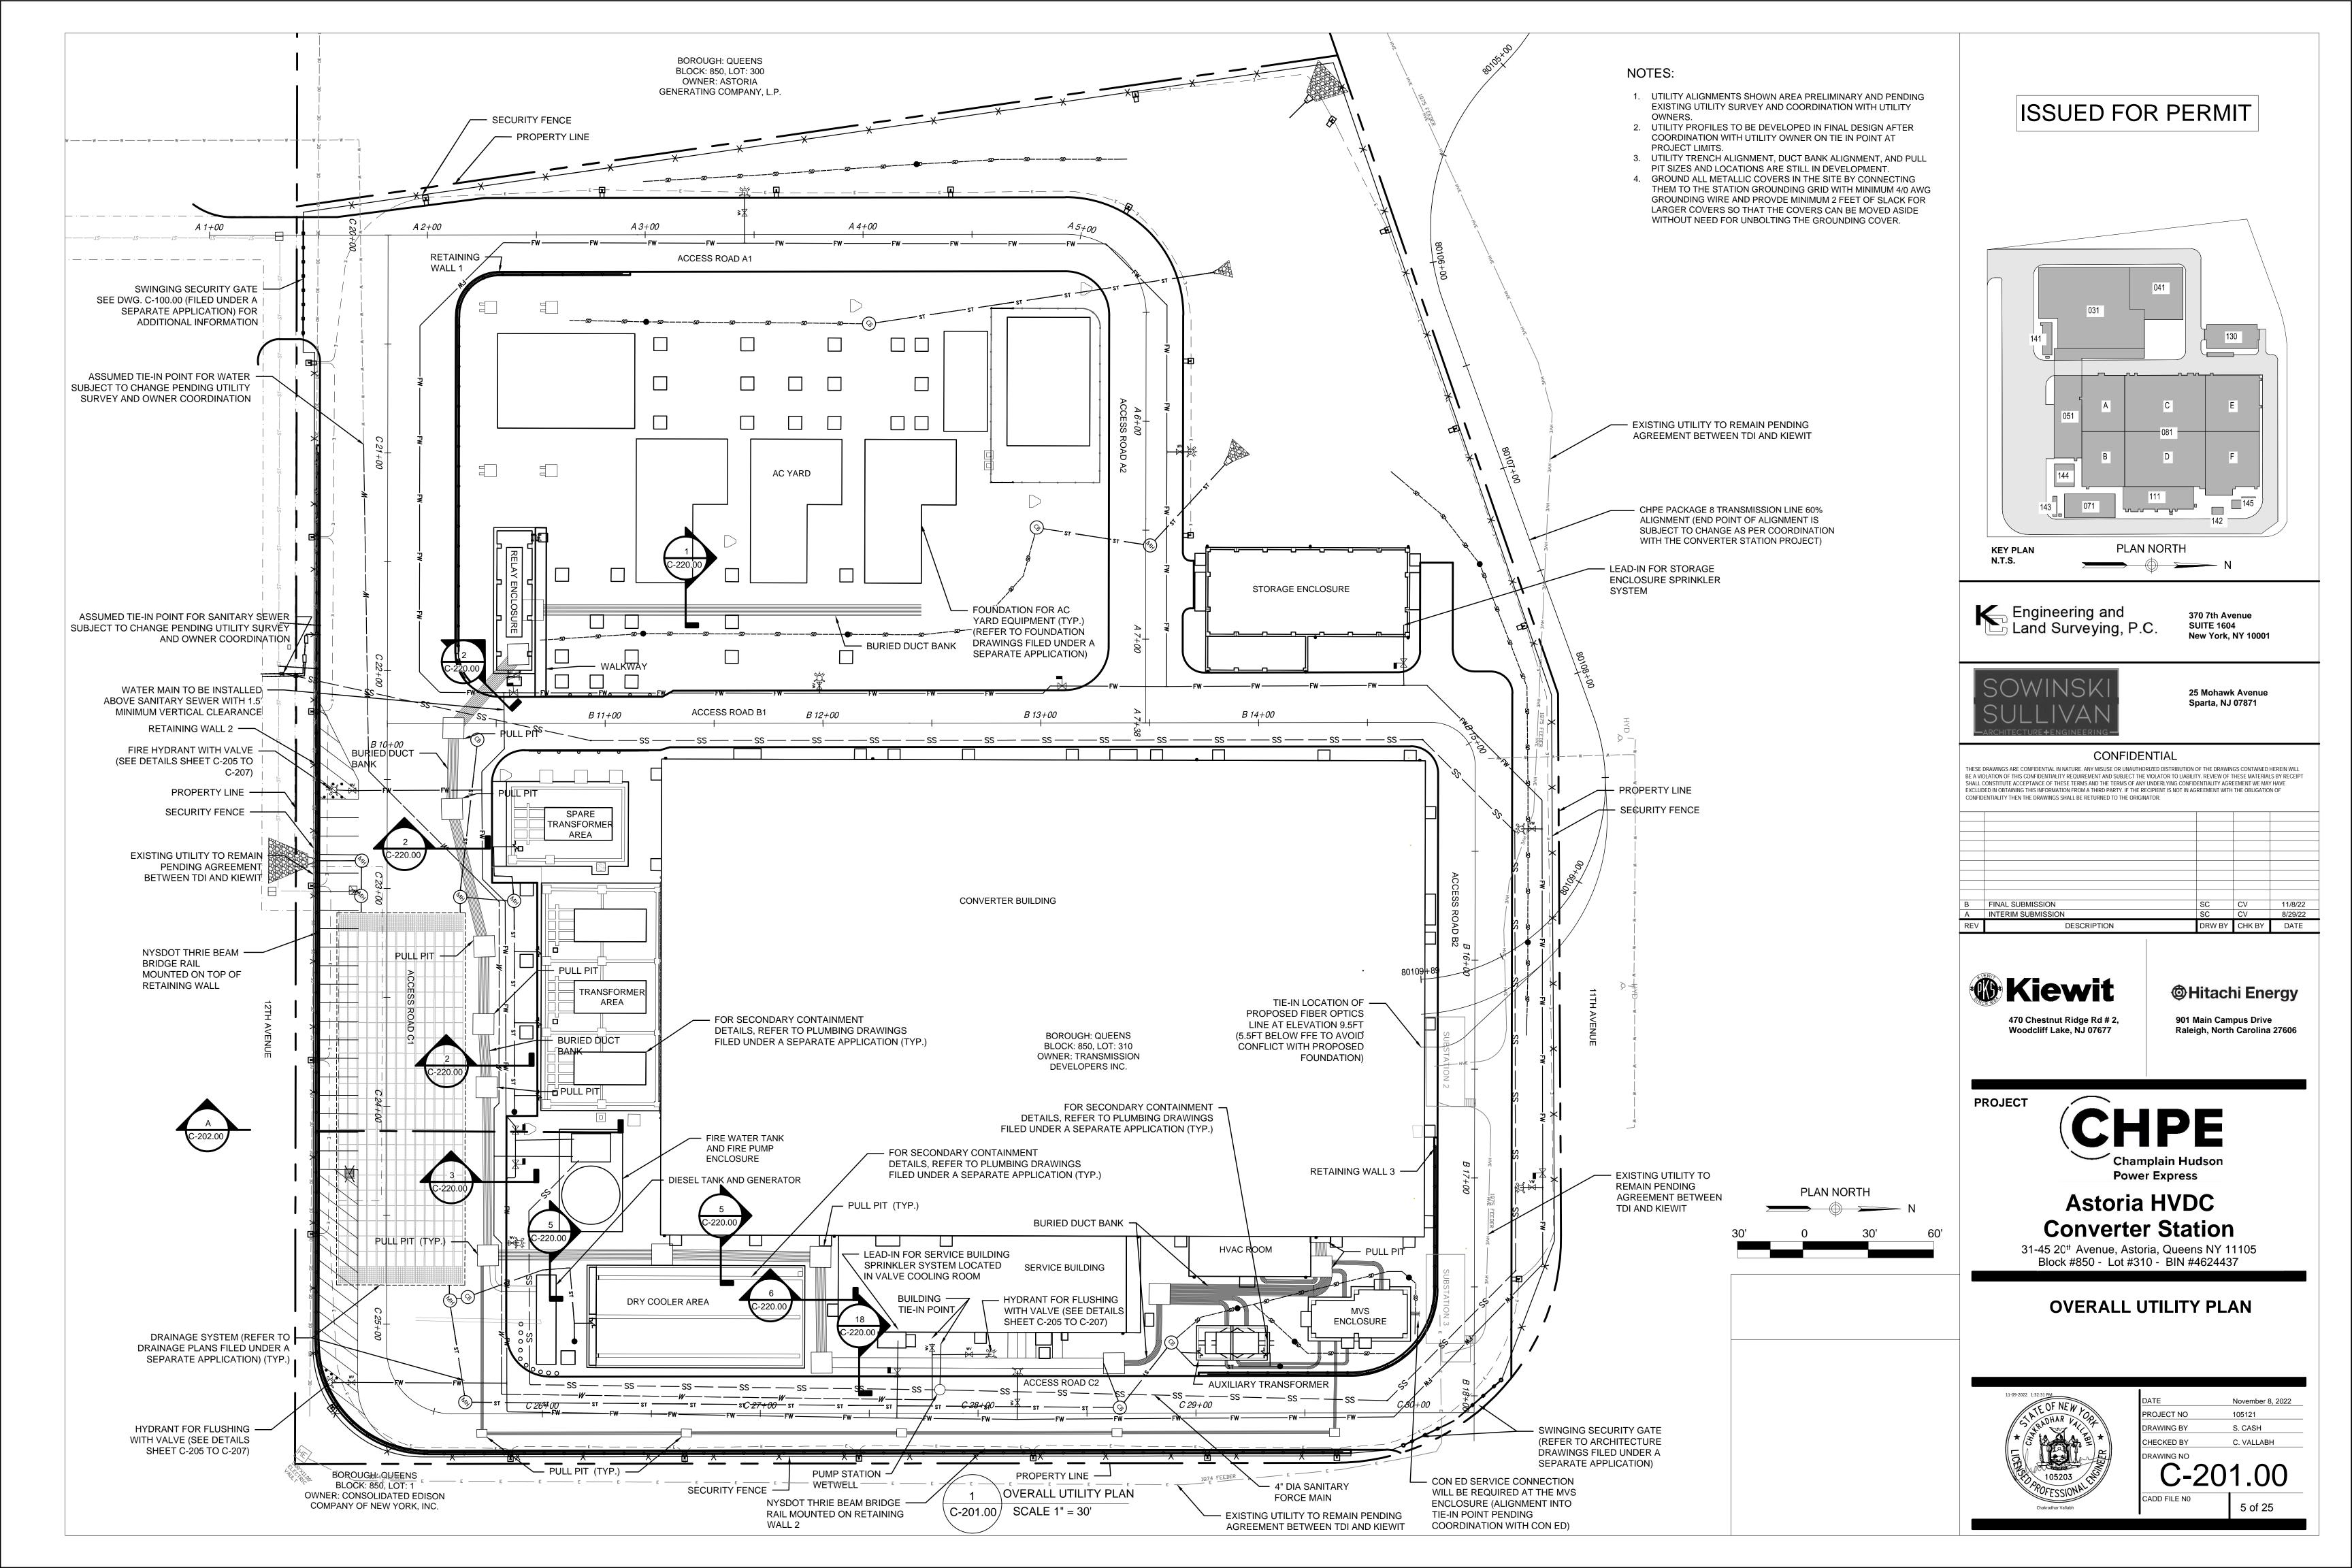



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В	FINAL SUBMISSION	AB	JL	11/8/22
Α	INTERIM SUBMISSION	MK	JL	08/29/22
REV	DESCRIPTION	DRW BY	CHK BY	DATE



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10'


HORIZONTAL



Astoria HVDC Converter Station


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UTILITY SECTION

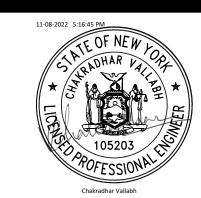



NOVEMBER 8, 2022 M.KWOK CHECKED BY J.LORENTE

6 of 25

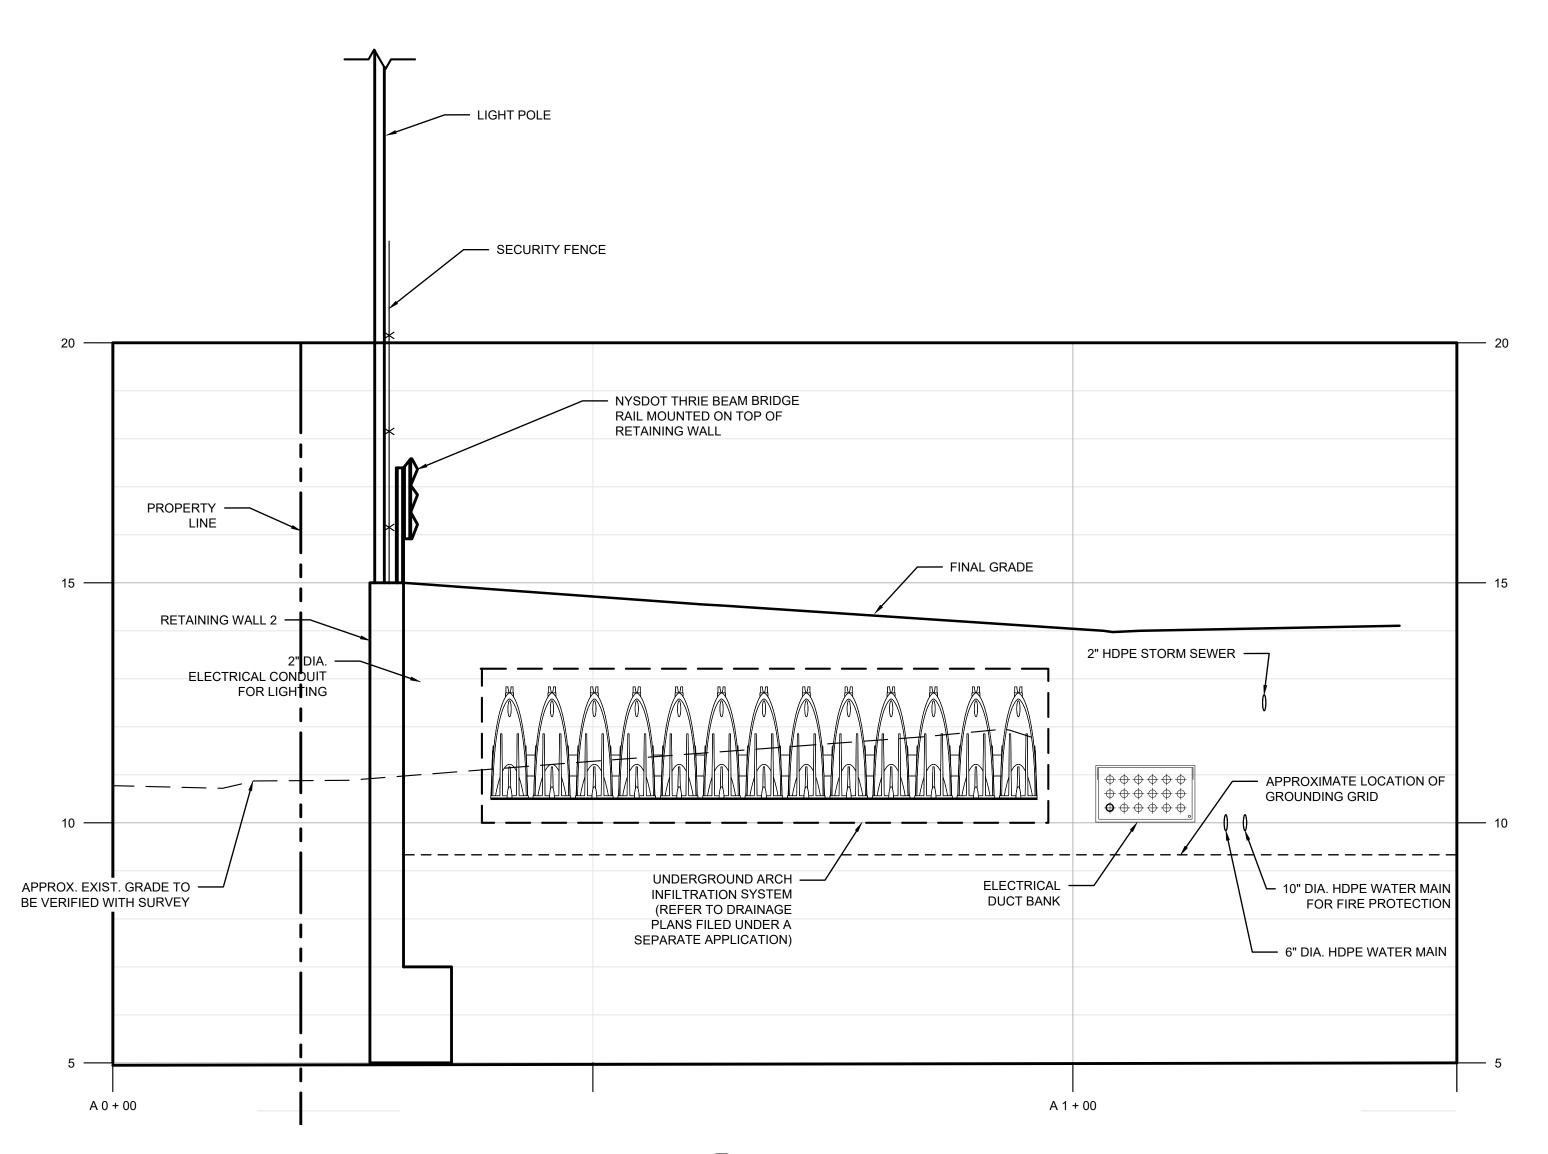

A SITE SECTION A C-201.00 HORIZONTAL SCALE 1" = 10' VERTICAL SCALE 1" = 2'

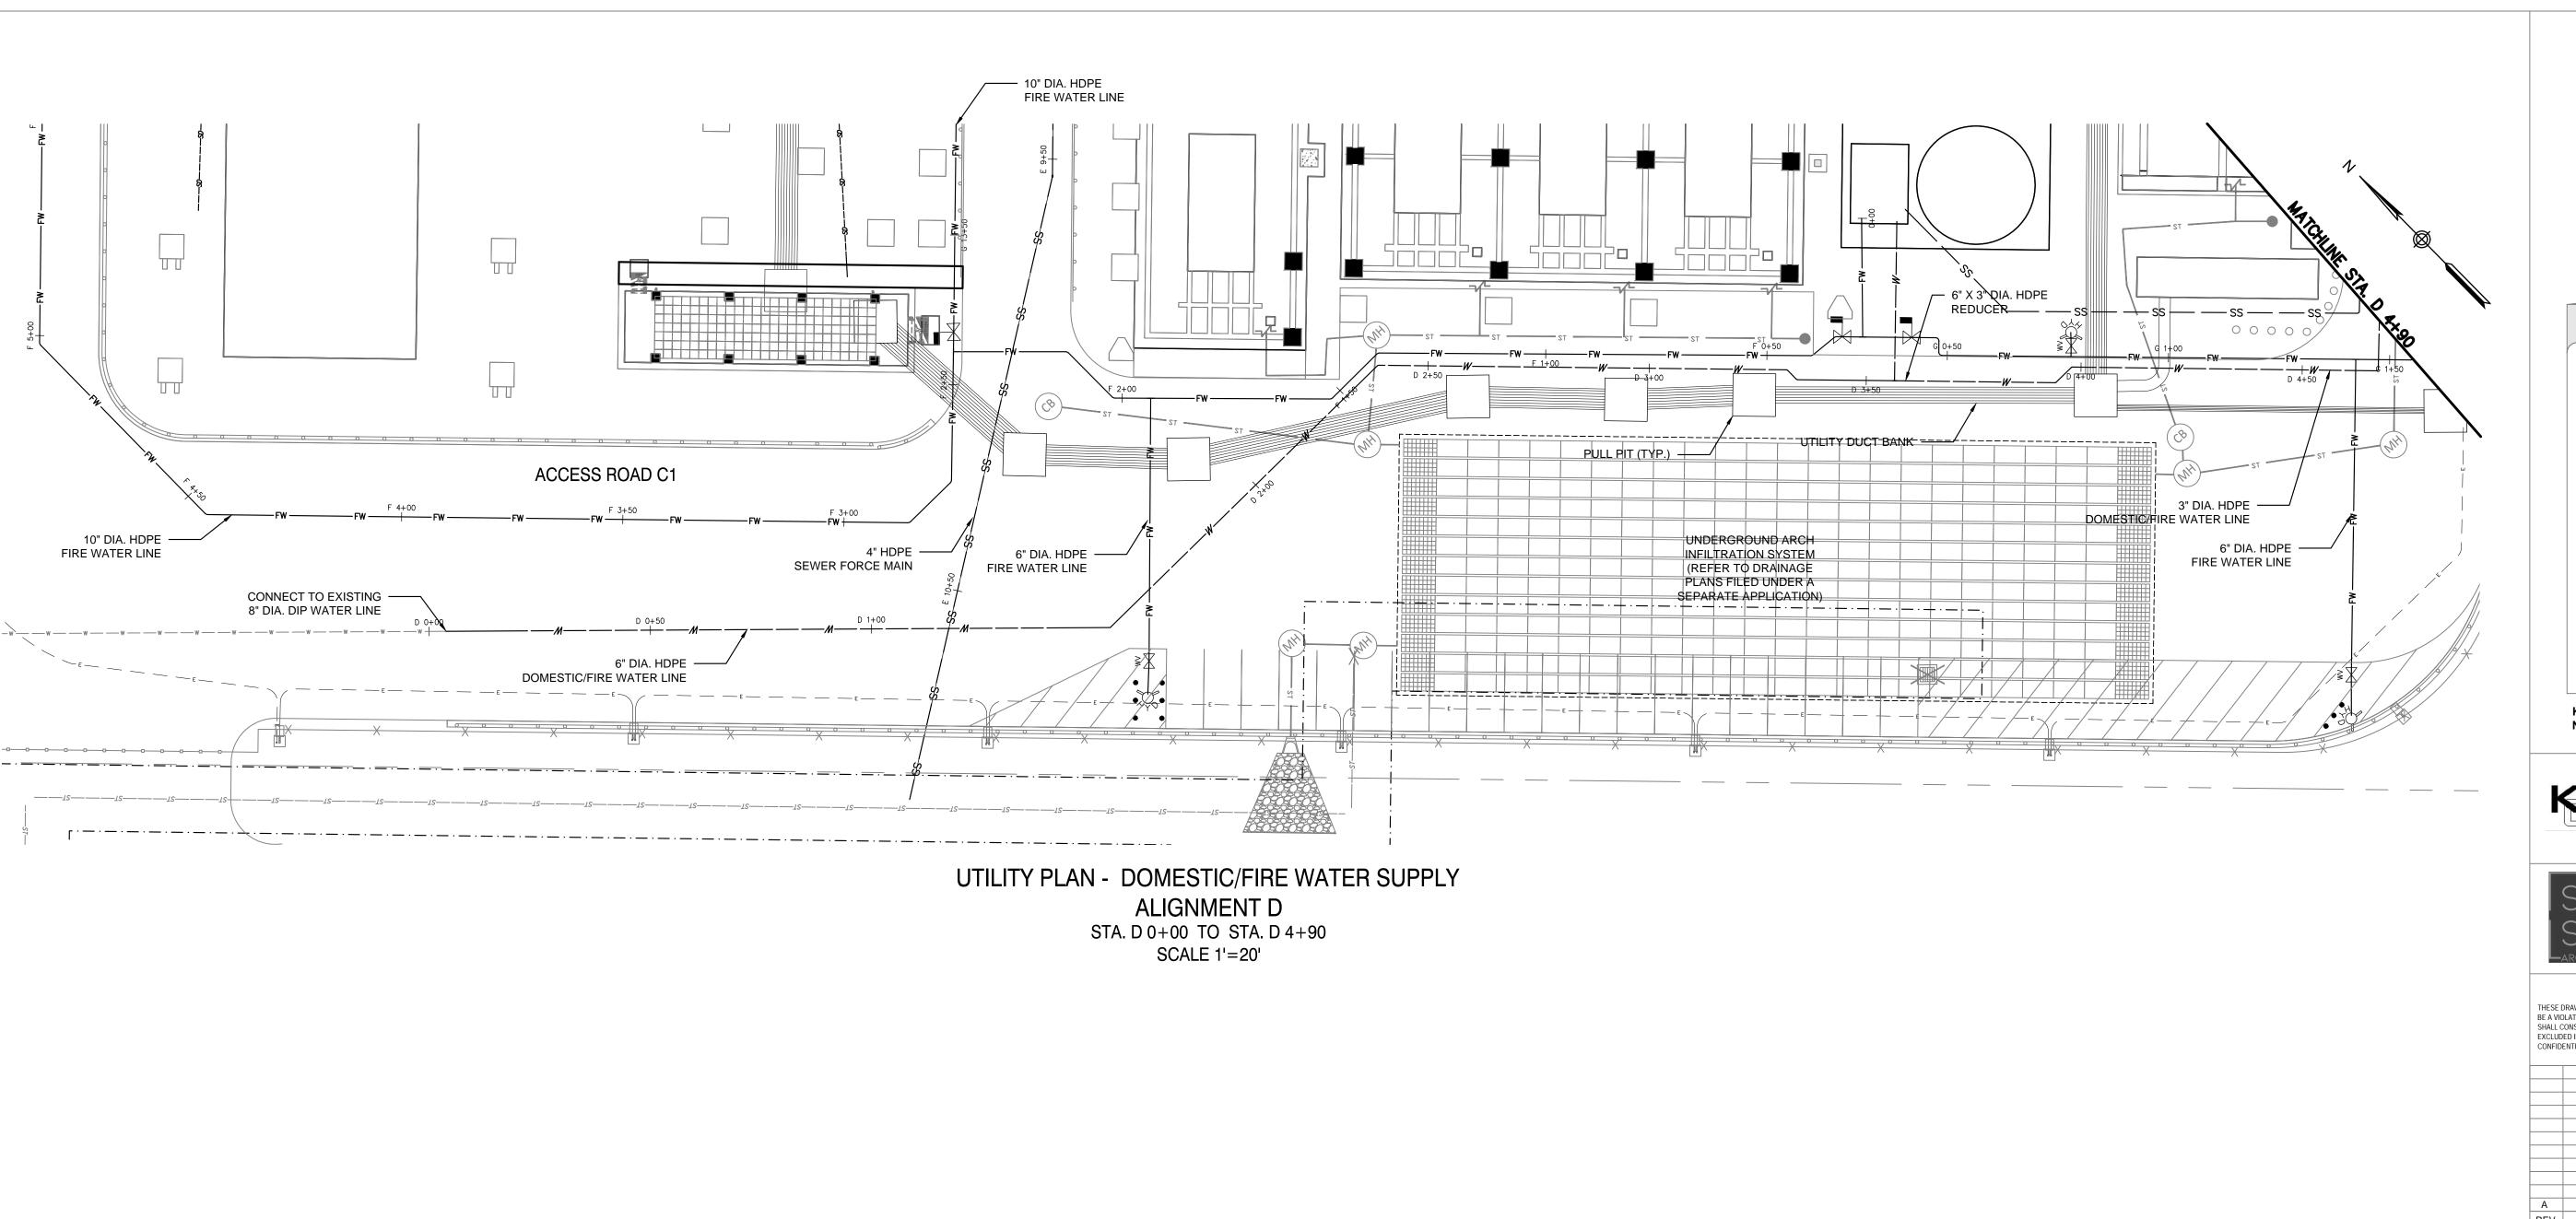


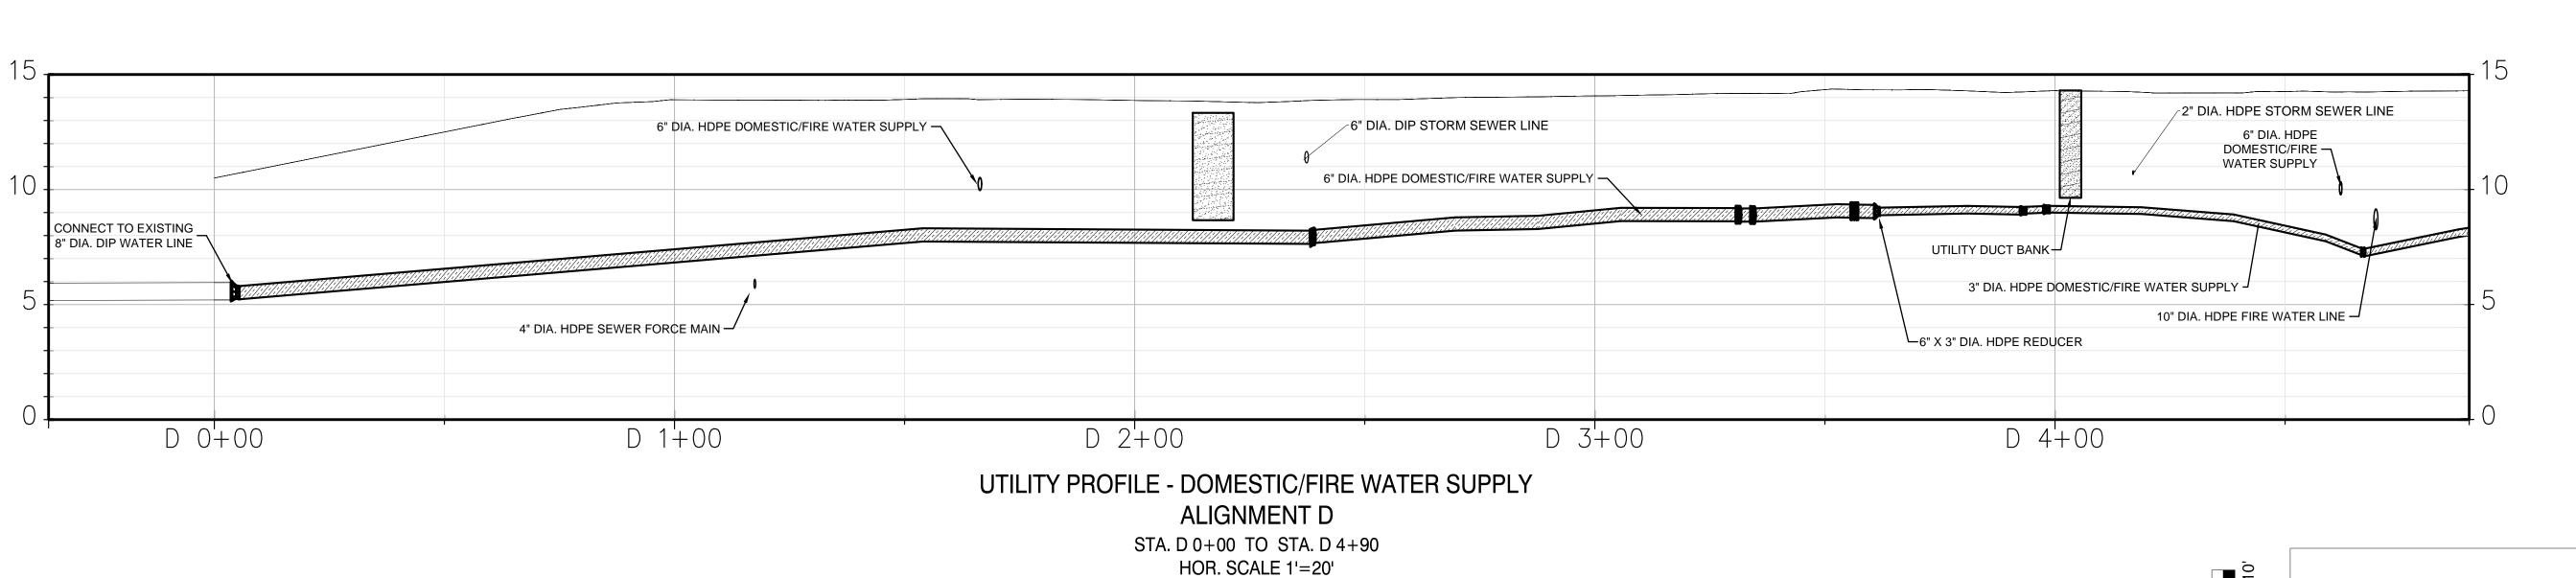

VERT. SCALE 1'=5"

20' 0 20' 40'

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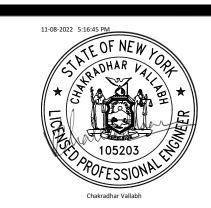
PROJECT

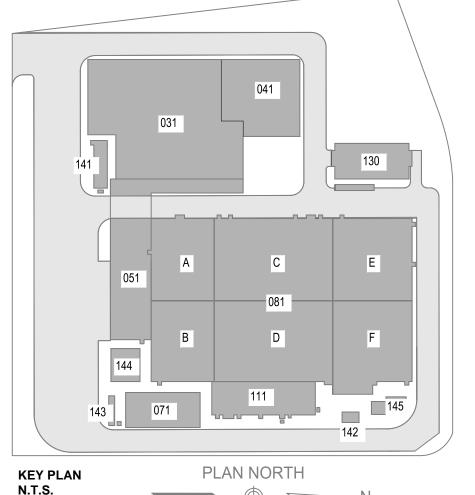

Astoria HVDC Converter Station

31-45 20th Avenue, Astoria, Queens NY 11105 Block #850 - Lot #310 - BIN #4624437


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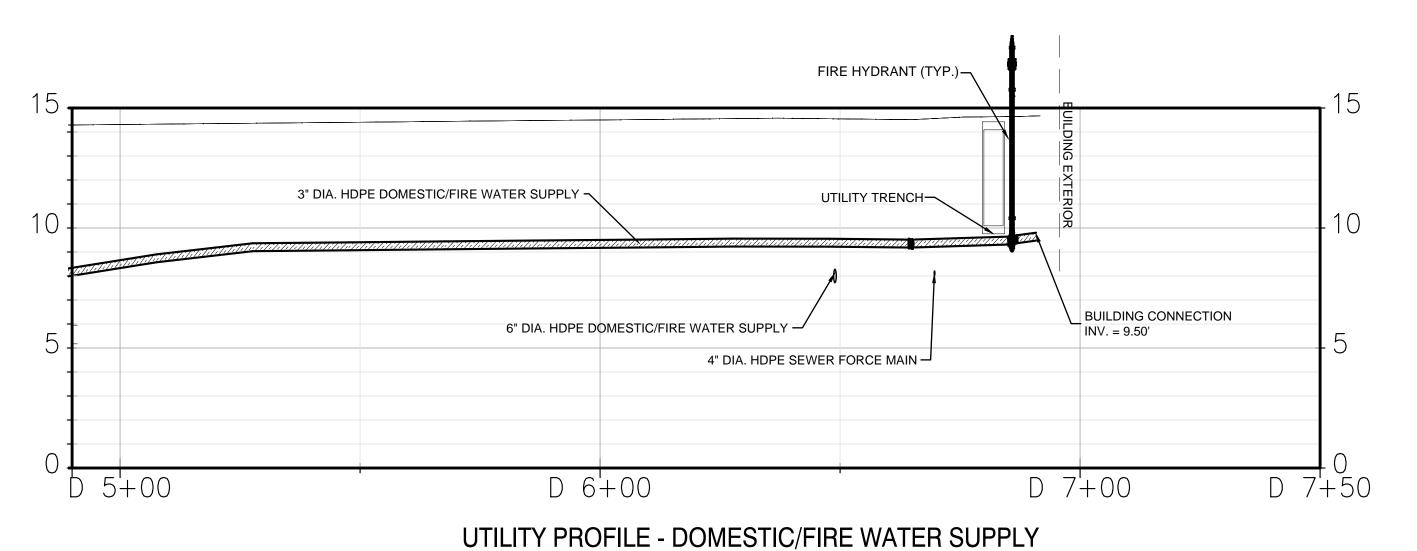


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PROJECT NO	105121
DRAWING BY	A. TRACEY
CHECKED BY	C. VALLABH

C-203.00

ADD FILE NO



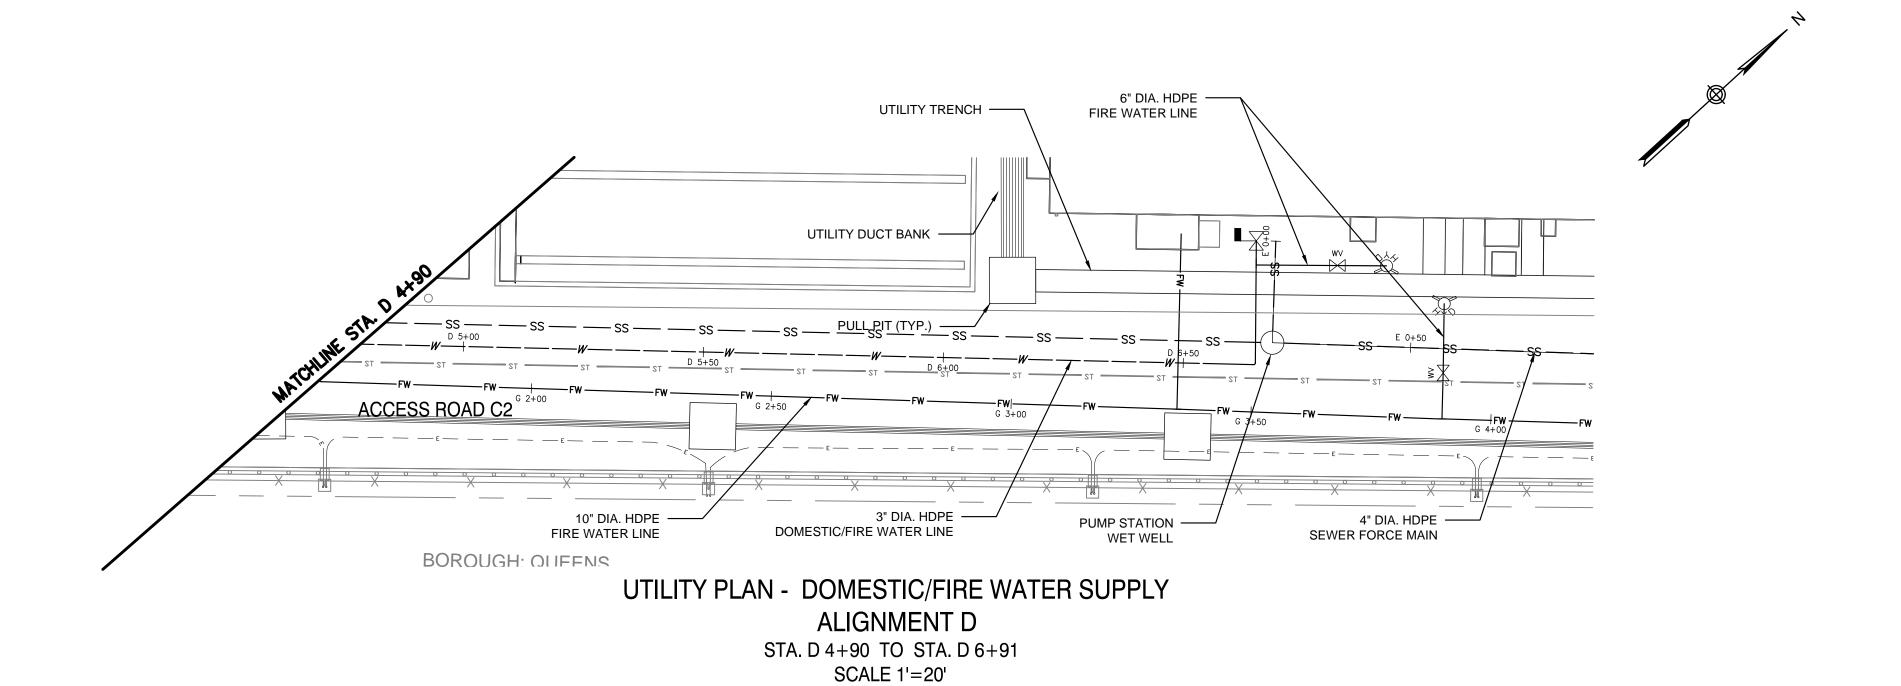

ALIGNMENT D


STA. D 4+90 TO STA. D 6+91

HOR. SCALE 1'=20'

VERT. SCALE 1'=5"

20' 40'

ISSUED FOR PERMIT

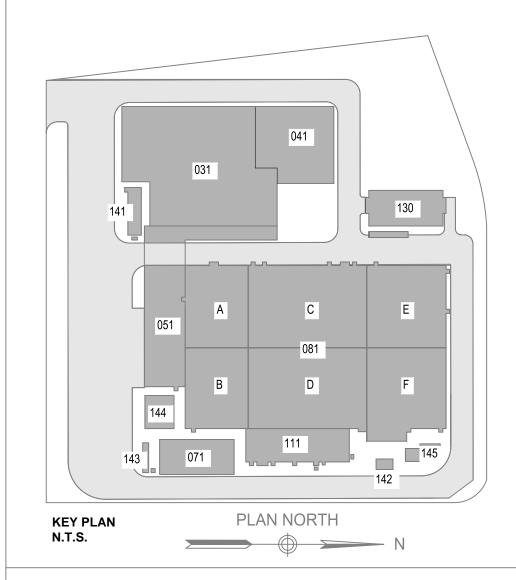




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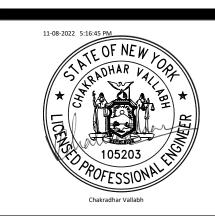
PROJECT



Astoria HVDC Converter Station

31-45 20th Avenue, Astoria, Queens NY 11105 Block #850 - Lot #310 - BIN #4624437


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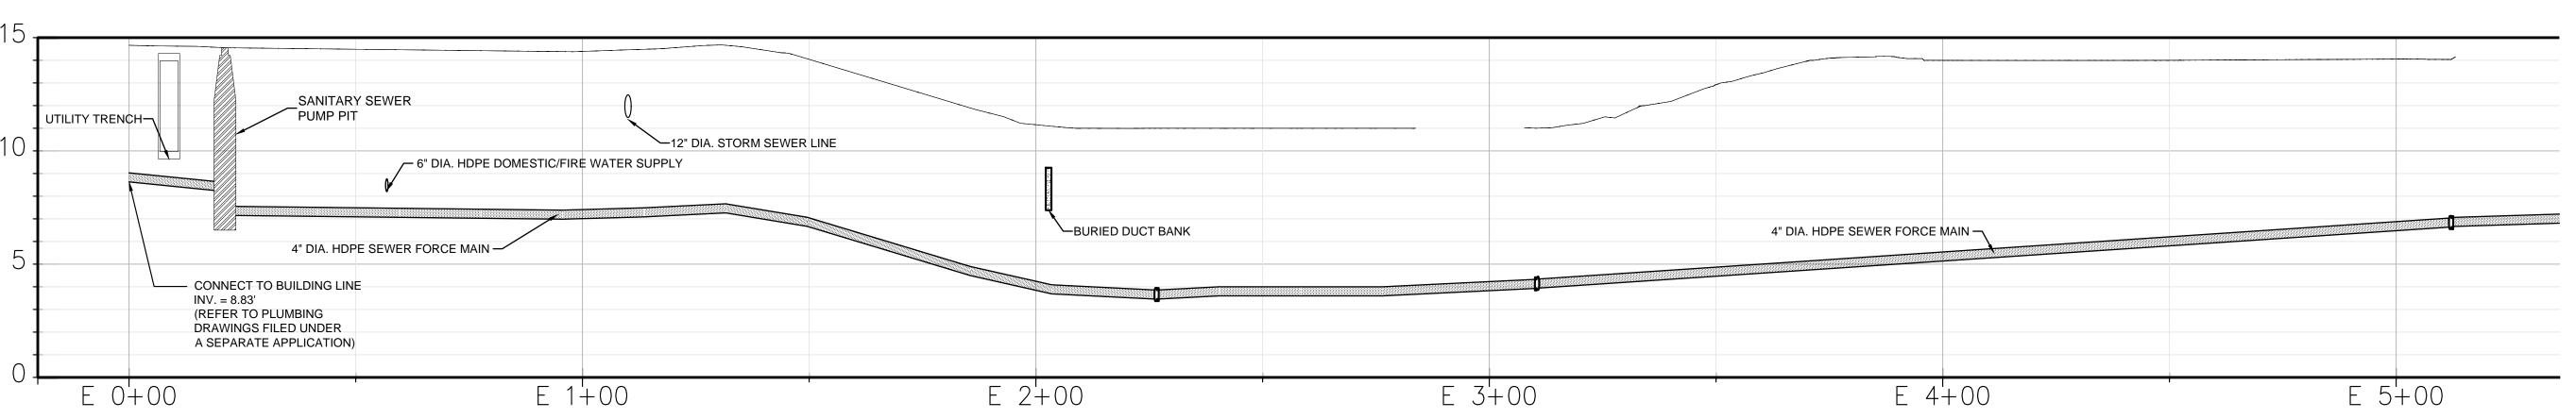

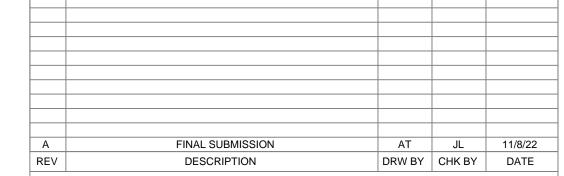
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DATE	NOVEMBER 8, 2022
PROJECT NO	105121
DRAWING BY	A. TRACEY
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C-204.00


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UTILITY PROFILE - SANITARY SEWER ALIGNMENT E STA. E 0+00 TO STA. E 5+40 HOR. SCALE 1'=20' VERT. SCALE 1'=5"

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FINAL SUBMISSION AT JL 11/8/22
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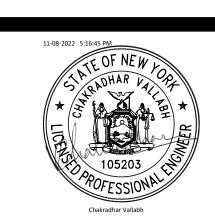
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Astoria HVDC Converter Station

31-45 20th Avenue, Astoria, Queens NY 11105 Block #850 - Lot #310 - BIN #4624437

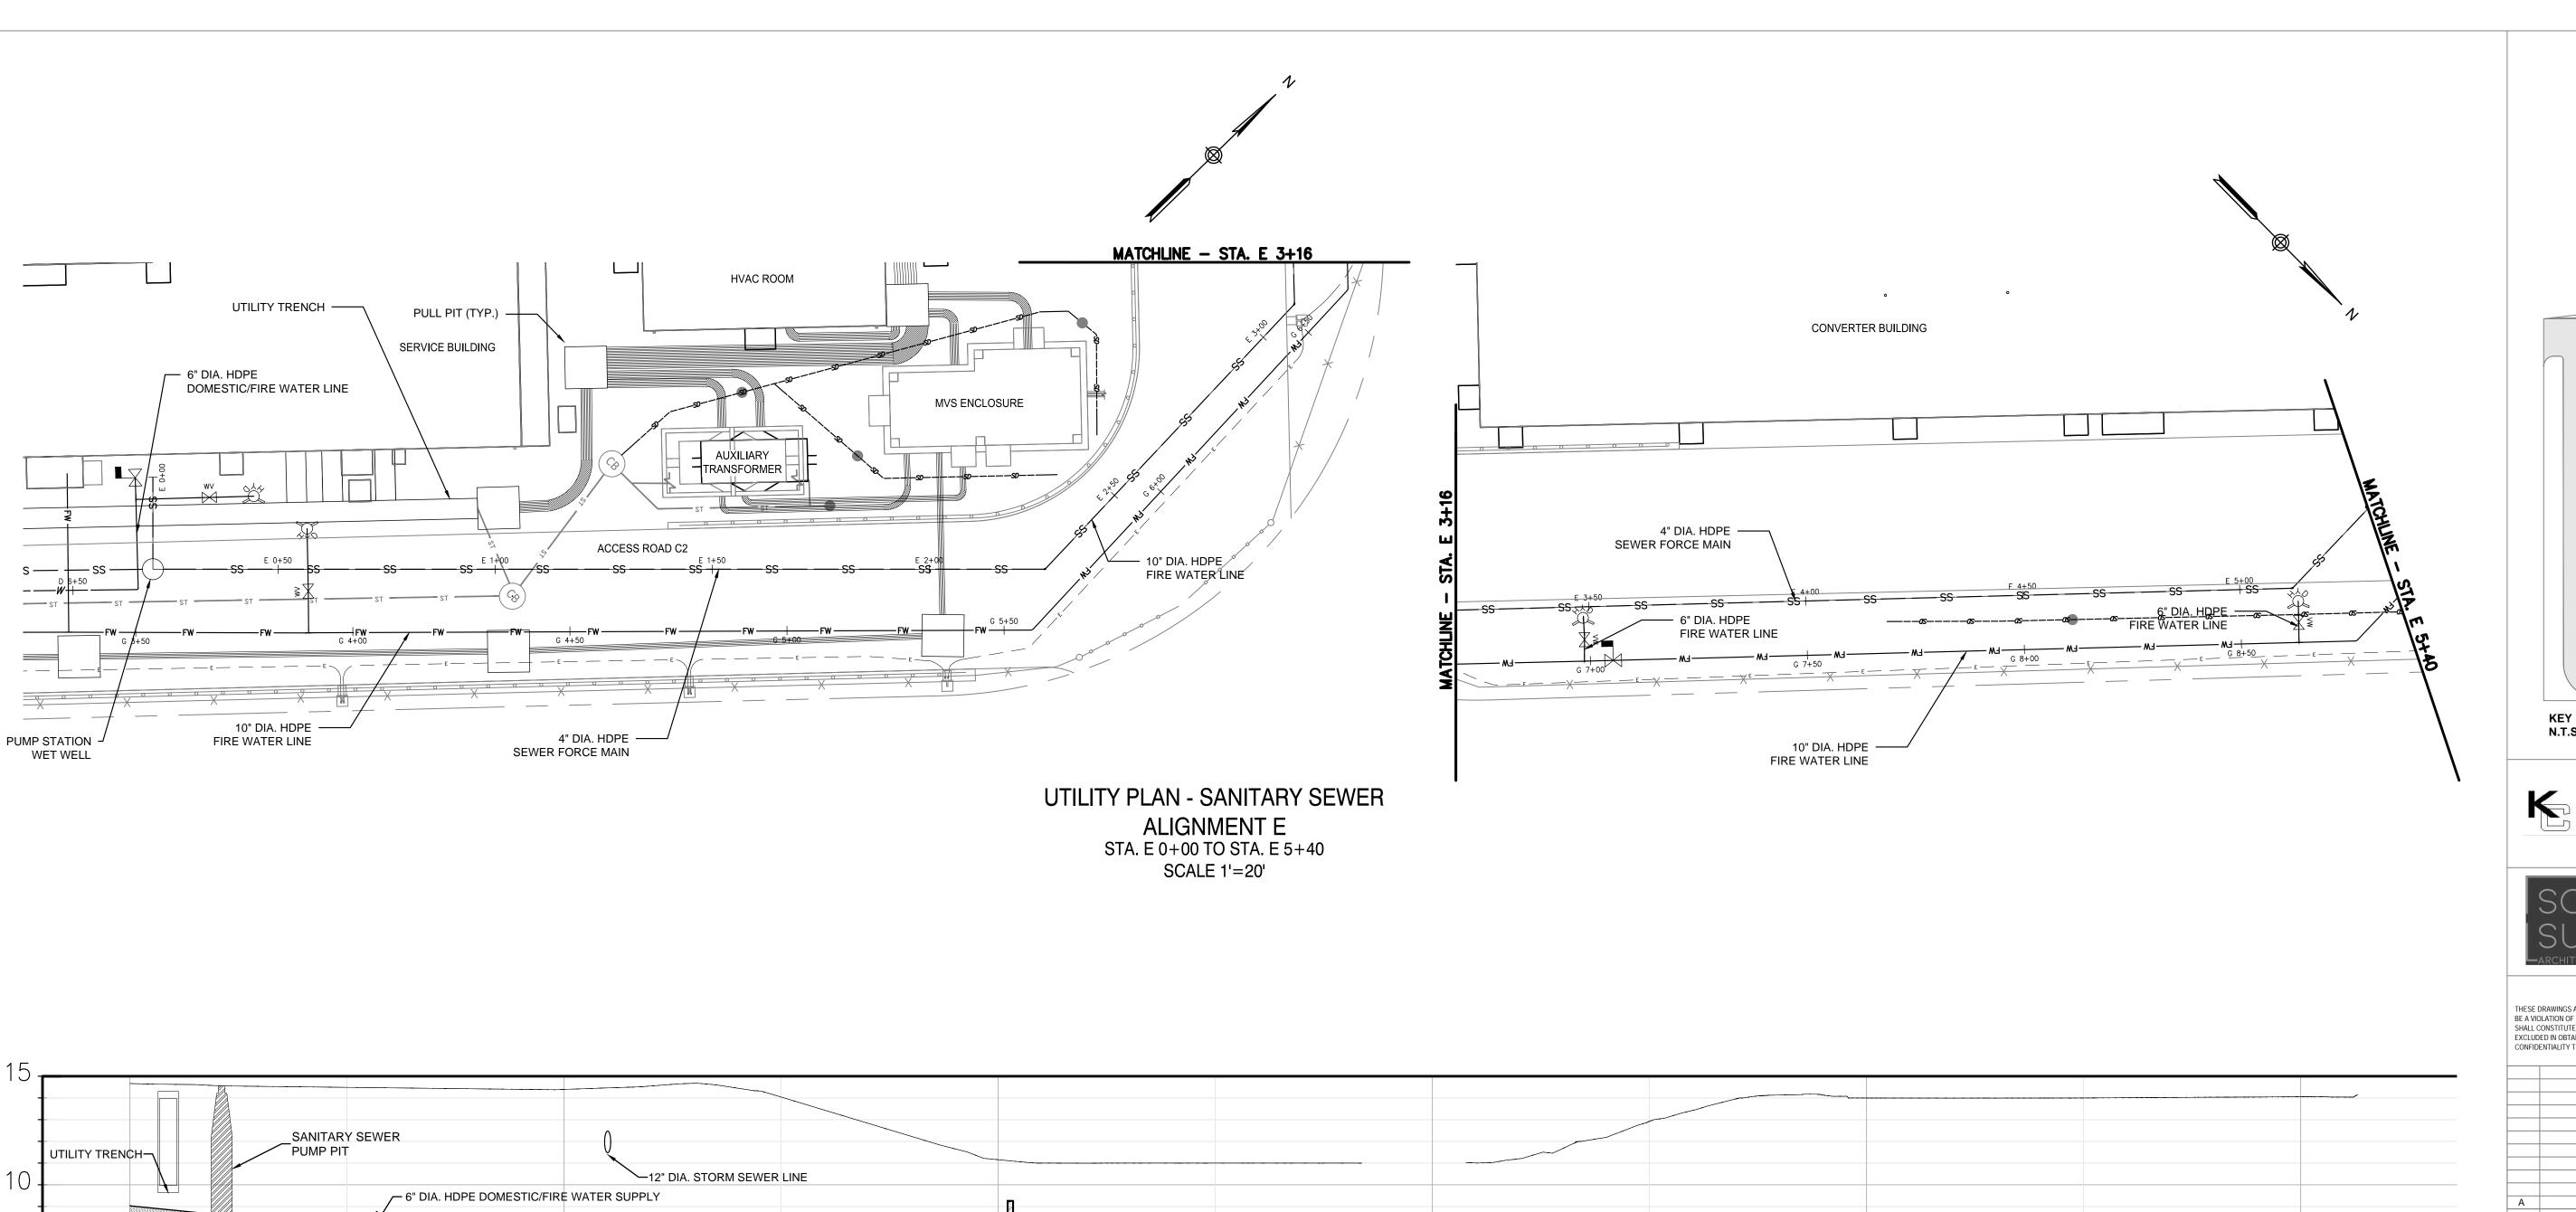
UTILITY PROFILE - 3

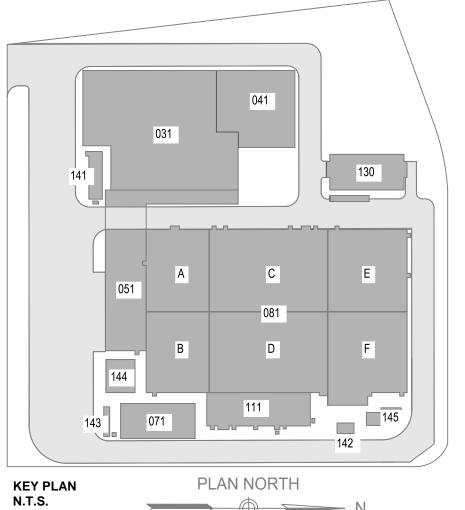



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PROJECT NO	105121
DRAWING BY	A. TRACEY
CHECKED BY	C. VALLABH
DRAWING NO	


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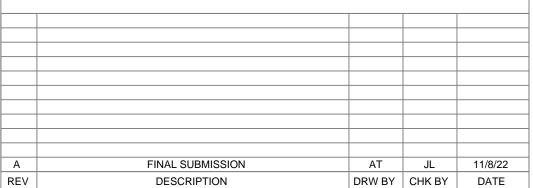
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470 Chestnut Ridge Rd # 2, Woodcliff Lake, NJ 07677

Raleigh, North Carolina 27606

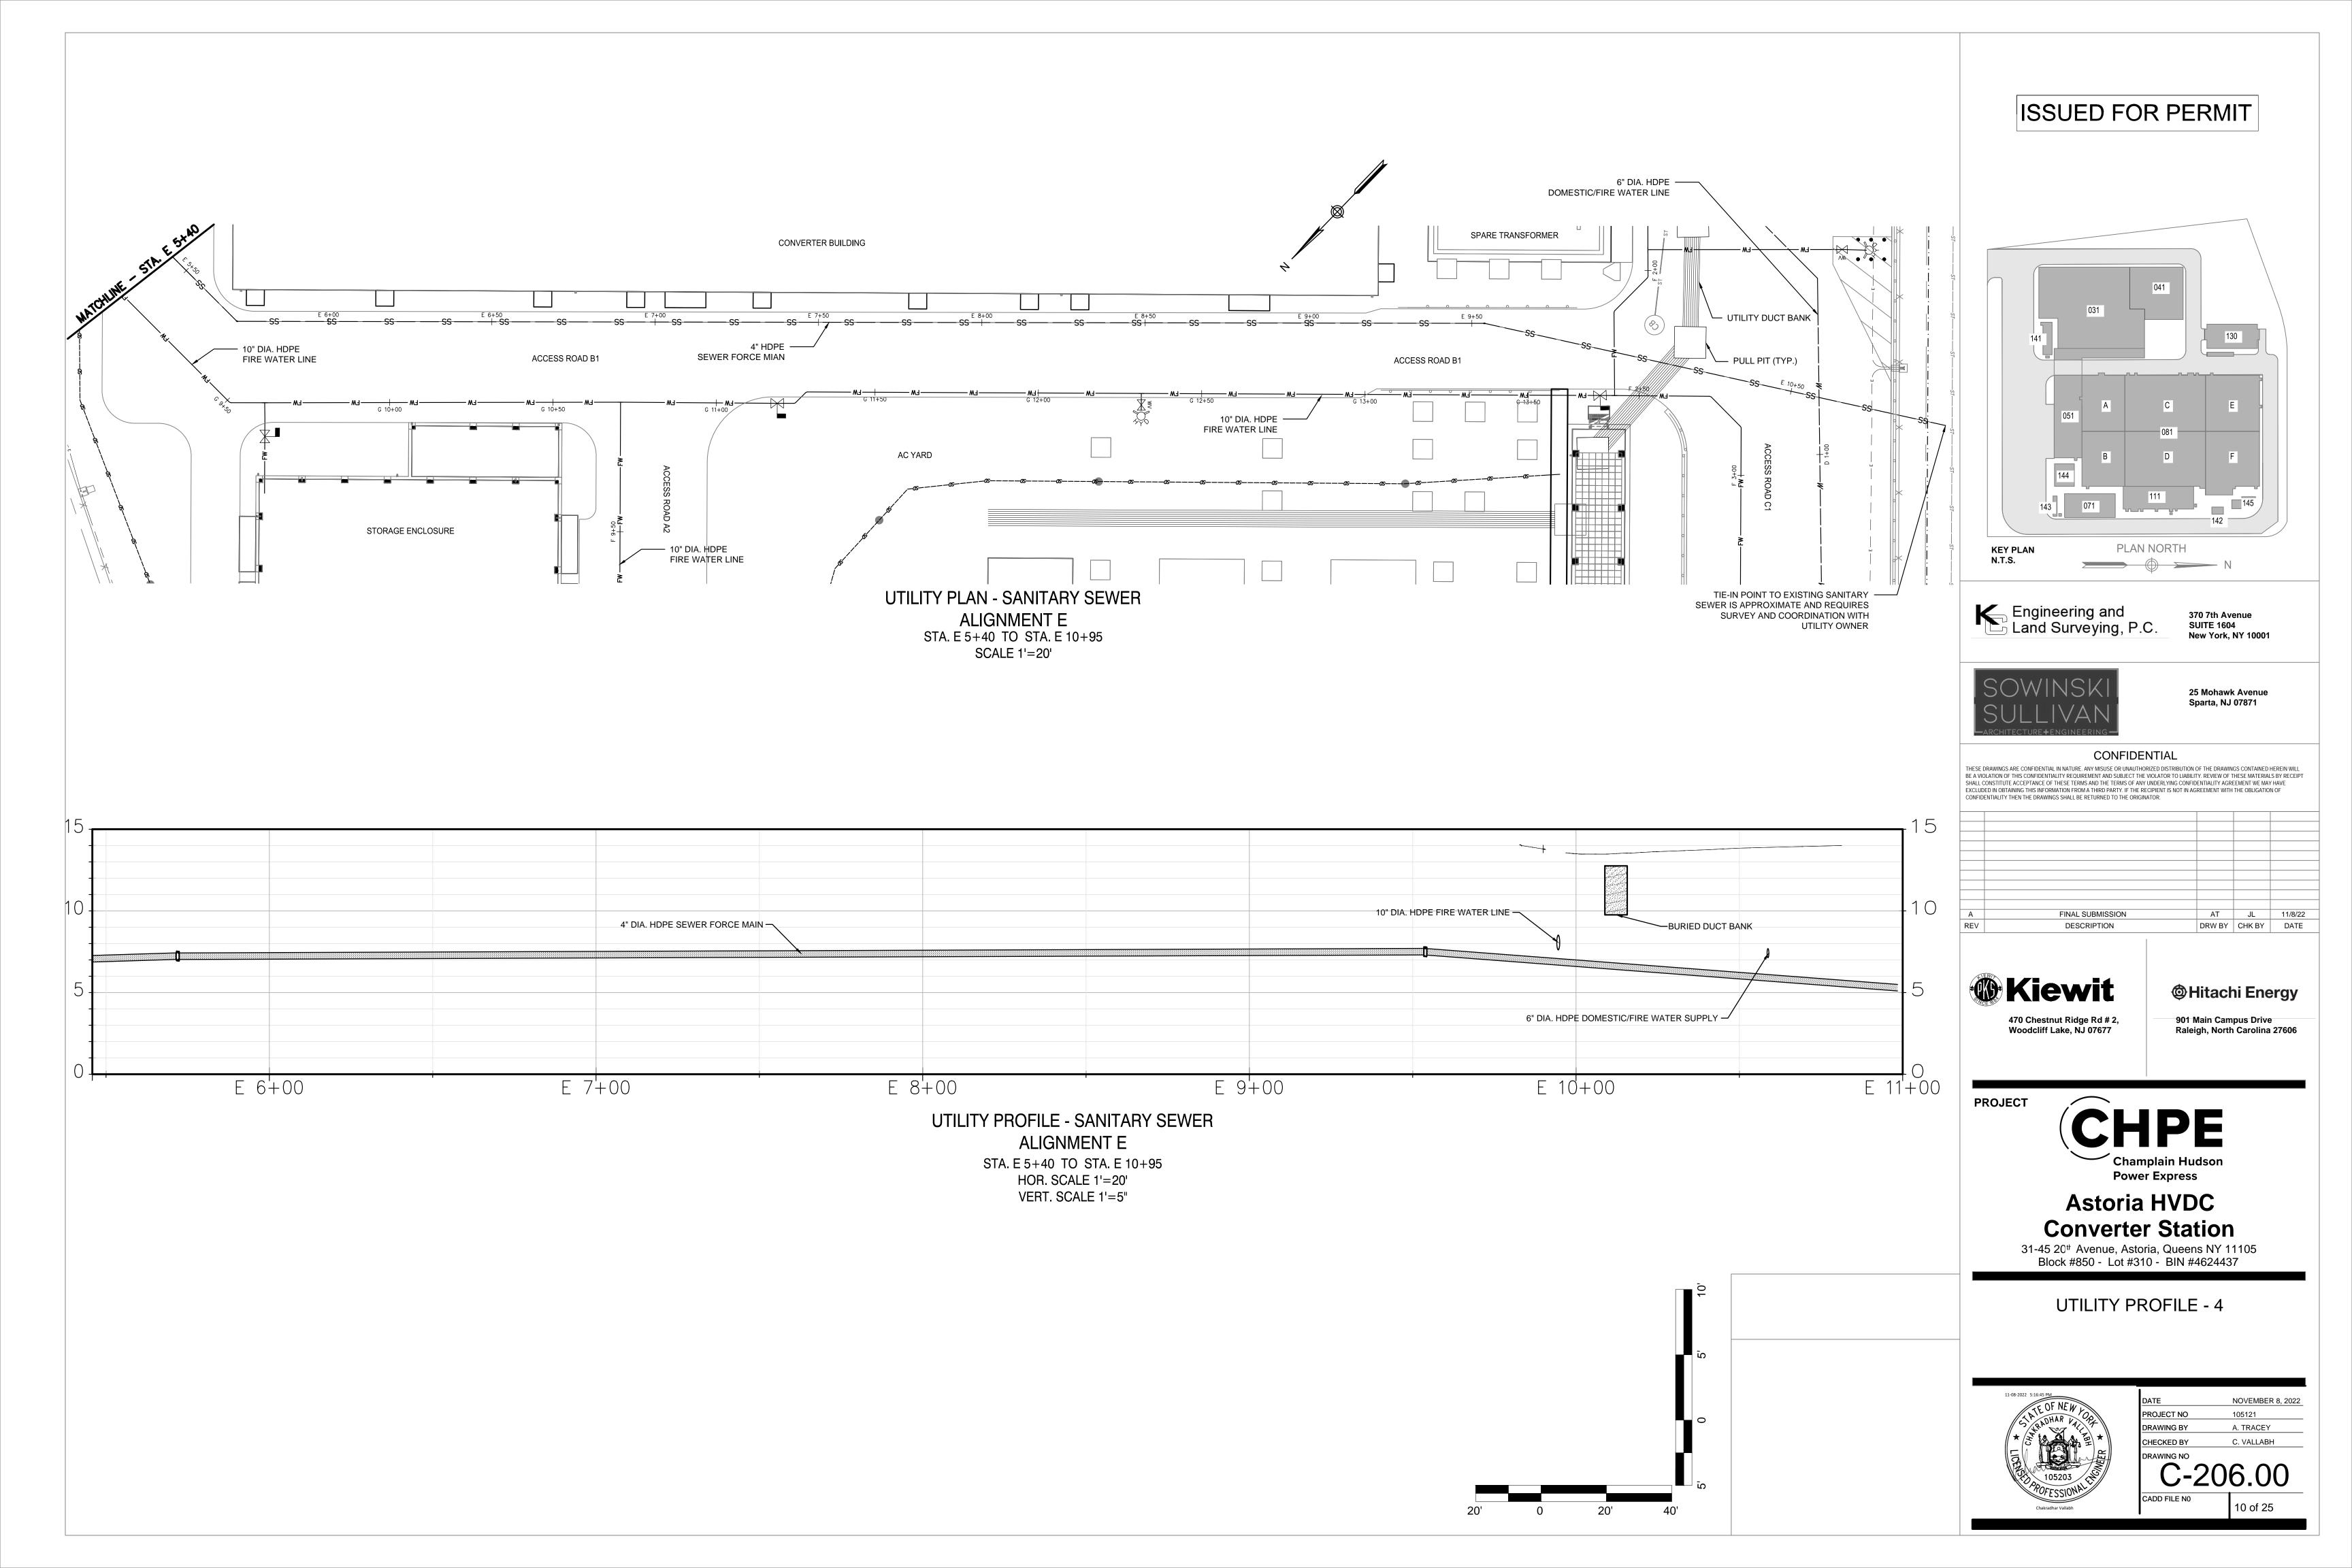PROJECT

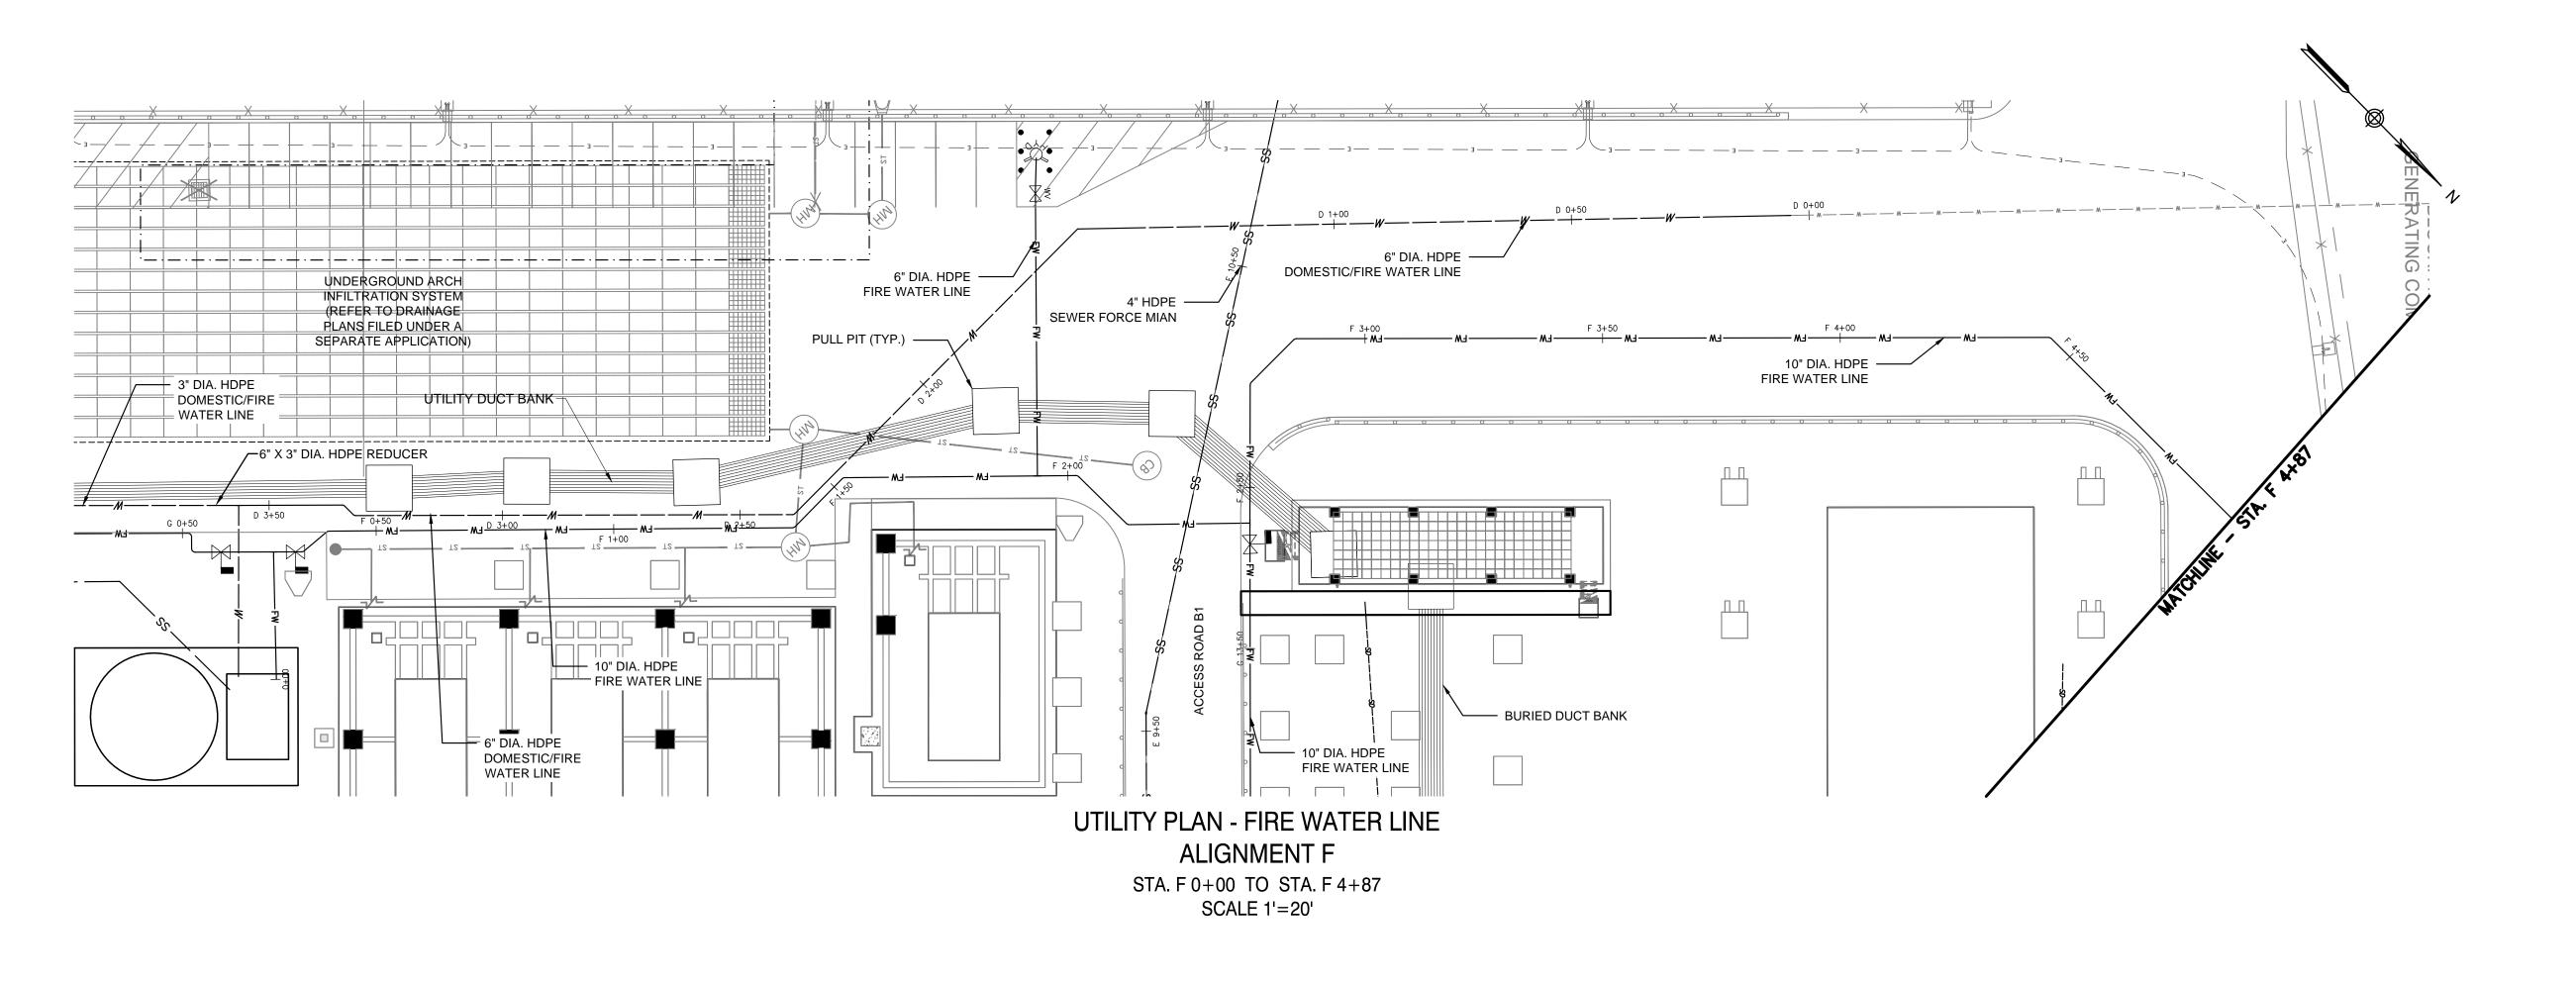

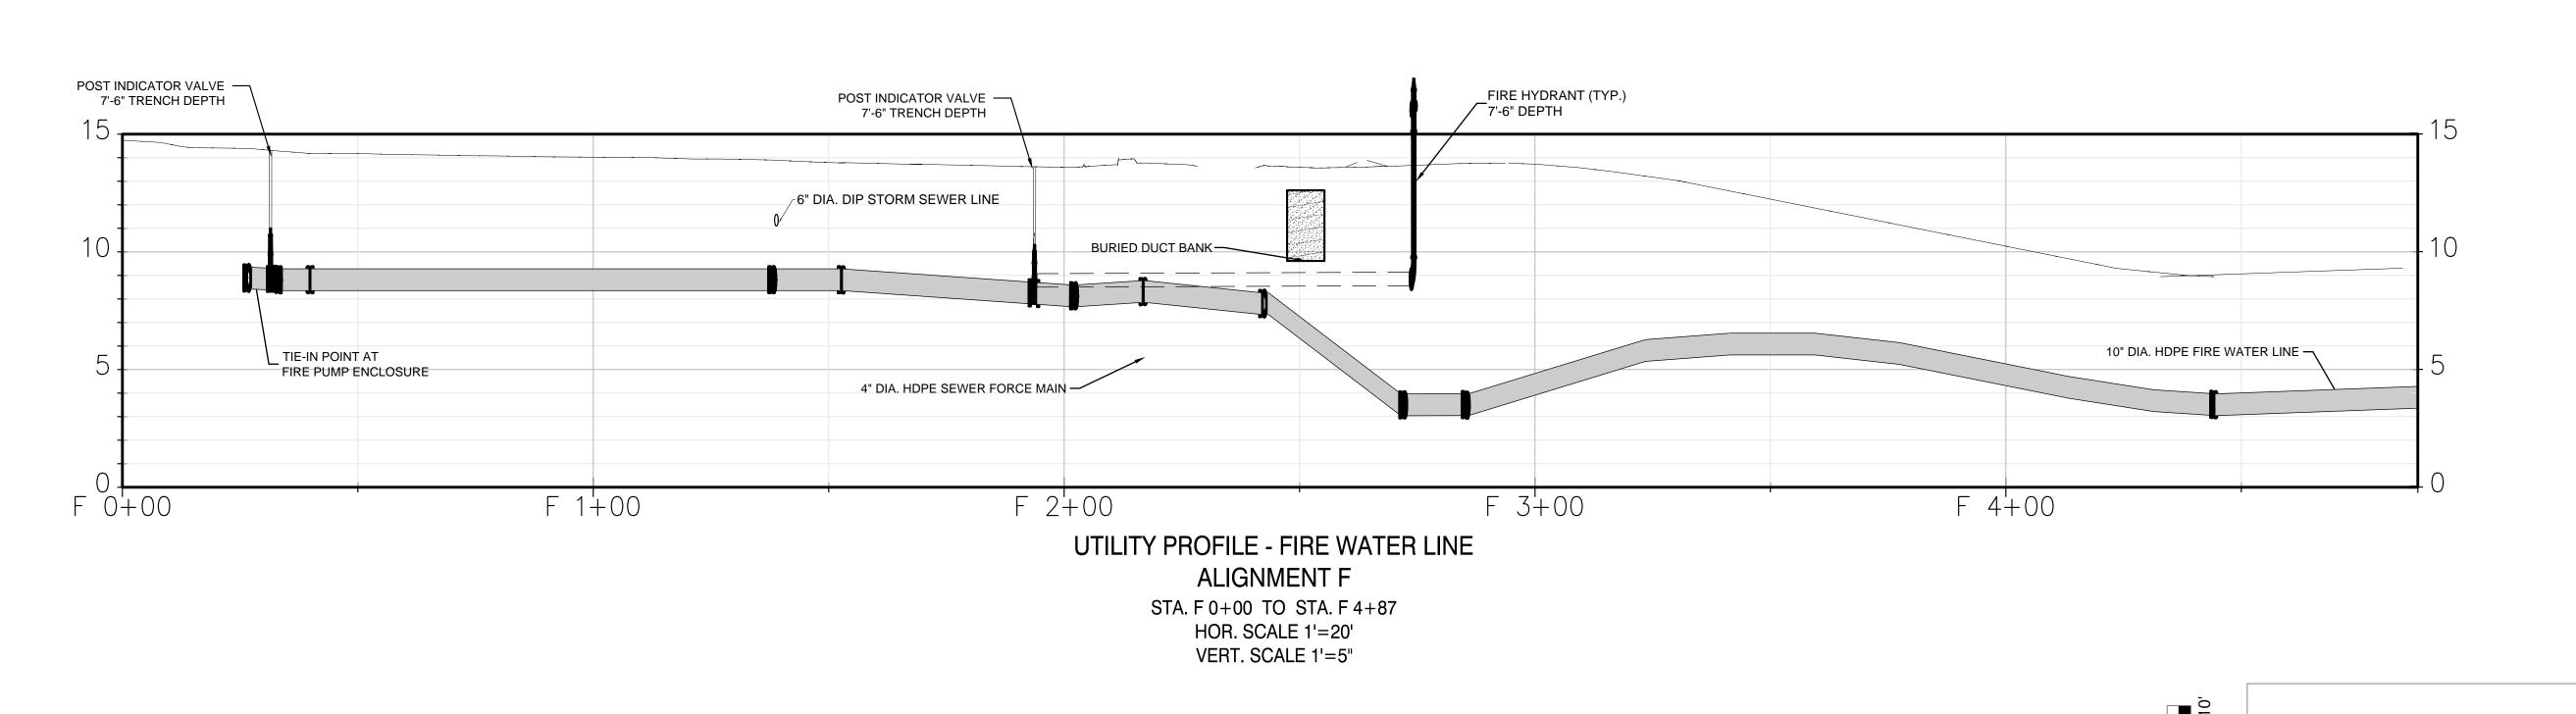Astoria HVDC Converter Station

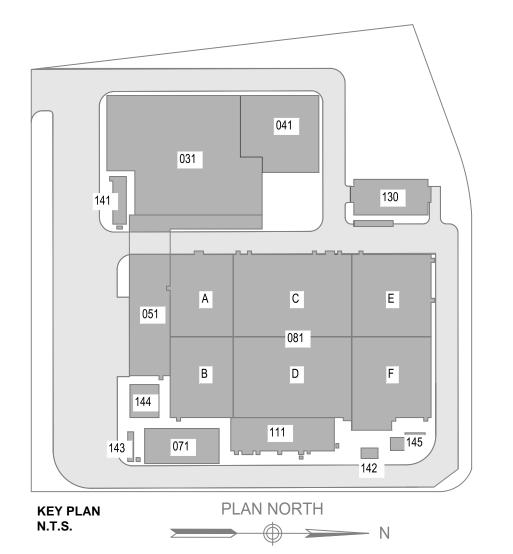31-45 20th Avenue, Astoria, Queens NY 11105 Block #850 - Lot #310 - BIN #4624437


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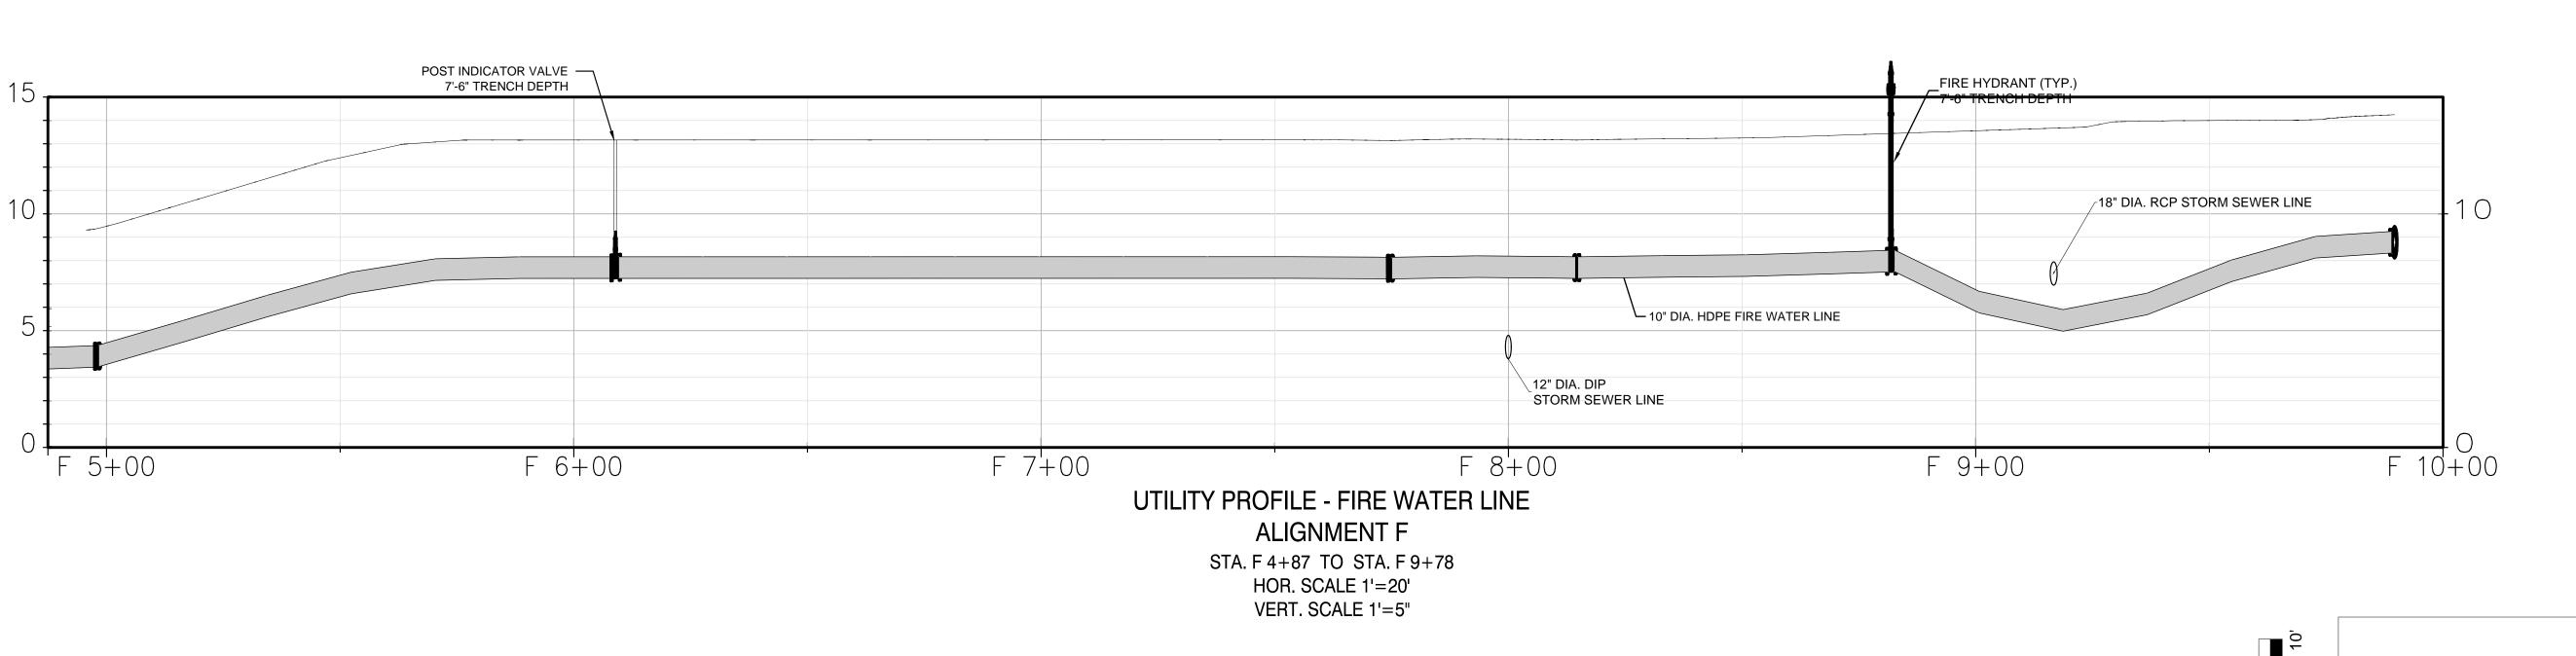



DATE NOVEMBER 8, 2022
PROJECT NO 105121
DRAWING BY A. TRACEY
CHECKED BY C. VALLABH


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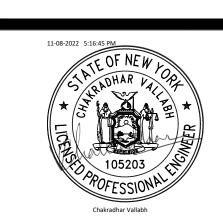
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Astoria HVDC Converter Station

31-45 20th Avenue, Astoria, Queens NY 11105 Block #850 - Lot #310 - BIN #4624437


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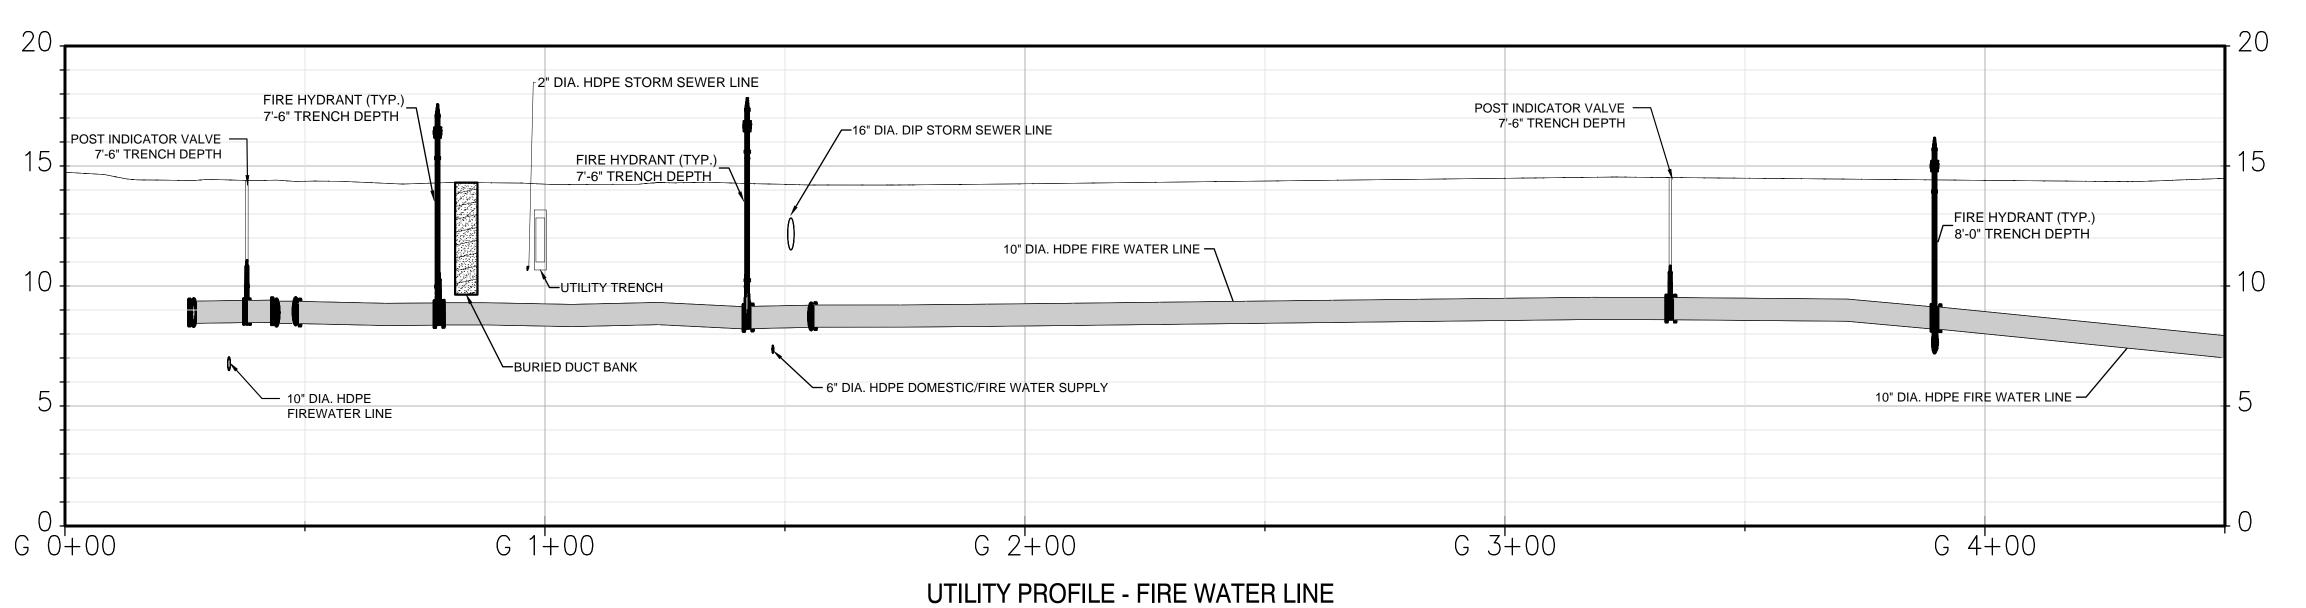

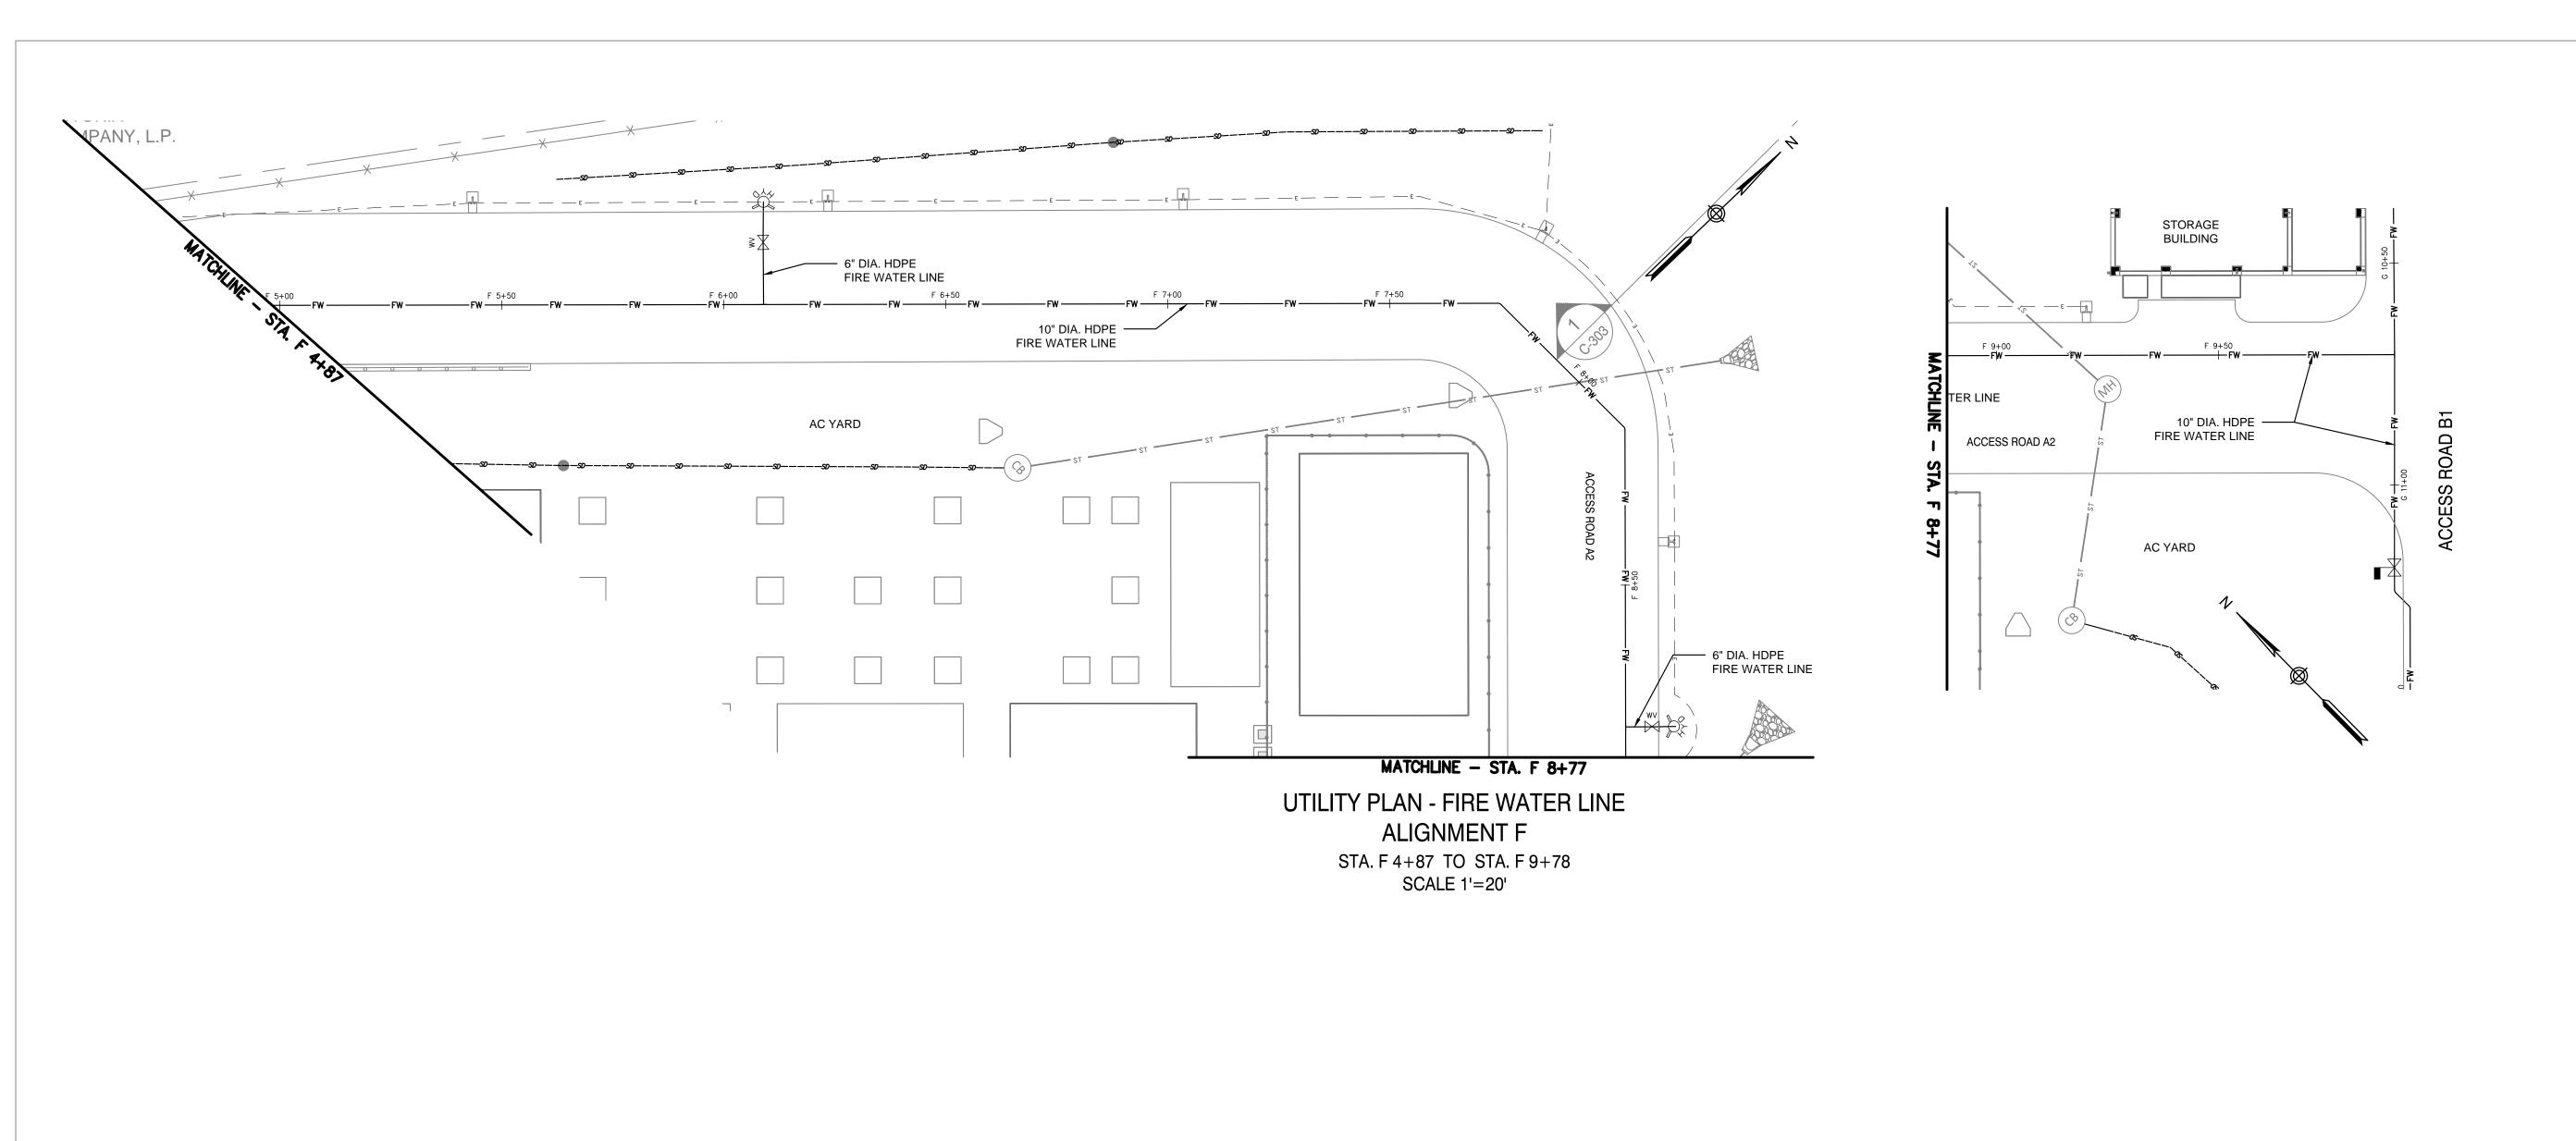
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	DATE	NOVEMBER 8, 2022
	PROJECT NO	105121
	DRAWING BY	A. TRACEY
	CHECKED BY	C. VALLABH

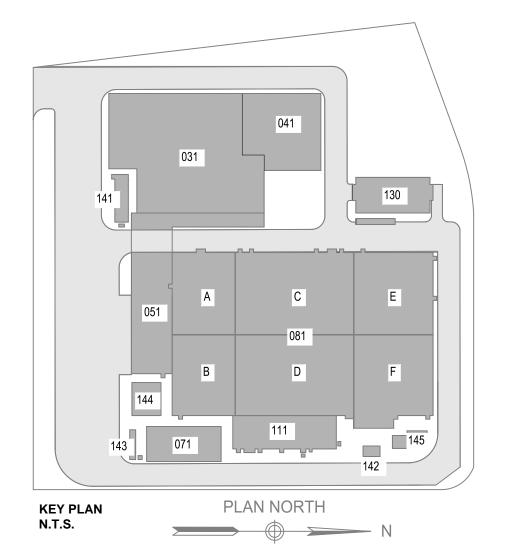C-208.00

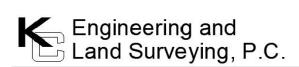
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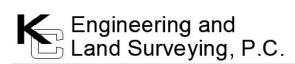


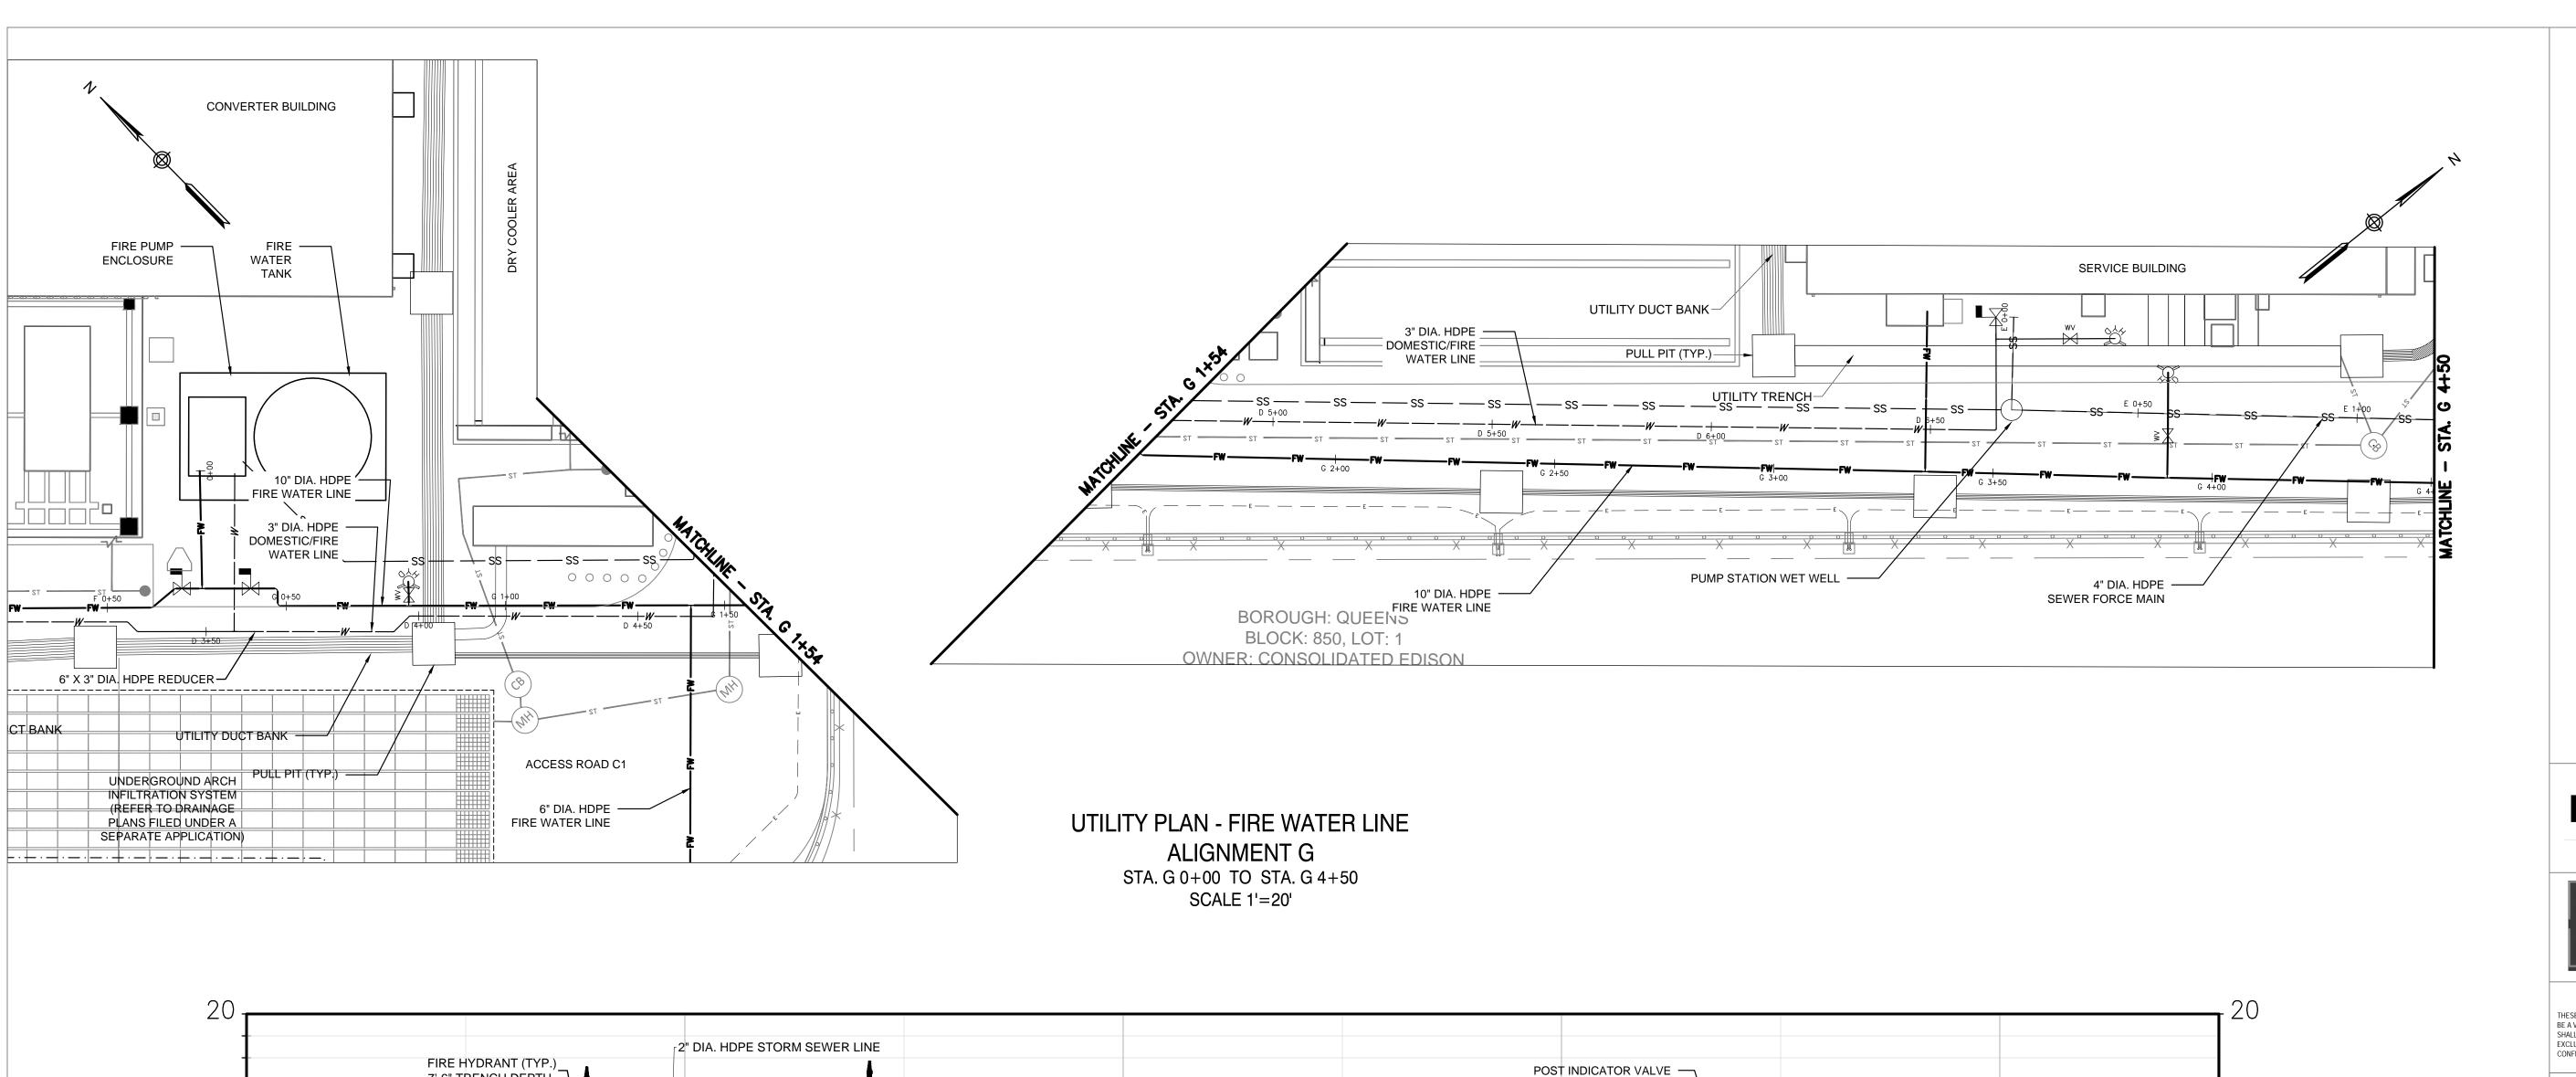

ALIGNMENT G STA. G 0+00 TO STA. G 4+50 HOR. SCALE 1'=20' VERT. SCALE 1'=5"

ISSUED FOR PERMIT



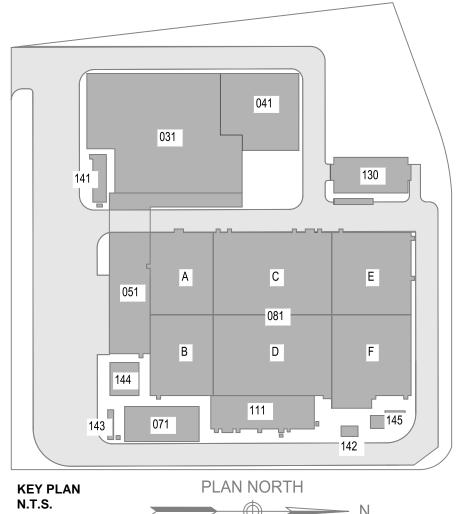


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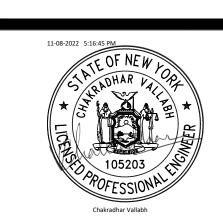
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Astoria HVDC Converter Station


31-45 20th Avenue, Astoria, Queens NY 11105 Block #850 - Lot #310 - BIN #4624437


UTILITY PROFILE - 7




DATE	NOVEMBER 8, 2022
PROJECT NO	105121
DRAWING BY	A. TRACEY
CHECKED BY	C. VALLABH
DRAWING NO	

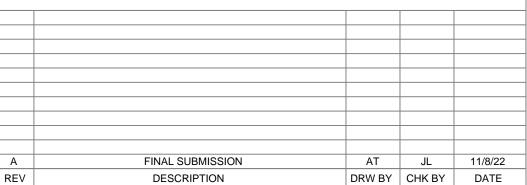C-209.00 13 of 25

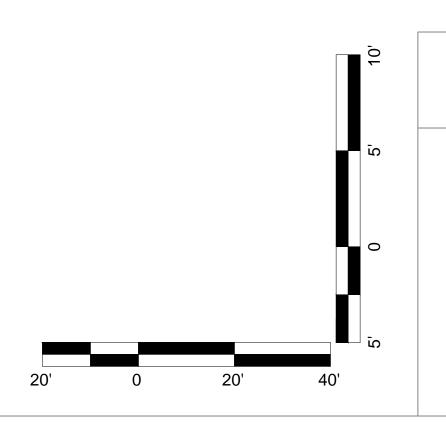

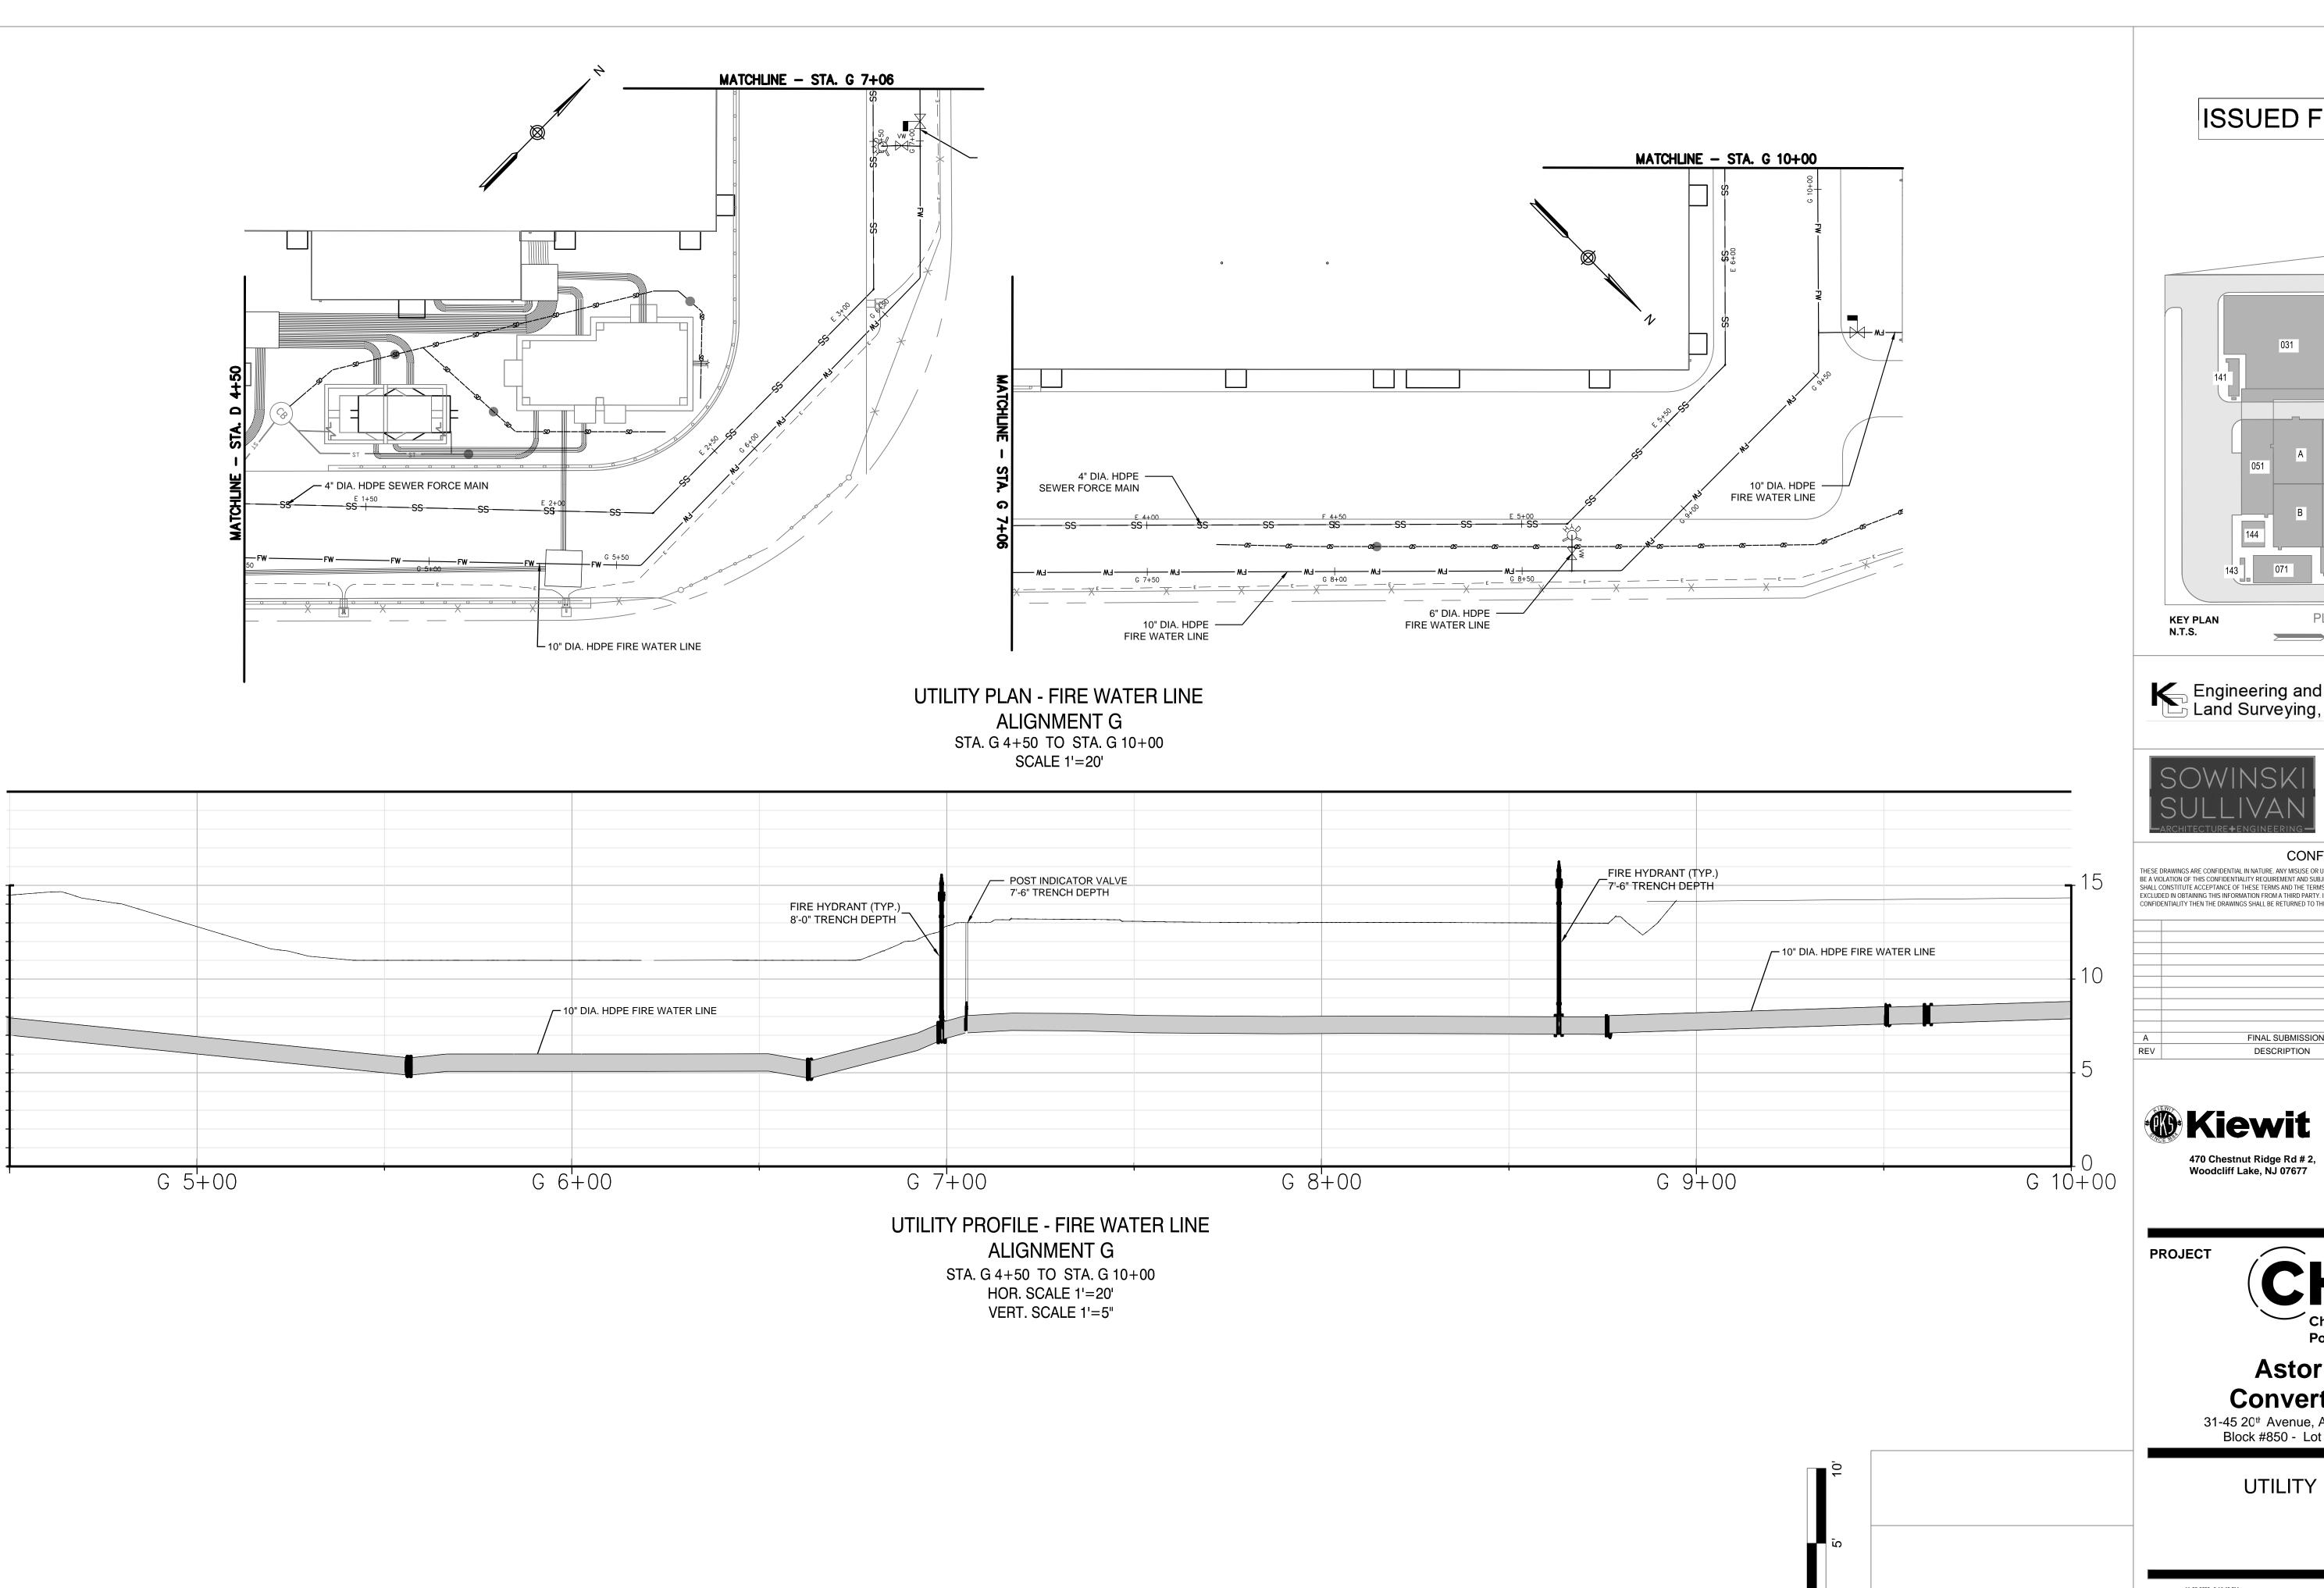

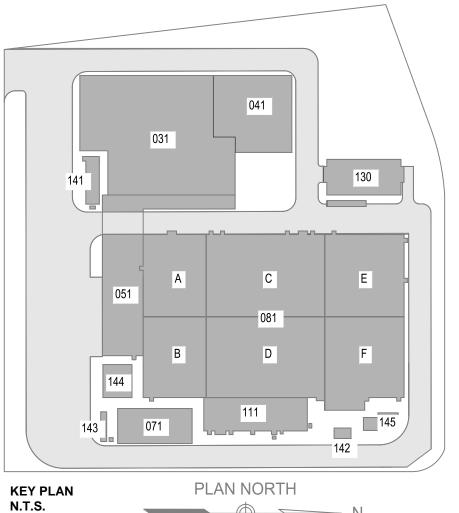

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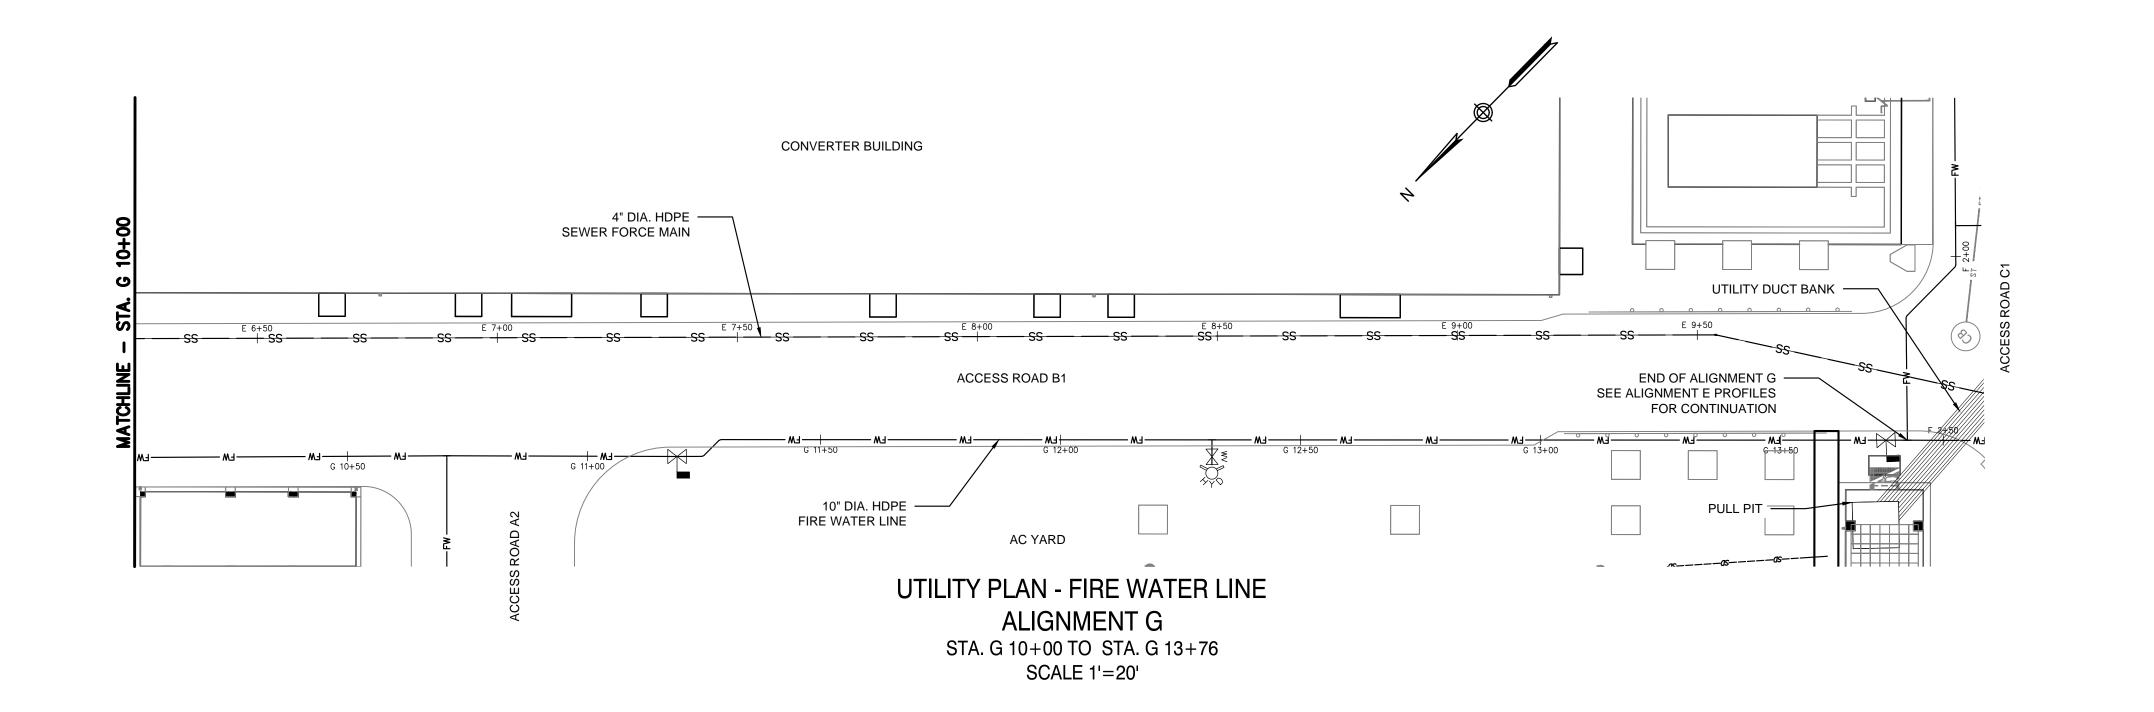
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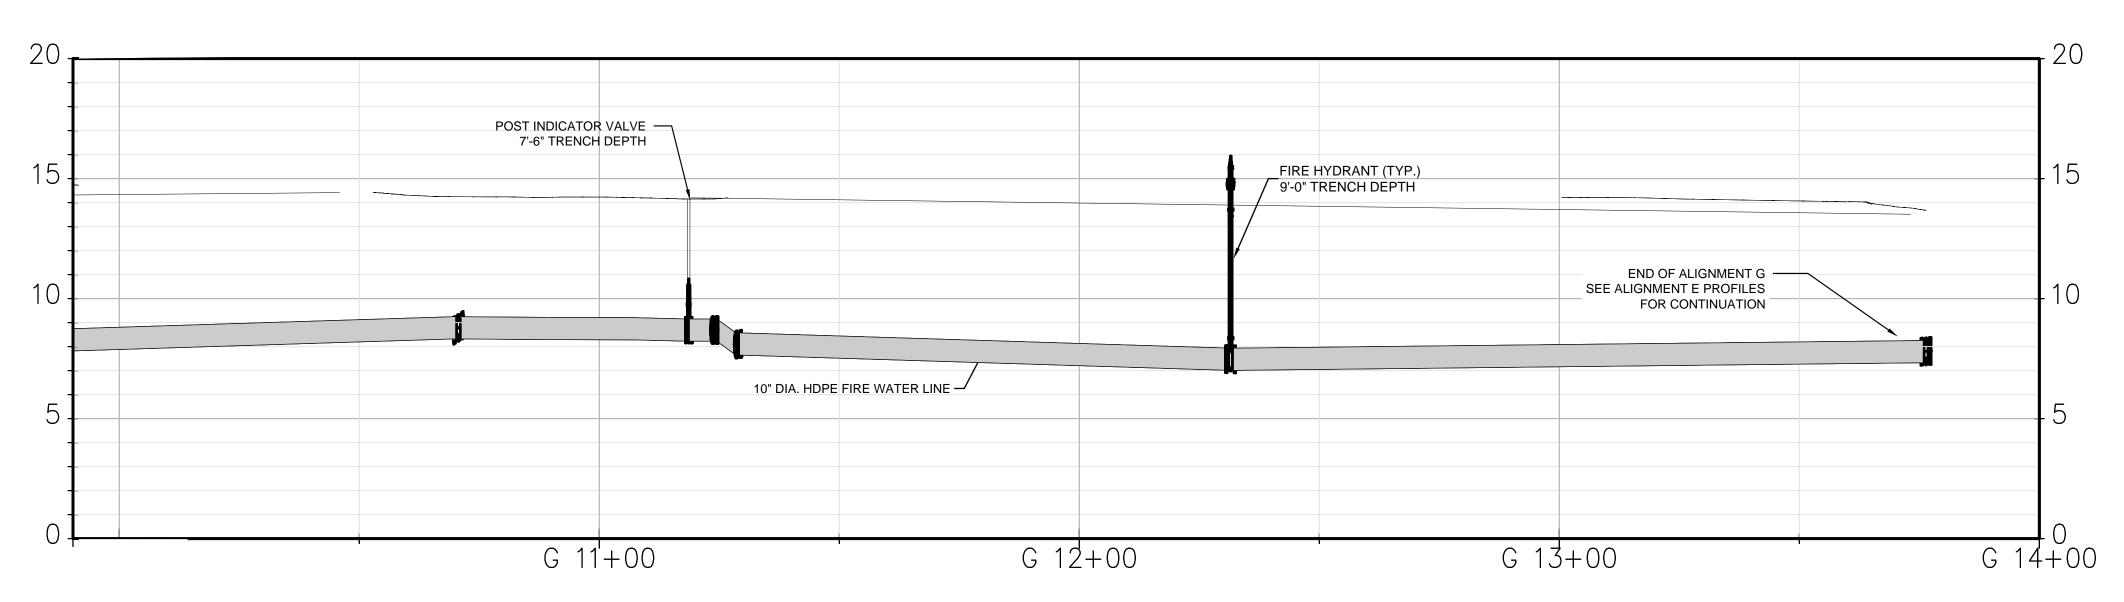
UTILITY PROFILE - 8



DATE	NOVEMBER 8, 2022
PROJECT NO	105121
DRAWING BY	A. TRACEY
CHECKED BY	C. VALLABH

C-210.00






UTILITY PROFILE - FIRE WATER LINE

ALIGNMENT G STA. G 4+50 TO STA. G 13+76

HOR. SCALE 1'=20' VERT. SCALE 1'=5"

ISSUED FOR PERMIT

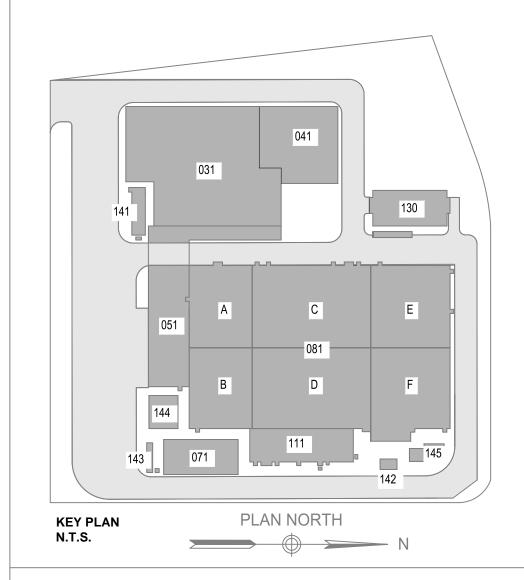



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AT JL 11/8/22

DRW BY CHK BY DATE FINAL SUBMISSION DESCRIPTION



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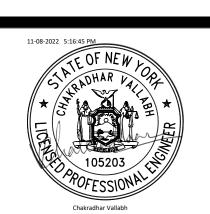
PROJECT



Astoria HVDC Converter Station


31-45 20th Avenue, Astoria, Queens NY 11105 Block #850 - Lot #310 - BIN #4624437


UTILITY PROFILE - 9



DATE	NOVEMBER 8, 20	122
PROJECT NO	105121	,,,,
DRAWING BY	A. TRACEY	
CHECKED BY	C. VALLABH	
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Α	INTERIM SUBMISSION	SC	CV	8/29/22
REV	DESCRIPTION	DRW BY	CHK BY	DATE

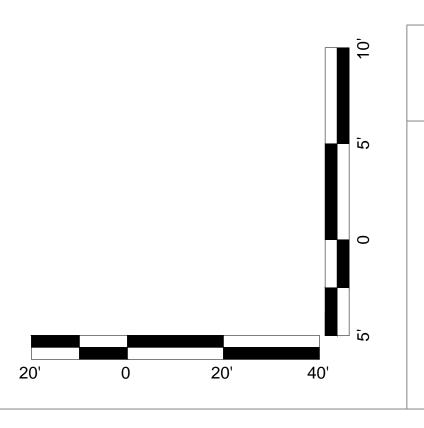

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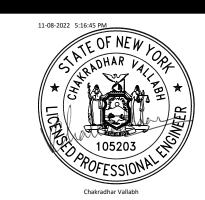
PROJECT

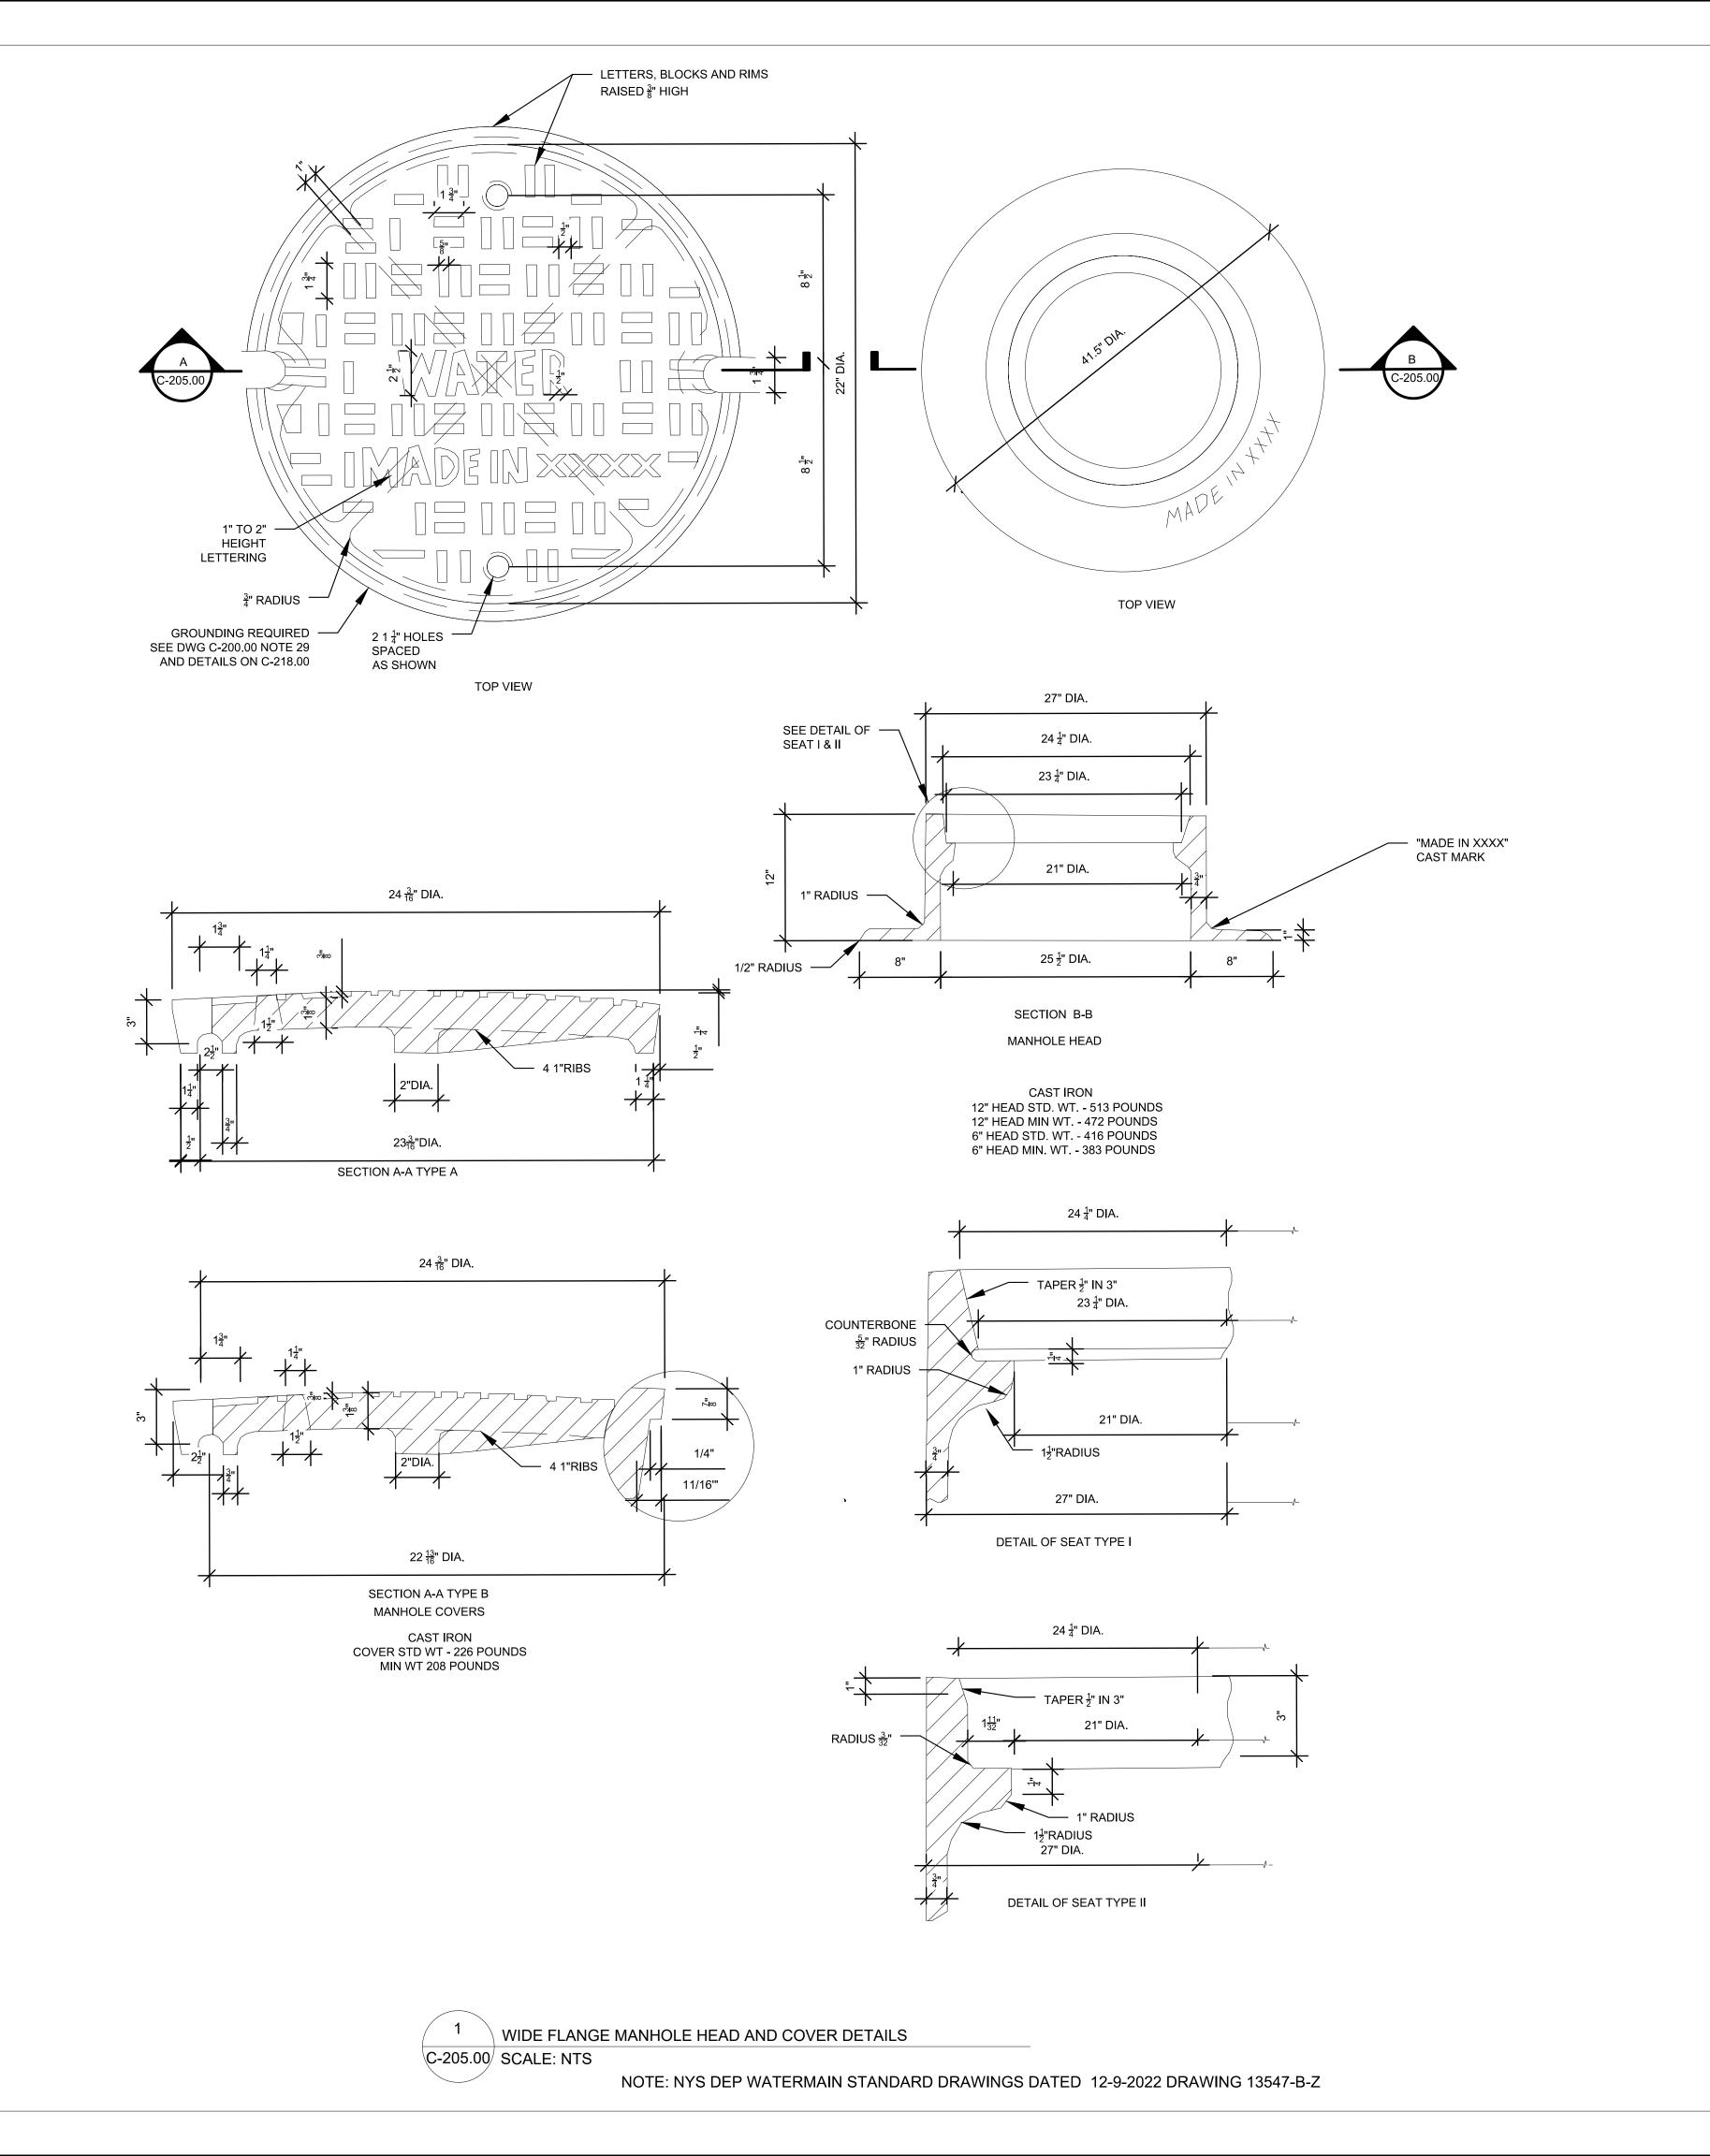

Astoria HVDC Converter Station

31-45 20th Avenue, Astoria, Queens NY 11105 Block #850 - Lot #310 - BIN #4624437

UTILITY DETAILS 1
WATER MAIN MANHOLE
FRAME AND COVER




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DATE	NOVEMBER 8, 2022
PROJECT NO	105121
DRAWING BY	S. CASH
CHECKED BY	C. VALLABH
DRAWING NO	

C-212.00

16 of 25

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Engineering and Land Surveying, P.C.
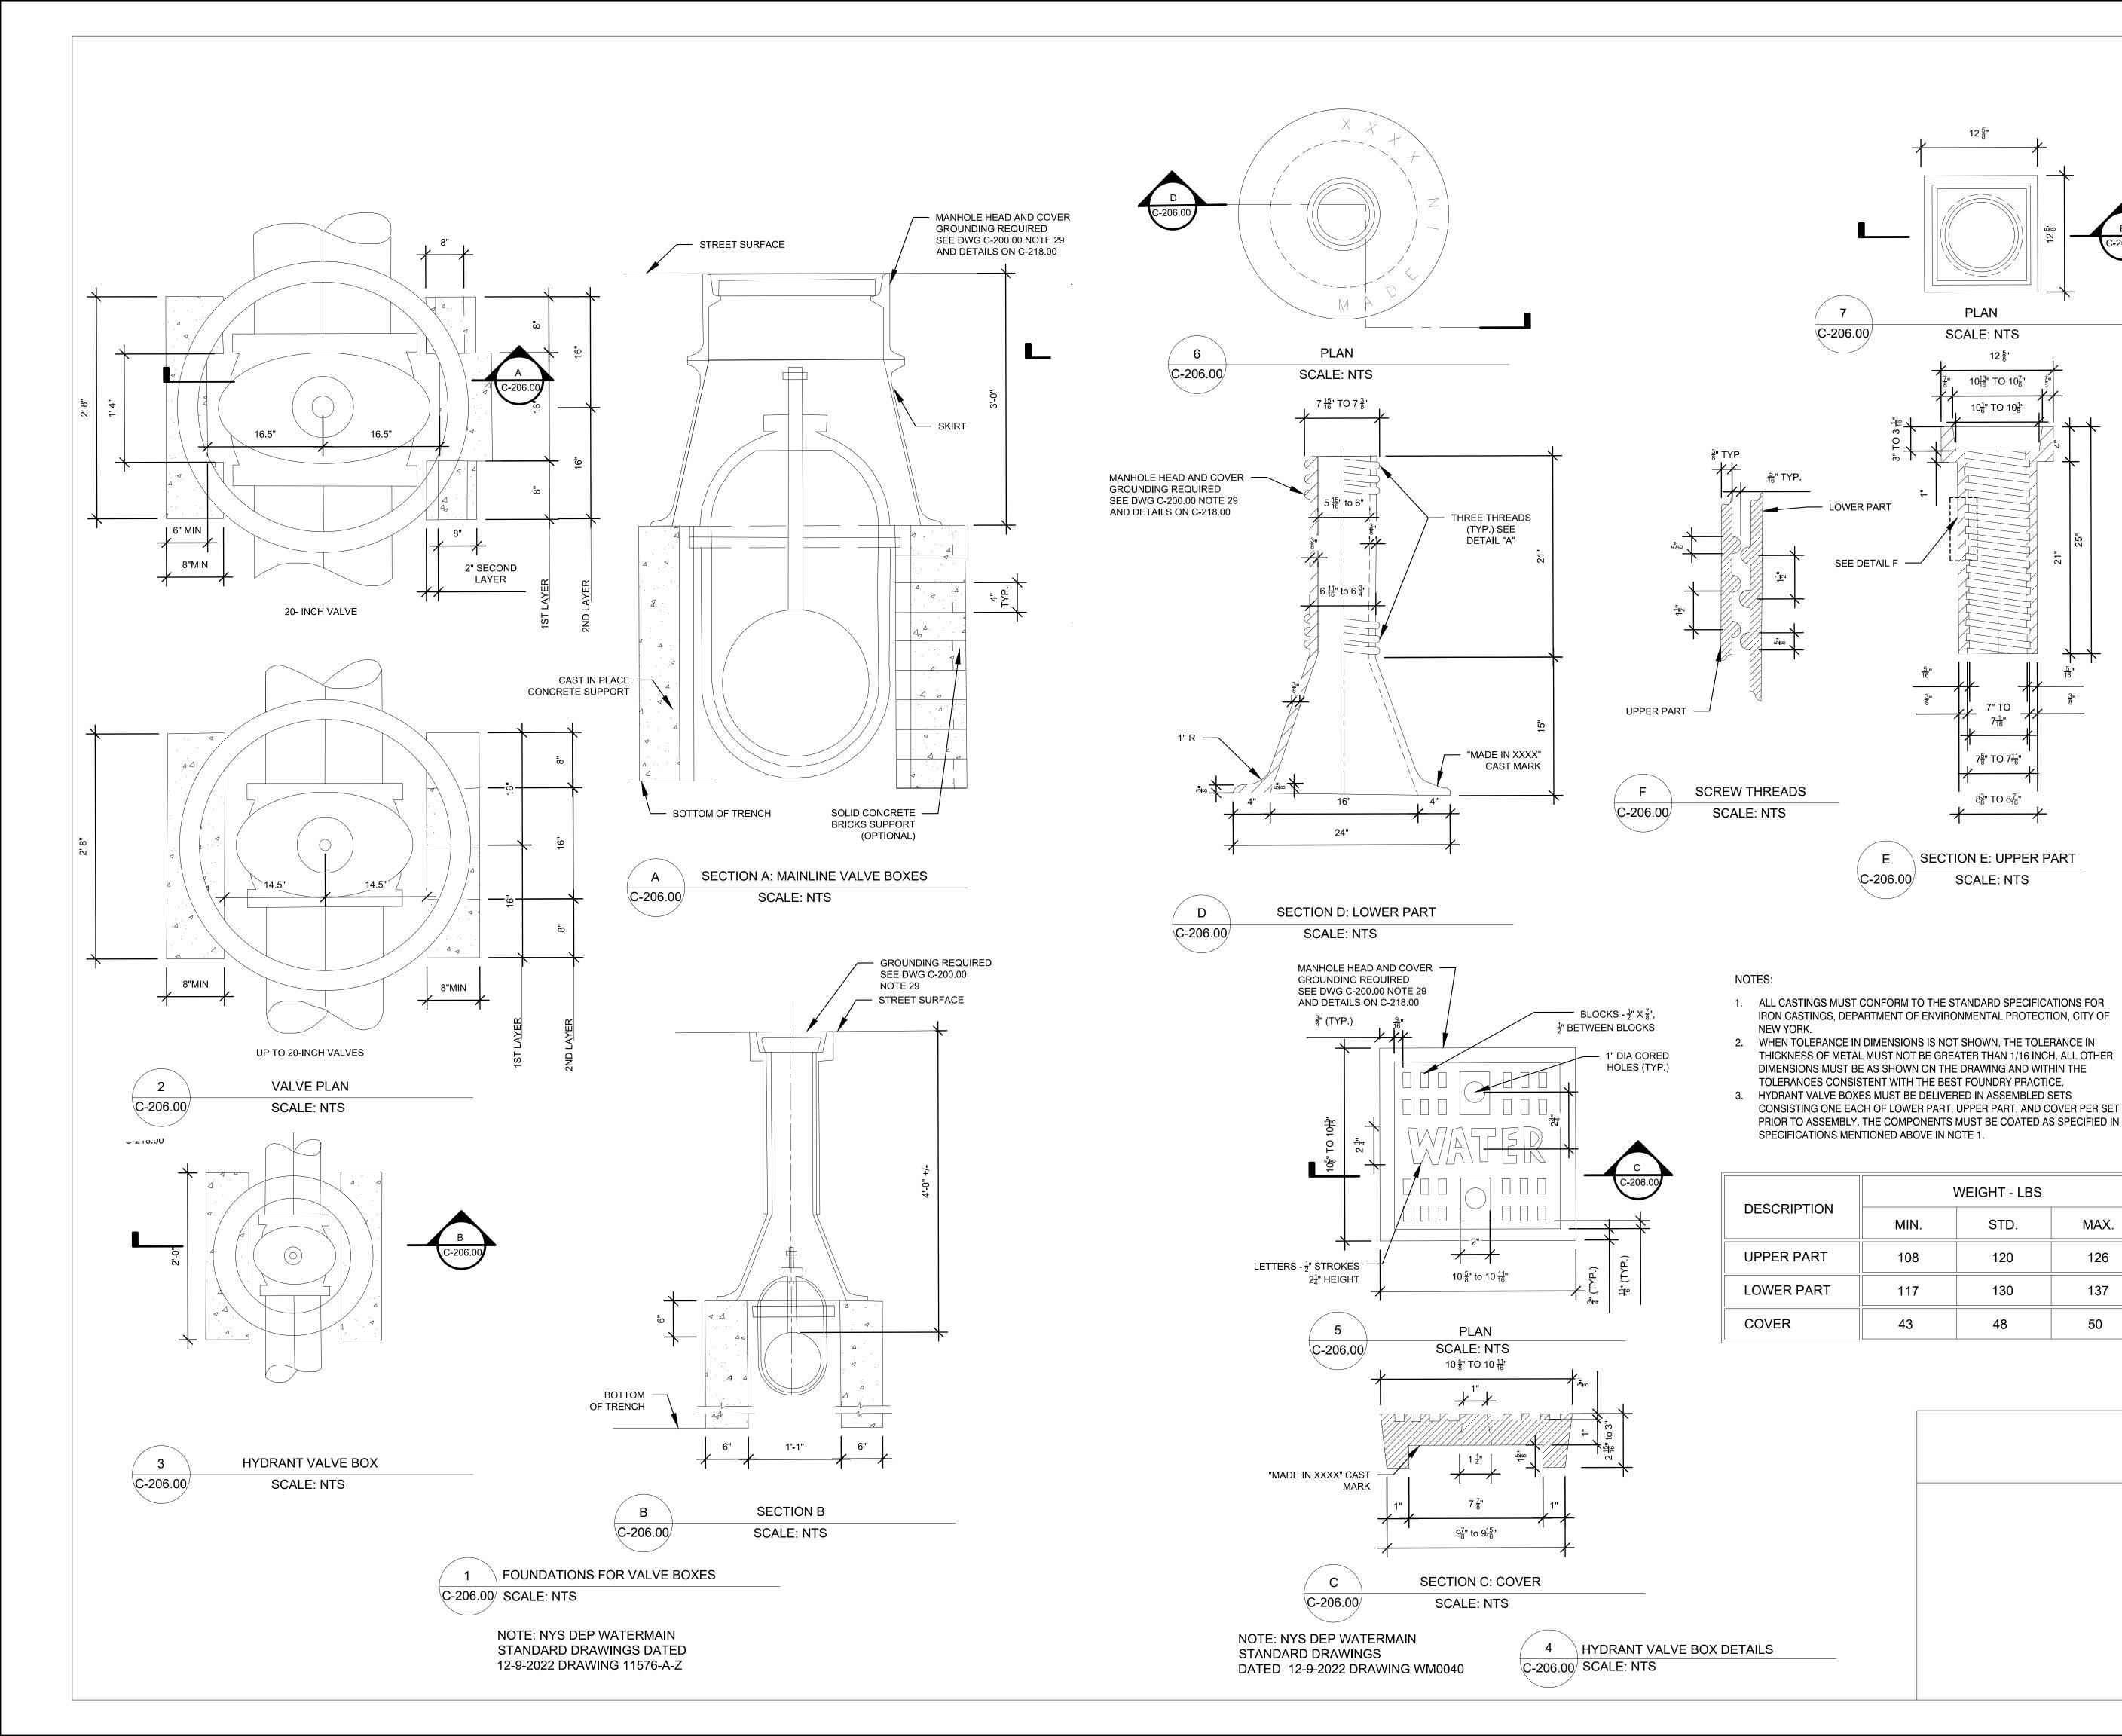
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Α	INTERIM SUBMISSION	sc	CV	8/29/22
В	FINAL SUBMISSION	SC	CV	11/8/22



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PROJECT




Astoria HVDC Converter Station

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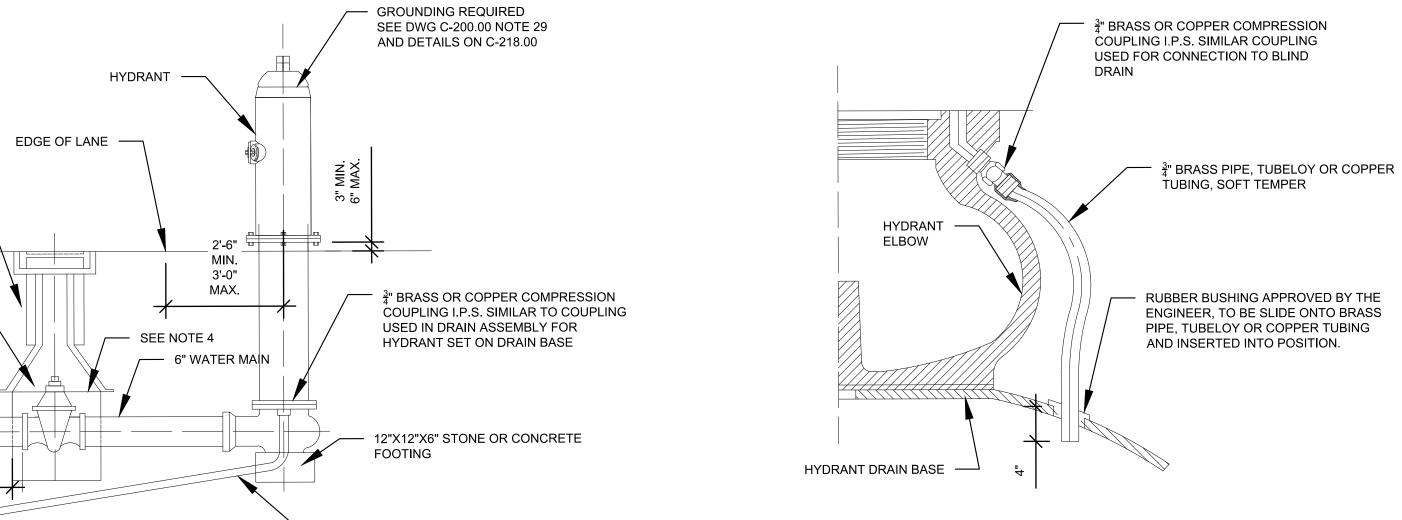
Block #850 - Lot #310 - BIN #4624437


UTILITY DETAILS 2
WATER MAIN VALVE
DETAILS

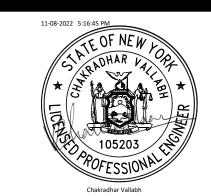

DATE	November 8, 2022
PROJECT NO	105121
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DRAWING NO	
C-21	3.00


ADD FILE NO



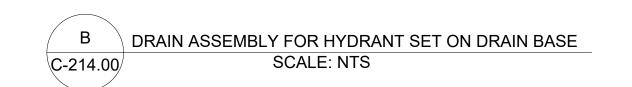


NOTES:

- 1. HYDRANT DRAIN BASE MUST BE MADE IN ACCORDANCE WITH DEPARTMENT'S LATEST STANDARD SPECIFICATION FOR IRON CASTINGS.
- 2. LOCATION OF THE DOMED CAST IRON HYDRANT DRAIN IN METHOD-B TO BE
- AS DETERMINED BY THE ENGINEER.
- 3. THE DISTANCE OF THE HYDRANT VALVE SHALL BE WITHIN 20 FEET OF HYDRANT PER NPFA 24.
- 4. SELECT GRANULAR FILL MUST BE PROVIDED TO BACKFILL VOID SPACE FROM THE BOTTOM OF THE CONCRETE BLOCKS UP TO THE THE BOTTOM OF THE VALVE BOX SKIRT, IN LINE WITH THE TOP OF THE VALVE BOX FLANGE.

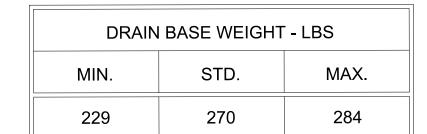



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RE\/	DESCRIPTION	DRW BY	CHK BY	DATE

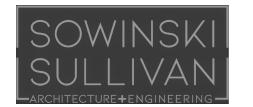

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PROJECT



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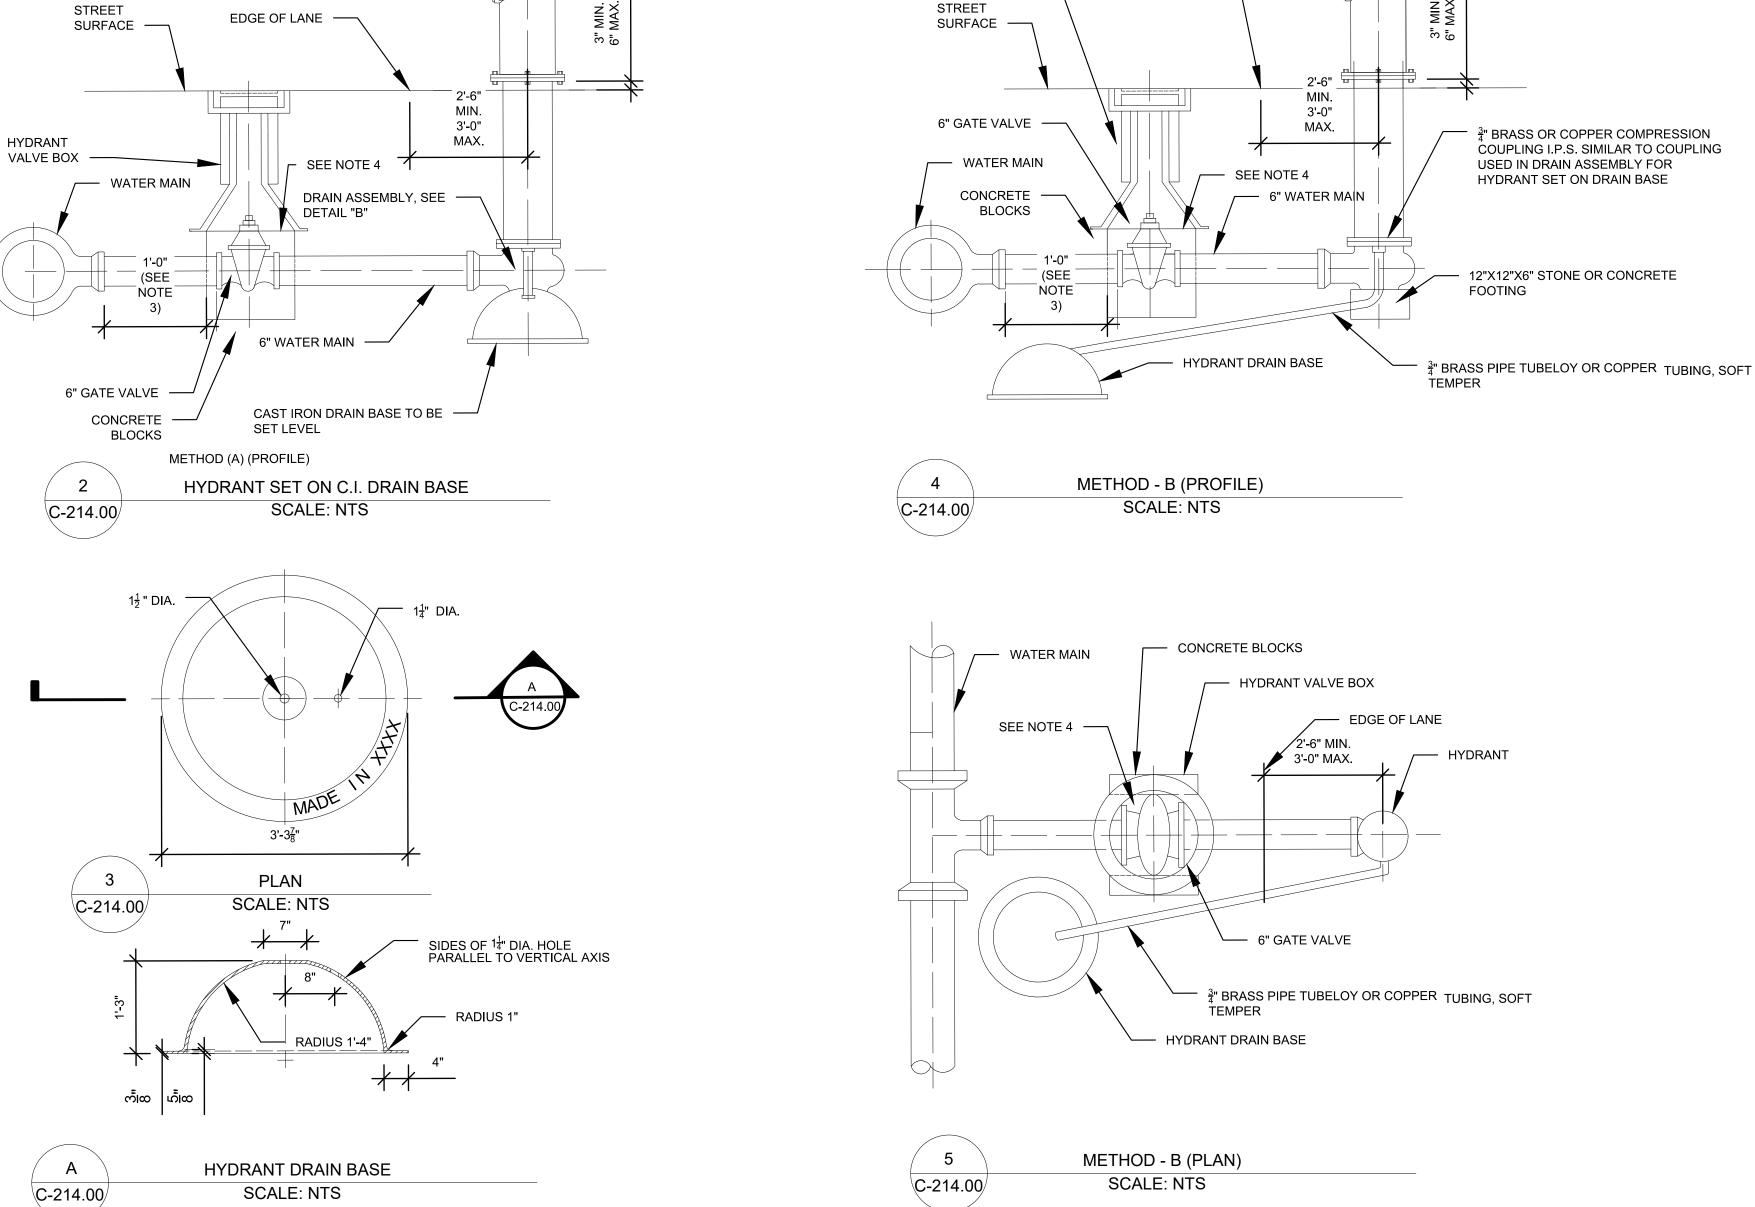
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> **UTILITY DETAILS 3 FIRE HYDRANT DETAILS**



November 8, 2022 S. CASH HECKED BY C. VALLABH

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HYDRANT VALVE вох —

STREET

- GROUNDING REQUIRED


HYDRANT

CENTER OF HOSE OUTLETS — 18"-36" ABOVE GRADE PER

NFPA 24


SEE DWG C-200.00 NOTE 29 AND DETAILS ON C-218.00

NOTE: NYS DEP WATERMAIN STANDARD DRAWINGS DATED 12-9-2020 DRAWING WM0020

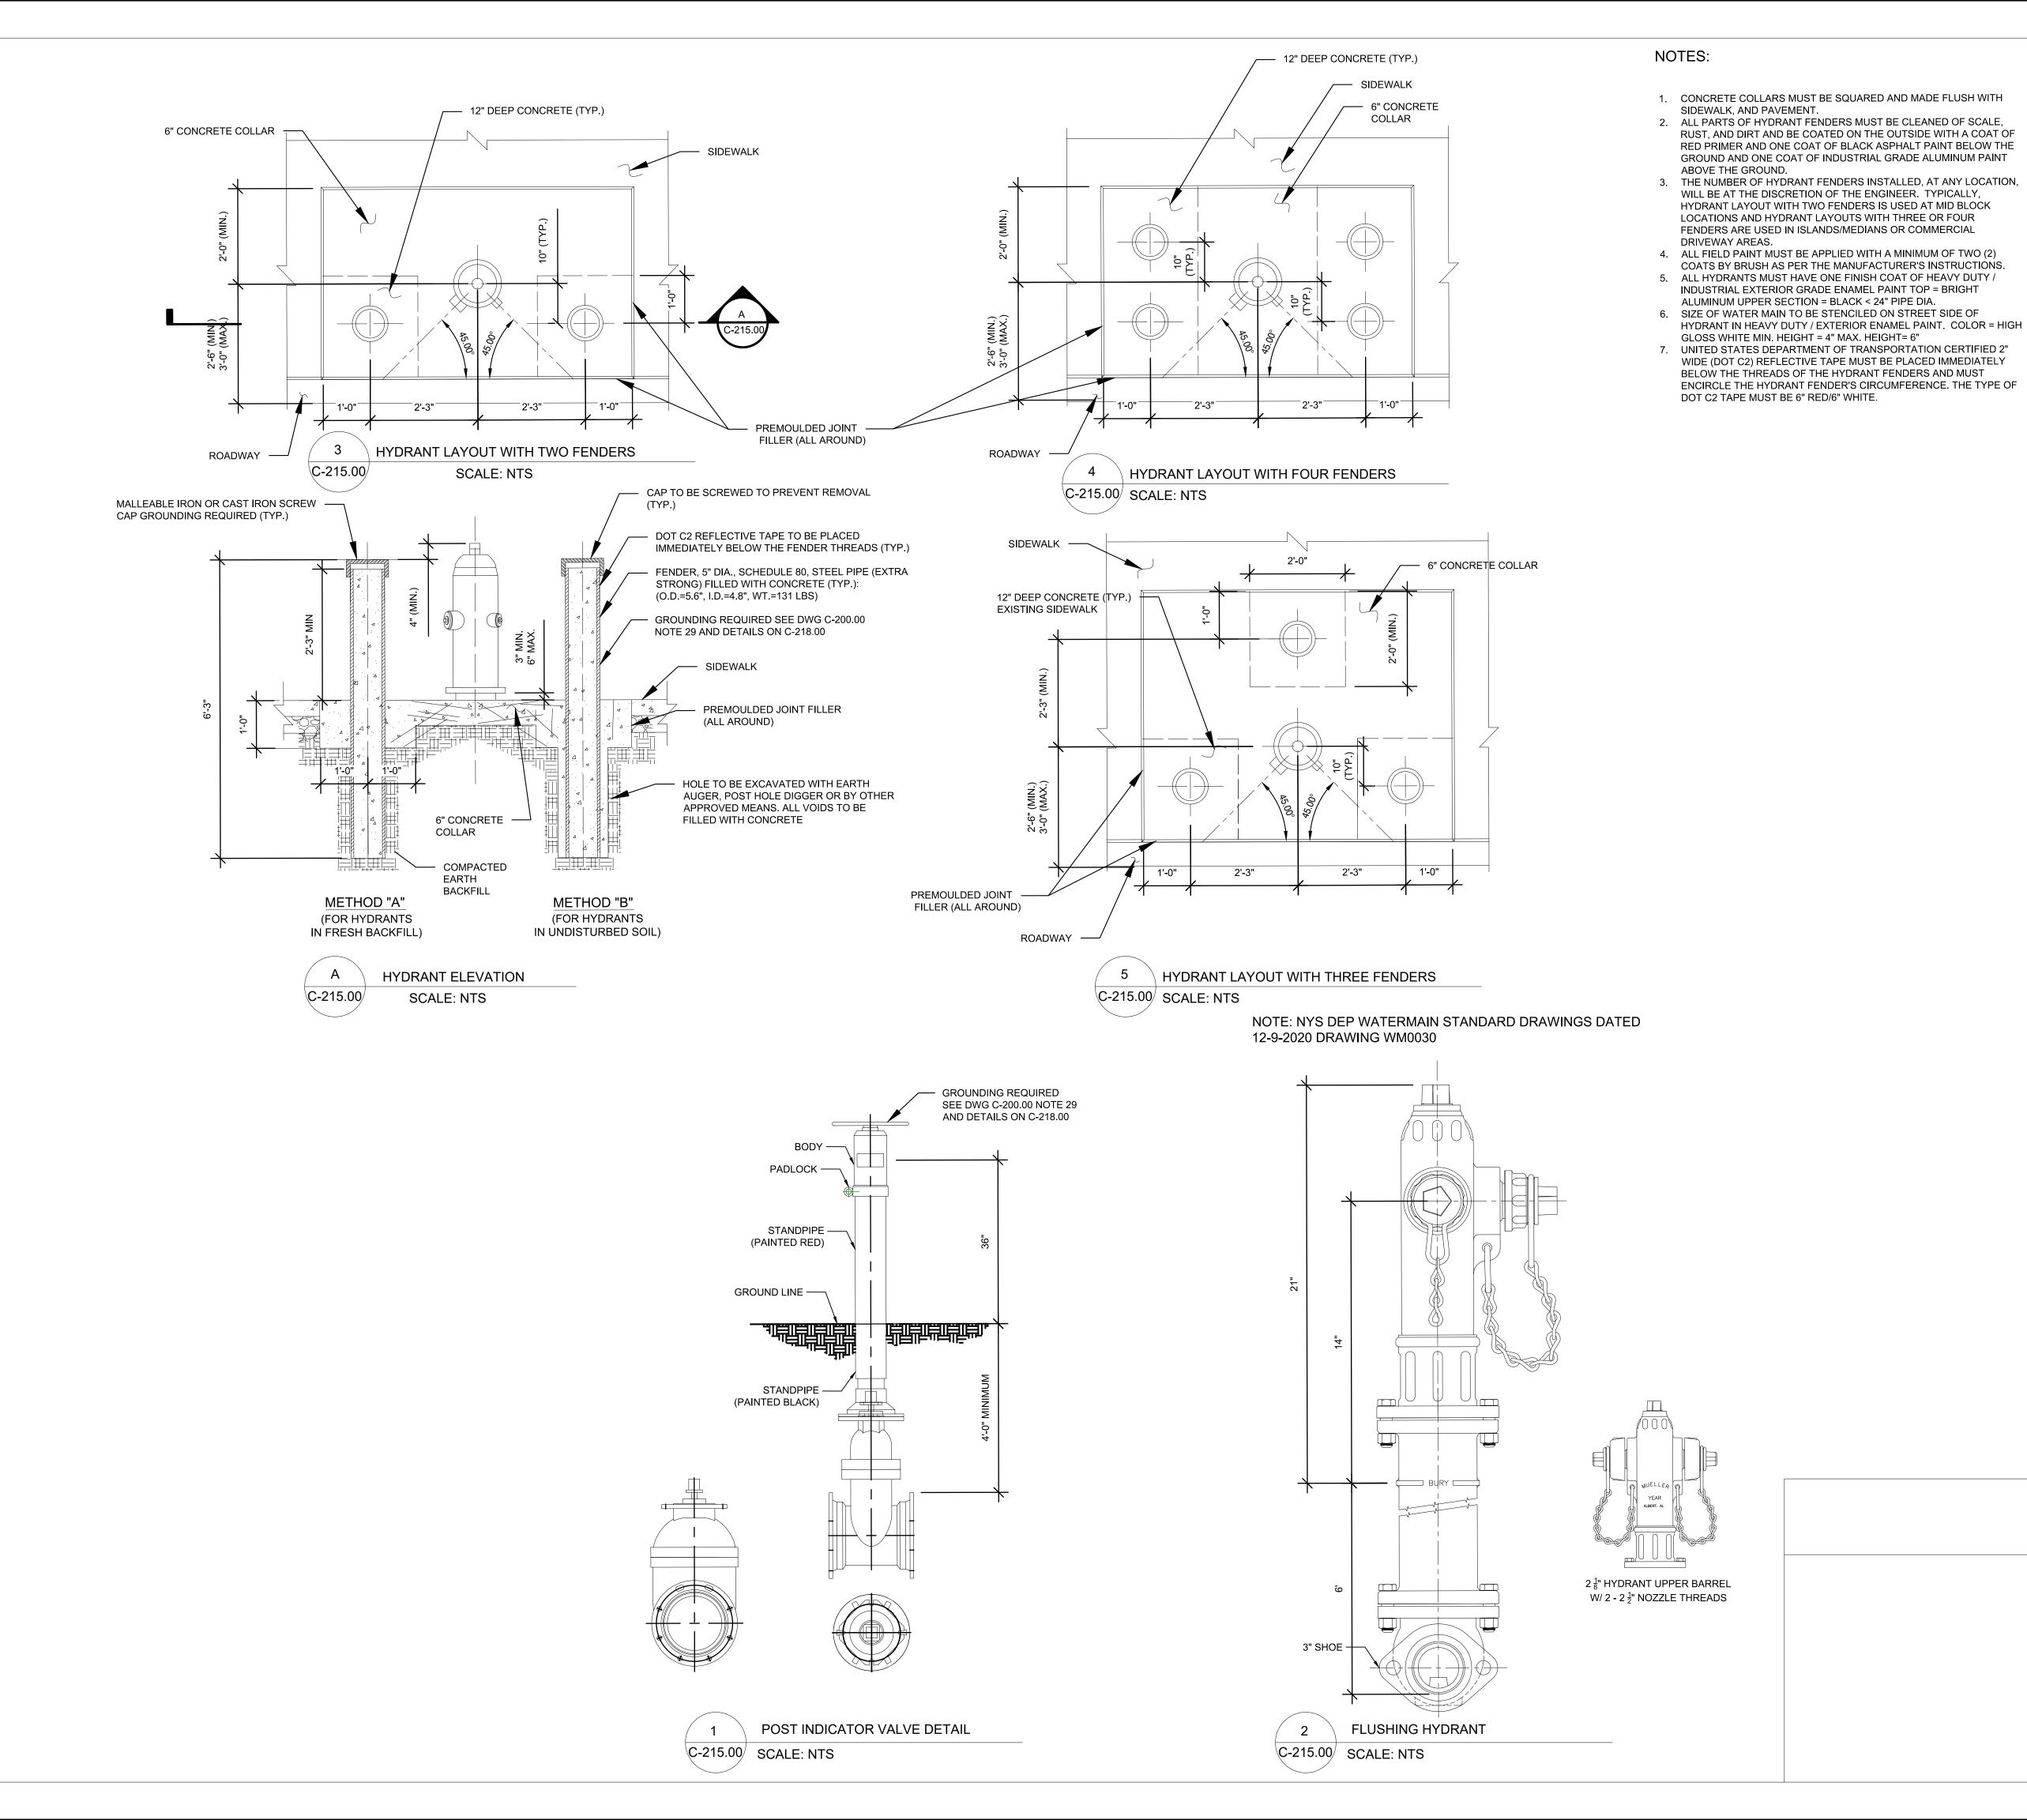



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Α	INTERIM SUBMISSION	SC	CV	8/29/22
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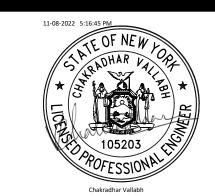
PROJECT

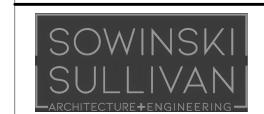

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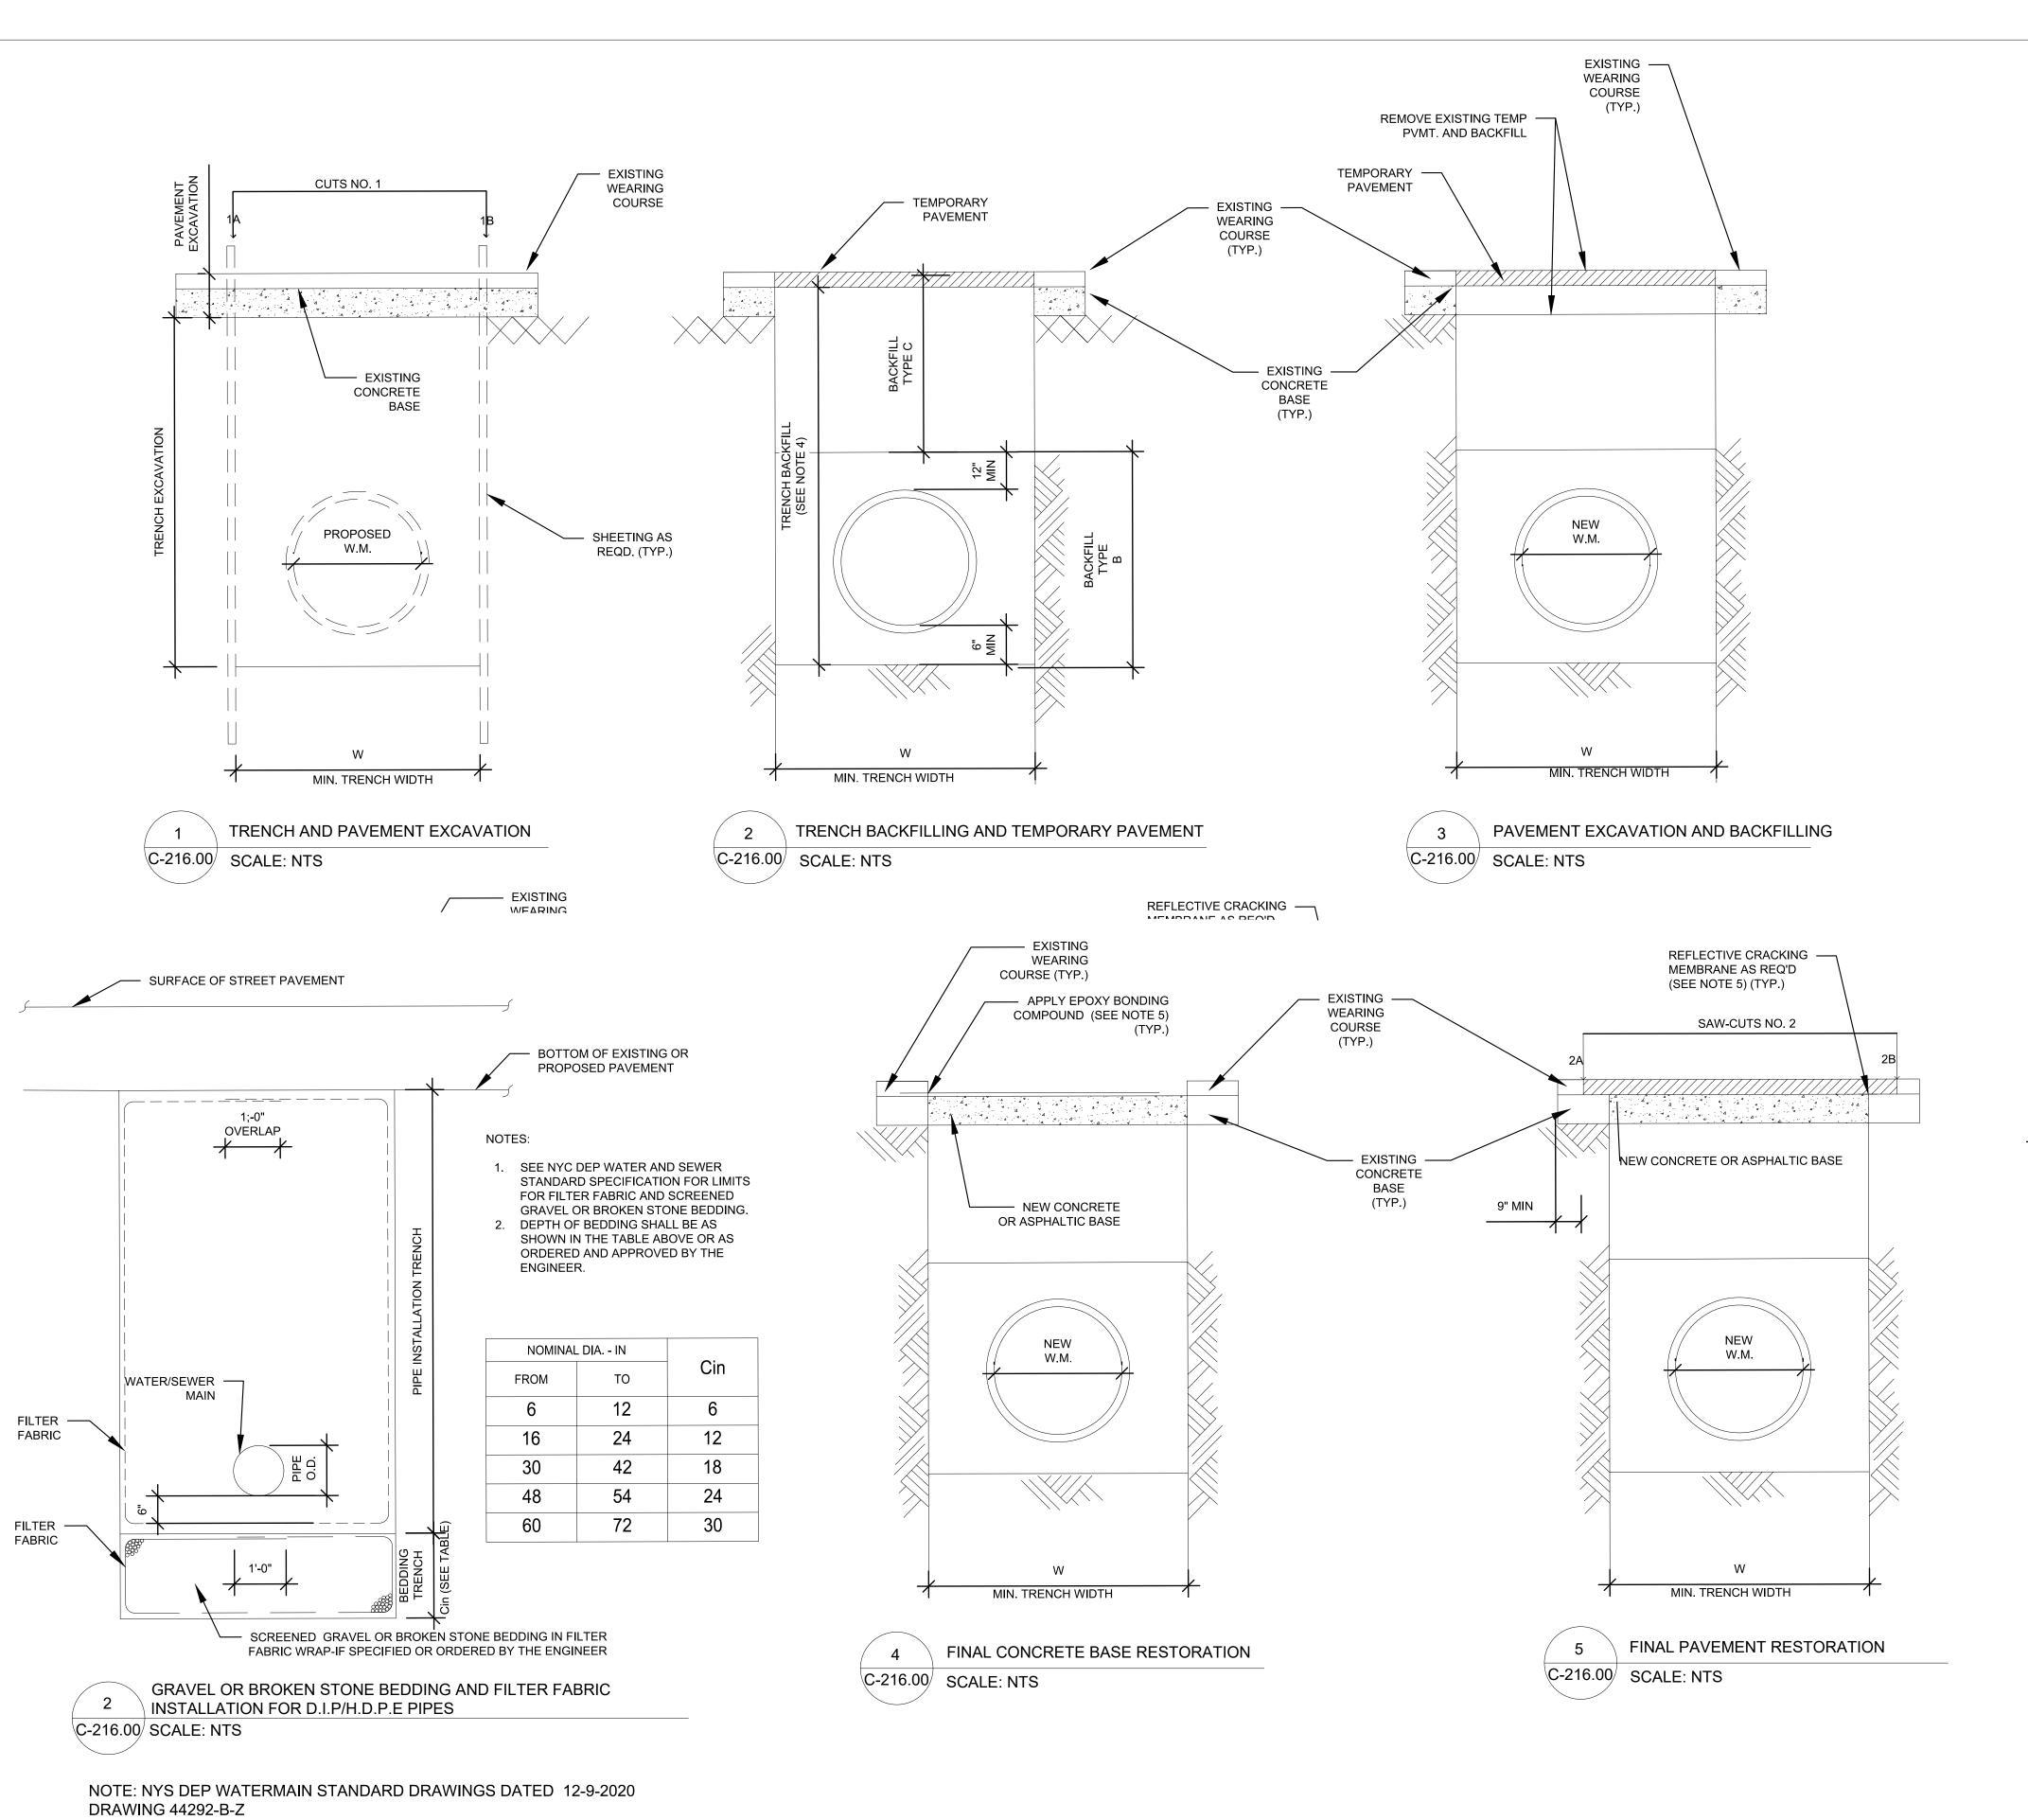
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> **UTILITY DETAILS 4** FIRE HYDRANT **DETAILS**



DATE	November 8, 2022
PROJECT NO	105121
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DRAWING NO	


C-215.00



NOTES:

- (1) ALL BACKFILL MATERIALS AND METHODS OF COMPACTION SHALL COMPLY WITH THE REQUIREMENTS OF THE STANDARD SPECIFICATIONS OF THE DIVISION OF INFRASTRUCTURE, DEPARTMENT OF DESIGN AND CONSTRUCTION.
- (2) BROKEN STONE BASE OR OTHER SUPPORT UNDER PIPE, AND FILTER FABRIC, INSTALLATION OF WHICH MAY BE REQUIRED, ARE NOT SHOWN. (3) THE MINIMUM WIDTH OF TRENCH (W), GOVERNING THE WIDTH OF PAVEMENT
- EXCAVATION AND REPLACEMENT, IS SPECIFIED IN SECTION 60.12 OF THE STANDARD WATER MAIN SPECIFICATIONS.
- (4) FOR ADDITIONAL INFORMATION ON BACKFILLING TRENCHES AND DESCRIPTION OF BACKFILL TYPES "B" AND "C", SEE SECTION 26.01 OF THE STANDARD WATER MAIN SPECIFICATIONS.
- (5) EXPOSED CONCRETE EDGES SHALL BE CLEANED AND COATED WITH AN APPROVED EPOXY BONDING COMPOUND.
- (6) REFLECTIVE CRACKING MEMBRANE SHALL BE PLACED OVER JOINT BETWEEN NEWLY PLACED AND EXISTING CONCRETE BASES AND OVER ALL TRANSVERSE
- JOINTS OR CRACKS THAT CARRY THROUGH. (7) ALL SAW-CUT EDGES OF EXISTING ASPHALT PAVEMENT SHALL BE COATED WITH AN APPROVED ASPHALTIC TACK COAT NOT MORE THAN THREE (3) HOURS PRIOR
- TO THE RESTORATION OF THE WEARING COURSE. (8) FOR DETAILS OF REPLACING PAVEMENTS AND FOUNDATIONS, SEE SECTION 71.41 OF THE STANDARD WATER MAIN SPECIFICATIONS.

MAXIMUM WIDTH OF TRENCH (SEE NOTE 4)

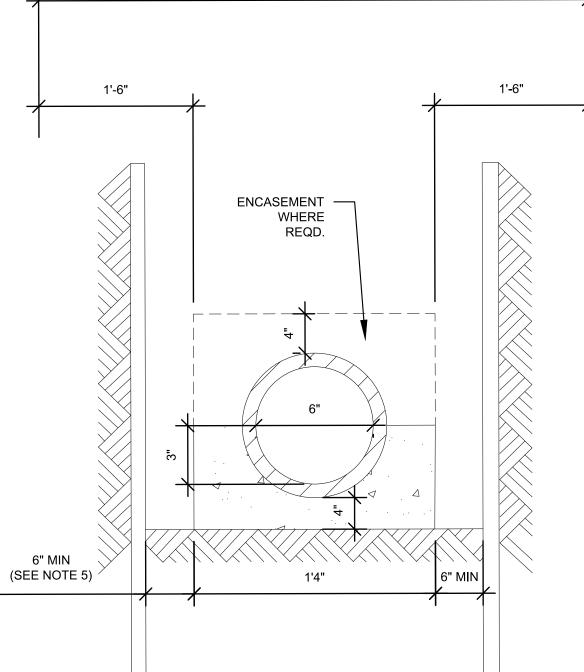

STANDARD FOR HOUSE CONNECTIONS (FOR 6" AND 8" DIA. CAST IRON SOIL PIPE OR VITRIFIED CLAY PIPE ON CONCRETE CRADLE OR ENCASED IN CONCRETE ON EARTH)

NOTES:

- A. CRADLE AND ENCASEMENT ARE CLASS 40 CONCRETE FOR ALL HOUSE CONNECTIONS. B. ENTIRE CRADLE OR ENCASEMENT IS TO BE PLACED MONOLITHICALLY.
- C. ENCASEMENT REQUIRED ON H.C. PIPE WHICH HAS A COVER, FROM FINAL GRADE TO THE OUTER TOP OF THE PIPE, OF LESS THAN THREE (3) FEET OR WHEN THE UPPER LIMIT OF COVER IS EXCEEDED.
- D. UNLESS OTHERWISE APPROVED BY THE ENGINEER, THE MAXIMUM WIDTH OF TRENCH BETWEEN INNER FACES OF THE LOWEST STAGE OF SHEETING OR ROCK SHALL NOT EXCEED THE WIDTH OF THE CRADLE BY MORE THAN THREE (3) FEET (1'-6" MAXIMUM EACH SIDE OF CRADLE).
- E. SIX (6) INCH MINIMUM SHALL BE MAINTAINED AT ALL TIMES, EXCEPT WHERE SHEETING IS TO BE USED AS FORMWORK.



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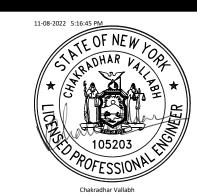
PROJECT



Astoria HVDC Converter Station

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> **UTILITY DETAILS 5** PIPE INSTALLATION **DETAILS**



November 8, 2022 S. CASH HECKED BY C. VALLABH RAWING NO

C-216.00