# APPENDIX C.03 CASE 10-T-0139 SITE PLANS AND CONSTRUCTION DRAWINGS SITE PLAN – PAVEMENT ASTORIA HVDC CONVERTER STATION - SEGMENT 22



# ASTORIA HVDC CONVERTER STATION

# SITE PAVEMENT PACKAGE

# SCOPE OF WORK

THE SITE PAVEMENT SCOPE OF WORK INCLUDES THE FOLLOWING:

1. PAVEMENT DESIGN


2. SURFACE TREATMENT/MATERIALS OUTSIDE OF PAVEMENT LIMITS

# FLOOD ZONE DESIGN CERTIFICATION:

THE EXISTING PROPERTY IS IN THE SPECIAL FLOOD HAZARD AREA (SFHA), ZONE AE PER EFFECTIVE 2015 FLOOD INSURANCE RATE MAP(FIRM). THIS IS TO CONFIRM THAT THE PROPOSED INSTALLATION IS IN COMPLIANCE WITH THE REQUIREMENTS SET FORTH IN APPENDIX Q OF THE NYC BUILDING CODE.


# NYC ENERGY CODE COMPLIANCE:

STATEMENT: TO THE BEST OF MY KNOWLEDGE, BELIEF AND PROFESSIONAL JUDGEMENT, THESE PLANS AND SPECIFICATIONS ARE IN COMPLIANCE WITH THE NEW YORK CITY ENERGY CONSERVATION CODE. PROPOSED WORK MEETS THE GUIDELINES AND INSTRUCTIONS OUTLINED IN THE 2020 NYC ECC CHAPTER 4.

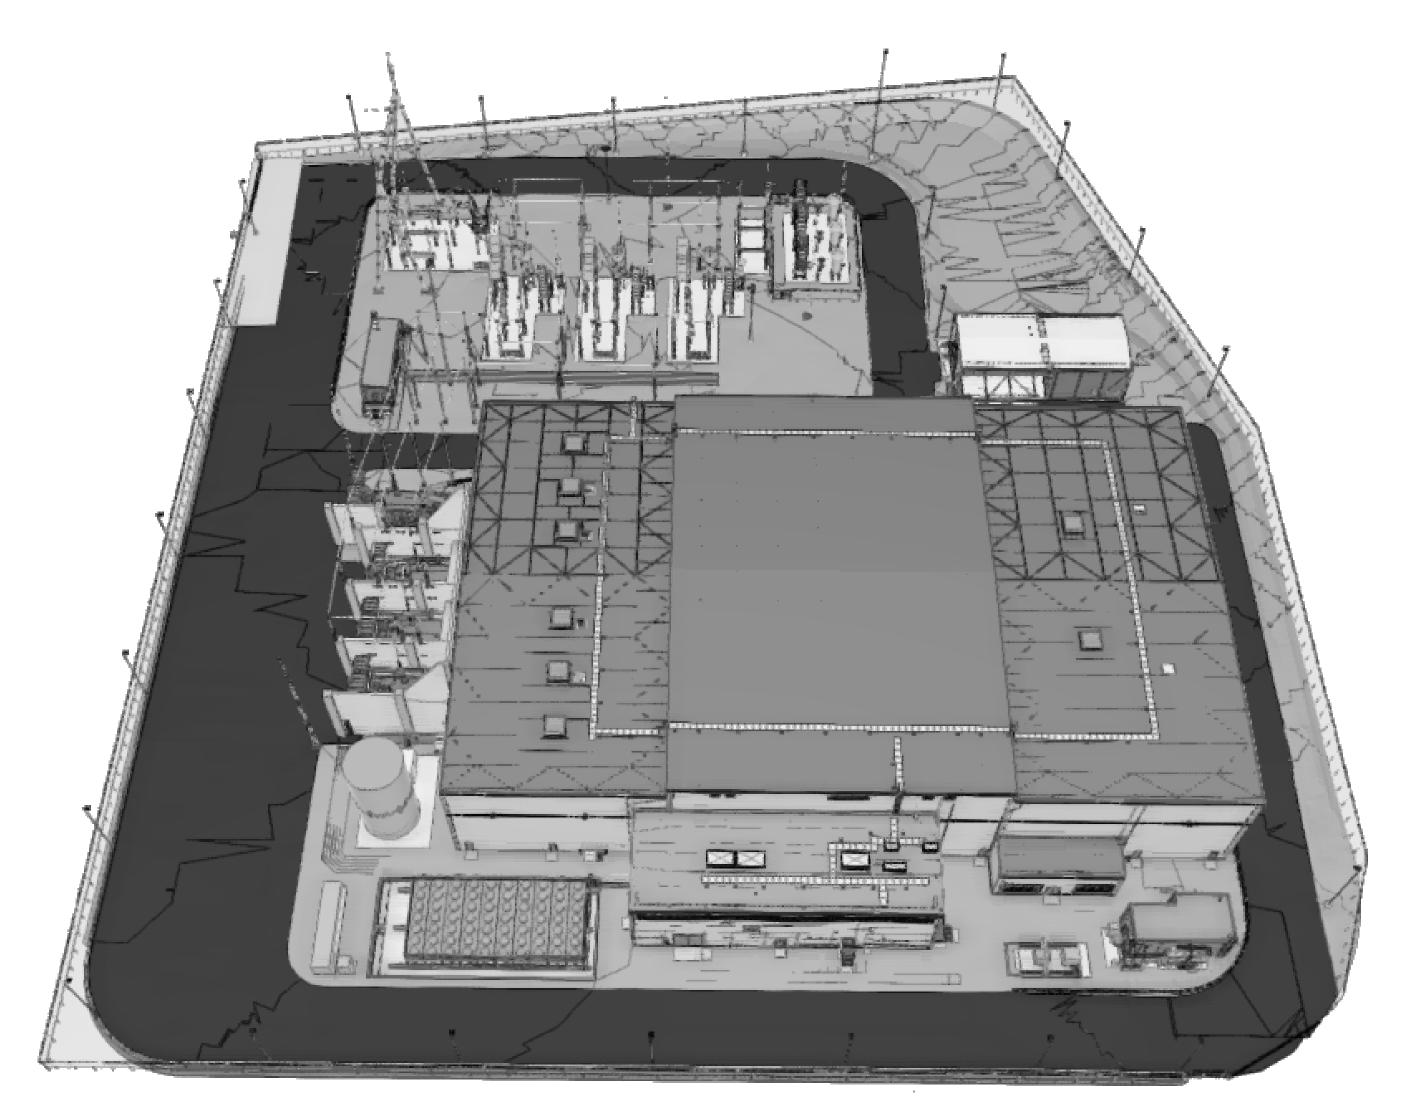



# ISSUED FOR PERMIT

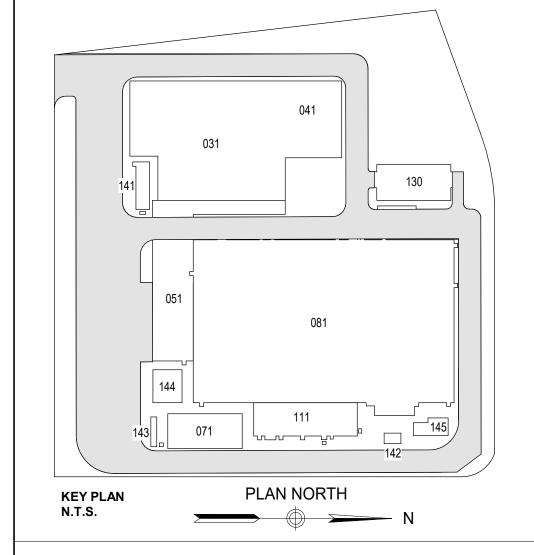



370 7th Avenue SUITE 1604 New York, NY 1000



25 Mohawk Avenue Sparta, NJ 07871

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	В	FINAL SUBMISSION	VSP	EK	11/08/2022
	Α	INTERIM SUBMISSION	VSP	EK	09/13/2022
	REV	DESCRIPTION	DRW BY	CHK BY	DATE





PROJECT



# Astoria HVDC Converter Station

31-45 20<sup>th</sup> Avenue, Astoria, Queens NY 11105 Block #850 - Lot #310 - BIN #4624437

**COVER SHEET** 



DATE	11/08/2022
PROJECT NO	105121
DRAWING BY	V. PATEL
CHECKED BY	E. KIDANE
DRAWING NO	

### **GENERAL NOTES:**


- 1. THE PLANS SHOW SUBSURFACE STRUCTURES, ABOVE GROUND STRUCTURES, AND/OR UTILITIES FROM FIELD LOCATION AND RECORD MAPPING, EXACT LOCATION OF WHICH MAY VARY FROM THE LOCATIONS INDICATED. IN PARTICULAR, THE CONTRACTOR IS WARNED THAT THE EXACT OR EVEN APPROXIMATE LOCATION OF SUCH PIPELINES, SUBSURFACE STRUCTURES, AND/OR UTILITIES IN THE AREA MAY BE DIFFERENT FROM THAT SHOWN OR MAY NOT BE SHOWN, AND IT SHALL BE HIS RESPONSIBILITY TO PROCEED WITH GREAT CARE IN EXECUTING ANY WORK. 48 HOURS BEFORE YOU DIG, DRILL, OR BLAST, CALL UNDERGROUND FACILITIES PROTECTION ORGANIZATION (UFPO) 1-(800)-962-7962 TOLL FREE.
- 2. THE ENGINEER SHALL BE NOTIFIED IN WRITING OF ANY CONDITIONS THAT VARY FROM THOSE SHOWN ON THE PLANS. THE CONTRACTOR'S WORK SHALL NOT VARY FROM THE PLANS WITHOUT THE PRIOR APPROVAL OF THE ENGINEER.
- 3. THE CONTRACTOR SHALL PROTECT AND PRESERVE ALL PUBLIC AND PRIVATE PROPERTY, INCLUDING ALL EXISTING VEGETATION, EXISTING LANDSCAPE FEATURES, AND MONUMENTS WITHIN, ALONG, AND ADJACENT TO THE PROPERTY. ALL AREAS DISTURBED BY THE CONTRACTOR SHALL BE RESTORED TO A PLEASING AND ACCEPTABLE CONDITION.
- 4. THE CONTRACTOR SHALL BE RESPONSIBLE FOR OBTAINING AND INCURRING THE COST OF ALL REQUIRED PERMITS, INSPECTIONS, CERTIFICATES, ETC. AND SHALL COMPLY WITH ALL REQUIRED PERMITS.
- 5. ALL WORK SHALL BE DONE IN STRICT COMPLIANCE WITH ALL APPLICABLE NATIONAL, STATE, AND LOCAL CODES, STANDARDS, ORDINANCES, RULES, AND
- 6. ALL PROPOSED UTILITIES AND APPURTENANCES SHALL BE CONSTRUCTED IN COMPLIANCE WITH THE LOCAL MUNICIPALITIES' CODES AND REGULATIONS GOVERNING THE INSTALLATION OF SUCH UTILITIES.
- 7. THE ENGINEER RESERVES THE RIGHT TO EXAMINE ANY WORK DONE ON THIS PROJECT AT ANY TIME TO DETERMINE THE CONFORMANCE WITH THE REQUIREMENTS OF THE CONTRACT DOCUMENTS OF THIS PROJECT.
- 8. THE CONTRACTOR SHALL PROTECT EXISTING PROPERTY LINE MONUMENTATION. ANY MONUMENTATION DISTURBED OR DESTROYED, AS JUDGED BY THE ENGINEER OR OWNER, SHALL BE REPLACED AT THE CONTRACTOR'S EXPENSE UNDER THE SUPERVISION OF A NEW YORK STATE LICENSED LAND SURVEYOR.
- 9. IT IS THE CONTRACTOR'S RESPONSIBILITY TO EXAMINE ALL PLAN SHEETS AND COORDINATE WORK WITH ALL OTHER CONTRACTS FOR THE SITE.
- 10. THE CONTRACTOR SHALL:
  - 10.A. VERIFY ALL CONDITIONS IN THE FIELD PRIOR TO COMMENCEMENT OF WORK AND NOTIFY THE ENGINEER OF ANY DISCREPANCIES.
  - 10.B. EXAMINE THE SITE AND INCLUDE IN HIS WORK THE EFFECT OF ALL EXISTING CONDITIONS ON THE WORK.
  - 10.C. PROVIDE AND INSTALL ALL MATERIALS AND PERFORM ALL WORK IN ACCORDANCE WITH GOOD STANDARD PRACTICE.
- 11. ALL TRENCH EXCAVATION AND ANY REQUIRED SHEETING AND SHORING SHALL BE DONE IN ACCORDANCE WITH THE LATEST REVISIONS OF NEW YORK CITY BUILDING CODE CHAPTER 33 AND OSHA REGULATIONS FOR CONSTRUCTION. SHEET PILING SHALL BE DESIGNED AND SEALED BY A NEW YORK STATE LICENSED PROFESSIONAL ENGINEER.
- 12. CONTRACTOR SHALL BE RESPONSIBLE FOR ROUTINE DEWATERING RELATED TO THE MAINTENANCE OF SURFACE DRAINAGE DURING THE COURSE OF WORK. CONTRACTOR SHALL MAINTAIN EXISTING SITE DRAINAGE PATTERNS THROUGHOUT CONSTRUCTION UNLESS OTHERWISE SHOWN ON THE PLANS. DEWATERING FOR MAJOR CONSTRUCTION ITEMS IS NOT THE RESPONSIBILITY OF THE CONTRACTOR AND SHALL BE PERFORMED BY TDI.
- 13. CONTRACTOR SHALL NOT DISRUPT SERVICE TO ANY UTILITIES WITHOUT PRIOR COORDINATION WITH UTILITY OWNER.
- 14. ALL FRAMES/COVERS WITHIN PAVED AREAS SHALL HAVE THE TOPS SET FLUSH WITH THE FINAL PAVEMENT GRADE. IN LANDSCAPED AREAS, ALL FRAMES SHALL BE 0.1' ABOVE GRADE.
- 15. THE CONTRACTOR SHALL BE RESPONSIBLE FOR PROVIDING ALL FIELD LAYOUT. THE CONTRACTOR SHALL PROVIDE MARKED-UP AS-BUILT PLANS FOR ALL UTILITIES SHOWING TIE-IN AND CONNECTIONS, BENDS, VALVES, LENGTHS OF LINES, AND INVERTS. AS-BUILT PLANS FOR ALL UTILITIES SHOWING TIES TO CONNECTIONS, BENDS, VALVES, LENGTHS OF LINES, AND INVERTS. AS-BUILT PLANS SHOWING ALL UNDERGROUND UTILITIES INSTALLED OR ENCOUNTERED SHALL BE SUBMITTED TO THE OWNER AND HIS REPRESENTATIVES.
- 16. CONTRACTOR SHALL MAINTAIN ALL TRAFFIC IN ALL AREAS (INCLUDING THE ADJACENT ROADWAYS TO THE SITE AND CONSTRUCTION VEHICLE ENTRANCE AND EXIT TO THE SITE) AS PER COORDINATION WITH ADJACENT PROPERTY OWNERS.
- 17. ALL EXCAVATIONS SHALL BE PROTECTED AT THE END OF EACH WORK DAY.
- 18. CONTRACTOR SHALL TAKE CARE TO PREVENT DAMAGE TO EXISTING UTILITIES. DAMAGED UTILITIES SHALL BE IMMEDIATELY REPAIRED BY THE CONTRACTOR AT THE CONTRACTOR'S EXPENSE. IF DURING EXCAVATION PREVIOUSLY DAMAGED UTILITIES ARE UNCOVERED, CONTRACTOR SHALL DOCUMENT THE DAMAGE AND REPORT DAMAGE TO THE APPROPRIATE OWNER.
- 19. THE CONTRACTOR MUST COORDINATE HIS SCHEDULE OF OPERATIONS WITH THE VARIOUS UTILITY OWNERS INVOLVED WITH THE PROJECT AND SHALL VERIFY UTILITY INFORMATION FOUND IN THE CONTRACT DOCUMENTS.
- 20. PRIOR TO THE COMMENCEMENT OF CONSTRUCTION, TDI SHALL COORDINATE WITH ALL THE KNOWN PUBLIC AND PRIVATE UTILITY COMPANIES THAT MAY HAVE POTENTIAL IMPACT TO OVERHEAD AND UNDERGROUND UTILITIES FROM THE CONTRACTORS WORK. THE CONTRACTOR SHALL, AT THIS MEETING, INFORM THE UTILITY COMPANIES OF HIS SCHEDULE OF OPERATIONS SO THAT UTILITY COMPANIES PLAN AND SCHEDULE THEIR ACTIVITIES ACCORDINGLY.
- 21. THE CONTRACTOR IS GOVERNED BY AND MUST ADHERE TO THE PROVISIONS OF THE 16 NYCRR PART 753, "PROTECTION OF UNDERGROUND FACILITIES." AND ALL ITS AMENDMENTS; I.E. CALL 811 DIG SAFE PRIOR TO BREAKING GROUND
- 22. THE CONTRACTOR SHALL CONDUCT ALL OPERATIONS IN ACCORDANCE WITH ALL OSHA RULES AND REGULATIONS AND IN ACCORDANCE WITH NEW YORK STATE LABOR LAW, SECTION 202-H, "THE HIGH VOLTAGE PROXIMITY ACT."
- 23. REFER TO FLOOD INSURANCE RATE MAP (FIRM) NUMBER 3604970092G FOR THE PROJECT SITE. THE SPECIAL FLOOD HAZARD AREA TYPE IS ZONE AE AND X. BASE FLOOD ELEVATION IS 13' AND DESIGN FLOOD ELEVATION IS 15'.
- 24. EXISTING IMPERVIOUS SURFACE AREA WITHIN THE PROPERTY LIMITS TOTALS 4.36 ACRES, WHILE PROPOSED IMPERVIOUS SURFACE AREA TOTALS 7.77 ACRES.

GENERAL PROVISIONS


### FL FLOOD

- FL-1. THE SITE IS DEFINED AS A ZONE (NON-COASTAL).
- FL-2. BASE FLOOD ELEVATION, BFE, = 13 FEET NAVD 88.
- FL-3. RECOMMENDED FREE BOARD BY THE 2022 NYCBC-APPENDIX G IS 2.0 FEET.
- FL-4. RECOMMENDED DESIGN FLOOD ELEVATION, DFE = 15 FEET NAVD 88.
- FL-5. THE STRUCTURE IS NOT SUBJECTED TO HYDRODYNAMIC LOADS.

DESIGN ELEVATION / DEPTH	FEET IN NAVD 88
DESIGN BASE FLOOD ELEVATION	13.0
FINISH FLOOR ELEVATION	15.0
SEA LEVEL RISE	NOT CONSIDERED

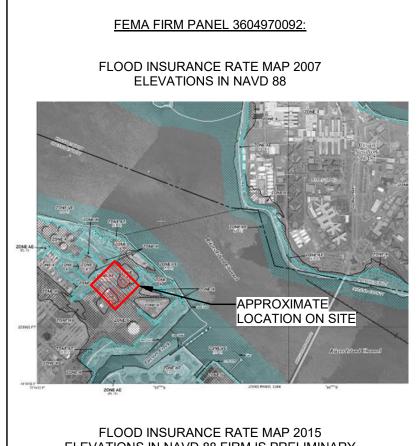

ELEVATIONS IN NAVD 88 FIRM IS PRELIMINARY

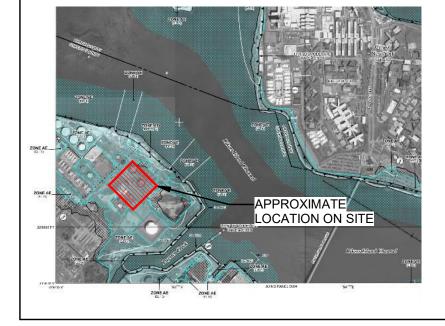

### GENERAL NOTES C-001.00 LEGEND AND ABBREVIATIONS C-002.00 OVERALL PAVEMENT PLAN C-401.00 PAVEMENT AND MISCELLANEOUS SECTIONS - 1 C-402.00 PAVEMENT AND MISCELLANEOUS SECTIONS - 2 C-403.00

DWG. NO.

SITE CIVIL SHEET INDEX

DRAWING TITLE





370 7th Avenue **SUITE 1604** New York, NY 10001



25 Mohawk Avenue Sparta, NJ 07871

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В	FINAL SUBMISSION	AB	JL	11/8/22
Α	INTERIM SUBMISSION	NS	JL	8/29/22
REV	DESCRIPTION	DRW BY	CHK BY	DATE



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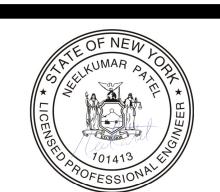
**PROJECT** 



# **Astoria HVDC Converter Station**

31-45 20th Avenue, Astoria, Queens NY 11105 Block #850 - Lot #310 - BIN #4624437

**GENERAL NOTES** 



NOVEMBER 8, 2022 A.BUDARAPU HECKED BY J.LLORENTE

C-001.00

32 - EXTERIOR IMPROVEMENTS 321216 ASPHALT PAVING

LIST OF SPECIFICATIONS:

LIST OF SPECIAL INSPECTIONS:

INSPECTION AND TEST CODE/SECTION SUBGRADE INSPECTION BC 1704.7.1

# LEGENDS & SYMBOLS

EXISTING PROPERTY LINE

PROPOSED FENCE

PROPOSED RETAINING WALL

PROPOSED SECURITY GATE

PROPOSED LIGHT POLE

# **ABBREVIATIONS**

AASHTO = AMERICAN ASSOCIATION OF STATE HIGHWAY AND TRANSPORTATION OFFICIALS

AC = ALTERNATING CURRENT

AD = TANGENT OFFSET AT PVI

APPROX = APPROXIMATE

ASCE = AMERICAN SOCIETY OF CIVIL ENGINEERS

ASTM = AMERICAN SOCIETY OF TESTING AND MATERIALS

BVCE = BEGINING OF VERTICAL CURVE ELEVATION

BVCS = BEGINING OF VERTICAL CURVE STATION

CB = CATCH BASIN

CIP = CAST IN PLACE

CONC = CONCRETE

33113

DIA = DIAMETER

DIP = DUCTILE IRON PIPE

DGA = DENSE GRADED AGGREGATE

E = EPOXY COATED REBAR

ELEV = ELEVATION

EVCE = END OF VERTICAL CURVE ELEVATION

EVCS = END OF VERTICAL CURVE STATION

EXIST = EXISTING

FF = FRONT FACE

FDNY = NEW YORK CITY FIRE DEPARTMENT

FFE = FINISHED FLOOR ELEVATION

HDPE = HIGH DENSITY POLYETHYLENE

HPBO = HEAVY POST BLOCK OUT

HVAC = HEATING, VENTILATION AND AIR CONDITIONING

HVE = HIGH VOLTAGE ELECTRIC

ID = INNER DIAMETER

IPS = IRON PIPE SIZE

LBS = POUNDS

LF = LINEAR FEET

LVC = LENGTH OF VERTICAL CURVE

MAX = MAXIMUM

MH = MANHOLE

MIN = MINIMUM

MPT = MAINTENANCE AND PROTECTION OF TRAFFIC

MTS = MANUAL TRANSFER SWITCH

MVS = MEDIUM VOLTAGE SWITCHGEAR

N/A = NOT APPLICABLE

NTS = NOT TO SCALE

NYC = NEW YORK CITY

NYCDOT = NEW YORK CITY DEPARTMENT OF TRANSPORTATION

NYCDEP = NEW YORK CITY DEPARTMENT OF ENVIRONMENTAL PROTECTION

NYCRR = NEW YORK CITY CODES, RULES AND REGULATIONS

NYSDOT = NEW YORK STATE DEPARTMENT OF TRANSPORTATION

OC = ON CENTER

OD = OUTER DIAMETER

OSHA = OCCUPATIONAL SAFETY AND HEALTH ADMINISTRATION

PCC = PORTLAND CEMENT CONCRETE

PCD = PRECAST CONCRETE DUCTS

PVI = POINT OF VERTICAL INTERSECTION

PVMT = PAVEMENT

STA = STATIONTYP = TYPICAL

RCP = REINFORCED CONCRETE PIPE

RD = ROAD

REQ'D = REQUIRED

REV = REVISION

RF = REAR FACE

WM = WATER MAIN


WT = WEIGHT


YR = YEAR

WWF = WELDED WIRE FABRIC

WZTC = WORK ZONE TRAFFIC CONTROL

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В	FINAL SUBMISSION	AB	JL	11/8/22
A	INTERIM SUBMISSION	MK	JL	8/29/22
REV	DESCRIPTION	DRW BY	CHK BY	DATE

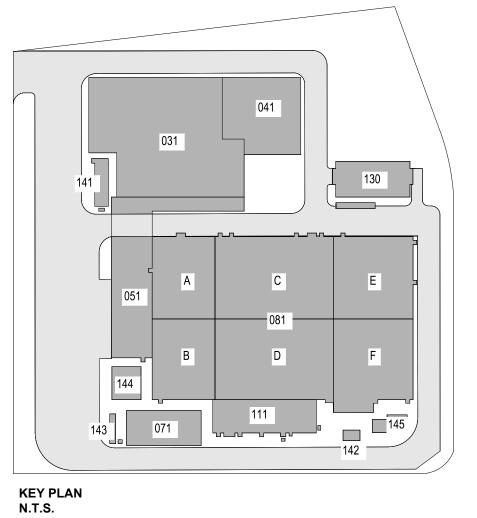

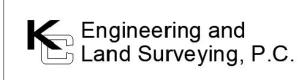**@**Hitachi Energy

901 Main Campus Drive Raleigh, North Carolina 27606

PROJECT



# Astoria HVDC Converter Station

31-45 20<sup>th</sup> Avenue, Astoria, Queens NY 11105 Block #850 - Lot #310 - BIN #4624437

LEGEND AND ABBREVIATIONS



DATE November 8, 2022

PROJECT NO 105121

DRAWING BY M. KWOK


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DRAWING NO


C-002.00

CADD FILE NO

3 of 6

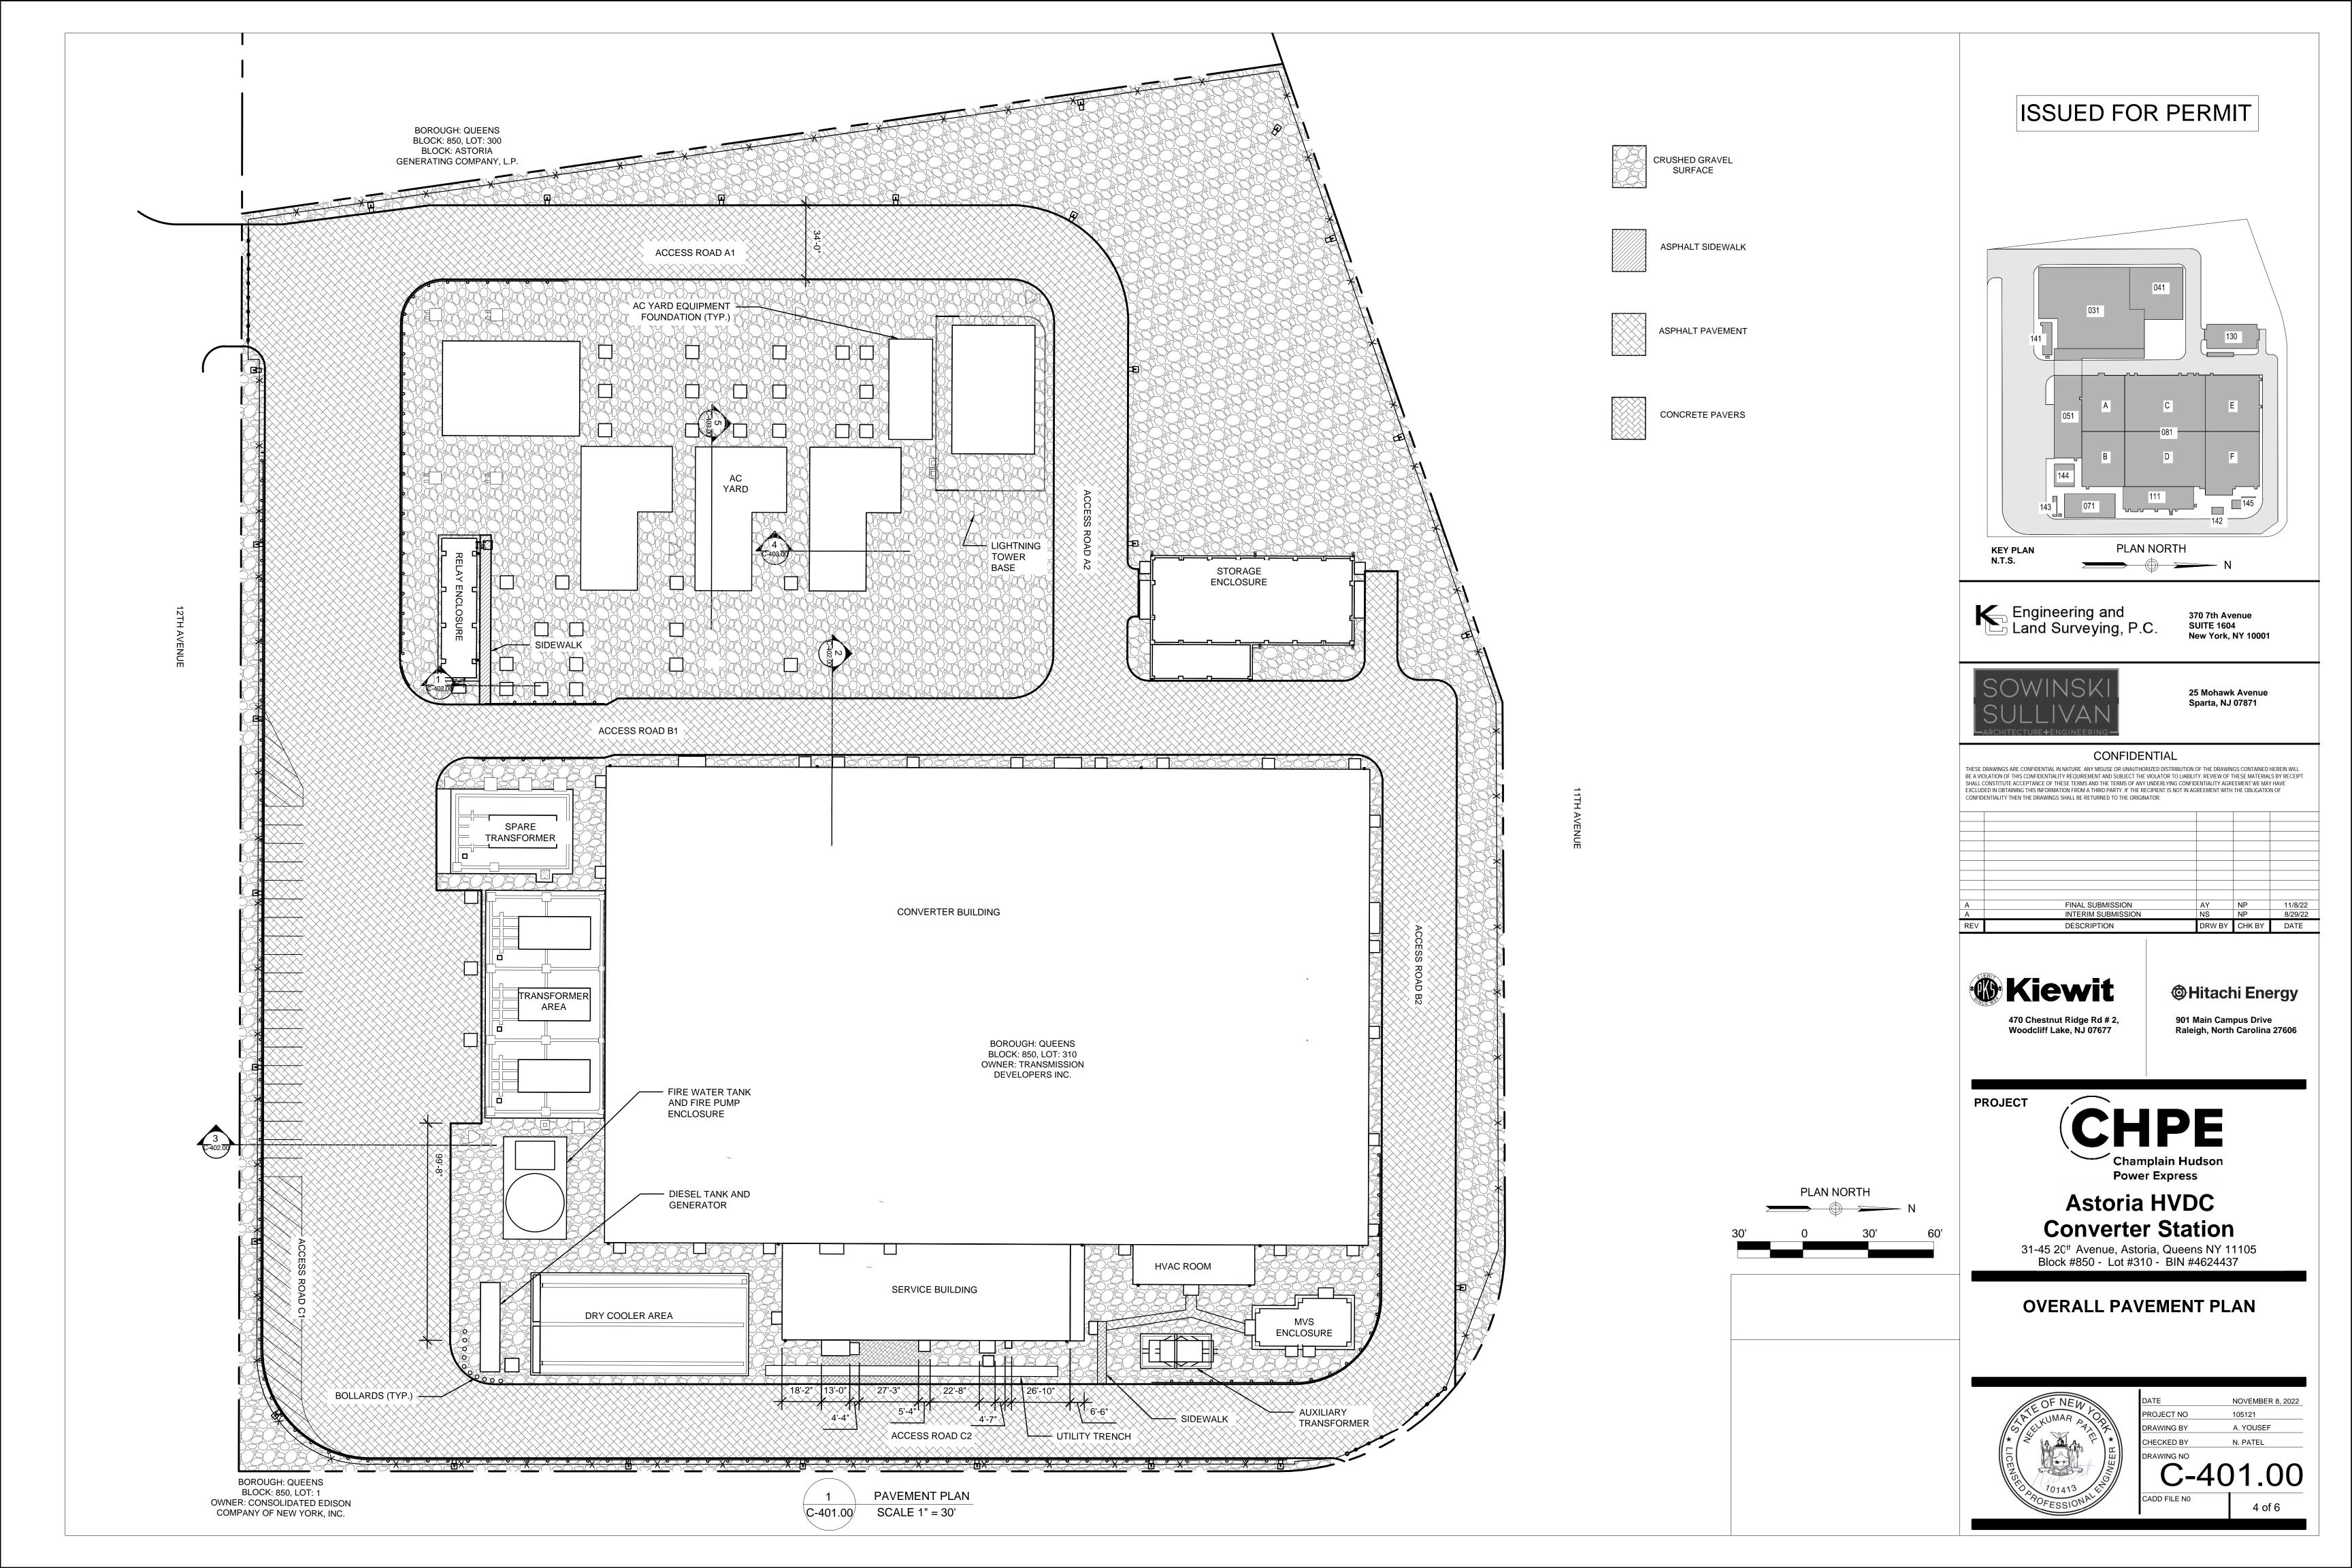

# 6" AC YARD WASHED GRAVEL SURFACE REFER TO GROUNDING GRID DRAWINGS (FILED UNDER A 5'-0" SIDEWALK SEPARATE APPLICATION) $1\frac{1}{2}$ " ASPHALT TOP COURSE 4" ASPHALT BINDER COURSE 6" SIDEWALK FOUNDATION NO. 3 BROKEN STONE OR GRAVEL AC YARD SIDEWALK SECTION C-401.00 SCALE 1" = 1'

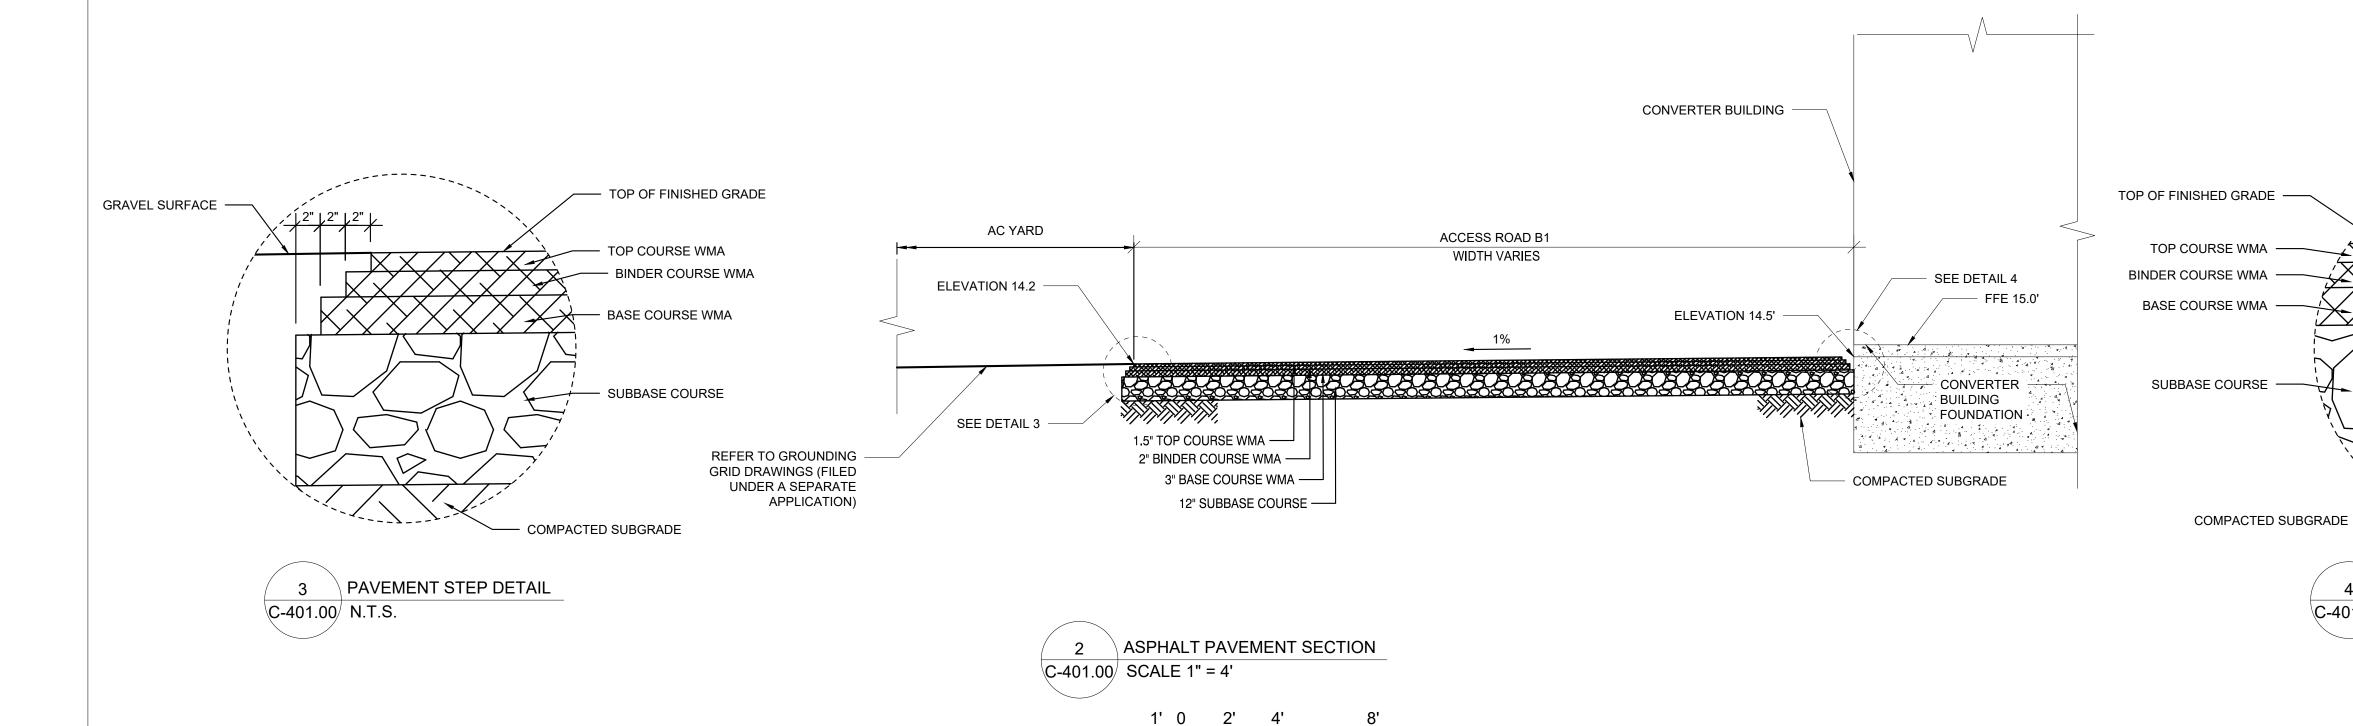

### PAVEMENT CONSTRUCTION NOTES:

- 1. PAVEMENT SUBGRADE SHALL BE COMPACTED TO AT LEAST 95% MAX. DRY DENSITY. AN ADDITIONAL LAYER OF DENSE-GRADED AGGREGATE (DGA) SHALL BE INSTALLED ON TOP OF THE COMPACTED SUBGRADE WHERE NEEDED TO MEET FINAL GRADE, AND SHALL BE COMPACTED TO AT LEAST 95% MAX. DRY DENSITY.
- 2. SUBBASE COURSE SHALL BE COMPACTED IN PLACE WITH AT LEAST TWO PASSES OF A HAND-OPERATED VIBRATORY PLATE, LIGHT ROLLER, OR OTHER SUITABLE WALK-BEHIND EQUIPMENT.
- 3. ALL PAVEMENT SURFACES SHALL SLOPE AWAY FROM BUILDINGS AND ENCLOSURES.

# **GRAVEL SURFACE NOTES:**

- 1. GRAVEL SURFACE COURSE SHALL BE 6" IN DEPTH AND CONSIST OF WASHED CLEAN UNIFORMLY GRADED CRUSHED ROCK WITH NO FINES TO ALLOW FOR FREE DRAINAGE. MATERIAL SHALL BE HARD ABRASION RESISTANT, DURABLE, GRANITE TYPE, ANGULAR OF SUB-ANGULAR CRUSHED ROCK.
- 2. BACKFILL MATERIAL BENEATH THE GRAVEL SURFACE COURSE SHALL CONFORM TO NYSDOT AND NYPA SPECIFICATIONS AS APPROPRIATE. GROUNDING GRID FOR ELECTRICAL EQUIPMENT TO BE INSTALLED IN THIS LAYER. REFER TO SECTION 6.1 OF THE GEOTECHNICAL ENGINEERING REPORT FOR BACKFILL MATERIAL RECOMMENDATIONS (FILED UNDER A SEPARATE APPLICATION).

BUILDING FACE

· GRAVEL SURFACE

FOUNDATION

3. MATERIAL RESISTIVITY PROPERTIES SHALL BE AS FOLLOWS: 3.1. GRAVEL SURFACE COURSE: 3000 Ω\*π MIN. WHEN WET

\_\_\_\_\_\_

PAVEMENT AND BUILDING FACE DETAIL

C-401.00/ N.T.S.

- 3.2. BACKFILL LAYER: 500 Ω\*m MAX.



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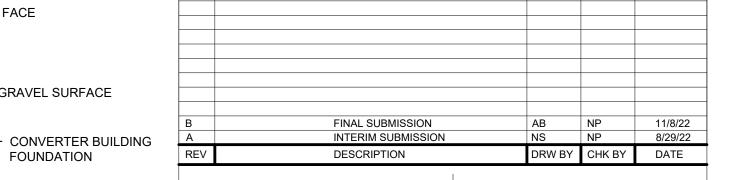


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**W**Kiewit 470 Chestnut Ridge Rd # 2, Woodcliff Lake, NJ 07677

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**PROJECT** 



# **Astoria HVDC Converter Station**


31-45 20th Avenue, Astoria, Queens NY 11105 Block #850 - Lot #310 - BIN #4624437

**PAVEMENT & MISCELLANEOUS SECTIONS - 1** 



NOVEMBER 8, 2022 A. YOUSEF HECKED BY


5 of 6

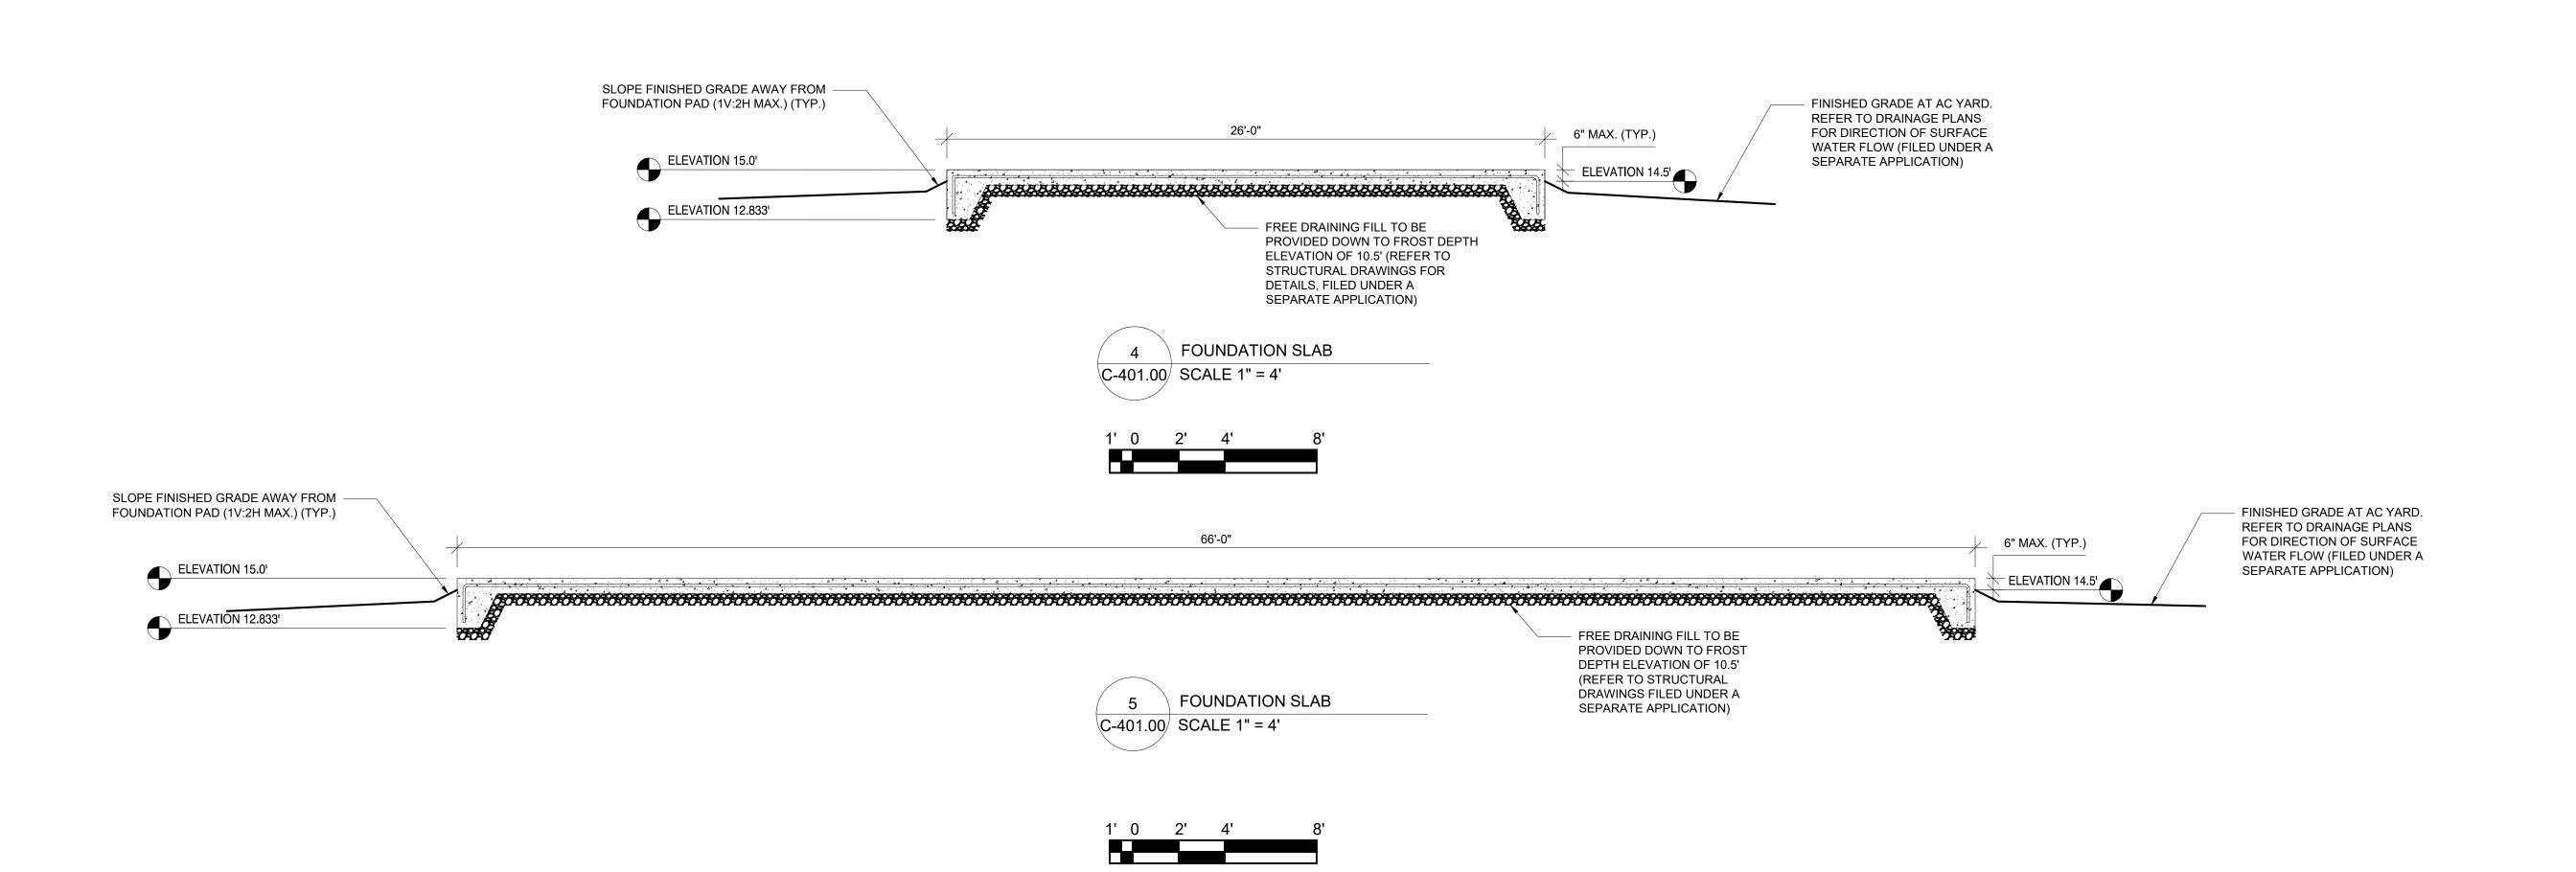

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A	FINAL SUBMISSION	AJ	NP	11/8/22
Α	INTERIM SUBMISSION	NS	NP	8/29/22
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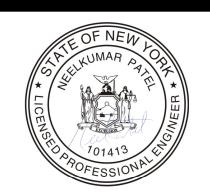
PROJECT



# Astoria HVDC Converter Station

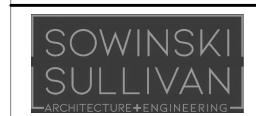31-45 20<sup>th</sup> Avenue, Astoria, Queens NY 11105 Block #850 - Lot #310 - BIN #4624437

PAVEMENT & MISCELLANEOUS SECTIONS - 2



DATE NOVEMBER 8, 2022
PROJECT NO 105121
DRAWING BY A. JALLOW
CHECKED BY N. PATEL

C-403.00

ADD FILE NO

6 of 6