# APPENDIX C.1 CASE 10-T-0139 SITE PLANS AND CONSTRUCTION DRAWINGS SITE PLAN – CIVIL PACKAGE ASTORIA HVDC CONVERTER STATION - SEGMENT 22



# ASTORIA HVDC CONVERTER STATION

# SITE CIVIL PACKAGE

### SCOPE OF WORK

THE SITE CIVIL SITE SCOPE OF WORK INCLUDES THE FOLLOWING:


- 1. OVERALL SITE GRADING PLAN
- 2. ACCESS ROAD LAYOUT AND ROADWAY DESIGN
- 3. SECURITY FENCE
- 4. VEHICULAR GUIDE RAIL

### FLOOD ZONE DESIGN CERTIFICATION:

THE EXISTING PROPERTY IS IN THE SPECIAL FLOOD HAZARD AREA (SFHA), ZONE AE PER EFFECTIVE 2015 FLOOD INSURANCE RATE MAP(FIRM). THIS IS TO CONFIRM THAT THE PROPOSED INSTALLATION IS IN COMPLIANCE WITH THE REQUIREMENTS SET FORTH IN APPENDIX Q OF THE NYC BUILDING CODE.


### NYC ENERGY CODE COMPLIANCE:

STATEMENT: TO THE BEST OF MY KNOWLEDGE, BELIEF AND PROFESSIONAL JUDGEMENT, THESE PLANS AND SPECIFICATIONS ARE IN COMPLIANCE WITH THE NEW YORK CITY ENERGY CONSERVATION CODE. PROPOSED WORK MEETS THE GUIDELINES AND INSTRUCTIONS OUTLINED IN THE 2020 NYC ECC CHAPTER 4.

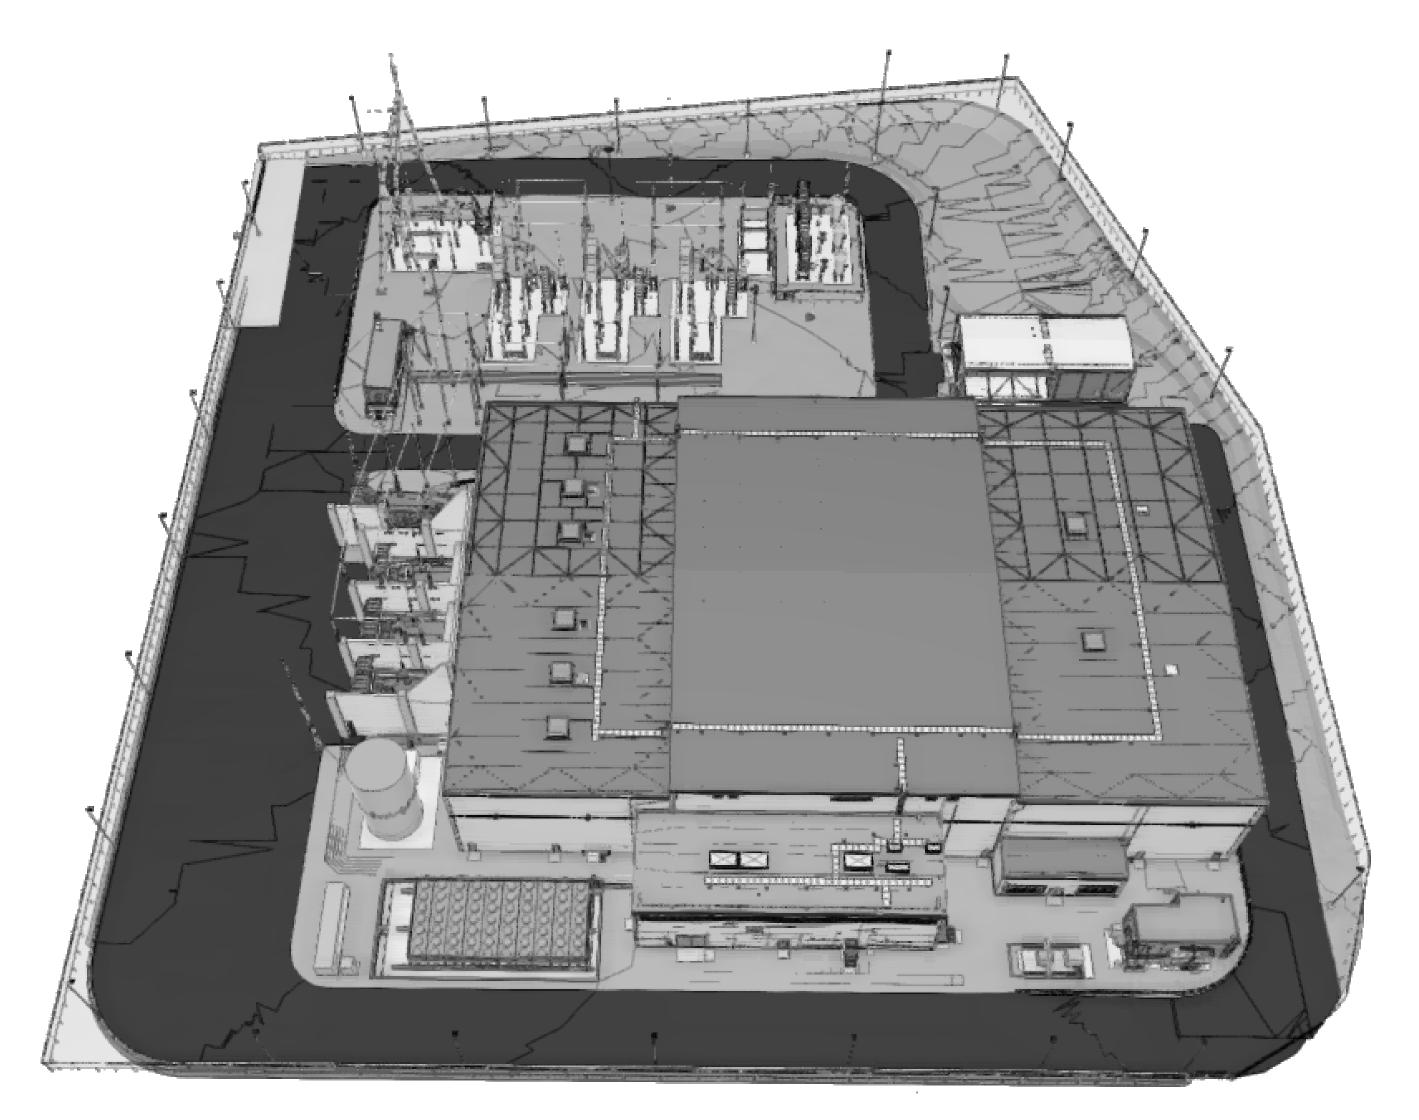

1 OVERALL SITE VIEW N.T.S.

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370 7th Avenue SUITE 1604 New York, NY 1000

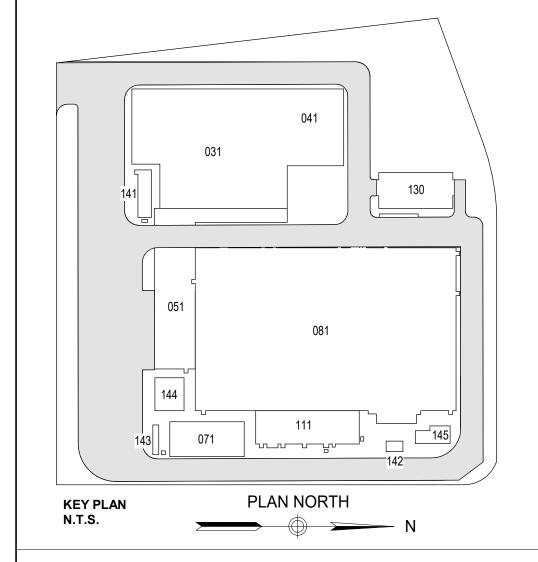

25 Mohawk Avenue Sparta, NJ 07871

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	В	FINAL SUBMISSION	VSP	EK	11/08/2022
	Α	INTERIM SUBMISSION	VSP	EK	09/13/2022
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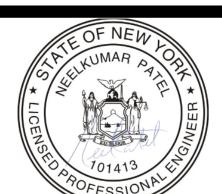
PROJECT



# Astoria HVDC Converter Station

31-45 20<sup>th</sup> Avenue, Astoria, Queens NY 11105 Block #850 - Lot #310 - BIN #4624437

**COVER SHEET** 



		DATE	11/08/2022
		PROJECT NO	105121
١		DRAWING BY	V. PATEL
١	١	CHECKED BY	E. KIDANE
I		DRAWING NO	
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Autodesk Docs://CHPE 1 of 26

#### **GENERAL NOTES:**

- 1. THE PLANS SHOW SUBSURFACE STRUCTURES, ABOVE GROUND STRUCTURES, AND/OR UTILITIES FROM FIELD LOCATION AND RECORD MAPPING, EXACT LOCATION OF WHICH MAY VARY FROM THE LOCATIONS INDICATED. IN PARTICULAR, THE CONTRACTOR IS WARNED THAT THE EXACT OR EVEN APPROXIMATE LOCATION OF SUCH PIPELINES, SUBSURFACE STRUCTURES, AND/OR UTILITIES IN THE AREA MAY BE DIFFERENT FROM THAT SHOWN OR MAY NOT BE SHOWN, AND IT SHALL BE HIS RESPONSIBILITY TO PROCEED WITH GREAT CARE IN EXECUTING ANY WORK. 48 HOURS BEFORE YOU DIG, DRILL, OR BLAST, CALL UNDERGROUND FACILITIES PROTECTION ORGANIZATION (UFPO) 1-(800)-962-7962 TOLL FREE.
- 2. THE ENGINEER SHALL BE NOTIFIED IN WRITING OF ANY CONDITIONS THAT VARY FROM THOSE SHOWN ON THE PLANS. THE CONTRACTOR'S WORK SHALL NOT VARY FROM THE PLANS WITHOUT THE PRIOR APPROVAL OF THE ENGINEER.
- 3. THE CONTRACTOR SHALL PROTECT AND PRESERVE ALL PUBLIC AND PRIVATE PROPERTY, INCLUDING ALL EXISTING VEGETATION, EXISTING LANDSCAPE FEATURES, AND MONUMENTS WITHIN, ALONG, AND ADJACENT TO THE PROPERTY. ALL AREAS DISTURBED BY THE CONTRACTOR SHALL BE RESTORED TO A PLEASING AND ACCEPTABLE CONDITION.
- 4. THE CONTRACTOR SHALL BE RESPONSIBLE FOR OBTAINING AND INCURRING THE COST OF ALL REQUIRED PERMITS, INSPECTIONS, CERTIFICATES, ETC. AND SHALL COMPLY WITH ALL REQUIRED PERMITS.
- 5. ALL WORK SHALL BE DONE IN STRICT COMPLIANCE WITH ALL APPLICABLE NATIONAL, STATE, AND LOCAL CODES, STANDARDS, ORDINANCES, RULES, AND
- 6. ALL PROPOSED UTILITIES AND APPURTENANCES SHALL BE CONSTRUCTED IN COMPLIANCE WITH THE LOCAL MUNICIPALITIES' CODES AND REGULATIONS GOVERNING THE INSTALLATION OF SUCH UTILITIES.
- 7. THE ENGINEER RESERVES THE RIGHT TO EXAMINE ANY WORK DONE ON THIS PROJECT AT ANY TIME TO DETERMINE THE CONFORMANCE WITH THE REQUIREMENTS OF THE CONTRACT DOCUMENTS OF THIS PROJECT.
- 8. THE CONTRACTOR SHALL PROTECT EXISTING PROPERTY LINE MONUMENTATION. ANY MONUMENTATION DISTURBED OR DESTROYED, AS JUDGED BY THE ENGINEER OR OWNER, SHALL BE REPLACED AT THE CONTRACTOR'S EXPENSE UNDER THE SUPERVISION OF A NEW YORK STATE LICENSED LAND SURVEYOR.
- 9. IT IS THE CONTRACTOR'S RESPONSIBILITY TO EXAMINE ALL PLAN SHEETS AND COORDINATE WORK WITH ALL OTHER CONTRACTS FOR THE SITE.
- 10. THE CONTRACTOR SHALL:
  - 10.A. VERIFY ALL CONDITIONS IN THE FIELD PRIOR TO COMMENCEMENT OF WORK AND NOTIFY THE ENGINEER OF ANY DISCREPANCIES.
  - 10.B. EXAMINE THE SITE AND INCLUDE IN HIS WORK THE EFFECT OF ALL EXISTING CONDITIONS ON THE WORK.
  - 10.C. PROVIDE AND INSTALL ALL MATERIALS AND PERFORM ALL WORK IN ACCORDANCE WITH GOOD STANDARD PRACTICE.
- 11. ALL TRENCH EXCAVATION AND ANY REQUIRED SHEETING AND SHORING SHALL BE DONE IN ACCORDANCE WITH THE LATEST REVISIONS OF NEW YORK CITY BUILDING CODE CHAPTER 33 AND OSHA REGULATIONS FOR CONSTRUCTION. SHEET PILING SHALL BE DESIGNED AND SEALED BY A NEW YORK STATE LICENSED PROFESSIONAL ENGINEER.
- 12. CONTRACTOR SHALL BE RESPONSIBLE FOR ROUTINE DEWATERING RELATED TO THE MAINTENANCE OF SURFACE DRAINAGE DURING THE COURSE OF WORK. CONTRACTOR SHALL MAINTAIN EXISTING SITE DRAINAGE PATTERNS THROUGHOUT CONSTRUCTION UNLESS OTHERWISE SHOWN ON THE PLANS. DEWATERING FOR MAJOR CONSTRUCTION ITEMS IS NOT THE RESPONSIBILITY OF THE CONTRACTOR AND SHALL BE PERFORMED BY TDI.
- 13. CONTRACTOR SHALL NOT DISRUPT SERVICE TO ANY UTILITIES WITHOUT PRIOR COORDINATION WITH UTILITY OWNER.
- 14. ALL FRAMES/COVERS WITHIN PAVED AREAS SHALL HAVE THE TOPS SET FLUSH WITH THE FINAL PAVEMENT GRADE. IN LANDSCAPED AREAS, ALL FRAMES SHALL BE 0.1' ABOVE GRADE.
- 15. THE CONTRACTOR SHALL BE RESPONSIBLE FOR PROVIDING ALL FIELD LAYOUT. THE CONTRACTOR SHALL PROVIDE MARKED-UP AS-BUILT PLANS FOR ALL UTILITIES SHOWING TIE-IN AND CONNECTIONS, BENDS, VALVES, LENGTHS OF LINES, AND INVERTS. AS-BUILT PLANS FOR ALL UTILITIES SHOWING TIES TO CONNECTIONS, BENDS, VALVES, LENGTHS OF LINES, AND INVERTS. AS-BUILT PLANS SHOWING ALL UNDERGROUND UTILITIES INSTALLED OR ENCOUNTERED SHALL BE SUBMITTED TO THE OWNER AND HIS REPRESENTATIVES.
- 16. CONTRACTOR SHALL MAINTAIN ALL TRAFFIC IN ALL AREAS (INCLUDING THE ADJACENT ROADWAYS TO THE SITE AND CONSTRUCTION VEHICLE ENTRANCE AND EXIT TO THE SITE) AS PER COORDINATION WITH ADJACENT PROPERTY OWNERS.
- 17. ALL EXCAVATIONS SHALL BE PROTECTED AT THE END OF EACH WORK DAY.
- 18. CONTRACTOR SHALL TAKE CARE TO PREVENT DAMAGE TO EXISTING UTILITIES. DAMAGED UTILITIES SHALL BE IMMEDIATELY REPAIRED BY THE CONTRACTOR AT THE CONTRACTOR'S EXPENSE. IF DURING EXCAVATION PREVIOUSLY DAMAGED UTILITIES ARE UNCOVERED, CONTRACTOR SHALL DOCUMENT THE DAMAGE AND REPORT DAMAGE TO THE APPROPRIATE OWNER.
- 19. THE CONTRACTOR MUST COORDINATE HIS SCHEDULE OF OPERATIONS WITH THE VARIOUS UTILITY OWNERS INVOLVED WITH THE PROJECT AND SHALL VERIFY UTILITY INFORMATION FOUND IN THE CONTRACT DOCUMENTS.
- 20. PRIOR TO THE COMMENCEMENT OF CONSTRUCTION, TDI SHALL COORDINATE WITH ALL THE KNOWN PUBLIC AND PRIVATE UTILITY COMPANIES THAT MAY HAVE POTENTIAL IMPACT TO OVERHEAD AND UNDERGROUND UTILITIES FROM THE CONTRACTORS WORK. THE CONTRACTOR SHALL, AT THIS MEETING, INFORM THE UTILITY COMPANIES OF HIS SCHEDULE OF OPERATIONS SO THAT UTILITY COMPANIES PLAN AND SCHEDULE THEIR ACTIVITIES ACCORDINGLY.
- 21. THE CONTRACTOR IS GOVERNED BY AND MUST ADHERE TO THE PROVISIONS OF THE 16 NYCRR PART 753, "PROTECTION OF UNDERGROUND FACILITIES." AND ALL ITS AMENDMENTS; I.E. CALL 811 DIG SAFE PRIOR TO BREAKING GROUND
- 22. THE CONTRACTOR SHALL CONDUCT ALL OPERATIONS IN ACCORDANCE WITH ALL OSHA RULES AND REGULATIONS AND IN ACCORDANCE WITH NEW YORK STATE LABOR LAW, SECTION 202-H, "THE HIGH VOLTAGE PROXIMITY ACT."
- 23. REFER TO FLOOD INSURANCE RATE MAP (FIRM) NUMBER 3604970092G FOR THE PROJECT SITE. THE SPECIAL FLOOD HAZARD AREA TYPE IS ZONE AE AND X. BASE FLOOD ELEVATION IS 13' AND DESIGN FLOOD ELEVATION IS 15'.
- 24. EXISTING IMPERVIOUS SURFACE AREA WITHIN THE PROPERTY LIMITS TOTALS 4.36 ACRES, WHILE PROPOSED IMPERVIOUS SURFACE AREA TOTALS 7.77 ACRES.


#### FL FLOOD

- FL-1. THE SITE IS DEFINED AS A ZONE (NON-COASTAL).
- FL-2. BASE FLOOD ELEVATION, BFE, = 13 FEET NAVD 88.
- FL-3. RECOMMENDED FREE BOARD BY THE 2022 NYCBC-APPENDIX G IS 2.0 FEET.
- FL-4. RECOMMENDED DESIGN FLOOD ELEVATION, DFE = 15 FEET NAVD 88.
- FL-5. THE STRUCTURE IS NOT SUBJECTED TO HYDRODYNAMIC LOADS.

DESIGN ELEVATION / DEPTH	FEET IN NAVD 88
DESIGN BASE FLOOD ELEVATION	13.0
FINISH FLOOR ELEVATION	15.0
SEA LEVEL RISE	NOT CONSIDERED

FEMA FIRM PANEL 3604970092:

# FLOOD INSURANCE RATE MAP 2007 **ELEVATIONS IN NAVD 88** OCATION ON SITE FLOOD INSURANCE RATE MAP 2015 ELEVATIONS IN NAVD 88 FIRM IS PRELIMINARY

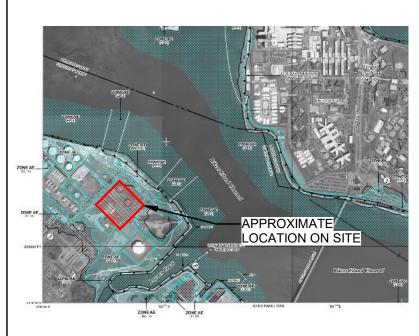


# LIST OF SPECIFICATIONS:


05 - METALS	050001	GENERAL PROVISIONS
05 - METALS	055200	HANDRAILS AND RAILINGS
31 - EARTHWORK	310001	GENERAL PROVISIONS
31 - EARTHWORK	312319	DEWATERING
32 - EXTERIOR IMPROVEMENTS	320001	GENERAL PROVISIONS
32 - EXTERIOR IMPROVEMENTS	321416	BRICK UNIT PAVING
32 - EXTERIOR IMPROVEMENTS	323113	CHAIN LINK FENCES AND GATES
34 - TRANSPORTATION	347113	VEHICLE BARRIERS

SITE CIVIL SHEET INDEX	
DRAWING TITLE	DWG. NO.
GENERAL NOTES	C-001.00
LEGEND AND ABBREVIATIONS	C-002.00
OVERALL SITE PLAN	C-100.00
OVERALL GRADING PLAN	C-101.00
SITE SECTIONS 1	C-102.00
SITE SECTIONS 2	C-103.00
ACCESS ROAD PROFILES 1	C-104.00
ACCESS ROAD PROFILES 2	C-105.00
TURNING MOVEMENT PLAN - FDNY SEAGRAVE TRUCK (ALTERNATIVE 1)	C-106.00
TURNING MOVEMENT PLAN - FDNY SEAGRAVE TRUCK (ALTERNATIVE 2)	C-107.00
TURNING MOVEMENT PLAN - FDNYSEAGRAVE TRUCK (ALTERNATIVE 3)	C-108.00
TURNING MOVEMENT PLAN - HL-93 TRUCK (ALTERNATIVE 1)	C-109.00
TURNING MOVEMENT PLAN - HL-93 TRUCK (ALTERNATIVE 2)	C-110.00
TURNING MOVEMENT PLAN - HL-93 TRUCK (ALTERNATIVE 3)	C-111.00
TURNING MOVEMENT PLAN - HL-93 TRUCK STORAGE ENCLOSURE DRIVEWAY	C-112.00
TURNING MOVEMENT VEHICLE DETAILS	C-113.00
TURNING MOVEMENT VERTICAL PROFILE - FDNY SEAGRAVE TRUCK	C-114.00
TURNING MOVEMENT VERTICAL PROFILE - FDNY SEAGRAVE TRUCK	C-115.00
TURNING MOVEMENT VERTICAL PROFILE - FDNY SEAGRAVE TRUCK	C-116.00
TURNING MOVEMENT VERTICAL PROFILE - AASHTO HL-93 TRUCK	C-117.00
TURNING MOVEMENT VERTICAL PROFILE - AASHTO HL-93 TRUCK	C-118.00
TURNING MOVEMENT VERTICAL PROFILE - AASHTO HL-93 TRUCK	C-119.00
GUIDE RAIL LAYOUT DETAILS	C-120.00
FENCE, GUARD RAIL, AND BOLLARD DETAILS	C-121.00
NYSDOT THRIE BEAM BRIDGE RAIL DETAILS	C-122.00



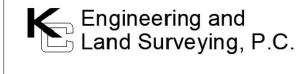

370 7th Avenue **SUITE 1604** New York, NY 10001

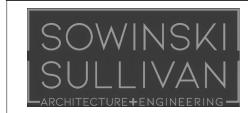

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В	FINAL SUBMISSION	AB	JL	11/8/22
Α	INTERIM SUBMISSION	NS	JL	8/29/22
RE\/	DESCRIPTION	DRW BY	CHK BY	DATE




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### **Astoria HVDC Converter Station**

31-45 20th Avenue, Astoria, Queens NY 11105 Block #850 - Lot #310 - BIN #4624437


**GENERAL NOTES** 



NOVEMBER 8, 2022 A.BUDARAPU HECKED BY J.LLORENTE DRAWING NO

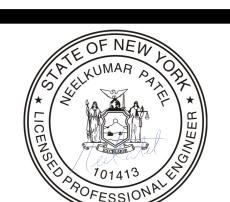C-001.00

#### LEGENDS & SYMBOLS

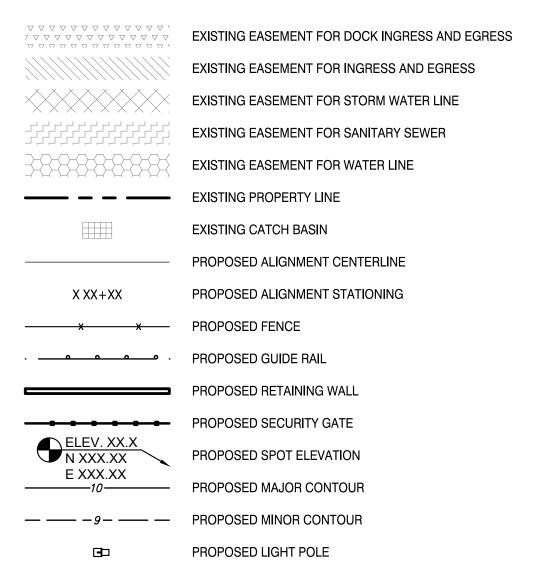

#### **ABBREVIATIONS**

AASHTO = AMERICAN ASSOCIATION OF STATE HIGHWAY AND TRANSPORTATION OFFICIALS AC = ALTERNATING CURRENT

OC = ON CENTER

PVMT = PAVEMENT

STA = STATION

TYP = TYPICAL

RD = ROAD

REQ'D = REQUIRED

REV = REVISION

RF = REAR FACE

WM = WATER MAIN

WWF = WELDED WIRE FABRIC

WZTC = WORK ZONE TRAFFIC CONTROL

WT = WEIGHT

YR = YEAR

OD = OUTER DIAMETER

PCC = PORTLAND CEMENT CONCRETE

PVI = POINT OF VERTICAL INTERSECTION

PCD = PRECAST CONCRETE DUCTS

RCP = REINFORCED CONCRETE PIPE

OSHA = OCCUPATIONAL SAFETY AND HEALTH ADMINISTRATION

AD = TANGENT OFFSET AT PVI

APPROX = APPROXIMATE

ASCE = AMERICAN SOCIETY OF CIVIL ENGINEERS

ASTM = AMERICAN SOCIETY OF TESTING AND MATERIALS BVCE = BEGINING OF VERTICAL CURVE ELEVATION

BVCS = BEGINING OF VERTICAL CURVE STATION

CB = CATCH BASIN

CIP = CAST IN PLACE

CONC = CONCRETE

DIA = DIAMETER

DIP = DUCTILE IRON PIPE

DGA = DENSE GRADED AGGREGATE

E = EPOXY COATED REBAR

ELEV = ELEVATION

EVCE = END OF VERTICAL CURVE ELEVATION

EVCS = END OF VERTICAL CURVE STATION

EXIST = EXISTING

FF = FRONT FACE

FDNY = NEW YORK CITY FIRE DEPARTMENT

FFE = FINISHED FLOOR ELEVATION

HDPE = HIGH DENSITY POLYETHYLENE

HPBO = HEAVY POST BLOCK OUT

HVAC = HEATING, VENTILATION AND AIR CONDITIONING

HVE = HIGH VOLTAGE ELECTRIC

ID = INNER DIAMETER

IPS = IRON PIPE SIZE

LBS = POUNDS

LF = LINEAR FEET

LVC = LENGTH OF VERTICAL CURVE

MAX = MAXIMUM

MH = MANHOLE

MIN = MINIMUM

MPT = MAINTENANCE AND PROTECTION OF TRAFFIC

MTS = MANUAL TRANSFER SWITCH

MVS = MEDIUM VOLTAGE SWITCHGEAR

N/A = NOT APPLICABLE

NTS = NOT TO SCALE

NYC = NEW YORK CITY

NYCDOT = NEW YORK CITY DEPARTMENT OF TRANSPORTATION

NYCDEP = NEW YORK CITY DEPARTMENT OF ENVIRONMENTAL PROTECTION

NYCRR = NEW YORK CITY CODES, RULES AND REGULATIONS

NYSDOT = NEW YORK STATE DEPARTMENT OF TRANSPORTATION

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Engineering and Land Surveying, P.C.

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В	FINAL SUBMISSION	AB	JL	11/8/22
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**PROJECT** 



## **Astoria HVDC Converter Station**


31-45 20th Avenue, Astoria, Queens NY 11105 Block #850 - Lot #310 - BIN #4624437


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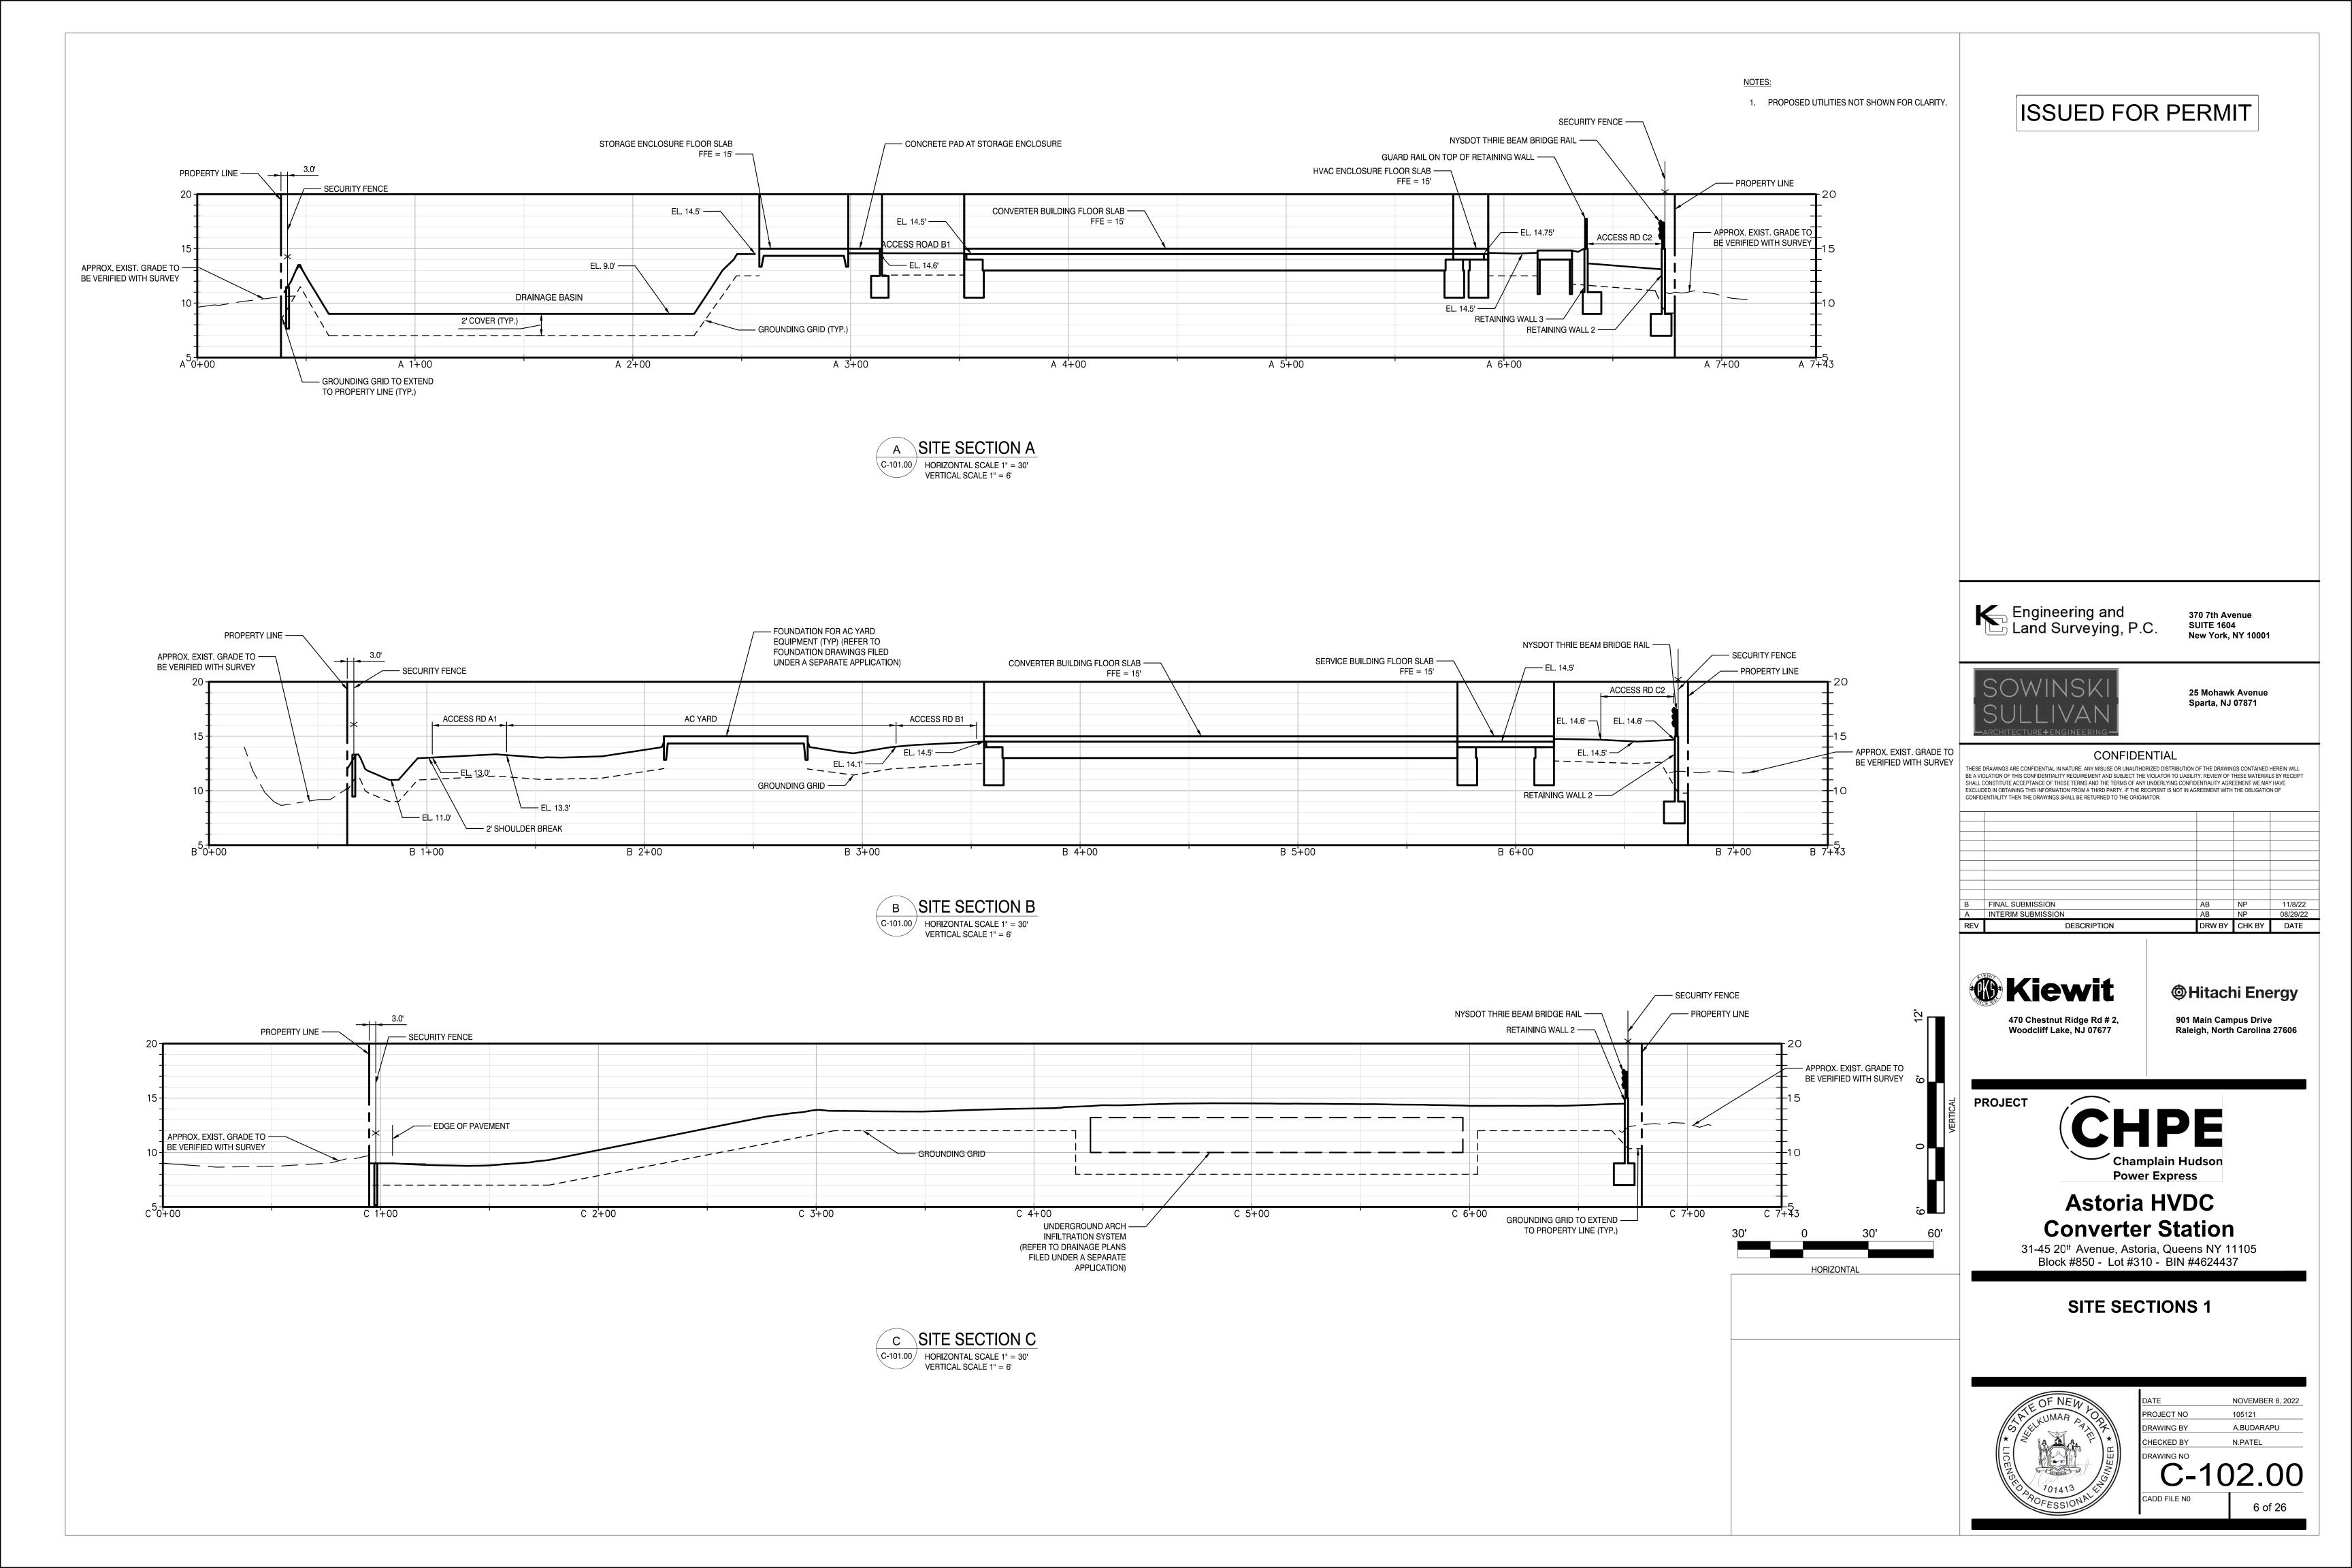


November 8, 2022 CHECKED BY J.LLORENTE


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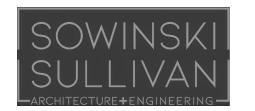
D SITE SECTION D

C-101.00 HORIZONTAL SCALE 1" = 30'

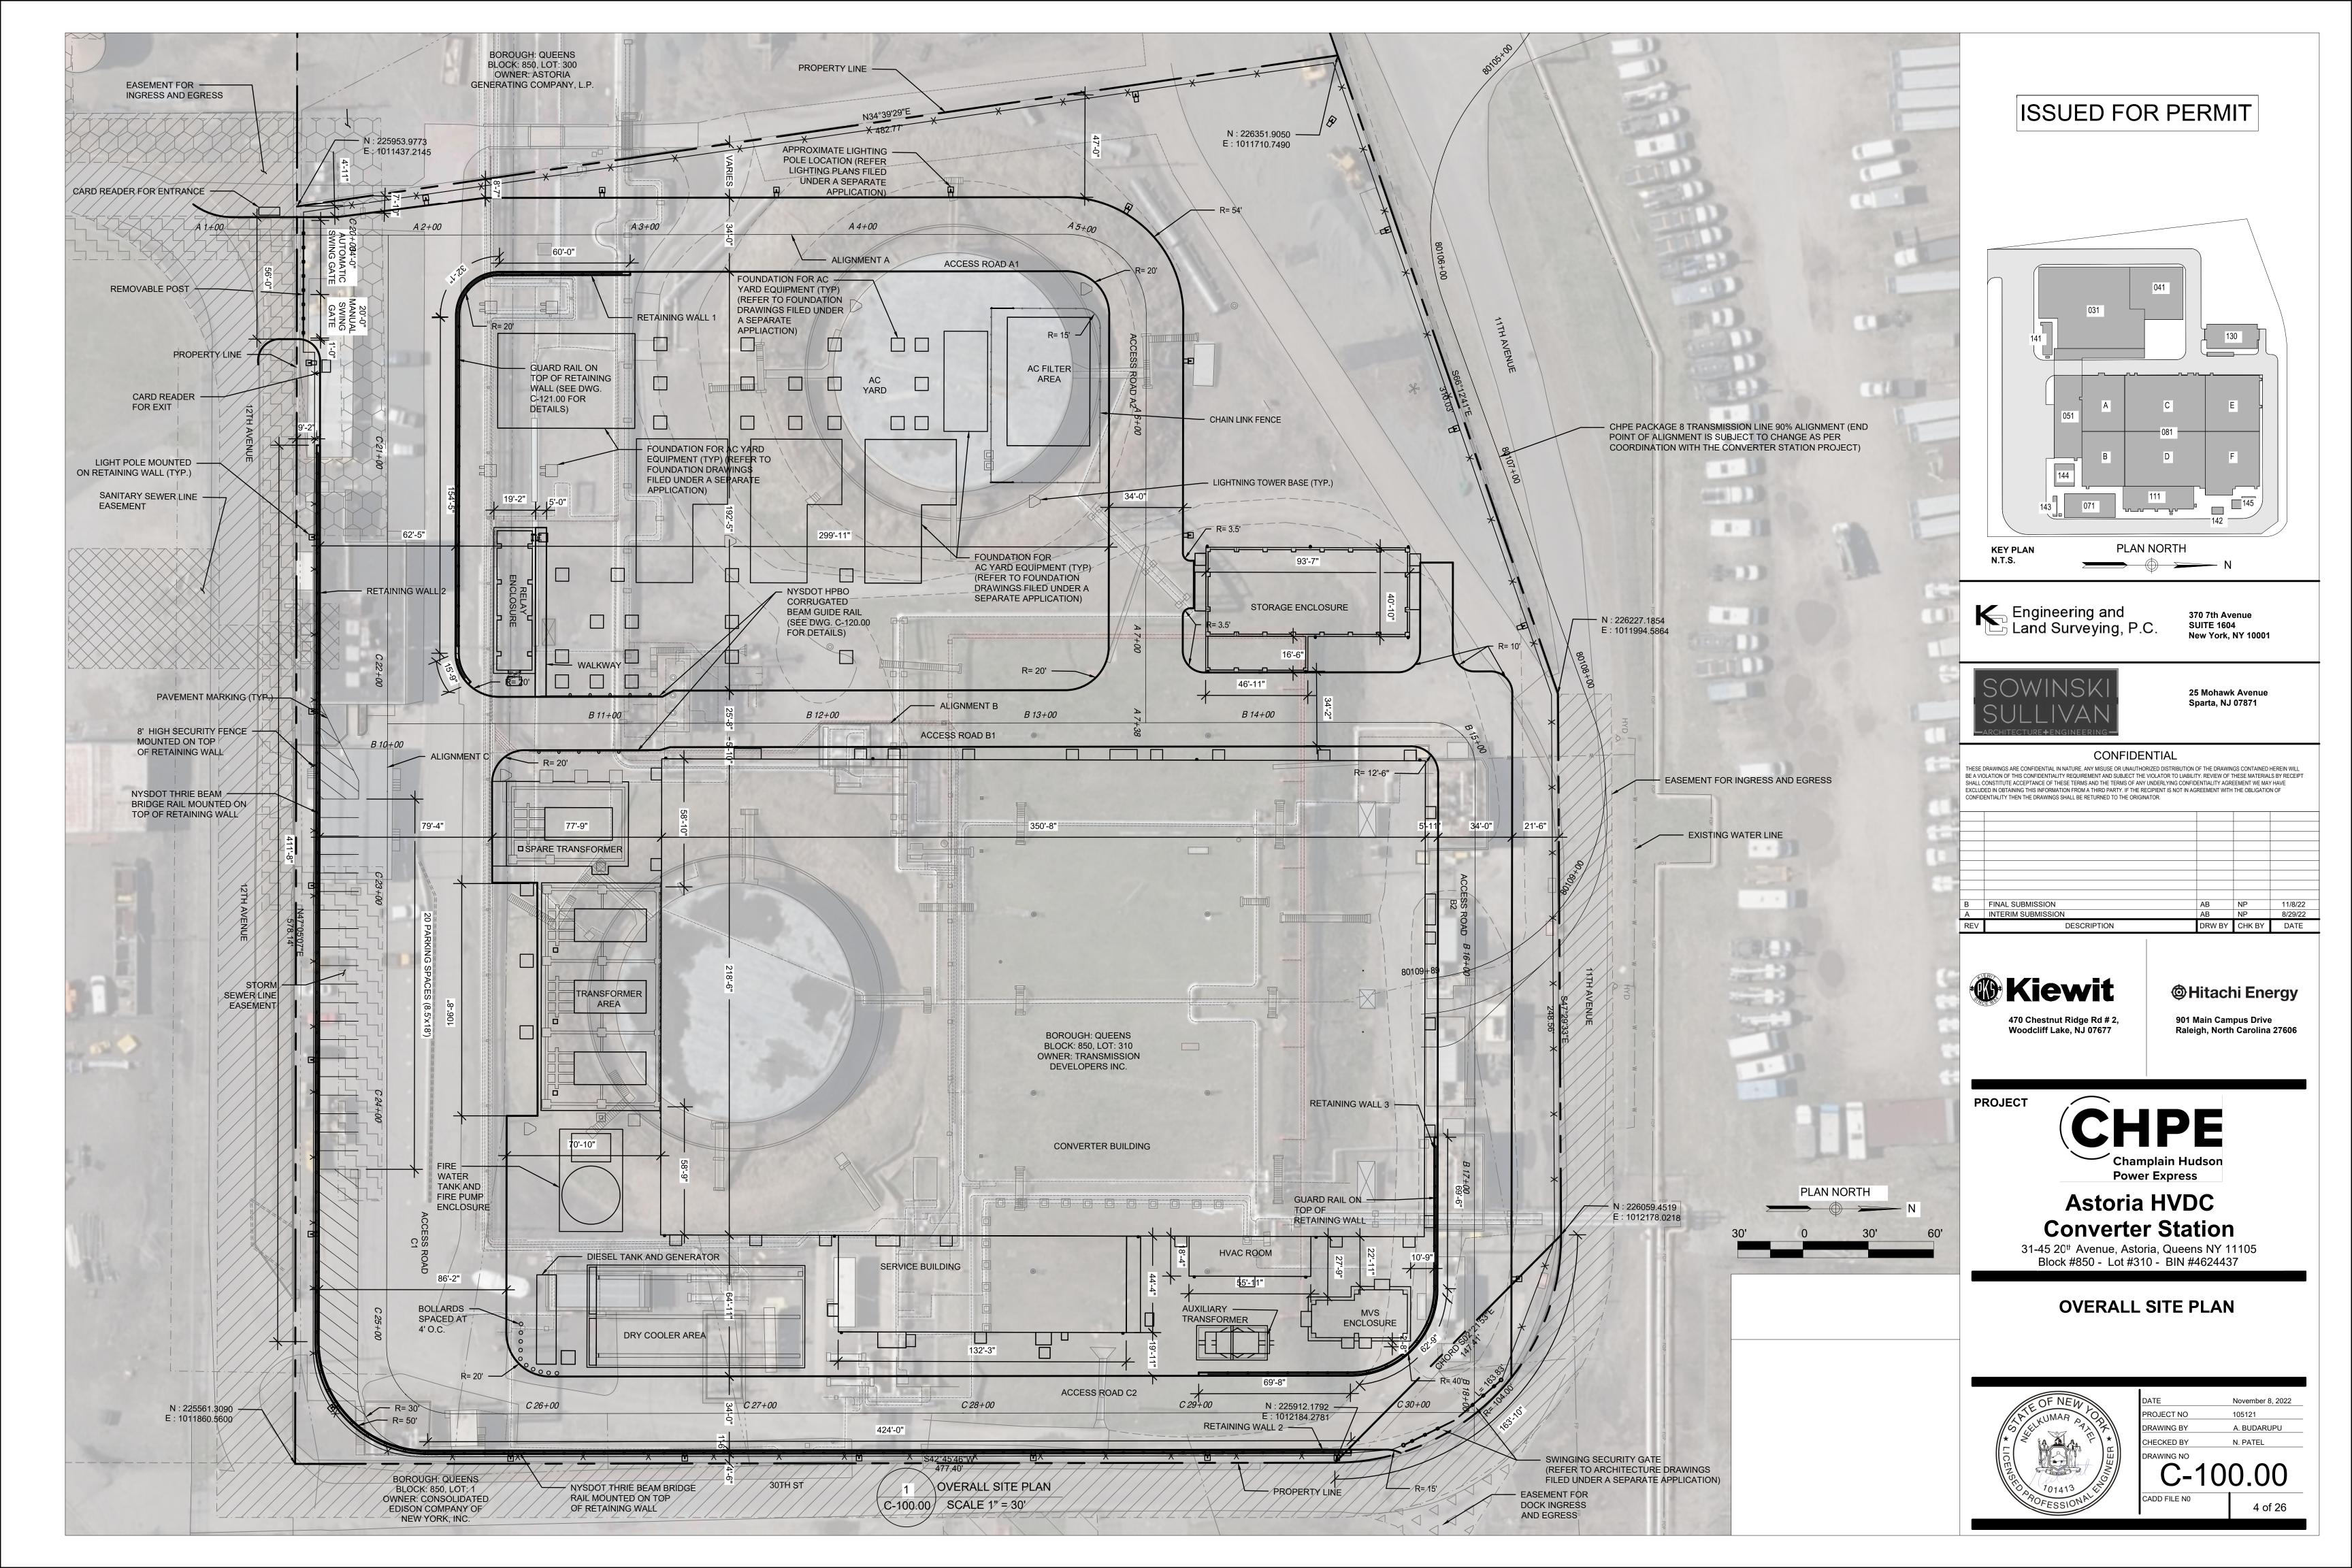VERTICAL SCALE 1" = 6'
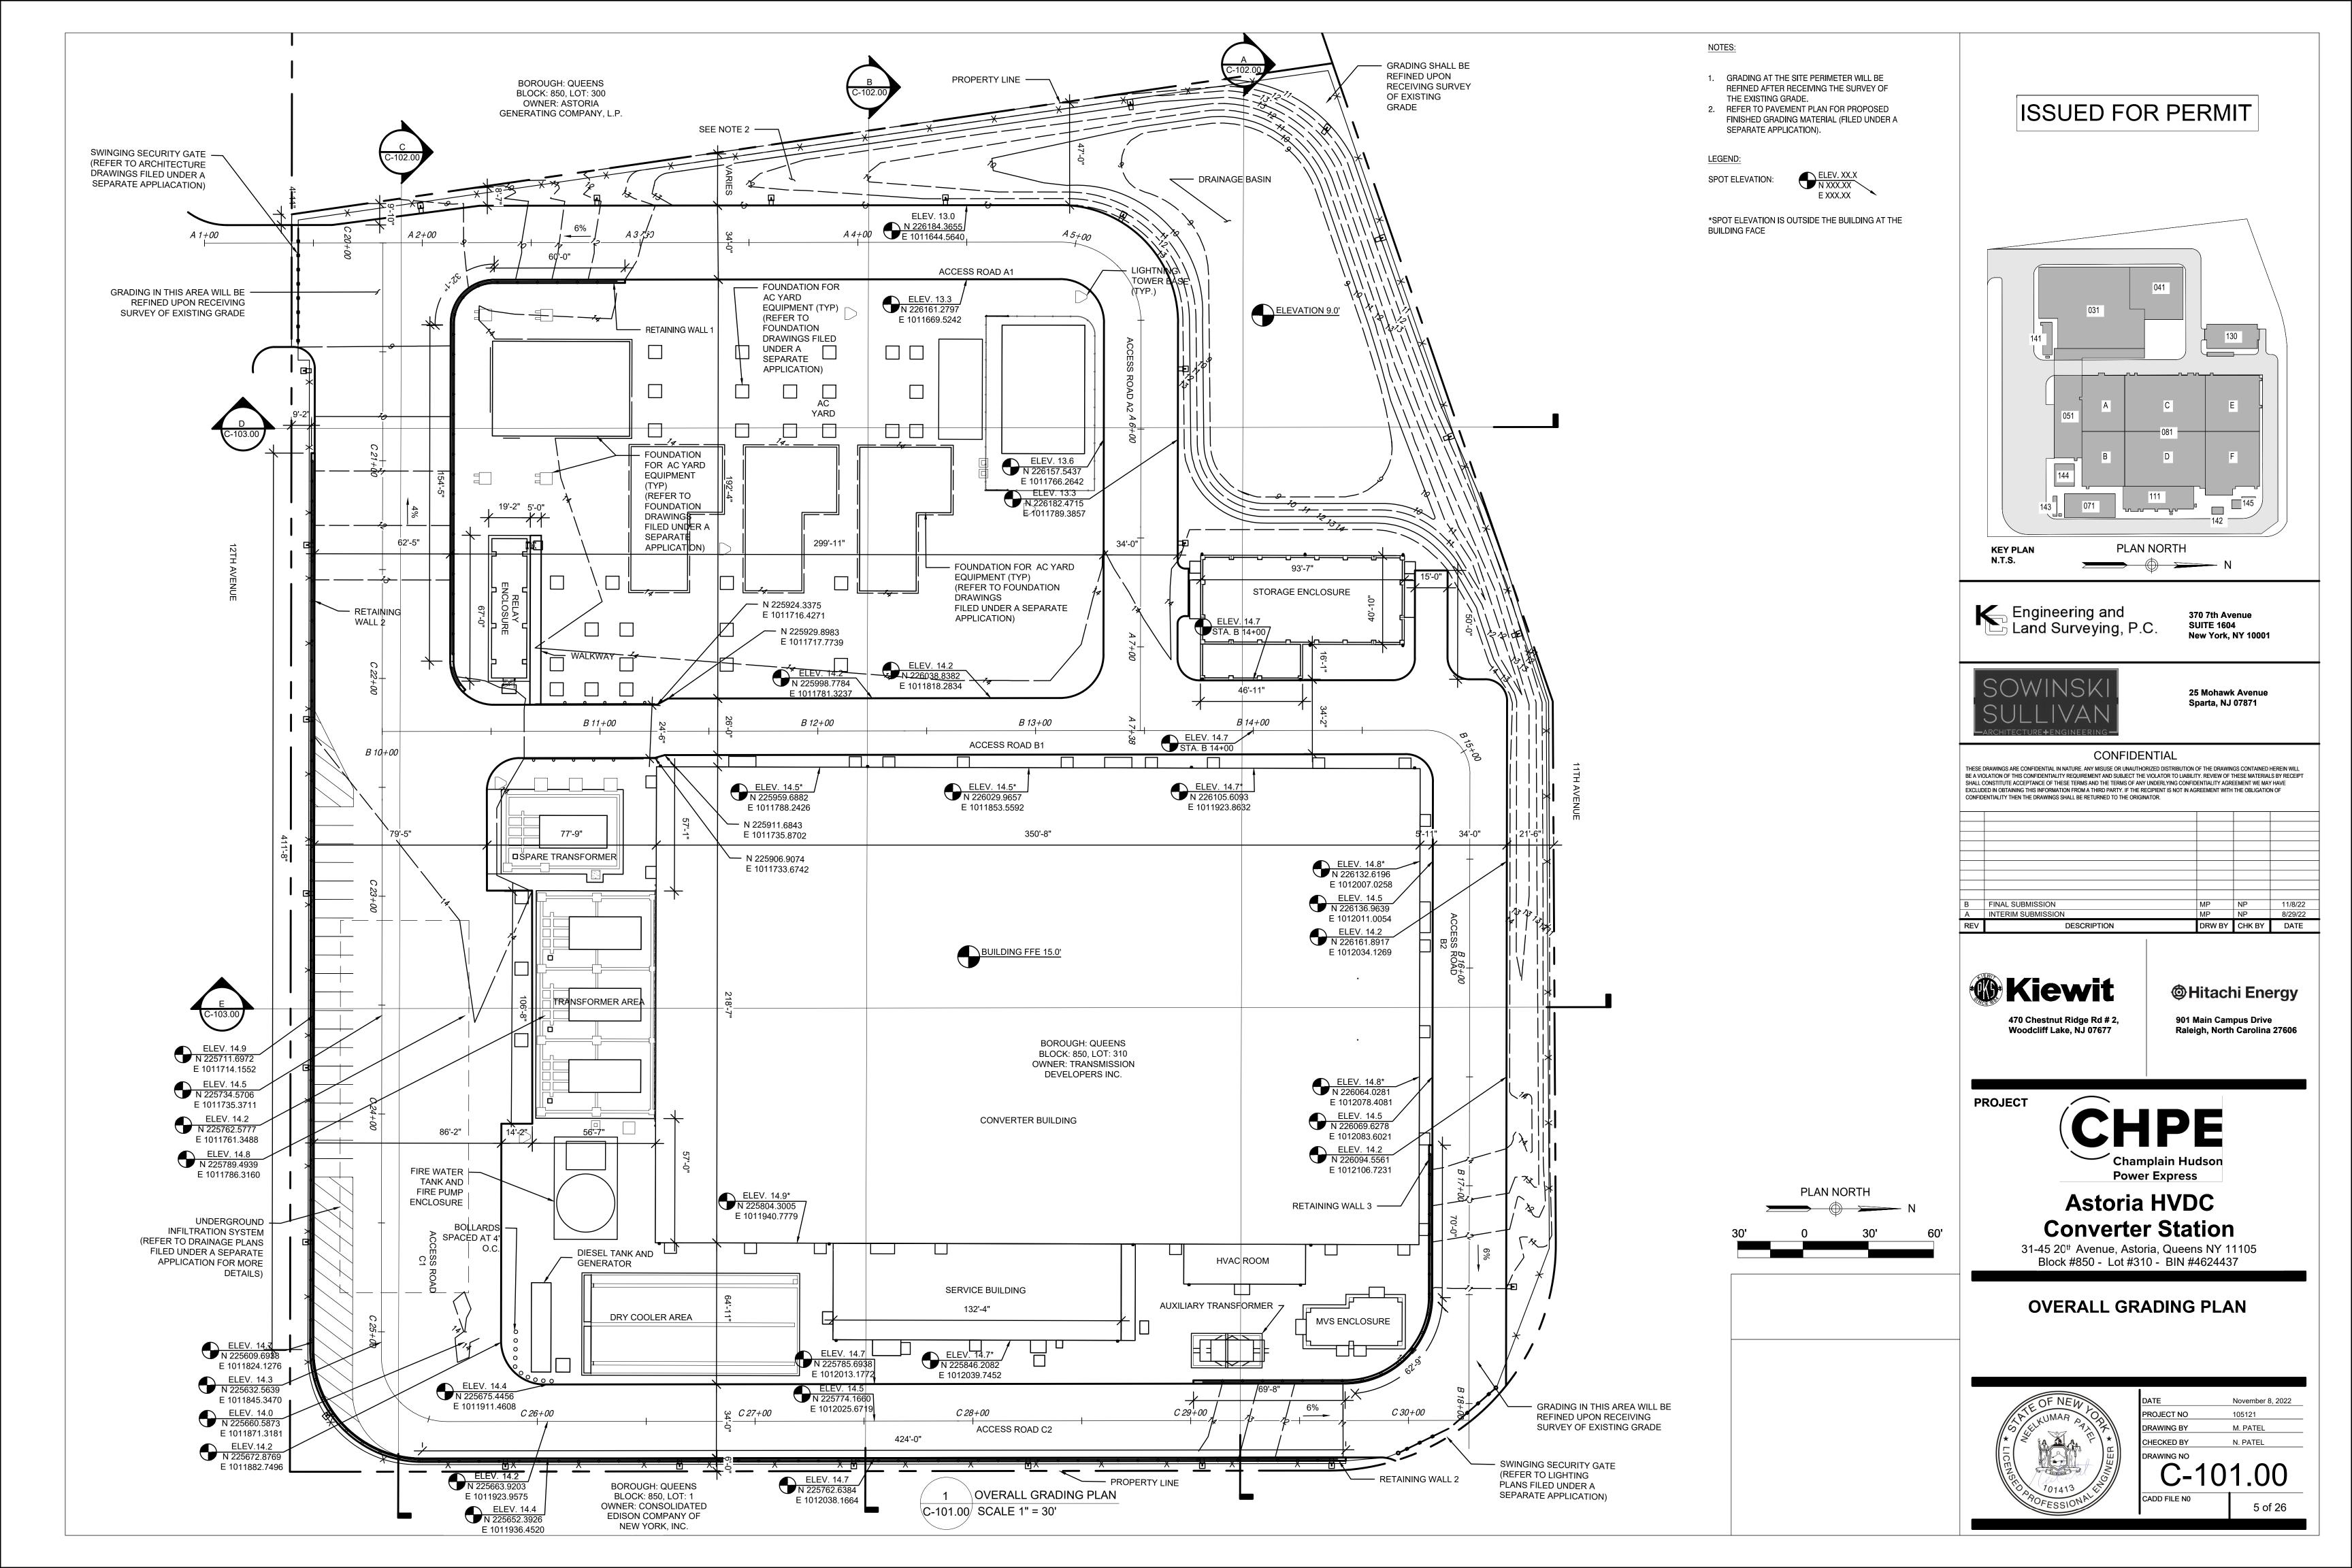
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PROJECT CHPE

Champlain Hudson

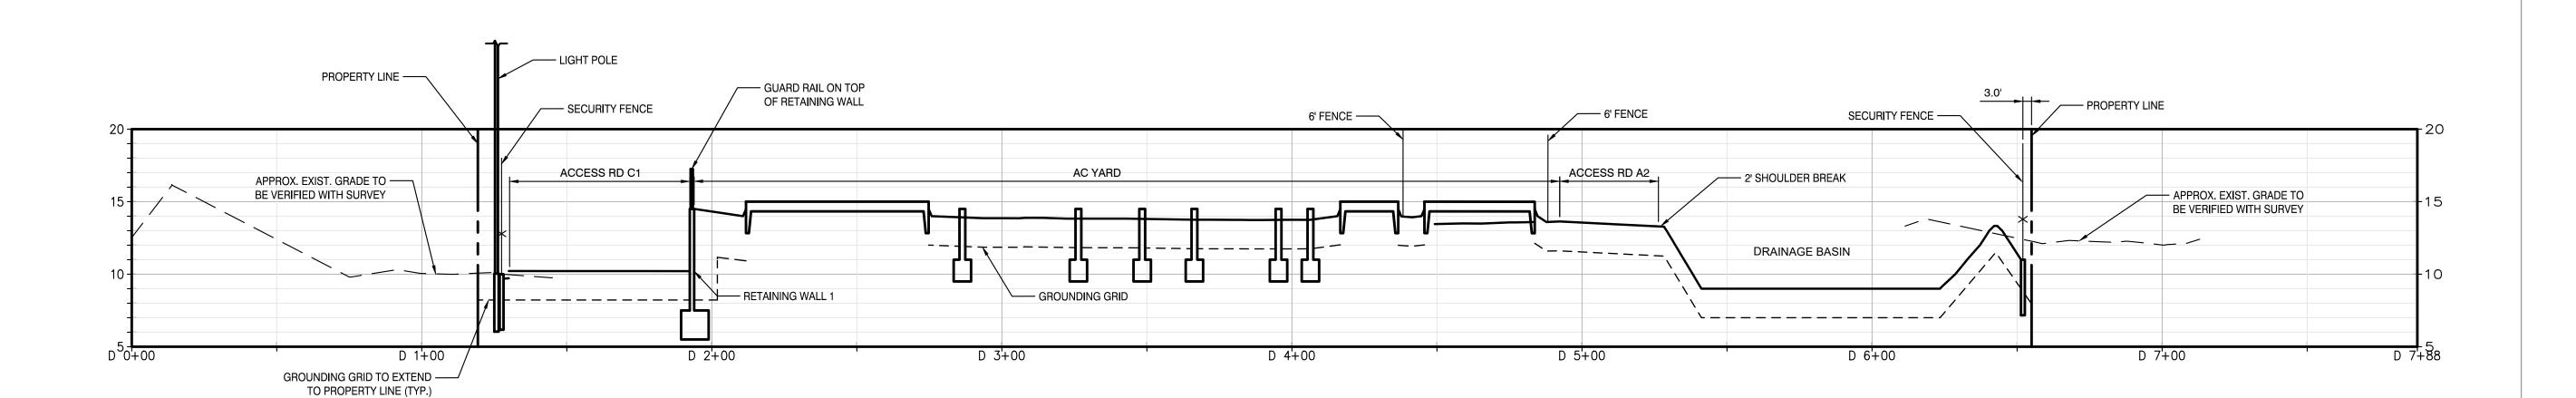
Astoria HVDC Converter Station

**Power Express** 

31-45 20<sup>th</sup> Avenue, Astoria, Queens NY 11105 Block #850 - Lot #310 - BIN #4624437

Block #850 - Lot #310 - BIN #462443

SITE SECTIONS 2

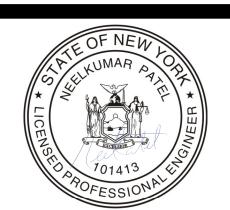



DATE NOVEMBER 8,2022
PROJECT NO 105121
DRAWING BY A.BUDARAPU
CHECKED BY N.PATEL
DRAWING NO


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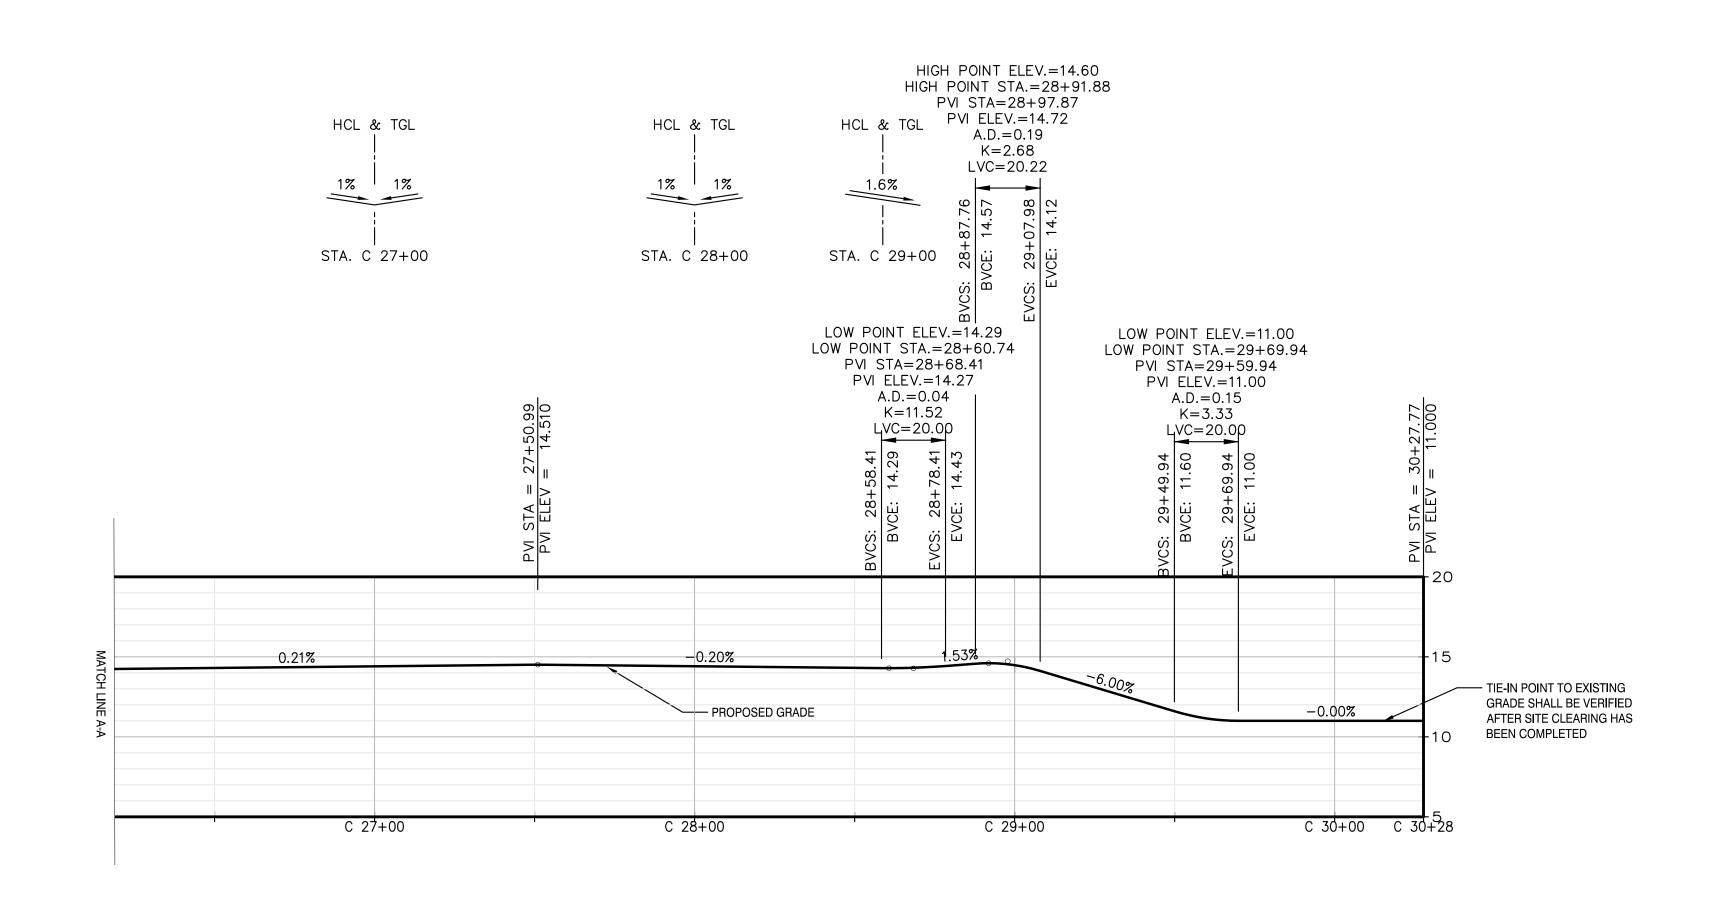
31-45
BIO

HORIZONTAL



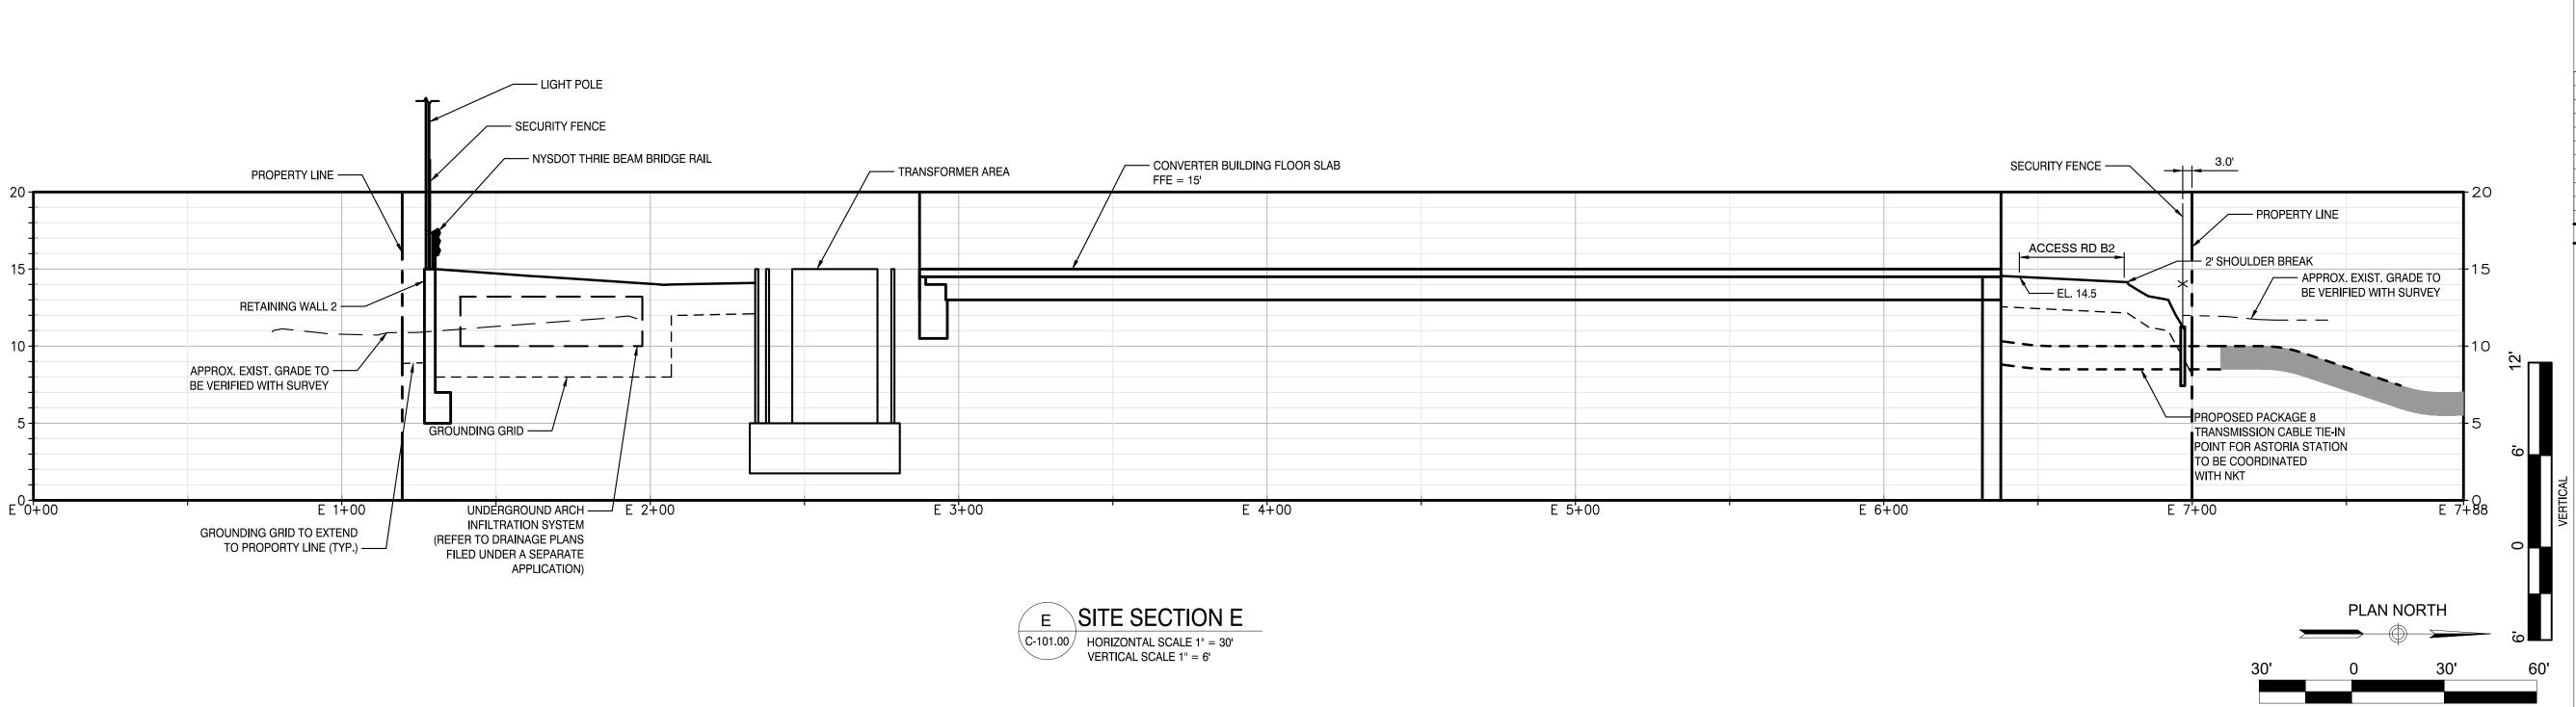

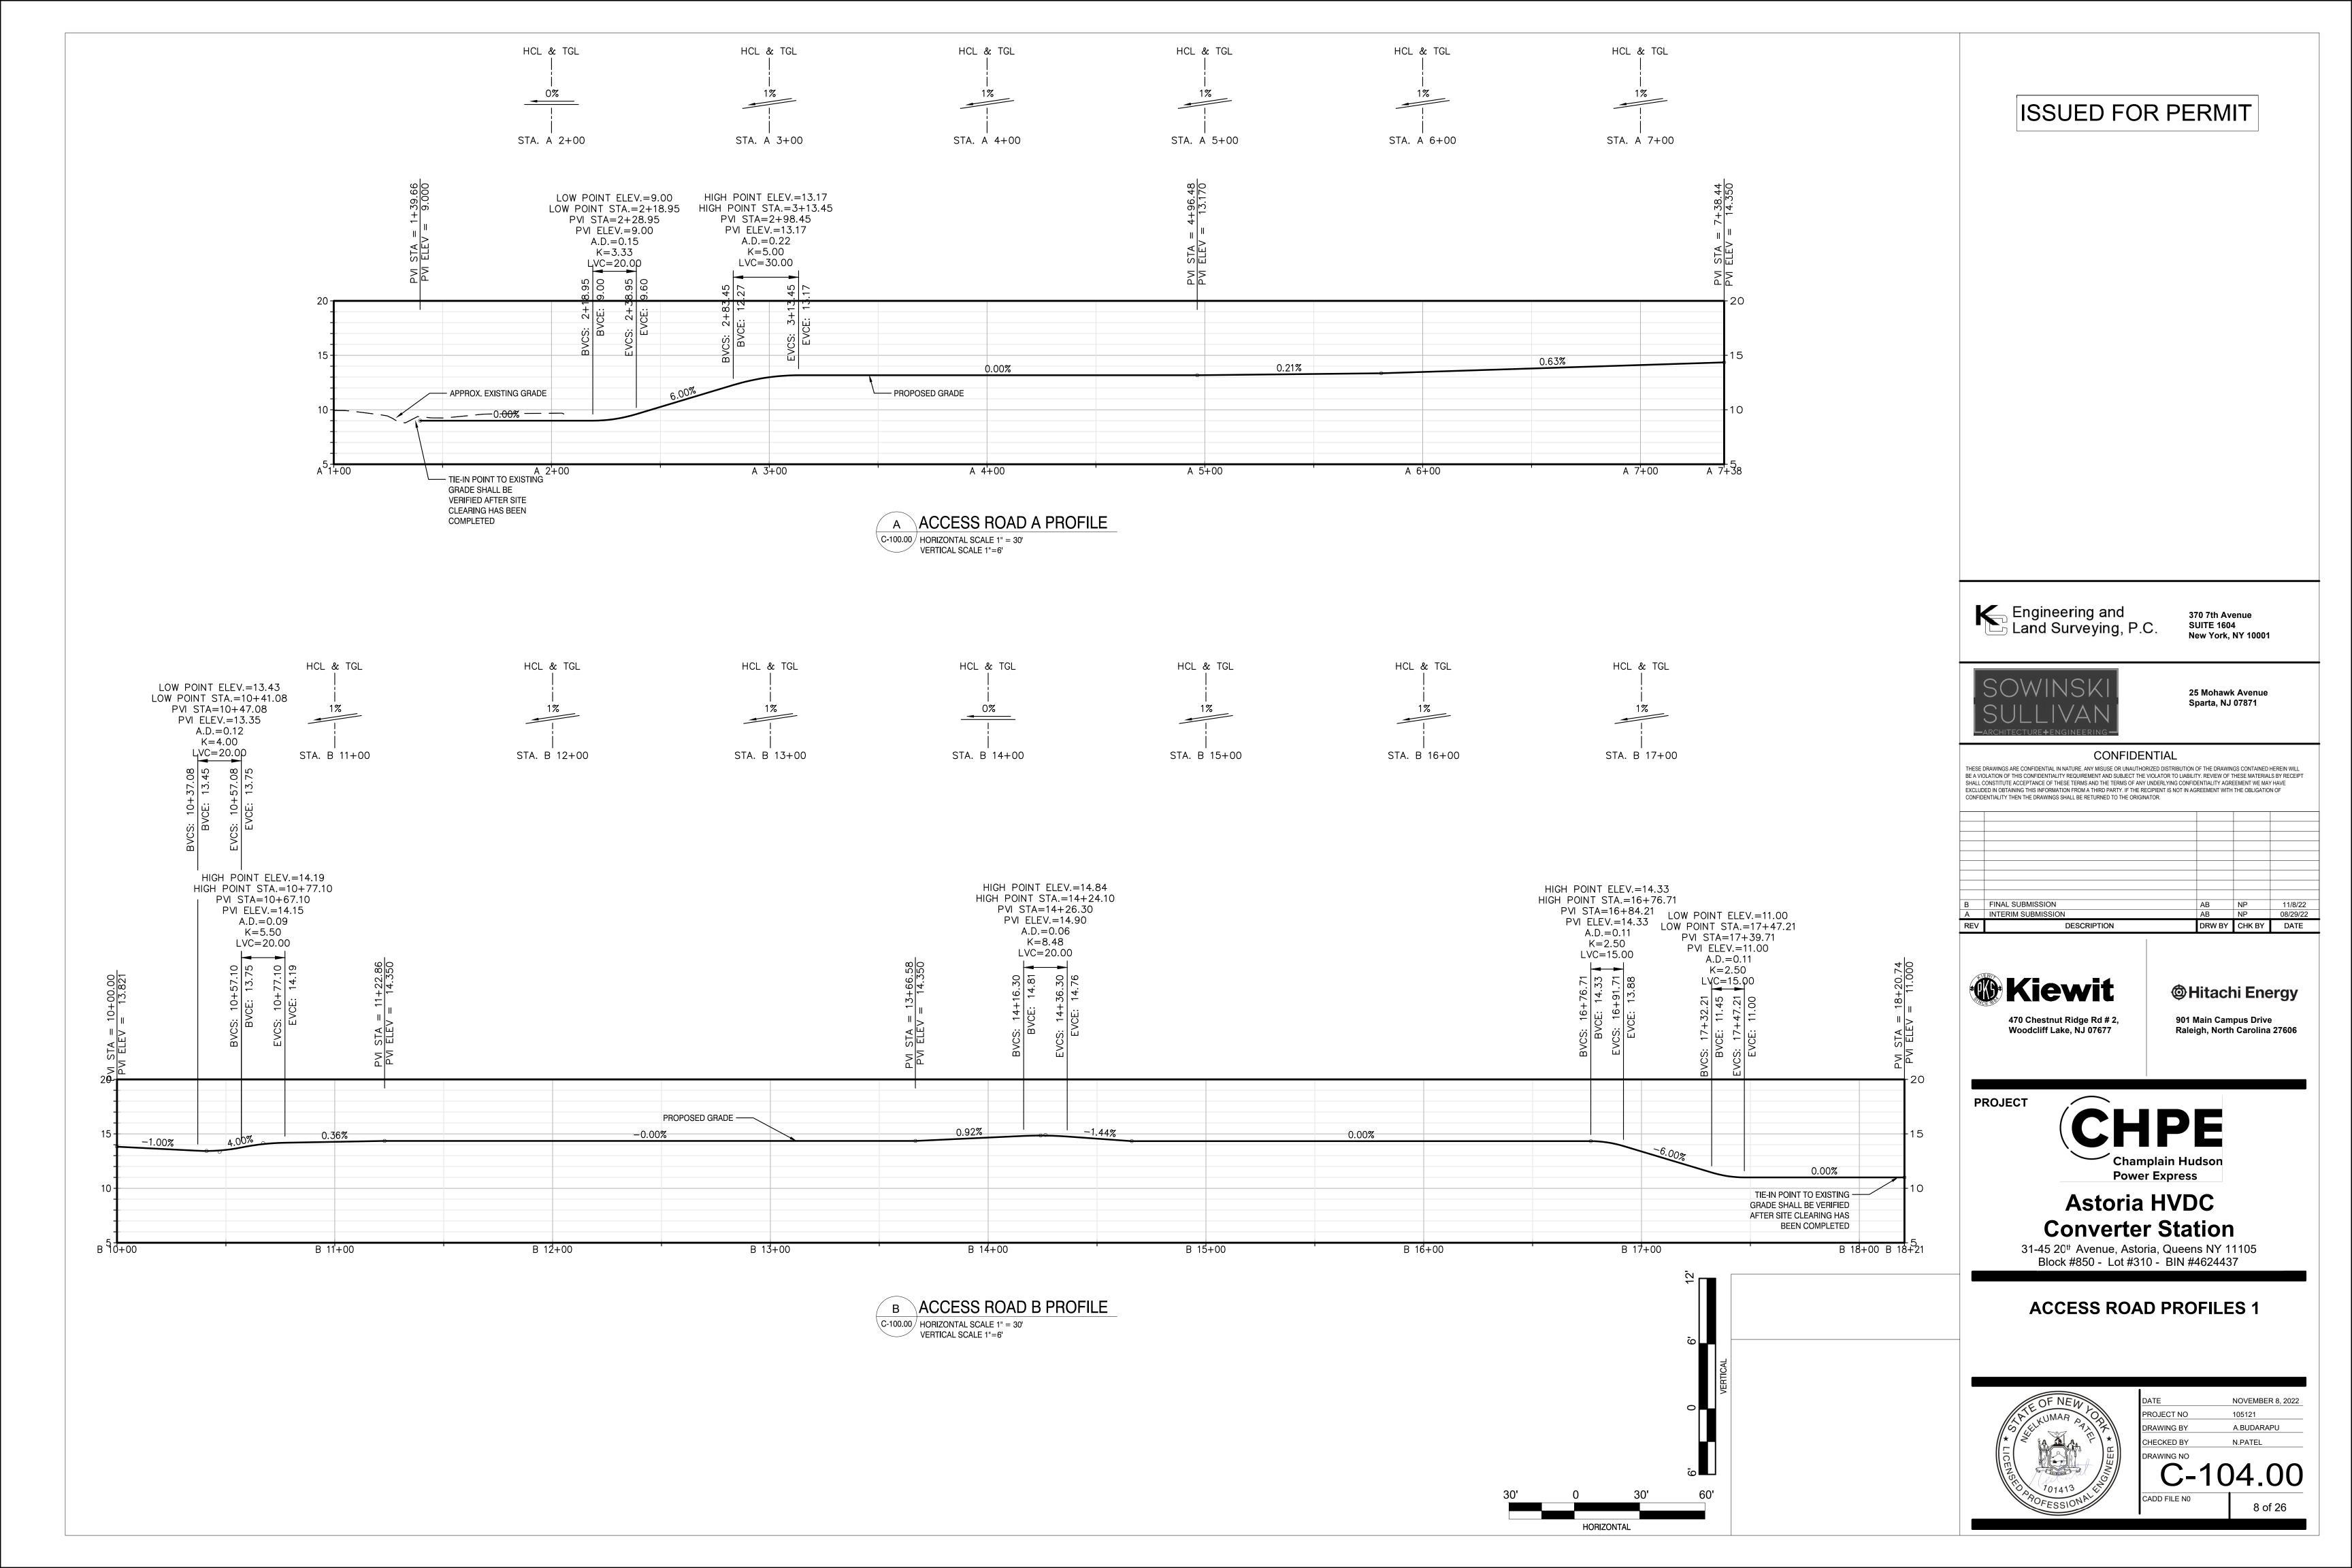

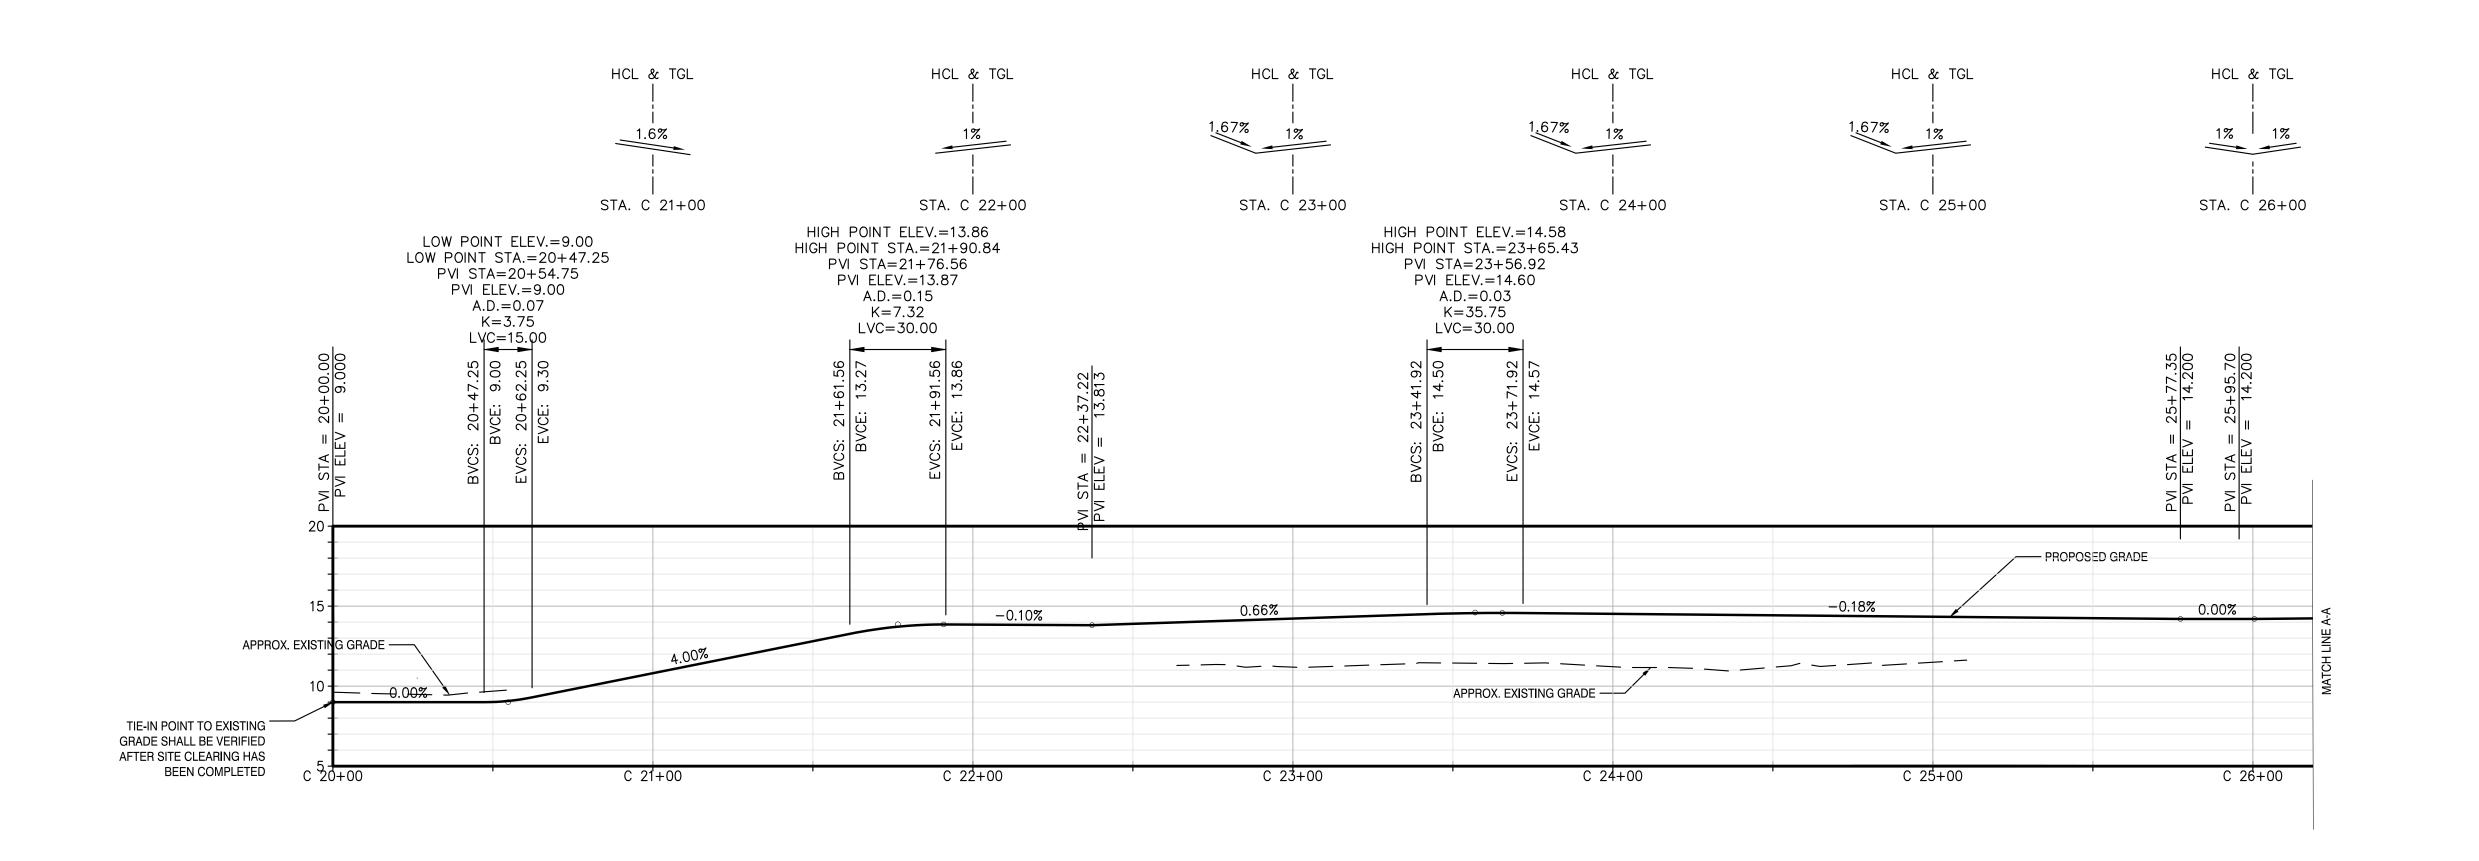

C ACCESS ROAD C PROFILE

C-100.00 HORIZONTAL SCALE 1" = 30'
VERTICAL SCALE 1" = 6'

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REV	DESCRIPTION	DRW BY	CHK BY	DATE
Α	INTERIM SUBMISSION	AB	NP	08/29/22
В	FINAL SUBMISSION	AB	NP	11/8/22



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HORIZONTAL



# Astoria HVDC Converter Station


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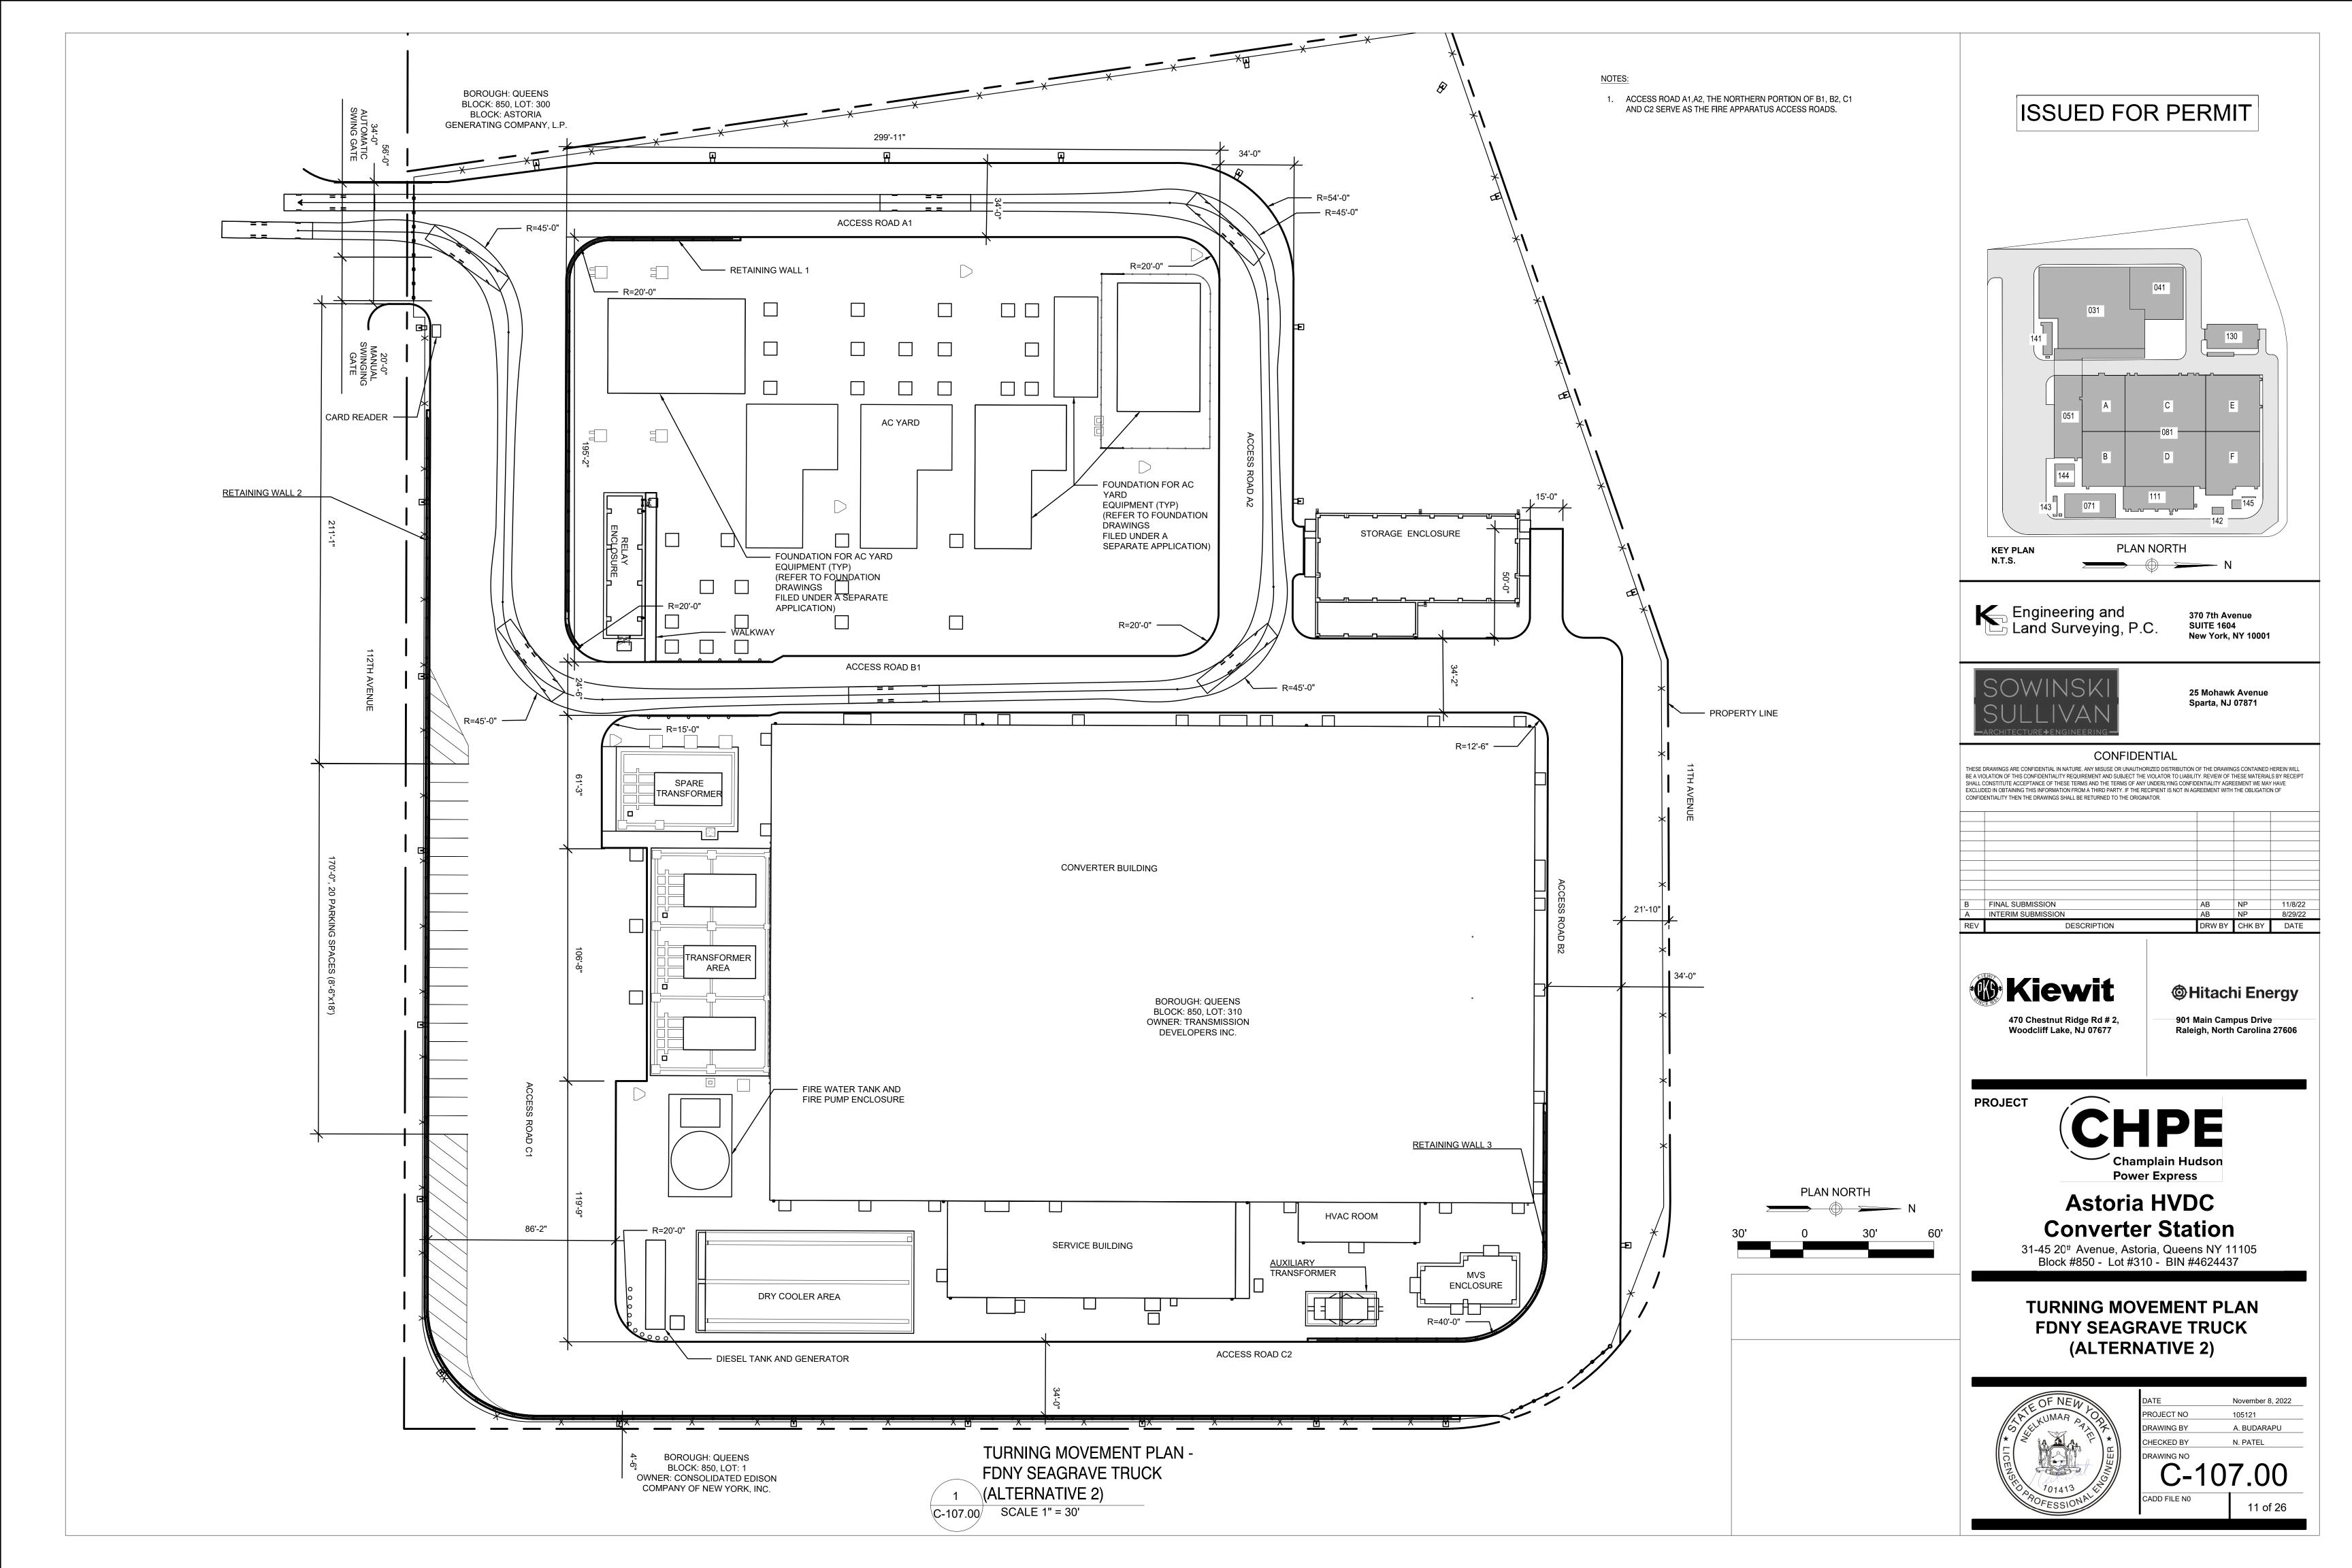
ACCESS ROAD PROFILES 2





DATE NOVEMBER 8, 2022
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DRAWING BY A.BUDARAPU
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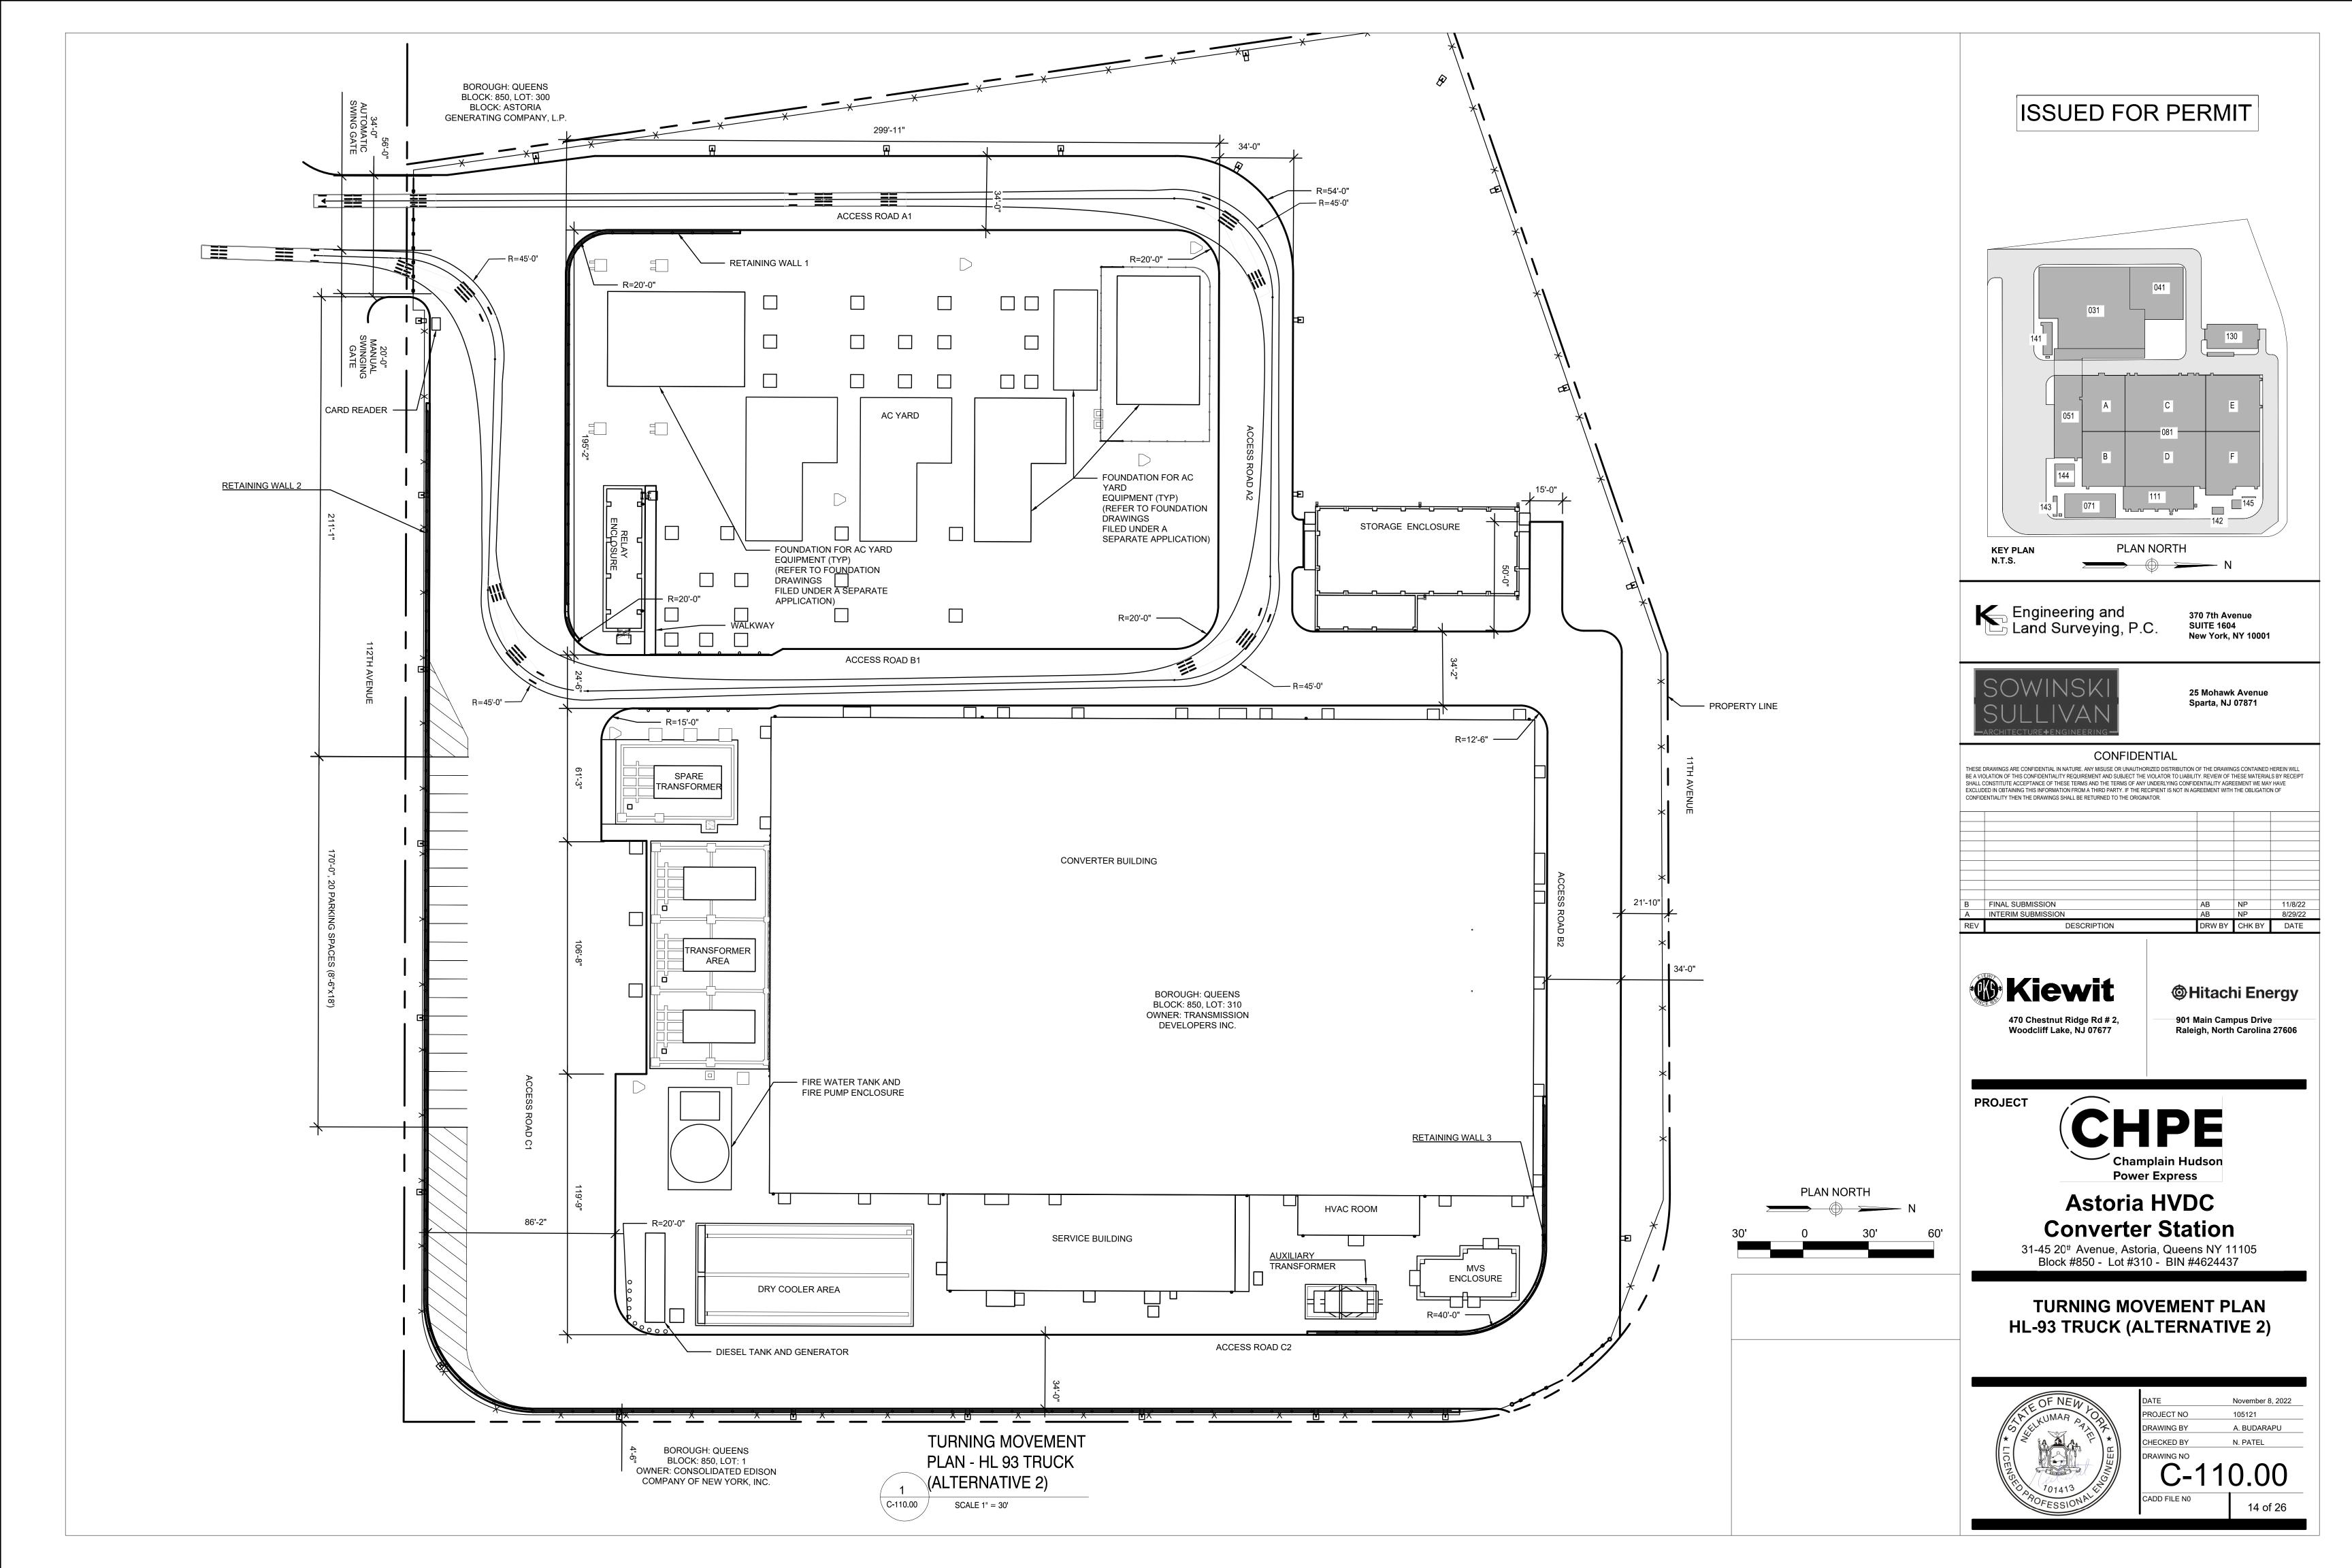
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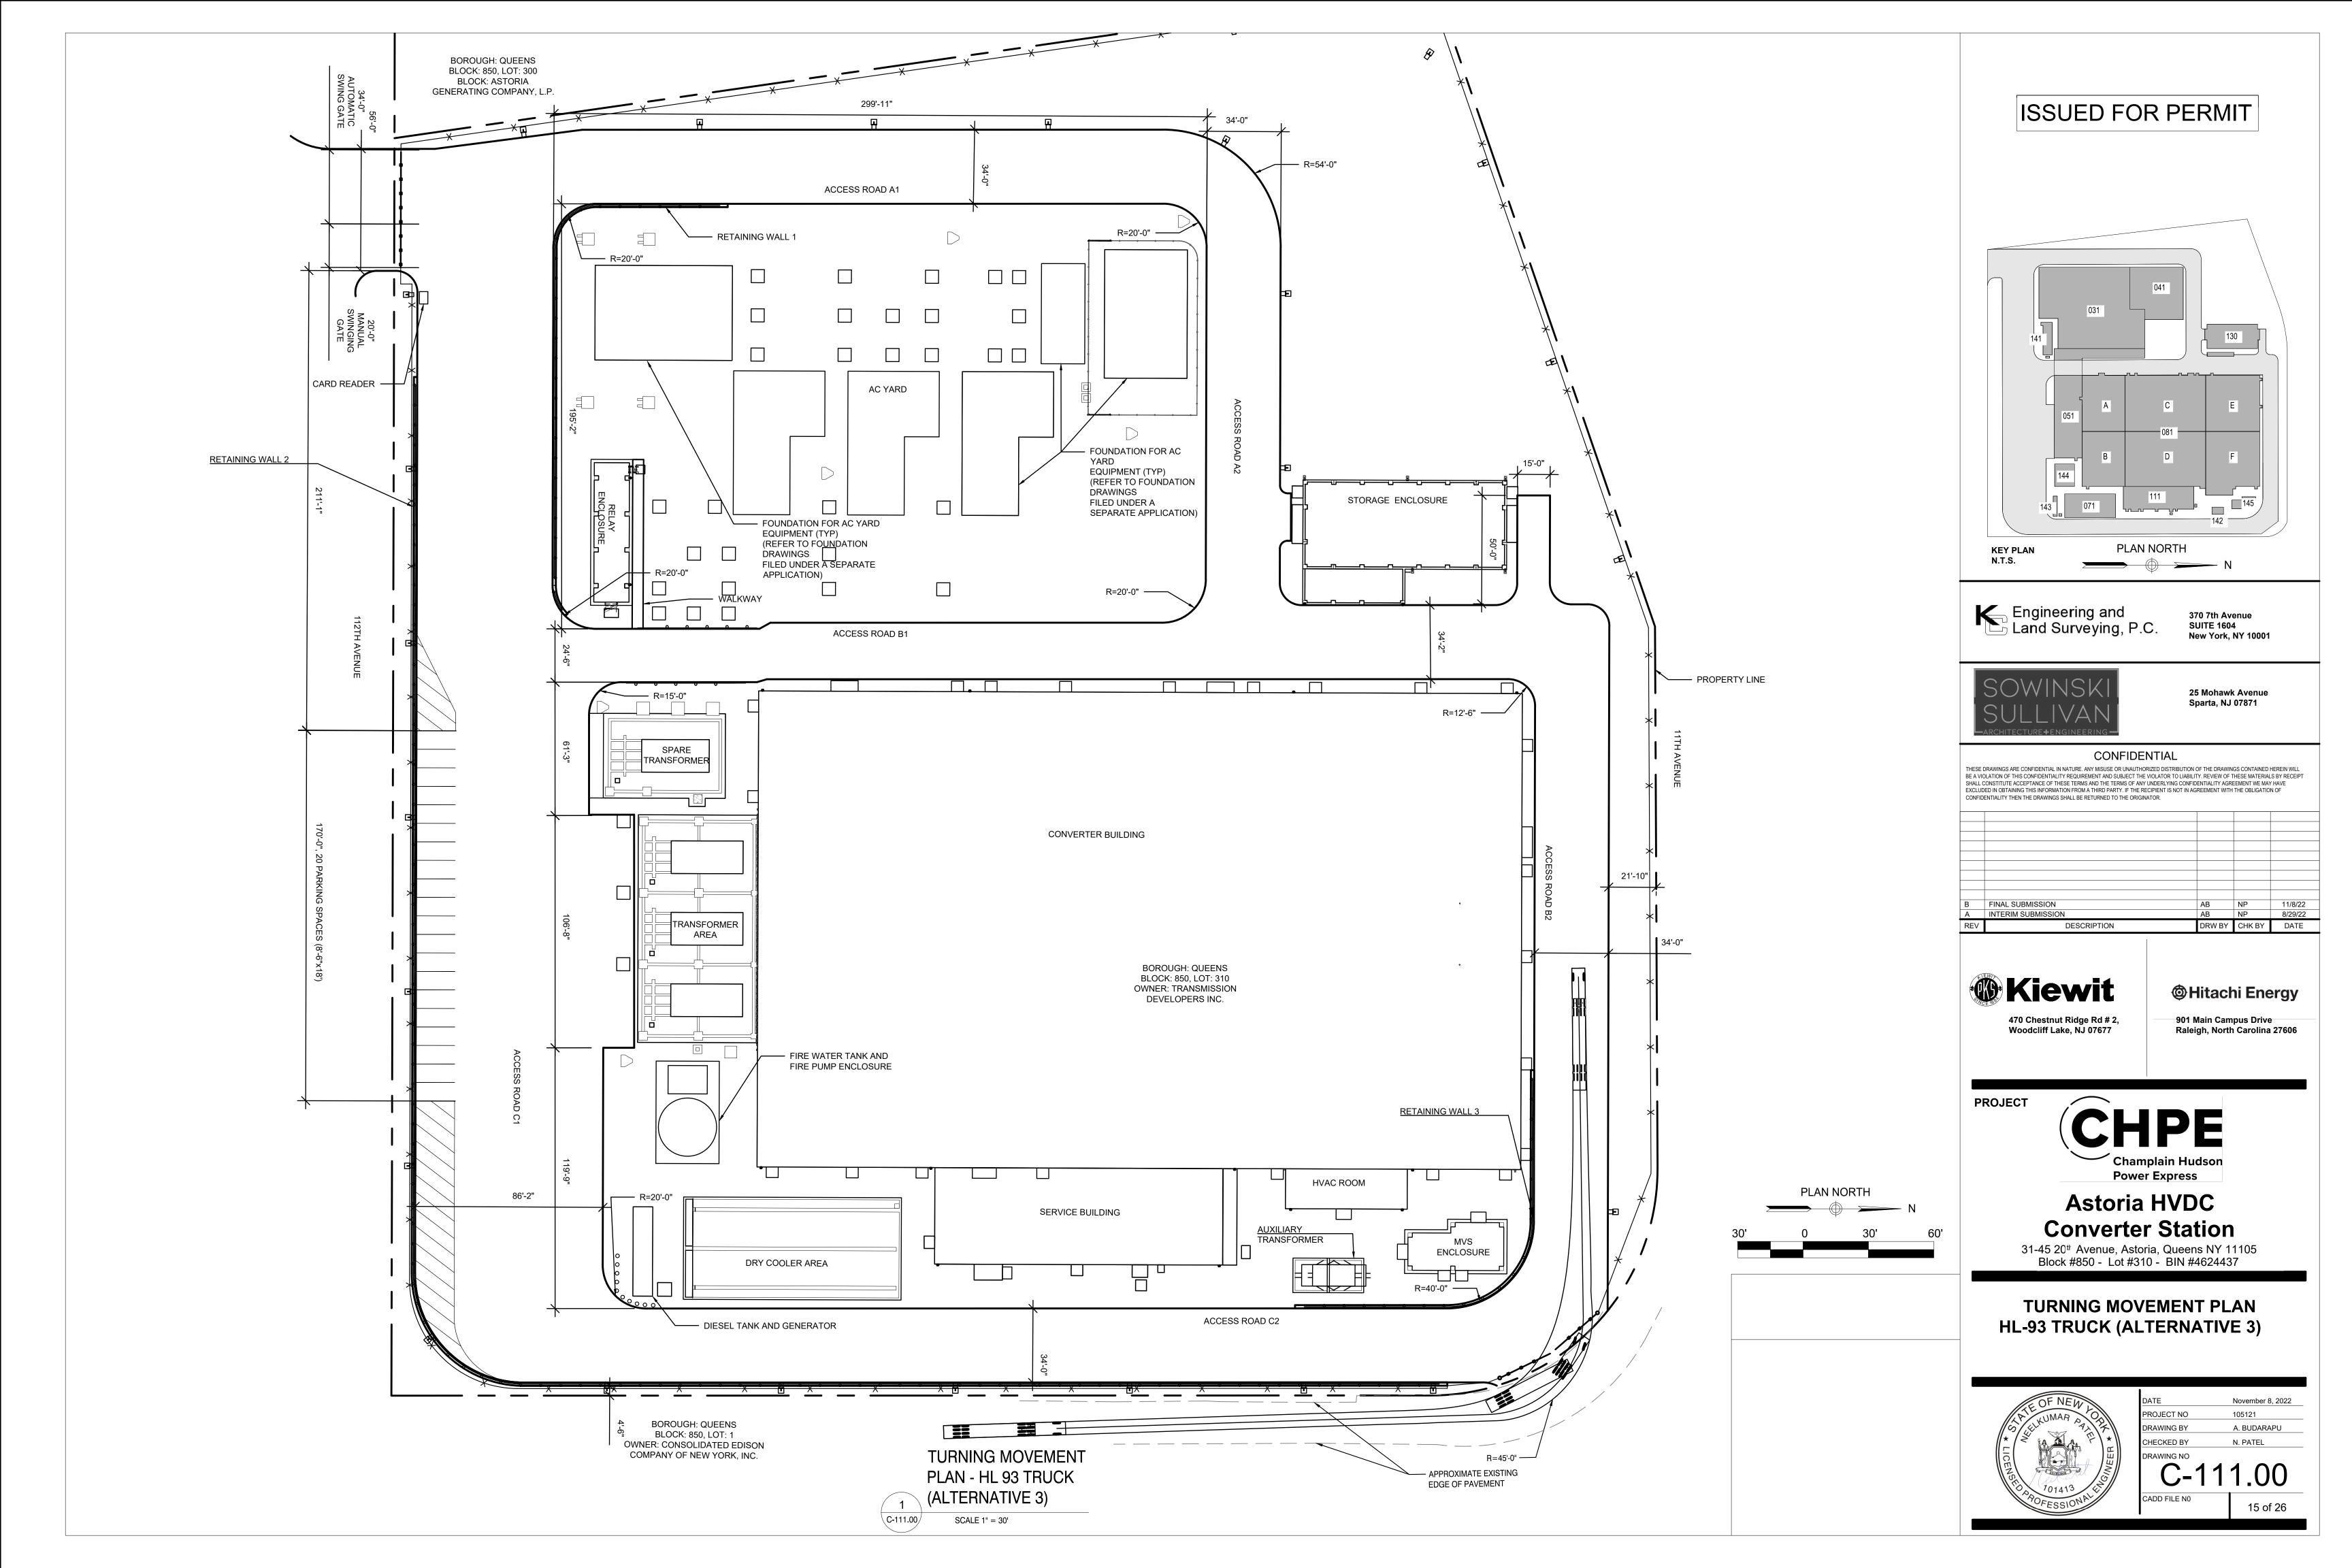







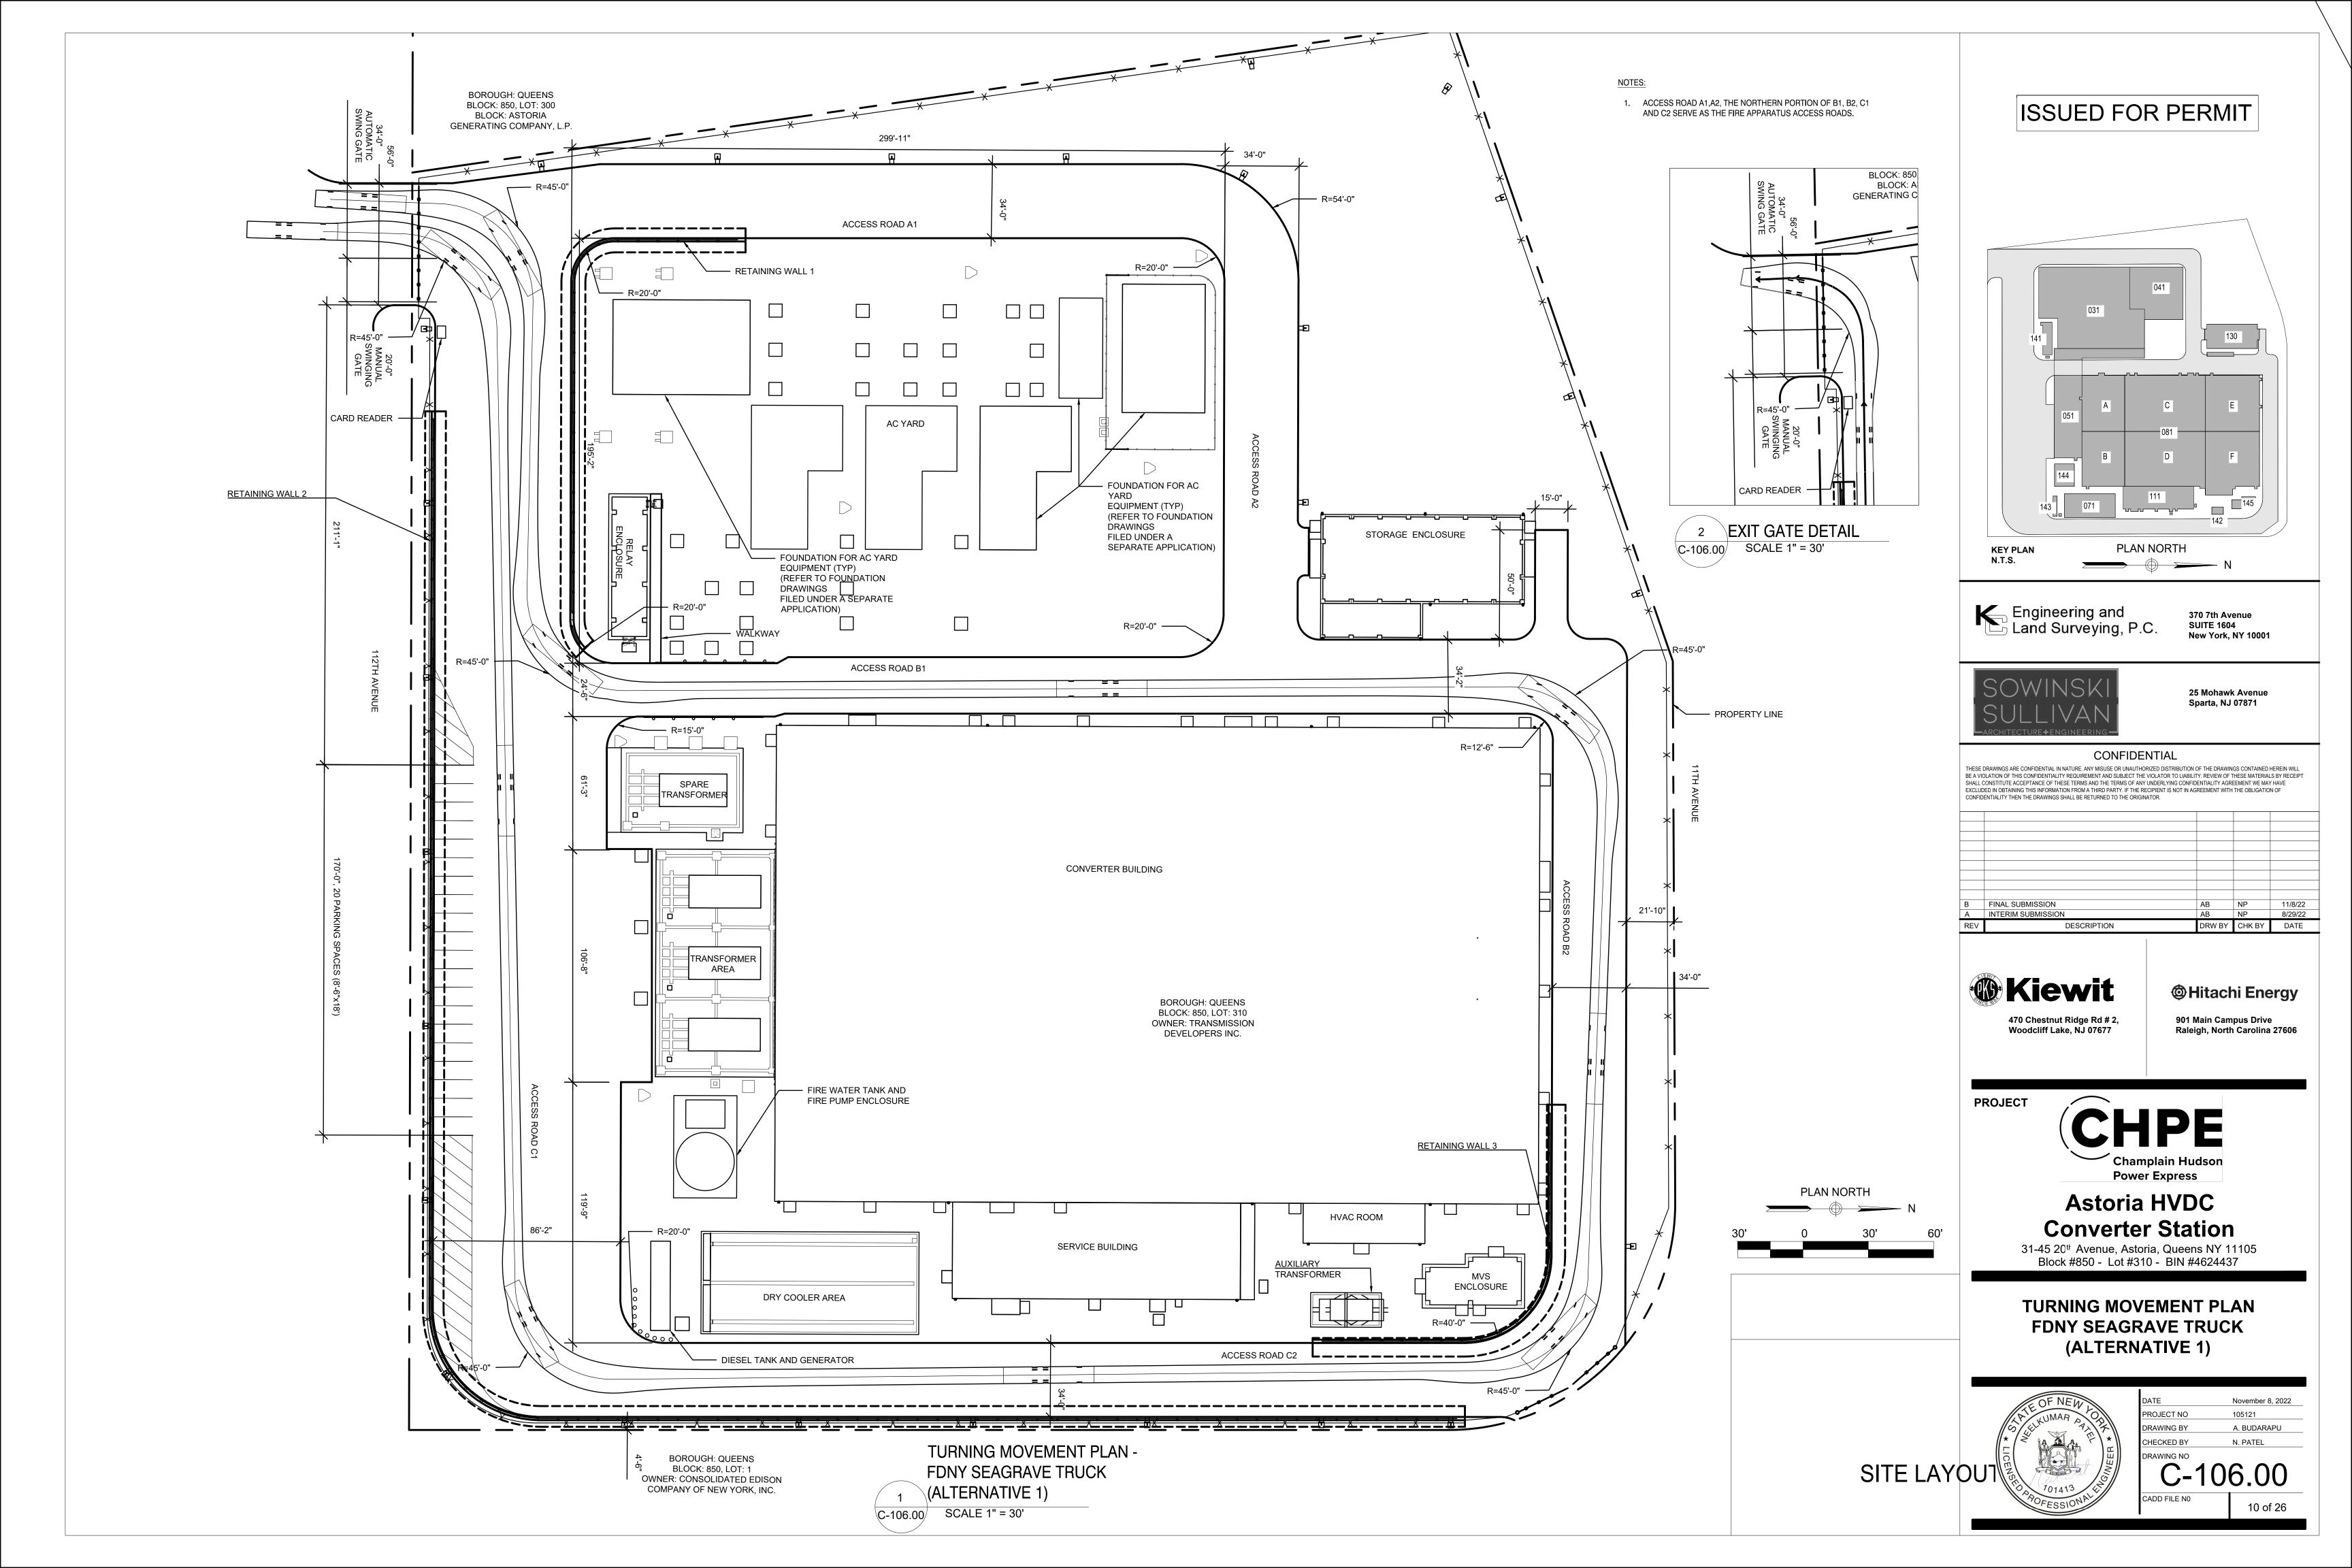

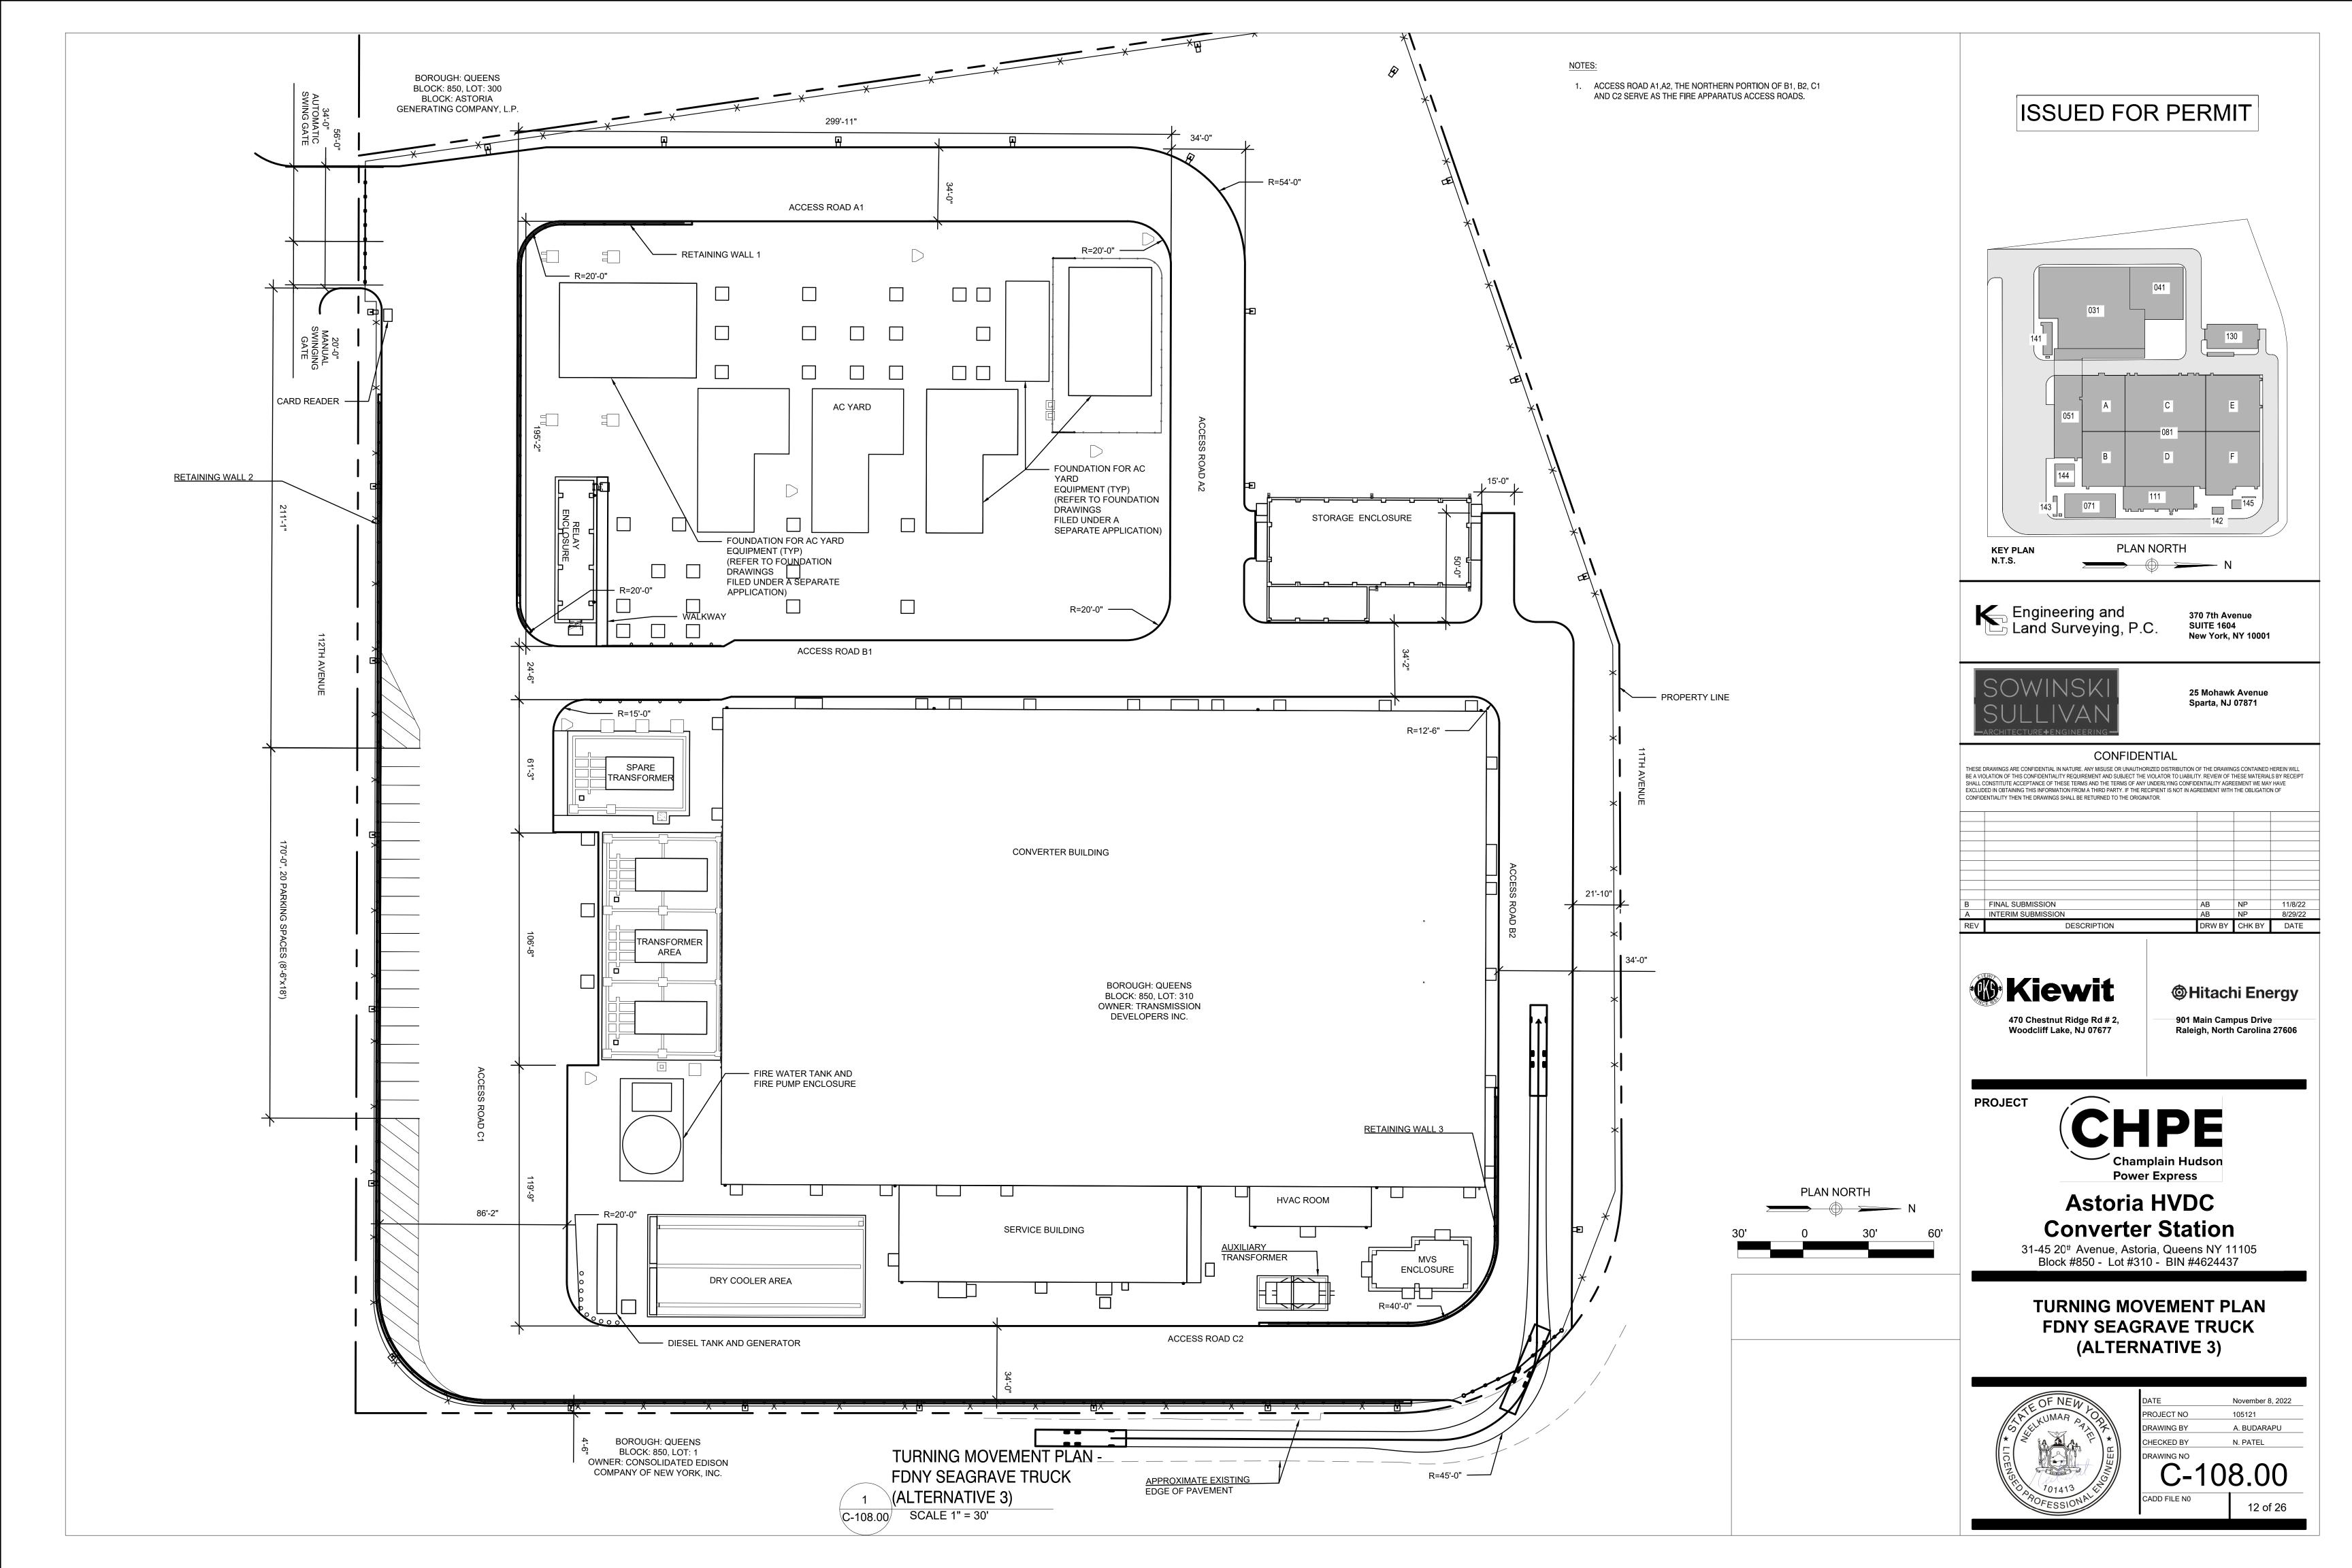

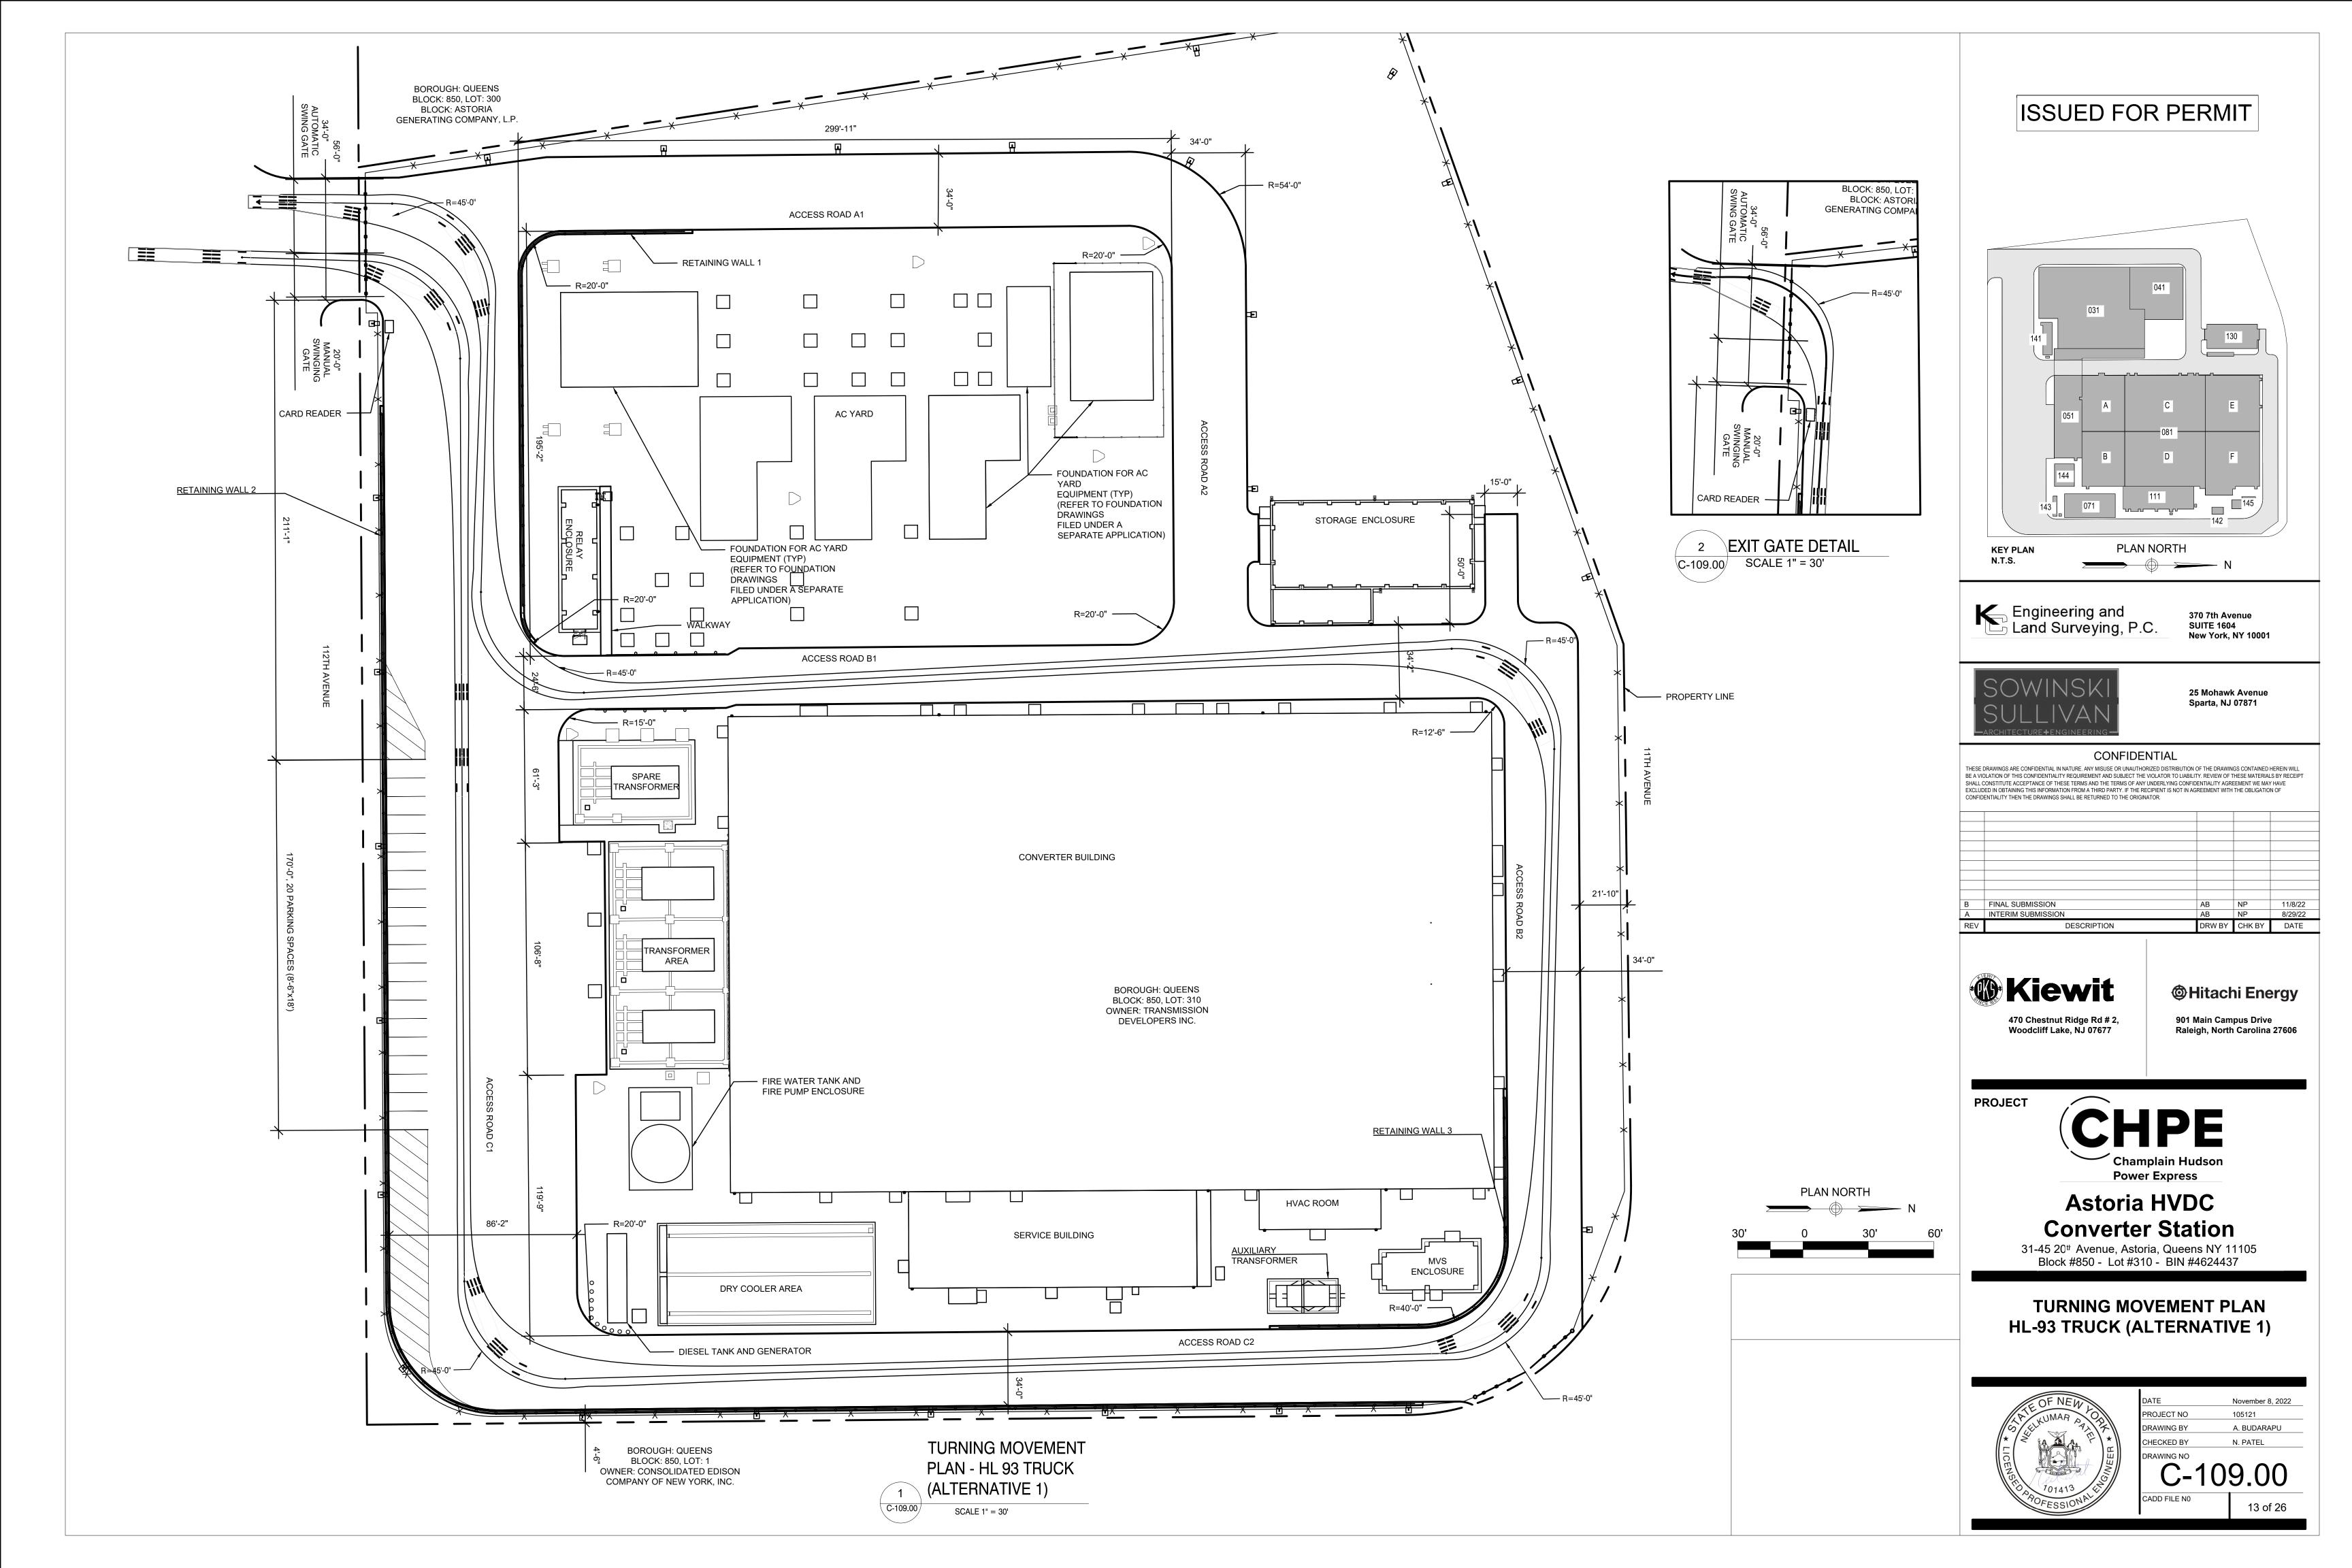


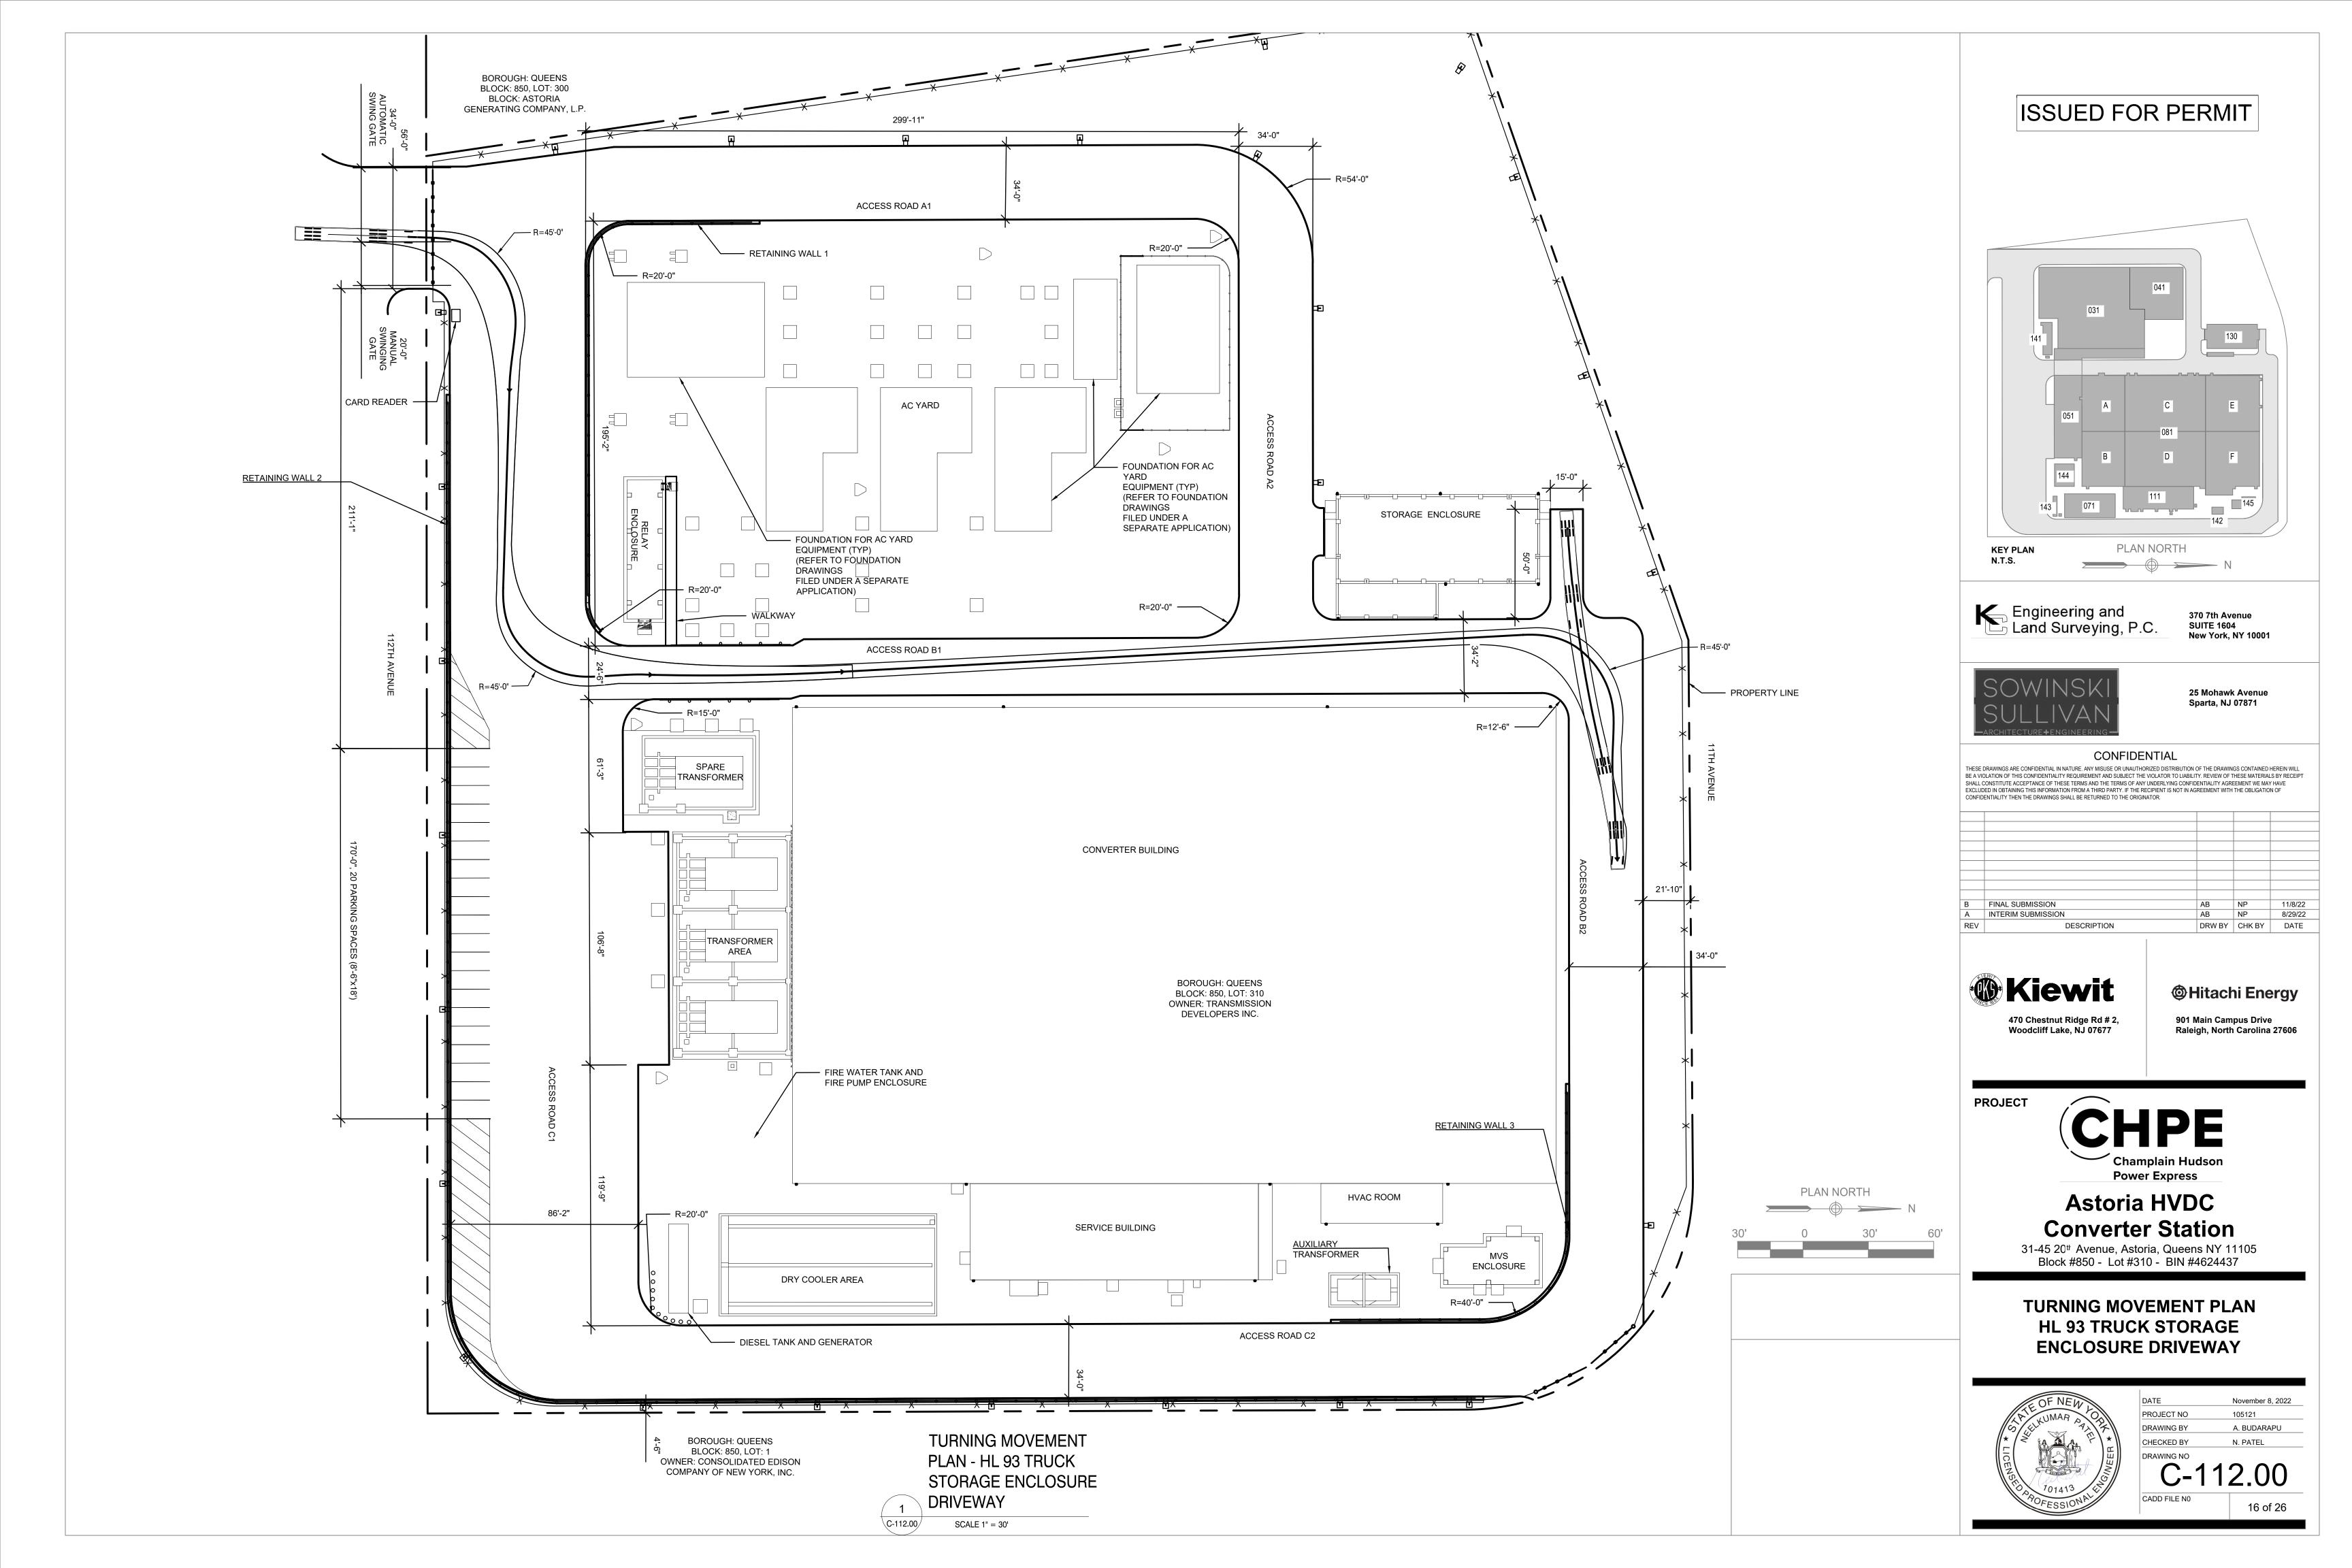


NOTE:

1. ALL DIMENSIONS IN FEET.




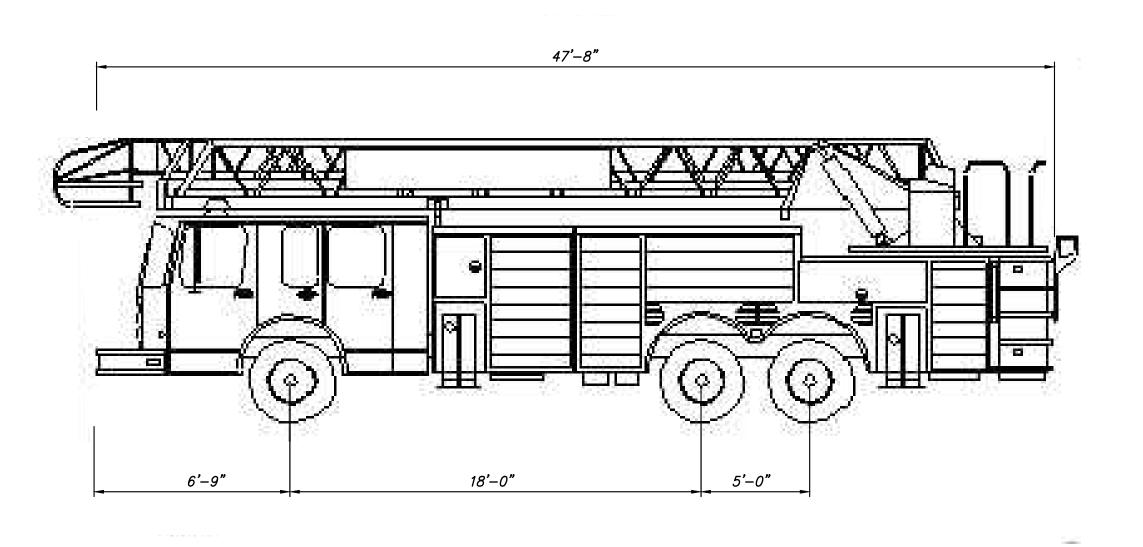

1 FDNY SEAGRAVE FIRE TRUCK
NOT TO SCALE

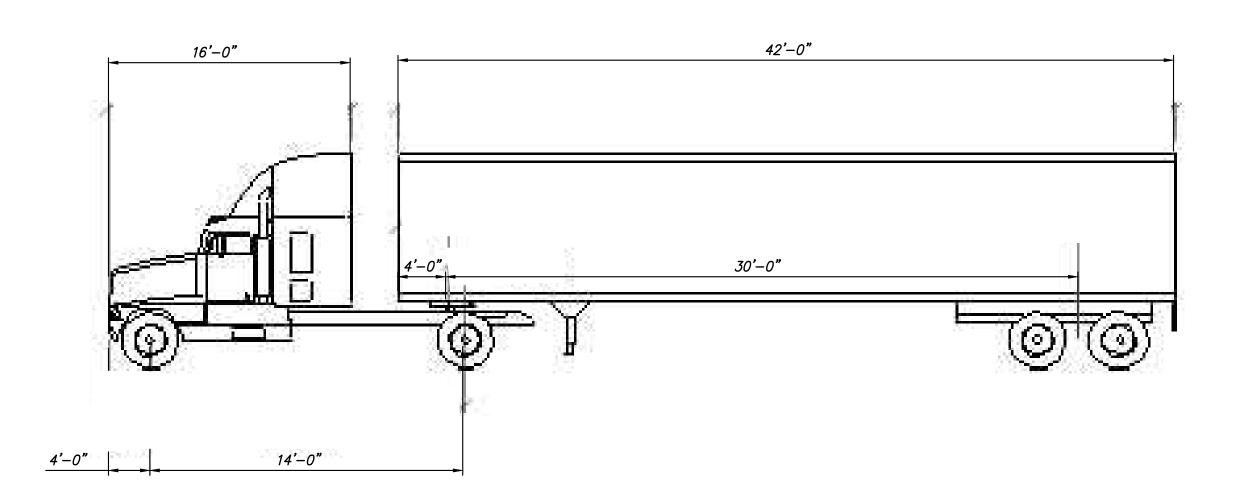



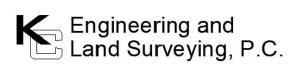

370 7th Avenue SUITE 1604 New York, NY 10001



25 Mohawk Avenue Sparta, NJ 07871

#### CONFIDENTIAL

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В	FINAL SUBMISSION	AB	NP	11/8/22
Α	INTERIM SUBMISSION	AB	NP	8/29/22
REV	DESCRIPTION	DRW BY	CHK BY	DATE



**@**Hitachi Energy

901 Main Campus Drive Raleigh, North Carolina 27606


PROJEC



# Astoria HVDC Converter Station

31-45 20<sup>th</sup> Avenue, Astoria, Queens NY 11105 Block #850 - Lot #310 - BIN #4624437


TURNING MOVEMENT VEHICLE DETAILS

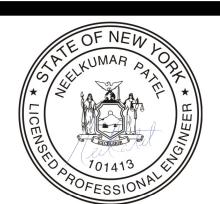



DATE	November 8, 2022
PROJECT NO	105121
DRAWING BY	A. BUDARAPU
CHECKED BY	N. PATEL
DRAWING NO	


C-113.00


NOTE: ISSUED FOR PERMIT 1. FOR ROADWAY ALIGNMENTS SEE DWG. C-100.00. APPROX. CLEARANCE VARIES FROM 6" TO 1' FROM BOTTOM OF VEHICLE
TO TOP OF ROADWAY — BOTTOM OF VEHICLE A 3+00 A 2<sup>'</sup>+00 1 ACCESS ROAD A1 VERTICAL PROFILE - FDNY FIRE TRUCK C-114.00 SCALE 1" = 10' Engineering and Land Surveying, P.C. 370 7th Avenue **SUITE 1604** New York, NY 10001 25 Mohawk Avenue Sparta, NJ 07871 CONFIDENTIAL THESE DRAWINGS ARE CONFIDENTIAL IN NATURE. ANY MISUSE OR UNAUTHORIZED DISTRIBUTION OF THE DRAWINGS CONTAINED HEREIN WILL BE A VIOLATION OF THIS CONFIDENTIALITY REQUIREMENT AND SUBJECT THE VIOLATOR TO LIABILITY. REVIEW OF THESE MATERIALS BY RECEIPT SHALL CONSTITUTE ACCEPTANCE OF THESE TERMS AND THE TERMS OF ANY UNDERLYING CONFIDENTIALITY AGREEMENT WE MAY HAVE EXCLUDED IN OBTAINING THIS INFORMATION FROM A THIRD PARTY. IF THE RECIPIENT IS NOT IN AGREEMENT WITH THE OBLIGATION OF CONFIDENTIALITY THEN THE DRAWINGS SHALL BE RETURNED TO THE ORIGINATOR. APPROX. CLEARANCE — BOTTOM OF VEHICLE — PROPOSED GRADE VARIES FROM 6" TO 1' FROM BOTTOM OF VEHICLE TO TOP OF ROADWAY A INTERIM SUBMISSION A 5+00 A 6'+00 A 7+00 DRW BY CHK BY DATE **® Kiewit @**Hitachi Energy Ground Clearance (units: ft) 470 Chestnut Ridge Rd # 2, Woodcliff Lake, NJ 07677 901 Main Campus Drive Raleigh, North Carolina 27606 1.50 1.50 1.50 2 ACCESS ROAD A2 VERTICAL PROFILE - FDNY FIRE TRUCK C-114.00 SCALE 1" = 10' **PROJECT** Champlain Hudson Power Express **Astoria HVDC Converter Station** 31-45 20th Avenue, Astoria, Queens NY 11105 Block #850 - Lot #310 - BIN #4624437 **TURNING MOVEMENT VERTICAL PROFILE** FDNY SEAGRAVE TRUCK NOVEMBER 8, 2022 A.BUDARAPU CHECKED BY 18 of 26

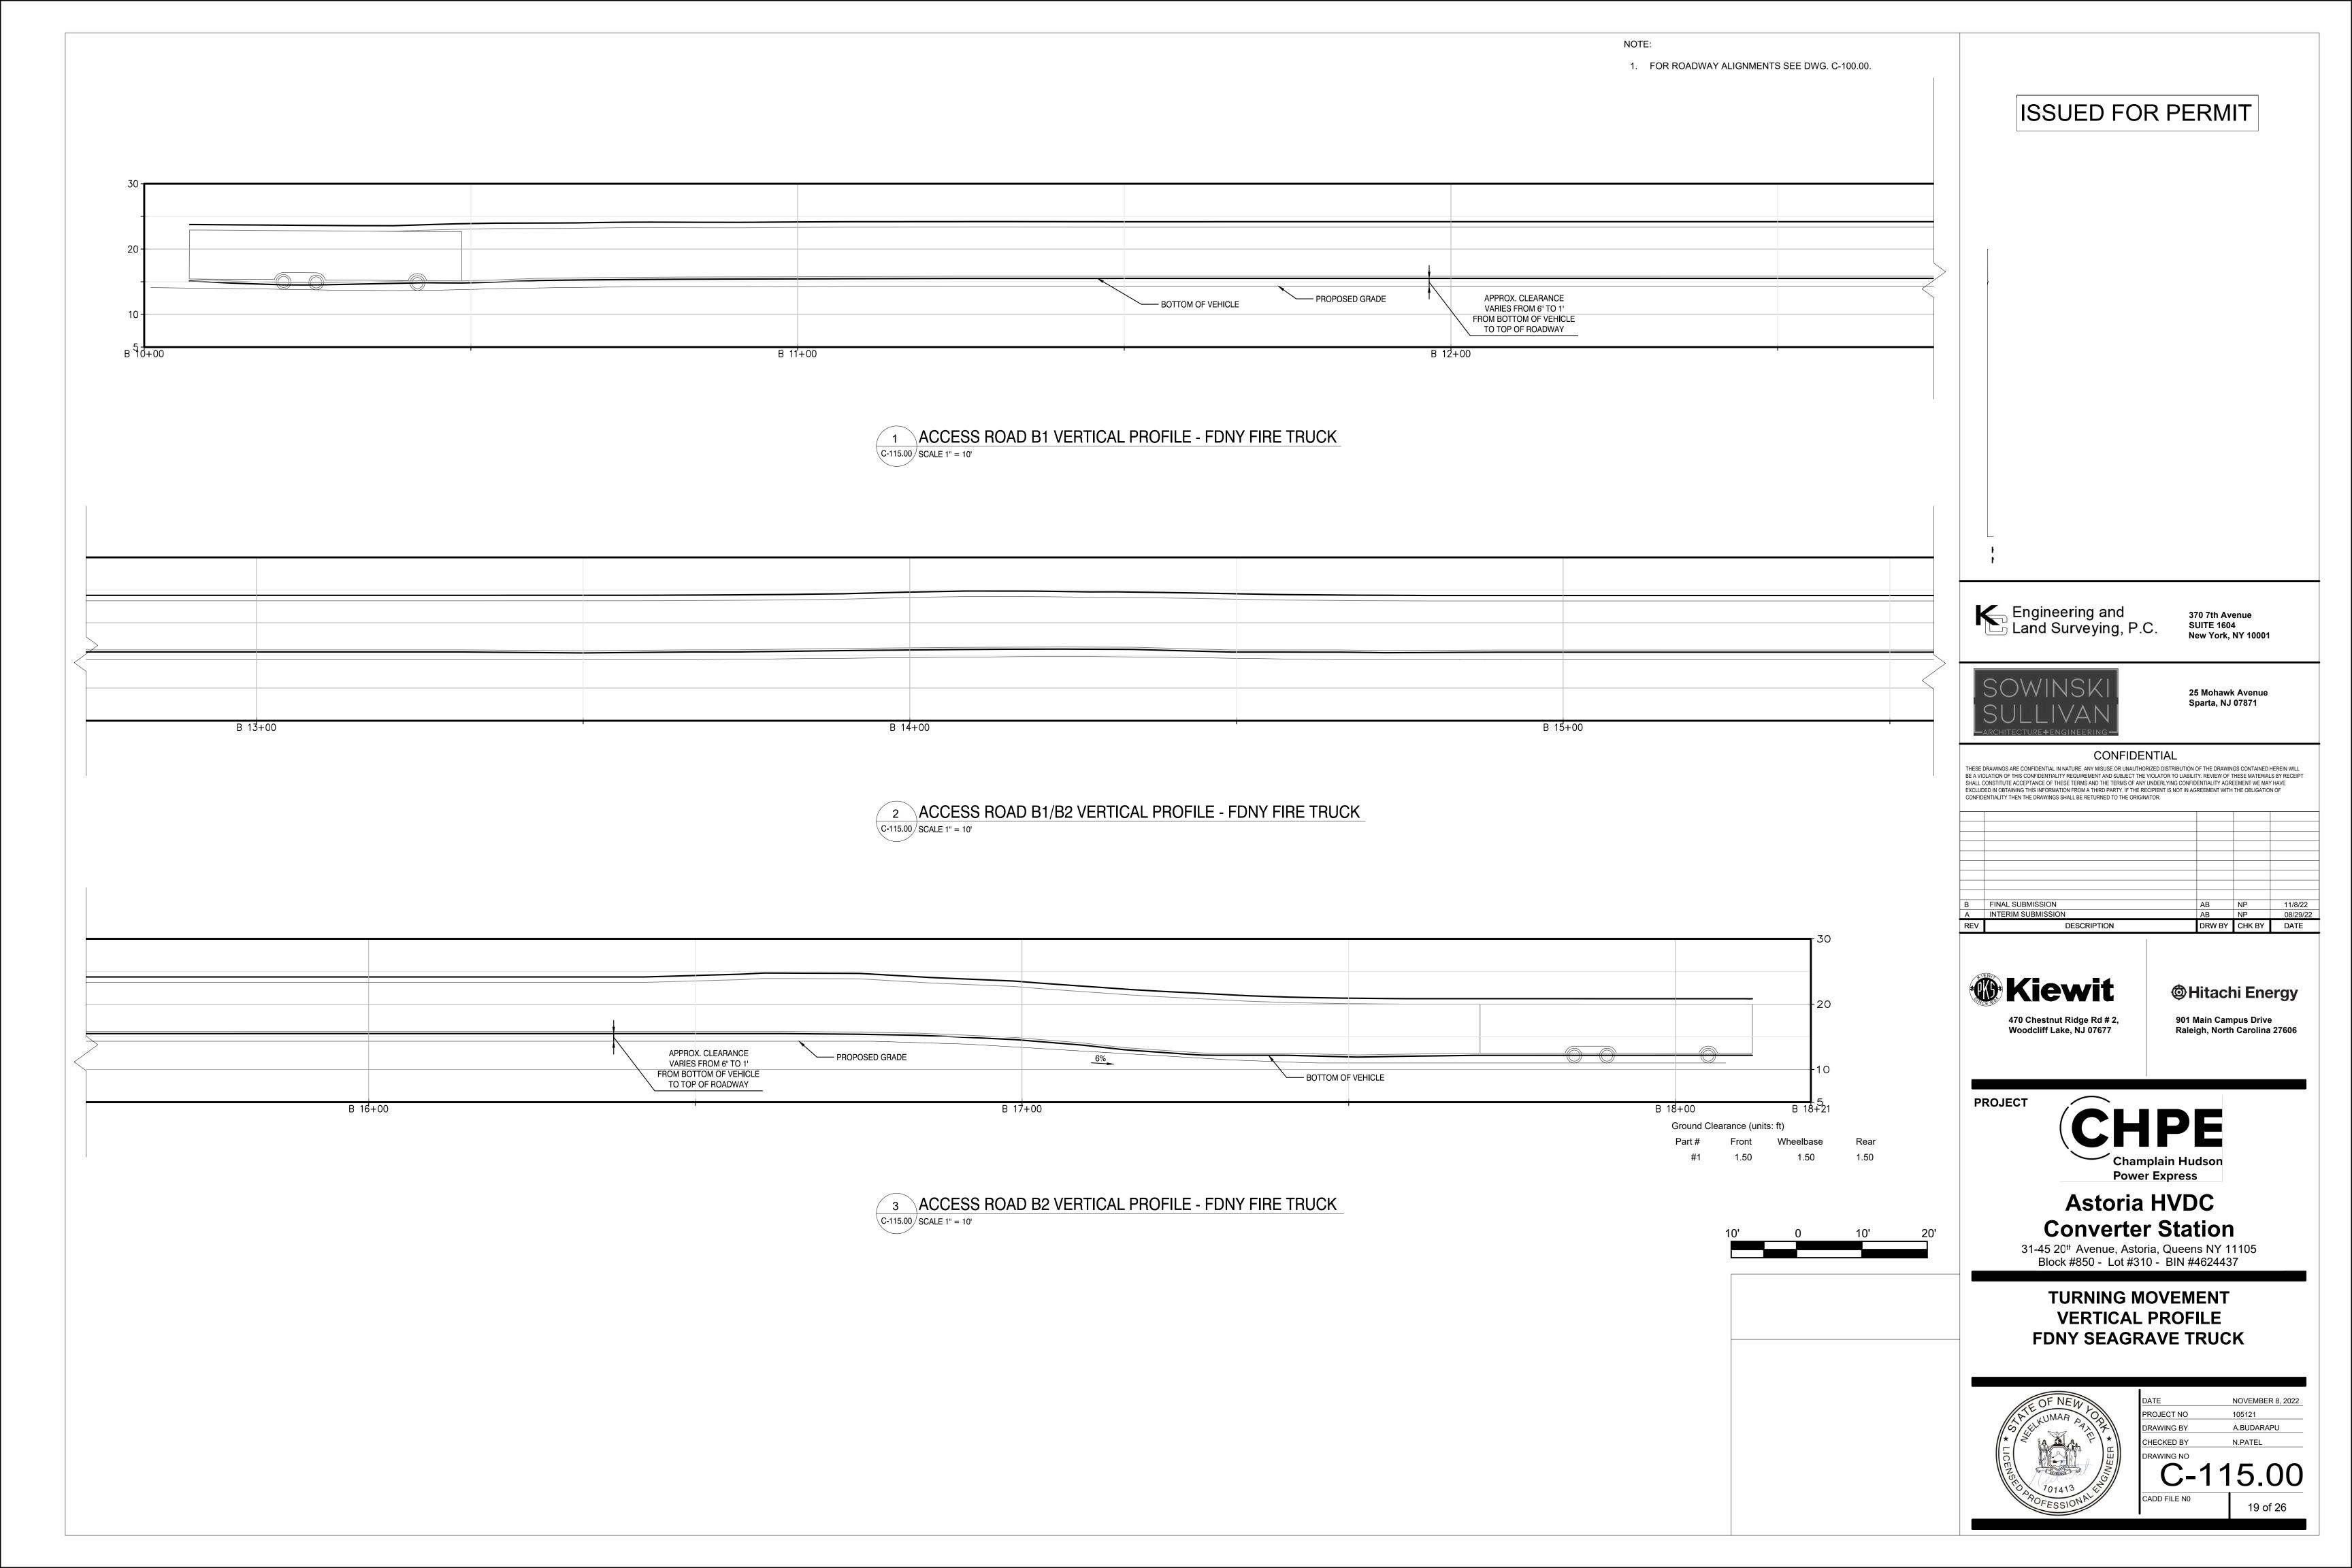


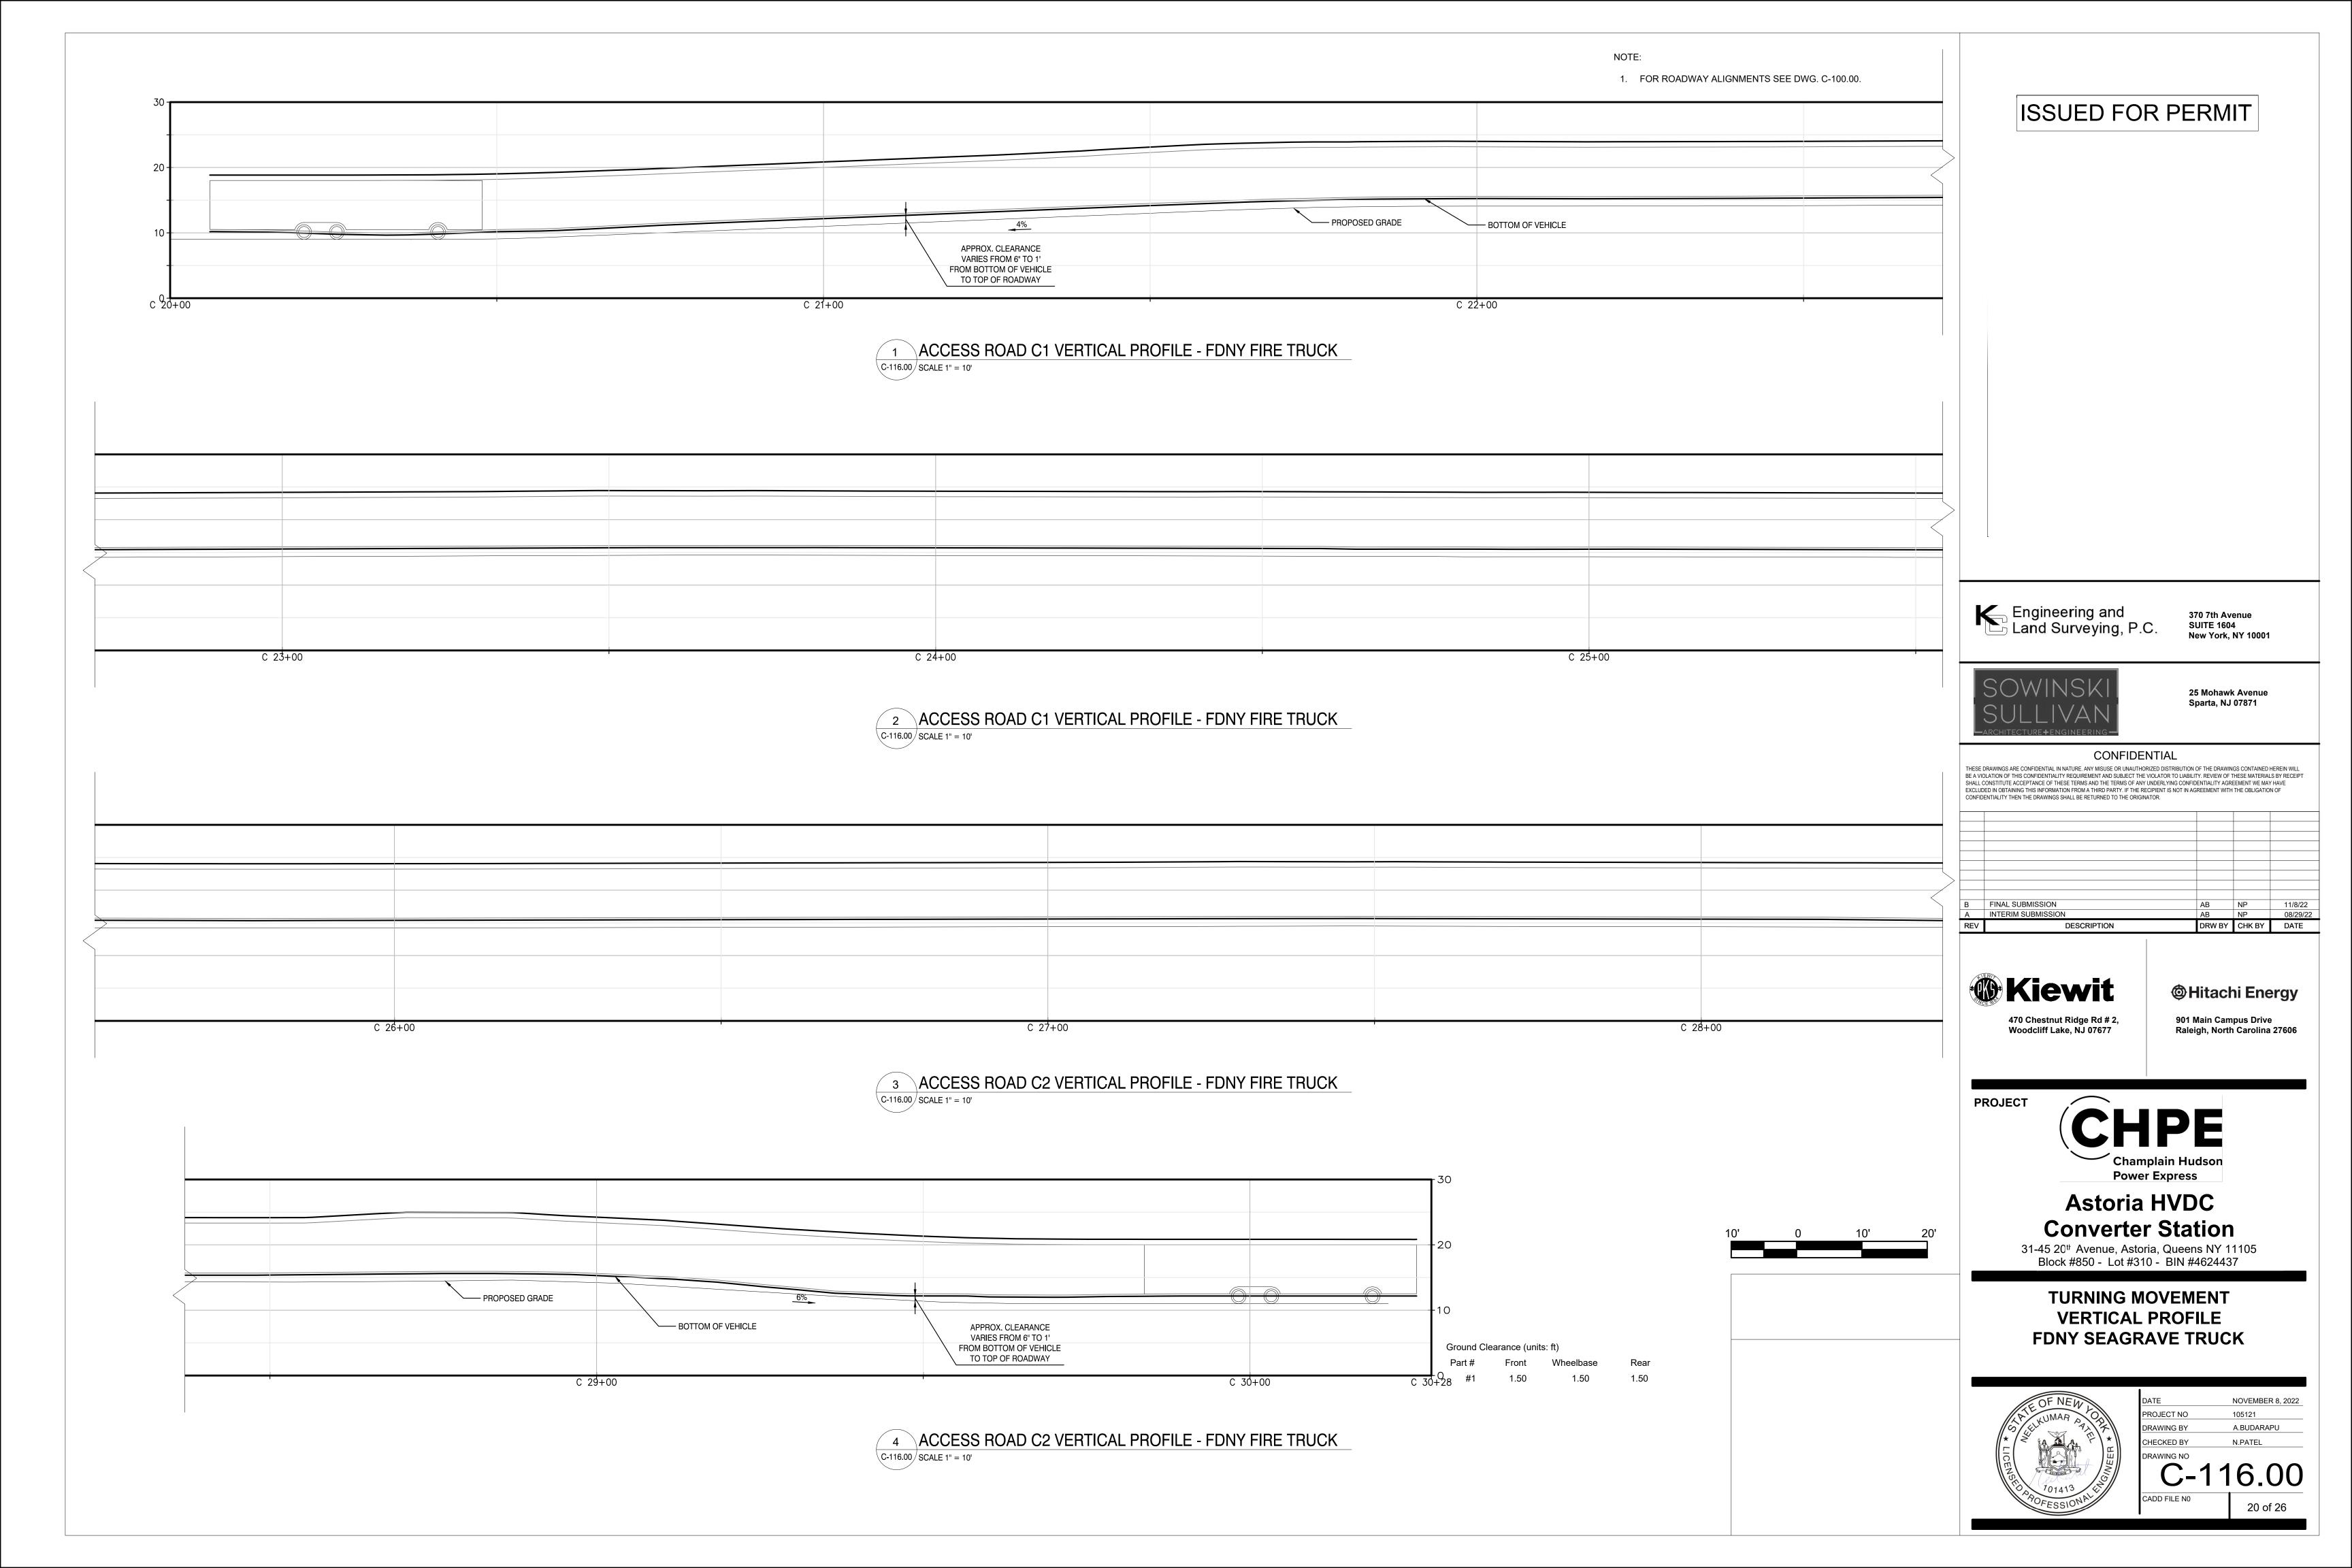


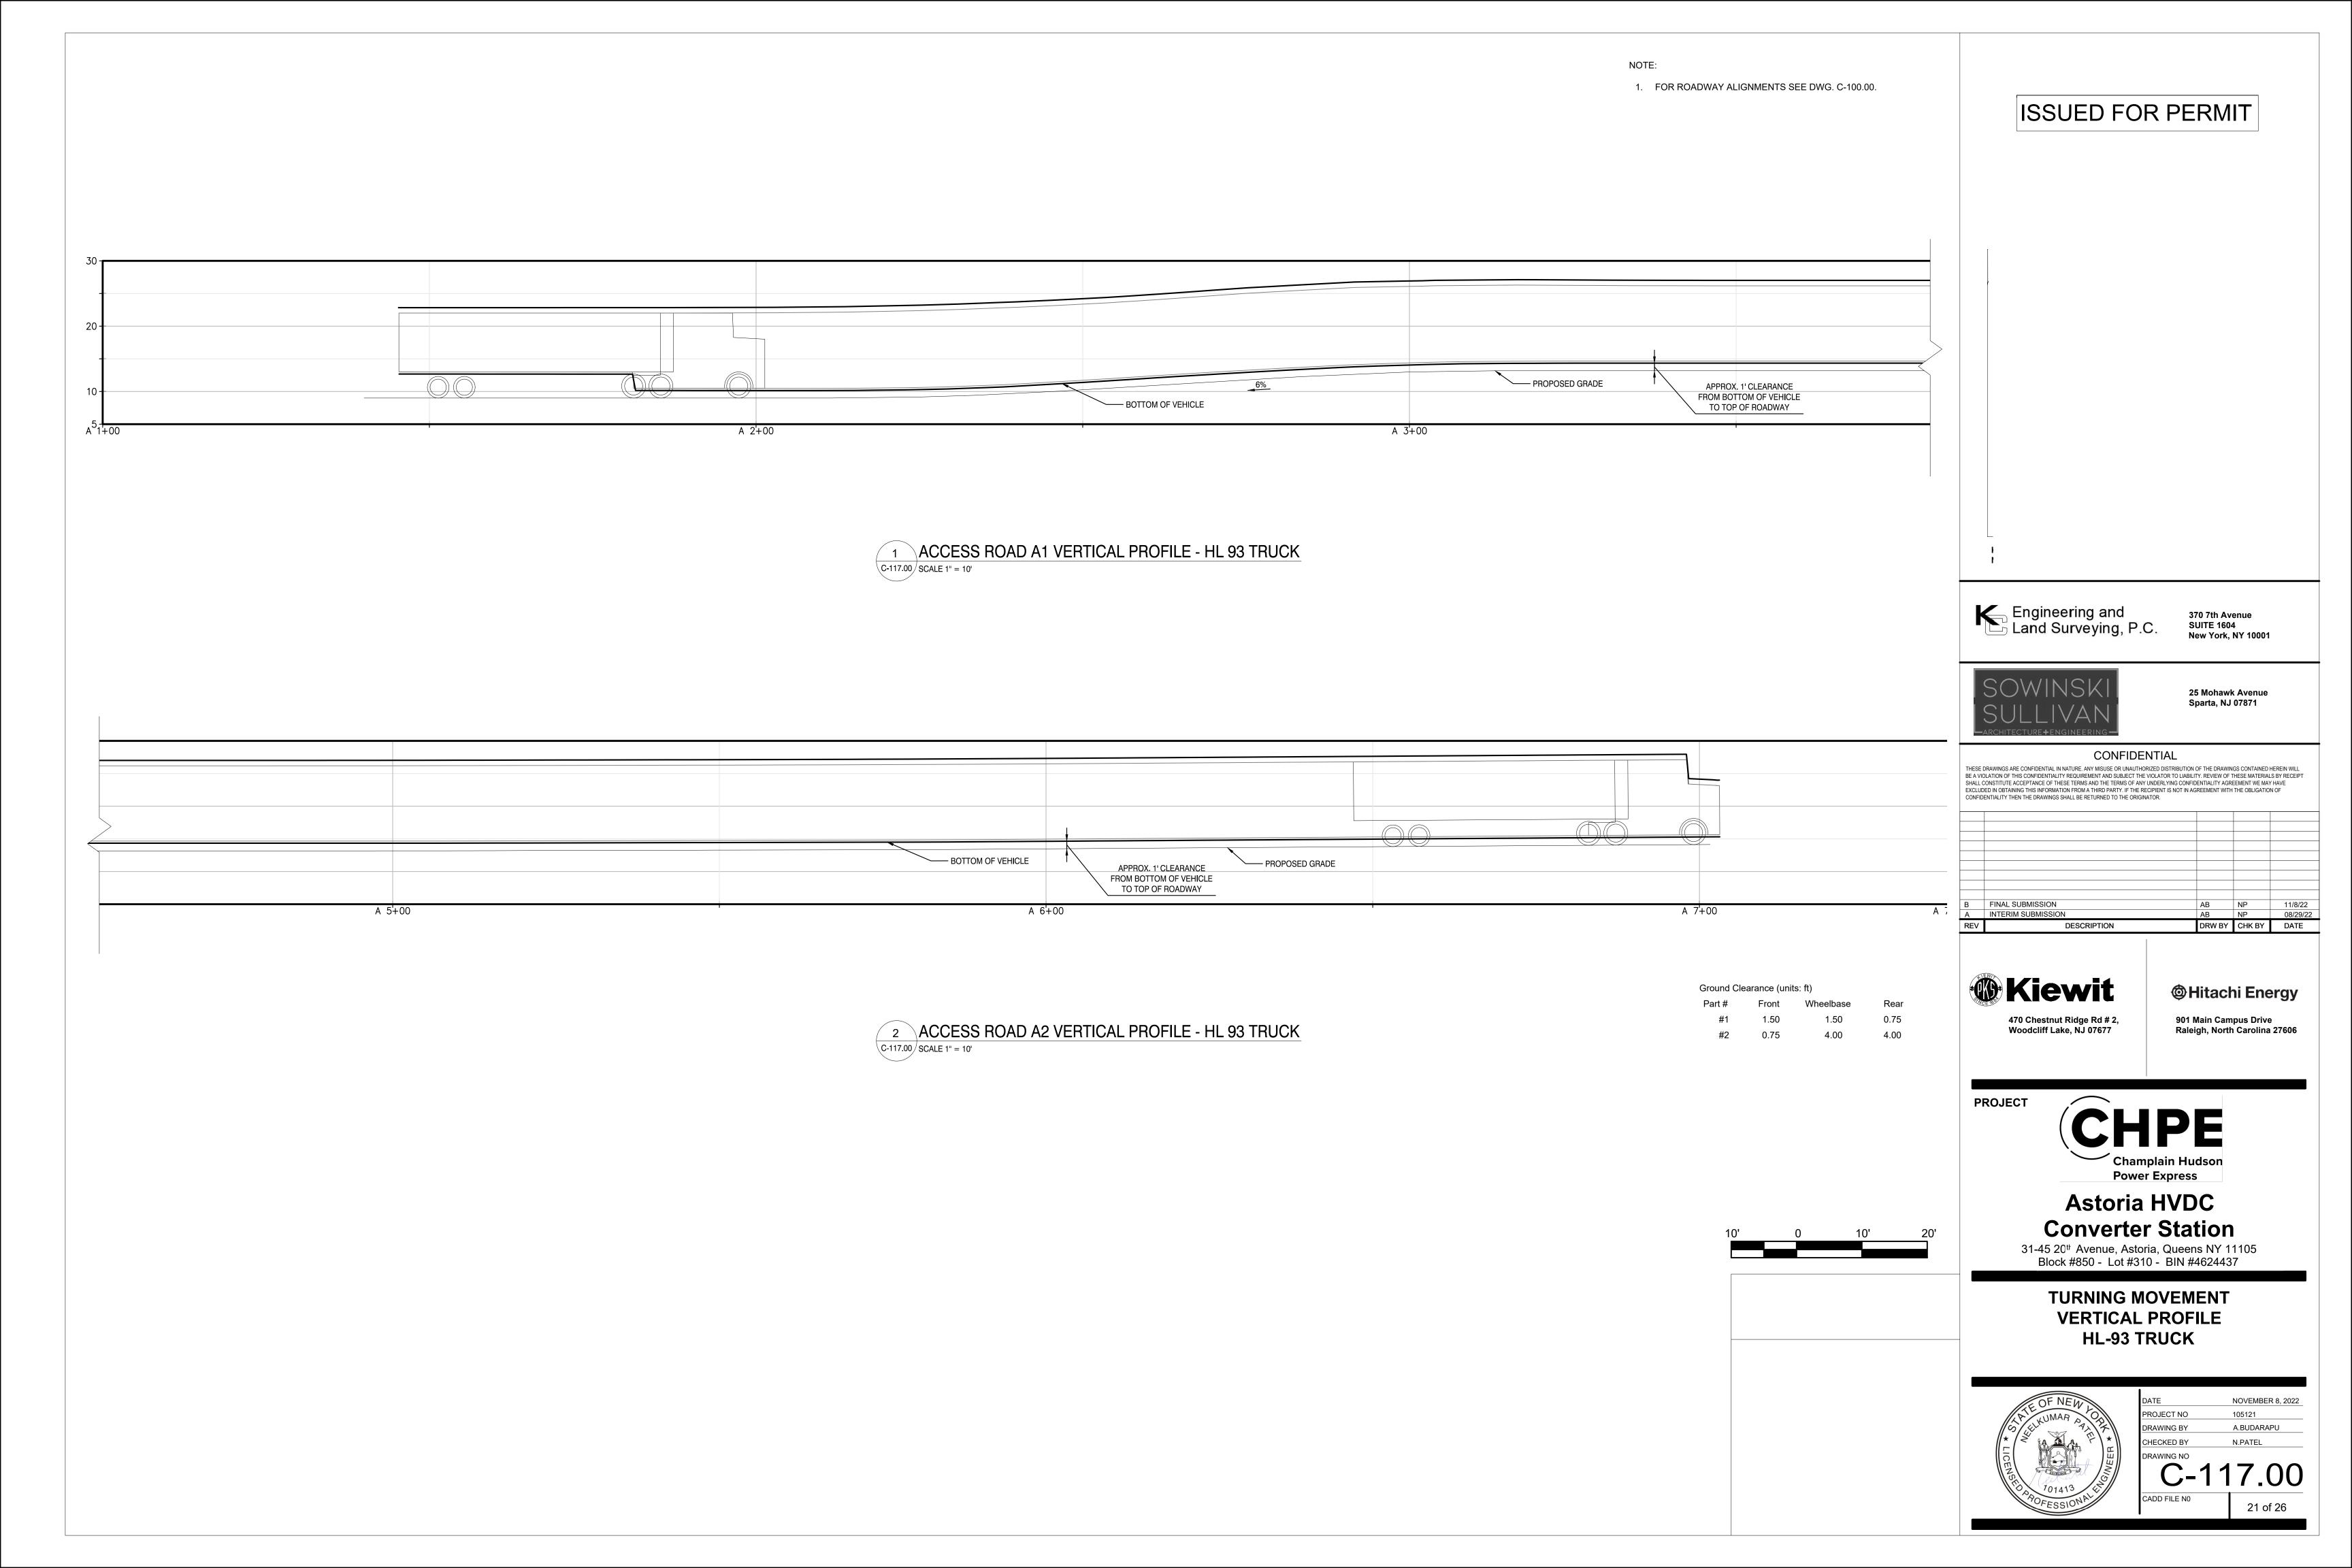

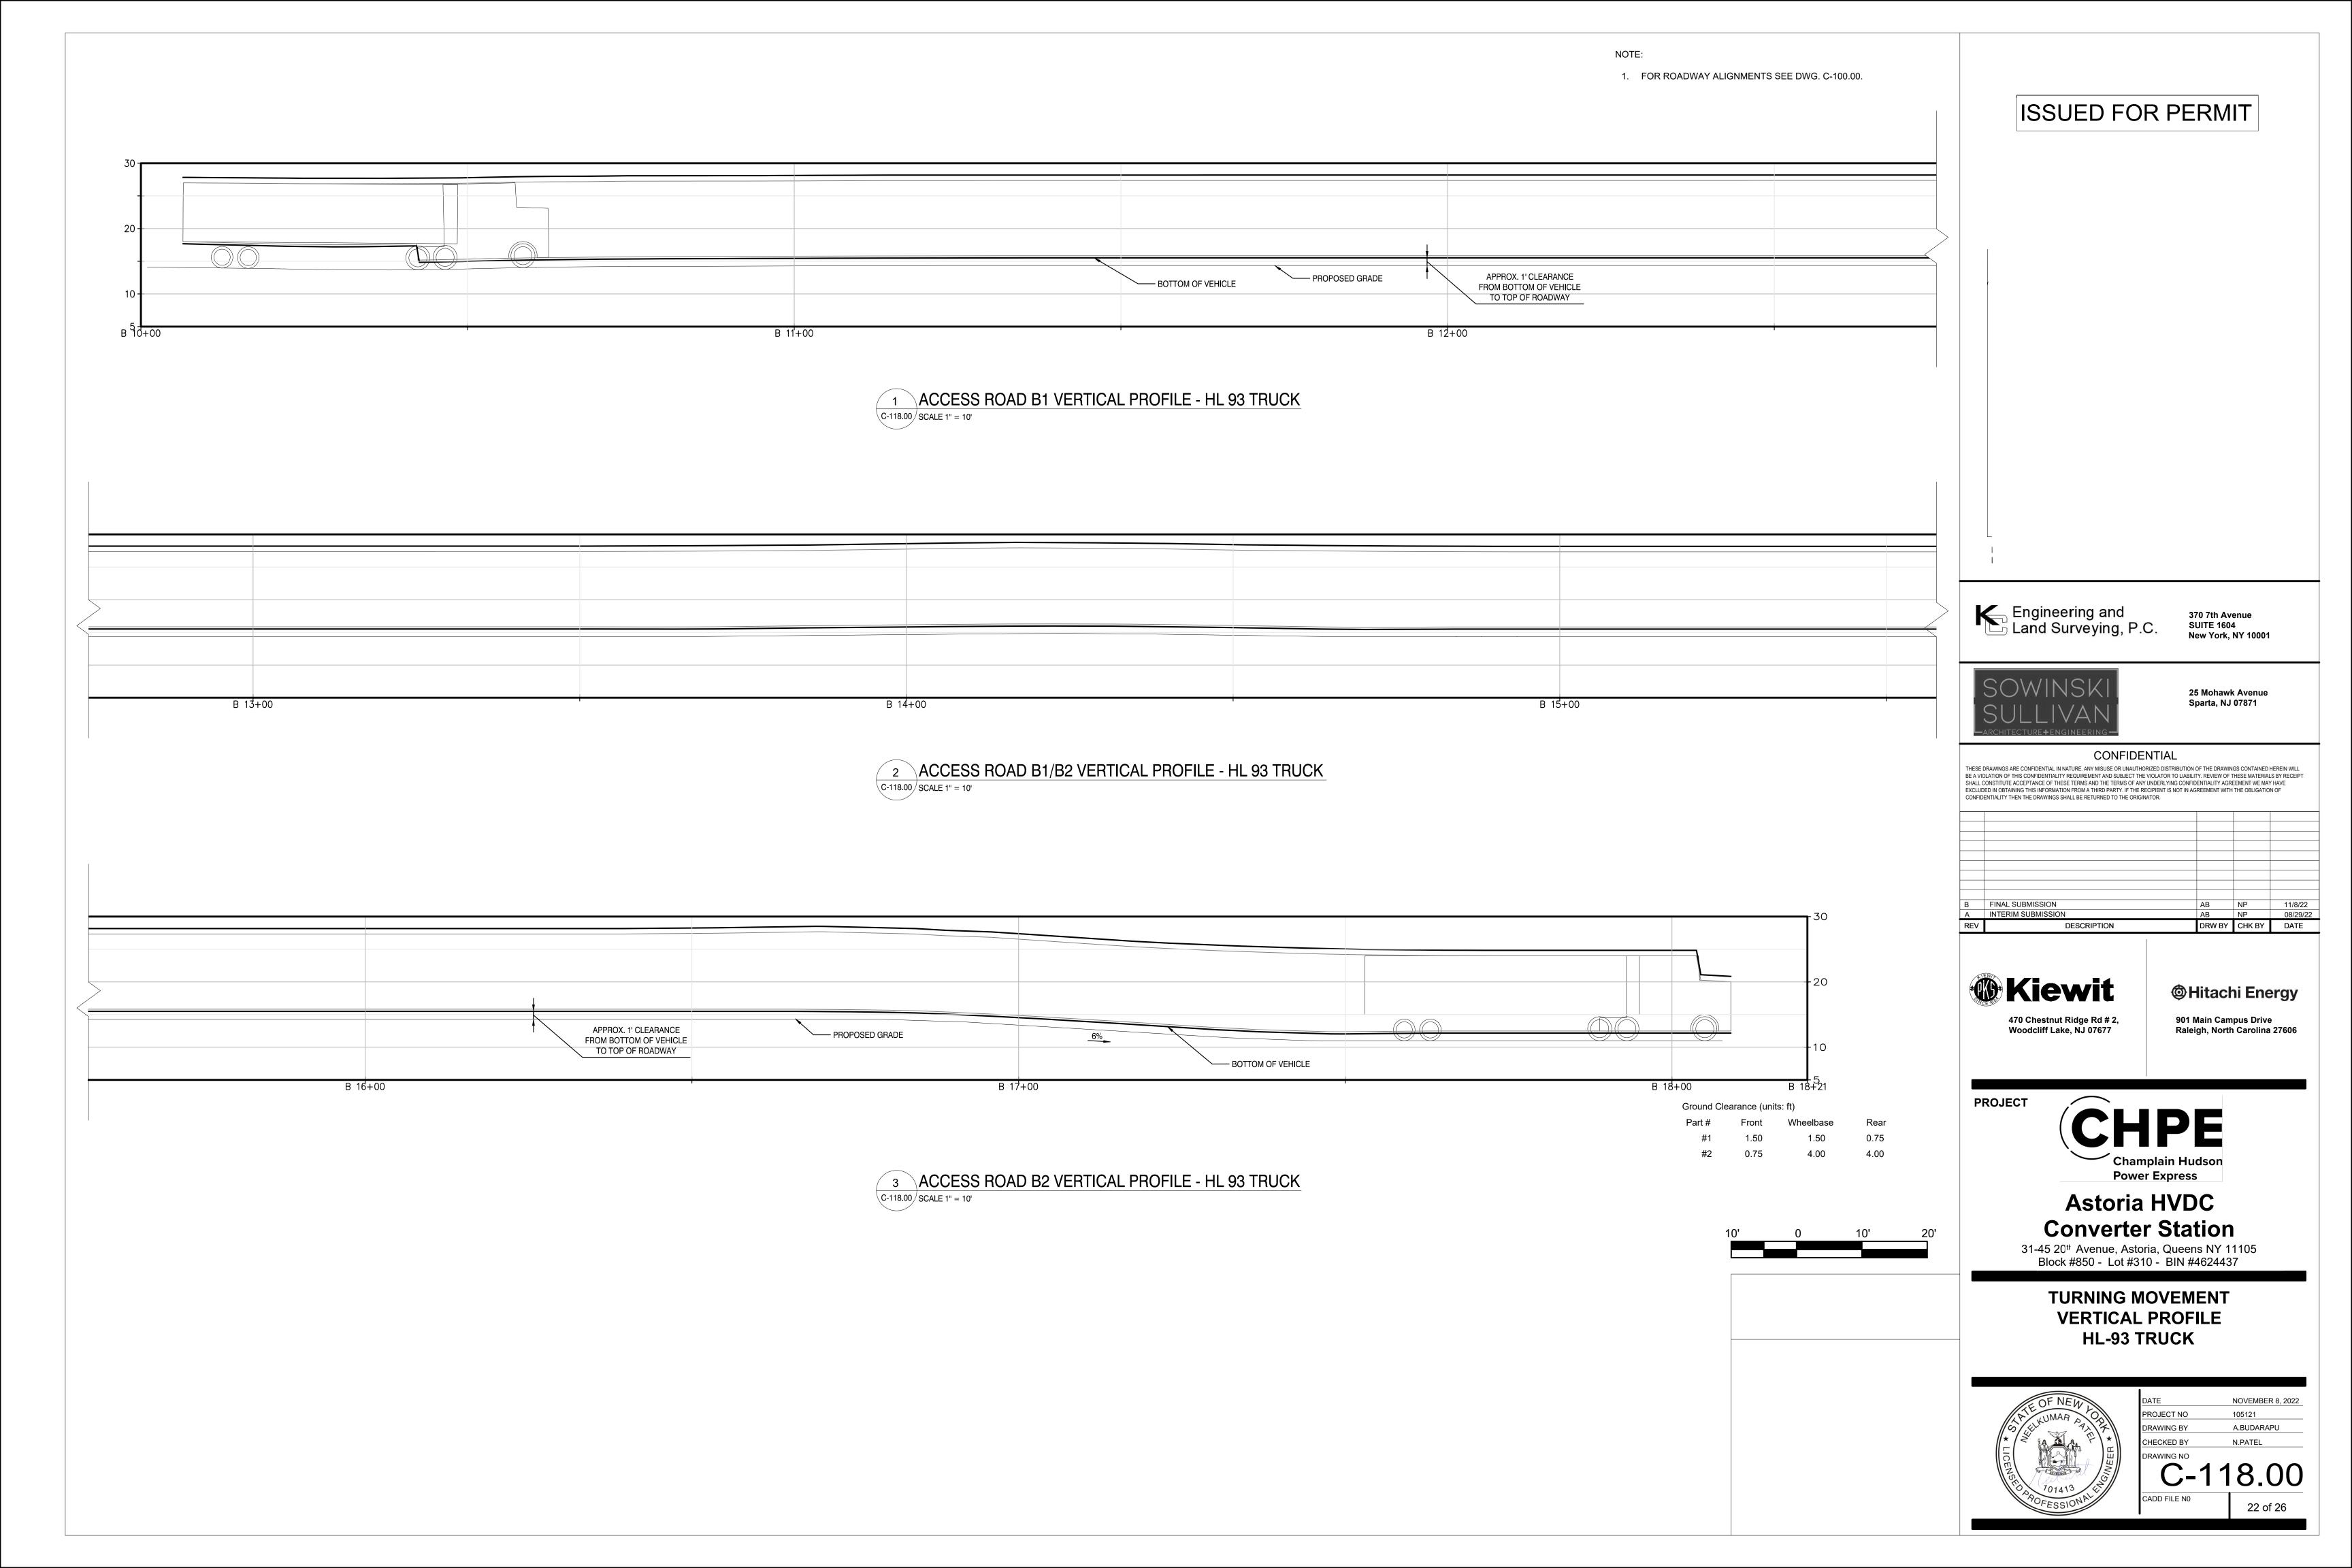

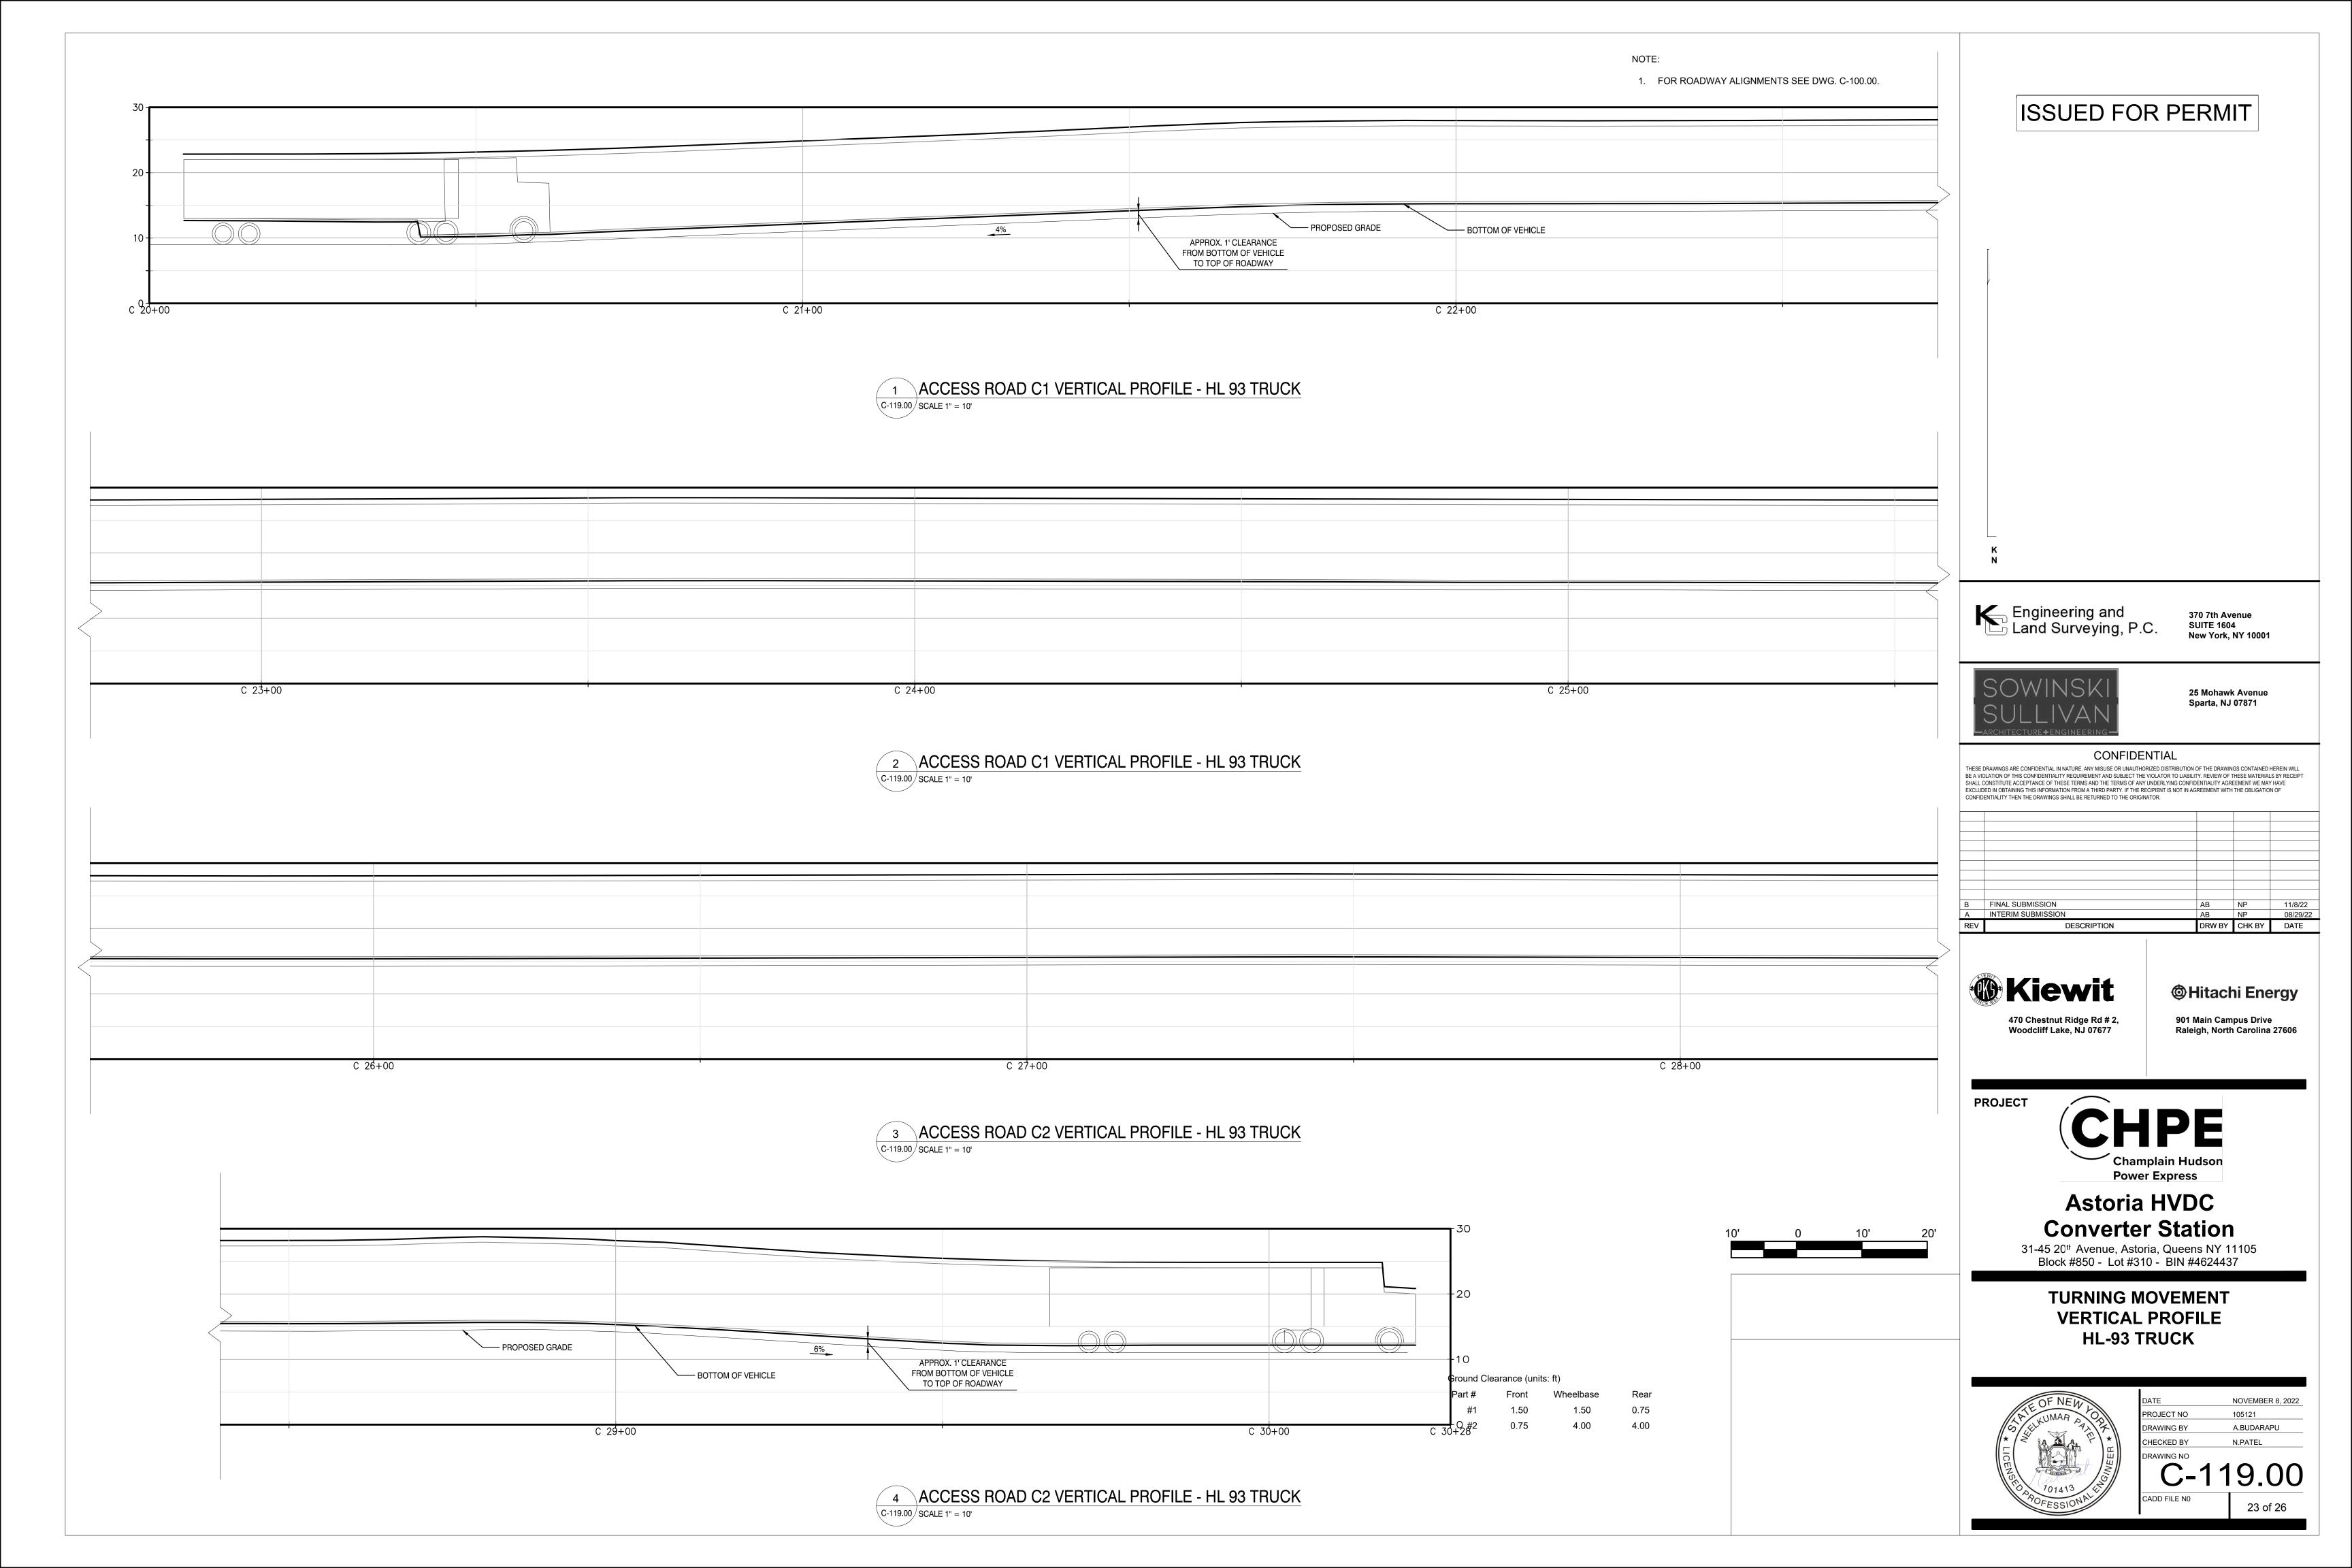

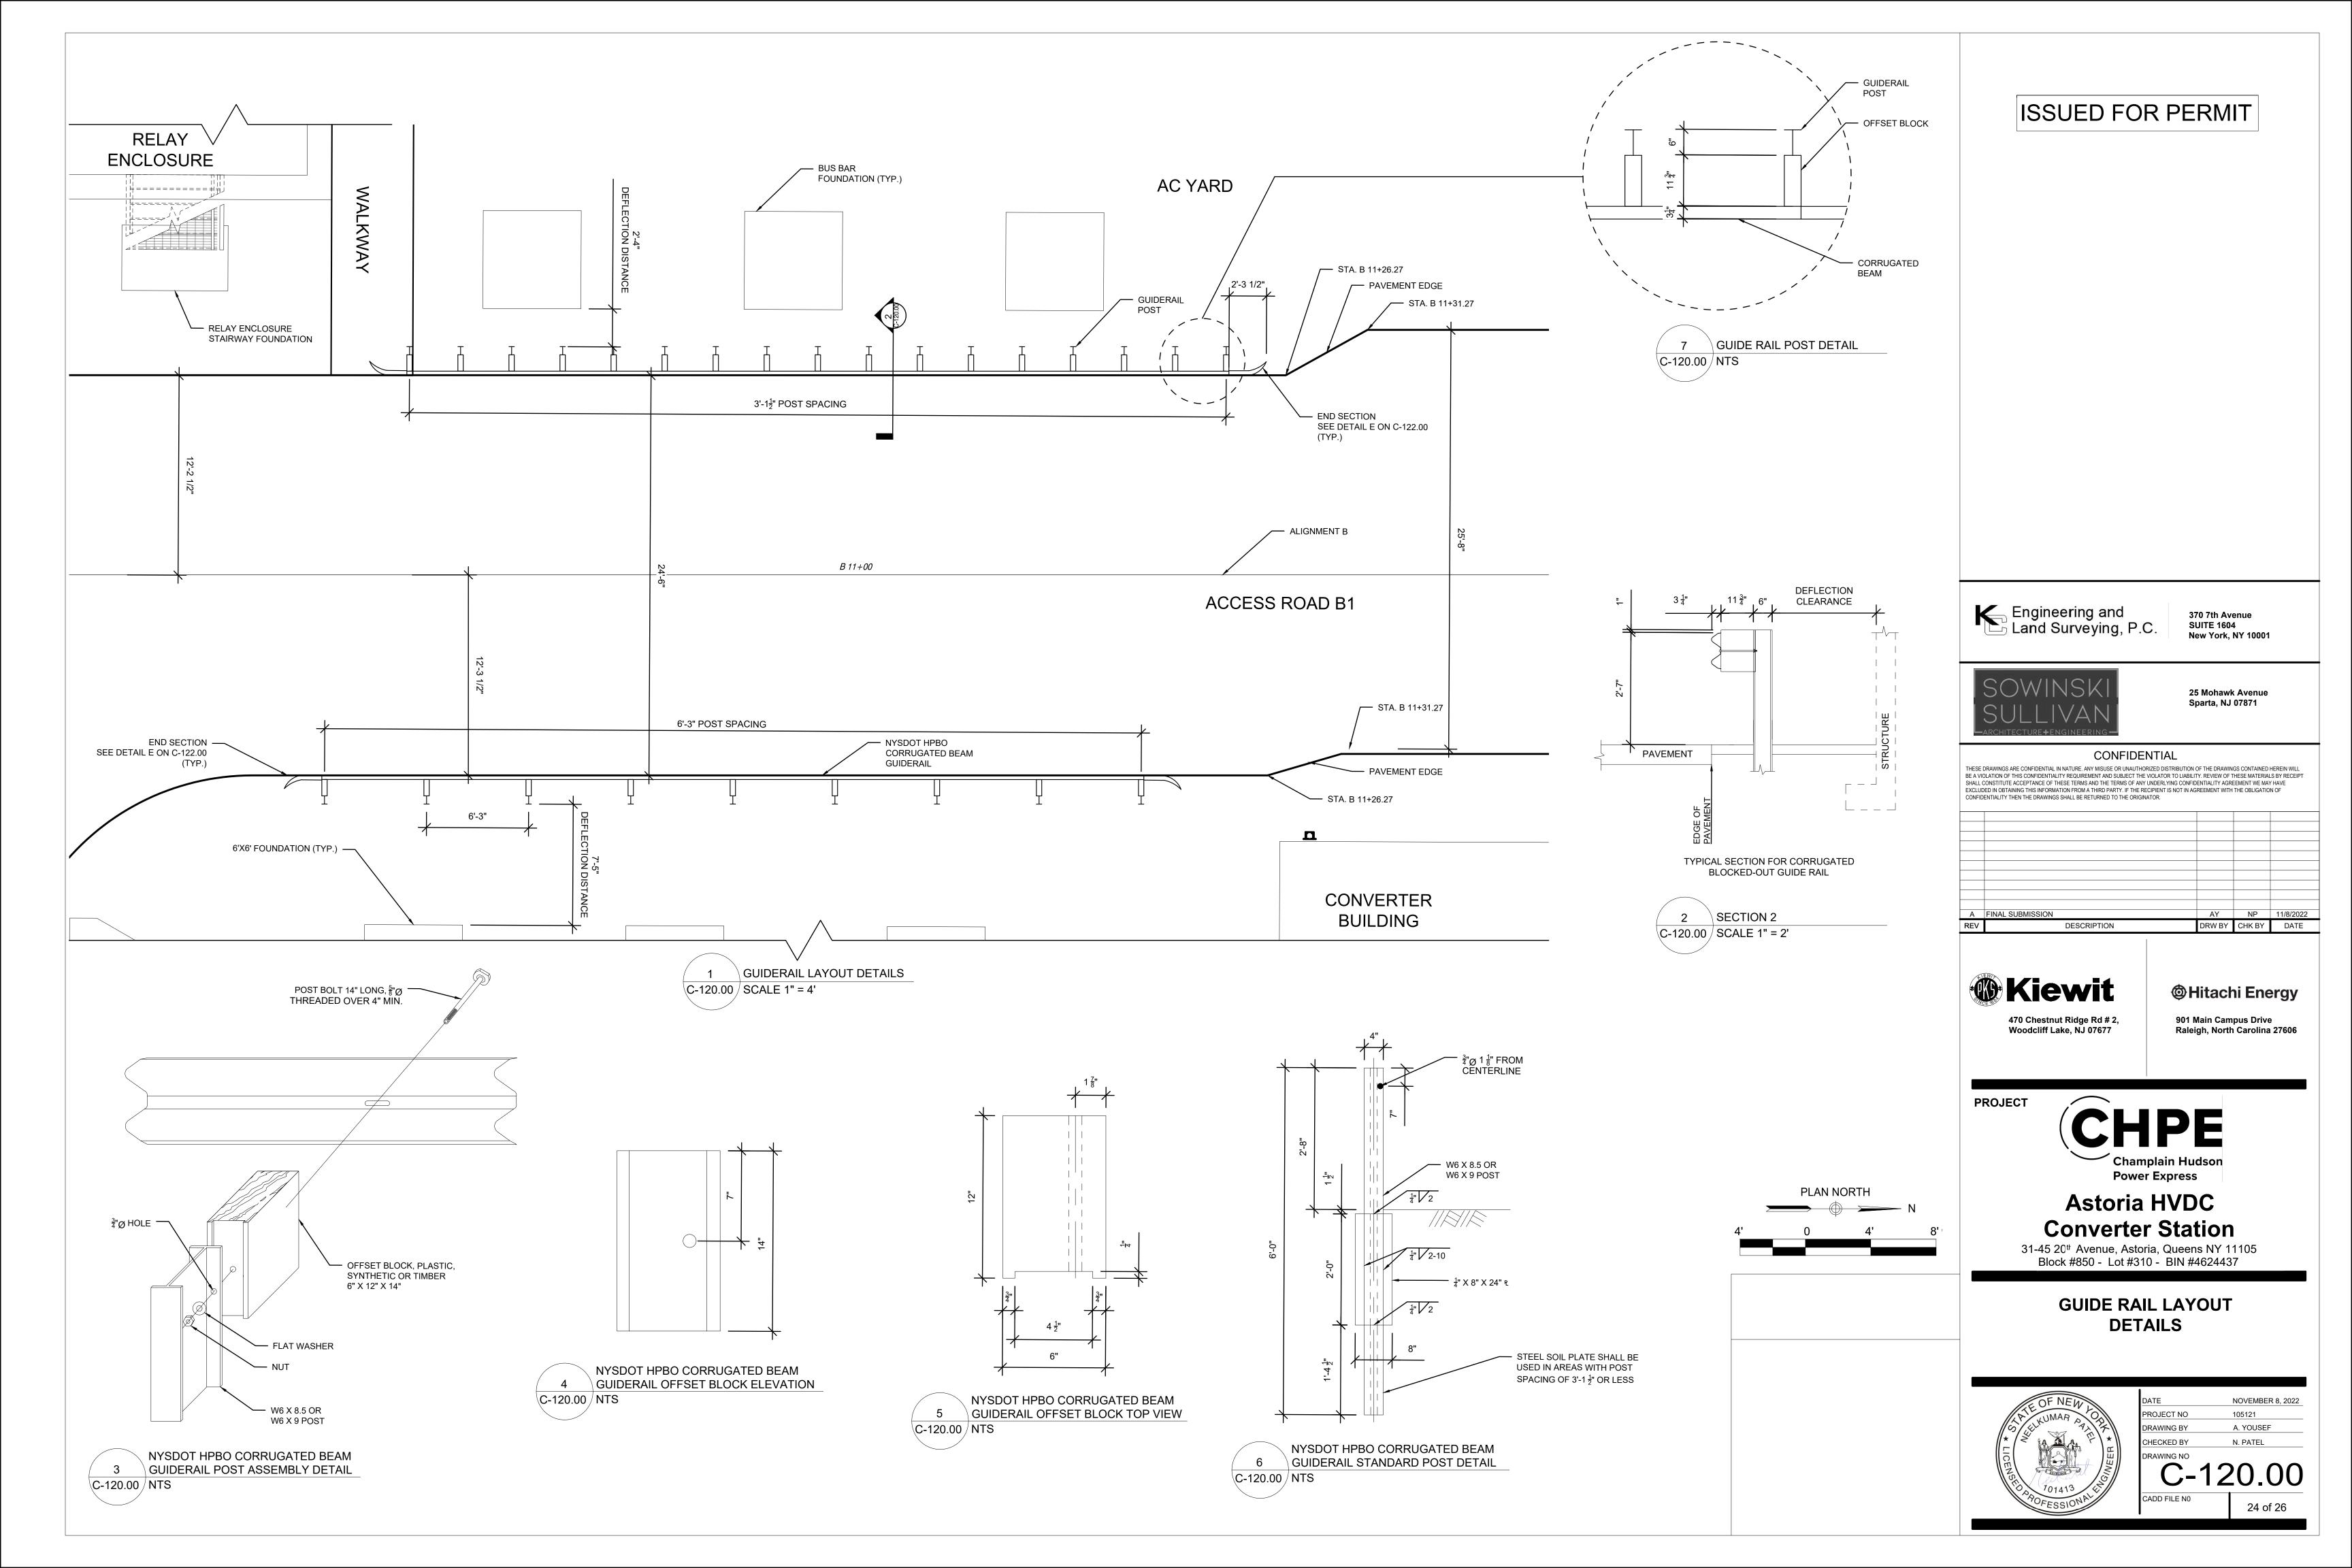

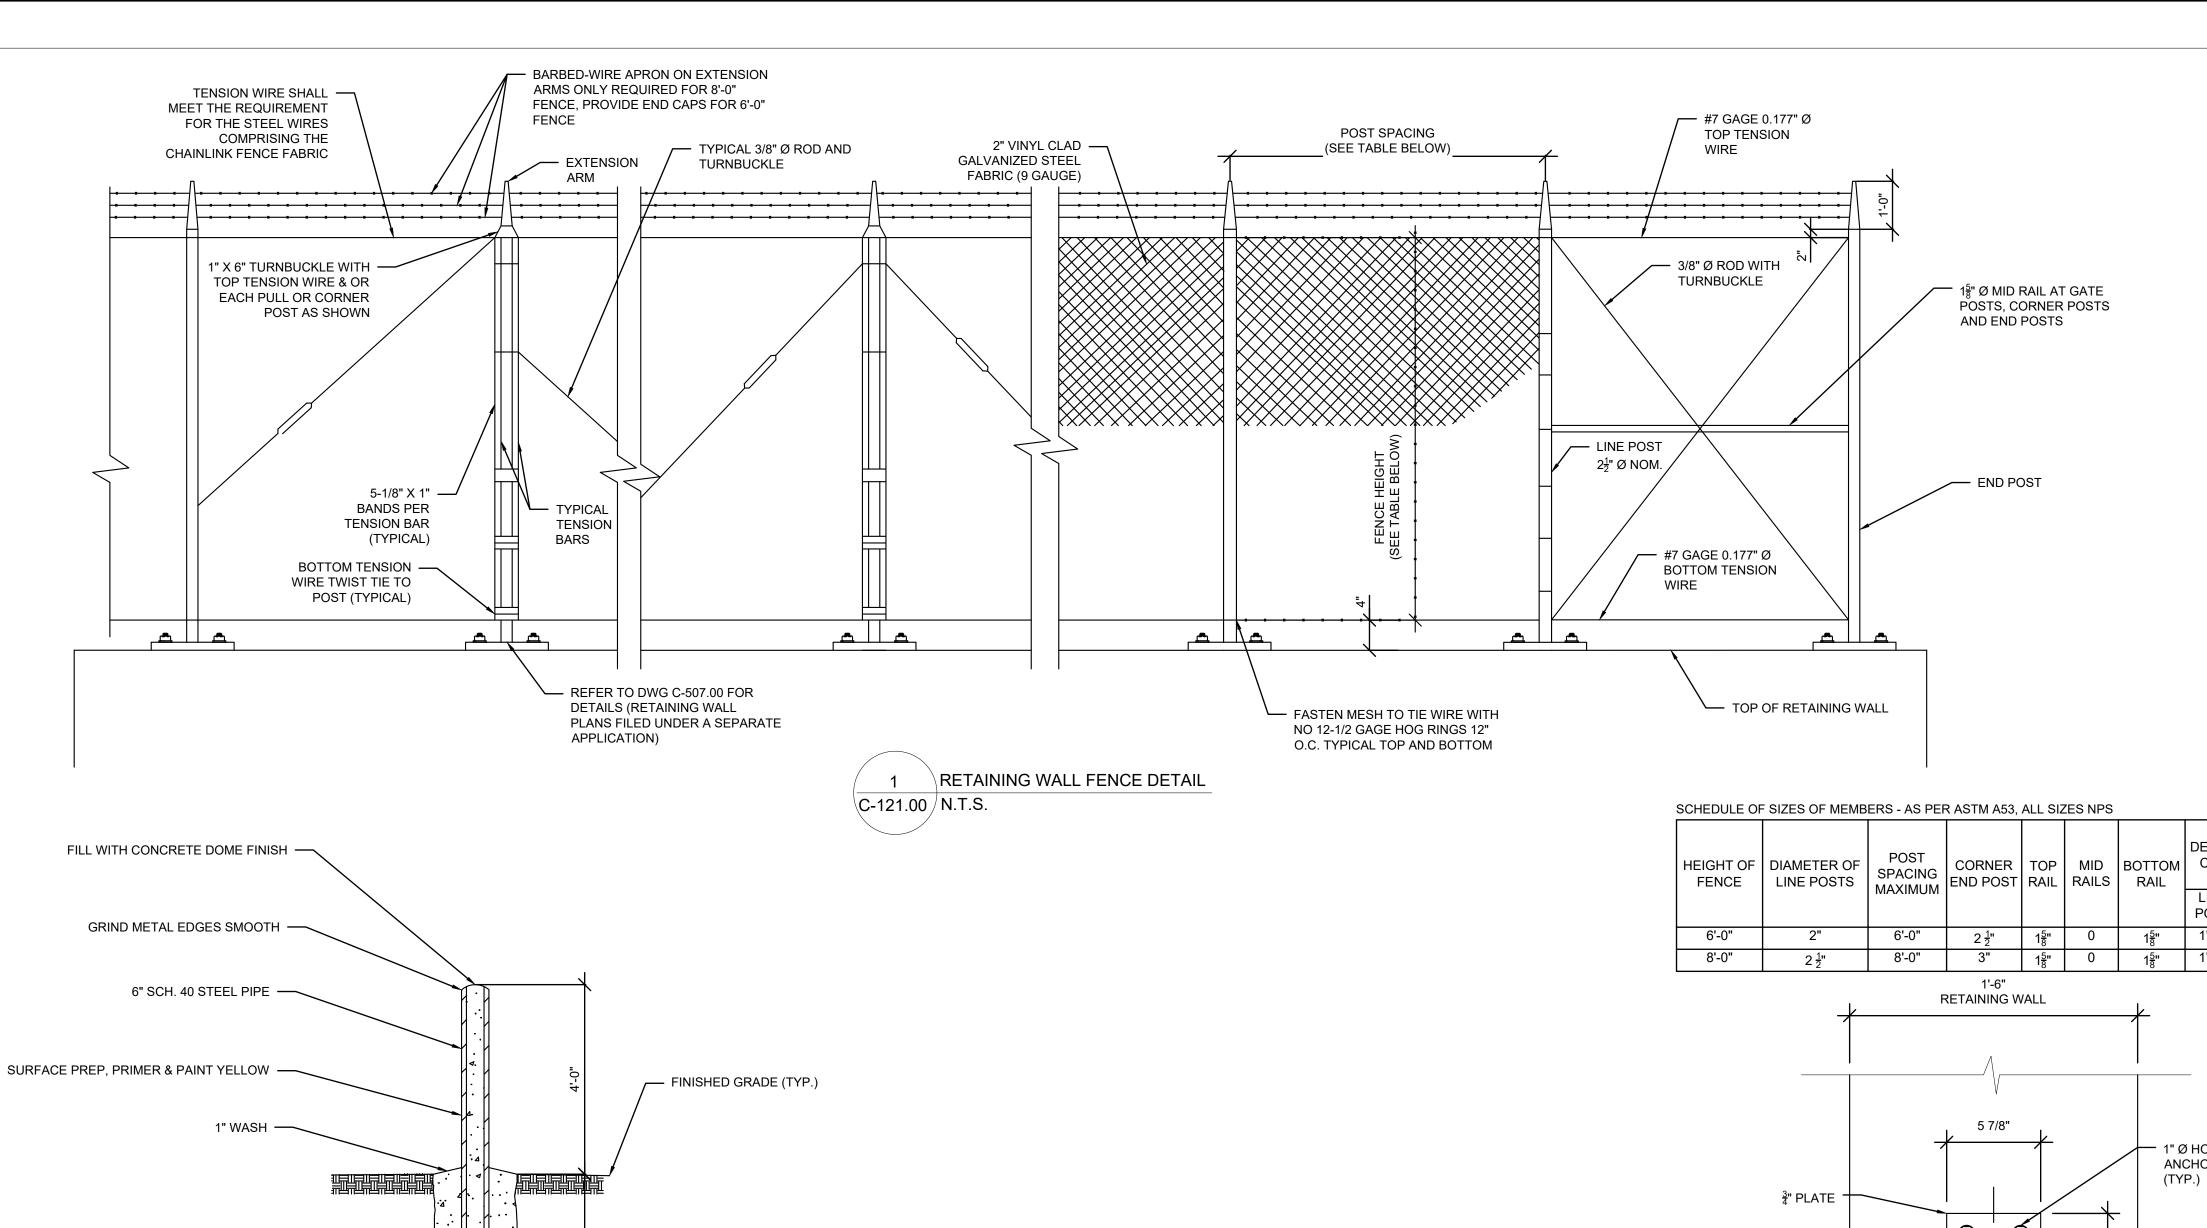

DEPTH OF POST INTO | HORIZONTAL CURB AND FTG AT: BRACES AT DIAGONAL CORNER & BRACES LINE END/CORNER END POST POST | /GATE POST 1'-8" <u>1</u>" DIA.

NOTES:

1. THE TENSION WIRE SHALL BE SECURED AT THE TOP WITH A

TWO-WAY CLAMP AT EACH SEVENTH POST FOR 6'-0" HIGH OR AT

EACH FIFTH POST FOR 8'-0" HIGH FENCING SO THAT THE MAX,

UNTIED SPAN OF TENSION WIRE DOES NOT EXCEED 36'-0" FOR 6'-0" HIGH OR 32'-0" FOR 8'-0" HIGH FENCE. WHEREAS, IF THE TOTAL LENGTH OF DAMAGED FABRIC TO BE REPLACED IS LESS

THAN 16'-0", NO TENSION WIRE SHALL BE INSTALLED, BUT THE

DAMAGED TOP RAIL SHALL BE REPLACED WITH NEW TOP RAIL.

2. CORNER POSTS SHALL BE USED AT SHARP BREAKS IN VERTICAL GRADE AND CHANGES IN HORIZONTAL ALIGNMENT OF 15° AND OVER. INTERMEDIATE PULL POSTS SHALL BE INSTALLED ALONG TANGENT FENCE RUNS AND SHALL BE SPACED AT INTERVALS

3. ALL FABRICATION AND INSTALLATION DETAILS OF THIS FENCING ARE SHOWN ON THE CONTRACT PLANS. ANY PROPOSED

CHANGES BY THE CONTRACTOR SHALL BE SUBMITTED IN WRITING, EXPLAINING THE REASON FOR SUCH REQUESTED

CHANGE AND SUPPLEMENTED BY CLEAR SHOP DRAWINGS

PERFORMED BY THE CONTRACTOR IN ACCORDANCE WITH THE

INTENT OF THE CONTRACT PLANS. ALL SUCH LAYOUT SHALL BE

4. LAYOUT OF CHAIN LINK FENCE POST LOCATIONS SHALL BE

CHECKED AND APPROVED BY THE ENGINEER PRIOR TO

5. THE FENCE SHALL BE CAREFULLY ALIGNED TO A UNIFORM

GRADE BY THE CONTRACTOR. BEFORE THE POSTS ARE

PERMANENTLY AFFIXED, THE ENGINEER SHALL INSPECT THE LINE AND GRADE, ORDER ANY NECESSARY ADJUSTMENTS AND

APPROVE THE FINAL ALIGNMENT IN THAT SECTION OF FENCING.

<sup>1</sup>⁄<sub>2</sub>" DIA.

DEFINING THE CONTRACTORS PROPOSAL.

1 AT 1등"


DAMAGES TO TOP OR BOTTOM RAILS HAVE BEEN INCURRED AND


NEW TENSION WIRES SHALL BE INSTALLED ONLY WHEN

REPLACEMENT IS NECESSARY.

NOT EXCEEDING 180'.

ERECTION OF FENCE.

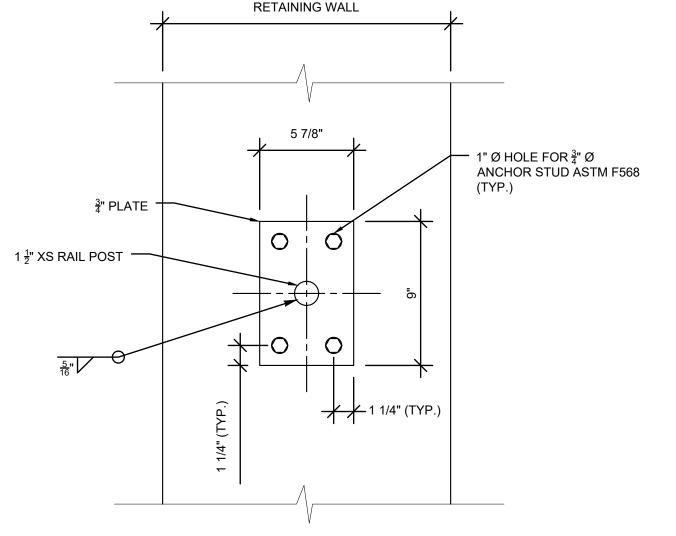

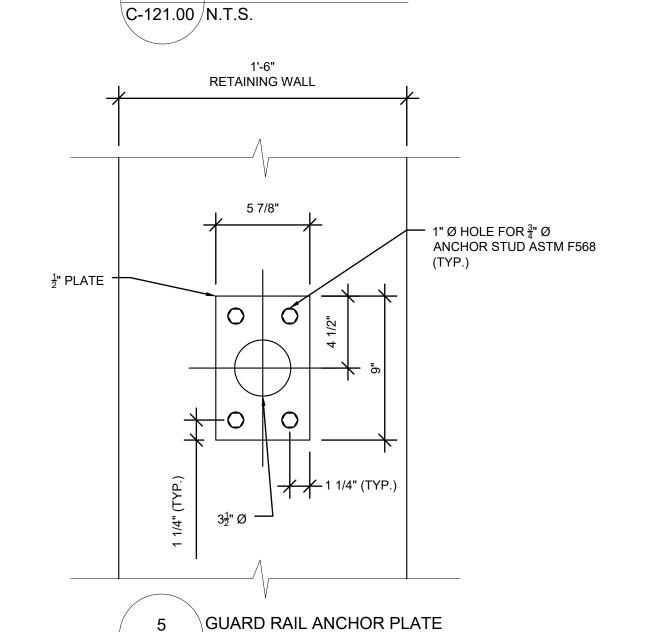

\C-121.00 / N.T.S.

GUARD RAIL BASE PLATE





370 7th Avenue **SUITE 1604** New York, NY 10001



25 Mohawk Avenue **Sparta, NJ 07871** 

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В	FINAL SUBMISSION	AY	NP	11/8/2022
Α	INTERIM SUBMISSION	AY	NP	9/12/2022
REV	DESCRIPTION	DRW BY	CHK BY	DATE



**PROJECT** 

**@**Hitachi Energy 901 Main Campus Drive

Raleigh, North Carolina 27606

**Champlain Hudson Power Express** 

### **Astoria HVDC Converter Station**

31-45 20th Avenue, Astoria, Queens NY 11105 Block #850 - Lot #310 - BIN #4624437

FENCE, GUARD RAIL, AND **BOLLARD DETAILS** 



1	
DATE	NOVEMBER 8, 2022
PROJECT NO	105121
DRAWING BY	A. YOUSEF
CHECKED BY	N. PATEL
DRAWING NO	
	101 00

C-121.0025 of 26

GUARD RAIL DETAIL C-121.00 N.T.S.

CL GUARD RAIL

2" MIN \_\_\_\_

GUARD RAIL TO BE ANCHORED -

ONTO RETAINING WALL 1 AND 3,

REFER TO DWG. C-505.00 AND

C-507.00(FILED UNDER A

SEPARATE APPLICATION)

— 3" R 90 DEGREE

(TYP.)

WELDED ELBOW

GROUNDING REQUIRED FOR

POSTS, BASE PLATES AND

UTILITY DRAWINGS FOR

DETAILS, FILED UNDER A

SEPARATE APPLICATION)

ANCHOR PLATES (REFER TO

20" DIA. CONC. BASE CAST IN PLACE -

(NYSDOT CLASS A CONCRETE)

BOLLARD DETAIL

\_8'-0" MAX POST SPACING

GUARD RAIL (TYP.) -

GRIND ALL WELDS —

SMOOTH (TYP.)

GUARD RAIL POST (TYP.) —

 $\frac{3}{4}$ "X5 $\frac{7}{8}$ "X9" BASE PLATE (TYP.)

 $\frac{1}{2}$ "X5 $\frac{7}{8}$ "X9" ANCHOR PLATE (TYP.)

C-121.00 N.T.S.

— ALL MEMBERS SHALL BE

GALVANIZED

TOP OF RETAINING WALL —

# **GUARD RAIL NOTES**

GUARD RAIL MEMBERS SHALL BE THE MATERIAL AND SIZE SHOWN BELOW FOR THE RESPECTIVE TYPE IN ORDER OF PREFERENCE:

a. POST i. PIPE 1-1/2XS. ..ASTM A53 GRADE B, TYPE E OR S ..ASTM A1085 OR ASTM A500 GRADE B/C ii. HSS1.900X0.188.

a. SLEEVES

i. PIPE 2STD... ..ASTM A53 GRADE B, TYPE E OR S

..ASTM A1085 OR ASTM A500 GRADE B/C ii. HSS2.375X0.154.

b. OTHER MEMBERS

i. PIPE1-1/2STD.... ii. HSS1.900X0.145..

..ASTM A53 GRADE B, TYPE E OR S ..ASTM A1085 OR ASTM A500 GRADE B/C

