
APPENDIX C: PLAN & PROFILE DRAWINGS, EROSION AND SEDIMENT CONTROL PLANS, AND MAINTENANCE AND PROTECTION OF TRAFFIC PLANS CASE 10-T-0139

CHAMPLAIN HUDSON POWER EXPRESS

SEGMENT 8 (PACKAGE 5A) CSX: ROTTERDAM TO BETHLEHEM SCHENECTADY & ALBANY COUNTY, NEW YORK FINAL SUBMISSION PLANS

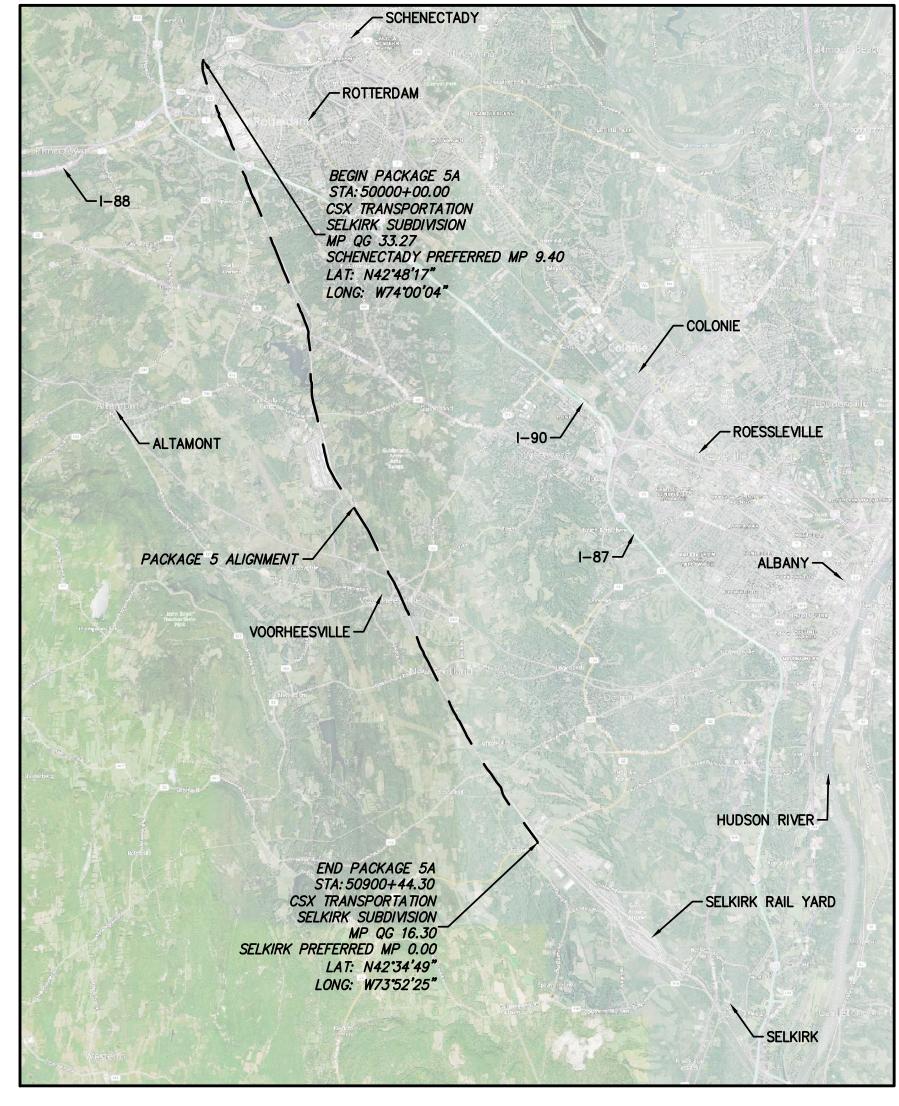







IS A VIOLATION OF LAW FOR ANY PERSON, UNLESS THEY ARE ACTING UNDER THE DIRECTION OF A LICENSED R LAND SURVEYOR TO ALTER AN ITEM IN ANY WAY. IF AN **FOR EMCP REVIEW** LTERED. THE ALTERING ENGINEER, ARCHITECT, LANDSCAPE NOT FOR CONSTRUCTION RCHITECT OR LAND SURVEYOR SHALL STAMP THE DOCUMENT AND INCLUDE THE NOTATION "ALTERED BY" FOLLOWED BY THEIR SIGNATURE, THE DATE OF SUCH ALTERATION, AND A SPECIFIC DESCRIPTION OF THE ALTERATION.

					CHAMPLAIN HUDSC	JN POV	VER EX
					SEGMENT 8 (PACKAGE 5A) - C	CSX: ROTT	ERDAM -
Е	12/16/2022	FINAL SUBMISSION	BV	TK	, , ,		
D	11/11/2022	DRAFT FINAL SUBMISSION	BV	TK	COVER	R SHEET	
С	06/06/2022	60% DESIGN SUBMISSION	BV	TK			
В	02/11/2022	PRELIMINARY DESIGN DEVELOPMENT	BV	TK			
Α	01/24/2022	PRELIMINARY PROGRESS	BV	TK			
No.	DATE	SUBMITTAL / REVISION DESCRIPTION	DB	APP	DRAWN BY: AR DESIGNED BY: BV AP	PPROVED BY:	TK SCALE REV. NO.

KIEWIT PROJECT NO. CHAMPLAIN HUDSON POWER EXPRESS 21162 SEGMENT 8 (PACKAGE 5A) - CSX: ROTTERDAM - BETHLEHEM **COVER SHEET** DRAWING NO. **G-000** AS SHOWN DATE

	I
	SHEET INDEX
DRAWING NO.	SHEET TITLE
PACKAGE 5A: GENER	I RAL SHEETS
G-000	COVER SHEET
G-001	SHEET INDEX
G-002	GENERAL NOTES 1 OF 2
G-003	GENERAL NOTES 2 OF 2
G-004	PACKAGE SPECIFIC NOTES
G-005	LEGEND AND ABBREVIATIONS
G-006	PLAN AND PROFILE KEY MAP
G-007	SPLICE, LINK BOX HANDHOLE, AND FIBER SPLICE HANDHOLE LOCATION TABLES
G-008	TEST HOLE TABLE
G-009	EM-CP DATA TABLES
G-010	EM-CP DATA TABLES
G-011	EM-CP DATA TABLES
G-012	EM-CP DATA TABLES
G-013	EM-CP DATA TABLES
G-014	EM-CP DATA TABLES
G-015	EM-CP DATA TABLES
	AND PROFILE SHEETS
C-101	STA. 50000+00.00 TO STA. 50015+00.00 PLAN AND PROFILE
C-102	STA. 50015+00.00 TO STA. 50030+00.00 PLAN AND PROFILE
C-103	STA. 50030+00.00 TO STA. 50045+00.00 PLAN AND PROFILE
C-104	STA. 50045+00.00 TO STA. 50060+00.00 PLAN AND PROFILE
C-105	STA. 50060+00.00 TO STA. 50075+00.00 PLAN AND PROFILE
C-106	STA. 50075+00.00 TO STA. 50090+00.00 PLAN AND PROFILE
C-107	STA. 50090+00.00 TO STA. 50105+00.00 PLAN AND PROFILE
C-108	STA. 50105+00.00 TO STA. 50120+00.00 PLAN AND PROFILE
C-109	STA. 50120+00.00 TO STA. 50135+00.00 PLAN AND PROFILE
C-110	STA. 50135+00.00 TO STA. 50150+00.00 PLAN AND PROFILE
C-111	STA. 50150+00.00 TO STA. 50165+00.00 PLAN AND PROFILE
C-112	STA. 50165+00.00 TO STA. 50180+00.00 PLAN AND PROFILE
C-113	STA. 50180+00.00 TO STA. 50195+00.00 PLAN AND PROFILE
C-114	STA. 50195+00.00 TO STA. 50210+00.00 PLAN AND PROFILE
C-115	STA. 50210+00.00 TO STA. 50225+00.00 PLAN AND PROFILE
C-116	STA. 50225+00.00 TO STA. 50240+00.00 PLAN AND PROFILE
C-117	STA. 50240+00.00 TO STA. 50255+00.00 PLAN AND PROFILE
C-118	STA. 50255+00.00 TO STA. 50270+00.00 PLAN AND PROFILE
C-119	STA. 50270+00.00 TO STA. 50285+00.00 PLAN AND PROFILE
C-120	STA. 50285+00.00 TO STA. 50300+00.00 PLAN AND PROFILE
C-121	STA. 50300+00.00 TO STA. 50315+00.00 PLAN AND PROFILE
C-122	STA. 50315+00.00 TO STA. 50330+00.00 PLAN AND PROFILE
C-123	STA. 50330+00.00 TO STA. 50345+00.00 PLAN AND PROFILE
C-124	STA. 50345+00.00 TO STA. 50360+00.00 PLAN AND PROFILE
C-125	STA. 50360+00.00 TO STA. 50375+00.00 PLAN AND PROFILE
C-126	STA. 50375+00.00 TO STA. 50390+00.00 PLAN AND PROFILE
C-127	STA. 50390+00.00 TO STA. 50405+00.00 PLAN AND PROFILE
C-128	STA. 50405+00.00 TO STA. 50420+00.00 PLAN AND PROFILE
C-129	STA. 50420+00.00 TO STA. 50435+00.00 PLAN AND PROFILE
C-130	STA. 50435+00.00 TO STA. 50450+00.00 PLAN AND PROFILE
C-131	STA. 50450+00.00 TO STA. 50465+00.00 PLAN AND PROFILE
C-132	STA. 50465+00.00 TO STA. 50480+00.00 PLAN AND PROFILE
C-133	STA. 50480+00.00 TO STA. 50495+00.00 PLAN AND PROFILE
C-134	STA. 50495+00.00 TO STA. 50510+00.00 PLAN AND PROFILE
C-135	STA. 50510+00.00 TO STA. 50525+00.00 PLAN AND PROFILE
C-136	STA. 50525+00.00 TO STA. 50540+00.00 PLAN AND PROFILE
C-137	STA. 50540+00.00 TO STA. 50555+00.00 PLAN AND PROFILE
C-137	STA. 50555+00.00 TO STA. 50570+00.00 PLAN AND PROFILE
C-139	STA. 50570+00.00 TO STA. 50570+00.00 PLAN AND PROFILE STA. 50570+00.00 TO STA. 50585+00.00 PLAN AND PROFILE
C-139	STA. 50570+00.00 TO STA. 50585+00.00 PLAN AND PROFILE STA. 50585+00.00 TO STA. 50600+00.00 PLAN AND PROFILE
C-140	STA. 50600+00.00 TO STA. 50600+00.00 PLAN AND PROFILE STA. 50600+00.00 TO STA. 50615+00.00 PLAN AND PROFILE
C-141	STA. 50600+00.00 TO STA. 50615+00.00 PLAN AND PROFILE STA. 50615+00.00 TO STA. 50630+00.00 PLAN AND PROFILE
C-142	
	STA. 50630+00.00 TO STA. 50660+00.00 PLAN AND PROFILE
C-144	STA. 50645+00.00 TO STA. 50660+00.00 PLAN AND PROFILE

	SHEET INDEX
DRAWING NO.	SHEET TITLE
C-145	STA. 50660+00.00 TO STA. 50675+00.00 PLAN AND PROFILE
C-146	STA. 50675+00.00 TO STA. 50690+00.00 PLAN AND PROFILE
C-147	STA. 50690+00.00 TO STA. 50705+00.00 PLAN AND PROFILE
C-148	STA. 50705+00.00 TO STA. 50720+00.00 PLAN AND PROFILE
C-149	STA. 50720+00.00 TO STA. 50735+00.00 PLAN AND PROFILE
C-150	STA. 50735+00.00 TO STA. 50750+00.00 PLAN AND PROFILE
C-151	STA. 50750+00.00 TO STA. 50765+00.00 PLAN AND PROFILE
C-152	STA: 50765+00.00 TO STA: 50780+00.00 PLAN AND PROFILE
C-153	STA: 50780+00.00 TO STA: 50795+00.00 PLAN AND PROFILE
C-154	STA: 50795+00.00 TO STA: 50793+00.00 PLAN AND PROFILE
C-155	
	STA. 50810+00.00 TO STA. 50825+00.00 PLAN AND PROFILE
C-156	STA. 50825+00.00 TO STA. 50840+00.00 PLAN AND PROFILE
C-157	T
C-158	STA. 50855+00.00 TO STA. 50870+00.00 PLAN AND PROFILE
C-159	STA. 50870+00.00 TO STA. 50885+00.00 PLAN AND PROFILE
C-160	STA. 50885+00.00 TO STA. 50900+44.30 PLAN AND PROFILE
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C-201	TEMP OFF-SITE ACCESS ROADS (1 OF 10)
C-202	TEMP OFF-SITE ACCESS ROADS (2 OF 10)
C-203	TEMP OFF-SITE ACCESS ROADS (3 OF 10)
C-204	TEMP OFF-SITE ACCESS ROADS (4 OF 10)
C-205	TEMP OFF-SITE ACCESS ROADS (5 OF 10)
C-206	TEMP OFF-SITE ACCESS ROADS (6 OF 10)
C-207	TEMP OFF-SITE ACCESS ROADS (7 OF 10)
C-208	TEMP OFF-SITE ACCESS ROADS (8 OF 10)
C-209	TEMP OFF-SITE ACCESS ROADS (9 OF 10)
C-210	TEMP OFF-SITE ACCESS ROADS (10 OF 10)
C-211	TEMP OFF-SITE ACCESS ROUTES (1 OF 12)
C-212	TEMP OFF-SITE ACCESS ROUTES (2 OF 12)
C-213	TEMP OFF-SITE ACCESS ROUTES (3 OF 12)
C-214	TEMP OFF-SITE ACCESS ROUTES (4 OF 12)
C-215	TEMP OFF-SITE ACCESS ROUTES (5 OF 12)
C-216	TEMP OFF-SITE ACCESS ROUTES (6 OF 12)
C-217	TEMP OFF-SITE ACCESS ROUTES (7 OF 12)
C-218	TEMP OFF-SITE ACCESS ROUTES (8 OF 12)
C-219	TEMP OFF-SITE ACCESS ROUTES (9 OF 12)
	, ,
C-220	TEMP OFF-SITE ACCESS ROUTES (10 OF 12)
C-221	TEMP OFF-SITE ACCESS ROUTES (11 OF 12)
C-222	TEMP OFF-SITE ACCESS ROUTES (12 OF 12)
PACKAGE 5A: HDD	
C-301	PLAN AND PROFILE - HDD 71 - CONDUIT 1
C-302	PLAN AND PROFILE - HDD 71 - CONDUIT 1
C-303	PLAN AND PROFILE - HDD 71 - CONDUIT 1
C-304	PLAN AND PROFILE - HDD 71 - CONDUIT 1
C-305	PLAN AND PROFILE - HDD 72 - CONDUIT 1
C-306	PLAN AND PROFILE - HDD 72 - CONDUIT 2
C-307	PLAN AND PROFILE - HDD 73 - CONDUIT 1
C-308	PLAN AND PROFILE - HDD 73 - CONDUIT 2
C-309	PROPOSED PLAN AND PROFILE HDD 73A, 74 - CONDUIT 1
C-310	PROPOSED PLAN AND PROFILE HDD 73A, 74 - CONDUIT 1
C-311	PROPOSED PLAN AND PROFILE HDD 73A, 74 - CONDUIT 2
C-312	PROPOSED PLAN AND PROFILE HDD 73A, 74 - CONDUIT 2
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C-314	PLAN AND PROFILE - HDD 75 - CONDUIT 2
C-315	PROPOSED PLAN AND PROFILE HDD 75.A.A — CONDUIT 1
C-316	PROPOSED PLAN AND PROFILE HDD 75.A.A — CONDUIT 2
C-317	PROPOSED PLAN AND PROFILE HDD 75.A — CONDUIT 1
C-318	PROPOSED PLAN AND PROFILE HDD 75.A — CONDUIT 1
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C-319	PROPOSED PLAN AND PROFILE HDD 75.A — CONDUIT 2
	PROPOSED PLAN AND PROFILE HDD 75.A — CONDUIT 2 PROPOSED PLAN AND PROFILE HDD 75.A — CONDUIT 2
C-319	

DRAWING NO.	SHEET INDEX SHEET TITLE
C-323	
	PROPOSED PLAN AND PROFILE HDD 76, 76A - CONDUIT 1
C-324	PROPOSED PLAN AND PROFILE HDD 76, 76A - CONDUIT 1
C-325	PROPOSED PLAN AND PROFILE HDD 76, 76A - CONDUIT 2
C-326	PROPOSED PLAN AND PROFILE HDD 76, 76A - CONDUIT 2
C-327	PROPOSED PLAN AND PROFILE HDD 77, CONDUIT 1
C-328	PROPOSED PLAN AND PROFILE HDD 77, CONDUIT 1
C-329	PROPOSED PLAN AND PROFILE HDD 77, CONDUIT 1
C-330	PROPOSED PLAN AND PROFILE HDD 77, CONDUIT 2
C-331	PROPOSED PLAN AND PROFILE HDD 78, CONDUIT 1
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C-333	PROPOSED PLAN AND PROFILE HDD 78, CONDUIT 2
C-334	PROPOSED PLAN AND PROFILE HDD 78, CONDUIT 2
C-335	PROPOSED PLAN AND PROFILE HDD 79B, CONDUIT 1
C-336	PROPOSED PLAN AND PROFILE HDD 79B, CONDUIT 2
C-337	PROPOSED PLAN AND PROFILE HDD 80, CONDUIT 1
C-338	PROPOSED PLAN AND PROFILE HDD 80, CONDUIT 1
C-339	PROPOSED PLAN AND PROFILE HDD 80, CONDUIT 1
C-340	PROPOSED PLAN AND PROFILE HDD 80, CONDUIT 1
C-341	PROPOSED PLAN AND PROFILE HDD 80A - CONDUIT 1
C-342	PROPOSED PLAN AND PROFILE HDD 80A - CONDUIT 1
C-343	PROPOSED PLAN AND PROFILE HDD 80A - CONDUIT 2
C-344	PROPOSED PLAN AND PROFILE HDD 80A - CONDUIT 2
C-345	PROPOSED PLAN AND PROFILE HDD 81, CONDUIT 1
C-346	PROPOSED PLAN AND PROFILE HDD 81, CONDUIT 2
C-347	PROPOSED PLAN AND PROFILE HDD 82,83 CONDUIT 1
C-348	PROPOSED PLAN AND PROFILE HDD 82,83 CONDUIT 1
C-349	PROPOSED PLAN AND PROFILE HDD 82,83 CONDUIT 2
C-350	PROPOSED PLAN AND PROFILE HDD 82,83 CONDUIT 2
C-351	PROPOSED PLAN AND PROFILE HDD 83A, CONDUIT 1
C-352	PROPOSED PLAN AND PROFILE HDD 83A, CONDUIT 2
C-353	PROPOSED PLAN AND PROFILE HDD 84, CONDUIT 1
C-354	PROPOSED PLAN AND PROFILE HDD 84, CONDUIT 2
C-355	PROPOSED PLAN AND PROFILE HDD 84A, CONDUIT 1
C-356	PROPOSED PLAN AND PROFILE HDD 84A, CONDUIT 1
C-357	PROPOSED PLAN AND PROFILE HDD 84B, CONDUIT 1
C-358	PROPOSED PLAN AND PROFILE HDD 84B, CONDUIT 1
C-359	PROPOSED PLAN AND PROFILE HDD 85, CONDUIT 1
C-360	PROPOSED PLAN AND PROFILE HDD 85, CONDUIT 1
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C-361	PROPOSED PLAN AND PROFILE HDD 85, CONDUIT 2
C-362	PROPOSED PLAN AND PROFILE HDD 85, CONDUIT 2
C-363	PROPOSED PLAN AND PROFILE HDD 87, CONDUIT 1
C-364	PROPOSED PLAN AND PROFILE HDD 87, CONDUIT 2
C-365	PROPOSED PLAN AND PROFILE HDD 87A, CONDUIT 1
C-366	PROPOSED PLAN AND PROFILE HDD 87A, CONDUIT 2
PACKAGE 5A: EROS	SION AND SEDIMENT CONTROL PLANS
C-400	E&CS KEY PLAN
C-401	STA. 50000+00.00 TO STA. 50030+00.00 PLAN
C-401 C-402	STA. 50000+00.00 TO STA. 50060+00.00 PLAN
C-403	STA. 50060+00.00 TO STA. 50090+00.00 PLAN
C-404	STA. 50090+00.00 TO STA. 50120+00.00 PLAN
C-405	STA. 50120+00.00 TO STA. 50150+00.00 PLAN
C-406	STA. 50150+00.00 TO STA. 50180+00.00 PLAN
C-407	STA. 50180+00.00 TO STA. 50210+00.00 PLAN
C-408	STA. 50210+00.00 TO STA. 50240+00.00 PLAN
C-409	STA. 50240+00.00 TO STA. 50270+00.00 PLAN
C-410	STA. 50285+00.00 TO STA. 50300+00.00 PLAN
C-411	STA. 50300+00.00 TO STA. 50330+00.00 PLAN
C-412	STA. 50330+00.00 TO STA. 50360+00.00 PLAN
C-413	STA. 50360+00.00 TO STA. 50390+00.00 PLAN
C-414	STA. 50390+00.00 TO STA. 50420+00.00 PLAN
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C-415	STA. 50420+00.00 TO STA. 50450+00.00 PLAN

DRAWING NO.	SHEET TITLE
C-417	STA. 50480+00.00 TO STA. 50510+00.00 PLAN
C-418	STA. 50510+00.00 TO STA. 50540+00.00 PLAN
C-419	STA. 50540+00.00 TO STA. 50570+00.00 PLAN
C-420	STA. 50570+00.00 TO STA. 50600+00.00 PLAN
C-421	STA. 50600+00.00 TO STA. 50630+00.00 PLAN
C-422	STA. 50630+00.00 TO STA. 50660+00.00 PLAN
C-423	STA. 50660+00.00 TO STA. 50690+00.00 PLAN
C-424	STA. 50690+00.00 TO STA. 50720+00.00 PLAN
C-425	STA. 50720+00.00 TO STA. 50750+00.00 PLAN
C-426	STA. 50750+00.00 TO STA. 50780+00.00 PLAN
C-427	STA. 50780+00.00 TO STA. 50810+00.00 PLAN
C-428	STA. 50810+00.00 TO STA. 50840+00.00 PLAN
C-429	STA. 50840+00.00 TO STA. 50870+00.00 PLAN
C-430	STA. 50870+00.00 TO STA. 50900+44.30 PLAN
PACKAGE 5A: MAIN	ITENANCE AND PROTECTION OF TRAFFIC PLANS
C-501	WORK ZONE TRAFFIC CONTROL NOTES, LEGEND AND ABBREVIATIONS
C-502	WORK ZONE TRAFFIC CONTROL
C-503	WORK ZONE TRAFFIC CONTROL
C-504	WORK ZONE TRAFFIC CONTROL
C-505	WORK ZONE TRAFFIC CONTROL
C-506	WORK ZONE TRAFFIC CONTROL PRINCETOWN ROAD DETOUR
C-507	WORK ZONE TRAFFIC CONTROL COUNTY LINE ROAD DETOUR
C-508	
C-509	WORK ZONE TRAFFIC CONTROL VOORHEESVILLE AVENUE DETOUR
C-510	WORK ZONE TRAFFIC CONTROL NEW SCOTLAND SOUTH ROAD LANE CLOSURE
C-511	WORK ZONE TRAFFIC CONTROL GAME FARM ROAD DETOUR
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C-602	EROSION AND SEDIMENT CONTROL DETAILS
C-611	WETLAND CROSSING DETAILS
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S-711	FRP LINK BOX HANDHOLES
S-750	BRIDGE NO.8 - UTILITY TRUSS BRIDGE - PLAN AND ELEVATION
S-751	BRIDGE NO.8 — UTILITY TRUSS BRIDGE — ABUTMENT ELEVATIONS AND SECTIONS
S-752	BRIDGE NO.8 - UTILITY TRUSS BRIDGE - SECTIONS AND DETAILS
S-753	BRIDGE NO.8 - UTILITY TRUSS BRIDGE - CONDUIT TRANSITION DETAIL
S-754	BRIDGE NO.8 - UTILITY TRUSS BRIDGE - SPANS 1 AND 8 - PLAN AND
	BRIDGE NO.8 - UTILITY TRUSS BRIDGE - SPANS 2, 3, 4, 5, 7 - PLAN AND
S-755	ELEVATION
S-756	BRIDGE NO.8 - UTILITY TRUSS BRIDGE - SPAN 6 PLAN AND ELEVATION
S-757	BRIDGE NO.8 - UTILITY TRUSS BRIDGE - TRUSS DETAILS
S-758	BRIDGE NO.8 - UTILITY TRUSS BRIDGE - TYPICAL WELD AND FENCE DETAILS
S-759	BRIDGE NO.8 - UTILITY TRUSS BRIDGE - TYPICAL BEARING AT PIERS
S-760	BRIDGE NO.8 - UTILITY TRUSS BRIDGE - TYPICAL BEARING AT ABUTMENTS
S-761	BRIDGE NO.8 - UTILITY TRUSS BRIDGE - BEARING REACTIONS AND CAMBER
S-771	FRP COMMUNICATION HANDHOLE
C-801	ABOVE GROUND MARKING DETAILS
C-808	TYPICAL OPEN PIT SPLICE CASING DETAILS
C-809	OPEN PIT SPLICE CASING DETAILS OPEN PIT SPLICE GROUNDING DETAILS
C-811	STEEL SUPPORT DETAILS
C-853	OPEN VAULT W/FIBER OPTIC HANDHOLE
	<u>'</u>
C-854	FIBER OPTIC HANDHOLE DETAILS
C-855	FIBER OPTIC SPLICE DIAGRAM
C-856	FIBER OPTIC SLACK ENCLOSURE DETAILS
C-901	UTILITY TYPICAL SEPARATION DETAILS





FOR EMCP REVIEW **NOT FOR CONSTRUCTION** IT IS A VIOLATION OF LAW FOR ANY PERSON, UNLESS THEY ARE ACTING UNDER THE DIRECTION OF A LICENSED PROFESSIONAL ENGINEER, ARCHITECT, LANDSCAPE ARCHITECT OR LAND SURVEYOR TO ALTER AN ITEM IN ANY WAY. IF AN ITEM BEARING THE STAMP OF A LICENSED PROFESSIONAL IS ALTERED, THE ALTERING ENGINEER, ARCHITECT, LANDSCAPE ARCHITECT OR LAND SURVEYOR SHALL STAMP THE DOCUMENT AND INCLUDE THE NOTATION "ALTERED BY" FOLLOWED BY THEIR SIGNATURE, THE DATE OF SUCH ALTERATION, AND A SPECIFIC DESCRIPTION OF THE ALTERATION.

					SE
Е	12/16/2022	FINAL SUBMISSION	BV	TK	
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No.	DATE	SUBMITTAL / REVISION DESCRIPTION	DB	APP	DR

CHAMPLAIN HUDSON POWER EXPRESS SEGMENT 8 (PACKAGE 5A) - CSX: ROTTERDAM - BETHLEHEM SHEET INDEX

KIEWIT PROJECT NO. 21162 DRAWING NO.

G-001

DRAWN BY: AR DESIGNED BY: BV APPROVED BY: TK REV. NO.

2. THE ENGINEER SHALL BE NOTIFIED IN WRITING OF ANY CONDITIONS THAT VARY FROM THOSE SHOWN ON THE PLANS. THE CONTRACTOR'S WORK SHALL NOT VARY FROM THE PLANS WITHOUT THE EXPRESSED APPROVAL OF THE ENGINEER. CHANGES TO THE PLAN SHALL BE DONE IN ACCORDANCE WITH THE EM&CP SECTION 3.2.6.

THE CONTRACTOR SHALL RESTORE LAWNS, DRIVEWAYS, CULVERTS, SIGNS AND OTHER PUBLIC OR PRIVATE PROPERTY DAMAGED OR REMOVED TO AT LEAST AS GOOD A CONDITION AS BEFORE BEING DISTURBED AS DETERMINED BY THE

4. THE CONTRACTOR AND/OR CERTIFICATE HOLDER SHALL BE RESPONSIBLE FOR OBTAINING AND INCURRING THE COST OF ALL CONSTRUCTION PERMITS, INSPECTIONS, CERTIFICATES, ETC. AND SHALL COMPLY WITH ALL REQUIRED PERMITS.

5. ALL WORK SHALL BE DONE IN STRICT COMPLIANCE WITH ALL APPLICABLE NATIONAL, STATE, AND LOCAL CODES, STANDARDS, ORDINANCES, RULES, AND REGULATIONS.

6. ALL PROPOSED UTILITIES AND APPURTENANCES TO BE CONSTRUCTED IN COMPLIANCE WITH THE LOCAL MUNICIPALITIES' CODES AND REGULATIONS GOVERNING THE INSTALLATION OF SUCH UTILITIES.

7. THE ENGINEER RESERVES THE RIGHT TO EXAMINE ANY WORK DONE ON THIS PROJECT AT ANY TIME TO DETERMINE THE CONFORMANCE WITH THE REQUIREMENTS OF THE CONTRACT DOCUMENTS OF THIS PROJECT.

8. THE CONTRACTOR SHALL PROTECT EXISTING PROPERTY LINE MONUMENTATION. ANY MONUMENTATION DISTURBED OR DESTROYED, AS JUDGED BY THE ENGINEER OR OWNER, SHALL BE REPLACED AT THE CONTRACTOR'S EXPENSE UNDER THE SUPERVISION OF A NEW YORK STATE LICENSED LAND SURVEYOR.

9. IT IS THE CONTRACTOR'S RESPONSIBILITY TO EXAMINE ALL PLAN SHEETS.

10. THE CONTRACTOR SHALL:

A. VERIFY ALL CONDITIONS IN THE FIELD PRIOR TO COMMENCEMENT OF WORK AND NOTIFY THE ENGINEER OF ANY

EXAMINE THE SITE AND INCLUDE IN HIS WORK THE EFFECT OF ALL EXISTING CONDITIONS ON THE WORK.

PROVIDE AND INSTALL ALL MATERIALS AND PERFORM ALL WORK IN ACCORDANCE WITH RECOGNIZED GOOD STANDARD PRACTICE.

11. ALL TRENCH EXCAVATION AND ANY REQUIRED SHEETING AND SHORING SHALL BE DONE IN ACCORDANCE WITH THE LATEST REVISIONS OF NEW YORK STATE INDUSTRIAL CODE RULE 23 AND OSHA REGULATIONS FOR CONSTRUCTION. SHEET PILING SHALL BE DESIGNED AND SEALED BY A NEW YORK STATE PROFESSIONAL ENGINEER. WHERE WITHIN RAIL ROAD ROW, ANY EXCAVATION AND SHORING SHALL BE DESIGNED TO MINIMUM CSX AND AREMA REQUIREMENTS.

12. CONTRACTOR SHALL BE RESPONSIBLE FOR DEWATERING AND THE MAINTENANCE OF SURFACE DRAINAGE DURING THE COURSE OF WORK IN CONFORMANCE WITH REFERENCE SECTION 4.4.6 DEWATERING METHODS IN THE EM&CP. CONTRACTOR SHALL MAINTAIN EXISTING SITE DRAINAGE PATTERNS THROUGHOUT CONSTRUCTION UNLESS OTHERWISE SHOWN ON THE

13. MAINTAIN FLOW FOR ALL EXISTING UTILITIES.

14. ALL FRAMES/COVERS WITHIN PAVED AREAS SHALL HAVE THE TOPS SET FLUSH WITH THE EXISTING PAVEMENT GRADE. IN LANDSCAPED AREAS, ALL FRAMES SHALL BE 0.1' ABOVE GRADE.

15. TEMPORARY PAVEMENT SHALL BE PLACED WITHIN 48 HOURS OF COMPLETION OF BACKFILL OPERATIONS WITHIN THE EXISTING PAVEMENT LIMITS.

16. CONTRACTOR SHALL MAINTAIN ALL TRAFFIC IN ALL AREAS IN ACCORDANCE WITH THE NYSDOT MANUAL OF UNIFORM TRAFFIC CONTROL DEVICES.

17. ALL EXCAVATIONS SHALL BE PROTECTED AT THE END OF EACH WORK DAY PER OSHA AND NYSDOT REQUIREMENTS.

18. WITHIN NYSDOT ROW ALL OPEN EXCAVATIONS TO BE PROTECTED BY CONCRETE BARRIERS OR BE COVERED BY A STEEL PLATE, 3/4" THICK MINIMUM. A SINGLE PLATE SHOULD COVER THE ENTIRE EXCAVATION AND HAVE ENOUGH BEARING ON SURROUNDING SURFACES TO SUPPORT A VEHICLE.

19. CONTRACTOR SHALL TAKE CARE TO PREVENT DAMAGE TO EXISTING UTILITIES. UTILITIES DAMAGED BY CONTRACTOR SHALL BE IMMEDIATELY REPAIRED BY CONTRACTOR AT THE CONTRACTOR'S EXPENSE. IF DURING EXCAVATION PREVIOUSLY DAMAGED UTILITIES ARE UNCOVERED, CONTRACTOR SHALL DOCUMENT THE DAMAGE AND REPORT DAMAGE TO THE APPROPRIATE OWNER.

20. DEPTH OF BURY FOR EXISTING CABLED UTILITIES FIBER / ELECTRICAL / TELECOM AND WATERLINES UNKNOWN. ASSUMED DEPTH OF BURY FOR CABLED UTILITIES IS 30" UNLESS OTHERWISE SHOWN. ASSUMED DEPTH OF BURY FOR WATERLINES IS 5' UNLESS OTHERWISE SHOWN.

21. CONTRACTOR TO COORDINATE ALL DRIVEWAY CROSSINGS WITH THE PROPERTY OWNERS PRIOR TO EXCAVATING. ACCESS TO ALL DRIVEWAYS FOR THE RESIDENTS AND COMMERCIAL PROSPERITIES, WILL NEED TO BE MAINTAINED DURING THE PROJECT. ALL EXCAVATIONS IN THE ENTRANCES/DRIVEWAYS WILL NEED TO BE BACKFILLED AT THE END OF EACH WORKDAY, OR STEEL PLATES SHALL BE INSTALLED TO ALLOW ACCESS DURING CONSTRUCTION. REFER TO THE EM&CP FOR EMERGENCY ACCESS MANAGEMENT PLAN.

22. ALL WORK WITHIN AGRICULTURAL LANDS WILL BE PERFORMED IN COMPLIANCE WITH APPLICABLE NEW YORK STATE DEPARTMENT OF AGRICULTURE AND MARKETS (NYSDAM) GUIDANCE INCLUDING "NYSDAM GUIDELINES FOR CONSTRUCTION MITIGATIONS FOR AGRICULTURAL LANDS IN AGRICULTURAL AREAS". RESTORATION WORK WILL FOLLOW APPLICABLE SECTIONS OF NYSDAM GUIDANCE "FERTILIZING LIME, AND SEEDING RECOMMENDATIONS FOR RESTORATION OF CONSTRUCTION PROJECTS ON FARMLAND IN NYS".

23. SERVICE CONNECTIONS TO BE FIELD LOCATED PRIOR TO CONSTRUCTION.

EROSION CONTROL NOTES

1. SEE C-400 SERIES OF SHEETS FOR EROSION AND SEDIMENT CONTROL SHEETS.

2. LAND DISTURBING ACTIVITIES SHALL NOT COMMENCE UNTIL APPROVAL TO DO SO HAS BEEN RECEIVED BY GOVERNING AUTHORITIES.

3. THE GENERAL CONTRACTOR SHALL STRICTLY ADHERE TO THE STORM WATER POLLUTION PREVENTION PLAN (SWPPP) AND FOLLOW THE EM&CP DOCUMENTS DURING CONSTRUCTION OPERATIONS.

4. NO LAND CLEARING OR GRADING SHALL BEGIN UNTIL ALL PERIMETER EROSION AND SEDIMENT CONTROL MEASURES HAVE BEEN INSTALLED. (WETLAND PROTECTION FENCE. SILT FENCE AND STABILIZED CONSTRUCTION ENTRANCE)

5. SITE DISTURBANCE SHALL NOT EXCEED FIVE (5) ACRES OF SOIL AT ANY ONE TIME WITHOUT PRIOR WRITTEN AUTHORIZATION FROM NYSDEC DIVISION OF WATER.

6. ALL EXPOSED AREAS SHALL BE SEEDED AND MULCHED AS SPECIFIED WITHIN 14 DAYS OF FINAL GRADING. "FOR DISTURBED WETLAND AND SENSITIVE AREAS, AREA TO BE RESTORED IN ACCORDANCE WITH THE EM&CP"

INACTIVE PORTIONS OF THE SITE ARE TO BE SEEDED AND MULCHED AS SPECIFIED WITHIN 14 DAYS. "FOR DISTURBED WETLAND AND SENSITIVE AREAS, AREA TO BE RESTORED IN ACCORDANCE WITH THE EM&CP"

8. SEDIMENT AND EROSION CONTROL MEASURES SHALL BE INSPECTED AT LEAST ONCE EVERY SEVEN (7) DAYS OR MORE FREQUENTLY IF REQUIRED. ALL MAINTENANCE REQUIRED BY INSPECTION SHALL COMMENCE WITHIN 24 HOURS AND BE COMPLETED WITHIN 48 HOURS OF REPORT.

9. THIS PLAN SHALL NOT BE CONSIDERED ALL INCLUSIVE AS THE GENERAL CONTRACTOR SHALL TAKE ALL NECESSARY PRECAUTIONS TO PREVENT SOIL SEDIMENT FROM LEAVING THE SITE.

10. GENERAL CONTRACTOR SHALL COMPLY WITH ALL STATE AND LOCAL ORDINANCES THAT APPLY.

11. ADDITIONAL EROSION AND SEDIMENT CONTROL MEASURES WILL BE INSTALLED IF DEEMED NECESSARY FOLLOWING SITE INSPECTION. THE SWPPP AND/OR ENVIRONMENTAL INSPECTOR HAS THE AUTHORITY TO REQUIRE ADDITIONAL EROSION CONTROL MEASURES IF THE INSPECTOR DEEMS NECESSARY.

12. GENERAL CONTRACTOR SHALL BE RESPONSIBLE TO TAKE WHATEVER MEANS NECESSARY TO ESTABLISH PERMANENT SOIL STABILIZATION.

13. AT THE END OF EACH WORK DAY DISTURBED SOILS ARE TO BE REGRADED TO DRAIN INTO THE TEMPORARY DIVERSION SWALES AND DISCHARGES FROM DEWATERING ACTIVITIES ARE TO BE DIRECTED INTO CATCH BASINS OR SWALES.

14. CONCRETE WASHOUTS DEPICTED ON PLANS ARE FOR REFERENCE ONLY. CONTRACTOR TO FIELD LOCATE WASHOUTS AS NECESSARY. FIELD LOCATED WASHOUTS SHALL BE LOCATED CONSTRUCTED IN ACCORDANCE WITH THE EM&CP AND SHALL BE A MINIMUM OF 100' FROM ADJACENT WETLANDS AND 200' FROM ANY EXISTING

HDD PLAN & PROFILE NOTES

1. ALL BURIED LINE DEPTHS ARE APPROXIMATE PRIOR TO ANY EXCAVATION OR EXPLORATORY BORING, CONTRACTOR MUST CONTACT 811 AND ABIDE BY ALL STATE EXCAVATION REQUIREMENTS.

2. THE MINIMUM SEPARATION DISTANCE FROM EXISTING SUBSURFACE UTILITIES SHALL NOT BE LESS THAN 120 INCHES AS MEASURED FROM THE OUTSIDE EDGE OF THE UTILITY TO THE OUTSIDE OF THE PROPOSED HDD.

3. ALL COORDINATES ARE IN NEW YORK STATE PLANE, NAD83, EAST ZONE, US FOOT.

CIVIL NOTES

1. WORKING IN WETLANDS: IN GENERAL, STOCKPILING SOILS AND GRADING SOILS FOR ANY ROADS, WORK AREAS, OR PADS IS PROHIBITED WITHIN WETLAND AREAS. TIMBER MATTING SHALL BE LAYERED (STACKED) TO ACHIEVE REQUIRED ELEVATIONS. THE CONTOURS SHOWN WITHIN WETLAND AREAS IN THESE PLANS ARE INTENDED TO DEPICT THE ELEVATION DIFFERENCE BETWEEN EXISTING AND PROPOSED ELEVATIONS ONLY AND ARE NOT INTENDED TO REPRESENT GRADING SOILS OR EARTHWORK ACTIVITIES. FOR SPECIFIC REQUIREMENTS FOR WORKING IN WETLAND AREAS INCLUDING REQUIREMENTS FOR EXCAVATION AND STOCKPILING, REFER TO EM&CP SECTION 4.10.2.

2. THE CIVIL ENGINEER OF RECORD (EOR) LICENSED PROFESSIONAL ENGINEER SEAL AND SIGNATURE ON THE PLAN AND PROFILE KEY MAP SHEET, SPLICE LOCATION TABLE SHEET, PLAN AND PROFILE SHEETS, TEMP OFF-SITE ACCESS ROADS SHEETS, TEMP OFF-SITE ACCESS ROUTES SHEETS, LAYDOWN YARDS SHEET, AND TYPICAL SECTIONS SHEETS IS LIMITED TO THE SCOPE OF DESIGN AS OUTLINED BELOW:

A. THE CIVIL EOR DESIGN SCOPE INCLUDES THE FOLLOWING:

a. HORIZONTAL AND VERTICAL GEOMETRY OF THE TRENCH AND CONDUITS

b. GEOMETRIC DESIGN OF TEMPORARY ROADS AND WORK AREAS

1. THESE PLANS DEPICT THE GENERAL LAYOUT AND GRADING EXTENTS OF THE ROADS AND WORK AREAS. GEOMETRIC INFORMATION FOR TEMPORARY ROADS IS NOT SHOWN IN THESE PLANS AND WILL BE AVAILABLE UPON REQUEST IN EXCEL OR CIVIL 3D 2020 DIGITAL FORMAT.

B. THE ELECTRICAL EOR IS RESPONSIBLE FOR THE FOLLOWING DESIGN SCOPE:

a. DESIGN ASSOCIATED WITH THE ELECTRICAL TRANSMISSION LINE AND APPURTENANCES INCLUDING BUT NOT LIMITED TO PUBLIC SAFETY CONSIDERATIONS; MATERIAL SELECTION; INSTALLATION; AND INTERFERENCE, THERMAL, AND STRAY CURRENT EFFECTS.

b. DESIGN OF THE TRENCH FOR THE CONDUIT, HVDC (HIGH VOLTAGE DIRECT CURRENT) CABLE, AND FIBER OPTIC CABLE INSTALLATION

c. MATERIAL SELECTION AND SIZING OF THE CONDUITS AND HVDC CABLE

d. CABLE INSTALLATION (PULLING) CALCULATIONS FOR INSTALLATION OF CABLES INCLUDING CABLE PULLING DIRECTION

C. THE HDD (HORIZONTAL DIRECTION DRILLING) EOR IS RESPONSIBLE FOR THE FOLLOWING DESIGN SCOPE:

a. HDD HORIZONTAL AND VERTICAL GEOMETRY

b. HDD PLAN AND PROFILE SHEETS

c. DESIGN OF THE WORK AREAS AND PITS FOR HDD INSTALLATION

D. THE CIVIL EOR DESIGN SCOPE EXCLUDES HYDROLOGIC OR HYDRAULIC DRAINAGE ANALYSIS OR DESIGN INCLUDING STREAM AND DITCH CROSSINGS.

3. IT IS THE RESPONSIBILITY OF THE CONTRACTOR TO IMPLEMENT SAFETY MEASURES AND/OR AN OPERATIONAL SAFETY PLAN DURING CONSTRUCTION TO PROTECT PERSONNEL AND VEHICLES FROM STEEP SLOPES OR HAZARDS ADJACENT TO ROADS AND WORK AREAS. THIS DESIGN PROVIDES TEMPORARY ACCESS AND WORK AREAS FOR CONSTRUCTION OPERATIONS FOR LOW-SPEED CONSTRUCTION TRAFFIC WITHIN A SITE THAT IS RESTRICTED FROM PUBLIC ACCESS.

A. THESE PLANS DO NOT INCLUDE COMPREHENSIVE ROADSIDE SAFETY MEASURES OR HARDWARE, INCLUDING BUT NOT LIMITED TO: BARRIERS, GUARDRAIL, SIGNING, GATES, DELINEATORS, AND SAFETY BERMS.

B. ACCESS ROADS ARE DESIGNED FOR A DESIGN SPEED OF 15 MPH FOR CRUSHED ROCK SURFACING (GRAVEL/AGGREGATE SURFACING). IT WILL BE THE CONTRACTOR'S RESPONSIBILITY TO ENSURE VEHICLES ARE ADEQUATELY EQUIPPED FOR ROAD CONDITIONS, AND ROADS ARE ADEQUATELY MAINTAINED FOR

C. IT IS THE CONTRACTOR'S RESPONSIBILITY TO DETERMINE THE STABILITY OF AND/OR SETBACKS FROM STEEP SLOPES, SHORING, AND WALLS ADJACENT TO VEHICULAR TRAFFIC OR NEAR PLACEMENT OF CONSTRUCTION EQUIPMENT (OR MATERIALS) AS DETERMINED BY A GEOTECHNICAL ENGINEER.

4. IT IS THE RESPONSIBILITY OF THE CONTRACTOR TO VERIFY EXISTING STRUCTURES ARE ADEQUATE TO SAFELY SUPPORT VEHICLES AND CONSTRUCTION EQUIPMENT (OR MATERIALS) AS DETERMINED BY A STRUCTURAL AND/OR GEOTECHNICAL ENGINEER.

DISTURBANCE NOTE:

1. THE PROPOSED DISTURBANCE FOR THE TRENCH DETAIL WILL BE LIMITED TO THE WIDTH OF THE TRENCH SECTIONS DEPICTED ON C-621.

2. AREAS OF THE LIMIT OF WORK ACROSS THE ALIGNMENT HAVE BEEN EXPANDED TO INCLUDE AREAS OFF THE ROADWAY WITHIN LAWN AREAS THAT ARE SUITABLE FOR POTENTIAL TEMPORARY STAGING AREAS DURING CONSTRUCTION. SHOULD THESE AREAS BE UTILIZED AND DISTURBED THE AREAS SHOULD BE RESTORED TO EXISTING CONDITION PER THE PROJECT RESTORATION NOTES AND DETAILS. EROSION AND SEDIMENT CONTROL MEASURES HAVE BEEN DEVELOPED TO INCORPORATE THESE POTENTIALLY DISTURBED AREAS.









FOR EMCP REVIEW NOT FOR CONSTRUCTION

T IS A VIOLATION OF LAW FOR ANY PERSON LINLESS THEY ARE ACTING UNDER THE DIRECTION OF A LICENSED DFESSIONAL ENGINEER, ARCHITECT, LANDSCAPE ARCHITECT R LAND SURVEYOR TO ALTER AN ITEM IN ANY WAY. IF AN EM BEARING THE STAMP OF A LICENSED PROFESSIONAL IS LTERED. THE ALTERING ENGINEER, ARCHITECT, LANDSCAPE RCHITECT OR LAND SURVEYOR SHALL STAMP THE DOCUMENT AND INCLUDE THE NOTATION "ALTERED BY" FOLLOWED BY THEIR SIGNATURE, THE DATE OF SUCH ALTERATION, AND A SPECIFIC DESCRIPTION OF THE ALTERATION.

CHAMPLAIN HUDSON POWER EXPRESS BV TK E | 12/16/2022 | FINAL SUBMISSION 11/11/2022 DRAFT FINAL SUBMISSION BV TK 06/06/2022 | 60% DESIGN SUBMISSION BV TK 02/11/2022 PRELIMINARY DESIGN DEVELOPMENT BV TK BV TK 01/24/2022 PRELIMINARY PROGRESS DATE SUBMITTAL / REVISION DESCRIPTION DB | APP | DRAWN BY: AR | DESIGNED BY: BV | APPROVED BY: TK | REV. NO.

SEGMENT 8 (PACKAGE 5A) - CSX: ROTTERDAM - BETHLEHEM GENERAL NOTES 1 OF 2

KIEWIT PROJECT NO. 21162

DRAWING NO.

G-002

AS SHOWN DATI E SH.NO.

CLEANUP STANDARDS AND PRACTICES

FROM THE BMPS', CLEAN-UP, RESTORATION, AND REVEGETATION PROCEDURES WILL BE ONGOING DURING CONSTRUCTION AS EACH SEGMENT IS COMPLETED. DURING CONSTRUCTION, ROAD AND CONSTRUCTION ROWS WILL BE KEPT FREE OF DEBRIS AND DISCARDED MATERIAL TO THE GREATEST EXTENT POSSIBLE. AS CONSTRUCTION CONTINUES, EACH SECTION OF THE ROWS WILL BE THOROUGHLY CLEANED AFTER CONSTRUCTION IS COMPLETED ON THAT PARTICULAR SECTION. ALL FABRICATED DEBRIS RESULTING FROM CONSTRUCTION WILL BE DISPOSED OF AT AN APPROVED DISPOSAL SITE IN COMPLIANCE WITH ALL APPROPRIATE ENVIRONMENTAL REGULATIONS. FABRICATED DEBRIS GENERATED DURING CONSTRUCTION INCLUDES PIPING, FENCING, WIRING, AND ANY OTHER MATERIALS USED DURING CONSTRUCTION. NO FABRICATED DEBRIS BE BURNED OR BURIED. ALL TRUCKS LEAVING THE CONSTRUCTION AREA WILL BE LOADED AND COVERED IN ACCORDANCE WITH APPLICABLE REGULATIONS AS NEEDED AS DESCRIBED IN THE SOIL AND MATERIALS MANAGEMENT PLAN OF THE EM&CP IN APPENDIX L

RESTORATION AND PLANTING

THE FINAL STAGE OF CONSTRUCTION WILL CONSIST OF RESTORING THE ROAD AND CONSTRUCTION ROWS AND THIS SEGMENT TO ITS ORIGINAL CONDITION AND CHARACTER AS MUCH AS POSSIBLE/IS PRACTICAL, UNLESS DOING SO WOULD INTERFERE WITH THE SAFE OR RELIABLE OPERATION AND MAINTENANCE OF THE PROJECT. RESTORATION ACTIVITIES MAY VARY WITH THE SPECIFIC AREA TO BE RESTORED BUT WILL CONSIST PREDOMINANTLY OF RESTORING TOPOGRAPHY TO ORIGINAL GRADIENTS AND RESEEDING EXCAVATED AREAS OVER THE TRENCH AS IDENTIFIED HEREIN.

SITE PREPARATION FOR REVEGETATION

THE SURFACE OF THE ROAD AND CONSTRUCTION ROWS DISTURBED BY CONSTRUCTION ACTIVITIES WILL BE GRADED TO MATCH THE ORIGINAL TOPOGRAPHIC CONTOURS AND TO BE COMPATIBLE WITH SURROUNDING DRAINAGE PATTERNS WHERE APPROPRIATE. IT SHOULD BE NOTED THAT SUBCONTRACTORS WILL TYPICALLY LIMIT GRUBBING (THE REMOVAL OF STUMPS AND ROOTS) TO THE FOOTPRINT OF THE EXCAVATED TRENCH AND ACCESS ROADS TO ALLOW RE-SPROUTING AND ASSIST IN THE RECOVERY OF WOODY SPECIES, EXCEPT WHERE REMOVAL IS REQUIRED FOR SAFE CONSTRUCTION. WHERE NEEDED, IT MAY BE NECESSARY TO IMPORT TOPSOIL TO RETURN AN AREA TO GRADE. IMPORTED TOPSOIL WILL FOLLOW CLASSIFICATION AND CHARACTERIZATION MEASURES OUTLINED IN THE SOIL AND MATERIALS MANAGEMENT PLAN IN APPENDIX L. HDD ENTRY AND EXIT PITS WILL BE BACKFILLED AND THE DISTURBED GROUND SURFACE WILL BE SIMILARLY GRADED. TRENCHES WILL BE BACKFILLED IN ACCORDANCE WITH THE MEASURES OUTLINED IN SECTION 4.4.7 OF THE EM&CP. THE CERTIFICATE HOLDER WILL BE RESPONSIBLE FOR WILL CHECKING ALL CULVERTS AND ASSURE THAT THEY ARE NOT CRUSHED OR BLOCKED DURING CONSTRUCTION AND RESTORATION OF THIS SEGMENT AND, IF A CULVERT IS BLOCKED OR CRUSHED, TAKE IMMEDIATE STEPS TO REPLACE OR REPAIR THE CULVERT IN ACCORDANCE WITH APPLICABLE STATE OR LOCAL STANDARDS.

SEEDING AND PLANTING

SEEDING OPERATIONS ACROSS THE 35-FOOT-WIDE CONSTRUCTION AND FACILITY ROWS AS WELL AS WITHIN STAGING AND LAYDOWN AREAS WILL COMMENCE ONLY AFTER AN ACCEPTABLE SEEDBED HAS BEEN ESTABLISHED, AS DESCRIBED ABOVE. . SEED WILL BE APPLIED BY HAND, OR VIA HYDRO-SEEDERS. THE ENTIRE SEEDED AREA WILL BE WATERED WITH A FINE SPRAY, AS NECESSARY, UNTIL A UNIFORM MOISTURE DEPTH OF APPROXIMATELY ONE (1) INCH HAS BEEN ACHIEVED AS APPLICABLE. MULCHING AND ANCHORING OF THE MULCH MAY BE NECESSARY IN SOME AREAS UNLESS A HYDROMULCH/SEED SLURRY IS USED. ON STEEP SLOPES, JUTE NET WILL BE USED TO PROVIDE STABILIZATION. FERTILIZER WILL BE ADDED, AS APPLICABLE, AT THE APPROPRIATE RATES AFTER SEED IS APPLIED AND/OR TO A HYDROMULCH/SEED SLURRY. NO FERTILIZER WILL BE APPLIED IN WETLAND RESOURCE AREAS. SEEDING/MULCHING WILL TAKE PLACE UNDER THE SUPERVISION OF THE ENVIRONMENTAL INSPECTOR. THE SEED MIXTURE AND RATE OF APPLICATION WILL DEPEND ON THE SOIL TYPE, LAND USE, AVAILABLE MOISTURE, AND SEASON AT THE TIME OF APPLICATION. THE LOCAL SOIL AND WATER CONSERVATION DISTRICT AND THE LANDOWNER/OPERATOR WILL BE CONSULTED REGARDING APPROPRIATE SEED MIXTURES AND APPLICATION RATES. ALL SEED MIXES WILL BE FREE OF INVASIVE SPECIES. ALL SEED BAG TAGS (EITHER ORIGINAL OR SCANNED COPIES) WILL BE PROVIDED TO THE ENVIRONMENTAL INSPECTOR EITHER ORIGINAL TAGS OR SCANNED COPIES. SEEDED AREAS WILL BE MONITORED FOLLOWING RESTORATION UNTIL A MINIMUM VEGETATIVE COVER OF EIGHTY (80) PERCENT IS ACHIEVED. THE SEED MIXTURES WILL FOLLOW THE TECHNICAL SPECIFICATIONS INCLUDED ON THE PLAN AND PROFILE DRAWINGS IN APPENDIX C (SHEET G-020 OF BOTH SEGMENT 1 AND SEGMENT 2) FOR UPLANDS AND WETLAND BUFFER ZONES. FOR WETLAND RESOURCE AREAS, EMERGENT COMMUNITIES SHOULD BE REVEGETATED WITH AN ERNST FACW WETLAND MEADOW MIX (ERNMX-122) OR EQUIVALENT, AND FOR SHADED SITES WITHIN FORESTED/SHRUB-SHRUB WETLAND COMMUNITIES, DISTURBED AREAS SHOULD BE REVEGETATED WITH ERNST SPECIALIZED WETLAND MIX FOR SHADED AREAS (ERNMX-137) OR EQUIVALENT.

THE MAJORITY OF SOIL DISTURBANCE FOR THIS SEGMENT WILL BE WITHIN THE TRENCH-LINE FOR THE CONDUIT/CABLE. HOWEVER, SOME DISTURBANCE WILL ALSO OCCUR DURING INSTALLATION AND REMOVAL OF TEMPORARY ACCESS ROADS AS DESCRIBE IN SECTION 4.10 OF THE EM&CP. ALL TRENCH AREAS AND OTHER EXCAVATED AREAS WILL BE RESEEDED WITH AN APPROPRIATE SEED MIX AS IDENTIFIED ABOVE. VEGETATION THROUGHOUT THE CONSTRUCTION ROW WILL BE CUT TO GROUND LEVEL AND ROOT SYSTEMS WILL REMAIN INTACT TO ALLOW FOR RESPROUTING FOLLOWING CONSTRUCTION, UNLESS RESPROUTING WOULD INTERFERE WITH THE SAFE AND RELIABLE OPERATION OF THE PROJECT.

MINIMAL TREE CLEARING IS ANTICIPATED TO BE REQUIRED IN THIS SEGMENT (SEE SECTION 8.0 OF THE EM&CP); IF REQUIRED, ALL TREES OVER TWO (2) INCHES IN DBH OR SHRUBS OVER FOUR (4) FEET IN HEIGHT THAT ARE DAMAGED OR DESTROYED BY ACTIVITIES DURING CONSTRUCTION, OPERATION, OR MAINTENANCE WITHIN ASSOCIATED URBAN, RESIDENTIAL OR ADIRONDACK PARK LANDSCAPED AREAS, WILL BE REPLACED WITHIN THE FOLLOWING YEAR BY THE CERTIFICATE HOLDERS WITH THE EQUIVALENT TYPE OF TREES OR SHRUBS EXCEPT IF:

- a)EQUIVALENT TYPE REPLACEMENT TREES OR SHRUBS WOULD INTERFERE WITH THE PROPER CLEARING, CONSTRUCTION, OPERATION, OR MAINTENANCE OF THE PROJECT OR WOULD BE INCONSISTENT WITH STATE-INVASIVE SPECIES POLICY; OR
- b)REPLACEMENT WOULD BE CONTRARY TO SOUND ROW MANAGEMENT PRACTICES, OR TO ANY APPROVED LONG-RANGE ROW MANAGEMENT PLAN APPLICABLE TO THE FACILITY OR ADJOINING ROW; OR
- c)THE OWNER OF LAND WHERE THE DAMAGED OR DESTROYED TREES OR SHRUBS WERE LOCATED (OR OTHER RECORDED EASEMENT OR LICENSE HOLDERS WITH THE RIGHT TO CONTROL REPLACEMENT) DECLINES REPLACEMENT.

RESTORATION OF WATERBODIES

DIRECT IMPACTS TO STREAMS AND WATERBODIES ASSOCIATED WITH THIS SEGMENT HAVE BEEN AVOIDED BY CROSSING OVER OR UNDER EXISTING CULVERTS, AND INCORPORATING HDD METHODS. HOWEVER, IF IMPACTS TO WATERBODIES DO OCCUR, THE PROCEDURES FOR THE CLEANUP AND RESTORATION OF STREAMS AND WATERBODIES ARE SUMMARIZED IN SECTION 9.1 OF THE EM&CP

RESTORATION OF WETLANDS

THESE AREAS WILL BE RESTORED AS CLOSE AS PRACTICABLE TO PRE-CONSTRUCTION CONDITIONS AND CONTOURS. ALL TEMPORARY FENCING AND EROSION CONTROLS WILL BE REMOVED AND DISPOSED OF IN AN ACCEPTABLE MANNER AT A STATE APPROVED DISPOSAL FACILITY APPROVED BY DPS STAFF AND THE CERTIFICATE HOLDER. ALL MOTORIZED CONSTRUCTION EQUIPMENT WILL BE TRANSPORTED TO OFF—SITE FACILITIES. ALL WETLAND MATS AND MATERIALS WILL BE COLLECTED, PACKED, AND TRANSPORTED TO OFF-SITE STORAGE FACILITY OR TO THE NEXT SEGMENT'S STAGING AREAS NEEDED.

RESTORATION OF CONSTRUCTION MATERIALS AND EQUIPMENT STAGING LOCATIONS AND TEMPORARY ACCESS ROADS

THE CONSTRUCTION MATERIALS EQUIPMENT STAGING LOCATIONS FOR THIS SEGMENT ARE SUMMARIZED IN SECTION 5.4 TABLE 5.2 OF THE EM&CP AND ARE SHOWN IN THE PLAN AND PROFILE DRAWINGS AND ESCP. THESE AREAS WILL BE RESTORED AS CLOSE AS PRACTICABLE TO PRE-CONSTRUCTION CONDITIONS AND CONTOURS TO THE EXTENT PRACTICABLE.

ALL TEMPORARY FENCING AND EROSION CONTROLS WILL BE REMOVED AND DISPOSED OF IN AN ACCEPTABLE MANNER AT A STATE-APPROVED DISPOSAL FACILITY APPROVED BY DPS STAFF AND THE CERTIFICATE HOLDERS. ALL MOTORIZED CONSTRUCTION EQUIPMENT WILL BE TRANSPORTED TO OFF-SITE FACILITIES. ALL OTHER USABLE CONSTRUCTION EQUIPMENT AND MATERIALS WILL BE COLLECTED, PACKED, AND TRANSPORTED TO OFF-SITE STORAGE FACILITIES OR TO THE NEXT SEGMENT'S STAGING AREA AS NEEDED. ALL UNUSABLE EQUIPMENT AND MATERIALS WILL BE REMOVED FROM THE LAYDOWN YARD AND DISPOSED OF APPROPRIATELY.

PLANT INSPECTION, GUARANTEE AND MAINTENANCE

VEGETATION RESTORATION ALSO INCLUDES THE MAINTENANCE OF PLANTINGS FOR SPECIFIED TIME PERIODS AND THE REPLACEMENT OF UNSUCCESSFUL PLANTINGS. PRIOR TO PLANTING, THE ENVIRONMENTAL INSPECTOR WILL INSPECT ALL PLANTS IN CONTAINERS. PLANTINGS WILL BE PERFORMED BY A QUALIFIED LANDSCAPE OR NURSERY CONTRACTOR. THE ENVIRONMENTAL INSPECTOR WILL ALSO INSPECT ALL PLANTS AFTER COMPETITION OF PLANTING TO ENSURE PROPER PLANTING PROCEDURES AND THE CORRECT PLANT SPECIES WERE USED. ADDITIONALLY, THE ENVIRONMENTAL INSPECTOR WILL CONDUCT A FINAL INSPECTION OF ALL REVEGETATED AREAS AFTER THE END OF THE MONITORING PERIOD TO ENSURE FINAL STABILIZATION. ALL VEGETATION REPLACED WILL HAVE A MINIMUM TWO (2) YEAR SURVIVAL GUARANTEE. AS DESCRIBED IN THE BMP DOCUMENT, WHERE TREE OR SHRUB PLANTINGS ARE NEEDED, A POST CONSTRUCTION SURVIVAL SURVEY WILL BE PERFORMED ONE YEAR AFTER THE PLANTINGS. IF ANY TREE OR SHRUB HAS NOT SURVIVED OR IS IN POOR HEALTH, THE TREE/SHRUB WILL BE REPLACED.

SWPPP INSPECTIONS WILL BE PERFORMED BY THE ENVIRONMENTAL INSPECTOR ON A WEEKLY BASIS UNTIL ALL DISTURBED AREAS HAVE ACHIEVED 80% REVEGETATION AND HAVE ACHIEVED FINAL STABILIZATION. FOLLOWING FINAL RESTORATION, EROSION AND SEDIMENT CONTROL MEASURES WILL BE REMOVED FROM THE SITE AND DISPOSED OF APPROPRIATELY.

RESTORATION WITHIN NYSDOT ROW

ALL RESTORATION WITHIN THE NYSDOT ROW SHALL BE DONE IN ACCORDANCE WITH THE LATEST VERSION OF THE NYSDOT STANDARD SPECIFICATIONS AND STANDARD SHEETS.

RESTORATION OF RECREATIONAL AREAS

FOLLOWING CONSTRUCTION, THE CERTIFICATE HOLDERS WILL RESEED THE CONSTRUCTION AREA WITHIN RECREATIONAL AREAS USING THE PROCEDURES AND METHODS SPECIFIED IN THE SECTIONS ABOVE WHERE NEEDED. IF NECESSARY, ADDITIONAL REVEGETATION AND TREE PLANTING MAY BE PERFORMED DEPENDING ON THE IMPACT OF CONSTRUCTION.

ROADWAY RESTORATION (STRIPPING, SIGNAGE, AUDIBLE ROADWAY

<u>DELINEATORS)</u>

STRIPPING IMPACTED OR REMOVED FROM CONSTRUCTION WITHIN THE LIMITS OF WORK, INCLUDING AREAS OF MILL AND OVERLAYS TO BE INSTALLED PER EXISTING STRIPPING PATTERNS. CONTRACTOR SHALL INVENTORY ALL STRIPPING PRIOR TO WORK. WORK TO BE COMPLETED IN ACCORDANCE WITH NYSDOT STANDARD SHEETS AND SPECIFICATIONS (SEE 685 SERIES STANDARD SHEETS).

SIGNAGE IMPACTGED DAMAGED OR REMOVED DURING CONSTRUCTION SHALL BE REPLACED IN KIND OR REINSTALLED IN ACCORDANCE WITH NYSDOT STANDARD SHEETS AND SPECIFICATIONS (SEE 645 SERIES STANDARD SHEETS)

AUDILBE ROADWAY DELINEATORS DAMAGED OR REMOVED DUE TO CONSTRUCTION SHALL BE INSTALLED DURING RE-PAVING OPERATIONS IN ACCORDANCE WITH NYSDOT STANDARD SHEET 649-03

RESTORATION OF ROADWAY

THESE AREAS WILL BE RESTORED AS CLOSE AS PRACTICABLE TO PRE-CONSTRUCTION CONDITIONS AND CONTOURS. TRENCHES WILL BE BACKFILLED PER THE APPROPRIATE DETAIL, FULL WIDTH OF THE TRENCH WILL BE RESTORED TO MATCH THE EXISTING PAVEMENT SECTION, THE FULL WIDTH OF THE TRAVEL LANE TO THE CENTERLINE WILL BE MILLED AND OVERLAYED WITH A TOP COURSE OF ASPHALT. ALL TEMPORARY FENCING AND EROSION CONTROLS WILL BE REMOVED AND DISPOSED ON IN AN ACCEPTABLE MANNER AT A STATE-APPROVED DISPOSAL FACILITY APPROVED BY DPS STAFF AND THE CERTIFICATE HOLDERS.

RESTORATION OF ROADWAY SHOULDER

THESE AREAS WILL BE RESTORED AS CLOSE AS PRACTICABLE TO PRE-CONSTRUCTION CONDITIONS AND CONTOURS. TRENCHES WILL BE BACKFILLED PER THE APPROPRIATE DETAIL, FULL WIDTH OF THE TRENCH WILL BE RESTORED TO MATCH THE EXISTING PAVEMENT SECTION, THE FULL WIDTH OF THE TRAVEL LANE TO THE CENTERLINE WILL BE MILLED AND OVERLAYED WITH A TOP COURSE OF ASPHALT. ALL TEMPORARY FENCING AND EROSION CONTROLS WILL BE REMOVED AND DISPOSED ON IN AN ACCEPTABLE MANNER AT A STATE-APPROVED DISPOSAL FACILITY APPROVED BY DPS STAFF AND THE CERTIFICATE HOLDERS.

PAVEMENT RESTORATION

AS DESCRIBED IN THE BMP DOCUMENT AND CERTIFICATE CONDITIONS, CURBS, SIDEWALKS, AND STREETS DAMAGED BY CONSTRUCTION WILL BE RESTORED TO PRE-EXISTING CONDITION OR BETTER. FURTHER, DISTURBED AREAS, RUTS, AND RILLS ALONG ROADWAYS SHALL BE RESTORED TO ORIGINAL GRADES AND CONDITIONS WITH PERMANENT REVEGETATION AND EROSION CONTROLS APPROPRIATE FOR THOSE LOCATIONS, AS APPROPRIATE.

THE CERTIFICATE HOLDERS WILL CONSULT THE MUNICIPAL ROAD OR HIGHWAY DEPARTMENT AND/OR THE REGIONAL OFFICE OR COUNTY ENGINEER OF THE NYSDOT IN ORDER TO IDENTIFY AND INCORPORATE APPROPRIATE SPECIFICATIONS FOR CURB, SIDEWALK, OR STREET RESTORATION. ALL SURFACE RESTORATION WILL FOLLOW THE SPECIFICATIONS AND DETAILS PROVIDED IN THE PLAN AND PROFILE DRAWINGS (SHEET C-631). GUIDE RAILS WILL BE REMOVED AND REPLACED IN ACCORDANCE WITH NYSDOT STANDARD SHEET 606-01.

SEED MIXES

- A. GENERAL SEED:
- 1. PIPELINE MIX W/SWITCHGRASS (ERNMX-102-1)
- 2. MIX COMPOSITION
- 33.0% PANICUM VIRGATUM, 'SHAWNEE' (SWITCHGRASS, 'SHAWNEE')
- 25.0% FESTUCA RUBRA (CREEPING RED FESCUE)
- 18.0% LOLIUM MULTIFLORUM (ANNUAL RYEGRASS)
- 16.0% PHLEUM PRATENSE, CLIMAX (TIMOTHY, CLIMAX)
- 5.0% TRIFOLIUM HYBRIDUM (ALSIKE CLOVER) 3.0% AGROSTIS ALBA (REDTOP)
- 3. APPLIED AT A RATE OF 40 LBS/ACRE.
- B. ADIRONDACK SEED:
- 1. MIX COMPOSITION
 - 25% VIRGINIA WILD RYE (ELYMUS VIRGINICUS VAR. VIRGINICUS)
 - 25% CANADA WILD RYE (ELYMUS CANADENSIS)
 - 25% AUTUMN BENTGRASS (AGROSTIS PERENNANS)
- 25% CAMPER LITTLE BLUESTEM (SCHIZACHYRIUM SCOPARIUM)
- 2. APPLIED AT A RATE OF 40 LBS/ACRE.
- C. SPECIALIZED WETLAND MIX FOR SHADED OBL-FACW AREAS (ERNMX-137) 1. MIX COMPOSITION
 - 35.0% CAREX VULPINOIDEA, PA ECOTYPE (FOX SEDGE, PA ECOTYPE)
- 20.0% ELYMUS VIRGINICUS, MADISON-NY ECOTYPE (VIRGINIA WILDRYE, MADISON-NY ECOTYPE)
- 15.0% CAREX SCOPARIA, PA ECOTYPE (BLUNT BROOM SEDGE, PA ECOTYPE) 12.8% CAREX LURIDA, PA ECOTYPE (LURID SEDGE, PA ECOTYPE)
- 5.0% CAREX LUPULINA, PA ECOTYPE (HOP SEDGE, PA ECOTYPE)
- 4.0% VERBENA HASTATA, PA ECOTYPE (BLUE VERVAIN, PA ECOTYPE)
- 2.0% HELIOPSIS HELIANTHOIDES, PA ECOTYPE (OXEYE SUNFLOWER, PA ECOTYPE)
- 1.0% CAREX INTUMESCENS, PA ECOTYPE (STAR SEDGE, PA ECOTYPE)
- 1.0% SPARGANIUM AMERICANUM (EASTERN BUR REED)
- 0.7% IRIS VERSICOLOR (BLUEFLAG)
- 0.5% BIDENS CERNUA, PA ECOTYPE (NODDING BUR MARIGOLD, PA ECOTYPE)
- 0.5% CAREX CRINITA, PA ECOTYPE (FRINGED SEDGE, PA ECOTYPE)
- 0.5% CAREX STIPATA, PA ECOTYPE (AWL SEDGE, PA ECOTYPE)
- 0.5% EUPATORIUM PERFOLIATUM, PA ECOTYPE (BONESET, PA ECOTYPE)
- 0.5% SCIRPUS CYPERINUS, PA ECOTYPE (WOOLGRASS, PA ECOTYPE)
- 0.5% VERNONIA NOVEBORACENSIS, PA ECOTYPE (NEW YORK IRONWEED, PA ECOTYPE)
- 0.3% LOBELIA SIPHILITICA, PA ECOTYPE (GREAT BLUE LOBELIA, PA ECOTYPE)
- 0.2% PENTHORUM SEDOIDES, PA ECOTYPE (DITCH STONECROP, PA ECOTYPE) 2. APPLIED AT A RATE OF APPROXIMATELY 20 LBS/ACRE, ALONG WITH THE COVER CROP.
- 3. COVER CROP SHOULD BE APPLIED AT A RATE OF 60-80 LBS/ACRE. COVER CROP TO BE AN ANNUAL RYE. COVER CROP
- BASED ON SEASON OF RESTORATION AN ANNUAL RYE THROUGH SPRING AND SUMMER AND WINTER RYE FOR LATE FALL.
- D. FACW WETLAND MEADOW MIX (ERNMX-122)
- 1. MIX COMPOSITION
- 21.0% CAREX VULPINOIDEA, PA ECOTYPE (FOX SEDGE, PA ECOTYPE)
- 20.0% ELYMUS VIRGINICUS, PA ECOTYPE (VIRGINIA WILDRYE, PA ECOTYPE)
- 16.0% CAREX LURIDA, PA ECOTYPE (LURID SEDGE, PA ECOTYPE)
- 12.0% CAREX LUPULINA, PA ECOTYPE (HOP SEDGE, PA ECOTYPE)
- 12.0% CAREX SCOPARIA, PA ECOTYPE (BLUNT BROOM SEDGE, PA ECOTYPE)
- 3.0% VERBENA HASTATA, PA ECOTYPE (BLUE VERVAIN, PA ECOTYPE)
- 2.4% ASCLEPIAS INCARNATA, PA ECOTYPE (SWAMP MILKWEED, PA ECOTYPE)
- 2.0% JUNCUS EFFUSUS (SOFT RUSH)
- 2.0% ZIZIA AUREA, PA ECOTYPE (GOLDEN ALEXANDERS, PA ECOTYPE)
- 1.6% ASTER NOVAE-ANGLIAE, PA ECOTYPE (NEW ENGLAND ASTER, PA ECOTYPE) 1.3% CAREX STIPATA, PA ECOTYPE (AWL SEDGE, PA ECOTYPE)
- 1.0% BIDENS CERNUA, PA ECOTYPE (NODDING BUR MARIGOLD, PA ECOTYPE)
- 1.0% JUNCUS TENUIS, PA ECOTYPE (PATH RUSH, PA ECOTYPE)
- 0.8% SOLIDAGO RUGOSA, PA ECOTYPE (WRINKLELEAF GOLDENROD, PA ECOTYPE)
- 0.6% VERBENA URTICIFOLIA. PA ECOTYPE (WHITE VERVAIN, PA ECOTYPE)
- 0.5% CAREX CRINITA, PA ECOTYPE (FRINGED SEDGE, PA ECOTYPE) 0.5% EUPATORIUM PERFOLIATUM, PA ECOTYPE (BONESET, PA ECOTYPE)
- 0.5% HELENIUM AUTUMNALE, PA ECOTYPE (COMMON SNEEZEWEED, PA ECOTYPE)
- 0.5% MIMULUS RINGENS, PA ECOTYPE (SQUARE STEMMED MONKEYFLOWER, PA ECOTYPE)
- 0.3% LOBELIA SIPHILITICA, PA ECOTYPE (GREAT BLUE LOBELIA, PA ECOTYPE) 0.3% SCIRPUS CYPERINUS, PA ECOTYPE (WOOLGRASS, PA ECOTYPE)
- 0.2% ALISMA SUBCORDATUM, PA ECOTYPE (MUD PLANTAIN, PA ECOTYPE)
- 0.2% ASTER PUNICEUS, PA ECOTYPE (PURPLESTEM ASTER, PA ECOTYPE)
- 0.2% ASTER UMBELLATUS, PA ECOTYPE (FLAT TOPPED WHITE ASTER, PA ECOTYPE)
- 0.1% PENTHORUM SEDOIDES, PA ECOTYPE (DITCH STONECROP, PA ECOTYPE)
- 2. APPLIED AT A RATE OF APPROXIMATELY 20 LBS/ACRE, ALONG WITH THE COVER CROP.
- 3. COVER CROP SHOULD BE APPLIED AT A RATE OF 60-80 LBS/ACRE. COVER CROP TO BE AN ANNUAL RYE. COVER CROP BASED ON SEASON OF RESTORATION AN ANNUAL RYE THROUGH SPRING AND SUMMER AND WINTER RYE FOR LATE FALL.





FOR EMCP REVIEW NOT FOR CONSTRUCTION

IS A VIOLATION OF LAW FOR ANY PERSON, UNLESS THEY ARE ACTING UNDER THE DIRECTION OF A LICENSED R LAND SURVEYOR TO ALTER AN ITEM IN ANY WAY. IF AN LITERED THE ALTERING ENGINEER ARCHITECT LANDSCAPE RCHITECT OR LAND SURVEYOR SHALL STAMP THE DOCUMENT AND INCLUDE THE NOTATION "ALTERED BY" FOLLOWED BY THEIR SIGNATURE, THE DATE OF SUCH ALTERATION, AND A SPECIFIC DESCRIPTION OF THE ALTERATION.

CHAMPLAIN HUDSON POWER EXPRESS BV TK E | 12/16/2022 | FINAL SUBMISSION BV TK 11/11/2022 DRAFT FINAL SUBMISSION 06/06/2022 | 60% DESIGN SUBMISSION BV TK 02/11/2022 PRELIMINARY DESIGN DEVELOPMENT BV TK BV TK 01/24/2022 PRELIMINARY PROGRESS DATE SUBMITTAL / REVISION DESCRIPTION DRAWN BY: AR DESIGNED BY: BV APPROVED BY: TK REV. NO.

SEGMENT 8 (PACKAGE 5A) - CSX: ROTTERDAM - BETHLEHEM GENERAL NOTES 2 OF 2

DRAWING NO. **G-003**

4 OF

KIEWIT PROJECT NO.

21162

2. INTERFERENCE WITH CSX OPERATION

- 2.a. AGENCY OR ITS CONTRACTOR SHALL ARRANGE AND CONDUCT ITS WORK SO THAT THERE WILL BE NO INTERFERENCE WITH CSX OPERATIONS, INCLUDING, BUT NOT LIMITED TO: TRAIN, SIGNAL, TELEPHONE AND TELEGRAPHIC SERVICES. OR DAMAGE TO CSX'S PROPERTY. OR TO POLES. WIRES. AND OTHER FACILITIES OF TENANTS ON CSX'S PROPERTY OR RIGHT-OF-WAY. AGENCY OR ITS CONTRACTOR SHALL STORE MATERIALS SO AS TO PREVENT TRESPASSERS FROM CAUSING DAMAGE TO TRAINS, OR CSX PROPERTY. WHENEVER WORK IS LIKELY TO AFFECT THE OPERATIONS OR SAFETY OF TRAINS, THE METHOD OF DOING SUCH APPROVAL SHALL NOT RELIEVE AGENCY OR ITS CONTRACTOR FROM LIABILITY IN CONNECTION WITH SUCH WORK.
- 2.b. IF CONDITIONS ARISING FROM OR IN CONNECTION WITH THE PROJECT REQUIRE THAT IMMEDIATE AND UNUSUAL PROVISIONS BE MADE TO PROTECT TRAIN OPERATIONS OR CSX'S PROPERTY, AGENCY OR ITS CONTRACTOR SHALL MAKE SUCH PROVISION. IF THE CSX REPRESENTATIVE DETERMINES THAT SUCH PROVISIONS IS INSUFFICIENT. CSX MAY, AT THE EXPENSE OF AGENCY OR ITS CONTRACTOR, REQUIRE OR PROVIDE SUCH PROVISION AS MAY BE DEEMED NECESSARY, OR CAUSE THE WORK TO CEASE IMMEDIATELY.
- 2.c. SHOULD WORK ACTIVITIES BE REQUIRED WITHIN CSX PROPERTY OR RIGHT-OF-WAY, THE CONTRACTOR SHALL REQUEST CSX TO LOCATE ANY BURIED UTILITIES OR FACILITIES (AIR LINES, WELLS, ETC.) A WRITTEN REQUEST SHALL BE DELIVERED TO THE CSX REPRESENTATIVE AT LEAST FIVE (5) DAYS IN ADVANCE. THE TRADITIONAL "ONE CALL" UTILITY LOCATE SERVICES ARE NOT RESPONSIBLE FOR LOCATING ANY CSX UNDERGRADE UTILITIES OR FACILITIES.

3. INSURANCE:

THE CONTRACTOR SHALL NOT BE PERMITTED TO WORK ON, OR HAVE POTENTIAL TO FOUL, CSX PROPERTY OR RIGHT-OF-WAY UNTIL IT HAS COMPLIED WITH THE FOLLOWING CONDITIONS:

- 3.a. NOTIFY CSX IN WRITING OF THE DATE THAT IT INTENDS TO COMMENCE WORK ON THE PROJECT. SUCH NOTICE MUST BE RECEIVED BY CSX AT LEAST TEN (10) BUSINESS DAYS IN ADVANCE OF THE DATE AGENCY OR ITS CONTRACTOR PROPOSES TO BEGIN WORK ON CSX PROPERTY. THE NOTICE MUST REFER TO THIS AGREEMENT BY DATE. IF FLAGGING SERVICE IS REQUIRED, SUCH NOTICE SHALL BE SUBMITTED AT LEAST THIRTY (30) BUSINESS DAYS IN ADVANCE OF THE DATE SCHEDULED TO COMMENCE THE WORK.
- 3.b. OBTAIN AUTHORIZATION, THROUGH THE NOTICE TO PROCEED, FROM THE CSX REPRESENTATIVE TO BEING WORK ON CSX PROPERTY. ONCE AUTHORIZATION IS GIVEN, AGENCY OR CONTRACTOR SHALL PROVIDE A DETAILED SCHEDULE TO INCLUDE MEANS AND METHODS FOR REVIEW, COMMENT AND/OR APPROVAL PRIOR TO COMMENCEMENT OF WORK. CSX WILL IN TURN PROVIDE DIRECTION REGARDING SPECIFIC CONDITIONS WITH WHICH IT MUST COMPLY.
- 3.c. OBTAIN FROM CSX THE NAMES, ADDRESSES AND TELEPHONE NUMBERS OF CSX'S PERSONNEL WHO MUST RECEIVE NOTICE UNDER PROVISIONS IN THE AGREEMENT. WHERE MORE THAN ONE INDIVIDUAL IS DESIGNATED, THE AREA OF RESPONSIBILITY OF EACH SHALL BE SPECIFIED.

4. WORK FOR THE BENEFIT OF THE CONTRACTOR:

- 4.a. NO TEMPORARY OR PERMANENT CHANGES TO WIRE LINES OR OTHER FACILITIES (OTHER THAN THIRD PARTY FIBER OPTIC CABLE TRANSMISSION SYSTEMS) ON CSX PROPERTY THAT ARE CONSIDERED NECESSARY TO THE WORK ARE ANTICIPATED OR SHOWN ON THE PLANS. IF ANY SUCH CHANGES ARE. OR BECOME. NECESSARY IN THE OPINION OF CSX OR AGENCY, SUCH CHANGES WILL BE COVERED BY APPROPRIATE REVISIONS TO THE PLANS AND BY PREPARATION OF A FORCE ACCOUNT ESTIMATE. SUCH FORCE ACCOUNT ESTIMATE MAY BE INITIATED BY EITHER CSX OR AGENCY, BUT MUST BE APPROVED BY BOTH CSX AND AGENCY. AGENCY OR CONTRACTOR SHALL BE RESPONSIBLE FOR ARRANGING FOR THE RELOCATION OF THE THIRD PARTY FIBER OPTIC CABLE TRANSMISSION SYSTEMS, AT NO COST OR EXPENSE TO CSX.
- 4.b. SHOULD AGENCY OR CONTRACTOR DESIRE ANY CHANGES IN ADDITION TO THE ABOVE, THEN IT SHALL MAKE SEPARATE ARRANGEMENTS WITH CSX FOR SUCH CHANGES TO BE ACCOMPLISHED AT THE AGENCY OR CONTRACTOR'S EXPENSE.

5. HAUL ACROSS RAILROAD:

- 5.a. IF AGENCY OR CONTRACTOR DESIRES ACCESS ACROSS CSX PROPERTY OF TRACKS AT OTHER THAN AN EXISTING AND OPEN PUBLIC ROAD CROSSING IN OR INCIDENT TO CONSTRUCTION OF THE PROJECT, THE AGENCY OR CONTRACTOR MUST FIRST OBTAIN THE PERMISSION OF CSX AND SHALL EXECUTE A LICENSE AGREEMENT OR RIGHT OF ENTRY, WHEREIN AGENCY OR CONTRACTOR AGREES TO BEAR ALL COSTS AND LIABILITIES RELATED TO SUCH ACCESS.
- 5.b. TEMPORARY CONSTRUCTION HAUL ROADS ACROSS CSX TRACKS WILL REQUIRE A SEPARATE APPLICATION AND PAYMENT TO CSX PROPERTY SERVICES. AGREEMENT EXTENSIONS REQUIRE ADDITIONAL PAYMENT. ACTUAL COST IS VARIABLE AND PROJECT SPECIFIC. ADDITIONAL INFORMATION CAN BE FOUND AT THIS
- 5.c. AGENCY AND CONTRACTOR SHALL NOT CROSS CSX'S PROPERTY AND TRACKS WITH VEHICLES OR EQUIPMENT OF ANY KIND OR CHARACTER, EXCEPT AT SUCH CROSSING OR CROSSINGS AS MAY BE PERMITTED PURSUANT TO THIS SECTION.

6. COOPERATION AND DELAYS

- 6.a. AGENCY OR CONTRACTOR SHALL ARRANGE A SCHEDULE WITH CSX FOR ACCOMPLISHING STAGE CONSTRUCTION INVOLVING WORK BY CSX. IN ARRANGING ITS SCHEDULE, AGENCY OR CONTRACTOR SHALL ASCERTAIN, FROM CSX, THE LEAD TIME REQUIRED FOR ASSEMBLING CREWS AND MATERIALS AND SHALL MAKE DUE ALLOWANCE THEREFORE.
- 6.b. AGENCY OR CONTRACTOR MAY NOT CHARGE ANY COSTS OR SUBMIT ANY CLAIMS AGAINST CSX FOR HINDRANCE OR DELAY CAUSE BY RAILROAD TRAFFIC; WORK DONE BY CSX OR OTHER DELAY INCIDENT TO OR NECESSARY FOR SAFE MAINTENANCE OF RAILROAD TRAFFIC: OR FOR ANY DELAYS DUE TO COMPLIANCE WITH THESE SPECIAL PROVISIONS.
- 6.c. AGENCY AND CONTRACTOR SHALL COOPERATE WITH OTHERS PARTICIPATING IN THE CONSTRUCTION OF THE PROJECT TO THE END THAT ALL WORK MAY BE CARRIED ON TO THE BEST ADVANTAGE.
- 6.d. AGENCY AND CONTRACTOR UNDERSTAND AND AGREE THAT CSX DOES NOT ASSUME ANY RESPONSIBILITY FOR WORK PERFORMED BY OTHERS IN CONNECTION WITH THE PROJECT. AGENCY AND CONTRACTOR FURTHER UNDERSTAND AND AGREE THAT THEY SHALL HAVE NO CLAIM WHATSOEVER AGAINST CSX FOR ANY INCONVENIENCE, DELAY OR ADDITIONAL COST INCURRED BY AGENCY OR CONTRACTOR ON ACCOUNT OF OPERATIONS BY OTHERS.

7. STORAGE OF MATERIALS AND EQUIPMENT:

7.a. AGENCY AND CONTRACTOR SHALL NOT STORE THEIR MATERIALS OR EQUIPMENT ON CSX'S PROPERTY OR WHERE THEY MAY POTENTIALLY INTERFERE WITH CSX'S OPERATIONS, UNLESS AGENCY OR CONTRACTOR HAS RECEIVED CSX REPRESENTATIVE'S PRIOR WRITTEN PERMISSION. AGENCY AND CONTRACTOR UNDERSTAND AND AGREE THAT CSX WILL NOT BE LIABLE FOR ANY DAMAGE TO SUCH MATERIALS AND EQUIPMENT FROM ANY CAUSE AND THAT CSX MAY MOVE, OR REQUIRE AGENCY OR CONTRACTOR TO MOVE, SUCH MATERIAL AND EQUIPMENT AT AGENCY'S OR CONTRACTOR'S SOLE EXPENSE. TO MINIMIZE THE POSSIBILITY OF DAMAGE TO THE RAILROAD TRACKS RESULTING FROM THE UNAUTHORIZED USE OF EQUIPMENT, ALL GRADING OR OTHER CONSTRUCTION EQUIPMENT THAT IS LEFT PARKED NEAR THE TRACKS UNATTENDED BY WATCHMEN SHALL BE IMMOBILIZED TO THE EXTENT FEASIBLE SO THAT IT CANNOT BE MOVED UNAUTHORIZED PERSONS.

8. CONSTRUCTION PROCEDURES

GENERAL

- 8.a. CONSTRUCTION WORK ON CSX PROPERTY SHALL BE SUBJECT TO CSX'S INSPECTION AND APPROVAL.
- 8.b. CONSTRUCTION WORK ON CSX PROPERTY SHALL BE IN ACCORD WITH CSX'S CONSTRUCTION SUBMISSION CRITERIA, LATEST EDITION AND CSX'S WRITTEN OUTLINE OF SPECIFIC CONDITIONS AND WITH THESE SPECIAL
- 8.c. CONTRACTOR SHALL OBSERVE THE TERMS AND RULES OF THE CSX SAFE WAY MANUAL, WHICH AGENCY AND CONTRACTOR SHALL BE REQUIRED TO OBTAIN FROM CSX, AND IN ACCORD WITH ANY OTHER INSTRUCTIONS FURNISHED BY CSX OF CSX'S REPRESENTATIVE. FAILURE TO COMPLY WITH THE TERMS OF THE AGREEMENT AND CSX RULES CAN RESULT IN MANDATORY RAILROAD WORKER PROTECTIVE TRAINING FOR THE AGENCY, CONTRACTOR AND ITS SUBCONTRACTORS.

BLASTING

- 8.d. AGENCY OR CONTRACTOR SHALL OBTAIN CSX REPRESENTATIVE'S AND AGENCY REPRESENTATIVES PRIOR WRITTEN APPROVAL FOR USE OF EXPLOSIVES ON OR ADJACENT TO CSX PROPERTY. IF PERMISSION FOR USE OF EXPLOSIVES IS GRANTED. AGENCY OR CONTRACTOR MUST COMPLY WITH THE FOLLOWING CODE:
- 8.d.1. BLASTING SHALL BE DONE WITH LIGHT CHARGES UNDER THE DIRECT SUPERVISION OF A RESPONSIBLE OFFICER OR EMPLOYEE OF AGENCY OR CONTRACTOR
- ELECTRIC DETONATING FUSES SHALL NOT BE USED BECAUSE OF THE POSSIBILITY OF PREMATURE EXPLOSIONS RESULTING FROM OPERATION OF TWO-WAY TRAIN RADIOS.
- 8.d.3. NO BLASTING SHALL BE DONE WITHOUT THE PRESENCE OF AN AUTHORIZED REPRESENTATIVE OF CSX. AT LEAST THIRTY (30) DAYS' ADVANCE NOTICE TO CSX REPRESENTATIVES IS REQUIRED TO ARRANGE FOR THE PRESENCE OF AN AUTHORIZED CSX REPRESENTATIVE AND ANY FLAGGING THAT CSX MAY REQUIRE.
- 8.d.4. AGENCY OR CONTRACTOR MUST HAVE AT THE PROJECT SITE ADEQUATE EQUIPMENT, LABOR AND MATERIALS, AND ALLOW SUFFICIENT TIME TO (1) CLEAN UP (AT AGENCY'S EXPENSE) DEBRIS RESULTING FROM THE BLASTING WITHOUT ANY DELAY TO TRAINS; AND (2) CORRECT (AT AGENCY'S EXPENSE) ANY TRACK MISALIGNMENT OR OTHER DAMAGE TO CSX'S PROPERTY RESULTING FROM THE BLASTING, AS DIRECTED BY CSX REPRESENTATIVE, WITHOUT DELAY TO TRAINS. IF AGENCY'S OR CONTRACTOR'S ACTIONS RESULT IN DELAY OF ANY TRAINS, INCLUDING AMTRAK PASSENGER TRAINS, AGENCY SHALL BEAR THE ENTIRE COST THEREOF.
- 8.d.5. AGENCY AND CONTRACTOR SHALL NOT STORE EXPLOSIVES ON CSX PROPERTY.

9. CSX REPRESENTATIVE WILL

- 9.a. DETERMINE THE APPROXIMATE LOCATION OF TRAINS AND ADVISE AGENCY OR CONTRACTOR OF THE APPROXIMATE AMOUNT OF TIME AVAILABLE FOR THE BLASTING OPERATION AND CLEAN-UP.
- HAVE THE AUTHORITY TO ORDER DISCONTINUANCE OF BLASTING IF, IN HIS OR HER OPINION, BLASTING IS TOO HAZARDOUS OR IS NOT IN ACCORD WITH THESE SPECIAL PROVISIONS.

- 10.a. SHOULD SOIL EXCAVATION WITHIN CSX PROPERTY BE ANTICIPATED AND SAID SOILS CANNOT REMAIN ON CSX PROPERTY DURING AND AFTER CONSTRUCTION, THEN CSX ENVIRONMENTAL MUST BE CONTACTED AT LEAST THIRTY (30) DAYS IN ADVANCE OF THE WORK IN ORDER TO SCHEDULE SAMPLING, CLASSIFICATION AND DISPOSITION OF MATERIAL. EXCAVATED MATERIAL IS PROHIBITED FROM BEING REMOVED FROM CSX PROPERTY. OR RIGHTS-OF-WAY, WITHOUT EXPRESSED WRITTEN DIRECTION FROM CSX. SHOULD FINAL DISPOSITION REQUIRE DISPOSAL OF EXCAVATED MATERIAL, CSX SHALL HAVE SOLE DISCRETION OF MEANS AND LOCATION OF SAID DISPOSAL. THE PROJECT SPONSOR OR AGENCY WILL BEAR ALL COSTS ASSOCIATED WITH SAMPLING, STAGING AND SUBSEQUENT DISPOSAL IF DEEMED NECESSARY. CONTRACTOR WILL BE REQUIRED TO OBTAIN ALL DISPOSAL TICKETS / DOCUMENTATION AND PROVIDE THE INFORMATION TO THE CSX REPRESENTATIVE. CSX WILL NOT BEAR ANY COSTS ASSOCIATED WITH THIS WORK.
- 10.b. ANY WASTE MATERIALS GENERATED BY THE PROJECT, INCLUDING BUT NOT LIMITED TO WASHING WITH CLEANING SOLVENTS, BLASTING, SCRAPING, BRUSHING AND PAINTING OPERATIONS, SHALL BE THE RESPONSIBILITY OF THE AGENCY OR ITS CONTRACTOR AND SHALL BE CONTAINED. COLLECTED AND PROPERLY DISPOSED OF BY THE AGENCY OR ITS CONTRACTOR, AGENCY AND ITS CONTRACTOR AGREE TO FULLY COMPLY WITH ALL FEDERAL, STATE, AND LOCAL ENVIRONMENTAL LAWS, REGULATIONS, STATUTES AND ORDINANCES AT ALL TIMES.

11. MAINTENANCE OF DITCHES ADJACENT TO CSX TRACKS

11.a. AGENCY OR CONTRACTOR SHALL MAINTAIN ALL DITCHES AND DRAINAGE STRUCTURES FREE OF SILT OR OTHER OBSTRUCTIONS THAT MAY RESULT FROM THEIR OPERATIONS. IN ADDITION, AGENCY OR CONTRACTOR SHALL MAINTAIN ALL CSX PROPERTY OR RIGHT-OF-WAY IMPACTED BY PROJECT OPERATIONS INCLUDING BUT NOT LIMITED TO; ACCESS OR HAUL ROADS, STAGING AREAS, PARKING LOTS IN A MANNER THAT PROVIDES CSX FREE AND CLEAR ACCESS TO FACILITIES, MATERIALS WHILE PROVIDING ACCEPTABLE DRIVING SURFACES FREE OF DRAINAGE IMPACTS OR REDUCED CSX CAPACITY. AGENCY OR CONTRACTOR SHALL PROVIDE EROSION CONTROL MEASURES DURING CONSTRUCTION AND USE METHODS THAT ACCORD WITH APPLICABLE STATE STANDARD SPECIFICATIONS FOR ROAD AND BRIDGE CONSTRUCTION, INCLUDING EITHER (1) SILT FENCE; (20 HAY OR STRAW BARRIER; (3) BERM OF TEMPORARY DITCHES; (4) SEDIMENT BASIN; AGGREGATE CHECKS; AND (60 CHANNEL LINING. ALL SUCH MAINTENANCE AND REPAIR OF DAMAGES DUE TO AGENCY'S OR CONTRACTORS OPERATIONS SHALL BE PERFORMED AT AGENCY'S EXPENSE.

12. TRACK PROTECTION / INSPECTION SERVICE

- 12.a. CSX HAS SOLE AUTHORITY TO DETERMINE THE NEED FOR TRACK PROTECTION REQUIRED TO PROTECT ITS OPERATIONS AND PROPERTY. IN GENERAL, TRACK PROTECTION WILL BE REQUIRED WHENEVER AGENCY OR CONTRACTOR OR THEIR EQUIPMENT ARE, OR ARE LIKELY TO BE, WORKING WITHIN FIFTY (50) FEET OF LIVE TRACK OR OTHER TRACK CLEARANCES SPECIFIED BY CSX, OR OVER TRACKS.
- 12.b. AGENCY SHALL REIMBURSE CSX DIRECTLY FOR ALL COSTS OF TRACK PROTECTION THAT IS REQUIRED ON ACCOUNT OF CONSTRUCTION WITHIN CSX PROPERTY SHOWN IN THE PLANS, OR THAT IS COVERED BY AN APPROVED PLAN REVISION, SUPPLEMENTAL AGREEMENT OR CHANGE ORDER.
- 12.c. AGENCY OR CONTRACTOR SHALL GIVE A MINIMUM OF THIRTY (30) DAYS' ADVANCE NOTICE TO CSX REPRESENTATIVE FOR ANTICIPATED NEED FOR TRACK PROTECTION. NO WORK SHALL BE UNDERTAKEN UNTIL THE FLAG PERSONS(S) IS/ARE AT THE JOB SITE. IF IT IS NECESSARY FOR CSX TO ADVERTISE A FLAGGING JOB FOR BID, IT MAY TAKE UP TO NINETY (90) DAYS TO OBTAIN THIS SERVICE AND CSX SHALL NOT BE LIABLE FOR THE COST OF DELAYS ATTRIBUTED TO OBTAINING SUCH SERVICE.
- 12.d. CSX SHALL HAVE THE RIGHT TO ASSIGN AN INDIVIDUAL TO THE SITE OF THE PROJECT TO PERFORM INSPECTION SERVICE WHENEVER, IN THE OPINION OF CSX REPRESENTATIVE, SUCH INSPECTION MAY BE NECESSARY. AGENCY SHALL REIMBURSE CSX FOR THE COSTS INCURRED BY CSX FOR SUCH INSPECTION SERVICE. INSPECTION SERVICE SHALL NOT RELIEVE AGENCY OR CONTRACTOR FROM LIABILITY.
- 12.e. CSX SHALL RENDER INVOICES FOR, AND AGENCY SHALL PAY FOR, THE ACTUAL PAY RATE OF THE FALGPERSONS AND INSPECTORS USED. PLUS STANDARD ADDITIVES. WHETHER THAT AMOUNT IS ABOVE OR BELOW THE RATE PROVIDED IN THE ESTIMATE. IF THE RATE OF PAY THAT IS TO BE USED FOR INSPECTOR OR FLAGGING SERVICE IS CHANGED BEFORE THE WORK IS STARTED OR DURING THE PROGRESS OF THE WORK, WETHER BY LAW OR AGREEMENT BETWEEN CSX AND ITS EMPLOYEES, OR IF THE TAX RATES ON LABOR ARE CHANGED. BILLS WILL BE RENDERED BY CSX AND PAID BY AGENCY USING THE NEW AGENCY AND CONTRACTOR SHALL PERFORM THEIR OPERATIONS THAT REQUIRE TRACK PROTECTION OR INSPECTION SERVICE IN SUCH A MANNER AND SEQUENCE THAT THE COST OF SUCH WILL BE AS ECONOMICAL AS

13. UTILITY FACILITIES ON CSX PROPERTY

13.a. AGENCY SHALL ARRANGE, UPON APPROVAL FROM CSX, TO HAVE ANY UTILITY FACILITIES ON OR OVER CSX PROPERTY CHANGED AS MAY BE NECESSARY TO PROVIDE CLEARANCES FOR THE PROPOSED TRACKAGE.

14. CLEAN-UP

14.a. AGENCY OR CONTRACTOR, UPON COMPLETION OF THE PROJECT, SHALL REMOVE AND DISPOSE FROM CSX'S PROPERTY ANY TEMPORARY CONSTRUCTION WORK, ANY TEMPORARY EROSION CONTROL MEASURES USED TO CONTROL DRAINAGE, ALL MACHINERY, EQUIPMENT, SURPLUS MATERIALS, FALSEWORK, RUBBISH, OR TEMPORARY BUILDINGS BELONGING TO AGENCY OR CONTRACTOR. AGENCY OR CONTRACTOR, UPON COMPLETION OF THE PROJECT, SHALL LEAVE CSX PROPERTY IN NEAT CONDITION, SATISFACTORY TO THE CSX REPRESENTATIVE.

15. FAILURE TO COMPLY

15.a. IF AGENCY OR CONTRACTOR VIOLATE OR FAIL TO COMPLY WITH ANY OF THE REQUIREMENTS OF THESE SPECIAL PROVISIONS, (A) CSX MAY REQUIRE AGENCY AND/OR CONTRACTOR TO VACATE CSX PROPERTY; AND (B) CSX MAY WITHHOLD MONIES DUE AGENCY AND/OR CONTRACTOR; (C) CSX MAY REQUIRE AGENCY TO WITHHOLD MONIES DUE CONTRACTOR; AND (D) CSX MAY CURE SUCH FAILURE AND THE AGNECY SHALL REIMBURSE CSX FOR THE COST OF CURING SUCH FAILURE.







FOR EMCP REVIEW NOT FOR CONSTRUCTION T IS A VIOLATION OF LAW FOR ANY PERSON. UNLESS THEY ARE ACTING UNDER THE DIRECTION OF A LICENSED DFESSIONAL ENGINEER, ARCHITECT, LANDSCAPE ARCHITECT R LAND SURVEYOR TO ALTER AN ITEM IN ANY WAY. IF AN EM BEARING THE STAMP OF A LICENSED PROFESSIONAL IS LTERED. THE ALTERING ENGINEER, ARCHITECT, LANDSCAPE RCHITECT OR LAND SURVEYOR SHALL STAMP THE DOCUMENT AND INCLUDE THE NOTATION "ALTERED BY" FOLLOWED BY THEIR SIGNATURE, THE DATE OF SUCH ALTERATION, AND A SPECIFIC DESCRIPTION OF THE ALTERATION.

CHAMPLAIN HUDSON POWER EXPRESS BV TK E | 12/16/2022 | FINAL SUBMISSION 11/11/2022 DRAFT FINAL SUBMISSION BV TK 06/06/2022 | 60% DESIGN SUBMISSION BV ΤK 02/11/2022 PRELIMINARY DESIGN DEVELOPMENT BV TK 01/24/2022 PRELIMINARY PROGRESS BV TK DB | APP | DRAWN BY: AR | DESIGNED BY: BV | APPROVED BY: TK | REV. NO. DATE SUBMITTAL / REVISION DESCRIPTION

SEGMENT 8 (PACKAGE 5A) - CSX: ROTTERDAM - BETHLEHEM

PACKAGE SPECIFIC NOTES

21162

G-004

DRAWING NO.

KIEWIT PROJECT NO.

AS SHOWN DATI E SH.NO.

EXISTING POST

EXISTING SYMBOL

EXISTING REFLECTOR MARKER

EXIST. STRUCTURE POST EXIST. STRUCTURE MAILBOX EXIST. WETLAND FLAG EXIST. GAS LINE EXIST. UNDERGROUND TELE. EXIST. UNDERGROUND ELEC. EXIST. OVERHEAD TELE. EXIST. CULVERT EXIST. STORM SEWER EXIST. STORM SEWER EXIST. POTABLE WATER LINE EXIST. CONTOUR, INDEX EXIST. CONTOUR, INDEX EXIST. CONTOUR, DEPRESSION INTERMEDIATE EXIST. COLUTRAL FIELD LINE EXIST. CULTURAL FIELD LINE EXIST. CULTURAL STORAGE AREA EXIST. CULTURAL STORAGE AREA EXIST. CULTURAL STORAGE AREA EXIST. CULTURAL STORAGE AREA EXIST. CULTURAL STORAGE AREA EXIST. NATURAL SHOULDER EXIST. NATURAL SINGLE TREE/BUSH EXIST. STRUCTURAL BUILDING EXIST. PAVED DRIVE EXIST. PAVED SIDEWALK EXIST. PAVED SIDEWALK EXIST. PAVED SIDEWALK EXIST. PAVED SIDEWALK EXIST. RATILROAD EXIST. R	SIGN	EXISTING SIGN
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R RADIUS 7' FOUL ZONE: NO VEHICLES, MATERIALS, DISTURBANCE, PERSONNEL, OR WORK SHALL ENCROACH THE ZONE WITHIN 7FT RD ROAD PROP. TEMP EASEMENT ROW REVSION PROP. TEMP EASEMENT ROW RIGHT—OF—WAY PROP. TEMP ACCESS EASEMENT RIE WITHOUT CSX COORDINATION AND APPROVAL ROW RIGHT—OF—WAY PROP. TEMP ACCESS EASEMENT RIE ROUTE SPLICE LOCATION POLE MARKER SEWER SANITARY SEWER PIPE UNDERGROUND POWER CABLE POLE MARKER SHEET PROP. TRANSITION BOX MANHOLE STA STATION STORM STORM DRAIN PIPE TELECOM TELECOMMUNICATIONS CABLE TEMP TEMPORARY TRANSITION SCABLE TEMP TEMPORARY TRANSITION STORM TELECOMMUNICATIONS CABLE TEMP TEMPORARY THERMAL RESISTIVITY TYP TYPICAL V VERTICAL		PVI	POINT OF VERTICAL INTERSECTION
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OF THE NEAREST RAIL WITHOUT CSX COORDINATION AND APPROVAL PROP. TEMP EASEMENT PROP. PERM EASEMENT PROP. PERM EASEMENT RT RT RT ROUTE SPLICE LOCATION POLE MARKER SUMER SUMER SH SH ST ST STREET ST ST ST ST ST ST ST ST ST		RCP	REINFORCED CONCRETE PIPE
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PROP. PERM EASEMENT PROP. TEMP ACCESS EASEMENT SPLICE LOCATION POLE MARKER SEWER SEWER SH ST STREET ST STREET PROP. TRANSITION BOX MANHOLE STORM STORM STORM DRAIN PIPE TELECOM TELECOMMUNICATIONS CABLE TEMP TEMPORARY TYP TYPICAL V VERTICAL	PROP. TEMP EASEMENT	REV	REVISION
PROP. TEMP ACCESS EASEMENT RTE RTE ROUTE SPLICE LOCATION POLE MARKER SEWER SEWER SH SHEET ST STREET PROP. TRANSITION BOX MANHOLE PROP. TRANSITION BOX MANHOLE TELECOM TELECOMMUNICATIONS CABLE TEMP TYPICAL V VERTICAL		ROW	RIGHT-OF-WAY
RTE ROUTE SPLICE LOCATION POLE MARKER SEWER SANITARY SEWER PIPE JUNDERGROUND POWER CABLE POLE MARKER ST STREET STA STATION PROP. TRANSITION BOX MANHOLE STORM STORM DRAIN PIPE TELECOM TELECOMMUNICATIONS CABLE TEMP TEMPORARY TR THERMAL RESISTIVITY TYP TYPICAL V VERTICAL	PROP. PERM EASEMENT	RT	RIGHT
JUNDERGROUND POWER CABLE POLE MARKER SH ST STREET ST STA STATION PROP. TRANSITION BOX MANHOLE STORM STORM DRAIN PIPE TELECOM TELECOMMUNICATIONS CABLE TEMP TEMPORARY TR THERMAL RESISTIVITY TYP TYPICAL V VERTICAL	PROP. TEMP ACCESS EASEMENT	RTE	ROUTE
SH SHEET ST STREET PROP. TRANSITION BOX MANHOLE STA STORM STORM DRAIN PIPE TELECOM TELECOMMUNICATIONS CABLE TEMP TEMPORARY TR THERMAL RESISTIVITY TYP TYPICAL V VERTICAL	SPLICE LOCATION POLE MARKER	SEWER	SANITARY SEWER PIPE
ST STREET PROP. TRANSITION BOX MANHOLE STA STORM STORM DRAIN PIPE TELECOM TELECOMMUNICATIONS CABLE TR THERMAL RESISTIVITY TYP TYPICAL V VERTICAL	INDEDCROUND DOWED CARLE DOLE MARKED		
STORM STORM DRAIN PIPE TELECOM TELECOMMUNICATIONS CABLE TEMP TEMPORARY TR THERMAL RESISTIVITY TYP TYPICAL V VERTICAL	UNDERGROUND POWER CABLE POLE MARKER		
STORM STORM DRAIN PIPE TELECOM TELECOMMUNICATIONS CABLE TEMP TEMPORARY TR THERMAL RESISTIVITY TYP TYPICAL V VERTICAL	DDOD TRANSITION DOV MANUOLE	STA	STATION
TEMP TEMPORARY TR THERMAL RESISTIVITY TYP TYPICAL V VERTICAL	PROP. TRANSITION BOX MANHOLE	STORM	STORM DRAIN PIPE
TR THERMAL RESISTIVITY TYP TYPICAL V VERTICAL		TELECOM	TELECOMMUNICATIONS CABLE
TR THERMAL RESISTIVITY TYP TYPICAL V VERTICAL		TEMP	TEMPORARY
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V VERTICAL			
WATER			
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IT IS A VIOLATION OF LAW FOR ANY PERSON, UNLESS THEY ARE ACTING UNDER THE DIRECTION OF A LICENSED ARE ACTING UNDER THE DIRECTION OF A LICENSED PROFESSIONAL ENGINEER, ARCHITECT, LANDSCAPE ARCHITECT OR LAND SURVEYOR TO ALTER AN ITEM IN ANY WAY. IF AN ITEM BEARING THE STAMP OF A LICENSED PROFESSIONAL IS ALTERED, THE ALTERING ENGINEER, ARCHITECT, LANDSCAPE ARCHITECT OR LAND SURVEYOR SHALL STAMP THE DOCUMENT AND INCLUDE THE NOTATION "ALTERED BY" FOLLOWED BY THEIR SIGNATURE, THE DATE OF SUCH ALTERATION, AND A SPECIFIC DESCRIPTION OF THE ALTERATION.

					\dashv CHAMPLAIN HUDSON POWER EX
					SEGMENT 8 (PACKAGE 5A) - CSX: ROTTERDAM -
E	12/16/2022	FINAL SUBMISSION	BV	TK	LECEND AND ADDDEVIATIONS
D	11/11/2022	DRAFT FINAL SUBMISSION	BV	TK	LEGEND AND ABBREVIATIONS
С	06/06/2022	60% DESIGN SUBMISSION	BV	TK	
В	02/11/2022	PRELIMINARY DESIGN DEVELOPMENT	BV	TK	
Α	01/24/2022	PRELIMINARY PROGRESS	BV	TK	
No.	DATE	SUBMITTAL / REVISION DESCRIPTION	DB	APP	P DRAWN BY: AR DESIGNED BY: BV APPROVED BY: TK REV. NO.


CHAMPLAIN HUDSON POWER EXPRESS EGMENT 8 (PACKAGE 5A) - CSX: ROTTERDAM - BETHLEHEM LEGEND AND ABBREVIATIONS

G-005

DRAWING NO.

KIEWIT PROJECT NO.

21162

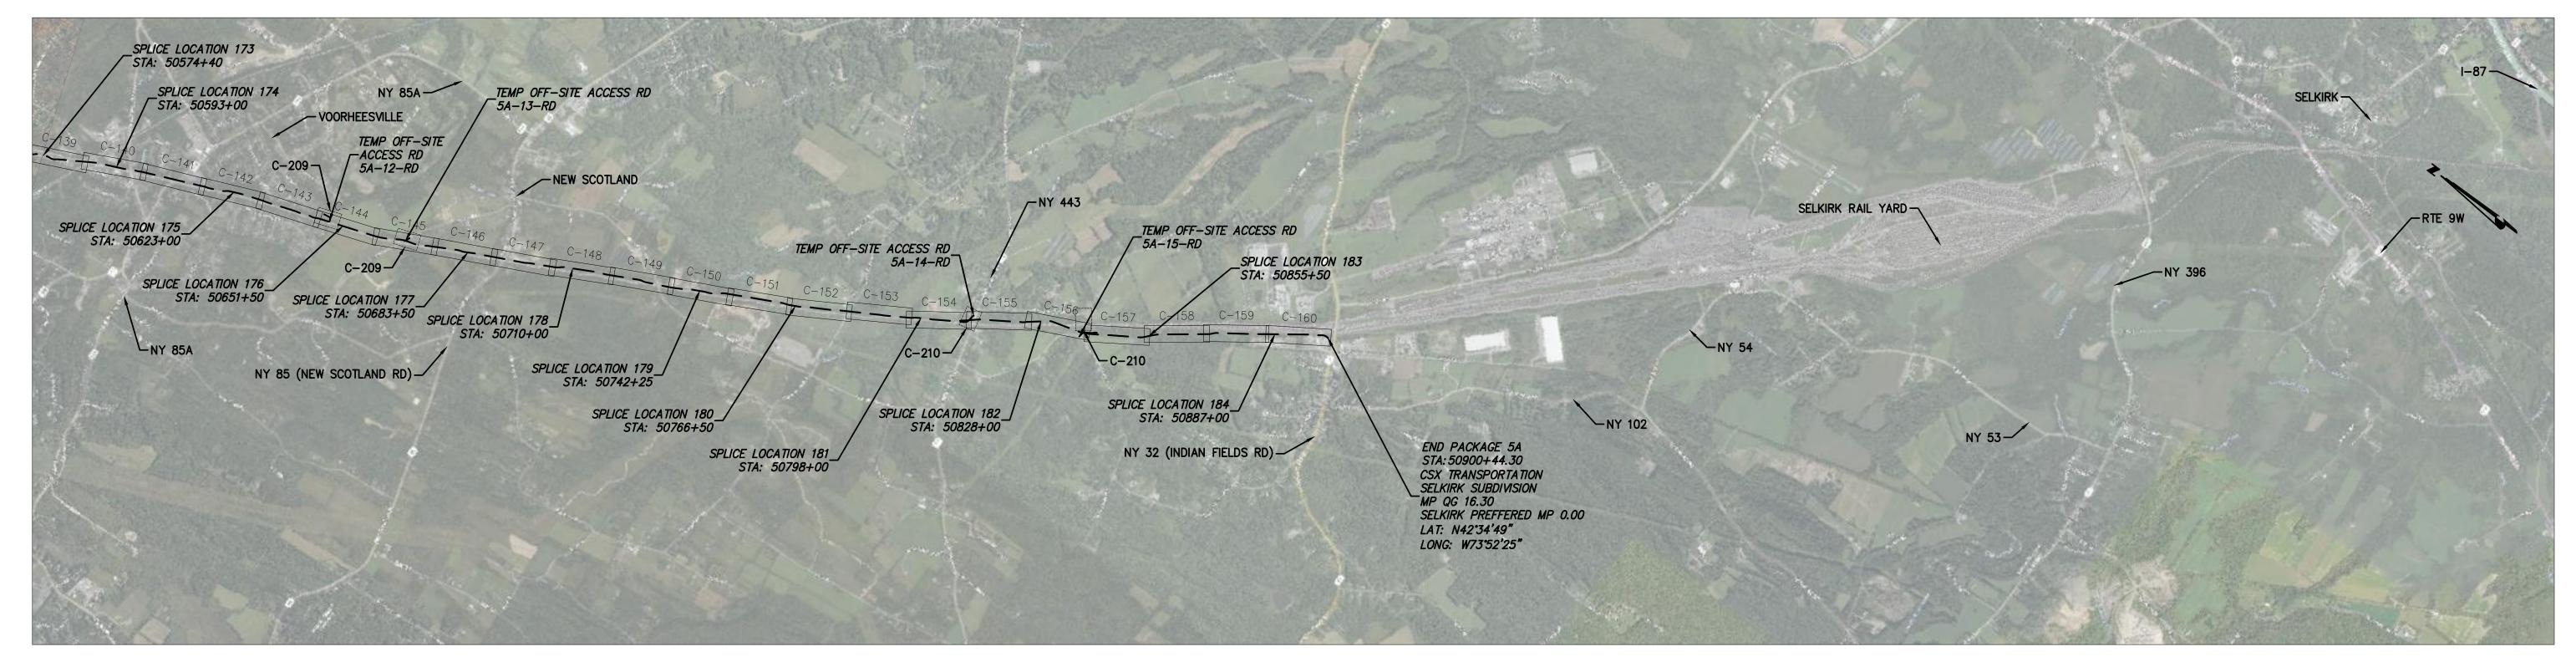

PLAN AND PROFILE KEY MAP SCALE: 1" = 2000'





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В	02/11/2022	PRELIMINARY DESIGN DEVELOPMENT	BV	TK						
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140.	DATE	SOBWITTAL / INEVISION DESCRIPTION		Α	DRAWN BY: AR	DESIGNED BY:	BV	APPROVED BY:	TK REV. N	ıO

KIEWIT PROJECT NO. CHAMPLAIN HUDSON POWER EXPRESS EGMENT 8 (PACKAGE 5A) - CSX: ROTTERDAM - BETHLEHEM PLAN AND PROFILE KEY MAP

G-006 AS SHOWN DATE

21162

DRAWING NO.

LINK BOX HANDHOLE TABLE									
LINK BOX HANDHOLE	SHEET NUMBER	STATION	NORTHING	EASTING	LATITUDE	LONGITUDE			
155	C-102	50027+50	1444473.86	626437.76	42.79729	73.99953			
158.A	C-109	50127+00	1435347.39	630181.86	42.77219	73.98579			
162	C-116	50238+00	1425109.11	634379.12	42.74402	73.97039			
166	C-124	50349+00	1414545.14	637167.93	42.71499	73.96026			
169	C-131 & C-132	50465+50	1403329.64	639778.55	42.68416	73.95087			
174	C-140	50593+00	1392297.02	646066.60	42.65378	73.92771			
178	C-148	50710+00	1381667.93	650886.74	42.62452	73.91007			
182	C-156	50828+00	1371564.43	656843.03	42.59668	73.88821			

	FIBER SPLICE HANDHOLE TABLE									
FIBER SPLICE HANDHOLE	SHEET NUMBER	STATION	NORTHING	EASTING	LATITUDE	LONGITUDE				
155	C-102	50027+25.25	1444498.49	626422.12	42.79736	73.99959				
156	C-104	50054+75.23	1441953.96	627436.85	42.79036	73.99586				
157	C-106	50081+35.25	1439563.53	628455.65	42.78378	73.99212				
158	C-107	50095+75.25	1438229.38	628992.44	42.78011	73.99015				
158.A	C-109	50126+75.25	1435373.21	630166.07	42.77226	73.98585				
159	C-111	50158+00.25	1432502.49	631355.24	42.76436	73.98148				
160	C-113	50180+75.22	1430403.52	632224.54	42.75859	73.97829				
161	C-114	50207+75.25	1427917.69	633264.93	42.75175	73.97448				
162	C-116	50237+75.25	1425134.89	634376.24	42.74409	73.97040				
163	C-118	50262+25.25	1422898.98	635364.16	42.73794	73.96678				
163.A	C-119	50276+25.25	1421601.65	635888.51	42.73437	73.96486				
164	C-121	50301+75.25	1419386.06	636782.15	42.72828	73.96158				
165	C-122 & C-123	50330+00.25	1416447.66	637161.18	42.72021	73.96024				
166	C-124	50348+75.25	1414573.71	637162.02	42.71506	73.96028				
167	C-125	50372+75.25	1412194.05	637321.52	42.70853	73.95975				
167.A	C-127	50402+00.25	1409346.57	637965.19	42.70071	73.95742				
168	C-129	50433+75.25	1406262.09	638626.98	42.69223	73.95503				
169	C-132	50465+25.25	1403351.12	639758.80	42.68422	73.95089				
170	C-133	50486+75.25	1401542.51	640921.31	42.67924	73.94661				
171	C-135	50518+75.25	1398894.69	642701.11	42.67194	73.94006				
172	C-137	50542+25.25	1396826.45	643810.87	42.66625	73.93598				
173	C-139	50574+15.25	1393954.29	645187.63	42.65834	73.93094				
174	C-140	50592+75.25	1392321.08	646050.10	42.65384	73.92777				
175	C-142	50622+75.25	1389606.55	647310.59	42.64637	73.92316				
176	C-144	50651+25.25	1386927.23	648270.11	42.63900	73.91966				
177	C-146	50683+25.25	1384040.79	649612.15	42.63106	73.91474				
178	C-148	50709+75.25	1381711.90	650865.58	42.62464	73.91015				
179	C-150	50742+00.25	1378842.53	652320.64	42.61674	73.90481				
180	C-152	50766+25.25	1376709.78	653452.42	42.61087	73.90067				
181	C-154	50797+75.25	1374025.57	655092.33	42.60347	73.89465				
182	C-156	50827+75.25	1371583.59	656821.02	42.59673	73.88829				
183	C-158	50855+25.25	1369216.21	658143.42	42.59021	73.88344				
184	C-160	50886+75.25	1366771.09	660099.11	42.58346	73.87625				

CHPE Champlain Hudson Power Express
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D	11/11/2022	DRAFT FINAL SUBMISSION	BV	TK	
С	06/06/2022	60% DESIGN SUBMISSION	BV	TK	
В	02/11/2022	PRELIMINARY DESIGN DEVELOPMENT	BV	TK	
Α	01/24/2022	PRELIMINARY PROGRESS	BV	TK	
No.	DATE	SUBMITTAL / REVISION DESCRIPTION	DB	APP	DRA

CHAMPLAIN HUDSON POWER EXPRESS EGMENT 8 (PACKAGE 5A) - CSX: ROTTERDAM - BETHLEHEM SPLICE, LINK BOX HANDHOLE, AND FIBER SPLICE HANDHOLE LOCATION TABLES

KIEWIT PROJECT NO. 21162 DRAWING NO.

G-007

AS SHOWN DATE

RAWN BY: AR DESIGNED BY: BV APPROVED BY: TK REV. NO.

IT IS A VIOLATION OF LAW FOR ANY PERSON, UNLESS THEY ARE ACTING UNDER THE DIRECTION OF A LICENSED

NOTE: DATA SHOWN ON THIS TABLE ARE CURRENTLY PROPOSED LOCATIONS ONLY. ACTUAL TEST HOLE INFORMATION WILL BE ADDED AS RECEIVED.

CHPE Kiewit **Power Express**



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IT IS A VIOLATION OF LAW FOR ANY PERSON, UNLESS THEY ARE ACTING UNDER THE DIRECTION OF A LICENSED ARE ACTING UNDER THE DIRECTION OF A LICENSED PROFESSIONAL ENGINEER, ARCHITECT, LANDSCAPE ARCHITECT OR LAND SURVEYOR TO ALTER AN ITEM IN ANY WAY. IF AN ITEM BEARING THE STAMP OF A LICENSED PROFESSIONAL IS ALTERED, THE ALTERING ENGINEER, ARCHITECT, LANDSCAPE ARCHITECT OR LAND SURVEYOR SHALL STAMP THE DOCUMENT AND INCLUDE THE NOTATION "ALTERED BY" FOLLOWED BY THEIR SIGNATURE, THE DATE OF SUCH ALTERATION, AND A SPECIFIC DESCRIPTION OF THE ALTERATION.

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					SEGMENT	8 (PACKAGE 5	δA)	- CSX: ROT	TEF	RDAM -
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С	06/06/2022	60% DESIGN SUBMISSION	BV	TK							
В	02/11/2022	PRELIMINARY DESIGN DEVELOPMENT	BV	TK							
Α	01/24/2022	PRELIMINARY PROGRESS	BV	TK							
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KIEWIT PROJECT NO. CHAMPLAIN HUDSON POWER EXPRESS SEGMENT 8 (PACKAGE 5A) - CSX: ROTTERDAM - BETHLEHEM TEST HOLE TABLE

DRAWING NO.

G-008

AS SHOWN DATE

21162

CHAPTER 4 - CONSTRUCTION METHODS

SECTION OF EM&CP

4.2

4.3

4.3.1

4.3.2

4.3.3, APPENDIX J

4.3.4

4.4

4.4.1

4.4.2

4.4.3

4.4.4

4.4.5

4.4.6

4.4.7

NOTE APPLICABLE FOR THIS SEGMENT

NOTE APPLICABLE FOR THIS SEGMENT

4.7

4.8 (SEE ALSO SECTION 8)

4.9

4.10

4.10.2

4.10.3

4.10.4

4.10.5

4.11 AND APPENDIX L

TOPIC

CABLE INSTALLATION REQUIREMENTS

HORIZONTAL DIRECTIONAL DRILLING

INSTALLATION AND PERFORMANCE CONTROLS

BUILDINGS AND STRUCTURES WITHIN 100-FT OF HDD

INADVERTENT RELEASE CONTINGENCY PLAN AND DRILLING FLUID

MANAGEMENT

ROAD CROSSING METHODS

TRENCHING

TRENCHING IN AGRICULTURAL LANDS

TRENCHING IN ROADWAYS

TRENCHING IN WETLANDS

LENGTH OF OPEN TRENCH

SPLICING AND JOINTING

DEWATERING METHODS

BEDDING AND BACKFILLING METHODS

DREDGING

CONVERTER STATION AND SUBSTATION REQUIREMENTS

RIGHT OF WAYS AND EASEMENTS

RIGHT OF WAY CLEARING

BUILDING AND STRUCTURE REMOVAL

ACCESS ROADS

DRIVEWAY ACCESS DURING CONSTRUCTION

ACCESS THROUGH WETLANDS OR STREAMS

ACCESS THROUGH AGRICULTURAL LANDS

DRAIN LINES AND UNDER DRAINS WITHIN AGRICULTURAL LANDS

SOIL MANAGEMENT PLAN CULVERT REPLACEMENT

THE MEASURES AND STANDARDS THAT WILL BE FOLLOWED WITHIN SEGMENT 8.

NOTE: TABLE 4 ABOVE SUMMARIZES THE CONSTRUCTION METHOD AND ASSOCIATED SUBSECTION THAT SUMMARIZES

<u>SEGMENT 8 - HDD LOCATIONS</u>

TABLE 4-1 - SEGMENT 8 HDD LOCATIONS								
HDD #	SHEET	LENGTH (FEET)	STATION (APPROXIMATE - SEE DRAWINGS FOR DETAILS)	PURPOSE				
81	C-139 AND C-140	550	STA 50578 TO 50588+50	AVOID CULVERTS AND UTILITIES, MAIN STREET				
82 AND 83	C-140 THROUGH C-142	1,100	STA 50599+50 TO 50615+50	AVOID MAPLE ROAD, CULVERT, DEC STREAM				
83.A	C-145 AND C-146	701	STA 50673+50 TO 50681	AVOID STREAM WITHIN CULVERT				
84	C-146 AND C-147	715	STA 50686+50 TO 50697+75	AVOID CULVERT AND NEW SCOTLAND ROAD				
84.A	C-149 AND C-150	1,028	STA 50728+50 TO 50739	AVOID NEW SCOTLAND SOUTH ROAD, BRIDGE CROSSING, AND STREAMS				
84.B	C-152 AND C-153	1,032	STA 50777 TO 50787+50	AVOID GAME FARM ROAD, TERRAIN CONSTRAINTS				
85	C-154 AND C-155	550	STA 50807+50 TO 50823	AVOID DELAWARE TURNPIKE AND MANY CULVERTS				
87	C-156 AND C-157	720	STA 50831 TO 50842+75	AVOID STREAM AND GAS LINES				
87.A.A	C-160	650	STA 50890 TO 50897	AVOID CULVERT				

<u>SEGMENT 8 - HDD INFORMATION AND ADJACENT STRUCTURES</u>

HDD #	PARCEL NUMBER	STRUCTURE OWNER	SHEET (APPROXIMATE -SEE APPENDIX (FOR DETAILS)
71	478-1.111	1155 PRINCETOWN ROAD, LLC	C-101 AND C-102
71	478-2.5	BURDECK ST DEVELOPMENT, LLC	C-101 AND C-102
71	483-5	797 BURDECK ST PROPERTY, LLC	C-101 AND C-102
71	48.9-1-8	MONINI III, VINCENT J	C-101 AND C-102
71	48.9-1-9	ATTANASIO, LINDA	C-101 AND C-102
71	48.9-1-10	ANTONELLI, LIANA G	C-101 AND C-102
71	48.9-1-12	GNIDOWSKI, DERRICK J	C-101 AND C-102
71	48.9-1-13	HOLLER, CHRISTA L	C-101 AND C-102
71	48.9-1-14.1	HAIGH, LINDA L	C-101 AND C-102
71	48.9-1-15.1	KRONE, ADAM R	C-101 AND C-102
71	48.9-1-16.1	COURT APARTMENTS LLC, BROOKVIEW	C-101 AND C-102
71	48.9-1-18	COURT APARTMENTS LLC, BROOKVIEW	C-101 AND C-102
72	48.17-3-3.1	SMITH, SHAWN M	C-103 AND C-104
72	48.17-3-11.11	COUNTY OF SCHENECTADY	C-103 AND C-104
72	48.17-3-12	DAZ REAL ESTATE DEVELOPMEN LLC	C-103 AND C-104
73	48.17-7-5.11	CAMPOLI, EILEEN M	C-105
73	48.17-7-10.11	PARKVIEW AT TICONDEROGA, LLC	C-105
73A 74	582-2.21	BROWN, JEFFREY D	C-107 AND C-108
73A 74	58.14-1-4.21	WHITE, LAWRENCE G	C-107 AND C-108
73	581-12.111	GOLUB CORPORATION	C-105
75	58.18-3-17	MARTINELLI, LARRY	C-105
75	70.6-3-1.1	ALGER, NINA L	C-105
75AA	703-29	GRIESEMER, MICHAEL H	C-112
75A	14.00-2-29	KIRCHHOF, DARRIN G	C-115 AND C-116
75A	14.00-2-17	DEPOALO, VICTOR	C-115 AND C-116
75A	14.00-2-36.2	ZELEZNIAK, STEPHEN	C-115 AND C-116
5B AND 76 76A	26.00-3-35	EIGHTY FOUR PROPERTIES LLC	C-120 TO C-122
76 76A	38.00-4-5.5	PORTER, ZACHARY KENNETH	C-121 AND C-122
76 76A 77	38.00-4-5.6	OPEL, PAULA A	C-121 TO C-124
78	38.20-2-21	FOUR HUNDRED TWENTY EIGHT	C-126 AND C-127
78	38.00-5-14	GUILDERLAND TOWN OF	C-126 AND C-127
78 79B 80	50.00-1-14.11/2	NORTHEASTERN IP HOLDINGS INC	C-126 TO C-131
80	50.00-1-14.21	NORTHEASTERN IP HOLDINGS INC	C-130 AND C-131
80A	613-16.1	FARLIN CORPORATION	C-137 TO C-139
80A 81	61.19-2-2	E W TOMPKINS CO INC	C-137 TO C-1340
81	72.8–3–1	VILLAGE OF VOORHEESVILLE	C-139 AND C-140
81	72.8–1–1	CURCIO NY, VOORHEESVILLE LLC	C-139 AND C-140
81	72.7-3-35	PHILLIPS FAMILY REALTY ASSOC.	C-139 AND C-140
81	72.7–3–31	GROVE STREET RENTALS LLC	C-139 AND C-140
81	72.7-3-31	GROVE STREET RENTALS LLC	C-139 AND C-140

HDD #	PARCEL NUMBER	STRUCTURE OWNER	SHEET (APPROXIMATE -SEE APPENDI FOR DETAILS)
81	61.19-3-22	BADGER, CHRISTINE	C-139 AND C-140
81	61.19-2-6	DERGOSITS, CHRISTINA	C-139 AND C-140
82	72.12-1-44	PIQUETTE, HENRY B	C-140 TO C-142
82	72.12-1-43	ELLIOTT, HUGUETTE B	C-140 TO C-142
82	72.12-1-43	ELLIOTT, HUGUETTE B	C-140 TO C-142
82	72.12-1-42	SIEGEL, SHARON	C-140 TO C-142
82	72.12-1-41	JONES, THOMAS K	C-140 TO C-142
82	72.12-1-40	MORRISSEY, MEGHAN	C-140 TO C-142
82	72.12-1-39	BARONE, JOSEPH A	C-140 TO C-142
82	72.12-1-38	PORTER, JOHN M	C-140 TO C-142
82	72.12-1-37	WILK, SYDNEY	C-140 TO C-142
82	72.12-1-36	MAXWELL, SHAWN R	C-140 TO C-142
82	72.12-4-9	HARBOUR-HOLLAND, MARGARET E	C-140 TO C-142
82	72.12-4-8	STARK, GEORGE E	C-140 TO C-142
82	72.12-4-6	SCHIPANO, DIANE	C-140 TO C-142
82	72.12-4-2	MAPLE TOV, LLC	C-140 TO C-142
82	72.12-4-1	MAPLE TOV, LLC	C-140 TO C-142
82	72.12-3-1	GARDNER JASON	C-140 TO C-142
82	72.8-1-26	KAUS, ROBERT B	C-140 TO C-142
82	72.8-1-38	SEMENICK, JOHN -LE-	C-140 TO C-142
82	72.8-1-25	SEMENICK, JOHN J	C-140 TO C-142
82	72.8-1-7.2	UNITED STATES POSTAL SERVICE	C-140 TO C-142
83A	723-41.2	MENGEL, ROBERT A	C-145 AND C-146
83A	723-41.3	WOOD, DENNIS	C-145 AND C-146
83A	723-42	MOREAU, DAVID N	C-145 AND C-146
83A	723-41.611	ECKELS, ROBERT	C-145 AND C-146
83A 84	723-41.612	WUTTKE, ERIC	C-145 TO C-147
84	954-2	ROBERT P LONG	C-146 AND C-147
84	954-2	CSX TRANSPORTATION INC.	C-146 AND C-147
84A	844-1.22	JEAJ, LLC	C-149 AND C-150
84A	844-1.21	BOEHLKE, CHESTER	C-149 AND C-150
84A	842-49.4	MURRAY, LAURA K	C-149 AND C-150
84A	842-49.3	BOEHLKE, CHESTER D SR	C-149 AND C-150
84B	842-50	NYSDEC	C-152 AND C-153
84B	842-50	NEW YORK STATE, NYSDEC	C-152 AND C-153
84B	953-1.1	WRIGHT, BARBARA	C-152 AND C-153
85	953-42	KEIB, MATTHIAS	C-154 AND C-155
87	1071-3	HASKELL, KEVIN R	C-156 AND C-157
87AA	108.00-1-13	FLACH PROPERTIES LLC	C-160
87AA	108.00-1-12	FLACH PROPERTIES LLC	C-160





FOR EMCP REVIEW NOT FOR CONSTRUCTION

IT IS A VIOLATION OF LAW FOR ANY PERSON, UNLESS THEY ARE ACTING UNDER THE DIRECTION OF A LICENSED ARE ACTING UNDER THE DIRECTION OF A LICENSED PROFESSIONAL ENGINEER, ARCHITECT, LANDSCAPE ARCHITECT OR LAND SURVEYOR TO ALTER AN ITEM IN ANY WAY. IF AN ITEM BEARING THE STAMP OF A LICENSED PROFESSIONAL IS ALTERED, THE ALTERING ENGINEER, ARCHITECT, LANDSCAPE ARCHITECT OR LAND SURVEYOR SHALL STAMP THE DOCUMENT AND INCLUDE THE NOTATION "ALTERED BY" FOLLOWED BY THEIR SIGNATURE, THE DATE OF SUCH ALTERATION, AND A SPECIFIC DESCRIPTION OF THE ALTERATION.

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					SEGMENT 8 (PACKAGE 5A) - CSX: ROTTER					
E	12/16/2022	FINAL SUBMISSION	BV	TK		`			- C	
D	11/11/2022	DRAFT FINAL SUBMISSION	BV	TK	TK EM-CP DATA TABLES					
С	06/06/2022	60% DESIGN SUBMISSION	BV	TK						
В	02/11/2022	PRELIMINARY DESIGN DEVELOPMENT	BV	TK						
Α	01/24/2022	PRELIMINARY PROGRESS	BV	TK				_		
No.	DATE	SUBMITTAL / REVISION DESCRIPTION	DB	APP	DRAWN BY: AR	DESIGNED BY:	BV	APPROVED BY:	TK	SCALE REV. NO.

KIEWIT PROJECT NO. CHAMPLAIN HUDSON POWER EXPRESS EGMENT 8 (PACKAGE 5A) - CSX: ROTTERDAM - BETHLEHEM EM-CP DATA TABLES

21162 DRAWING NO.

G-009

			TABLE 4-4 - FACILITY ROW OWNERSHIP FO	OR SEGMENT 8			
COUNTY	TOWN	PARCEL NUMBER	PROPERTY OWNER	STATION START	STATION END	OWNER TYPE	TYPE OF EASEMENT
SCHENECTADY COUNTY	ROTTERDAM		PRINCETOWN ROAD	50000+00	50011+95	PUBLIC	PERMANENT
SCHENECTADY COUNTY	ROTTERDAM		PRINCETOWN ROAD	50000+00	50005+38	PUBLIC	TEMPORARY CONSTRUCTION
SCHENECTADY COUNTY	ROTTERDAM	10 1 10 11	PHILIPS ROAD	50009+63	50009+89	PUBLIC	PERMANENT
SCHENECTADY COUNTY SCHENECTADY COUNTY	ROTTERDAM ROTTERDAM	481-12.11 478-1.111	DELAWARE & HUDSON RAIL COMPANY 1155 PRINCETOWN ROAD, LLC	50011+95 50014+68	50013+25 50015+28	PRIVATE PRIVATE	PERMANENT PERMANENT
SCHENECTADY COUNTY	ROTTERDAM	470-1.111	BURDECK STREET (EAST AND WEST BOUNDARY)	50020+71	50013+28	PUBLIC	PERMANENT
SCHENECTADY COUNTY	ROTTERDAM		BURDECK STREET	50021+57	50022+17	PUBLIC	TEMPORARY CONSTRUCTION
SCHENECTADY COUNTY	ROTTERDAM	48.00-3-5	797 BURDECK ST PROPERTY LLC	50023+67	50022+44	PRIVATE	TEMPORARY CONSTRUCTION
SCHENECTADY COUNTY	ROTTERDAM	48.00-3-5	797 BURDECK ST PROPERTY LLC	50023+33	50029+46	PRIVATE	TEMPORARY CONSTRUCTION
SCHENECTADY COUNTY	ROTTERDAM	48.00-1-12	DELAWARE & HUDSON RAILWAY	50034+59	50035+24	PRIVATE	TEMPORARY CONSTRUCTION
SCHENECTADY COUNTY	ROTTERDAM	48.00-1-12	DELAWARE & HUDSON RAILWAY (EAST AND WEST BOUNDARY)	50034+69	50035+37	PRIVATE	PERMANENT
SCHENECTADY COUNTY	ROTTERDAM	48.00-1-12	DELAWARE & HUDSON RAILWAY	50034+76	50035+41	PRIVATE	TEMPORARY CONSTRUCTION
SCHENECTADY COUNTY	ROTTERDAM		KELLER AVE	50040+88	50041+84	PRIVATE	TEMPORARY CONSTRUCTION
SCHENECTADY COUNTY SCHENECTADY COUNTY	ROTTERDAM ROTTERDAM	48.17-3-3.1	KELLER AVE (EAST AND WEST BOUNDARY) SHAWN M & PAMELA V. SMITH	50040+88 50041+70	50041+84 50044+23	PUBLIC PRIVATE	PERMANENT PERMANENT
SCHENECTADY COUNTY	ROTTERDAM	48.17-3-3.1	SHAWN M & PAMELA V. SMITH	50041+70	50044+25	PRIVATE	TEMPORARY CONSTRUCTION
SCHENECTADY COUNTY	ROTTERDAM	10.17 0 0.1	MARIAVILLE ROAD (EAST AND WEST BOUNDARY)	50044+23	50044+85	PUBLIC	PERMANENT
SCHENECTADY COUNTY	ROTTERDAM	48.17-3-12	DAZ REAL ESTATE DEVELOPMENT	50044+85	50045+37	PRIVATE	PERMANENT
SCHENECTADY COUNTY	ROTTERDAM	48.17-3-11.11	COUNTY OF SCHENECTADY	50045+37	50057+99	PRIVATE	PERMANENT
SCHENECTADY COUNTY	ROTTERDAM	48.17-3-11.11	COUNTY OF SCHENECTADY	50048+76	50054+00	PRIVATE	TEMPORARY CONSTRUCTION
SCHENECTADY COUNTY	ROTTERDAM	48.17-3-11.11	COUNTY OF SCHENECTADY	50056+00	50058+62	PRIVATE	TEMPORARY CONSTRUCTION
SCHENECTADY COUNTY	ROTTERDAM	48.17-3-11.11	COUNTY OF SCHEMECTADY	50058+01	50058+79	PRIVATE	PERMANENT
SCHENECTADY COUNTY	ROTTERDAM	48.17-7-3	3324 THOMSON LLC	50058+62	50061+85	PRIVATE	TEMPORARY CONSTRUCTION
SCHENECTADY COUNTY	ROTTERDAM	48.17-7-3	3324 THOMSON LLC (EAST AND WEST BOUNDARY)	50058+79	50061+85	PRIVATE	PERMANENT
SCHENECTARY COUNTY	ROTTERDAM	48.17-7-3	3324 THOMSON LLC PARKVIEW AT TICONDEROGA, LLC	50060+02	50061+35	PRIVATE	TEMPORARY CONSTRUCTION
SCHENECTADY COUNTY SCHENECTADY COUNTY	ROTTERDAM ROTTERDAM	48.17-7-10.11 48.17-7-10.11	PARKVIEW AT TICONDEROGA, LLC PARKVIEW AT TICONDEROGA, LLC (EAST AND WEST BOUNDARY)	50061+35 50061+85	50065+02 50067+11	PRIVATE PRIVATE	TEMPORARY CONSTRUCTION PERMANENT
SCHENECTADY COUNTY	ROTTERDAM	48.17-7-10.11	PARKVIEW AT TICONDEROGA, LLC	50061+85	50065+02	PRIVATE	TEMPORARY CONSTRUCTION
SCHENECTADY COUNTY	ROTTERDAM	10.17 7 10.11	DUANESBURG ROAD (EAST AND WEST BOUNDARY)	50067+11	50067+68	PUBLIC	PERMANENT
SCHENECTADY COUNTY	ROTTERDAM	58.00-2-12.111	GOLUB CORPORATION	50067+68	50086+58	PRIVATE	PERMANENT
SCHENECTADY COUNTY	ROTTERDAM	58.00-2-12.111	GOLUB CORPORATION	50070+08	50090+73	PRIVATE	TEMPORARY CONSTRUCTION
SCHENECTADY COUNTY	ROTTERDAM	58.00-2-12.111	GOLUB CORPORATION	50070+14	50072+63	PRIVATE	TEMPORARY CONSTRUCTION
SCHENECTADY COUNTY	ROTTERDAM	58.00-2-12.111	GOLUB CORPORATION	50094+15	50100+51	PRIVATE	TEMPORARY CONSTRUCTION
SCHENECTADY COUNTY	ROTTERDAM	58.00-2-12.111	GOLUB CORPORATION	50095+00	50097+00	PRIVATE	PERMANENT
SCHENECTADY COUNTY	ROTTERDAM	58.00-2-12.11	GOLUB CORPORATION	50104+45	50105+09	PRIVATE	PERMANENT
SCHENECTADY COUNTY	ROTTERDAM	58.00-1-2.31	ROTTERDAM VENTURES INC	50105+09	50108+79	PRIVATE	PERMANENT
SCHENECTADY COUNTY SCHENECTADY COUNTY	ROTTERDAM ROTTERDAM	58.00-1-8	ANEEL RAMTEJ NEW YORK STATE THROUGHWAY	50108+79 50114+88	50144+88 50119+54	PRIVATE PUBLIC	PERMANENT PERMANENT
SCHENECTADY COUNTY	ROTTERDAM		NEW YORK STATE THROUGHWAY	50118+21	50119+96	PUBLIC	TEMPORARY CONSTRUCTION
SCHENECTADY COUNTY	ROTTERDAM		NEW YORK STATE THROUGHWAY	50118+31	50119+82	PUBLIC	TEMPORARY CONSTRUCTION
SCHENECTADY COUNTY	ROTTERDAM	58.14-1-4.21	LAWRENCE G. WHITE (EAST AND WEST BOUNDARY)	50119+54	50122+75	PRIVATE	PERMANENT
SCHENECTADY COUNTY	ROTTERDAM	58.14-1-4.21	LAWRENCE G. WHITE	50119+96	50122+75	PRIVATE	TEMPORARY CONSTRUCTION
SCHENECTADY COUNTY	ROTTERDAM	58.14-1-4.111	JACOB SCHUMACHER & ALEXANDER FROST	50122+75	50125+60	PRIVATE	PERMANENT
SCHENECTADY COUNTY	ROTTERDAM	58.14-1-4.111	JACOB SCHUMACHER & ALEXANDER FROST	50122+75	50125+60	PRIVATE	TEMPORARY CONSTRUCTION
SCHENECTADY COUNTY	ROTTERDAM	58.14-1-4.111	JACOB SCHUMACHER & ALEXANDER FROST	50122+75	50125+60	PRIVATE	TEMPORARY CONSTRUCTION
SCHENECTARY COUNTY	ROTTERDAM	58.14-1-4.112	HARVEY CIVIL . & ANN M. NEACH	50125+60	50128+01	PRIVATE	PERMANENT
SCHENECTADY COUNTY SCHENECTADY COUNTY	ROTTERDAM ROTTERDAM	58.14-1-4.112 58.14-1-4.112	HARVEY CIVIL . & ANN M. NEACH HARVEY CIVIL . & ANN M. NEACH	50125+60 50125+60	50128+01 50128+01	PRIVATE PRIVATE	TEMPORARY CONSTRUCTION TEMPORARY CONSTRUCTION
SCHENECTADY COUNTY	ROTTERDAM	58.14-1-6	WESTCOTT ENTERPRISES, LLC	50128+01	50130+05	PRIVATE	PERMANENT
SCHENECTADY COUNTY	ROTTERDAM	58.14-1-6	WESTCOTT ENTERPRISES, LLC	50128+01	50133+23	PRIVATE	TEMPORARY CONSTRUCTION
SCHENECTADY COUNTY	ROTTERDAM	58.18-3-17	LARRY MARTINELLI	50143+86	50145+25	PRIVATE	TEMPORARY CONSTRUCTION
SCHENECTADY COUNTY	ROTTERDAM	58.18-3-17	LARRY MARTINELLI	50146+30	50149+04	PRIVATE	PERMANENT
SCHENECTADY COUNTY	ROTTERDAM	58.18-3-17	LARRY MATINELLI	50148+59	50149+04	PRIVATE	TEMPORARY CONSTRUCTION
SCHENECTADY COUNTY	ROTTERDAM		GUILDERLAND AVE	50149+02	20149+26	PUBLIC	TEMPORARY CONSTRUCTION
SCHENECTARY COUNTY	ROTTERDAM		GUILDERLAND AVE	50149+04	50149+32	PUBLIC	TEMPORARY CONSTRUCTION
SCHENECTADY COUNTY SCHENECTADY COUNTY	ROTTERDAM ROTTERDAM	70.06-3-1.1	GUILDERLAND AVE (EAST AND WEST BOUNDARY) THE ALGER REVOCABLE TRUST	50149+04 50150+57	50150+57 50159+13	PUBLIC PRIVATE	PERMANENT PERMANENT
SCHENECTADY COUNTY SCHENECTADY COUNTY	ROTTERDAM	70.06-3-1.1	THE ALGER REVOCABLE TRUST	50150+57	50159+13	PRIVATE	TEMPORARY CONSTRUCTION
SCHENECTADY COUNTY	ROTTERDAM	70.06-3-1.1	THE ALGER REVOCABLE TRUST	50153+64	50159+13	PRIVATE	TEMPORARY CONSTRUCTION
SCHENECTADY COUNTY	ROTTERDAM	70.00-2-5.111	FIRE DISTRICT OF #5	50159+13	50163+11	PRIVATE	PERMANENT
SCHENECTADY COUNTY	ROTTERDAM	70.00-2-5.111	FIRE DISTRICT OF #5	50159+13	50161+25	PRIVATE	TEMPORARY CONSTRUCTION
SCHENECTADY COUNTY	ROTTERDAM	70.00-2-5.111	FIRE DISTRICT OF #5	50159+13	50176+70	PRIVATE	TEMPORARY CONSTRUCTION
SCHENECTADY COUNTY	ROTTERDAM	70.00-2-5.111	FIRE DISTRICT OF #5	50167+15	50176+70	PRIVATE	PERMANENT
SCHENECTADY COUNTY	ROTTERDAM	70.00-3-29	MICHAEL H. GRIESEMER	50176+70	50183+64	PRIVATE	PERMANENT TEMPORARY CONCERNS AND ADMINISTRATION OF THE PERMANENT OF THE PERMAENT OF THE PERMANENT OF THE PERMANENT OF THE PERMANENT OF THE PER
SCHENECTADY COUNTY	ROTTERDAM	70.00-3-29	MICHAEL H. GRIESEMER	50176+70	50183+64	PRIVATE	TEMPORARY CONSTRUCTION
SCHENECTADY COUNTY	ROTTERDAM GUILDERLAND	70.00-2-22	COLLINS REVOCABLE TRUST, RANDOLPH J. COUNTY LINE ROAD (EAST)	50183+64 50194+91	50188+53 50195+41	PRIVATE PUBLIC	TEMPORARY CONSTRUCTION
ALBANY COUNTY ALBANY COUNTY	GUILDERLAND		COUNTY LINE ROAD (EAST) COUNTY LINE ROAD (EAST AND WEST BOUNDARY)	50194+91	50195+41	PUBLIC	TEMPORARY CONSTRUCTION PERMANENT
ALBANY COUNTY	GUILDERLAND		COUNTY LINE ROAD (EAST AND WEST BOUNDARY) COUNTY LINE ROAD (WEST)	50194+91	50195+41	PUBLIC	TEMPORARY CONSTRUCTION
ALBANY COUNTY	GUILDERLAND	142-15	MARTHA E. MASTERS	50195+41	50207+24	PRIVATE	TEMPORARY CONSTRUCTION
ALBANY COUNTY	GUILDERLAND	142-15	MARTHA E. MASTERS	50195+41	50200+12	PRIVATE	PERMANENT
ALBANY COUNTY	GUILDERLAND	142-15	MARTHA E. MASTERS	50203+17	50206+33	PRIVATE	PERMANENT
ALBANY COUNTY	GUILDERLAND	142-17	VICTOR DEPOALO	50207+24	50210+36	PRIVATE	TEMPORARY CONSTRUCTION
ALBANY COUNTY	GUILDERLAND	142-17	VICTOR DEPOALO	50207+24	50211+75	PRIVATE	PERMANENT
ALBANY COUNTY	GUILDERLAND	14-2-36.2	STEPHEN ZELENIAK	50235+93	50239+95	PRIVATE	TEMPORARY CONSTRUCTION
ALBANY COUNTY	GUILDERLAND	14-2-36.2	STEPHEN ZELENIAK	50251+41	50252+68	PRIVATE	TEMPORARY CONSTRUCTION

COUNTY	TOWN	PARCEL NUMBER	PROPERTY OWNER	STATION START	STATION END	OWNER TYPE	TYPE OF EASEMENT
ALBANY COUNTY	GUILDERLAND	14-2-36.2	STEPHEN ZELENIAK (EAST AND WEST BOUNDARY)	50251+41	50252+68	PRIVATE	PERMANENT
ALBANY COUNTY	GUILDERLAND	14-2-36.2	STEPHEN ZELENIAK	50251+41	50252+68	PRIVATE	TEMPORARY CONSTRUCTION (MUSTER
							AREA)
BANY COUNTY	GUILDERLAND		W. OLD STATE ROAD	50253+42	50253+91	PUBLIC	TEMPORARY CONSTRUCTION
BANY COUNTY	GUILDERLAND		W. OLD STATE ROAD (EAST AND WEST BOUNDARY)	50253+42	50253+91	PUBLIC	PERMANENT
LBANY COUNTY	GUILDERLAND	26.00-3-22	BRIAN E.MAKI (EAST AND WEST BOUNDARY)	50254+25	20256+41	PRIVATE	PERMANENT
ALBANY COUNTY	GUILDERLAND	26.00-3-22	BRIAN E.MAKI	50254+25	20256+41	PRIVATE	TEMPORARY CONSTRUCTION
LBANY COUNTY	GUILDERLAND	26.00-3-20.1	JAMES A. MOLLER (EAST AND WEST BOUNDARY)	50256+41	50257+87	PRIVATE	PERMANENT
LBANY COUNTY	GUILDERLAND	26.00-3-20.1	JAMES A. MOLLER	50256+41	50261+91	PRIVATE	TEMPORARY CONSTRUCTION
LBANY COUNTY	GUILDERLAND	26.00-3-20.1	JAMES A. MOLLER	50261+50	50261+91	PRIVATE	PERMANENT
ALBANY COUNTY	GUILDERLAND	26.00-3-19	DAVID R. RALSTON	50261+91	50263+50	PRIVATE	PERMANENT TEMPORARY CONCERNATION
ALBANY COUNTY	GUILDERLAND	26.00-3-19	DAVID R. RALSTON	50261+91	50267+98	PRIVATE	TEMPORARY CONSTRUCTION
ALBANY COUNTY	GUILDERLAND	26.00-3-34	ROBERT DUNCAN	50280+39	50299+71	PRIVATE	TEMPORARY CONSTRUCTION
ALBANY COUNTY	GUILDERLAND	26.00-3-34	ROBERT DUNCAN	50281+01	50283+95	PRIVATE	PERMANENT
ALBANY COUNTY	GUILDERLAND	26.00-3-34 26.00-3-34	ROBERT DUNCAN	50290+25	50298+64	PRIVATE	PERMANENT TEMPORARY CONSTRUCTION
ALBANY COUNTY ALBANY COUNTY	GUILDERLAND GUILDERLAND	26.00-3-34	ROBERT DUNCAN EIGHTY FOUR PROPERTIES, LLC	50297+40 50301+00	50299+70 50303+00	PRIVATE PRIVATE	TEMPORARY CONSTRUCTION PERMANENT
ALBANY COUNTY	GUILDERLAND	26.00-3-35	EIGHTY FOUR PROPERTIES, LLC	50299+71	50307+05	PRIVATE	TEMPORARY CONSTRUCTION
			EIGHTY FOUR PROPERTIES, LLC				TEMPORARY CONSTRUCTION (ACCESS
ALBANY COUNTY	GUILDERLAND	26.00-3-35	EIGHTY FOUR PROPERTIES, LLC	50304+48	50305+03	PRIVATE	,
ALBANY COUNTY	GUILDERLAND	26.00-3-35		50305+88	50308+78	PRIVATE	PERMANENT
ALBANY COUNTY	GUILDERLAND	78.00.4.0	ROUTE 20 — WESTERN TURNPIKE	50308+78	50309+66	PUBLIC	PERMANENT
ALBANY COUNTY	GUILDERLAND	38.00-4-9	CRISTO DEMOLITIONS LLC	50308+96	50309+56	PRIVATE	TEMPORARY CONSTRUCTION (ACCESS
ALBANY COUNTY	GUILDERLAND	38.00-4-9	CRISTO DEMOLITIONS LLC	50310+21 50310+61	50359+75	PRIVATE	TEMPORARY CONSTRUCTION
ALBANY COUNTY	GUILDERLAND	38.00-4-9	CRISTO DEMOLITIONS LLC	50310+61 50335+69	50311+57	PRIVATE	PERMANENT TEMPORARY CONSTRUCTION
ALBANY COUNTY	GUILDERLAND	39.00.4.0	FULLER STATION ROAD CRISTO DEMOLITIONS INC	50335+69 50338+38	50336+90	PUBLIC	TEMPORARY CONSTRUCTION
ALBANY COUNTY ALBANY COUNTY	GUILDERLAND GUILDERLAND	38.00-4.9 26.00-4-3	CRISTO DEMOLITIONS INC WATERVLIET WATER BOARD	50338+38 50364+33	50348+53 50368+54	PRIVATE PRIVATE	PERMANENT TEMPORARY CONSTRUCTION
				+			
ALBANY COUNTY	GUILDERLAND	38.00-5-12	TOWN OF GUILDERLAND	50368+54	50371+18	PRIVATE	TEMPORARY CONSTRUCTION (ACCESS
ALBANY COUNTY	GUILDERLAND	38.00-5-13	TOWN OF GUILDERLAND	50371+18	50375+47	PRIVATE	TEMPORARY CONSTRUCTION (ACCESS
ALBANY COUNTY	GUILDERLAND		FRENCH MILLS ROAD	50377+66	50378+16	PUBLIC	PERMANENT
ALBANY COUNTY	GUILDERLAND		FRENCH MILLS ROAD (EAST)	50377+66	50378+16	PUBLIC	TEMPORARY CONSTRUCTION
ALBANY COUNTY	GUILDERLAND		FRENCH MILLS ROAD (WEST)	50377+66	50378+16	PUBLIC	TEMPORARY CONSTRUCTION
ALBANY COUNTY	GUILDERLAND	38.00-5-14	TOWN OF GUILDERLAND	50378+53	50384+83	PRIVATE	TEMPORARY CONSTRUCTION (ACCESS
ALBANY COUNTY	GUILDERLAND		STATE ROUTE 146	50393+06	50394+20	PUBLIC	PERMANENT
ALBANY COUNTY	GUILDERLAND	50.00-1-15	TOWN OF GUILDERLAND	50394+77	50396+68	PRIVATE	PERMANENT
ALBANY COUNTY	GUILDERLAND	50.00-1-14.11	NORTHEASTERN IP HOLDINGS INC	50396+68	50445+46	PRIVATE	PERMANENT
ALBANY COUNTY	GUILDERLAND	50.00-1-14.11	NORTHEASTERN IP HOLDINGS INC	50398+15	50404+69	PRIVATE	TEMPORARY CONSTRUCTION
ALBANY COUNTY	GUILDERLAND		VAN BUREN BLVD	50398+15	50404+69	PUBLIC	TEMPORARY CONSTRUCTION
ALBANY COUNTY	GUILDERLAND	50.00-1-14.11	NORTHEASTERN IP HOLDINGS INC	50399+12	50409+89	PRIVATE	TEMPORARY CONSTRUCTION
ALBANY COUNTY	GUILDERLAND	50.00-1-14.11	NORTHEASTERN IP HOLDINGS INC	50407+63	50409K75	PRIVATE	TEMPORARY CONSTRUCTION
ALBANY COUNTY	GUILDERLAND	50.00-1-14.11	NORTHEASTERN IP HOLDINGS INC	50421+94	50442+90	PRIVATE	TEMPORARY CONSTRUCTION
ALBANY COUNTY	GUILDERLAND	50.00-1-14.11	NORTHEASTERN IP HOLDINGS INC	50421+94	50445+46	PRIVATE	TEMPORARY CONSTRUCTION
ALBANY COUNTY	GUILDERLAND	50.00-1-14.11	NORTHEASTERN IP HOLDINGS INC	50422+27	50444+80	PRIVATE	TEMPORARY CONSTRUCTION (ACCES
ALBANY COUNTY	GUILDERLAND	50.00-1-14.21	NORTHEASTERN IP HOLDINGS INC	50445+45	50467+43	PRIVATE	TEMPORARY CONSTRUCTION (ACCESS
ALBANY COUNTY	GUILDERLAND	50.00-1-14.21	NORTHEASTERN IP HOLDINGS INC	50445+45	40457+52	PRIVATE	PERMANENT
ALBANY COUNTY	GUILDERLAND	50.00-1-14.21	NORTHEASTERN IP HOLDINGS INC	50468+98	50473+30	PRIVATE	TEMPORARY CONSTRUCTION
ALBANY COUNTY	GUILDERLAND	50.00-1-14.21	NORTHEASTERN IP HOLDINGS INC	50485+04	50488+86	PRIVATE	TEMPORARY CONSTRUCTION
ALBANY COUNTY	GUILDERLAND		STONE ROAD (EAST)	50501+94	50502+54	PUBLIC	TEMPORARY CONSTRUCTION
ALBANY COUNTY	GUILDERLAND		STONE ROAD	50501+94	50502+54	PUBLIC	PERMANENT
ALBANY COUNTY	GUILDERLAND		STONE ROAD (WEST)	50501+94	50502+54	PUBLIC	TEMPORARY CONSTRUCTION
ALBANY COUNTY	GUILDERLAND	61.00-1-22	RANDY J.DAVIS	50502+44	50506+19	PRIVATE	TEMPORARY CONSTRUCTION
ALBANY COUNTY	GUILDERLAND	61.00-1-23	ALICIA L. MCNALLY	50506+19	50507+57	PRIVATE	TEMPORARY CONSTRUCTION
ALBANY COUNTY	GUILDERLAND	61.00-1-26.2	GUILDERLAND AND SELF STORAGE INC	50507+57	50511+03	PRIVATE	TEMPORARY CONSTRUCTION
ALBANY COUNTY	GUILDERLAND	61.00-1-26.3	HELDEBURG ROOF CONSLTANTS LLC	50516+58	50520+96	PRIVATE	TEMPORARY CONSTRUCTION
ALBANY COUNTY	GUILDERLAND	61.00-1-26.3	HELDEBURG ROOF CONSLTANTS LLC	50518+00	50520+00	PRIVATE	PERMANENT
ALBANY COUNTY	GUILDERLAND	61.00-1-28.2	JEFFERY LAWYER	50540+64	50544+36	PRIVATE	TEMPORARY CONSTRUCTION
ALBANY COUNTY	NEW SCOTLAND	61.00-3-16.1	FARLIN CORPARATION	50549+59	50551+17	PRIVATE	TEMPORARY CONSTRUCTION (ACCES
ALBANY COUNTY	NEW SCOTLAND	61.19-2-2	EW THOMPKINS CO. INC.	50559+88	50560+55	PRIVATE	PERMANENT
ALBANY COUNTY	NEW SCOTLAND	61.19-2-2	EW THOMPKINS CO. INC.	50569+51	50541+47	PRIVATE	PERMANENT
ALBANY COUNTY	NEW SCOTLAND		FOUNDARY ROAD	50573+25	50578+69	PUBLIC	TEMPORARY CONSTRUCTION
ALBANY COUNTY	NEW SCOTLAND	61.18-4-1.1	NORFOLK SOUTHERN RIALWAY CO.	50582+95	50585+26	PRIVATE	PERMANENT
ALBANY COUNTY	NEW SCOTLAND	61.18-4-1.1	NORFOLK SOUTHERN RIALWAY CO.	50585+19	50585+97	PRIVATE	TEMPORARY CONSTRUCTION (MUSTAGEA)
							TEMPORARY CONSTRUCTION (MUS
ALBANY COUNTY	NEW SCOTLAND	72.8-3-1	VILLAGE OF VOORHEESVILLE	50585+19	50586+31	PRIVATE	AREA)
ALBANY COUNTY	NEW SCOTLAND	61.18-4-1.1	NORFOLK SOUTHERN RIALWAY CO.	50585+26	50585+97	PRIVATE	PERMANENT
ALBANY COUNTY	NEW SCOTLAND		VOORHEESVILLE AVE	50596+35	50596+53	PRIVATE	TEMPORARY CONSTRUCTION
ALBANY COUNTY	NEW SCOTLAND	72.8–1–7.2	UNITED STATES POSTAL SERVICE	50596+53	50598+70	PRIVATE	TEMPORARY CONSTRUCTION
ALBANY COUNTY	NEW SCOTLAND	72.8–1–7.1	MARK CROUNSE	50596+53	50600+62	PRIVATE	TEMPORARY CONSTRUCTION
ALBANY COUNTY	NEW SCOTLAND	72.8–1–38	JOHN LE SEMENICK	50603+76	50605+37	PRIVATE	PERMANENT
ALBANY COUNTY	NEW SCOTLAND	72.8–1–26	ROBERT B. KAUS	50605+37	50608+52	PRIVATE	PERMANENT
ALBANY COUNTY	NEW SCOTLAND	72.12-3-1	JASON GARDNER	50607+03	50608+52	PRIVATE	PERMANENT
ALBANY COUNTY	NEW SCOTLAND		MAPLE ROAD	50608+52	50609+60	PUBLIC	PERMANENT
ALBANY COUNTY	NEW SCOTLAND	72.12-4-1	MAPLE TOV, LLC	50609+60	50611+49	PRIVATE	PERMANENT
ALBANY COUNTY	NEW SCOTLAND	72.12-4-2	MAPLE TOV, LLC	50611+49	50614+27	PRIVATE	PERMANENT
	55512/11/0	,	,	1 33311113	00011121		I EINMANTELLI

TABLE 4-4 - FACILITY ROW OWNERSHIP FOR SEGMENT 8





FOR EMCP REVIEW **NOT FOR CONSTRUCTION** IT IS A VIOLATION OF LAW FOR ANY PERSON, UNLESS THEY ARE ACTING UNDER THE DIRECTION OF A LICENSED PROFESSIONAL ENGINEER, ARCHITECT, LANDSCAPE ARCHITECT OR LAND SURVEYOR TO ALTER AN ITEM IN ANY WAY. IF AN ITEM BEARING THE STAMP OF A LICENSED PROFESSIONAL IS ALTERED, THE ALTERING ENGINEER, ARCHITECT, LANDSCAPE ARCHITECT OR LAND SURVEYOR SHALL STAMP THE DOCUMENT AND INCLUDE THE NOTATION "ALTERED BY" FOLLOWED BY THEIR SIGNATURE, THE DATE OF SUCH ALTERATION, AND A SPECIFIC DESCRIPTION OF THE ALTERATION.

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						SE
	E	12/16/2022	FINAL SUBMISSION	BV	TK	
	D	11/11/2022	DRAFT FINAL SUBMISSION	BV	TK	
[С	06/06/2022	60% DESIGN SUBMISSION	BV	TK	
	В	02/11/2022	PRELIMINARY DESIGN DEVELOPMENT	BV	TK	
	Α	01/24/2022	PRELIMINARY PROGRESS	BV	TK	
	No.	DATE	SUBMITTAL / REVISION DESCRIPTION	DB	APP	DR

CHAMPLAIN HUDSON POWER EXPRESS SEGMENT 8 (PACKAGE 5A) - CSX: ROTTERDAM - BETHLEHEM **EM-CP DATA TABLES**

21162 DRAWING NO.

KIEWIT PROJECT NO.

G-010

DRAWN BY: AR DESIGNED BY: BV APPROVED BY: TK REV. NO.

PARCEL NUMBER

72.12-4-6

COUNTY

ALBANY COUNTY

TOWN

NEW SCOTLAND

TABLE 4-4. FACILITY ROW OWNERSHIP FOR SEGMENT 8

PROPERTY OWNER

DIANE SCHIPANO

STATION START

50615+51

STATION END

50616+80

OWNER TYPE

PRIVATE

TYPE OF EASEMENT

TEMPORARY CONSTRUCTION (ACCESS RD)

TABLE 5-2. CONSTRUCTION MATERIAL	LS AND EQUIPMEN' AREAS	T STAGING LOCATIONS AND WORK
STAGING AREA/WORK AREA	SHEET	LOCATION (APPROXIMATE -SEE APPENDIX C FOR FURTHER DETAILS)
HDD 71 ENTRY WORK AREA	C-101	STA 50005
HDD 71 EXIT WORK AREA	C-102	STA 50024
HDD 72 ENTRY WORK AREA	C-103	STA 50043
HDD 72 EXIT WORK AREA	C-104	STA 50049
POTENTIAL MUSTER SITE	C-105	STA 50063
HDD 73 ENTRY WORK AREA	C-105	STA 50065
HDD 73 EXIT WORK AREA	C-105	STA 50070
HDD 73.A AND 74 ENTRY WORK AREA	C-107	STA 50100
POTENTIAL MUSTER SITE	C-108	STA 50119
HHD 73.A AND 74 EXIT WORK AREA	C-109	STA 50120
HDD 75 ENTRY WORK AREA	C-110	STA 50145
HDD 75 EXIT WORK AREA	C-111	STA 50154
HDD 75.A.A ENTRY WORK AREA	C-112	STA 50166
HDD 75.A.A EXIT WORK AREA	C-112	STA 50177
HDD 75.A ENTRY WORK AREA	C-115	STA 50210
HDD 75.A EXIT WORK AREA	C-116	STA 50234
HDD 75.B ENTRY WORK AREA	C-120	STA 50289
HDD 75.B EXIT WORK AREA	C-120	STA 50298
HDD 76 AND 76.A ENTRY WORK AREA	C-121	STA 50306
HDD 76 AND 76.A EXIT WORK AREA	C-122	STA 50328
HDD 77 ENTRY WORK AREA	C-123	STA 50333
HDD 77 EXIT WORK AREA	C-124	STA 50347
HDD 78 ENTRY WORK AREA	C-126	STA 50382
HDD 78 EXIT WORK AREA	C-127	STA 50399
HDD 79.B ENTRY WORK AREA	C-128	STA 50409
HDD 79.B EXIT WORK AREA	C-129	STA 50422
HDD 80 ENTRY WORK AREA	C-130	STA 50441
HDD 80 EXIT WORK AREA	C-131	STA 50462
HDD 80.A ENTRY WORK AREA	C-137	STA 50549
HDD 80.A EXIT WORK AREA	C-139	STA 50572
HDD 81 ENTRY WORK AREA	C-139	STA 50577
HDD 81 EXIT WORK AREA	C-140	STA 50589
HDD 82 AND 83 ENTRY WORK AREA	C-140	STA 50598
HDD 82 AND 83 EXIT WORK AREA	C-142	STA 50616
HDD 83.A ENTRY WORK AREA	C-145	STA 50673
HDD 83.A EXIT WORK AREA	C-146	STA 50680
HDD 84 ENTRY WORK AREA	C-146	STA 50687
HDD 84 EXIT WORK AREA	C-147	STA 50698
HDD 84.A ENTRY WORK AREA	C-149	STA 50728
HDD 84.A EXIT WORK AREA	C-150	STA 50739
HDD 84.B ENTRY WORK AREA	C-152	STA 50777
HDD 84.B EXIT WORK AREA	C-153	STA 50788
HDD 85 ENTRY WORK AREA	C-154	STA 50806
HDD 85 EXIT WORK AREA	C-155	STA 50824
HDD 87 ENTRY WORK AREA	C-156	STA 50830
HDD 87 EXIT WORK AREA	C-157	STA 50844
HDD 87.A.A ENTRY WORK AREA	C-160	STA 50890
HDD 87.A.A EXIT WORK AREA	C-160	STA 50897

ACCESS ROAD/ROUTE NUMBER	TEMPORARY OR PERMANENT	SHEET	LOCATION (APPROXIMATE -SEE DRAWINGS FOR DETAILS)	SENSITIVE AREAS CROSSED (AG OR WETLANDS)
5A-01-RD	TEMPORARY	C-202	STA 50041	NONE
5A-03-RD	TEMPORARY	C-203	STA 50149	WETLAND
5A-04-RD	TEMPORARY	C-203	STA 50253	NONE
5A-05-RD	TEMPORARY	C-204 TO C-206	STA 50345	WETLAND
5A-06-RD	TEMPORARY	C-207	STA 50333	NONE
5A-07-RD	TEMPORARY	C-207	STA 50365	NONE
5A-08-RD	TEMPORARY	C-208	STA 50371	NONE
5A-09-RD	TEMPORARY	C-208	STA 50473	WETLAND
5A-10-RD	TEMPORARY	C-209	STA 50550	AGRICULTURE
5A-11-RD	TEMPORARY	C-209	STA 50648	WETLAND
5A-13-RD	TEMPORARY	C-210	STA 50807	NONE
5A-14-RD	TEMPORARY	C-211	STA 50829	NONE
5A-15-RD	TEMPORARY	C-211	STA 50843	NONE
5A-01-RTE	TEMPORARY	C-212	STA 50057	NONE
5A-02-RTE	TEMPORARY	C-212	STA 50064	NONE
5A-03-RTE	TEMPORARY	C-213	STA 50084	NONE
5A-04-RTE	TEMPORARY	C-214	STA 50305	NONE
5A-06-RTE	TEMPORARY	C-215	STA 50383	NONE
5A-07-RTE	TEMPORARY	C-216	STA 50443	NONE
5A-08-RTE	TEMPORARY	C-217 THROUGH C-219	STA 50473	NONE
5A-09-RTE	TEMPORARY	C-220	STA 50550	NONE
5A-10-RTE	TEMPORARY	C-221	STA 50616	NONE
5A-11-RTE	TEMPORARY	C-222	STA 50698	NONE
5A-12-RTE	TEMPORARY	C-223	STA 50898	NONE

TABLE 4-5 SUMMARIZES THE ACCESS ROADS IN THIS PACKAGE AND THEIR ASSOCIATED IMPACTS ON ENVIRONMENTALLY SENSITIVE AREAS AND AGRICULTURAL LANDS IF APPLICABLE. SECTION 4.10 OF THE EM&CP SUMMARIZES THE PROCEDURES THAT WILL BE FOLLOWED FOR THE CONSTRUCTION OF ALL ACCESS ROADS. ALL ACCESS ROADS WILL BE TEMPORARY AND RESTORED ACCORDING TO SECTION 14.2.4 AND 14.4.1 OF THE EM&CP AS APPLICABLE.

SEGMENT 8 - AGRICULTURAL LANDS

			SEGMENT 8 AGRICULTUI	RAL LANDS
AGRICULTURAL LAND DESCRIPTION	PARCEL NUMBER	PLAN AND PROFILE (APPENDIX C) SHEET NUMBER	STATION (APPROXIMATE -SEE APPENDIX C FOR DETAILS)	ANTICIPATED IMPACTS TO AGRICULTURAL ACTIVITIES/LAND
AGRICULTURAL LAND #1	26.00-3-18	C-118 AND C-119	STA 50268+50 TO 50270+96	THE TRENCH CONSTRUCTION IS OUTSIDE OF THE REGULATED AGRICULTURAL AREA. GRADING WILL ONLY IMPACT THE EDGE OF THE AGRICULTURAL FIELD. ALL BMPS OUTLINED IN SECTION 7.1 AND RESTORATION REQUIREMENTS IN SECTION 14.5 WILL BE FOLLOWED.
AGRICULTURAL LAND #2	26.00-3-34	C-119 AND C-120	STA 50282+62 TO 50291+06	THE TRENCH CONSTRUCTION WILL ONLY IMPACT THE EDGE OF THE AGRICULTURAL FIELD. THE AGRICULTURAL TRENCH DETAIL ON SHEET C-621 WILL BE UTILIZED. ALL BMPS OUTLINED IN SECTION 7.1 AND RESTORATION REQUIREMENTS IN SECTION 14.5 WILL BE FOLLOWED.
AGRICULTURAL LAND #3	61.00-1-26.3	C-135	STA 50514+57 TO 50521+83	THE TRENCH CONSTRUCTION WILL ONLY IMPACT THE EDGE OF THE AGRICULTURAL FIELD. SPLICE LOCATION 171 WILL REMAIN AS CLOSE TO THE EDGE OF THE FIELD AS POSSIBLE. TOPSOIL WILL BE STRIPPED, AND THE AREA WILL BE GRAVELED. ALL BMPS OUTLINED IN SECTION 7.1 AND RESTORATION REQUIREMENTS IN SECTION 14.5 WILL BE FOLLOWED.
AGRICULTURAL LAND #4	61.00-1-29 AND 61.00-3-16.1	C-137	STA 50546+83 TO 50553+26	A VERY SMALL PORTION OF AN HDD WORK AREA IS WITHIN THE REGULATED AGRICULTURAL AREA. TEMPORARY ACCESS ROAD 5A-10-RD WILL UTILIZE TOPSOIL STRIPPING AND GRAVELLING. ALL BMPS OUTLINED IN SECTION 7.1 AND RESTORATION REQUIREMENTS IN SECTION 14.5 WILL BE FOLLOWED.
AGRICULTURAL LAND #5	72.00-3-41.51	C-144	STA 50647+60 TO 50667+64	THE TRENCH CONSTRUCTION WILL ONLY IMPACT THE EDGE OF THE AGRICULTURAL FIELD. SPLICE LOCATION 176 WILL REMAIN AS CLOSE TO THE EDGE OF THE FIELD AS POSSIBLE. THE ACCESS ROAD COMING INTO THIS PORTION WILL BE STRIPPED AND GRAVELED. ALL BMPS OUTLINED IN SECTION 7.1 AND RESTORATION REQUIREMENTS IN SECTION 14.5 WILL BE FOLLOWED.
AGRICULTURAL LAND #6	84.00-1-44.2 95.00-3-1.1	C-151 AND C-152	STA 50754+54 TO 50772+91	ALL TRENCHING OCCURS OUTSIDE THE REGULATED AGRICULTURAL AREA. SPLICE LOCATION 180 WILL REMAIN AS CLOSE TO THE EDGE OF THE FIELD AS POSSIBLE. ALL BMPS OUTLINED IN SECTION 7.1 AND RESTORATION REQUIREMENTS IN SECTION 14.5 WILL BE FOLLOWED.
AGRICULTURAL LAND #7	95.00-3-5 95.00-3-42	C-154	STA 50797+20 TO 50806+55	A TEMPORARY WORK AREA WILL BE THE ONLY IMPACT TO THE REGULATED AGRICULTURAL AREA AND WILL BE GRAVELED. SPLICE LOCATION 181 WILL REMAIN AS CLOSE TO THE EDGE OF THE FIELD AS POSSIBLE. ANY GRADING WILL FOLLOW ALL BMPS OUTLINED IN SECTION 7.1 AND RESTORATION REQUIREMENTS IN SECTION 14.5 WILL BE FOLLOWED.



ALBANY COUNTY

ALBANY COUNTY

ALBANY COUNTY

ALBANY COUNTY

ALBANY COUNTY

ALBANY COUNTY



FLACH PROPERTIES LLC

FLACH PROPERTIES LLC

FLACH PROPERTIES LLC

FLACH PROPERTIES LLC

FLACH PROPERTIES LLC (EAST AND WEST BOUNDARY)

FLACH PROPERTIES LLC

50885+15

50898+40

50898+40

50900+42

50900+54

50900+70

50886+87

50898+71

50898+71

50901+16

50901+16

50900+87

PRIVATE

PRIVATE

PRIVATE

PRIVATE

PRIVATE

PRIVATE

TEMPORARY CONSTRUCTION

TEMPORARY CONSTRUCTION (ACCESS RD

TEMPORARY CONSTRUCTION (ACCESS RD

TEMPORARY CONSTRUCTION (ACCESS RD

PERMANENT

TEMPORARY CONSTRUCTION

108.00-1-12

107.00-1-29

108.00-1-12

108.00-1-13

108.00-1-13

108.00-1-13

NEW SCOTLAND

NEW SCOTLAND

NEW SCOTLAND

BETHLEHEM

BETHLEHEM

NEW SCOTLAND

FOR EMCP REVIEW NOT FOR CONSTRUCTION T IS A VIOLATION OF LAW FOR ANY PERSON. UNLESS THEY ARE ACTING UNDER THE DIRECTION OF A LICENSED R LAND SURVEYOR TO ALTER AN ITEM IN ANY WAY. IF AN LTERED. THE ALTERING ENGINEER, ARCHITECT, LANDSCAPE RCHITECT OR LAND SURVEYOR SHALL STAMP THE DOCUMENT AND INCLUDE THE NOTATION "ALTERED BY" FOLLOWED BY THEIR SIGNATURE, THE DATE OF SUCH ALTERATION, AND A SPECIFIC DESCRIPTION OF THE ALTERATION.

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					SEGMENT 8	(PACKAG	E 5A)) - CSX: ROT	TER	DAM -
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D	11/11/2022	DRAFT FINAL SUBMISSION	BV	TK		EI	VI-CP	DATA TABL	.⊏ろ	
С	06/06/2022	60% DESIGN SUBMISSION	BV	TK						
В	02/11/2022	PRELIMINARY DESIGN DEVELOPMENT	BV	TK						
Α	01/24/2022	PRELIMINARY PROGRESS	BV	TK				_		
No.	DATE	SUBMITTAL / REVISION DESCRIPTION	DB	APP	DRAWN BY: AR	DESIGNED B	Y: BV	APPROVED BY:		SCALE REV. NO.

CHAMPLAIN HUDSON POWER EXPRESS EGMENT 8 (PACKAGE 5A) - CSX: ROTTERDAM - BETHLEHEM EM-CP DATA TABLES

G-011

KIEWIT PROJECT NO. 21162 DRAWING NO.

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FOLLOWED.

		<u>SEGMEN</u>	<u>T 8 - VEGETATION</u>
	TABLE 8-4 VEGETATION	AND TREE CLEARING LOCA	ATIONS
SHEET	LOCATION	CLEARING METHOD TYPE	ENVIRONMENTALLY SENSITIVI AREA(S)
	(APPROXIMATE -SEE APPENDIX C FOR DETAILS)		
C-101	STA 50000 TO 50007	TYPE I	NONE
C-102	STA 50022 TO 50030	TYPE I	NONE
C-103	STA 50030 TO 50041	TYPE IV	NONE
C-105	STA 50060 TO 50065	TYPE III	NONE
	STA 50069+50 TO 50075		
C-106	STA 50085 TO 50090	TYPE III	WETLAND
C-107	STA 50090	TYPE III	WETLAND (50090 TO 50090+50)
	STA 50095 TO 50101		
C-108	STA 50118+50	TYPE IV	NONE
C-109	STA 50122 TO 50135	TYPE IV	WETLAND
C-110	STA 50135 TO 50150	TYPE IV	WETLAND
C-111	STA 50153 TO 50165	TYPE I	WETLAND
C-112	STA 50165 TO 50180	TYPE IV	WETLAND
C-113	STA 50180 TO 50195	TYPE IV	WETLAND
C-114	STA 50195 TO 50210	TYPE IV	WETLAND (50198 TO 50200; 5020 TO 50205)
C-115	STA 50210 TO 50211	TYPE IV	NONE
C-116	STA 50233 TO 50240	TYPE IV	NONE
C-117	STA 50240 TO 50255	TYPE IV	WETLAND (50251; 50255)
C-118	STA 50255 TO 50269+50	TYPE I	WETLAND (50255 TO 50256; 50257+50 TO 50260+50)
C-119	STA 50270 TO 50285	TYPE IV	WETLAND (50271+50; 50278+50 50280; 50282+50)

TYPE IV

TYPE IV

TYPE I

TYPE IV

TYPE IV

TYPE IV

TYPE IV

TYPE IV

TYPE I

TYPE I

TYPE I

TYPE I

TYPE IV

TYPE I

TYPE I

TYPE I

TYPE IV

AGRICULTURAL LAND UNTIL 50291 WETLAND (50299+50 TO 50300)

WETLAND (50300 TO 50302)

WETLAND (50328)

WETLAND (50341 TO 50344+50)

WETLAND (50351 TO 50353+50) WETLAND (50366+50 TO 50367+50;

50375+50)

WETLAND (50379; 50384+50)

WETLAND

WETLAND

NONE

NONE

NONE

WETLAND

WETLAND WETLAND/REGULATED ADJACENT

AGRICULTURAL LAND (50514+57 TO

50521+83)

WETLAND (50510 TO 50520+50; 50523 TO 50525)

WETLAND (50525 TO 50527)

AGRICULTURAL LAND (50546+83)

NONE

NONE

NONE

NONE

WETLAND (50646 TO 50647+50)

AGRICULTURAL LAND (50659)

WETLAND (50665 TO 50667)

AGRICULTURAL LAND (50665 TO

50667)

WETLAND

WETLAND

STA 50285 TO 50288

STA 50292 STA 50297+50 TO 50300

STA 50300 TO 50302+50 STA 50307+50 STA 50310 TO 50315 STA 50327 TO 50330

STA 50330 TO 50345

STA 50345 TO 50360

STA 50360 TO 50360+50

STA 50364 TO 50375

STA 50375 TO 50379+50

STA 50384+50

STA 50399 TO 50401

STA 50409+50 TO 50410+50

STA 50422 TO 50435

STA 50435 TO 50443

STA 50461+50 TO 50465

STA 50465 TO 50480

STA 50480 TO 50495

STA 50495 TO 50502

SITAR 50503+50 TO 50510

STA 50510 TO 50525

STA 50525 TO 50540 STA 50540 TO 50547

> STA 50551 STA 50571+50

> > STA 50579

STA 50588 TO 50591

STA 50594 TO 50600

STA 50615 TO 50630

STA 50630 TO 50645

STA 50645 TO 50647+50

STA 50659 TO 50660

STA 50660 TO 50667+50

STA 50672 TO 50675

STA 50675 TO 50688

STA 50700 TO 50705

C-120

C-121

C-122 C-123

C-124

C-125

C-126

C-127

C-128

C-129

C-130

C-131

C-132

C-133

C-134

C-135

C-136

C-137

C-139

C-140

C-142

C-143

C-144

C-145

C-146

C-147

	TABLE 8-4 VEGETATION AND TREE CLEARING LOCATIONS								
SHEET	LOCATION	CLEARING METHOD TYPE	ENVIRONMENTALLY SENSITIVE AREA(S)						
C-148	STA 50705 TO 50720	TYPE IV	WETLAND						
C-149	STA 50720 TO 50731	TYPE IV	WETLAND (50720 TO 50725)						
	STA 50733 TO 50734								
C-150	STA 50736+50 TO 50738+50	TYPE I	WETLAND (50744 TO 50747+50)						
	STA 50744 TO 50750								
C-151	STA 50750 TO 50765	TYPE IV	WETLAND (50763+50 TO 50765)						
			AGRICULTURAL LAND (50754+54 TO 50765)						
C-152	STA 50765 TO 50780	TYPE IV	WETLAND (50765 TO 50771; 50772 TO 50773; 50776 TO 50779)						
			AGRICULTURAL LAND (50765 TO 50772+91)						
C-153	STA 50787+50 TO 50795	TYPE IV	NONE						
C-154	STA 50795 TO 50803+50	TYPE IV	WETLAND (50796 TO 50802)						
	STA 50807 TO 50810								
C-155	STA 50810 TO 50811	TYPE IV	NONE						
	STA 50823 TO 50825								
C-156	STA 50825 TO 50832	TYPE IV	NONE						
C-157	STA 50841+50 TO 50855	TYPE IV	NONE						
C-158	STA 50855 TO 50870	TYPE III	NONE						
C-159	STA 50870 TO 50885	TYPE IV	NONE						
C-160	STA 50885 TO 50900	TYPE IV	WETLAND (50898+50 TO 50900)						

<u>SEGMENT 8 - TREE AND VEGETATION DISPOSAL METHODS</u>

		TABLE 8.3 - TREE AND VEGETATION DISPOSAL METHODS
METHOD TYPE	METHOD TITLE	METHOD DESCRIPTION
TYPE A	CONSTRUCTION USE	LOGS MAY BE UTILIZED AS NEEDED DURING CONSTRUCTION FOR WETLAND ACCESS, CRIBBING, RETAINING WALLS, OR OTHER USES. FOLLOWING USE, ANY LOGS UNSUITABLE FOR FIREWOOD, SAW LOGS, OR CHIPPING WILL BE TRANSPORTED OFF THE RIGHT—OF—WAY TO AN APPROVED DISPOSAL SITE.
TYPE B	LOG PILES	LOGS NOT NEEDED FOR CONSTRUCTION WILL BE REMOVED FROM THE RIGHT-OF-WAY TO AN APPROVED DISPOSAL AREA.
TYPE C	SALE	WHERE SUFFICIENT MERCHANTABLE VOLUME EXISTS ON THE SITE, LOGS MAY BE SOLD TO A THIRD PARTY. WHERE APPROPRIATE AND PRACTICAL, AND WITH THE AGREEMENT OF LANDOWNERS, UNSOLD LOGS WILL BE HAULED TO ACCESSIBLE LOCATIONS FOR SALVAGE BY THE GENERAL PUBLIC IN ACCORDANCE WITH THE SUBSTANTIVE REQUIREMENTS OF 6 NYCRR PART 192.5, FIREWOOD RESTRICTIONS TO PROTECT FORESTS FROM INVASIVE SPECIES.
TYPE D	TREE/LOG CHIPPING	WHEN LOGS CANNOT BE REUSED OR SOLD, THEY WILL BE CHIPPED ON SITE. THE RESULTING WOOD CHIPS WI BE PILED IN UPLAND AREAS WITHIN THE RIGHT-OF-WAY OR TRANSPORTED OFF RIGHT-OF-WAY TO AN APPROVED DISPOSAL SITE. WOOD CHIPS WILL BE SPREAD THREE (3) TO FIVE (5) INCHES THICK WITH FERTILIZER SPREAD OVER THE CHIPS TO MINIMIZE SOIL NITROGEN DEPLETION DUE TO CELLULOSE DECOMPOSITION.
TYPE E	VEGETATION CHIPPING	VEGETATION MAY BE CHIPPED TO REDUCE DEBRIS VOLUME.
TYPE F	VEGETATION HAULING	VEGETATION AND STUMPS MAY BE HAULED TO A NYSDEC APPROVED LANDFILL OR OTHER SUITABLE OFF—SIT LOCATION WITH THE APPROVAL OF THE LANDOWNER AND ALL APPLICABLE PERMITTING AGENCIES.
TYPE G	VEGETATION BURIAL	STUMPS MAY BE BURIED ON THE RIGHT-OF-WAY WITH LANDOWNER AGREEMENT. THE BURIAL AREAS WILL B SUFFICIENTLY COMPACTED AND MONITORED AFTER CONSTRUCTION TO ASSURE THAT SETTLING DOES NOT OCCUR. WHERE SIGNIFICANT SETTLING AFTER CONSTRUCTION HAS BEEN IDENTIFIED BY THE CONSTRUCTION INSPECTOR ET. AL., FINISHED GRADE WILL BE RE-ESTABLISHED USING LOCALLY OBTAINED RUN-OF-BANK MATERIAL AND/OR TOPSOIL AND RE-SEEDED AS APPROPRIATE AS SPECIFIED IN SECTIONS 14.2. AREAS WHERE SIGNIFICANT AMOUNTS OF STUMP BURIAL OCCURS WILL BE NOTED ON AS-BUILT DRAWINGS, AND MONITORED FOR SETTLING DURING ROW CONDITION SURVEYS AND MAINTENANCE ACTIVITIES.

1. NOTE: SECTION 8.4 OF THE EM&CP SUMMARIZES THE TREE AND VEGETATION DISPOSAL PROCEDURES FOR THIS SEGMENT. NO BURNING OF ANY VEGETATIVE OR TREE DEBRIS IS PERMITTED WITHIN THE WORK AREAS OF THIS SEGMENT. ALL APPLICABLE NYSDEC REGULATIONS REGARDING INVASIVE SPECIES WILL BE FOLLOWED WHEN DISPOSING OF VEGETATION.

TABLE 8-1. TERMS AND DEFINITIONS FROM BMP DOCUMENT SECTION 5.2								
TERM	DEFINITION							
CLEARING	THE CUTTING AND PHYSICAL REMOVAL, EITHER BY HAND OR MECHANICAL MEANS, OF ALL VEGETATION FROM THE WORK AREA							
GRUBBING	THE MECHANICAL REMOVAL OF THE STUMP AND ROOT MASS OF FELLED WOODY VEGETATION							
SLASH	SHRUBS, SAPLINGS, AND TOPS OF TREES 4 INCHES IN DIAMETER OR LESS AT THE LARGE END FOR HARDWOOD AND 6 INCHES IN DIAMETER OR LESS AT THE LARGE END FOR SOFTWOODS.							
STUMPS	THE WOODY STEM AND FIBROUS ROOT MASS LEFT IN THE SOIL AFTER REMOVING THE TRUNK AT THE BUTT.							
TIMBER/LOGS	TRUNKS AND LIMBS GREATER THAN 6 INCHES IN DIAMETER AT THE SMALL END, WITH A MINIMUM 8-FOOT LENGTH.							

<u>SEGMENT 8 — RECREATIONAL AREAS</u>

TABLE 7-2 RECREATIONAL AREAS								
MUNICIPALITY	RECREATIONAL AREA	SHEET	LOCATION (APPROXIMATE -SEE DRAWINGS FOR DETAILS)					
VILLAGE OF VOORHEESVILLE	VOORHEESVILLE VILLAGE PARK	C-141	STA 50599 TO 50604					

<u>SEGMENT 8 - TREE AND VEGETATION CLEARING METHODS</u>

		TABLE 8.2 - TREE AND VEGETATION CLEARING METHODS
METHOD TYPE	Method Title	METHOD DESCRIPTION
TYPE I	HAND CUTTING (HC)	THIS METHOD EMPLOYS A HAND—HELD CHAIN SAW. IT IS SELECTIVE BUT IS SLOWER AND MORE EXPENSIVE THAN MOTORIZED MECHANICAL DEVICES. RESIDENTIAL AREAS, BUFFER ZONES, WETLANDS, AND HIGHWAY SCREENS ARE AREAS WHERE HAND CUTTING IS TYPICALLY PRESCRIBED.
TYPE II	MECHANICAL CLEARING MACHINE (HA)	THIS TERM USUALLY REFERS TO A MACHINE KNOWN AS THE HYDRO-AX OR KERSHAW MOWER. THIS MACHINE CAN CUT TREES UP TO TEN (10) INCHES IN DIAMETER AT THE RATE OF SEVERAL ACRES A DAY, DEPENDING ON STEM DENSITY AND TERRAIN. IT IS ESSENTIALLY NONSELECTIVE AND A GOOD DEVICE FOR CLEARING RIGHTS-OF-WAY THAT ARE COMPOSED OF YOUNG UNDESIRABLE SPECIES IN A RELATIVELY UNIFORM STAND.
TYPE III	MOWING	THIS TECHNIQUE IS PRIMARILY USED IN AREAS OF HERBACEOUS VEGETATION. TERRAIN MUST BE RELATIVELY FLAT WITH NO GULLIES OR ROCKS.
TYPE IV	MECHANICAL WHOLE—TREE FELLING EQUIPMENT	THIS METHOD ALLOWS CONTROLLED FELLING AND LOADING OF WHOLE TREES WHILE MINIMIZING DAMAGE TO ADJACENT TREES. WHERE VEGETATION IS CLEARED, EROSION AND SEDIMENT CONTROL MEASURES WILL BE INSTALLED AND MONITORED UNTIL THE TOPSOIL IS STABILIZED AND CAN SUPPORT GRASSY VEGETATION.

NOTE: TABLE 8.4.1 SUMMARIZES THE LOCATION AND CLEARING TYPE THAT WILL OCCUR WITHIN THIS PACKAGE. SECTION 8.0 AND 8.1 OF THE EM&CP SUMMARIZES THE CLEARING METHODS AND PROCEDURES FOR VEGETATION AND TREE CLEARING AND REMOVAL INCLUDING STANDARDS AND SPECIFICATIONS FOR CLEARING IN ENVIRONMENTALLY SENSITIVE AREAS.

- WETLANDS: SECTION 8.2.1 AND SECTION 9.1 OF THE EM&CP
- STREAM CROSSING: SECTION 8.2.1 AND SECTION 9.1 OF THE EM&CP.
- VISUALLY SENSITIVE AREAS SECTION 8.3.2 OF THE EM&CP AGRICULTURAL LANDS: SECTION 8.2.2 OF THE EM&CP.

<u>SEGMENT 8 - IMPACTS TO WATERBODIES</u>

			TABLE 3 1. 30	MMARY OF WATE	NOOD NOTS			
APPROXIMATE STATION	WATER-BODY NAME	NYSDEC CLASSIFICATION	WATERBODY FIELD ID	FLOW STATUS	AVOIDANCE AND MINIMIZATION MEASURE	DISTANCE OF SEPARATION FROM CULVERT (FEET)	PERMANENT ROW IMPACT (LF)	TEMPORARY CONSTRUCTION ROW IMPACT (L
50282+90	NA	UNMAPPED	S6	INTERMITTENT			14.4	50.6
50667+00	NA	C/C	AA	INTERMITTENT			_	94.2
50601+50	VLY CREEK	C/C(T)	AG	PERENNIAL	HDD		_	_
50582+25	NA	UNMAPPED	AJ	INTERMITTENT	HDD		_	_
50580+00	NA	c/c	AL	INTERMITTENT	HDD		_	_
50746+00	NA	C/C	CS1	INTERMITTENT			40.3	145.5
50731+20	NA	C/C	CS2	INTERMITTENT	HDD		_	_
50717+50	NA	UNMAPPED	CS3	INTERMITTENT			27	97.1
50160+30	NA	c/c	CS33	INTERMITTENT			13.3	40.3
50160+30	NA	C/C	CS33	INTERMITTENT			13.8	38.5
50875+50	NA	UNMAPPED	EDR STA	PERENNIAL			_	_
50832+90	NA	c/c	EDR STB	PERENNIAL			_	_
50818+15	NA	c/c	EDR STC	PERENNIAL	HDD		_	_
50814+50	NA	UNMAPPED	EDR STD	PERENNIAL	HDD		_	_
50780+30	NA	c/c	EDR STE	PERENNIAL	HDD		_	_
50414+50	BLACK CREEK	c/c	G-R-S-A	PERENNIAL	HDD		_	_
50476+50	NA	UNMAPPED	G-R-S-B	INTERMITTENT			16.3	59.3
50487+80	NA	UNMAPPED	G-R-S-C	INTERMITTENT			_	_
50110+60	NA	UNMAPPED	G-R-S-D	INTERMITTENT	HDD		_	_
50125+50	NA	C/C(T)	G-R-S-E	PERENNIAL			37.6	163.9
50362+00	NORMANS KILL	В/В	NORMANS KILL	PERENNIAL	AVOIDED VIA BRIDGE ATTACH		_	-
50296+70	NA	c/c	P5-S1	INTERMITTENT	HDD		_	_
50294+15	NA	c/c	P5-S2	PERENNIAL	HDD		_	_
50270+20	NA	UNMAPPED	P5-S5	PERENNIAL	PARTIAL AVOIDANCE VIA HDD		38.2	3822.5
50321+50	NA	D/D	P5-SD	INTERMITTENT	HDD		_	_
50219+20	NA	C/C	S1	PERENNIAL	HDD		_	_
50014+00	POENTIC KILL	B/B	S1A	PERENNIAL	HDD		_	_
50225+35	NA	C/C	S2	INTERMITTENT	HDD		_	_
50230+25	NA	UNMAPPED	S3	INTERMITTENT	HDD		_	_
50251+10	NA	c/c	S4	INTERMITTENT			27	92.3
50270+50	NA	c/c	S5	PERENNIAL	CONTAINED IN CULVERT	9.92	_	_
50282+30	NA	UNMAPPED	S6	INTERMITTENT	CONTAINED IN CULVERT	6.52	_	_
50689+20	NA	UNMAPPED	Т	INTERMITTENT	HDD		_	_
50676+00	NA	UNAMPPED	U	INTERMITTENT	PARTIAL AVOIDANCE VIA HDD		193.9	150.6
50676+00	NA	C/C	V	PERENNIAL	HDD		_	_
50692+25	NA	UNMAPPED	Y	INTERMITTENT	HDD		_	_
TOTAL							421.8 LF	4,754.8 LF

CHPE WKiewit **Power Express**



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					SEGMENT 8 (PACKAGE 5A) - CSX: ROTTERDAM -
E	12/16/2022	FINAL SUBMISSION	BV	TK	
D	11/11/2022	DRAFT FINAL SUBMISSION	BV	TK	EM-CP DATA TABLES
С	06/06/2022	60% DESIGN SUBMISSION	BV	TK	
В	02/11/2022	PRELIMINARY DESIGN DEVELOPMENT	BV	TK	
Α	01/24/2022	PRELIMINARY PROGRESS	BV	TK	
No.	DATE	SUBMITTAL / REVISION DESCRIPTION	DB	APP	SCALE SCALE
140.	DAIL	SODIVITIAL/ NEVISION DESCRIPTION	00	711	DRAWN BY: AR DESIGNED BY: BV APPROVED BY: TK REV. NO.

KIEWIT PROJECT NO. CHAMPLAIN HUDSON POWER EXPRESS SEGMENT 8 (PACKAGE 5A) - CSX: ROTTERDAM - BETHLEHEM EM-CP DATA TABLES

DRAWING NO.

G-012

21162

AS SHOWN DATE E SH.NO.

		_					_
SEGMENT	8	_	11	<u>MPACTS</u>	TO	WETL	_

		Table 9-2	2 Summary of	f Wetland Imp	pacts		
Wetland ID	Wetland Community Type	Drawing Approximate Station (Appendix C)	Jurisdiction	Permanent ROW Impacts (square feet)	Temporary Construction Impacts (square feet)	Temporary State Regulated Adjacent Area Impacts (square feet)	Permanen t State Regulated Adjacent Area Impacts (square feet)
A-1	PEM	50897+00	USACE	685.6	9,626.40	_	_
AA	PEM	50397+00	USACE		2,553.50	_	_
CA	PEM	50503+00	USACE	20,105.00	35,401.30	_	_
CH	PEM	50145+00	USACE	1,267.30	10,460.50	_	_
СН	PSS	50145+00	USACE	960.2	16,330.50	_	_
CI	PEM	50160+00	USACE	905.6	2,361.60	_	_
CI	PSS	50160+00	USACE	1,485.60	3,153.50	_	_
CJ	PEM	50164+00	USACE	3,822.00	12,636.60	_	_
СК	PEM	50172+00	USACE	2,730.20	11,876.60	_	_
СК	PFO	50172+00	USACE	19,250.20	72,177.50	_	_
СК	PSS	50172+00	USACE	_	66.6	_	_
СМ	PEM	50772+75	USACE & NYSDEC (C-5)	510.4	1,261.40	9,970.90	2,763.00
CN	PEM	50769+00	USACE & NYSDEC (C-5)	1,503.10	4,544.40	14,586.10	2,666.00
CO	PEM	50765+00	USACE &		2,604.60	_	_
СР	PEM	50764+00	NYSDEC (C-5)	1,860.60	14,755.70	42,521.70	3,429.90
CQ	PEM	50761+00	USACE	-	2,822.50	_	_
CR	PEM	50742+00	USACE & NYSDEC (C-5)	3,667.90	18,203.90	54,902.70	4,278.00
CR	PFO	50742+00	USACE & NYSDEC (C-5)	1,082.20	5,346.90	_	_
CS	PEM	50700+00	USACE	12,154.00	52,402.90	_	_
CS	PFO	50700+00	USACE	11,501.70	36,773.50	_	_
DA	PEM	50523+00	USACE	5,299.40	15,918.90	_	_
EA	PEM	50554+00	USACE	_	_	_	_
EDR A	PEM	50889+50	USACE	_	_	_	_
EDR C	PEM	50867+00	USACE	_	-	_	_
EDR D	PSS	50862+00	USACE	-	_	_	_
EDR E	PEM	50861+00	USACE	-	_	_	_
EDR F	PEM	50841+00	USACE	-	_	_	_
EDR G	PEM	50834+50	USACE	-	-	_	_
EDR H	PF0	50800+00	USACE	1,753.50	3,223.90	_	_
EDR H	PSS	50800+00	USACE	567.2	705.6	_	_
EDR I EDR K	PF0	50796+00	USACE	869.8	20,935.50	_	_
EDR K EDR-L	PEM PSS	50777+00 50768+50	USACE USACE	130.1	169	_	_
FA-AC	PEM	50646+00	USACE	3,289.10	4,459.40	_	_
FA-AK	PSS	50580+50	USACE	-	-,,.55.15	_	_
FA-AM	PSS	50579+00	USACE	_	_	_	_
FA-FN	PEM	50252+00	USACE	523.3	9,579.10	_	_
FA-FN	PSS	50252+00	USACE	1,343.20	8,037.60	_	_
FA-W	PEM	50676+50	USACE	_	_	_	_
FA-Z	PEM	50665+25	USACE	758.3	2,351.10	_	_
GCI	PFO	50159+00	USACE	_	386.8	_	_
GPI_99	PSS	50233+00	USACE	147.7	28,257.00	_	_
G-R-A	PEM	50468+00	USACE NYSDEC (V19)	28,307.70	78,668.20	_	_
G-R-A	PFO	50468+00	USACE NYSDEC (V19)	600.4	5,630.30	_	_
G-R-B	PFO	50069+00	USACE	_	_	_	_
G-R-C	PFO	50087+00	USACE	318.4	10,455.60	_	_
G-R-D	PEM	50103+00	USACE	_	_	_	_
G-R-D	PF0	50103+00	USACE	- 40 555 53	_	_	_
G-R-E	PSS	50122+00	USACE	12,503.90	41,964.90	_	_
G-R-F	PF0	50135+00	USACE	2,912.10	10,077.10	_	_
G-R-G	PF0	50139+00	USACE	7,214.00	40,360.50	_	_
			· · · · · · · · · · · · · · · · · · ·	2,940.30	7,867.20	_	_
L M	PEM PSS	50198+00 50203+50	USACE USACE	1,364.20	5,332.20	_	_

		idble 9-2	Summary of	r wetiana imp	oacts		
Wetland ID	Wetland Community Type	Drawing Approximate Station (Appendix C)	Jurisdiction	Permanent ROW Impacts (square feet)	Temporary Construction Impacts (square feet)	Temporary State Regulated Adjacent Area Impacts (square feet)	Permane t State Regulate Adjacen Area Impacts (square feet)
N	PEM	50211+00	USACE	_	_	_	_
0	PEM	50230+00	USACE	_	_	_	_
Р	PEM	50255+00	USACE	1,034.00	2,724.10	_	_
P5-A	PSS	50297+00	USACE	_	_	_	_
P5A-B	PFO	50830+00	USACE	267.1	10,051.70	_	_
P5-B	PEM	50294+30	USACE	_	_	_	_
P5-C	PEM	50895+00	USACE	_	193.8	_	_
P5-D	PSS	50314+00	USACE	_	3,533.70	_	_
P5-DB	PEM	50095+00	USACE	_	357.1	_	_
P5–E	PFO	50316+00	USACE	_	11,204.00	_	_
P5–F	PEM	50326+50	USACE	_	5,959.30	_	_
P5-G	PSS	50331+00	USACE	_	859.7	_	_
P5-H	PSS	50333+00	USACE	_	2,178.70	_	_
P5-I	PEM	50334+00	USACE	_	4,291.00	_	_
P5-J	PEM	50339+00	USACE	_	1,228.90	_	_
P5-K	PEM	50318+00	USACE	_	_	_	_
P5-L	PUB	50322+50	USACE	_	_	_	_
P5-M	PSS	50324+50	USACE	_	_	_	_
P5-0	PSS	50835+00	USACE	_	_	_	_
P5-Q	PEM	50306+50	USACE	_	_	_	_
P5-Q2	PEM	50336+00	USACE	_	1,842.70	_	_
P5-V	PEM	50132-30	USACE	_	812.5	_	_
P5-W	PFO	50146+65	USACE	_	_	_	_
P5-X	PEM	50207+00	USACE	1,680.50	2,692.30	_	_
P5-X	PFO	50207+00	USACE	_	24,353.10	_	_
P5-Y	PFO	50096+50	USACE	_	1,289.30	_	_
Q	PEM	50258+00	USACE	3,395.70	9,362.60	_	_
R	PEM	50278+00	USACE	1,864.90	5,150.60	-	_
S	PEM	50299+50	USACE	787.4	4,428.90	_	_
SKETCHED DETENTION BASIN	PUB	50421+00	USACE	_	1,610.70	_	_
T	PSS	50327+60	USACE	_	538.1	_	_
U	PFO	50343+00	USACE	_	9,093.90	_	_
٧	PFO	50352+00	USACE	2,677.60	9,292.90	_	_
W	PEM	50366+50	USACE	463.4	4,680.00	_	_
Χ	PEM	50375+00	USACE	811.1	4,385.00	_	_
Υ	PEM	50378+50	USACE	459.2	1,413.70	_	_
Z	PEM	50386+00	USACE	_	94.4	_	_
Z	PUB TO	50386+00	USACE	- 167,775.1 (3.9 ACRES)	733,363 (16.8 ACRES)	- 323,849.1 (7.4 ACRES)	- 30,167.4 (0.7 ACRES)
	SUBTOT	AL PEM		100,826 (2.31 ACRES)	349,972.7 (8.03 ACRES)	323,849.1 (7.4 ACRES)	30,167.4 (0.7 ACRES)
	SUBTOT	AL PSS		18,502.1 (0.42 ACRES)	111,127.1 (2.55 ACRES)	_	_
	SUBTOT	AL PFO		48,447 (1.11 ACRES)	270,652.5 (6.21 ACRES)	_	_
	SUBTOT	AL PUB		_	1,610.7 (0.04 ACRES)	_	_

Table 9-2 Summary of Wetland Impacts

ALL DELINEATED WETLANDS ARE ANTICIPATED TO BE FEDERALLY JURISDICTIONAL UNDER SECTION 404 OF THE CLEAN WATER

SEGMENT 10 - THREATENED AND ENDANGERED SPECIES

F0.4			TABLE 9 3. RTE SPECIES IMPACT AVOIDAN	1		TIME OF VEAD
ESA TYPE	STA. START	STA. END	BMPS	CONTRACTOR ACTION	ENVIRONMENTAL INSPECTOR ACTIONS	TIME OF YEAR RESTRICTION
ESA 1	50217+50	50319+50	A) LOCATIONS OF NESTS WITHIN ONE—HALF (0.5) MILE OF CONSTRUCTION WILL BE IDENTIFIED. B) IF ANY BLASTING ACTIVITIES ARE NECESSARY WITHIN ONE—HALF (0.5) MILE OF ACTIVE NESTS, THE CERTIFICATE HOLDERS WILL CONTACT USFWS AND NYSDEC FOR GUIDANCE TO AVOID AND/OR MINIMIZE THE POTENTIAL FOR NOISE—RELATED DISTURBANCE; C) IF CONSTRUCTION WILL OCCUR WITHIN SIX HUNDRED AND SIXTY (660) FEET OF AN ACTIVE NEST DURING THE NEST—BUILDING OR BREEDING SEASON (JANUARY 1— SEPTEMBER 30), THE CERTIFICATE HOLDERS CONTACT USFWS AND NYSDEC FOR GUIDANCE TO AVOID AND/OR MINIMIZE THE POTENTIAL FOR NOISE—RELATED DISTURBANCE. D)ENVIRONMENTAL TRAINING FOR CONTRACTORS AND CONSTRUCTION CREWS WILL INCLUDE TRAINING ON THE IDENTIFICATION OF THE SPECIES AND LOCATION OF NESTS. CONSTRUCTION PERSONNEL WILL BE INSTRUCTED TO REPORT ANY SIGHTINGS OF POTENTIAL NESTS THAT WERE NOT PREVIOUSLY IDENTIFIED BY THE NYSDEC. E) IF ANY PREVIOUSLY UNIDENTIFIED NESTS ARE DISCOVERED, THE CERTIFICATE HOLDERS WILL REPORT FINDINGS TO THE NYSDEC AS SOON AS POSSIBLE AND CONSULT WITH THE NYSDEC AND USFWS FOR GUIDANCE TO AVOID AND/OR MINIMIZE THE POTENTIAL FOR DISTURBANCE.	1. ATTEND TRAINING PROVIDED BY ENVIRONMENT AL INSPECTOR ON THE IDENTIFICATIO N OF THE SPECIES AND THEIR NESTS.	1. LOCATION ANY NESTS WITHIN ONE—HALF (0.5) MILES OF CONSTRUCTION. 2. IF ANY BLASTING IS PLANNED TO OCCUR WITHIN ONE—HALF (0.5) MILES OF ACTIVE NESTS, CONTACT USFWS AND NYSDEC FOR GUIDANCE TO AVOID AND/OR MINIMIZES NOISE—RELATED DISTURBANCE. 3. CONTACT USFWS AND NYSDEC IF TIME OF YEAR RESTRICTION COMES INTO ACTION. 4. PROVIDE TRAINING FOR CONTRACTORS AND CONSTRUCTION CREWS AND INCLUDE TRAINING ON THE IDENTIFICATION OF THE SPECIES AND LOCATIONS OF NESTS THAT WERE NOT PREVIOUSLY IDENTIFIED BY THE NYSDEC. 5. REPORT ANY PREVIOUSLY UNIDENTIFIED NEST THAT IS DISCOVERED TO THE NYSDEC AS SOON AS POSSIBLE. CONSULT WITH USFWS AND NYSDEC FOR GUIDANCE ON HOW TO AVOID/MINIMIZE IMPACT.	IF CONSTRUCTION WILL OCCUR WITHIN SIX HUNDRED AND SIXTY (660) FEET O AN ACTIVE NEST DURING THE NEST—BUILDING OF BREEDING SEASON (JANUARY 1— SEPTEMBER 30), TH ENVIRONMENTAL INSPECTOR WILL CONTACT USFWS AN NYSDEC FOR GUIDANCE TO AVOID AND/OR MINIMIZE THE POTENTIAL FOR NOISE—RELATED DISTURBANCE.
ESA 9	50000+00	50899+34	(A) CONDUCT TREE CLEARING BETWEEN OCTOBER 31 AND MARCH 31. TREE CLEARING IS NOT ALLOWED BETWEEN APRIL 1 AND OCTOBER 30. (B) DURING THE RECONSTRUCTION SURVEY, THE CONTRACTORS WOULD IDENTIFY LARGE LIVE OR DEAD TREES WITH PEELING BARK, INCLUDING LARGE SPECIMENS OF SHAGBARK HICKORY (CARYA OVATA), WITH THE POTENTIAL TO SERVE AS MATERNITY OR ROOST TREES AND THESE WOULD BE MARKED. POTENTIAL ROOST TREES IDENTIFIED WITHIN THE CONSTRUCTION LIMITS WOULD BE AVOIDED WHERE POSSIBLE DURING CONSTRUCTION ACTIVITIES.	1. TREES IDENTIFIED BY THE ENVIRONMENT AL INSPECTOR WILL BE AVOIDED WHERE POSSIBLE DURING CONSTRUCTIO N ACTIVITIES. 2. ALL TREE REMOVAL WILL FOLLOW TIME OF YEAR RESTRICTION.	1. IDENTIFY AND FLAG LARGE SPECIMEN TREES, LIVE OR DEAD, WITH PEELING BARK, INCLUDING SHAGBARK HICKORY (CARYA OVATA) WHICH COULD POTENTIALLY SERVE AS MATERNITY OR ROOST TREES.	TREE REMOVAL WIL BE CONDUCTED DURING THE WINTEI MONTHS (OCTOBER 31-MARCH31). TRE CLEARING BETWEEN APRIL 1 - OCTOBE 30 IS PROHIBITED.

<u>SEGMENT 8 - INVASIVE SPECIES</u>

SECTION 9.4 OF THE EM&CP AND APPENDIX N DESCRIBE THE INVASIVE SPECIES MANAGEMENT PLAN FOR THE PROJECT. SECTION 9.4.2 OF THE EM&CP DESCRIBE THE MEASURES TO PREVENT OR CONTROL THE TRANSPORT OF IVNASVIE PLANT AND INSECT SPECIES AS WELL AS THE NECESSARY REPORTING REQUIREMENTS TO NYSDEC REGIONAL FORESTER IF THESE SPECIES ARE ENCOUNTERED. THE ENVIRONMENTAL INSPECTOR WILL ENSURE THAT MEASURES TO PREVENT AND CONTROL THE SPREAD OF INVASIVES ARE FOLLOWED AND THAT CONSTRUCTION CREWS ARE EDUCATED IN SAID MEASURES. THE ENVIRONMENTAL INSPECTOR WILL NOTIFY CREWS IF AN UPCOMING WORK AREA REQUIRES SAID MEASURES.

<u>SEGMENT 8 - EM&CP NOISE SENSITIVE AREAS NOTE</u>

THE NOISE RECEPTORS THAT MAY OCCUR NEAR SEGMENT 8 AT VARIOUS POINTS INCLUDE RESIDENCES AND BUSINESSES. SECTION 10.2 OF THE EM&CP DESCRIBES THE NOISE CONTROL MEASURES THAT WILL BE EMPLOYED THROUGHOUT THIS SEGMENT.

CHPE Kiewit **Power Express**



FOR EMCP REVIEW **NOT FOR CONSTRUCTION**

IT IS A VIOLATION OF LAW FOR ANY PERSON, UNLESS THEY ARE ACTING UNDER THE DIRECTION OF A LICENSED PROFESSIONAL ENGINEER, ARCHITECT, LANDSCAPE ARCHITECT OR LAND SURVEYOR TO ALTER AN ITEM IN ANY WAY. IF AN ITEM BEARING THE STAMP OF A LICENSED PROFESSIONAL IS ALTERED, THE ALTERING ENGINEER, ARCHITECT, LANDSCAPE ARCHITECT OR LAND SURVEYOR SHALL STAMP THE DOCUMENT AND INCLUDE THE NOTATION "ALTERED BY" FOLLOWED BY THEIR SIGNATURE, THE DATE OF SUCH ALTERATION, AND A SPECIFIC DESCRIPTION OF THE ALTERATION.

					SEG
Е	12/16/2022	FINAL SUBMISSION	BV	TK	
D	11/11/2022	DRAFT FINAL SUBMISSION	BV	TK	
С	06/06/2022	60% DESIGN SUBMISSION	BV	TK	
В	02/11/2022	PRELIMINARY DESIGN DEVELOPMENT	BV	TK	
Α	01/24/2022	PRELIMINARY PROGRESS	BV	TK	
No.	DATE	SUBMITTAL / REVISION DESCRIPTION	DB	APP	DRAW

CHAMPLAIN HUDSON POWER EXPRESS EGMENT 8 (PACKAGE 5A) - CSX: ROTTERDAM - BETHLEHEM EM-CP DATA TABLES

KIEWIT PROJECT NO. 21162

G-013

DRAWING NO.

AS SHOWN DATE WN BY: AR DESIGNED BY: BV APPROVED BY: TK REV. NO.

SEGMENT 8 - NYSDOT COORDINATION

<u>320</u>	MENT 6 - NISDOT COORDI	147(11014
	Table 12—2 —NYSDOT Coordination Summary	
Coordinating Parties	Description	Current Status
Certificate Holders, DPS Staff, NYSDOT	All plans and work to be performed in State—owned ROW under NYSDOT's supervision and management.	Ongoing throughout
Certificate Holders, DPS Staff, NYSDOT staff	Certificate Holders shall provide DPS Staff and NYSDOT staff with a preliminary design marked to avoid conflict with potential transportation projects that NYSDOT Staff may seek to undertake in the future and shall offer to consult with NYSDOT Staff concerning any comments it may offer and shall use reasonable efforts to accommodate any NYSDOT concerns.	Prior to filing any Segment EM&CP involving any such state—owned ROW.
Certificate Holders, NYSDOT, Agency crossed by project	Certificate Holders will consult with each transportation department or agency having jurisdiction over any roads, related structures, and components that will be crossed by the Facility or used for direct access to the Construction Zone. If the access road takes direct access from, or lies within the limits of, such roads, the Certificate Holders will notify each relevant transportation department or agency of the approximate date when work will begin.	During preparation of the EM&CP and when work begins.
Certificate Holders, NYSDOT, DPS Staff, NYSDEC	The Certificate Holders will provide status reports summarizing construction and indicating construction activities and locations scheduled for the next month.	Bi-weekly.

<u>SEGMENT 8 - ROAD AND HIGHWAY CROSSINGS AND CONSTRUCTION</u>

		TABLE 12 □3: ROAD A	ND HIGHWAY CROSSINGS		
MUNICIPALITY	JURISDICTION	ROAD CROSSING	CROSSING METHOD (HDD OR OPEN TRENCH)	SHEET	LOCATION (APPROXIMATE, SEE APPENDIX C DRAWINGS FOR DETAILS)
ROTTERDAM	TOWN OF ROTTERDAM	PHILLIPS ROAD	HDD 71	C-101	STA 50010
ROTTERDAM	NYSDOT	BURDECK STREET	HDD 71	C-102	STA 50021
ROTTERDAM	NYSDOT	MARIAVILLE ROAD	HDD 72	C-103	STA 50044
ROTTERDAM	NYS THRUWAY AUTHORITY	DUANESBURG ROAD	HDD 73	C-105	STA 50067+50
ROTTERDAM	NYSDOT	I-90 THRUWAY	HDD 73.A AND 74	C-108	STA 50116
ROTTERDAM	NYSDOT	GUILDERLAND AVENUE	HDD 75	C-110	STA 50150
GUILDERLAND	TOWN OF GUILDERLAND	COUNTY LINE ROAD	TRENCH	C-113 AND C-114	STA 50195
GUILDERLAND	NYSDOT	WESTERN TURNPIKE (US ROUTE 20)	HDD 76 AND 76.A	C-121	STA 50309
GUILDERLAND	NYSDOT	STATE ROUTE 146	HDD 78	C-127	STA 50394+50
GUILDERLAND	ALBANY COUNTY	STONE ROAD	TRENCH	C-134	STA 50502
VOORHEESVILLE	ALBANY COUNTY	SOUTH MAIN STREET/CR 201	HDD 81	C-139 AND C-140	STA 50585
VOORHEESVILLE	NYSDOT	VOORHEESVILLE AVENUE	TRENCH	C-140	STA 50596+50
VOORHEESVILLE	NYSDOT	MAPLE ROAD	HDD 82 AND 83	C-141	STA 50609
NEW SCOTLAND	TOWN OF NEW SCOTLAND	YOUMANS ROAD	TRENCH	C-145	STA 50668
NEW SCOTLAND	NYSDOT	NEW SCOTLAND ROAD	HDD 84	C-147	STA 50692+50
NEW SCOTLAND	ALBANY COUNTY	NEW SCOTLAND SOUTH ROAD	HDD 84.A	C-149	STA 50731+50
NEW SCOTLAND	TOWN OF NEW SCOTLAND	GAME FARM ROAD	HDD 84.B	C-152	STA 50780
NEW SCOTLAND	NYSDOT	DELAWARE TURNPIKE	HDD 85	C-155	STA 50811

<u>SEGMENT 8 — CI COORDINATION</u>

Owner	Utility	Initial Contact Date	CI— Owner Response	Outreach Mailing #2	Outreach Mailing #3
City of Albany	Water	8/26/2022	'	NA	NA
, ,			12" Minimum clearance, utilities in casing		
National Grid	Electric / Gas	8/22/2022	9/13/22: CI Packages, including relevant plans and documents, were submitted to National Grid	9/27/22: National Grid granted CHPE, LLC and its contractors project permission to survey and investigate property owned by National Grid	10/6/22: National Grid provide Engineering guidelines, Land us application check list, construction and maintenance procedures.
Time Warner	Fiber / Telephone	8/22/2022	Time Warner confirmed and denied facilities in the Cl Packages provided to them. They took no exceptions	NA	NA
Lumen	Fiber / Telephone	8/22/2022	Lumen found no issues, stated they do not own facilities in the section through Selkirk Ny, and provided a KMZ of their facilities	NA	NA
Town of Rotterdam Water & Sewer	Sanitary / Storm / Water	8/22/2022			
City of Schenectady Water	Sanitary / Storm / Water	8/22/2022			
Sprint	Fiber / Telephone	8/22/2022			
CSX RR	Electric / Fiber	8/22/2022			
AT&T	Electric / Fiber	8/22/2022			
Verizon	Sanitary / Storm / Water	8/22/2022	No exceptions taken	NA	NA
Dominion (Now Berkshire Hathaway — Easter gas)	Gas	8/22/2022			
Telergy	Fiber	8/22/2022			
NYS Thruway	Fiber	8/22/2022	Requested additional HDD plans, which were provided on 9/28/22.		
			Awaiting feedback		
Elantic Telecom	Fiber	8/22/2022	10/14: Water mains must be protected during construction. Concern over damage to them and proximity to power lines and rail. believe that the water mains at each crossing should be replaced with new ductile iron water main installed in a casing pipe.		
Town of Guilderland	Sanitary / Storm / Water	8/22/2022			
NYSDOT	Electric / Fiber	8/22/2022			
Villlage of Voorheesville	Sanitary / Storm / Water	8/22/2022			
Town of Bethlehem	Sanitary / Storm / Water	8/22/2022			
Dominion Telecom	Fiber	8/22/2022			
Kinder Morgan	Gas	8/22/2022	9/15/22: Kinder Morgan requested specifications of the cable, asked about conduit and the voltage. Test pits requested.	10/6/22: Kinder Morgan provided developer handbook. Provides 24" of vertical separation.	
Private	Sanitary / Storm/ Water	8/22/2022			





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					SEC
E	12/16/2022	FINAL SUBMISSION	BV	TK	
D	11/11/2022	DRAFT FINAL SUBMISSION	BV	TK	
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No.	DATE	SUBMITTAL / REVISION DESCRIPTION	DB	APP	DRA

CHAMPLAIN HUDSON POWER EXPRESS EGMENT 8 (PACKAGE 5A) - CSX: ROTTERDAM - BETHLEHEM EM-CP DATA TABLES

KIEWIT PROJECT NO. 21162 DRAWING NO.

G-114

AS SHOWN DATE AWN BY: AR DESIGNED BY: BV APPROVED BY: TK REV. NO.

SECTION 13.2 OF THE EM&CP SUMMARIZES THE RAILROAD CROSSINGS THAT WILL OCCUR WITHIN THIS SEGMENT AS WELL AS THE MITIGATION MEASURES THAT WILL BE FOLLOWED AT EACH RAILROAD CROSSING. SECTION 13.3 OF THE EM&CP DESCRIBES THE UTILITY CROSSINGS THAT WILL OCCUR WITHIN THIS SEGMENT AS WELL AS THE MITIGATION MEASURES THAT WILL BE FOLLOWED FOR EACH TYPE OF UTILITY CROSSINGS.

SEGMENT 8 - RESTORATION METHODS AND NOTES

Table 14 Res	toration Methods
Land Use Description	Section of EM&CP
Construction Materials and Equipment Staging Locations and Temporary Access Roads	14.2.2
Pavement	14.2.2
Railway Ballast	14.2.3
Recreational Areas	14.2.4
Landscaping	14.3
Streams and Waterbodies	14.4
Access Roads and Laydown Areas within Agricultural Lands	14.5.1
Drainage Features	14.5.2
General Agricultural Lands	14.5

SECTION 14.0 OF THE EM&CP DESCRIBES THE CLEANUP STANDARDS AND PROCEDURES THAT WILL BE FOLLOWED THROUGHOUT THIS SEGMENT ONCE CONSTRUCTION IS COMPLETE. TABLE 14 SUMMARIZES THE APPROPRIATE SUBSECTION WITH SECTION 14 THAT INCLUDES THE RESTORATION PROCEDURE FOR EACH TYPE OF LAND USE.

CLEANUP AND RESTORATION NOTES

PROMPT CLEANUP AND RESTORATION OF ALL AREAS DISTURBED BY CONSTRUCTION ACTIVITY IS A PRIORITY OF THE CONSTRUCTION SCHEDULE AND SEQUENCING. TIMELY CLEANUP AND RESTORATION WILL ASSIST IN MINIMIZING POTENTIAL ENVIRONMENTAL IMPACTS ASSOCIATED WITH THE PROJECT. PROCEDURES FOR CLEANUP AND RESTORATION ARE DESCRIBED IN THE FOLLOWING SECTIONS. IN ACCORDANCE WITH CERTIFICATE CONDITION 48, WITHIN TEN (10) DAYS OF THE COMPLETION OF FINAL RESTORATION ACTIVITIES. THE CERTIFICATE HOLDER WILL NOTIFY THE SECRETARY THAT ALL RESTORATION HAS BEEN COMPLETED IN COMPLIANCE WITH THE CERTIFICATE AND THE ORDER(S) APPROVING THE EM&CP.

CLEANUP STANDARDS AND PRACTICES

FROM THE BMPS', CLEAN-UP, RESTORATION, AND REVEGETATION PROCEDURES WILL BE ONGOING DURING CONSTRUCTION AS EACH SEGMENT IS COMPLETED. DURING CONSTRUCTION, ROAD AND CONSTRUCTION ROWS WILL BE KEPT FREE OF DEBRIS AND DISCARDED MATERIAL TO THE GREATEST EXTENT POSSIBLE. AS CONSTRUCTION CONTINUES, EACH SECTION OF THE ROWS WILL BE THOROUGHLY CLEANED AFTER CONSTRUCTION IS COMPLETED ON THAT PARTICULAR SECTION. ALL FABRICATED DEBRIS RESULTING FROM CONSTRUCTION WILL BE DISPOSED OF AT AN APPROVED DISPOSAL SITE IN COMPLIANCE WITH ALL APPROPRIATE ENVIRONMENTAL REGULATIONS. FABRICATED DEBRIS GENERATED DURING CONSTRUCTION INCLUDES PIPING, FENCING, WIRING, AND ANY OTHER MATERIALS USED DURING CONSTRUCTION. NO FABRICATED DEBRIS BE BURNED OR BURIED. ALL TRUCKS LEAVING THE CONSTRUCTION AREA WILL BE LOADED AND COVERED IN ACCORDANCE WITH APPLICABLE REGULATIONS AS NEEDED AS DESCRIBED IN THE SOIL AND MATERIALS MANAGEMENT PLAN OF THE EM&CP IN APPENDIX L.

RESTORATION AND PLANTING

THE FINAL STAGE OF CONSTRUCTION WILL CONSIST OF RESTORING THE ROAD AND CONSTRUCTION ROWS AND THIS SEGMENT TO ITS ORIGINAL CONDITION AND CHARACTER AS MUCH AS POSSIBLE/IS PRACTICAL, UNLESS DOING SO WOULD INTERFERE WITH THE SAFE OR RELIABLE OPERATION AND MAINTENANCE OF THE PROJECT. RESTORATION ACTIVITIES MAY VARY WITH THE SPECIFIC AREA TO BE RESTORED BUT WILL CONSIST PREDOMINANTLY OF RESTORING TOPOGRAPHY TO ORIGINAL GRADIENTS AND RESEEDING EXCAVATED AREAS OVER THE TRENCH AS IDENTIFIED HEREIN.

SITE PREPARATION FOR REVEGETATION

THE SURFACE OF THE ROAD AND CONSTRUCTION ROWS DISTURBED BY CONSTRUCTION ACTIVITIES WILL BE GRADED TO MATCH THE ORIGINAL TOPOGRAPHIC CONTOURS AND TO BE COMPATIBLE WITH SURROUNDING DRAINAGE PATTERNS WHERE APPROPRIATE. IT SHOULD BE NOTED THAT SUBCONTRACTORS WILL TYPICALLY LIMIT GRUBBING (THE REMOVAL OF STUMPS AND ROOTS) TO THE FOOTPRINT OF THE EXCAVATED TRENCH AND ACCESS ROADS TO ALLOW RE-SPROUTING AND ASSIST IN THE RECOVERY OF WOODY SPECIES, EXCEPT WHERE REMOVAL IS REQUIRED FOR SAFE CONSTRUCTION. WHERE NEEDED, IT MAY BE NECESSARY TO IMPORT TOPSOIL TO RETURN AN AREA TO GRADE. IMPORTED TOPSOIL WILL FOLLOW CLASSIFICATION AND CHARACTERIZATION MEASURES OUTLINED IN THE SOIL MANAGEMENT PLAN IN APPENDIX L. HDD ENTRY AND EXIT PITS WILL BE BACKFILLED AND THE DISTURBED GROUND SURFACE WILL BE SIMILARLY GRADED. TRENCHES WILL BE BACKFILLED IN ACCORDANCE WITH THE MEASURES OUTLINED IN SECTION 4.4.7 OF THE EM&CP. THE CERTIFICATE HOLDER WILL BE RESPONSIBLE FOR WILL CHECKING ALL CULVERTS AND ASSURE THAT THEY ARE NOT CRUSHED OR BLOCKED DURING CONSTRUCTION AND RESTORATION OF THIS SEGMENT AND, IF A CULVERT IS BLOCKED OR CRUSHED, TAKE IMMEDIATE STEPS TO REPLACE OR REPAIR THE CULVERT IN ACCORDANCE WITH APPLICABLE STATE OR LOCAL STANDARDS.

SEEDING AND PLANTING

SEEDING OPERATIONS ACROSS THE 35-FOOT-WIDE CONSTRUCTION AND FACILITY ROWS AS WELL AS WITHIN STAGING AND LAYDOWN AREAS WILL COMMENCE ONLY AFTER AN ACCEPTABLE SEEDBED HAS BEEN ESTABLISHED, AS DESCRIBED ABOVE. . SEED WILL BE APPLIED BY HAND, OR VIA HYDRO-SEEDERS. THE ENTIRE SEEDED AREA WILL BE WATERED WITH A FINE SPRAY, AS NECESSARY, UNTIL A UNIFORM MOISTURE DEPTH OF APPROXIMATELY ONE (1) INCH HAS BEEN ACHIEVED AS APPLICABLE. MULCHING AND ANCHORING OF THE MULCH MAY BE NECESSARY IN SOME AREAS UNLESS A HYDROMULCH/SEED SLURRY IS USED. ON STEEP SLOPES, JUTE NET WILL BE USED TO PROVIDE STABILIZATION. FERTILIZER WILL BE ADDED, AS APPLICABLE, AT THE APPROPRIATE RATES AFTER SEED IS APPLIED AND/OR TO A HYDROMULCH/SEED SLURRY. NO FERTILIZER WILL BE APPLIED IN WETLAND RESOURCE AREAS. SEEDING/MULCHING WILL TAKE PLACE UNDER THE SUPERVISION OF THE ENVIRONMENTAL INSPECTOR THE SEED MIXTURE AND RATE OF APPLICATION WILL DEPEND ON THE SOIL TYPE, LAND USE, AVAILABLE MOISTURE, AND SEASON AT THE TIME OF APPLICATION. ALL SEED MIXES WILL BE FREE OF INVASIVE SPECIES. ALL SEED BAG TAGS (EITHER ORIGINAL OR SCANNED COPIES) WILL BE PROVIDED TO THE ENVIRONMENTAL INSPECTOR EITHER ORIGINAL TAGS OR SCANNED COPIES. SEEDED AREAS WILL BE MONITORED FOLLOWING RESTORATION UNTIL A MINIMUM VEGETATIVE COVER OF EIGHTY (80) PERCENT IS ACHIEVED. THE SEED MIXTURES WILL FOLLOW THE TECHNICAL SPECIFICATIONS INCLUDED ON THE PLAN AND PROFILE DRAWINGS IN APPENDIX C (SHEET G-020 OF BOTH SEGMENT 1 AND SEGMENT 2) FOR UPLANDS AND WETLAND BUFFER ZONES. FOR WETLAND RESOURCE AREAS, EMERGENT COMMUNITIES SHOULD BE REVEGETATED WITH AN ERNST FACW WETLAND MEADOW MIX (ERNMX-122) OR EQUIVALENT, AND FOR SHADED SITES WITHIN FORESTED/SHRUB-SHRUB WETLAND COMMUNITIES, DISTURBED AREAS SHOULD BE REVEGETATED WITH ERNST SPECIALIZED WETLAND MIX FOR SHADED AREAS (ERNMX-137) OR EQUIVALENT.

THE MAJORITY OF SOIL DISTURBANCE FOR THIS SEGMENT WILL BE WITHIN THE TRENCH-LINE FOR THE CONDUIT/CABLE. HOWEVER, SOME DISTURBANCE WILL ALSO OCCUR DURING INSTALLATION AND REMOVAL OF TEMPORARY ACCESS ROADS AS DESCRIBE IN SECTION 4.10 OF THE EM&CP. ALL TRENCH AREAS AND OTHER EXCAVATED AREAS WILL BE RESEEDED WITH AN APPROPRIATE SEED MIX AS IDENTIFIED ABOVE. VEGETATION THROUGHOUT THE CONSTRUCTION ROW WILL BE CUT TO GROUND LEVEL AND ROOT SYSTEMS WILL REMAIN INTACT TO ALLOW FOR RESPROUTING FOLLOWING CONSTRUCTION, UNLESS RESPROUTING WOULD INTERFERE WITH THE SAFE AND RELIABLE OPERATION OF THE PROJECT.

- IF REQUIRED, ALL TREES OVER TWO (2) INCHES IN DBH OR SHRUBS OVER FOUR (4) FEET IN HEIGHT THAT ARE DAMAGED OR DESTROYED BY ACTIVITIES DURING CONSTRUCTION, OPERATION, OR MAINTENANCE WITHIN ASSOCIATED URBAN, RESIDENTIAL OR LANDSCAPED AREAS, WILL BE REPLACED WITHIN THE FOLLOWING YEAR BY THE CERTIFICATE HOLDERS WITH THE EQUIVALENT TYPE OF TREES OR SHRUBS EXCEPT IF:
- a) EQUIVALENT TYPE REPLACEMENT TREES OR SHRUBS WOULD INTERFERE WITH THE PROPER CLEARING, CONSTRUCTION. OPERATION, OR MAINTENANCE OF THE PROJECT OR WOULD BE INCONSISTENT WITH STATE-INVASIVE SPECIES POLICY; OR b) REPLACEMENT WOULD BE CONTRARY TO SOUND ROW MANAGEMENT PRACTICES, OR TO ANY APPROVED LONG-RANGE ROW MANAGEMENT PLAN APPLICABLE TO THE FACILITY OR ADJOINING ROW; OR
- c) THE OWNER OF LAND WHERE THE DAMAGED OR DESTROYED TREES OR SHRUBS WERE LOCATED (OR OTHER RECORDED EASEMENT OR LICENSE HOLDERS WITH THE RIGHT TO CONTROL REPLACEMENT) DECLINES REPLACEMENT.

RESTORATION OF WATERBODIES

UPON COMPLETION OF BACKFILLING OPERATIONS, CLEANUP AND RESTORATION OF WATERBODY CROSSINGS AND BANK APPROACHES (AT LEAST FIFTY [50] FEET ADJACENT TO EACH BANK) WILL BE COMPLETED WITHIN 24 HOURS. IF NEEDED, STREAM BANKS WILL BE RE-ESTABLISHED TO ORIGINAL GRADE IMMEDIATELY AFTER STREAM BANK WORK IS COMPLETED. THE BANKS WILL THEN BE PERMANENTLY STABILIZED BY SEEDING WITH NATIVE GRASSES, MULCHED AND, IF NEEDED, PLANTED WITH NATIVE SHRUB SEEDLINGS. IF ADDITIONAL STABILIZATION IS NEEDED JUTE NETTING OR EROSION CONTROL BLANKETS WILL BE USED.. RESTORATION AND PLANTING DETAILS FOR WATERBODIES ARE FURTHER DETAILED IN SECTION 14.4.1 OF THE EM&CP.

RESTORATION OF WETLANDS

THESE AREAS WILL BE RESTORED AS CLOSE AS PRACTICABLE TO PRE-CONSTRUCTION CONDITIONS AND CONTOURS. ALL TEMPORARY FENCING AND EROSION CONTROLS WILL BE REMOVED AND DISPOSED OF IN AN ACCEPTABLE MANNER AT A STATE APPROVED DISPOSAL FACILITY APPROVED BY DPS STAFF AND THE CERTIFICATE HOLDER. ALL MOTORIZED CONSTRUCTION EQUIPMENT WILL BE TRANSPORTED TO OFF—SITE FACILITIES. ALL WETLAND MATS AND MATERIALS WILL BE COLLECTED, PACKED, AND TRANSPORTED TO OFF-SITE STORAGE FACILITY OR TO THE NEXT SEGMENT'S STAGING AREAS NEEDED.

RESTORATION OF CONSTRUCTION MATERIALS AND EQUIPMENT STAGING LOCATIONS AND TEMPORARY ACCESS ROADS

THE CONSTRUCTION MATERIALS EQUIPMENT STAGING LOCATIONS FOR THIS SEGMENT ARE SUMMARIZED IN SECTION 5.4 TABLE 5.2 OF THE EM&CP AND ARE SHOWN IN THE PLAN AND PROFILE DRAWINGS AND ESCP. THESE AREAS WILL BE RESTORED AS CLOSE AS PRACTICABLE TO PRE-CONSTRUCTION CONDITIONS AND CONTOURS TO THE EXTENT PRACTICABLE.

ALL TEMPORARY FENCING AND EROSION CONTROLS WILL BE REMOVED AND DISPOSED OF IN AN ACCEPTABLE MANNER AT A STATE-APPROVED DISPOSAL FACILITY APPROVED BY DPS STAFF AND THE CERTIFICATE HOLDERS. ALL MOTORIZED CONSTRUCTION EQUIPMENT WILL BE TRANSPORTED TO OFF-SITE FACILITIES. ALL OTHER USABLE CONSTRUCTION EQUIPMENT AND MATERIALS WILL BE COLLECTED, PACKED, AND TRANSPORTED TO OFF-SITE STORAGE FACILITIES OR TO THE NEXT SEGMENT'S STAGING AREA AS NEEDED. ALL UNUSABLE EQUIPMENT AND MATERIALS WILL BE REMOVED FROM THE LAYDOWN YARD AND DISPOSED OF APPROPRIATELY.

PLANT INSPECTION, GUARANTEE, AND MAINTENANCE

VEGETATION RESTORATION ALSO INCLUDES THE MAINTENANCE OF PLANTINGS FOR SPECIFIED TIME PERIODS AND THE REPLACEMENT OF UNSUCCESSFUL PLANTINGS. PRIOR TO PLANTING, THE ENVIRONMENTAL INSPECTOR WILL INSPECT ALL PLANTS IN CONTAINERS. PLANTINGS WILL BE PERFORMED BY A QUALIFIED LANDSCAPE OR NURSERY CONTRACTOR. THE ENVIRONMENTAL INSPECTOR WILL ALSO INSPECT ALL PLANTS AFTER COMPETITION OF PLANTING TO ENSURE PROPER PLANTING PROCEDURES AND THE CORRECT PLANT SPECIES WERE USED. ADDITIONALLY, THE ENVIRONMENTAL INSPECTOR WILL CONDUCT A FINAL INSPECTION OF ALL REVEGETATED AREAS AFTER THE END OF THE MONITORING PERIOD TO ENSURE FINAL STABILIZATION. ALL VEGETATION REPLACED WILL HAVE A MINIMUM TWO (2) YEAR SURVIVAL GUARANTEE. AS DESCRIBED IN THE BMP DOCUMENT, WHERE TREE OR SHRUB PLANTINGS ARE NEEDED, A POST CONSTRUCTION SURVIVAL SURVEY WILL BE PERFORMED ONE YEAR AFTER THE PLANTINGS. IF ANY TREE OR SHRUB HAS NOT SURVIVED OR IS IN POOR HEALTH, THE TREE/SHRUB WILL BE REPLACED.

SWPPP INSPECTIONS WILL BE PERFORMED BY THE ENVIRONMENTAL INSPECTOR ON A WEEKLY BASIS UNTIL ALL DISTURBED AREAS HAVE ACHIEVED 80% REVEGETATION AND HAVE ACHIEVED FINAL STABILIZATION. FOLLOWING FINAL RESTORATION, EROSION AND SEDIMENT CONTROL MEASURES WILL BE REMOVED FROM THE SITE AND DISPOSED OF APPROPRIATELY.

RESTORATION WITHIN NYSDOT ROW

ALL RESTORATION WITHIN THE NYSDOT ROW SHALL BE DONE IN ACCORDANCE WITH THE LATEST VERSION OF THE NYSDOT STANDARD SPECIFICATIONS AND STANDARD SHEET.

RESTORATION OF RECREATIONAL AREAS

FOLLOWING CONSTRUCTION, THE CERTIFICATE HOLDERS WILL RESEED THE CONSTRUCTION AREA WITHIN RECREATIONAL AREAS USING THE PROCEDURES AND METHODS SPECIFIED IN THE SECTIONS ABOVE WHERE NEEDED. IF NECESSARY, ADDITIONAL REVEGETATION AND TREE PLANTING MAY BE PERFORMED DEPENDING ON THE IMPACT OF CONSTRUCTION.

ROADWAY RESTORATION <u>(STRIPPING, SIGNAGE, AUDIBLE ROADWAY DELINEATORS)</u>

ALL RESTORATION WITHIN THE NYSDOT ROW SHALL BE DONE IN ACCORDANCE WITH THE LATEST VERSION OF THE NYSDOT STANDARD SPECIFICATIONS AND STANDARD SHEET.

RESTORATION OF ROADWAY

THESE AREAS WILL BE RESTORED AS CLOSE AS PRACTICABLE TO PRE-CONSTRUCTION CONDITIONS AND CONTOURS. TRENCHES WILL BE BACKFILLED PER THE APPROPRIATE DETAIL, FULL WIDTH OF THE TRENCH WILL BE RESTORED TO MATCH THE EXISTING PAVEMENT SECTION. THE FULL WIDTH OF THE TRAVEL LANE TO THE CENTERLINE WILL BE MILLED AND OVERLAYED WITH A TOP COURSE OF ASPHALT. ALL TEMPORARY FENCING AND EROSION CONTROLS WILL BE REMOVED AND DISPOSED ON IN AN ACCEPTABLE MANNER AT A STATE-APPROVED DISPOSAL FACILITY APPROVED BY DPS STAFF AND THE CERTIFICATE HOLDERS.

RESTORATION OF ROADWAY SHOULDER

THESE AREAS WILL BE RESTORED AS CLOSE AS PRACTICABLE TO PRE-CONSTRUCTION CONDITIONS AND CONTOURS. TRENCHES WILL BE BACKFILLED PER THE APPROPRIATE DETAIL, FULL WIDTH OF THE TRENCH WILL BE RESTORED TO MATCH THE EXISTING PAVEMENT SECTION. THE FULL WIDTH OF THE TRAVEL LANE TO THE CENTERLINE WILL BE MILLED AND OVERLAYED WITH A TOP COURSE OF ASPHALT. ALL TEMPORARY FENCING AND EROSION CONTROLS WILL BE REMOVED AND DISPOSED ON IN AN ACCEPTABLE MANNER AT A STATE-APPROVED DISPOSAL FACILITY APPROVED BY DPS STAFF AND THE CERTIFICATE HOLDERS.

PAVEMENT RESTORATION

CURRENTLY, LIMITED RESTORATION NEEDS IN URBAN/RESIDENTIAL AREAS HAVE BEEN IDENTIFIED WITHIN THIS SEGMENT.

AS DESCRIBED IN THE BMP DOCUMENT AND CERTIFICATE CONDITIONS, CURBS, SIDEWALKS, AND STREETS DAMAGED BY CONSTRUCTION WILL BE RESTORED TO PRE-EXISTING CONDITION OR BETTER. FURTHER, DISTURBED AREAS, RUTS, AND RILLS ALONG ROADWAYS SHALL BE RESTORED TO ORIGINAL GRADES AND CONDITIONS WITH PERMANENT REVEGETATION AND EROSION CONTROLS APPROPRIATE FOR THOSE LOCATIONS, AS APPROPRIATE.

THE CERTIFICATE HOLDERS WILL CONSULT THE MUNICIPAL ROAD OR HIGHWAY DEPARTMENT AND/OR THE REGIONAL OFFICE OR COUNTY ENGINEER OF THE NYSDOT IN ORDER TO IDENTIFY AND INCORPORATE APPROPRIATE SPECIFICATIONS FOR CURB, SIDEWALK, OR STREET RESTORATION.

	Table 14□1. Agricultural Lands Re	equiring Restoration in Segment 8	
Agricultural Land Description	Parcel Number	Plan and Profile (Appendix C) Sheet Number	Station (approximate —see Appendix C for details)
Agricultural Land #1	26.00-3-18	C-118 and C-119	STA 50268+50 to 50270+96
Agricultural Land #2	26.00-3-34	C-119 and C-120	STA 50282+62 to 50291+06
Agricultural Land #3	61.00-1-25, 61.00-1-26.2, 61.00-1-26.3	C-135	STA 50507+55 to 50516+58
Agricultural Land #4	61.00-1-29 and 61.00-3-16.1	C-137	STA 50546+83 to 50553+26
Agricultural Land #5	72.00-3-41.51	C-144	STA 50648 to 50659
Agricultural Land #6	84.00-1-44.2 95.00-3-1.1	C-151 and C-152	STA 50754+54 to 50772+91
Agricultural Land #7	95.00-3-5 95.00-3-42	C-154	STA 50797+20 to 50806+55

SEGMENT 8 - FEMA

FEMA FIRM MAPS ARE PROVIDED IN APPENDIX D OF THE STORMWATER POLLUTION PREVENTION PLAN WHICH IS INCLUDED IN APPENDIX G OF THE EM&CP.

<u>SEGMENT 8 - EM&CP EROSION AND SEDIMENT CONTROL NOTES</u>

- 1. THE STORMWATER POLLUTION PREVENTION PLAN INCLUDED IN APPENDIX G OF THE EM&CP DESCRIBES THE EROSION AND SEDIMENT CONTROLS THAT WILL BE FOLLOWED FOR THIS SEGMENT.
- 2. THE EROSION AND SEDIMENT CONTROL PLANS CAN BE FOUND ON SHEETS C-400 TO SHEET C-430 FOR THIS SEGMENT.

Champlain Hudson **Power Express**



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					CHAMPLAIN HUDSON POWER EXSEGMENT 8 (PACKAGE 5A) - CSX: ROTTERDAM -					
E	12/16/2022	FINAL SUBMISSION	BV	TK	,					
D	11/11/2022	DRAFT FINAL SUBMISSION	BV	TK	EM-CP DATA TABLES					
С	06/06/2022	60% DESIGN SUBMISSION	BV	TK						
В	02/11/2022	PRELIMINARY DESIGN DEVELOPMENT	BV	TK						
Α	01/24/2022	PRELIMINARY PROGRESS	BV	TK						
No.	DATE	SUBMITTAL / REVISION DESCRIPTION	DB	APP	DRAWN BY: AR DESIGNED BY: BV APPROVED BY: TK REV. NO.					

CHAMPLAIN HUDSON POWER EXPRESS GMENT 8 (PACKAGE 5A) - CSX: ROTTERDAM - BETHLEHEM EM-CP DATA TABLES

G-115


DRAWING NO.

KIEWIT PROJECT NO.

21162

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STA. 50000+00.00 TO STA. 50015+00.00 PROFILE SCALE: H: 1" = 50' V: 1" = 10'



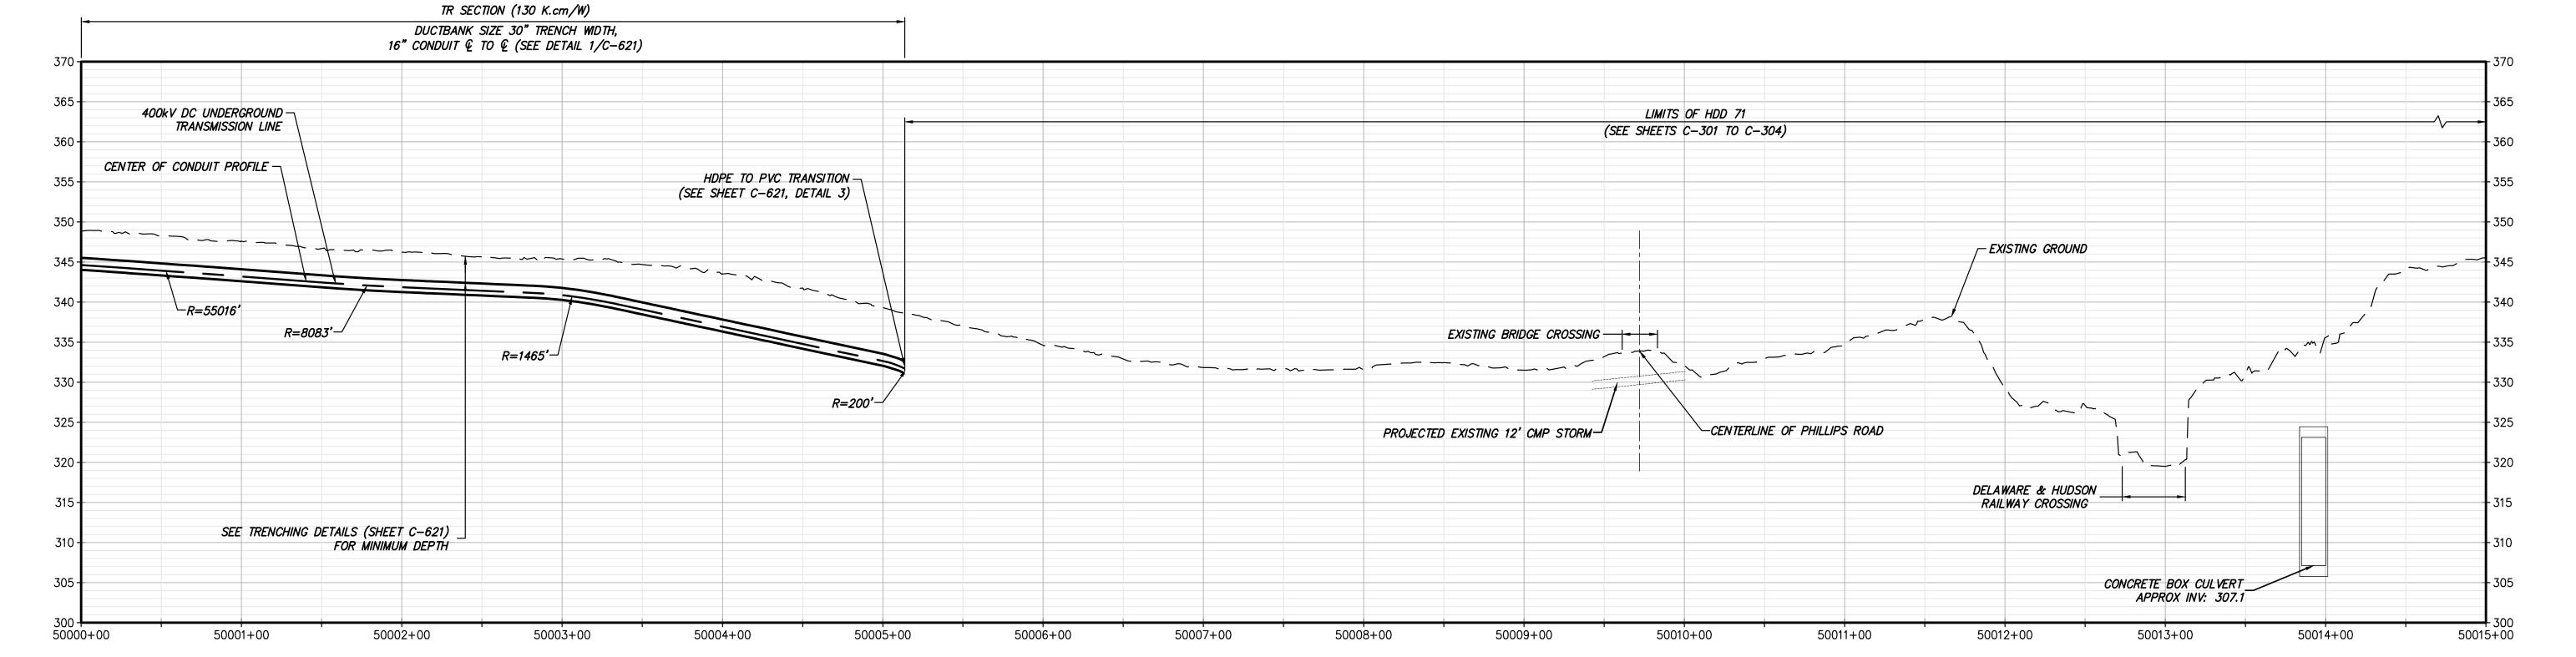


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ARCHITECT OR LAND SURVEYOR SHALL STAMP THE DOCUMENT
AND INCLUDE THE NOTATION "ALTERED BY" FOLLOWED BY
THEIR SIGNATURE, THE DATE OF SUCH ALTERATION, AND A
SPECIFIC DESCRIPTION OF THE ALTERATION. NOT FOR CONSTRUCTION


					SEC
Е	12/16/2022	FINAL SUBMISSION	BV	TK	
D	11/11/2022	DRAFT FINAL SUBMISSION	BV	TK	
O	06/06/2022	60% DESIGN SUBMISSION	BV	TK	
В	02/11/2022	PRELIMINARY DESIGN DEVELOPMENT	BV	TK	
Α	01/24/2022	PRELIMINARY PROGRESS	BV	TK	
No.	DATE	SUBMITTAL / REVISION DESCRIPTION	DB	APP	DRA

KIEWIT PROJECT NO. CHAMPLAIN HUDSON POWER EXPRESS EGMENT 8 (PACKAGE 5A) - CSX: ROTTERDAM - BETHLEHEM STA. 50000+00.00 TO STA. 50015+00.00 HVDC CONDUIT PLAN AND PROFILE (AND TEMPORARY ACCESS ROAD PLAN) AWN BY: AR DESIGNED BY: BV APPROVED BY: TK REV. NO. AS SHOWN DATE

DRAWING NO. C-101

21162

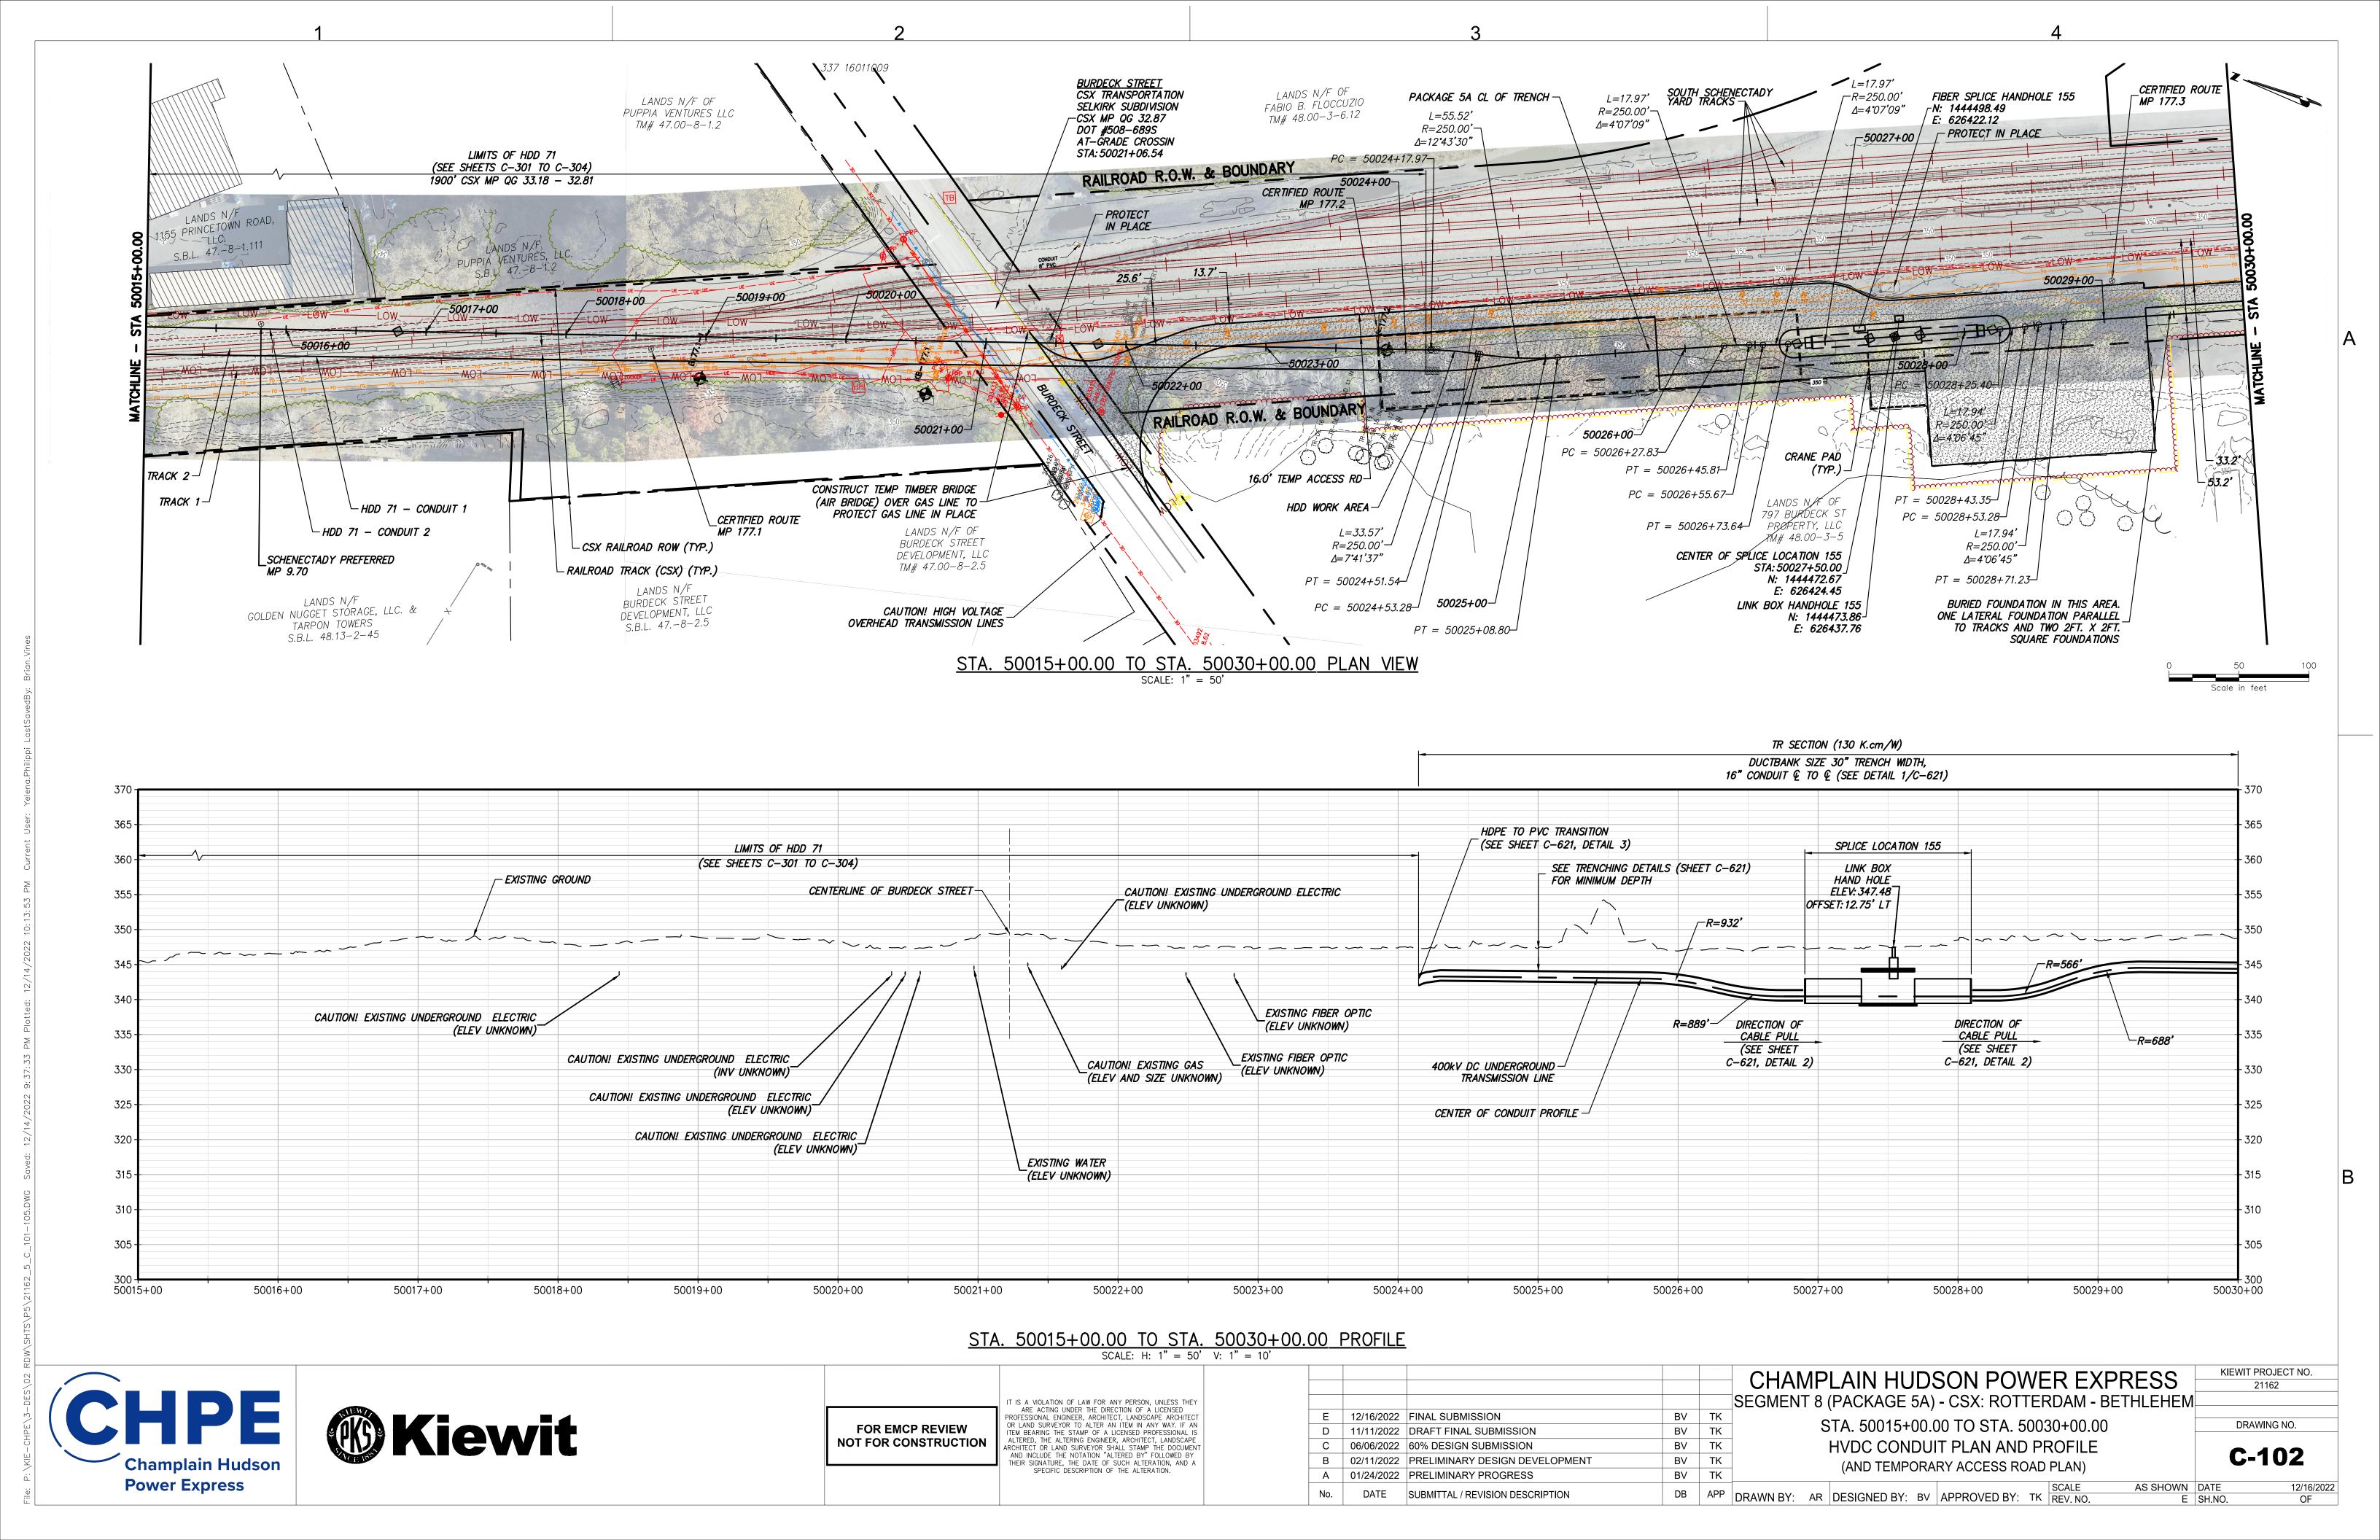

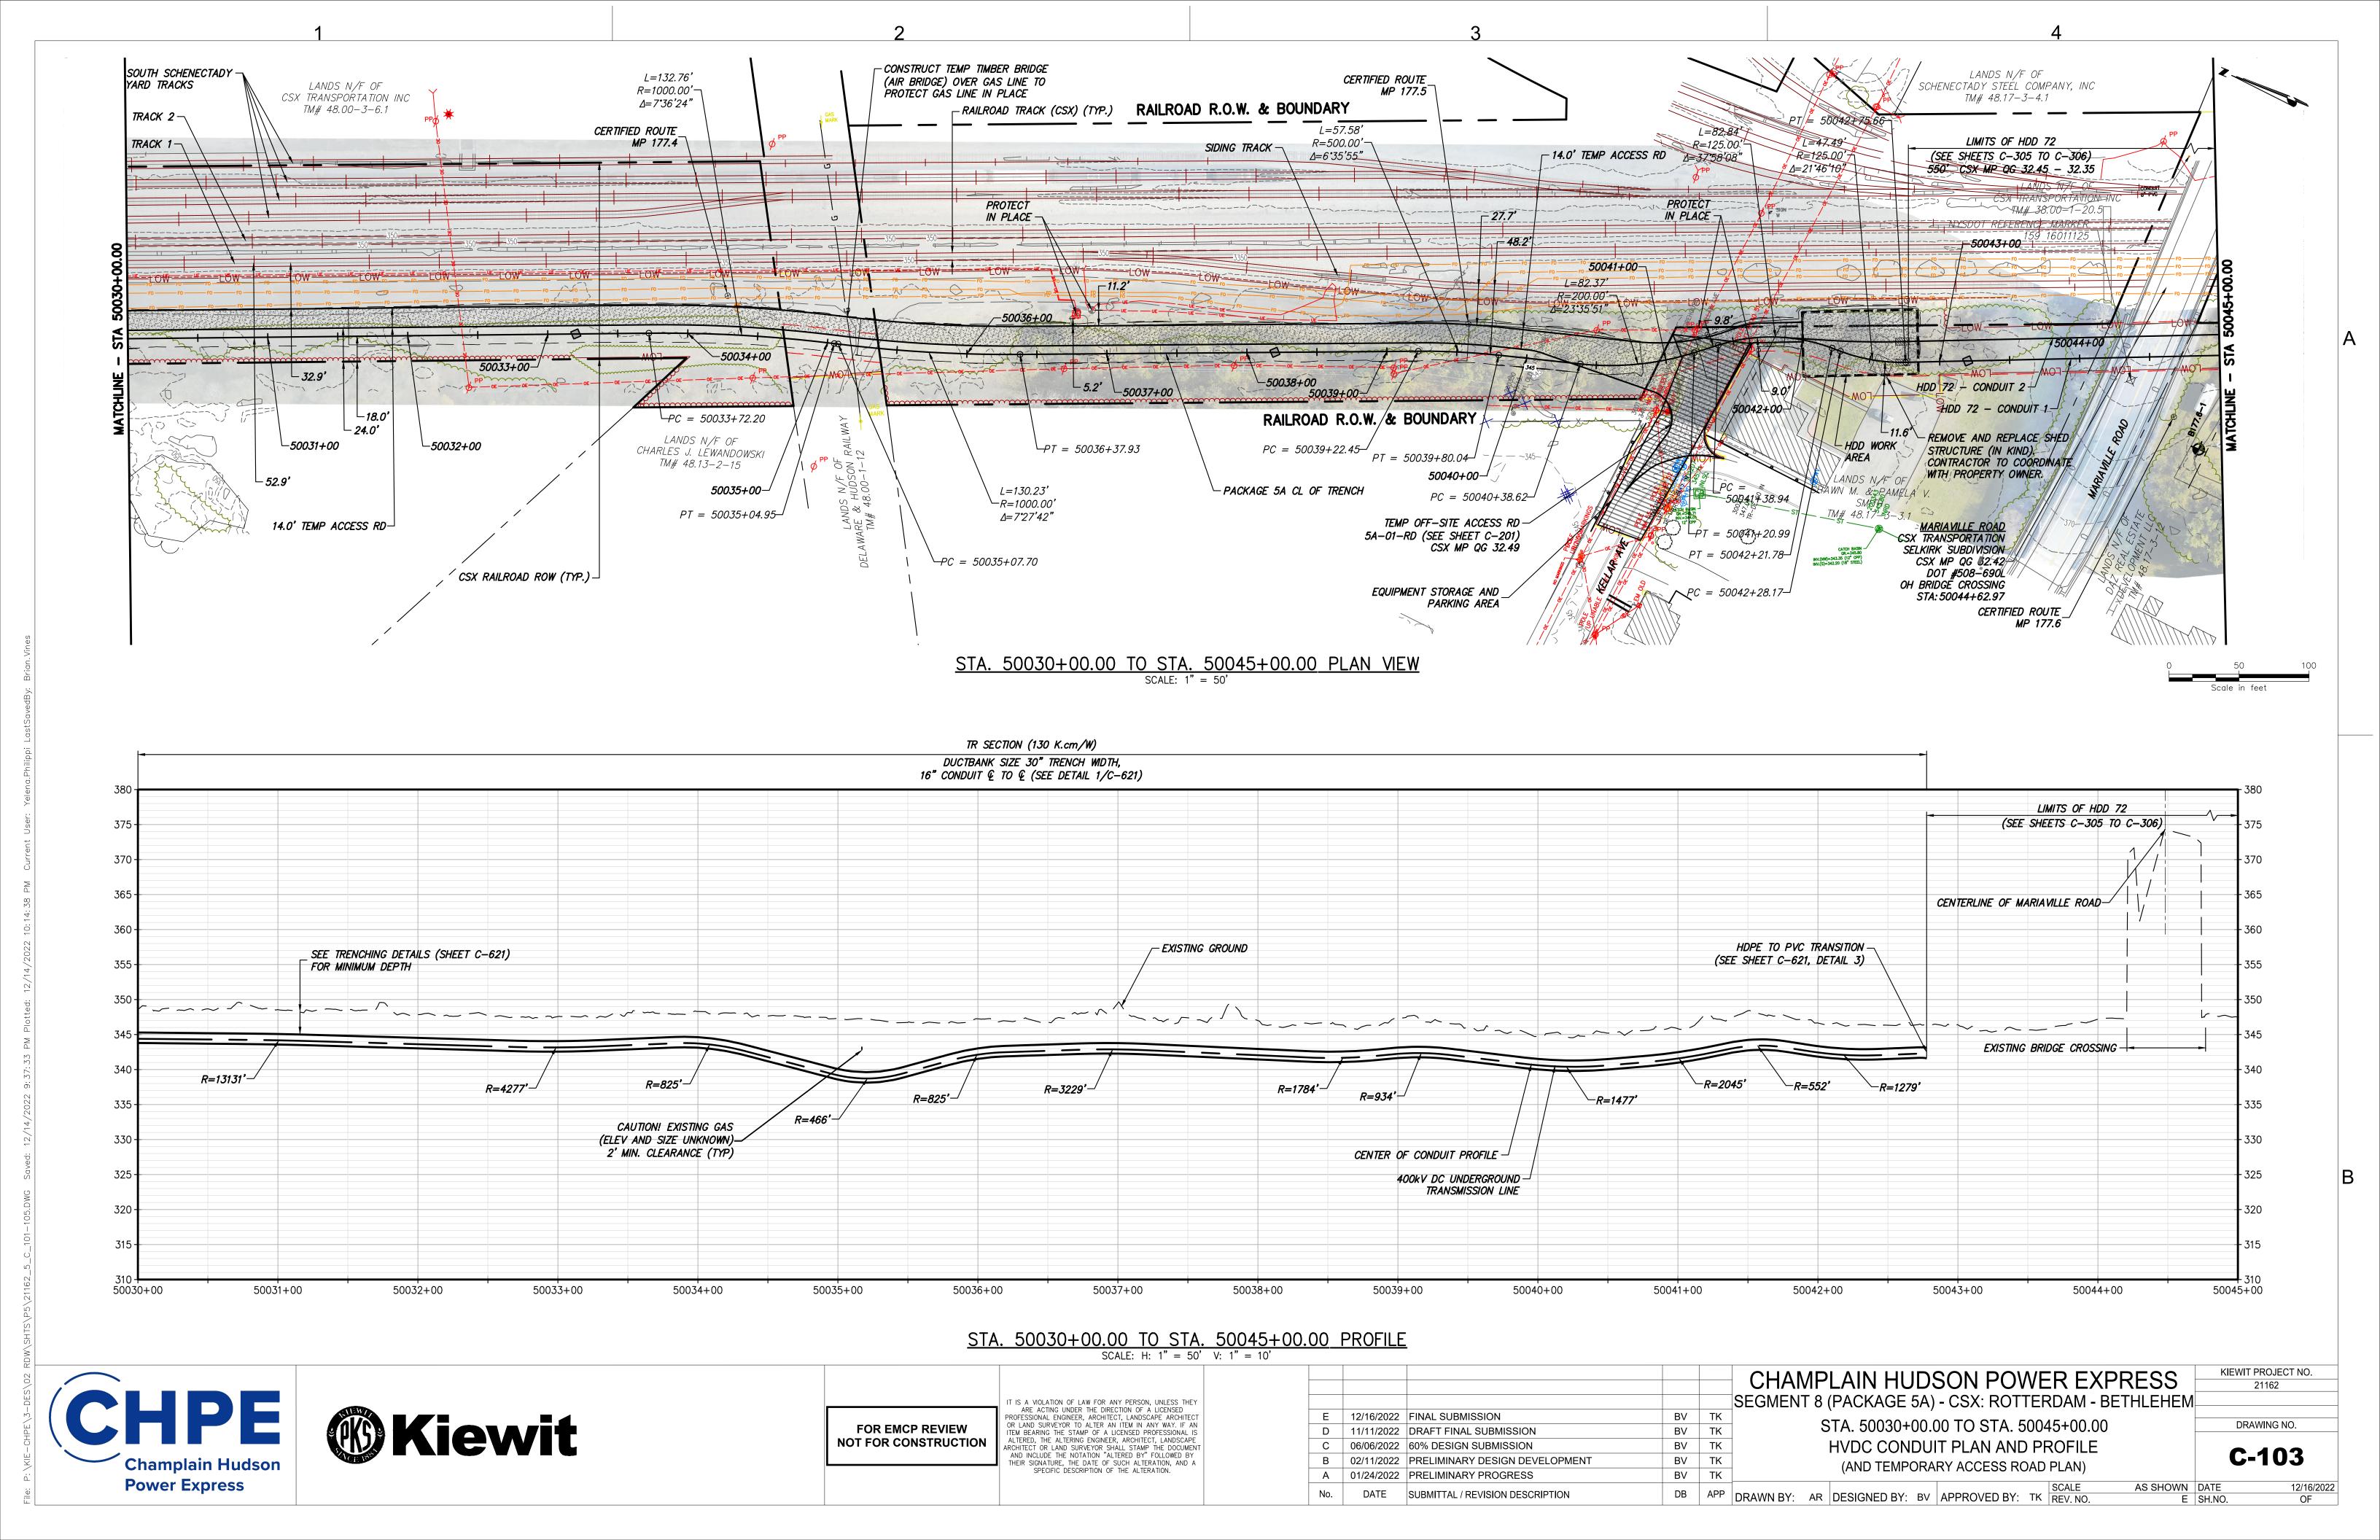

ARE ACTING UNDER THE DIRECTION OF A LICENSED PROFESSIONAL ENGINEER, ARCHITECT, LANDSCAPE ARCHITECT OR LAND SURVEYOR TO ALTER AN ITEM IN ANY WAY. IF AN ITEM BEARING THE STAMP OF A LICENSED PROFESSIONAL IS ALTERED, THE ALTERING ENGINEER, ARCHITECT, LANDSCAPE ARCHITECT OR LAND SURVEYOR SHALL STAMP THE DOCUMENT AND INCLUDE THE NOTATION "ALTERED BY" FOLLOWED BY THEIR SIGNATURE, THE DATE OF SUCH ALTERATION, AND A SPECIFIC DESCRIPTION OF THE ALTERATION.

FOR EMCP REVIEW

NOT FOR CONSTRUCTION

Power Express

E | 12/16/2022 | FINAL SUBMISSION

11/11/2022 DRAFT FINAL SUBMISSION

06/06/2022 | 60% DESIGN SUBMISSION

01/24/2022 PRELIMINARY PROGRESS

02/11/2022 PRELIMINARY DESIGN DEVELOPMENT

SUBMITTAL / REVISION DESCRIPTION

BV TK

BV

BV TK

BV TK

BV TK

TK

STA. 50045+00.00 TO STA. 50060+00.00


HVDC CONDUIT PLAN AND PROFILE


(AND TEMPORARY ACCESS ROAD PLAN)

DB APP DRAWN BY: AR DESIGNED BY: BV APPROVED BY: TK REV. NO.

DRAWING NO.

C-104

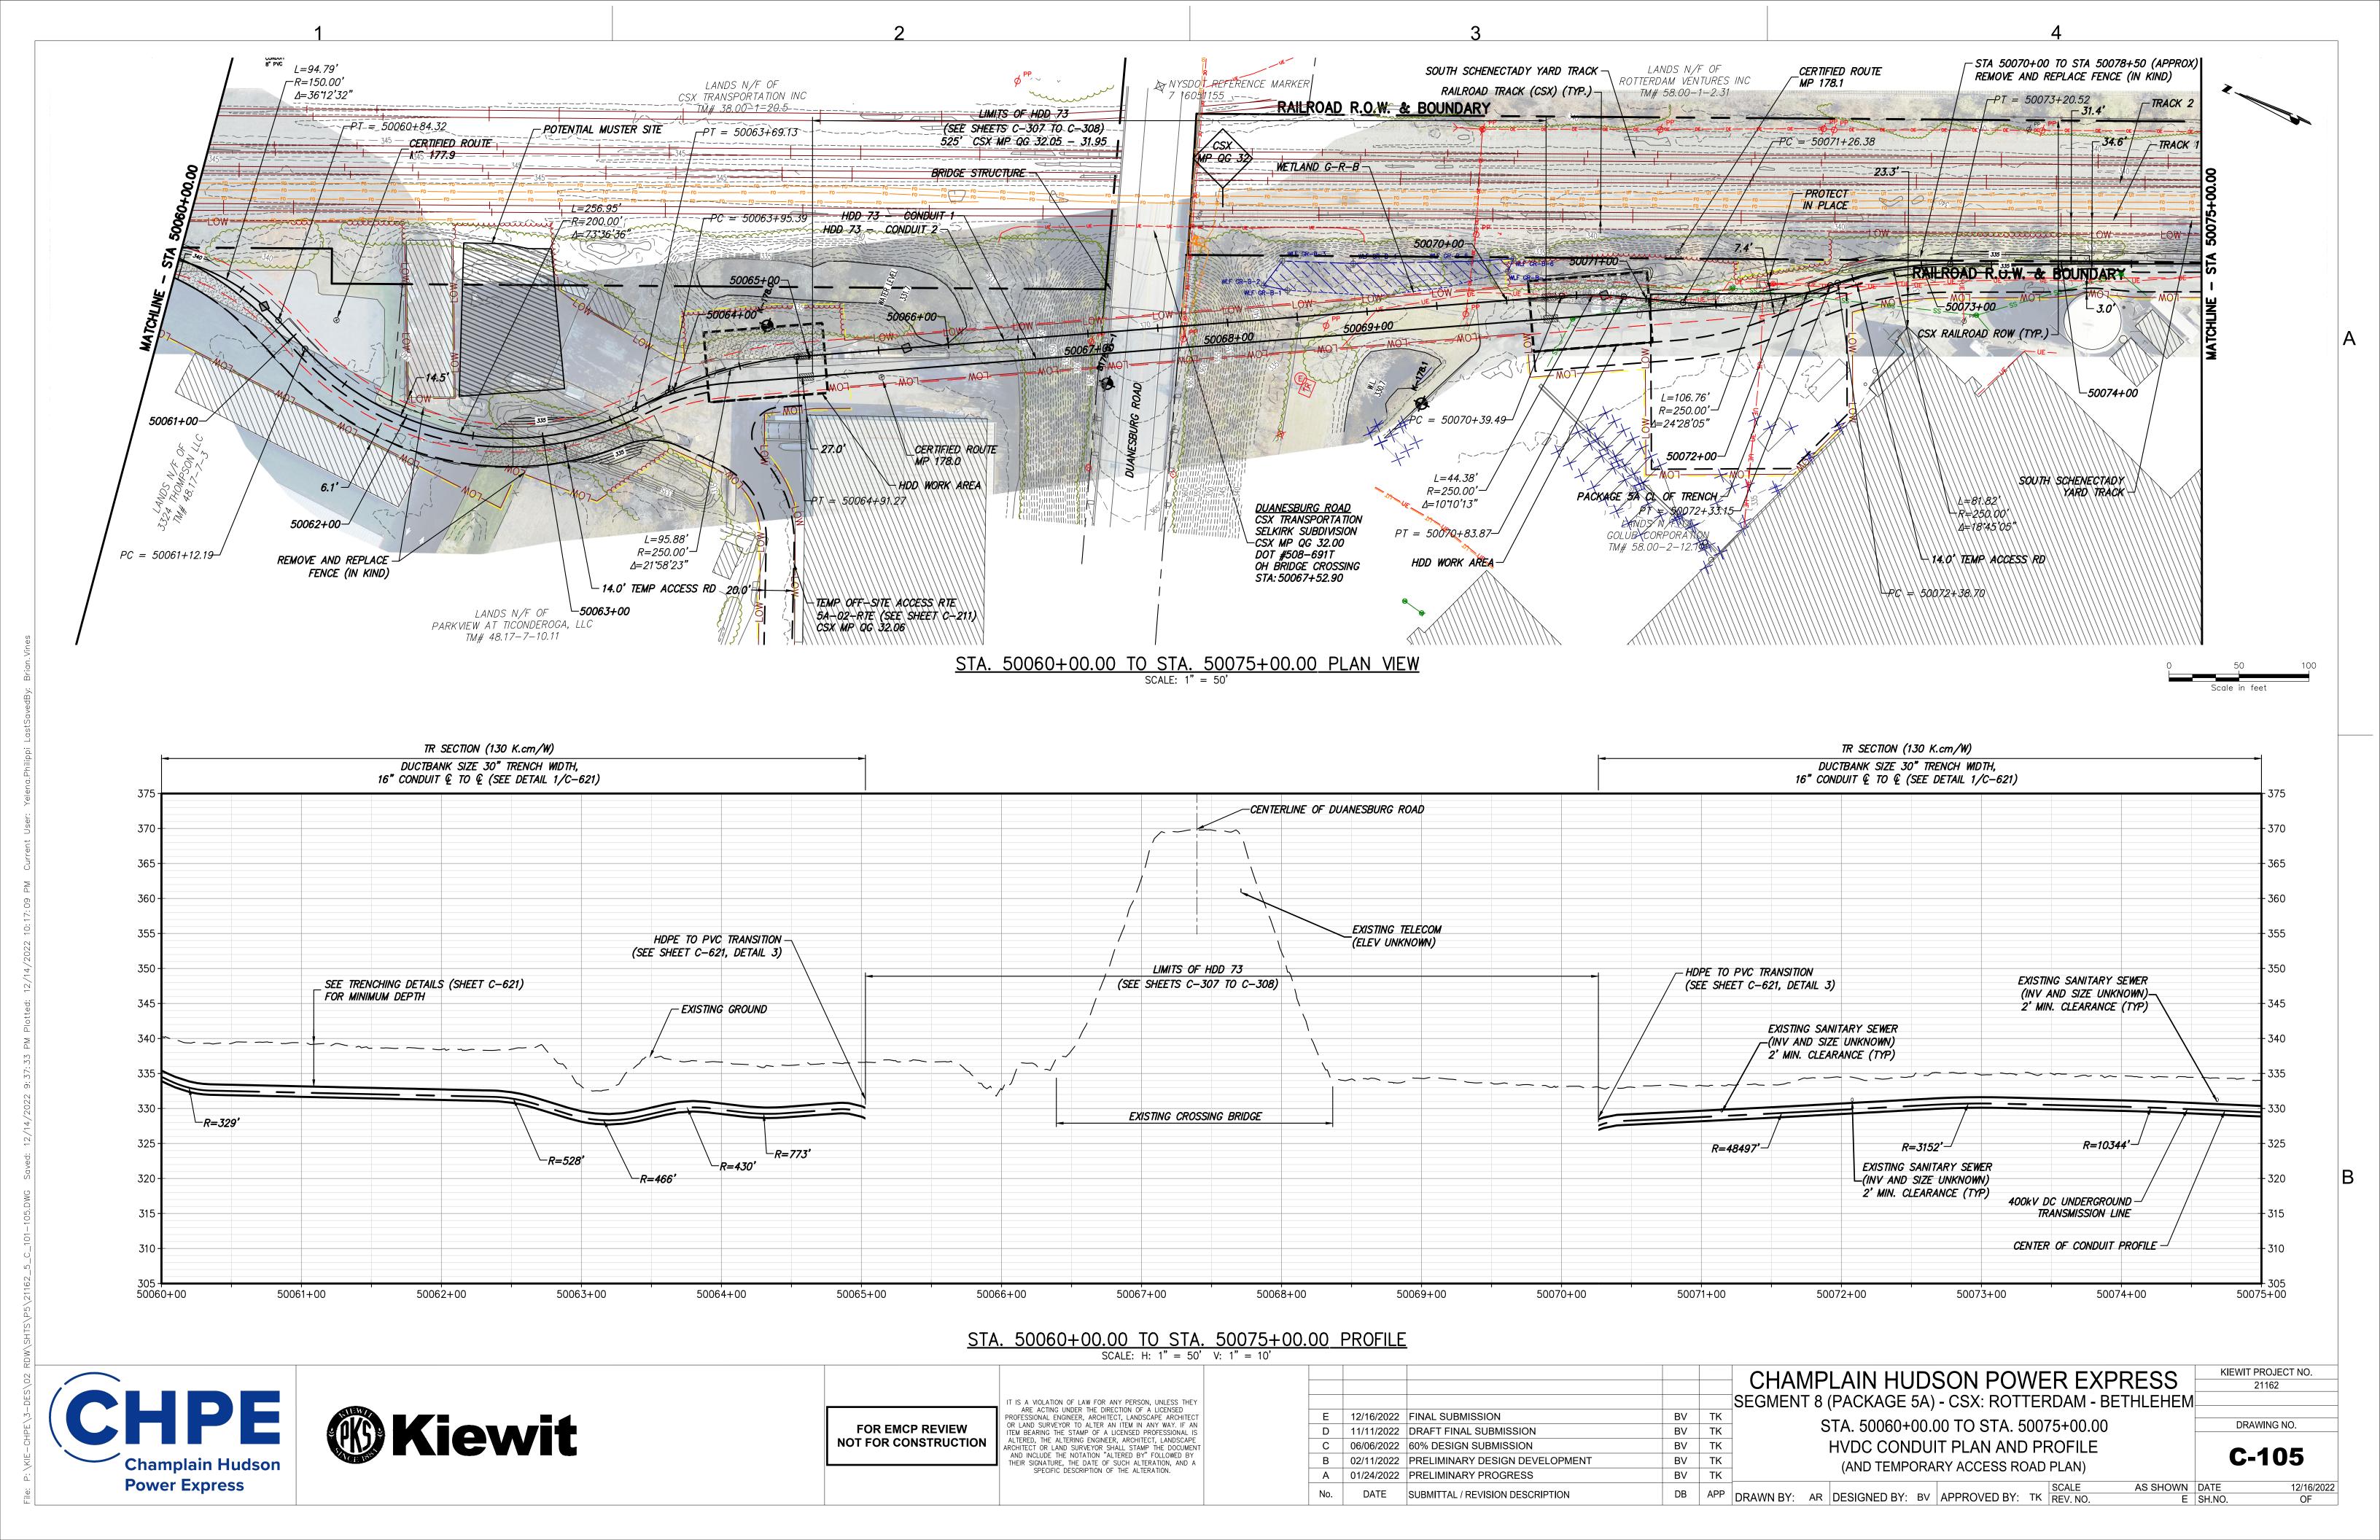

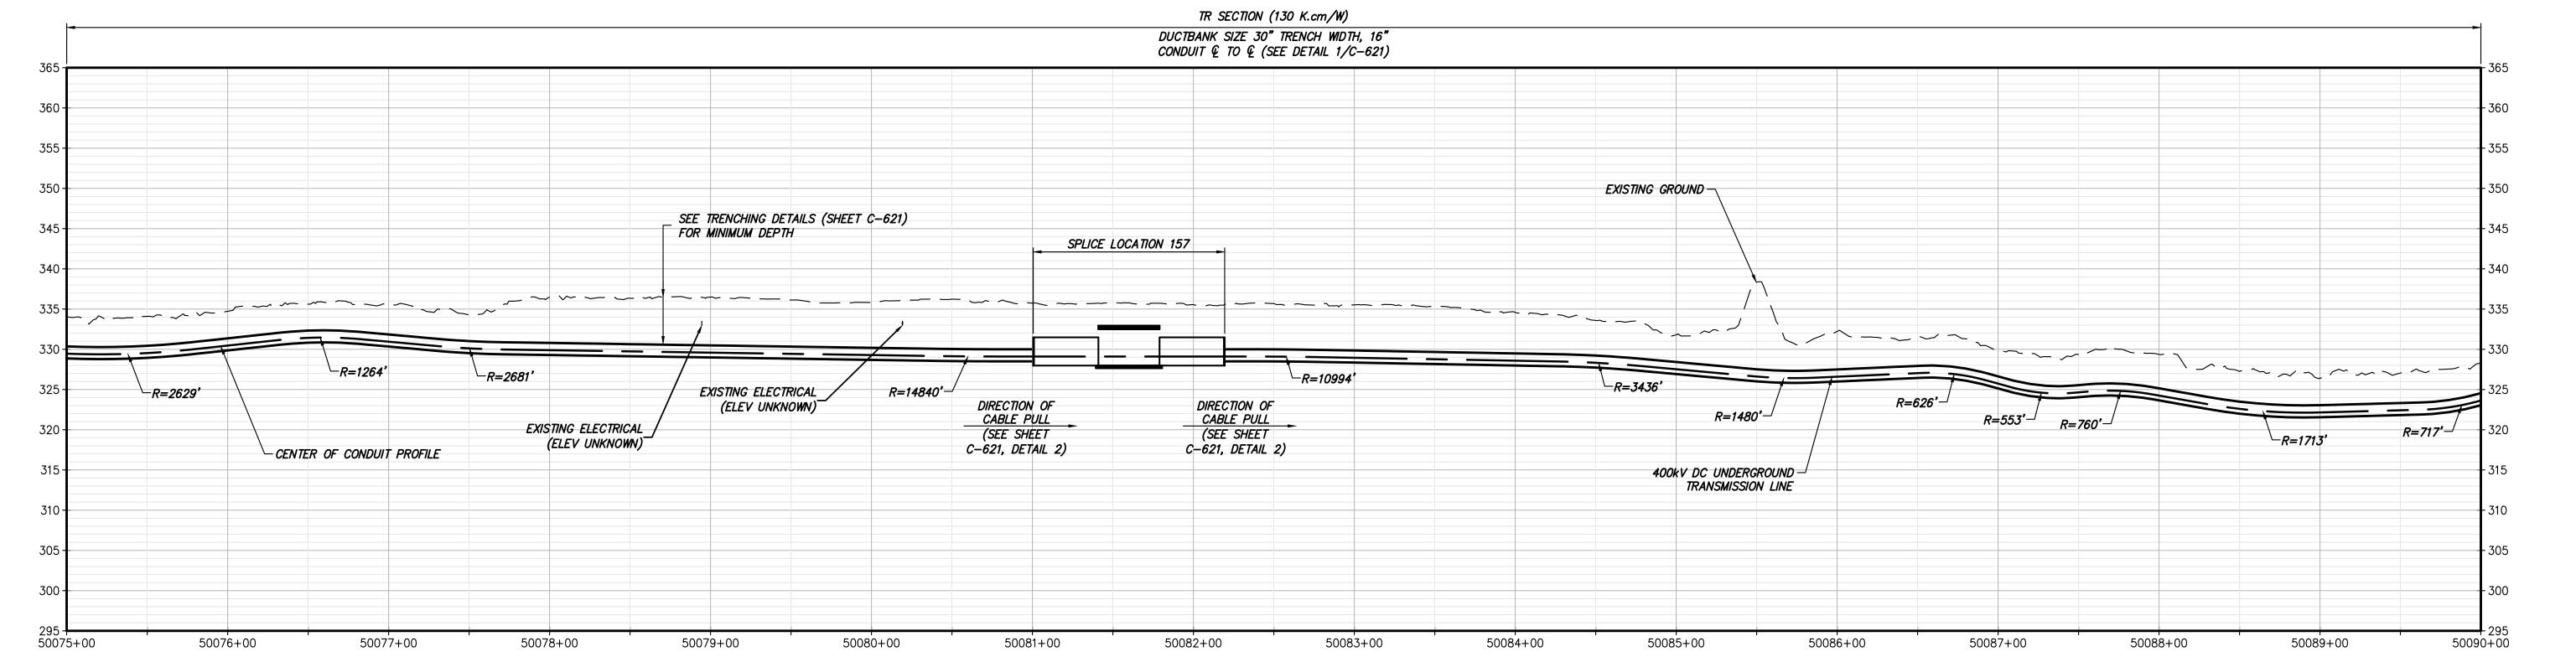

STA. 50075+00.00 TO STA. 50090+00.00 PROFILE SCALE: H: 1" = 50' V: 1" = 10'






IT IS A VIOLATION OF LAW FOR ANY PERSON, UNLESS THEY ARE ACTING UNDER THE DIRECTION OF A LICENSED ARE ACTING UNDER THE DIRECTION OF A LICENSED PROFESSIONAL ENGINEER, ARCHITECT, LANDSCAPE ARCHITECT OR LAND SURVEYOR TO ALTER AN ITEM IN ANY WAY. IF AN ITEM BEARING THE STAMP OF A LICENSED PROFESSIONAL IS ALTERED, THE ALTERING ENGINEER, ARCHITECT, LANDSCAPE ARCHITECT OR LAND SURVEYOR SHALL STAMP THE DOCUMENT AND INCLUDE THE NOTATION "ALTERED BY" FOLLOWED BY THEIR SIGNATURE, THE DATE OF SUCH ALTERATION, AND A SPECIFIC DESCRIPTION OF THE ALTERATION. **FOR EMCP REVIEW** NOT FOR CONSTRUCTION

					SEC
E	12/16/2022	FINAL SUBMISSION	BV	TK	
D	11/11/2022	DRAFT FINAL SUBMISSION	BV	TK	
С	06/06/2022	60% DESIGN SUBMISSION	BV	TK	
В	02/11/2022	PRELIMINARY DESIGN DEVELOPMENT	BV	TK	
Α	01/24/2022	PRELIMINARY PROGRESS	BV	TK	
No.	DATE	SUBMITTAL / REVISION DESCRIPTION	DB	APP	DRAV

KIEWIT PROJECT NO. CHAMPLAIN HUDSON POWER EXPRESS EGMENT 8 (PACKAGE 5A) - CSX: ROTTERDAM - BETHLEHEM STA. 50075+00.00 TO STA. 50090+00.00 HVDC CONDUIT PLAN AND PROFILE **C-106** (AND TEMPORARY ACCESS ROAD PLAN) AWN BY: AR DESIGNED BY: BV APPROVED BY: TK REV. NO. AS SHOWN DATE

21162

DRAWING NO.

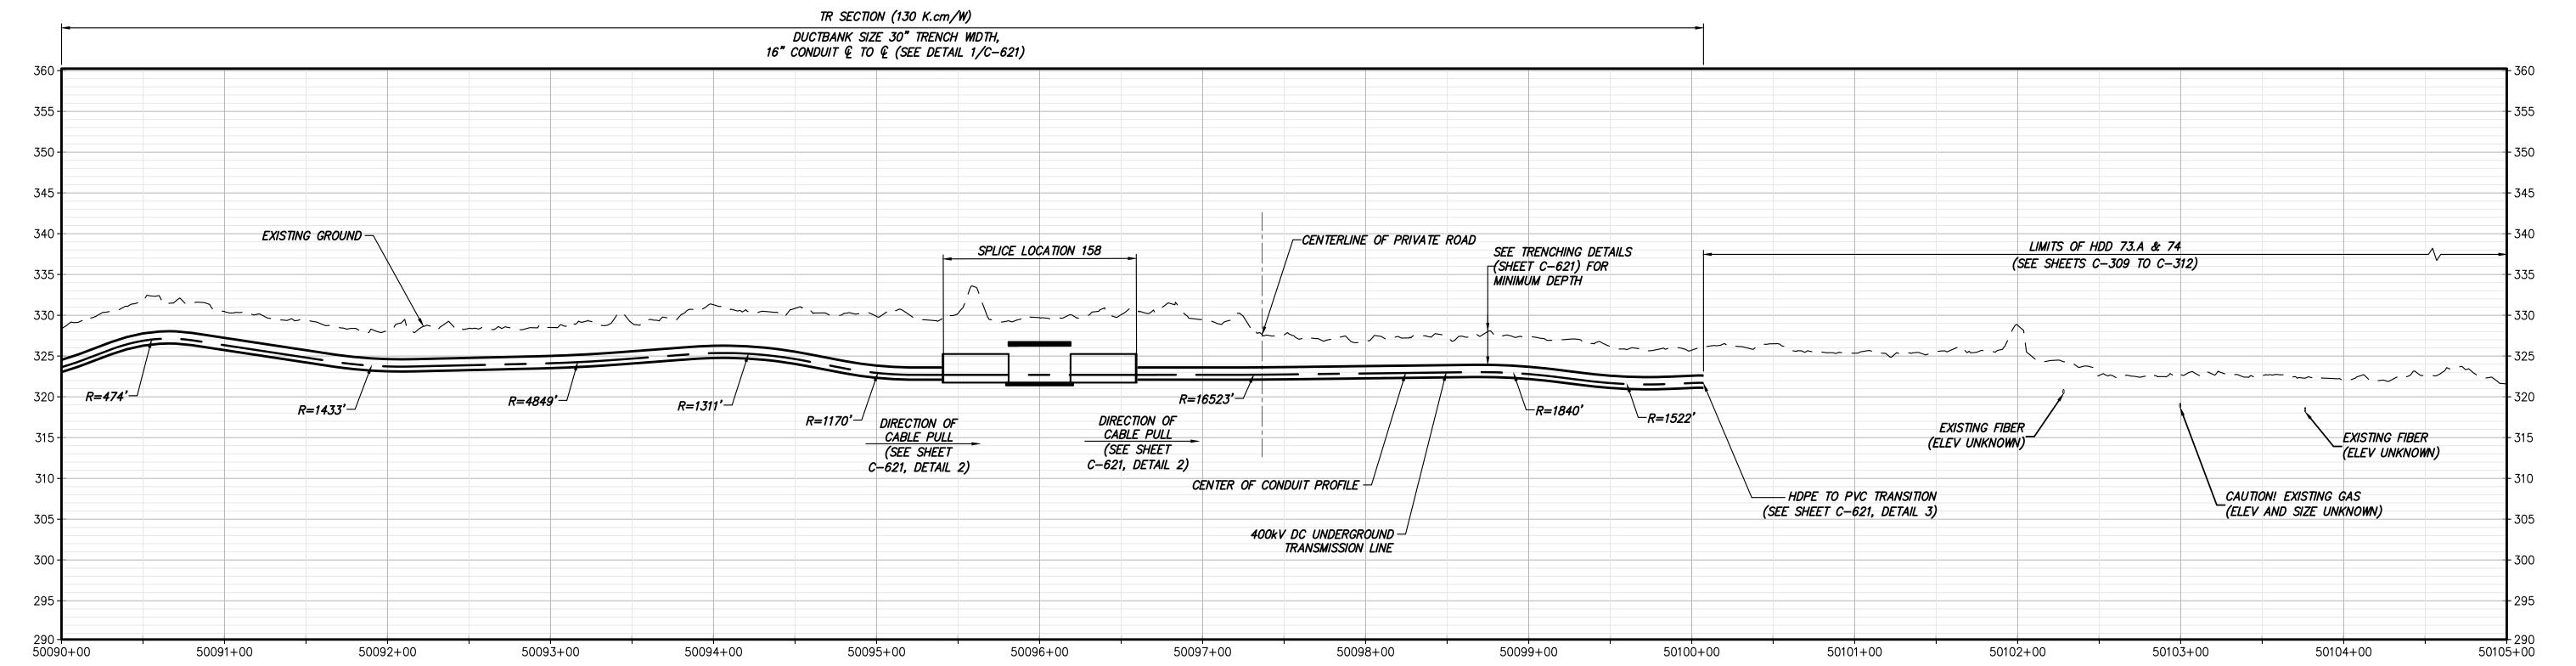

STA. 50090+00.00 TO STA. 50105+00.00 PROFILE SCALE: H: 1" = 50' V: 1" = 10'





IT IS A VIOLATION OF LAW FOR ANY PERSON, UNLESS THEY ARE ACTING UNDER THE DIRECTION OF A LICENSED ARE ACTING UNDER THE DIRECTION OF A LICENSED PROFESSIONAL ENGINEER, ARCHITECT, LANDSCAPE ARCHITECT OR LAND SURVEYOR TO ALTER AN ITEM IN ANY WAY. IF AN ITEM BEARING THE STAMP OF A LICENSED PROFESSIONAL IS ALTERED, THE ALTERING ENGINEER, ARCHITECT, LANDSCAPE ARCHITECT OR LAND SURVEYOR SHALL STAMP THE DOCUMENT AND INCLUDE THE NOTATION "ALTERED BY" FOLLOWED BY THEIR SIGNATURE, THE DATE OF SUCH ALTERATION, AND A SPECIFIC DESCRIPTION OF THE ALTERATION. **FOR EMCP REVIEW** NOT FOR CONSTRUCTION

					_
					SE
Е	12/16/2022	FINAL SUBMISSION	BV	TK	
D	11/11/2022	DRAFT FINAL SUBMISSION	BV	TK	
С	06/06/2022	60% DESIGN SUBMISSION	BV	TK	
В	02/11/2022	PRELIMINARY DESIGN DEVELOPMENT	BV	TK	
Α	01/24/2022	PRELIMINARY PROGRESS	BV	TK	
No.	DATE	SUBMITTAL / REVISION DESCRIPTION	DB	APP	DRA
	D C B	D 11/11/2022 C 06/06/2022 B 02/11/2022 A 01/24/2022	D 11/11/2022 DRAFT FINAL SUBMISSION C 06/06/2022 60% DESIGN SUBMISSION B 02/11/2022 PRELIMINARY DESIGN DEVELOPMENT A 01/24/2022 PRELIMINARY PROGRESS	D 11/11/2022 DRAFT FINAL SUBMISSION BV C 06/06/2022 60% DESIGN SUBMISSION BV B 02/11/2022 PRELIMINARY DESIGN DEVELOPMENT BV A 01/24/2022 PRELIMINARY PROGRESS BV	D 11/11/2022 DRAFT FINAL SUBMISSION BV TK C 06/06/2022 60% DESIGN SUBMISSION BV TK B 02/11/2022 PRELIMINARY DESIGN DEVELOPMENT BV TK A 01/24/2022 PRELIMINARY PROGRESS BV TK

KIEWIT PROJECT NO. CHAMPLAIN HUDSON POWER EXPRESS EGMENT 8 (PACKAGE 5A) - CSX: ROTTERDAM - BETHLEHEM STA. 50090+00.00 TO STA. 50105+00.00 HVDC CONDUIT PLAN AND PROFILE (AND TEMPORARY ACCESS ROAD PLAN) RAWN BY: AR DESIGNED BY: BV APPROVED BY: TK REV. NO.

DRAWING NO. **C-107** AS SHOWN DATE

21162