




### **Appendix A: Plan and Profile Drawings**

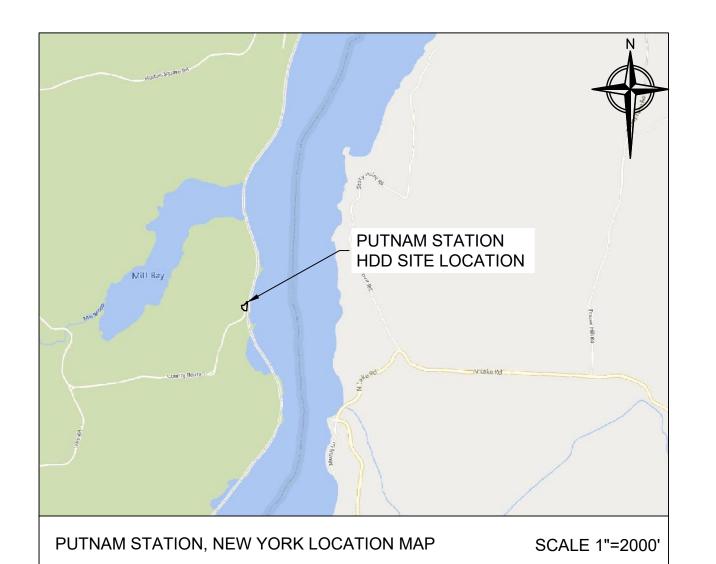

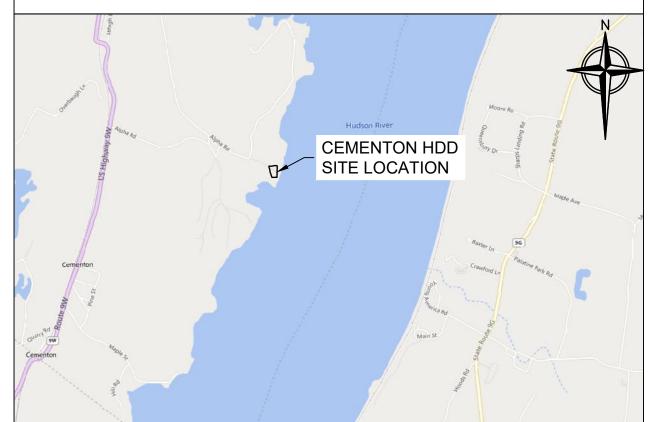

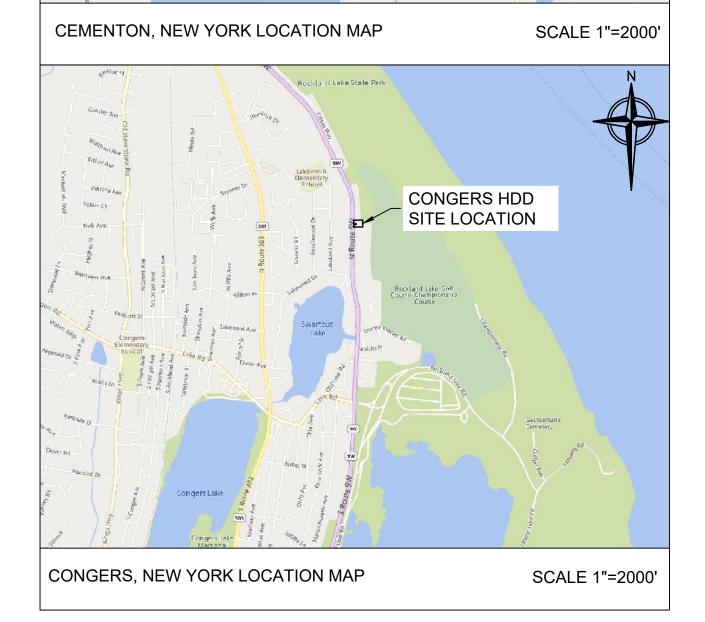

# CHAMPLAIN HUDSON POWER EXPRESS PUTNAM STATION, CEMENTON, AND CONGERS HDD PLAN & PROFILE DRAWINGS


# PROPERTY OWNER TABLE

LOCATION	LANDS NOW OR FORMERLY OF	BOOK, PAGE NO.	TAX MAP ID NO.		
PUTNAM STATION LAYDOWN AREA	TOWN OF PUTNAM 3114, 323		52-4.6		
PUTNAM STATION	DELAWARE & HUDSON RAILWAY CO.	639, 168	91-10		
HDD	ROBERT G. ST. ARMOUR	719, 336	133-21.1		
CEMENTON HDD	GLENS FALLS LEHIGH CEMENT CO.	923, 221	213.00-2-3		
TOMKINS COVE LAYDOWN AREA	SOUTHERN ENERGY LOVETT, LLC	NA	10.04-2-7		
	ISABELLA ROSE REALTY LLC	NA	44.12-2-44		
		739, 1165	44.08-1-8		
CONGERS HDD	PALISADES INTERSTATE PARK COMMISSION	741, 554	45.09-1-2		
	I ALIGADES INTERCOTATE PAINT COMMISSION	741, 561	45.05-1-2		
		NA	45.05-1-1		


# PREPARED FOR:

CALDWELL MARINE INTERNATIONAL 1333 CAMPUS PARKWAY WALL, NEW JERSEY 07753

NOVEMBER 29, 2022

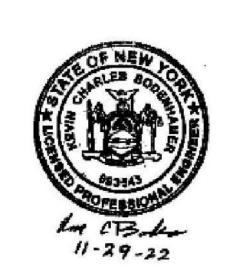



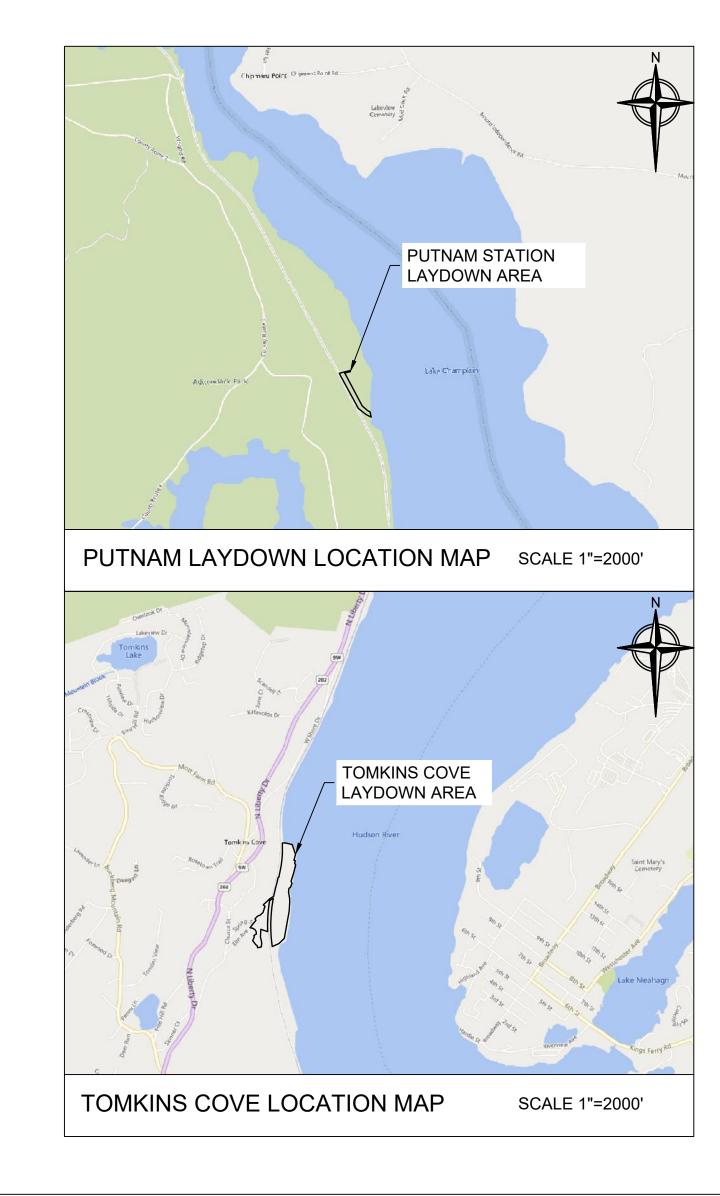

		DRAWING INDEX
SHEET NUMBER	DRAWING NUMBER	SHEET TITLE
1	-	COVER
2	N-1	NOTES & LEGEND
3	HDD-001	PUTNAM STATION LAYDOWN AREA PLAN
4	HDD-002	PUTNAM STATION HDD 1 PLAN AND PROFILE
5	HDD-003	PUTNAM STATION HDD 2 PLAN AND PROFILE
6	HDD-004	PUTNAM STATION HDD LAYOUT PLAN
7	HDD-005	PUTNAM STATION HDD EQUIPMENT LAYOUT PLAN
8	HDD-006	PUTNAM STATION RAILROAD CROSSING PLAN
9	HDD-007	TOMKINS COVE LAYDOWN AREA PLAN
10	HDD-008	CEMENTON HDD 1 PLAN AND PROFILE
11	HDD-009	CEMENTON HDD 2 PLAN AND PROFILE
12	HDD-010	CEMENTON HDD ACCESS ROAD PLAN
13	HDD-011	CEMENTON HDD LAYOUT PLAN
14	HDD-012	CEMENTON HDD EQUIPMENT LAYOUT PLAN
15	HDD-013	CONGERS HDD 1 PLAN AND PROFILE
16	HDD-014	CONGERS HDD 2 PLAN AND PROFILE
17	HDD-015	CONGERS HDD LAYOUT PLAN
18	HDD-016	CONGERS HDD EQUIPMENT LAYOUT PLAN
19	HDD-017	PUTNAM STATION & CEMENTON CONDUCTOR PIPE/GOAL POST/GRAVITY CELL INSTALLATION
20	HDD-018	CONGERS CONDUCTOR PIPE/GOAL POST/GRAVITY CELL INSTALLATION
21	HDD-019	DETAILS

FOR PERMITTING ONLY

#### **GENERAL NOTES:**

- 1. IT IS THE CONTRACTOR'S RESPONSIBILITY TO COORDINATE ALL NECESSARY CONSTRUCTION NOTIFICATIONS, PERMITS AND ACTIVITIES WITH THE CERTIFICATE HOLDERS PRIOR TO AND DURING CONSTRUCTION.
- 2. IT IS THE CONTRACTOR'S RESPONSIBILITY TO MAKE NECESSARY ARRANGEMENTS IF TRAFFIC CONTROL PLANS AND/OR RAILROAD REPRESENTATION ARE REQUIRED.
- 3. CONTRACTOR TO LOCATE, MARK AND POTHOLE FOREIGN LINES AS NECESSARY PRIOR TO EXCAVATION (AND MONITOR DURING DRILLING).
- 4. CONTRACTOR TO DEVELOP A CROSSING PLAN WITH THE OWNER OF ANY FOREIGN PIPELINE CROSSED WITH DRILLING EQUIPMENT.
- 5. LOCATIONS OF EXISTING FACILITIES SHOWN ARE APPROXIMATE. CONTRACTOR TO LOCATE AND/OR CONFIRM THE LOCATIONS AND DEPTH OF ALL UTILITIES, PIPELINES OR OTHER OBSTACLES PRIOR TO EXCAVATION. CONTRACTOR TO INFORM ENGINEER OF ANY UTILITY FOUND THAT MAY AFFECT HDD DESIGN.
- 6. CONTRACTOR TO SUPPORT EXISTING UTILITIES, PIPELINES AND/OR OTHER FEATURES.
- 7. CONTRACTOR TO GRADE EXCAVATION AREA AND RESTORE TO ORIGINAL CONDITIONS.
- 8. CONTRACTOR TO CONTACT STATE ONE CALL SYSTEM AT LEAST 72 HOURS PRIOR TO DRILLING.

## REFERENCE NOTES

- 1. AERIAL PHOTOGRAPHY ON PLAN AND PROFILE SHEETS HDD-002, HDD-003, HDD-008, HDD-009, HDD-013, & HDD-014 OBTAINED FROM MICROSOFT CORPORATION BING IMAGERY.
- 2. BASE PLAN REFERENCES A ROW, UTILITY & WETLAND SURVEY PREPARED IN THE FIELD BY CONTROL POINT ASSOCIATES, INC.
- 3. BASE PLAN HAS BEEN SUPPLEMENTED WITH INFORMATION PROVIDED BY CALDWELL MARINE, CLOUGH HARBOR ASSOCIATES AND NEW YORK GIS CLEARING HOUSE.
- 4. LAKE CHAMPLAIN BATHYMETRIC DATA PROVIDED BY OCEAN SURVEYS INC. IN OCTOBER 2022.

#### PROJECTION SYSTEM

1. NAD83 / NEW YORK EAST (U.S. SURVEY FEET).

#### INSTALLATION NOTES:

- 1. ACCESS: ALL EQUIPMENT MUST ACCESS THE LIMITS THE DISTURBANCE FROM PREVIOUSLY IMPROVED PUBLIC OR APPROVED PRIVATE ROADS.
- 2. WORK SPACE: LIMITS OF DISTURBANCE ARE DEPICTED HEREIN. LIMITED TREE CLEARING IS REQUIRED FOR PUTNAM STATION HDD OPERATIONS AND VEGETATION REMOVAL WILL BE LIMITED TO PRUNING OF LIMBS AND TRIMMING OF UNDERGROWTH AS NEEDED AROUND THE LIMITS OF THE CEMENTON AND CONGERS HDD OPERATIONS AREA. CLEARING BETWEEN THE ENTRY AND EXIT POINTS IS NOT ANTICIPATED. THE DEBRIS GENERATED FROM THE LIMITED PRUNING OF TREES AND THE TRIMMING OF UNDERGROWTH WILL BE COLLECTED IN A ROLL OFF DUMPSTER AND DISPOSED OF BY A LOCAL LICENSED WASTE DISPOSAL COMPANY.
- 3. WATER SOURCE: DRILL WATER SHALL BE OBTAINED FROM AN APPROVED SOURCE. THE CONTRACTOR WILL MAKE ARRANGEMENTS TO OBTAIN WATER FROM A LOCAL FIRE HYDRANT. WATER USAGE SHALL BE METERED AND OBTAINED THROUGH AN APPROVED BACK FLOW PREVENTER.
- 4. SPILL-PREVENTION: THE MOST RECENT VERSION OF THE SPILL PREVENTION PLAN (SPP) IS INCLUDED AS APPENDIX E OF THE CALDWELL MARINE HDD INSTALLATION MANUAL. THE CALDWELL MARINE HDD INSTALLATION MANUAL IS INCLUDED AS APPENDIX F OF THE ENVIRONMENTAL MANAGEMENT AND CONTROL PLAN (EM&CP). ALL REFUELING AND STORAGE IS ADDRESSED IN THE SPP. ALL PUMPS SHALL BE SET IN SECONDARY CONTAINMENT AND IN ACCORDANCE WITH THE SPP. EQUIPMENT AND PUMPS OPERATING WITHIN 100 FEET OF ANY WATER BODY OR WETLAND SHALL BE OPERATED AND REFUELED IN ACCORDANCE WITH THE SPP. EQUIPMENT REFUELING AND STORAGE OF HAZARDOUS MATERIALS, FUELS, ETC. SHALL BE CONDUCTED AT LEAST 100 FEET FROM WATER BODIES AND WETLAND WHERE PRACTICAL. EACH CONSTRUCTION CREW SHALL HAVE ON HAND SUFFICIENT TOOLS AND MATERIALS TO STOP LEAKS AND HAVE SUPPLIES OF ABSORBENT AND BARRIER MATERIALS TO ALLOW RAPID CONTAINMENT AND RECOVERY OF SPILLED MATERIALS.
- 5. EROSION AND SEDIMENT CONTROL: CONTRACTOR SHALL SUPPLY, INSTALL AND MAINTAIN SEDIMENT CONTROL STRUCTURES IN ACCORDANCE WITH CONTRACT DOCUMENTS. CONTRACTOR SHALL INSTALL ADDITIONAL EROSION CONTROL STRUCTURES AS DIRECTED BY THE ENVIRONMENTAL INSPECTOR OR AS NEEDED TO ENSURE SEDIMENT-LADEN RUNOFF FROM NEWLY DISTURBED AREAS IS PREVENTED FROM FLOWING OUTSIDE THE LIMITS OF DISTURBANCE.
- 6. MUD DISPOSAL: CONTRACTOR SHALL DISPOSE OF EXCESS DRILLING MUD AS DIRECTED BY THE COMPANY REPRESENTATIVE IN ACCORDANCE WITH PERMIT CONDITIONS. UNDER NO CIRCUMSTANCES SHALL DRILLING FLUID BE DISPOSED OF IN WATER BODIES OR WETLANDS. ANY DRILLING MUD WHICH INADVERTENTLY EXITS AT POINTS OTHER THAN THE ENTRY AND EXIT POINTS SHALL BE CONTAINED AND COLLECTED TO THE EXTENT PRACTICAL AND DISPOSED OF AS DIRECTED BY THE COMPANY REPRESENTATIVE IN ACCORDANCE WITH PERMIT CONDITIONS. DRILLING MUD WILL BE DISPOSED OF AT CLEAN EARTH NEW JERSEY, IN KEARNY, NJ OR AT AN ALTERNATE APPROVED FACILITY.
- 7. CLEANUP/STABILIZATION/RESTORATION: ALL DISTURBED AREAS SHALL BE RETURNED TO THE ORIGINAL CONDITIONS. DISTURBED AREAS SHALL BE SEEDED AND TEMPORARY EROSION/SEDIMENT CONTROL DEVICES SHALL BE REMOVED ONCE THE CONTRIBUTING DISTURBED AREAS ARE STABILIZED AND APPROVED BY THE QUALIFIED INSPECTOR. REFER TO THE SEED MIXTURES LISTED IN TABLE 4.4 OF APPENDIX G OF THE STORMWATER POLLUTION PREVENTION PLAN (SWPPP). THE SWPPP IS INCLUDED AS APPENDIX I OF THE EM&CP.
- 8. CONTRACTOR SHALL USE A GYROSCOPIC DRILL HEAD ON THE PILOT DRILL TO ENSURE ACCURATE EXIT LOCATION WITHIN THE TEMPORARY MODULAR GRAVITY CELLS.

# PROPOSED LEGEND

LIMITS OF DISTURBANCE

SF SILT FENCE

LAYDOWN AREA

PERMITTED DEVIATION ZONE

TEMPORARY EASEMENT

HDD CONDUIT

HDD ENTRY/EXIT POINTS

GEOTECH BORE HOLE LOCATIONS

# **EXISTING LEGEND**

EXISTING TREE LINE

RAILROAD TRACKS

OVERHEAD WIRES

UNDERGROUND UTILITY

DRAINAGE CULVERT

EXISTING FENCE

MAJOR CONTOUR

MINOR CONTOUR

WETLAND

100-FOOT WETLAND ADJACENT AREA

PARCEL BOUNDARIES

EXISTING NATURAL VEGETATION

EXISTING UTILITY POLE

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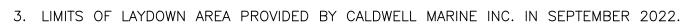
N-1

# PROPOSED WORK NOTES:

- 1. LAND DISTURBANCE IS NOT ANTICIPATED. TIMBER MATTING WITHIN GRASSED AREAS SHOULD BE USED WHEN SOFT OR POORLY DRAINED SOILS ARE PRESENT TO PREVENT EQUIPMENT RUTTING AND SEDIMENT TRACKING.
- 2. THE EXISTING ACCESS ROAD AND LAYDOWN AREA IS ANTICIPATED TO SUPPORT THE PIPE FUSING OPERATION IN IT'S CURRENT CONDITION. MINOR ACCESS SURFACE IMPROVEMENTS AND INSTALLATION OF ADDITIONAL EROSION CONTROLS WILL BE IMPLEMENTED AS NECESSARY TO PREVENT SEDIMENT—LADEN RUNOFF FROM FLOWING OUTSIDE OF THE LAYDOWN AREA.
- 3. TEMPORARY 'CONSTRUCTION TRAFFIC AHEAD' WARNING SIGNS WILL BE INSTALLED 100-FEET FROM THE EXISTING ACCESS VIA LAPOINTE LANE TO THE TOWN OF PUTNAMS PROPERTY ON BOTH LOWER ROAD APPROACHES. FINAL SIGN TEXT AND LOCATIONS TO BE APPROVED BY THE OWNER AND COORDINATED WITH THE TOWN OF PUTNAM.


#### **REFERENCE NOTES:**


- 1. AERIAL PHOTOGRAPHY OBTAINED FROM THE NEW YORK GIS CLEARINGHOUSE, STATEWIDE DIGITAL ORTHOIMAGERY PROGRAM, DATED SEPTEMBER 2017.
- 2. PARCEL DATA OBTAINED FROM NEW YORK GIS CLEARINGHOUSE, DIGITAL MAPS DATABASE, NYS STATEWIDE 2021 PARCEL LAYER, PUBLISHED OCTOBER 2022.







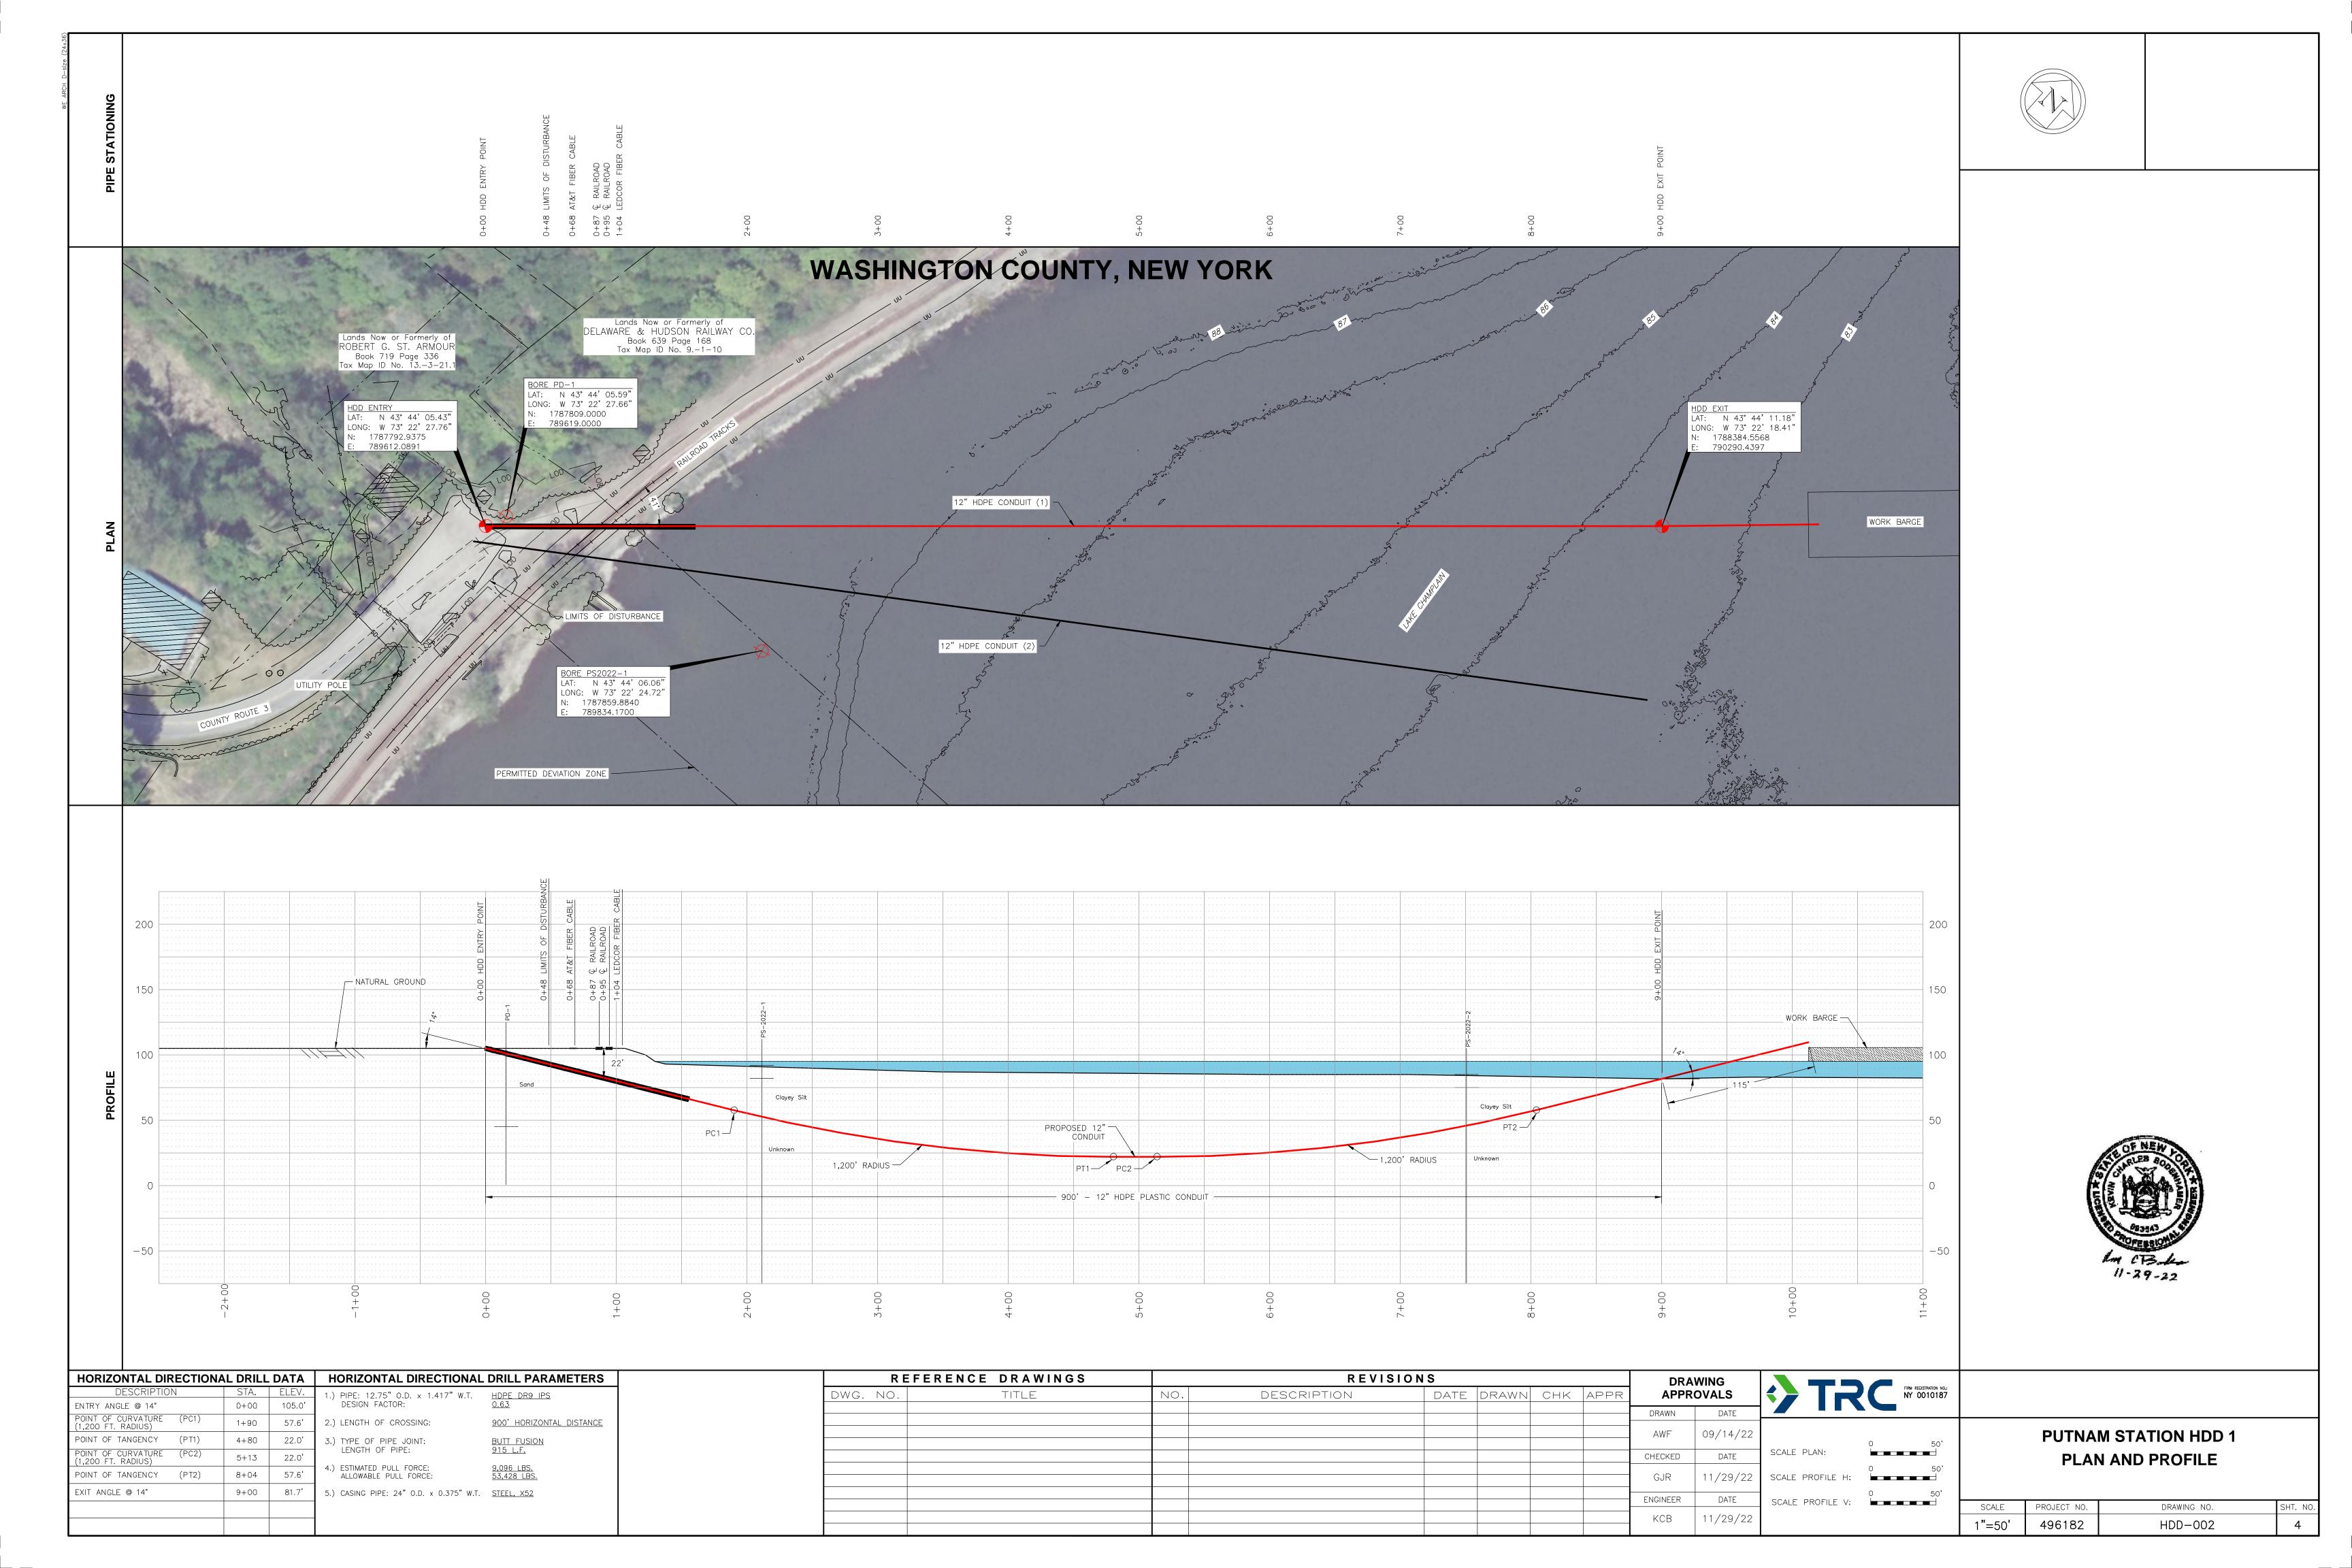

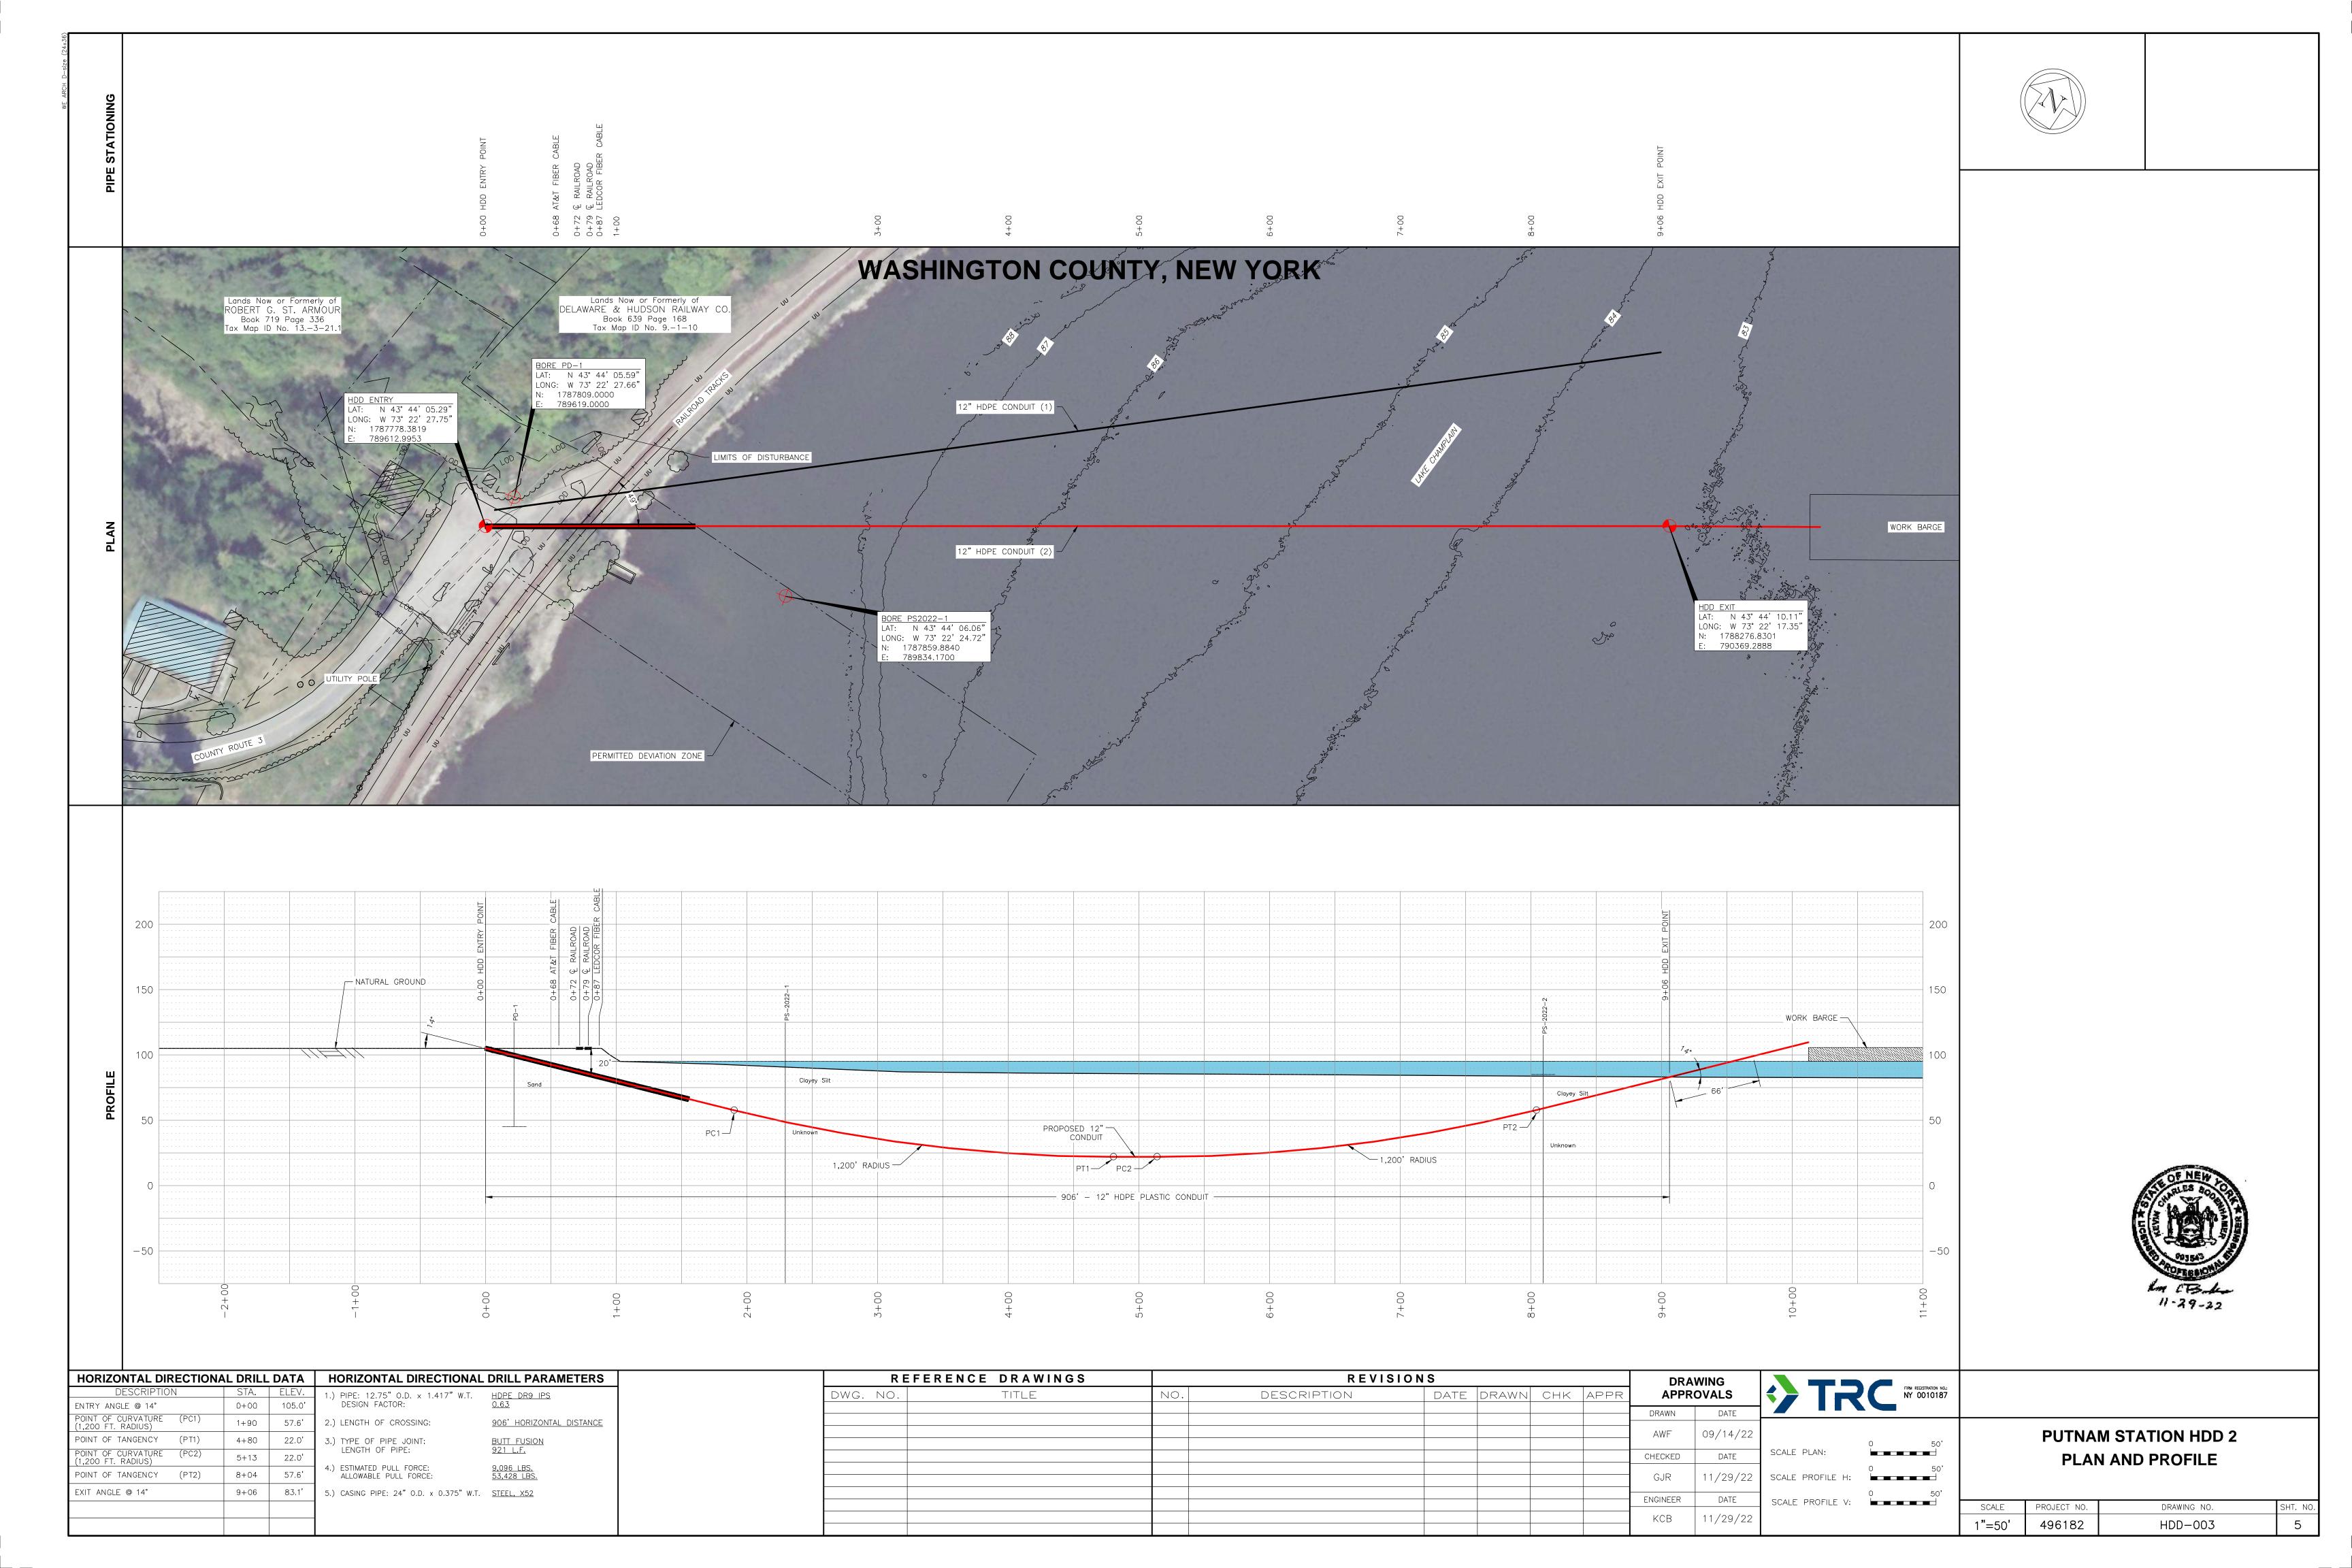

PROPOSED WORK NOTES: REFERENCE NOTES: 1. ALL HDD CONSTRUCTION OPERATIONS AND PARKING WILL BE CONTAINED IN THE FIELD BY CONTROL TREES WITHIN THE IMMEDIATE VICINITY OF THE BUILDING REMAINS TO THE EAST OF THE PAVED PARKING AREA, PRUNING OF LIMBS AND TRIMMING OF UNDERGROWTH ALONG THE PERIMETER OF THE HDD WORKSPACE, NO HERBICIDE USE IS POINT ASSOCIATES, INC. PERMITTED. ALL DISTURBED AREAS SHALL BE RESTORED AFTER CONSTRUCTION. 2. BASE PLAN HAS BEEN SUPPLEMENTED WITH INFORMATION PROVIDED BY CALDWELL MARINE, CLOUGH HARBOR ASSOCIATES AND NEW YORK GIS CLEARING HOUSE. 2. NO EXISTING ACCESS IMPROVEMENTS ARE ANTICIPATED. THE PAVED PARKING AREA SHALL BE RE-SURFACED AS NECESSARY TO SUPPORT HDD CONSTRUCTION OPERATIONS AND PREVENT SEDIMENT-LADEN RUNOFF TO FLOW OUTSIDE OF THE LIMITS OF DISTURBANCE. 3. TEMPORARY 'CONSTRUCTION TRAFFIC AHEAD' WARNING SIGN WILL BE INSTALLED IN THE SHOULDER OF COUNTY ROUTE 3 100-FEET FROM THE END OF THE DOUBLE YELLOW LINE. FINAL SIGN TEXT AND LOCATION TO BE APPROVED BY THE OWNER, DELAWARE AND HUDSON RAILWAY CO, AND COORDINATED WITH WASHINGTON COUNTY. ROBERT G. ST. ARMOUR UTILITY POLE (TYP. DELAWARE & HUDSON RAILWAY - 130 WETLAND CA (PEM/PFO) LIMITS OF DISTURBANCE LANDS N/F OF 0.31± AC CHARLES HOLMAN - SILT FENCE (TYP.) DANIELLE DRINKWINE-HOLMAN TM# 13.-3-21.2 HDD WORKSPACE SEE PROPOSED - EXISTING STRUCTURES -WORK NOTES PERMITTED DEVIATION ZONE NO MAJOR ACCESS IMPROVEMENTS ANTICIPATED. -MINOR IMPROVEMENTS MAY BE REQUIRED AS NECESSARY TO ENSURE SAFE ACCESS. HDD ENTRY CONDUIT (1) N:1787792.99 HDD ENTRY CONDUIT (2) E:789612.12 N:1787778.37 E:789612.99 OPÉN TRÉNCHED CONDUITS FROM HDD CONDUIT TO STUB-UPS AT TRANSITION VAULT (TYP.) (BY OTHERS) - HDD TRANSITION VAULT (CONNECTIONS TO CONDUIT 'CHPE PUTNAM STATION WORKSITE ENTRANCE' SIGN SEE PROPOSED WORK NOTES LAKE CHAMPLAIN - PERMITTED DEVIATION ZONE REFERENCE DRAWINGS REVISIONS APPROVALS DATE DRAWN CHK APPR DESCRIPTION DWG. NO. TITLE NO. DRAWN **PUTNAM STATION HDD** MMO SCALE PLAN: **LAYOUT PLAN** CHECKED DATE GJR ENGINEER DATE DRAWING NO. SCALE PROJECT NO. 11/29/2022 1"=20' HDD-004

